HARDSCAPE AND LANDSCAPE


IMPROVEMENTS TO

ASCEND ON JUNO LANDING

7542 JUNO LANDING, SAN ANTONIO, TEXAS

ISSUE FOR CONSTRUCTION

JANUARY 26, 2024

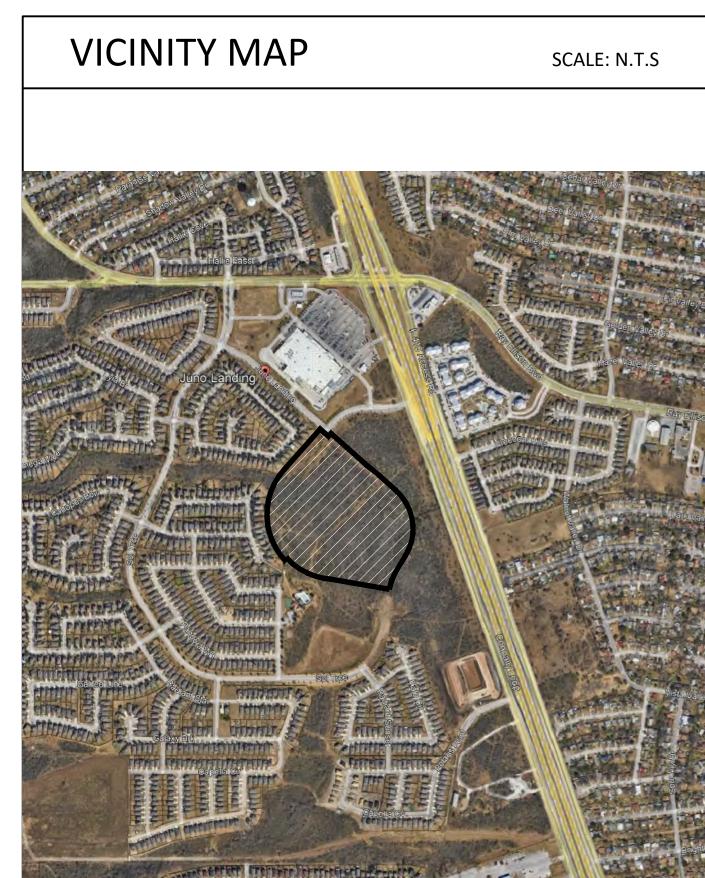

PROJECT INFORMATION

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LANDSCAPE ARCHITECT

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INDEX OF DRAWINGS

Sheet Title COVER SHEET GENERAL NOTES OVERALL TREE PRESERVATION PLAN
GENERAL NOTES
OVERALL TREE PRESERVATION PLAN
OVERALE TREE TRESERVATION TEAN
OVERALL TREE PRESERVATION PLAN
TREE PRESERVATION PLAN
TREE PRESERVATION PLAN
TREE PRESERVATION CALCULATION
TREE PRESERVATION CALCULATION
TREE PRESERVATION CALCULATION
HARDSCAPE SCHEDULE
OVERALL SITE PLAN
HARDSCAPE PLAN
HARDSCAPE PLAN
HARDSCAPE PLAN
HARDSCAPE PLAN
HARDSCAPE PLAN
HARDSCAPE PLAN
HARDSCAPE PLAN
HARDSCAPE PLAN
HARDSCAPE ENLARGED PLAN
HARDSCAPE ENLARGED PLAN
HARDSCAPE ENLARGED PLAN
HARDSCAPE DETAIL

LG1.00	OVERALL GRADING PLAN
LG1.01	GRADING ENLARGEMENT PLAN
LG1.02	GRADING ENLARGEMENT PLAN
LD1.01	DRAINAGE ENLARGEMENT PLAN
LL1.00	OVERALL LIGHTING PLAN
LL1.01	LIGHTING PLAN
LL1.02	LIGHTING PLAN
LL1.03	LIGHTING PLAN
LL1.04	LIGHTING PLAN
LL1.05	LIGHTING PLAN
LL1.06	LIGHTING PLAN
LL1.07	LIGHTING PLAN
LL1.08	LIGHTING PLAN
LL2.01	LIGHTING DETAIL
LL2.02	LIGHTING DETAIL
LP1.00	OVERALL LANDSCAPE PLANTING PLAN
LP1.01	LANDSCAPE PLANTING PLAN
LP1.02	LANDSCAPE PLANTING PLAN
LP1.03	LANDSCAPE PLANTING PLAN
LP1.04	LANDSCAPE PLANTING PLAN
LP1.05	LANDSCAPE PLANTING PLAN
LP1.06	LANDSCAPE PLANTING PLAN
LP1.07	LANDSCAPE PLANTING PLAN
LP1.08	LANDSCAPE PLANTING PLAN
LP1.09	LANDSCAPE PLANTING NOTES
LP1.10	LANDSCAPE PLANTING DETAILS
LP1.11	LANDSCAPE PLANTING SPECIFICATIONS
LP1.12	LANDSCAPE PLANTING SPECIFICATIONS
IR1.00	OVERALL IRRIGATION PLAN
IR1.01	IRRIGATION PLAN
IR1.02	IRRIGATION PLAN
IR1.03	IRRIGATION PLAN
IR1.04	IRRIGATION PLAN
IR1.05	IRRIGATION PLAN
IR1.06	IRRIGATION PLAN
IR1.07	IRRIGATION PLAN
IR1.08	IRRIGATION PLAN
IR1.09	IRRIGATION NOTES, ANALYIS, & SCHEDULE
IR1.10	IRRIGATION DETAILS
IR1.11	IRRIGATION LETTER OF CONFORMITY

SHEET TITLE

COVER SHEET

L0.00

GENERAL NOTES

- 1. CONTRACTOR SHALL ACT IN ACCORDANCE WITH APPLICABLE LOCAL CODES, ORDINANCES AND STANDARDS ENFORCED AT THE TIME OF CONSTRUCTION.
- 2. CONTRACTOR IS RESPONSIBLE FOR , AND MUST OBTAIN PRIOR TO CONSTRUCTION, ALL NECESSARY CONSTRUCTION PERMITS REQUIRED BY THE GOVERNING AGENCY.
- 3. PRIOR TO CONSTRUCTION, A PRE-CONSTRUCTION MEETING SHALL BE HELD WITH REPRESENTATIVES FROM ALL CONTRACTORS, LANDSCAPE ARCHITECT AND THE OWNER.
- 4. TOPOGRAPHICAL MAPPING SHOWN PER DATE BY LIA ENGINEERING. CONTRACTOR TO NOTIFY ARCHITECT OF ANY DISCREPANCIES BETWEEN THE PLAN TOPOGRAPHY AND THE CURRENT EXISTING CONDITIONS.
- 5. CONTRACTOR IS RESPONSIBLE FOR VERIFYING THE ACCURATE LOCATIONS OF PROPERTY LINES, RIGHT OF WAY AND FUTURE CONSTRUCTION EASEMENTS AND SHALL NOTIFY THE LANDSCAPE ARCHITECT OF ANY DISCREPANCIES PRIOR TO CONSTRUCTION.
- 6. EXISTING UTILITIES SHOWN ARE TAKEN FROM AVAILABLE RECORDS PROVIDED BY THE UTILITY OWNER AND FILE LOCATIONS OF SURFACE APPURTENANCES. LOCATIONS SHOWN ARE GENERALLY SCHEMATIC IN NATURE AND MAY NOT ACCURATELY REFLECT THE SIZE AND LOCATION OF EACH PARTICULAR UTILITY. SOME UTILITY LINES MAY NOT BE SHOWN. CONTRACTOR SHALL VERIFY THE LOCATION, SIZE, AND MATERIAL OF ALL UTILITIES AFFECTED BY CONSTRUCTION PRIOR TO BEGINNING CONSTRUCTION. CONTRACTOR SHALL CONTACT ALL AFFECTED UTILITY COMPANIES 48 HOURS PRIOR TO CONSTRUCTION. FOR UTILITY LOCATION AND TO OBTAIN A LIST OF KNOWN UTILITY COMPANIES, CONTRACTOR SHALL CONTACT TEXAS 811.
- 7. CONTRACTOR TO NOTIFY THE OWNER WHEN ANY DISCREPANCY IS FOUND BETWEEN PLANS AND EXISTING CONDITIONS. IN THE EVENT A DISCREPANCY IS FOUND THE CONTRACTOR WILL NOTIFY THE LANDSCAPE ARCHITECT AND MAKE FIELD ADJUSTMENTS TO CORRECT ANY PROBLEM.
- 8. CONTRACTOR SHALL REPAIR ANY AND ALL UTILITIES THAT ARE DAMAGED DURING INSTALLATION AT NO ADDITIONAL COST TO THE CLIENT.
- 9. CONTRACTOR IS RESPONSIBLE FOR REPLACEMENT OF ANY EXISTING MATERIALS THAT ARE DAMAGED DURING CONSTRUCTION, AS DETERMINED BY THE LANDSCAPE ARCHITECT OR OWNER'S AUTHORIZED REPRESENTATIVE.
- 10. THE CONTRACTOR IS RESPONSIBLE FOR SECURING ACCESS TO THE CONSTRUCTION SITE, SUBJECT TO APPROVAL FROM THE CLIENT.
- 11. CONTRACTOR SHALL CONSTRUCT A STABILIZED CONSTRUCTION ENTRANCE/EXIT AT ALL TRAFFIC ACCESS POINTS PRIOR TO EXITING ONTO ANY PAVED ROADWAY. REFERENCE CIVIL EROSION CONTROL PLANS FOR DETAILS.
- 12. THE CONTRACTOR IS RESPONSIBLE FOR KEEPING SIDEWALKS AND ROADS ADJACENT TO THE PROJECT SITE FREE FROM MUD AND DEBRIS FROM THE CONSTRUCTION SITE.
- 13. THE CONTRACTOR SHALL ADOPT APPROPRIATE CONSTRUCTION SITE MANAGEMENT PRACTICES TO PREVENT THE DISCHARGE OF OILS, GREASE, PAINTS, GASOLINE AND OTHER POLLUTANTS TO STORM WATER. APPROPRIATE PRACTICES SHALL BE INCIDENTAL TO THE OVERALL PROJECT COSTS AND INCLUDE BUT ARE NOT LIMITED TO:
- -DESIGNATING ARES FOR EQUIPMENT MAINTENANCE AND REPAIR
- -REGULAR COLLECTION OF WASTE

UTILITIES, AND STRUCTURES.

- -CONVENIENTLY LOCATED TRASH RECEPTACLES
 -DESIGNATING AND CONTROLLING EQUIPMENT WASHDOWN
- 14. CONTRACTOR SHALL PERFORM WORK IN A MANNER CONSISTENT WITH ALL REGULATIONS TO ELIMINATE HAZARDS TO PERSONS OR PROPERTY AND AVOID INTERFERENCE WITH ADJACENT AREAS,
- 15. THE ACCESS AND WORK AREAS SHALL BE SECURED DURING NON WORKING HOURS.
- 16. ADEQUATE MEASURES SHALL BE TAKEN TO PREVENT EROSION. IN THE EVENT THAT SIGNIFICANT EROSION OCCURS AS A RESULT OF CONSTRUCTION, THE CONTRACTOR SHALL RESTORE THE AFFECTED AREAS TO ORIGINAL CONDITION OR BETTER.
- 17. CONSTRUCTION STAGING AREA OR STORAGE YARDS SHALL BE OBTAINED PRIOR TO CONSTRUCTION. CONTRACTOR IS RESPONSIBLE FOR SECURING THESE LOCATIONS AND SHALL RETURN THE USED LOCATIONS TO ORIGINAL CONDITION OR BETTER UNLESS OTHERWISE SPECIFIED OR AGREED TO BY THE PROPERTY OWNER.
- 18. ANY DAMAGES THAT MAY OCCUR TO REAL PROPERTY OR EXISTING IMPROVEMENTS SHALL BE RESTORED BY THE CONTRACTOR TO AT LEAST THE SAME CONDITION THE REAL PROPERTY OR EXISTING IMPROVEMENTS WERE IN PRIOR TO THE DAMAGES. THIS RESTORATION SHALL BE SUBJECT TO OWNER'S APPROVAL; MOREOVER, THE RESTORATION SHALL NOT BE A BASIS FOR ADDITIONAL COMPENSATION TO THE CONTRACTOR.
- 19. LOT LINES SHOWN ON SURVEY CONTROL AND SHEET INDEXES ARE SHOWN FOR SCHEMATIC
- 20. THE LOCATION OF FEATURES TO BE CONSTRUCTED AND NOT SPECIFICALLY DIMENSIONED MAY BE DETERMINED BY SCALE. IF CONFLICTS ARISE IN THE FIELD, NOTIFY THE LANDSCAPE ARCHITECT FOR RESOLUTION.
- 21. IF THE IN FIELD SCALED DIMENSIONS CONFLICT WITH NOTED GRADES, AND/OR ELEVATIONS, NOTIFY THE LANDSCAPE ARCHITECT TO RESOLVE DISCREPANCIES.

GRADING NOTES

- THE CONTRACTOR SHALL BE RESPONSIBLE FOR TREE PROTECTION. MAINTAIN EXISTING GRADE WITHIN DRIP LINE OF ALL EXISTING TREES. THE CONTRACTOR SHALL NOTIFY THE LANDSCAPE ARCHITECT BEFORE COMMENCING WORK WHERE GRADING CONDITIONS DICTATE MORE THAN 2" OF FILL WITHIN THE DRIP LINE.
- 2. THE CONTRACTOR IS RESPONSIBLE FOR THE REPLACEMENT OF ANY EXISTING MATERIALS THAT ARE DAMAGED DURING CONSTRUCTION, AS DETERMINED BY THE OWNER'S AUTHORIZED REPRESENTATIVE.
- 3. NO CHANGE IN CONTRACT PRICE WILL BE ALLOWED FOR ANY ACTUAL OR CLAIMED DISCREPANCY BETWEEN EXISTING GRADES AND THOSE SHOWN ON PLANS AFTER CONTRACTOR HAS ACCEPTED EXISTING GRADES AND BEGUN WORK ON THE SITE.
- 4. CONTRACTOR SHALL BE RESPONSIBLE FOR ANY COORDINATION WITH SUBCONTRACTORS AS REQUIRED TO ACCOMPLISH GRADING OPERATIONS.
- 5. FILL AND GRADE SMOOTH ALL HOLES, DEPRESSIONS, AND RUTS THAT ARE A RESULT OF WORK PERFORMED UNDER THIS CONTRACT. ALL AREAS ARE TOO BE GRADED SO AS TO PROVIDE POSITIVE DRAINAGE AND OUTFALL.
- 6. FINISHED GRADE SHALL BE 1" BELOW ADJACENT CURBS, PAVEMENT, AND WALKS.
- 7. ALL GRADES SHOWN ARE FINISH GRADE ELEVATIONS UNLESS OTHERWISE NOTED ON THE DRAWINGS.

HARDSCAPE NOTES

- 1. CONTRACTOR SHALL STAKE LOCATIONS OF ALL PROPOSED HARDSCAPE ELEMENTS FOR APPROVAL BY THE LANDSCAPE ARCHITECT PRIOR TO CONSTRUCTION.
- 2. CONTRACTOR SHALL LAYOUT CURVILINEAR SIDEWALKS AND PATHS SO AS TO MAKE SMOOTH AND CONTINUOUS TRANSITIONS.
- 3. DIMENSIONS TAKEN FROM ROAD EDGE ARE TYPICALLY FROM BACK OF CURB (B.O.C.) UNLESS OTHERWISE NOTED ON THE PLAN. ALL DIMENSIONS TAKEN FROM CURBS, BUILDING FACE, OR OTHER HARDSCAPE FEATURES ARE TAKEN PERPENDICULAR UNLESS OTHERWISE NOTED ON PLANS.
- 4. ALL HARDSCAPE ELEMENT DIMENSIONS ARE TO CENTERLINE OF THE ELEMENT UNLESS OTHERWISE NOTED ON THE PLANS.
- 5. THE ELEVATIONS OF ALL PROPOSED HARDSCAPE ELEMENTS SHALL BE VERIFIED IN THE FIELD AND APPROVED BY LANDSCAPE ARCHITECT.
- 6. CONTRACTOR IS REQUIRED TO SAFELY MAINTAIN TRAFFIC FLOW DURING CONSTRUCTION.
- 7. CONTRACTOR SHALL FIELD VERIFY ALL DIMENSIONS.
- 8. ALL SIDEWALK AND TRAILS SHALL MEET ADA REQUIREMENTS UNLESS OTHERWISE NOTED. MAXIMUM CROSS SLOPE OF 2% MINIMUM CROSS SLOPE OF 0.5% AND MAXIMUM LONGITUDINAL SLOPE SHALL BE 5%. CONTRACTOR SHALL BE RESPONSIBLE FOR REMOVAL AND REPLACEMENT OF ANY ADA ACCESSIBLE FLATWORK THAT DOES NOT MEET THE MINIMUM ADA ACCESSIBILITY REQUIREMENTS AT NO ADDITIONAL COST TO THE OWNER.
- 9. MEET LEVEL AND FLUSH TO EXISTING RAMPS AND PROVIDE 5'X5' MINIMUM LANDING WITH A MAXIMUM 2% SLOPE IN ALL DIRECTIONS.
- 10. END SIDEWALK AT EXPANSION JOINT BOARD AND DOWEL FOR FUTURE CONNECTION, TYP.
- 11. CONTRACTOR SHALL PROCEED WITH PAVING NO MORE THAN 72 HOURS AFTER DENSITY/MOISTURE TESTS HAVE BEEN TAKEN AND PASSED BY A TESTING FIRM TO ASSIGNED BY THE OWNER. COPIES OF THE REST RESULTS SHALL BE FURNISHED TO THE OWNER. IN THE EVENT PAVING OPERATIONS HAVE NOT COMMENCED WITHIN THE 72 HOUR LIMIT, A RETEST SHALL BE REQUIRED AT NO ADDITIONAL COST TO THE OWNER.
- 12. THE PAVING CONTRACTOR IS RESPONSIBLE FOR ALL "PERMANENT SURVEY REFERENCE MONUMENTS" AS DESCRIBED IN THE SUBDIVISION ORDINANCE, INCLUDING CONCRETE MONUMENTS AND ALL BOUNDARY CORNERS
- 13. CONCRETE PAVING JOINTS SHALL BE CONSTRUCTED AS SHOWN ON THE DRAWINGS AND DETAILS. EXPANSION JOINTS SHALL BE PLACED AT CHANGES IN DIRECTION OF PAVING, AT DRIVEWAYS, AND/OR AS SHOWN ON THE DRAWINGS. SEAL ALL JOINTS AS SHOWN ON THE DRAWINGS.
- 14. REFERENCE SIDEWALK DETAILS FOR MINIMUM P.S.I, AND STRUCTURAL REINFORCEMENT REQUIREMENTS.
- 15. CONTRACTOR SHALL PROTECT EXISTING MONUMENTATION AND PRIMARY CONTROL. ANY SUCH POINTS WHICH THE CONTRACTOR BELIEVES WILL BE DESTROYED SHALL HAVE OFFSET POINTS ESTABLISHED BY THE CONTRACTOR PRIOR TO CONSTRUCTION. ANY MONUMENTATION DESTROYED BY THE CONTRACTOR SHALL BE REESTABLISHED AT NO ADDITIONAL COST TO THE OWNER.
- 16. CONTRACTOR SHALL LOCATE AND ADJUST EXISTING MANHOLE, LIDS, WATER VALVES, AND OTHER SURFACES APPURTENANCES AS REQUIRED FOR NEW CONSTRUCTION. CONTRACTOR SHALL COORDINATE UTILITY ADJUSTMENTS WITH OTHER DISCIPLINES AND THE APPROPRIATE AGENCIES AND PROVIDE FOR ALL FEES FOR PERMITS, CONNECTIONS, INSPECTIONS, ETC.

PLANTING NOTES

- 1. THE CONTRACTOR SHALL SUPPLY PHOTOS OR SAMPLES OF EACH PLANT SPECIES INDICATED ON THE PLANTING LEGEND, TO LANDSCAPE ARCHITECT, TO SERVE AS MIN. REQUIREMENTS OF EACH SPECIES
- 2. THE CONTRACTOR SHALL OBTAIN AN AGRICULTURAL SOILS ANALYSIS BY AN APPROVED LAB FOR SOILS AMENDMENTS AND PLANTING MEDIA RECOMMENDATIONS. PROVIDE ONE COPY TO THE LANDSCAPE ARCHITECT FOR APPROVAL PRIOR TO INSTALLATION OF SOIL MIX.
- OTHERWISE NOTED ON THE DRAWINGS.
- 4. TREE MATERIAL SHALL BE PLANTED NO CLOSER THAN 5' FROM EXISTING OR PROPOSED UTILITIES, UNLESS OTHERWISE NOTED.

3. TREE MATERIAL SHALL BE PLANTED A MIN. OF 5' FROM WALKWAYS, STREETS, OR BUILDINGS UNLESS

- 5. THE CONTRACTOR SHALL STAKE ALL TREE LOCATIONS AND PLANTING BEDS, AND VERIFY LIMITS OF TURF IN THE FIELD FOR APPROVAL BY THE LANDSCAPE ARCHITECT PRIOR TO INSTALLATION.
- 6. EXISTING SOIL SHALL BE REMOVED FROM PLANTING HOLES, SEE SPECIFICATIONS FOR APPROPRIATE
- 7. STABILIZE SOIL BELOW ROOTBALL PRIOR TO PLANTING TO PREVENT TREE OR SHRUB FROM SETTLING.
- 8. THE CONTRACTOR IS RESPONSIBLE FOR FINE GRADING ANY AREAS DISTURBED BY CONSTRUCTION ON
- 9. CONTRACTOR TO REPAIR OR REPLACE ALL DISTURBED TURF AREAS FROM LANDSCAPE CONSTRUCTION OUTSIDE OF TURF LIMITS, WITHIN LIMIT OF WORK, WITH SOLID SOD OF MATCHING EXISTING SPECIES.
- 10. ALL PLANTING SHALL HAVE PERMANENT IRRIGATION AS PER IRRIGATION PLAN PROVIDED BY LICENSED IRRIGATOR. CONTRACTOR INSTALLING IRRIGATION SYSTEM WILL PROVIDE AS BUILT DRAWINGS NOTING ANY CHANGES TO THE DESIGN DURING INSTALLATION. ALL WORK SHALL BE INSTALLED IN ACCORDANCE WITH APPLICABLE LOCAL CODES AND REQUIREMENTS.
- 11. THE NUMBER OF TREE POINTS RETAINED AND REPLACED ON SITE EXCEEDS THE NUMBER REMOVED AS DEFINED BY THE CITY OF FORT WORTH URBAN FORESTRY REQUIREMENTS.


CLEARING NOTES

- 1. THE CONTRACTOR SHALL VERIFY THE LOCATION OF ALL DESIGNATED CLEARING AREAS, TREES, AND SHRUBS WITH THE LANDSCAPE ARCHITECT PRIOR TO CLEARING ACTIVITIES.
- 2. THE CONTRACTOR SHALL REMOVE ONLY THOSE TREES AND SHRUBS WITHIN THE CLEARING AREAS DESIGNATED BY THE LANDSCAPE ARCHITECT.
- 3. THE CONTRACTOR SHALL COMPLETELY REMOVE STUMPS, ROOTS AND OTHER DEBRIS PROTRUDING THROUGH THE GROUND SURFACE TO A MINIMUM DEPTH OF 12".
- 4. THE CONTRACTOR SHALL REMOVE ALL SURFACE ROCKS, DEAD AND DELETERIOUS MATERIAL, AND TRASH FROM CONSTRUCTION AREA.
- 5. ANY PROTECTED TREE THAT IS DAMAGED OR REMOVED PRIOR TO CLIENT APPROVAL SHALL BE MITIGATED PER THE GOVERNING AGENCIES REQUIREMENTS BY THE CONTRACTOR AT NO ADDITIONAL COST TO THE CLIENT.
- 6. ALL TREES ARE TO REMAIN UNLESS OTHERWISE NOTED. EXTREME CAUTION AND CARE IS TO BE TAKEN WHEN INSTALLING PROPOSED IMPROVEMENTS AROUND TREES.

ABBREVIATIONS:

ABBREVIATION	EXTENSION
ADA	AMERICANS WITH DISABILITIES
ADJ	ADJACENT
ARCH	ARCHITECTURE
BC	BOTTOM OF CURB
BS	BOTTOM OF STEP
BW	BOTTOM OF WALL
CAD	COMPUTER AIDED DESIGN
CIP	CAST-IN-PLACE (CONCRETE APPLICATIONS)
CL	CIVIL CENTERLINE
CLS	
CLS	CENTER LINE OF SWALE CLEAR
CMU	CONCRETE MASONRY UNIT
CONC.	CONCRETE
CJ	CONTROL JOINT
DIA.	DIAMETER (LAYOUT, MEASUREMENT)
EJ	EXPANSION JOINT
EQ	EQUAL (LAYOUT, MEASUREMENT)
EXT	EXTERIOR
FOB	FACE OF BUILDING
FG	FINISHED GRADE (TOP OF SOIL GRADIENT)
FS	FINISHED SURFACE (HARD SURFACES)
GALV	GALVANIZED
GEOTECH	GEOTECHNICAL ENGINEER
GPH	GALLONS PER HOUR (IRRIGATION)
GPM	GALLONS PER MINUTE (IRRIGATION)
HEX.	HEXAGONAL
HP	HIGH POINT (GRADIENT)
HSS	HOLLOW STRUCTURAL SECTION
IE	INVERT ELEVATION
LA	LANDSCAPE ARCHITECT
LED LOW	LIGHT EMITTING DIODE (ELECTRICAL FIXTURE)
LOW LP	LIMIT OF WORK
MAX.	LOW POINT (GRADIENT)
MIN.	MAXIMUM
NAP	MINIMUM
O.C.	NOT A PART
O.D.	ON CENTER (LAYOUT, MEASUREMENT)
PA	OUTSIDE DIAMETER (LAYOUT, MEASUREMENT)
PERF	PLANTING AREA
POB	RERFORATED
PL	POINT OF BEGINNING
PSI	PROPERTY LINE
PT	POUNDS PER SQUARE INCH (IRRIGATION) PRESSURE TREATED
R	RADIUS
REF	REFERENCE OR REFER TO
REINF.	REINFORCEMENT
SE	STRUCTURAL ENGINEER
SPECS S.S.	CONTRACT SPECIFICATIONS
TBD	STRUCTURAL ENGINEER
TC	TO BE DETERMINED
TG	TOP OF CURB
TS	TOP OF GRATE
TW	TOP OF STEP
TYP.	TOP OF WALL
W/	TYPICAL
'	WITH

LEGEND

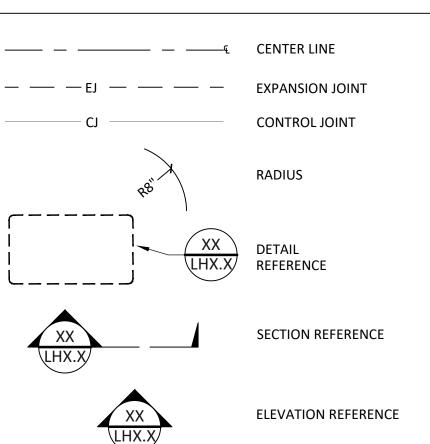


STRAND

10003 TECHNOLOGY BLVD. WEST DALLAS, TX. 75220 972-620-8204 REGISTRATION NO: F-1629

CLIENT INFO

DHI COMMUNITIES 5419 NORTH LOOP 1604 EAST, SAN ANTONIO, TX 78247

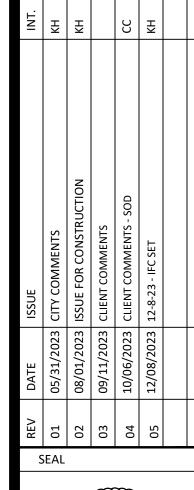

01/26/2024

CEND ON JUNO LANDIN

SCALE: AS SHOWN

DATE: 12/08/2023
DRWN: STRAND

STRAND


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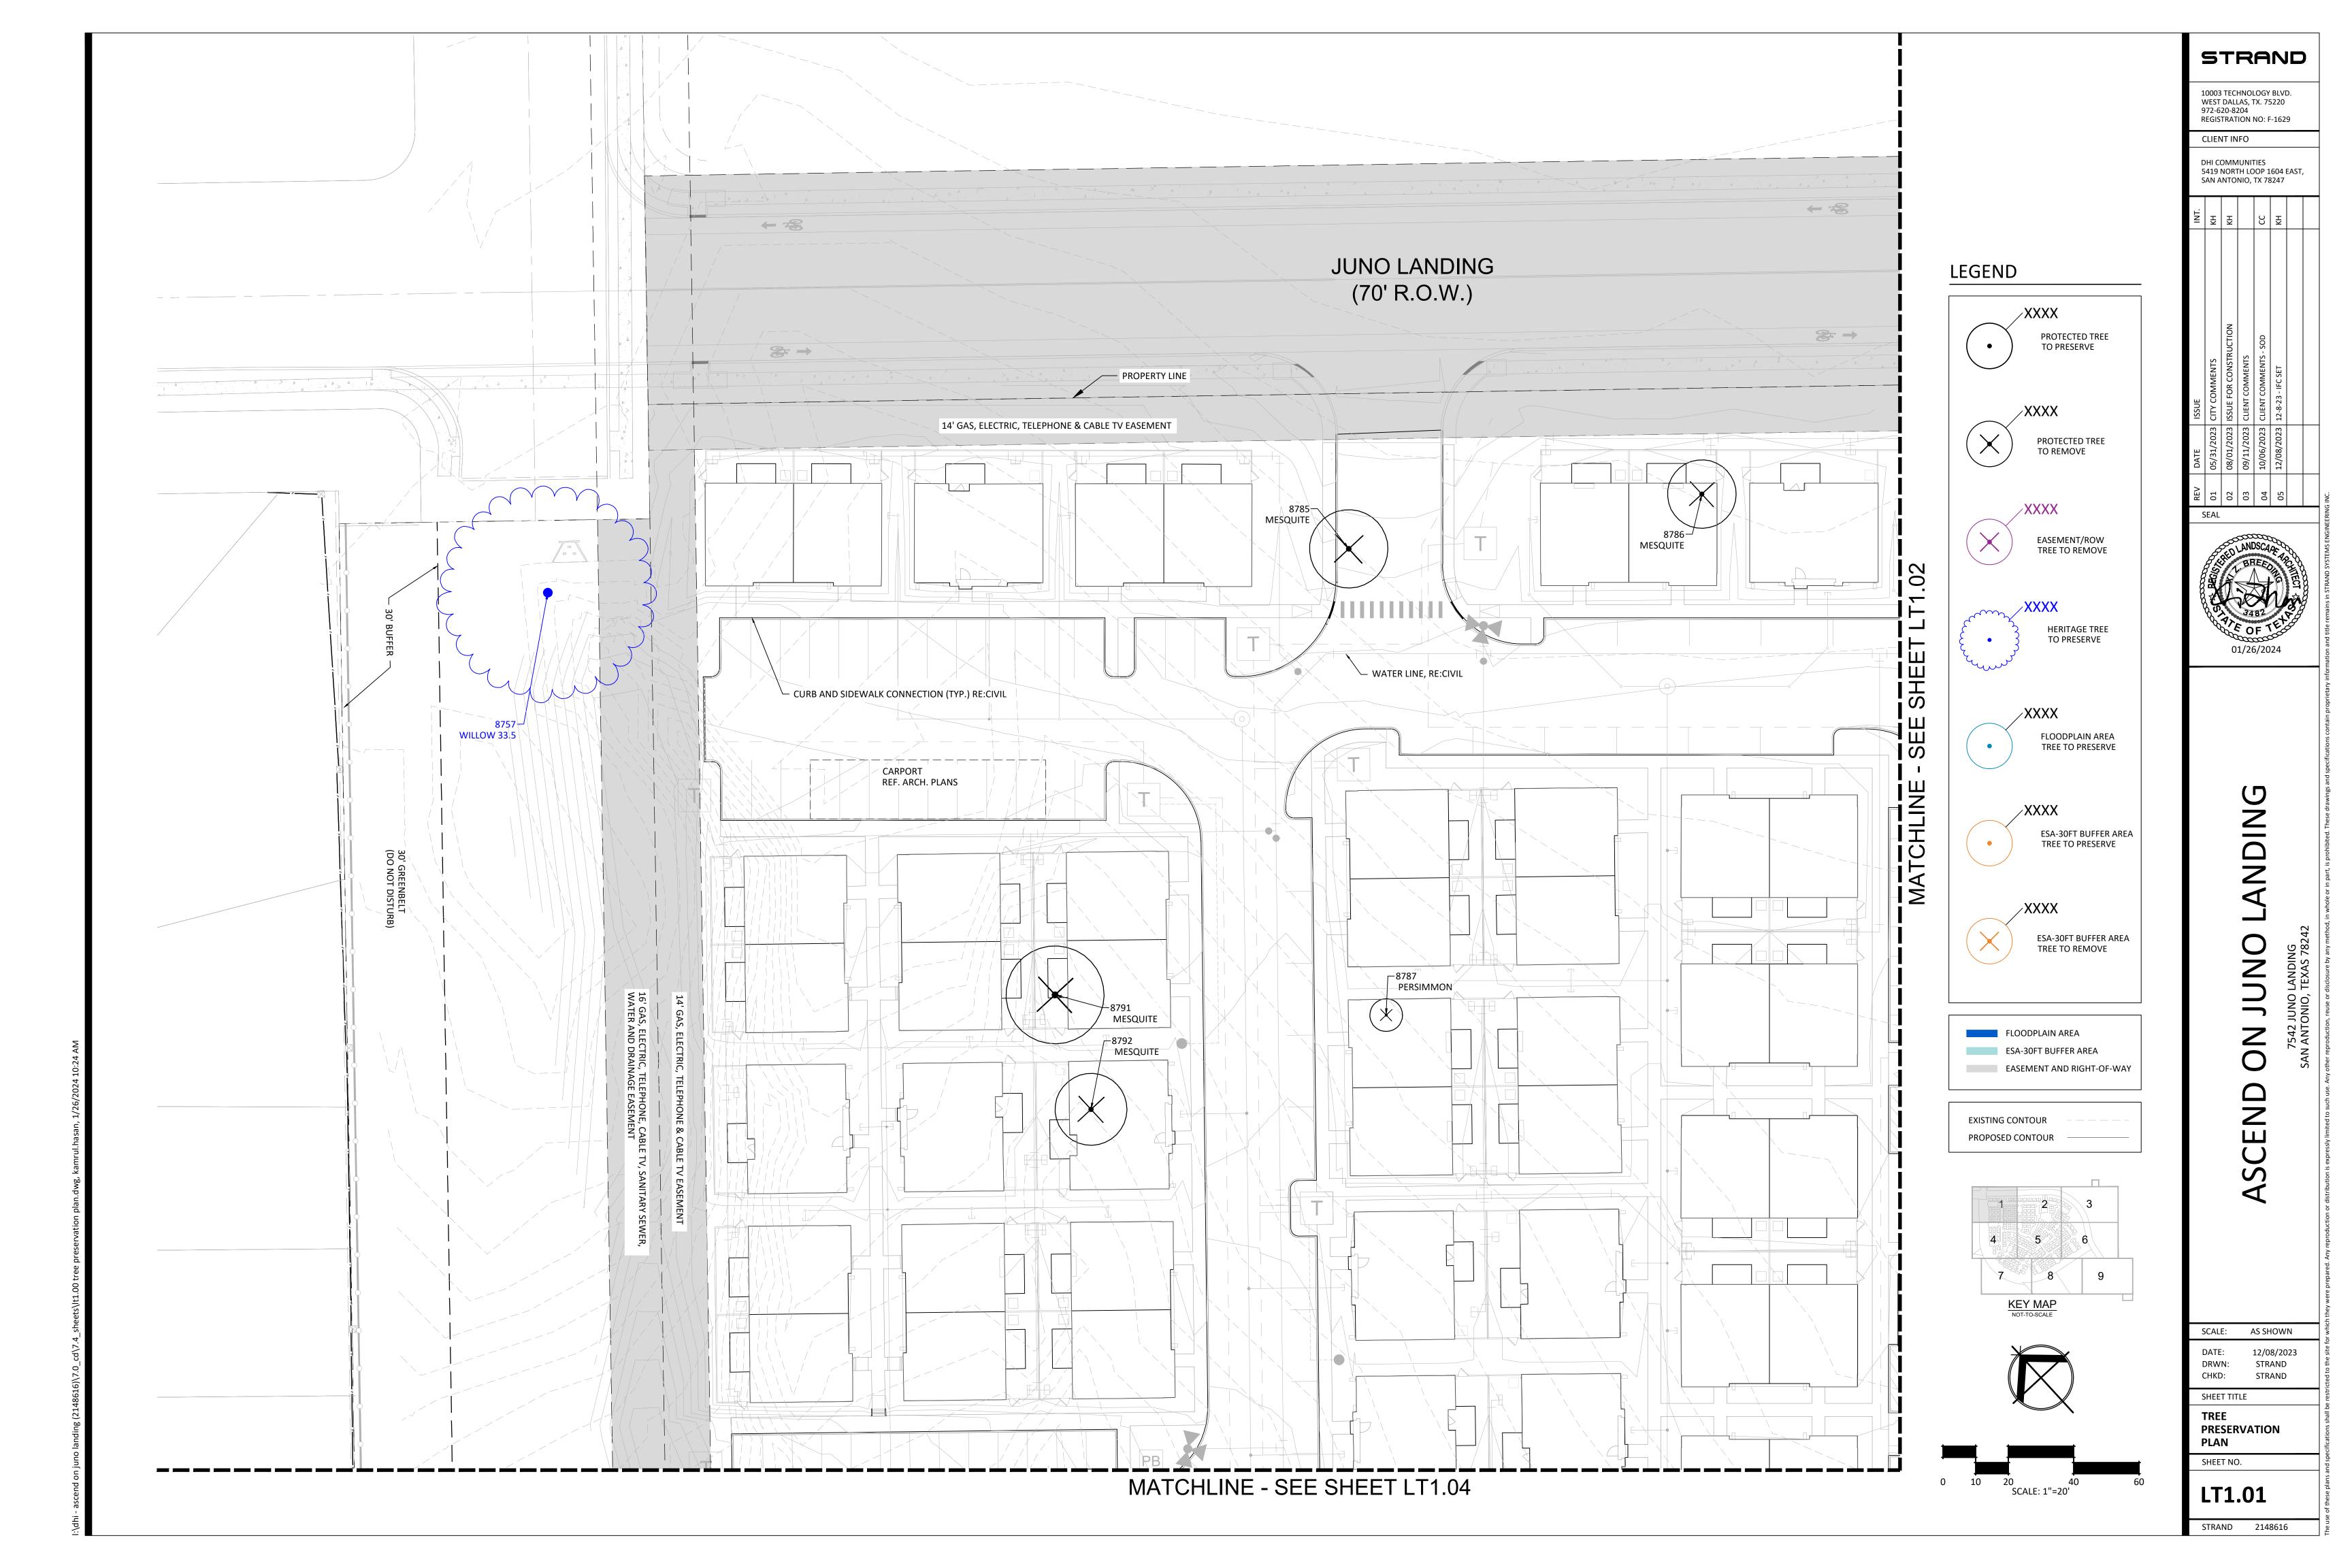
GENERAL NOTES


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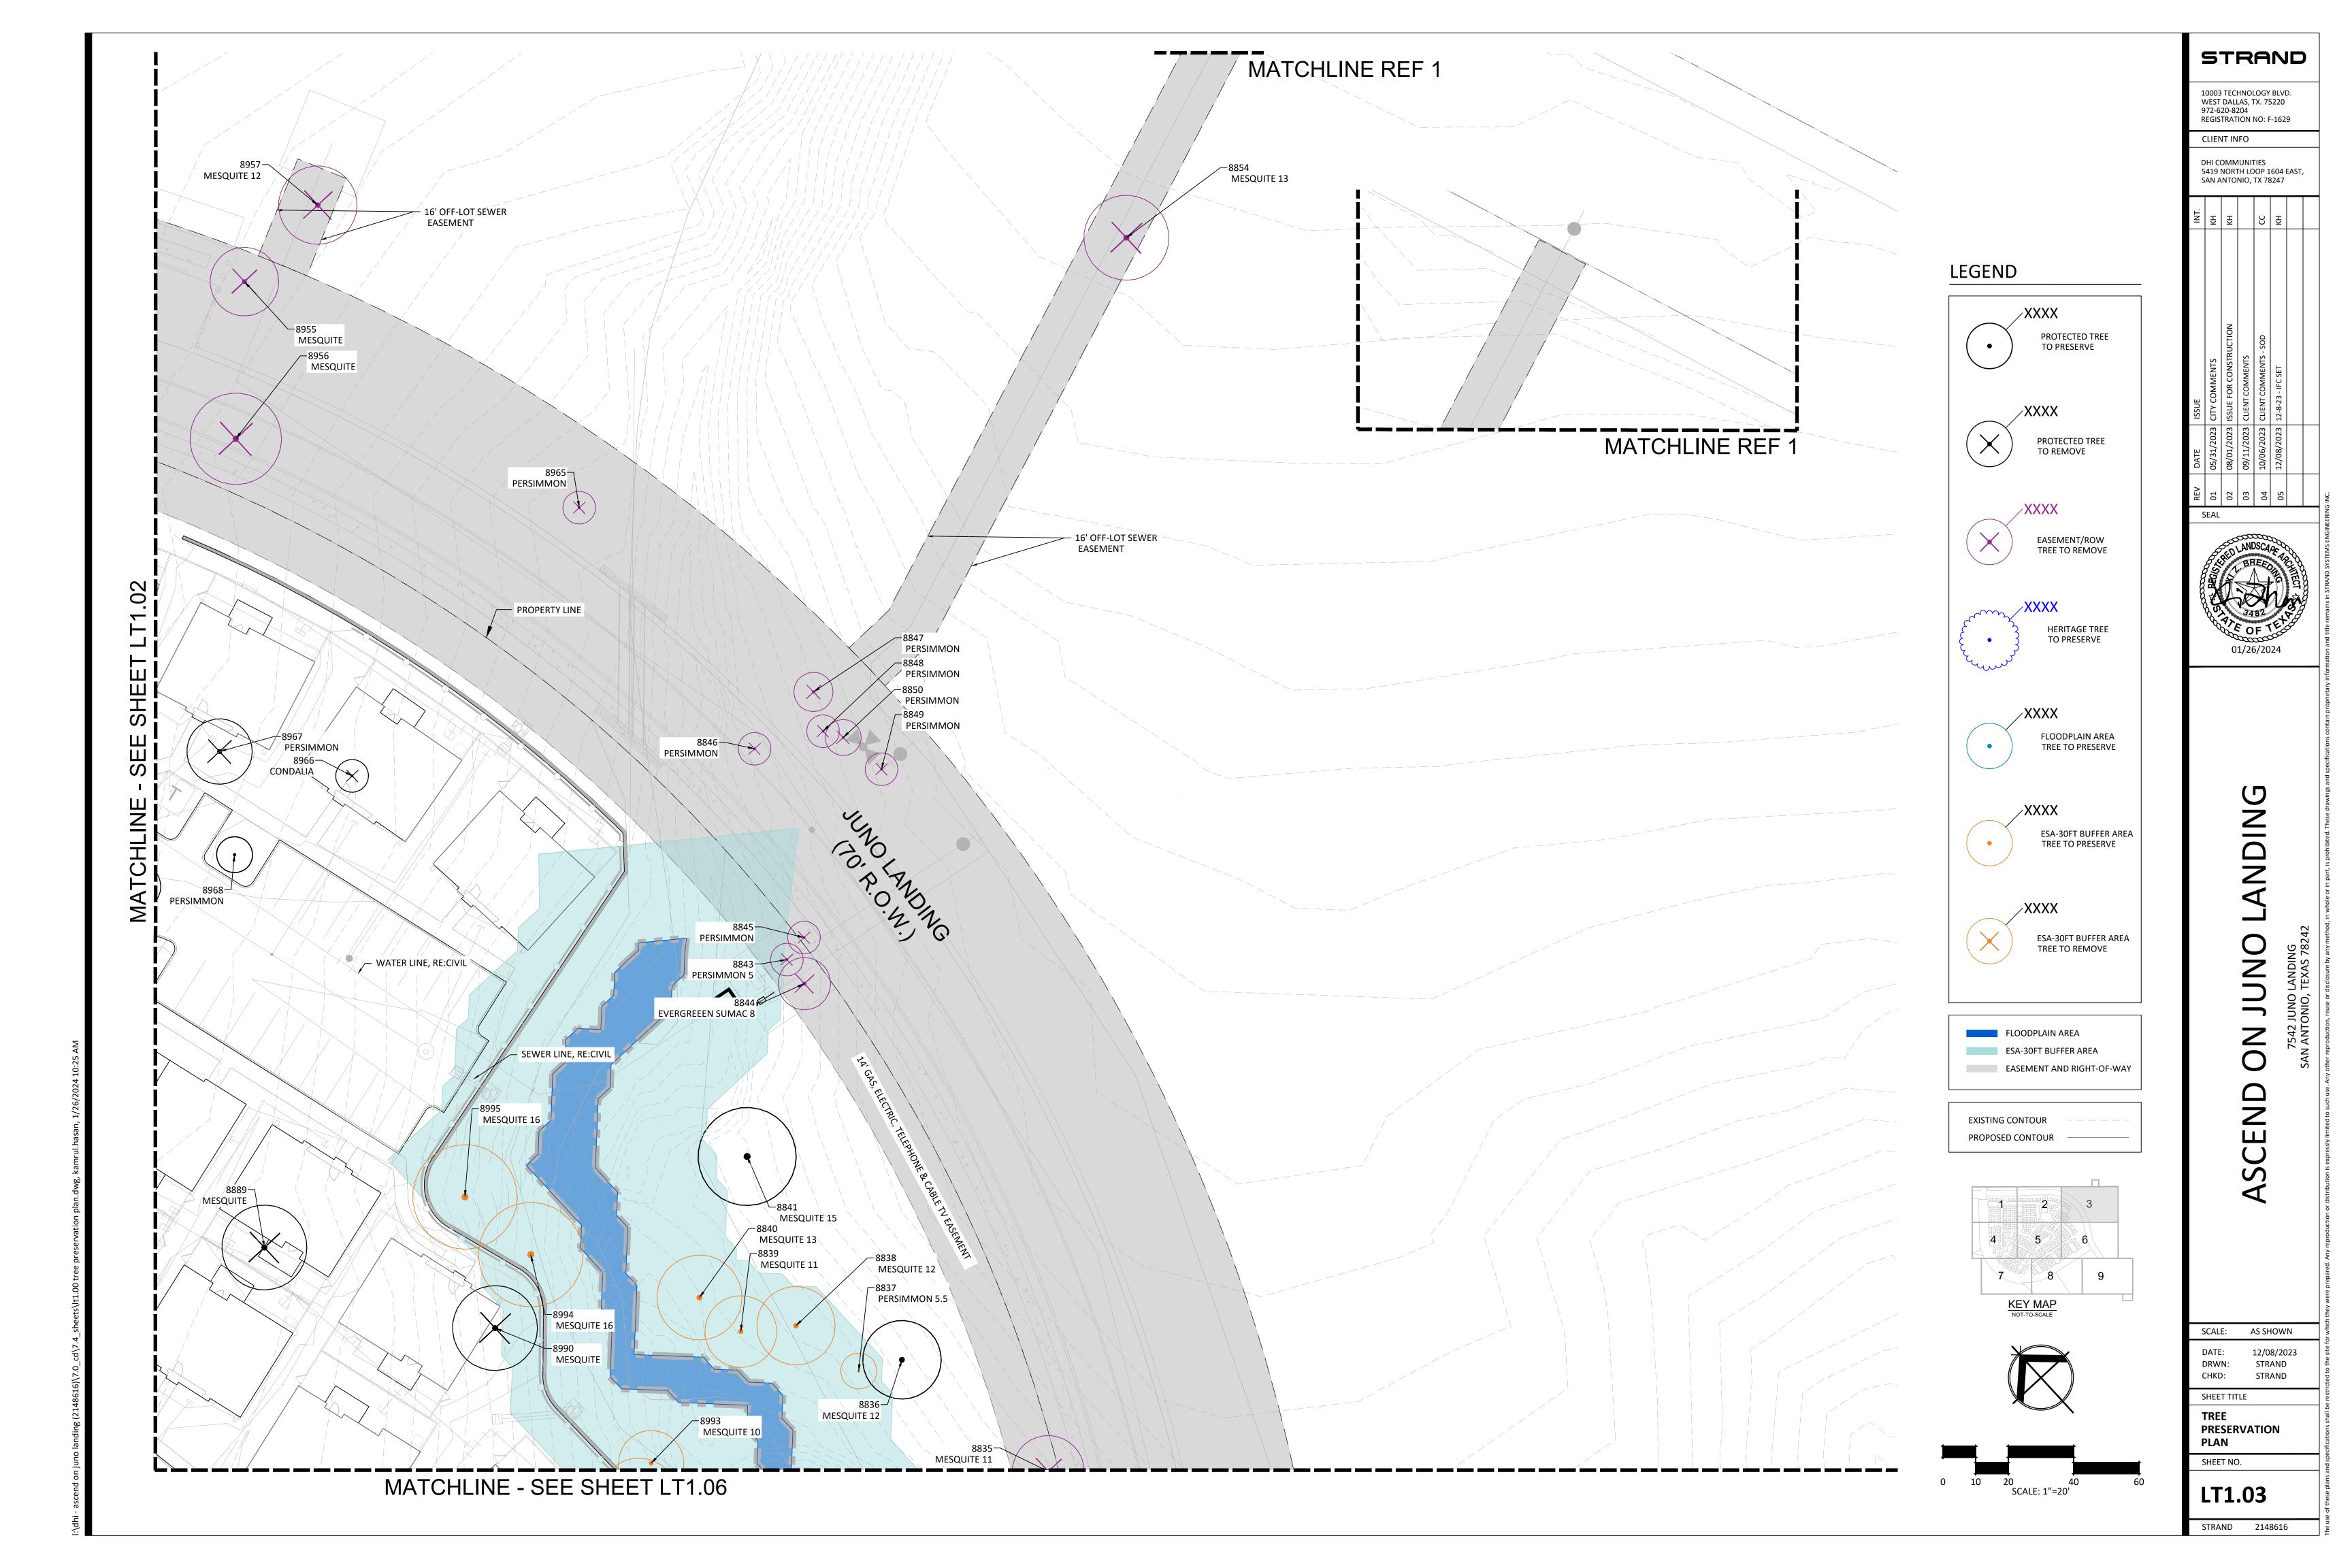
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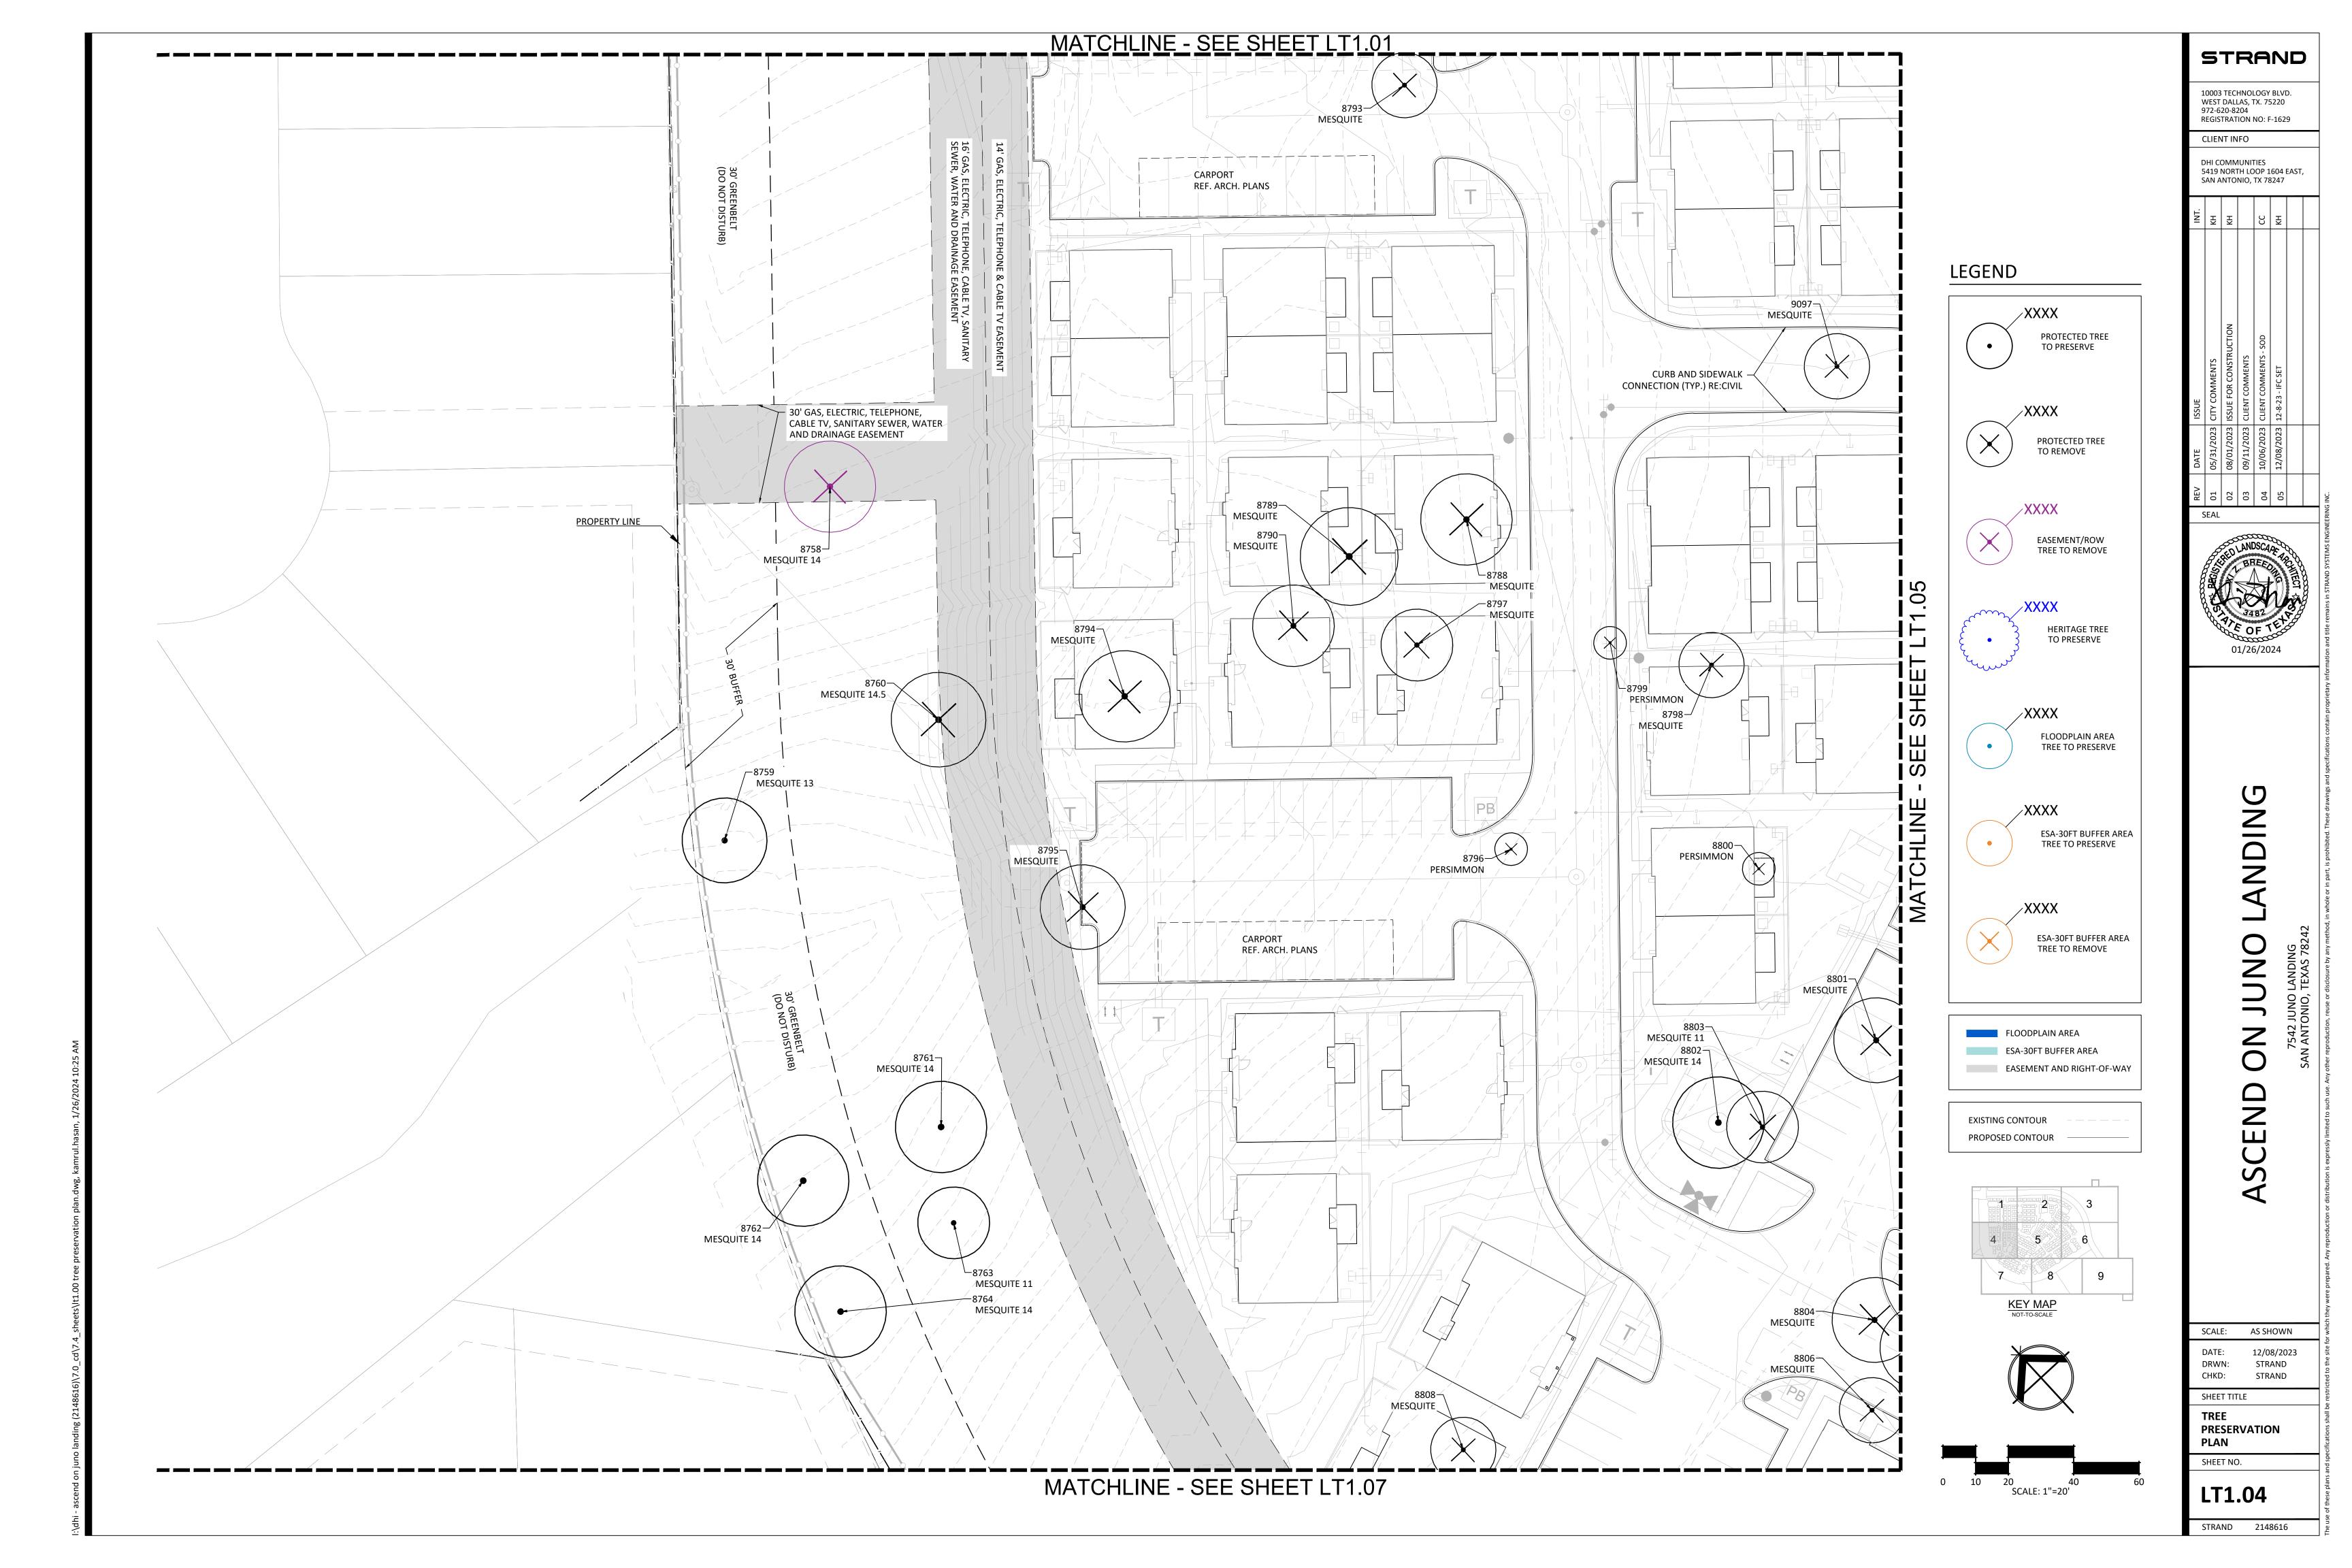











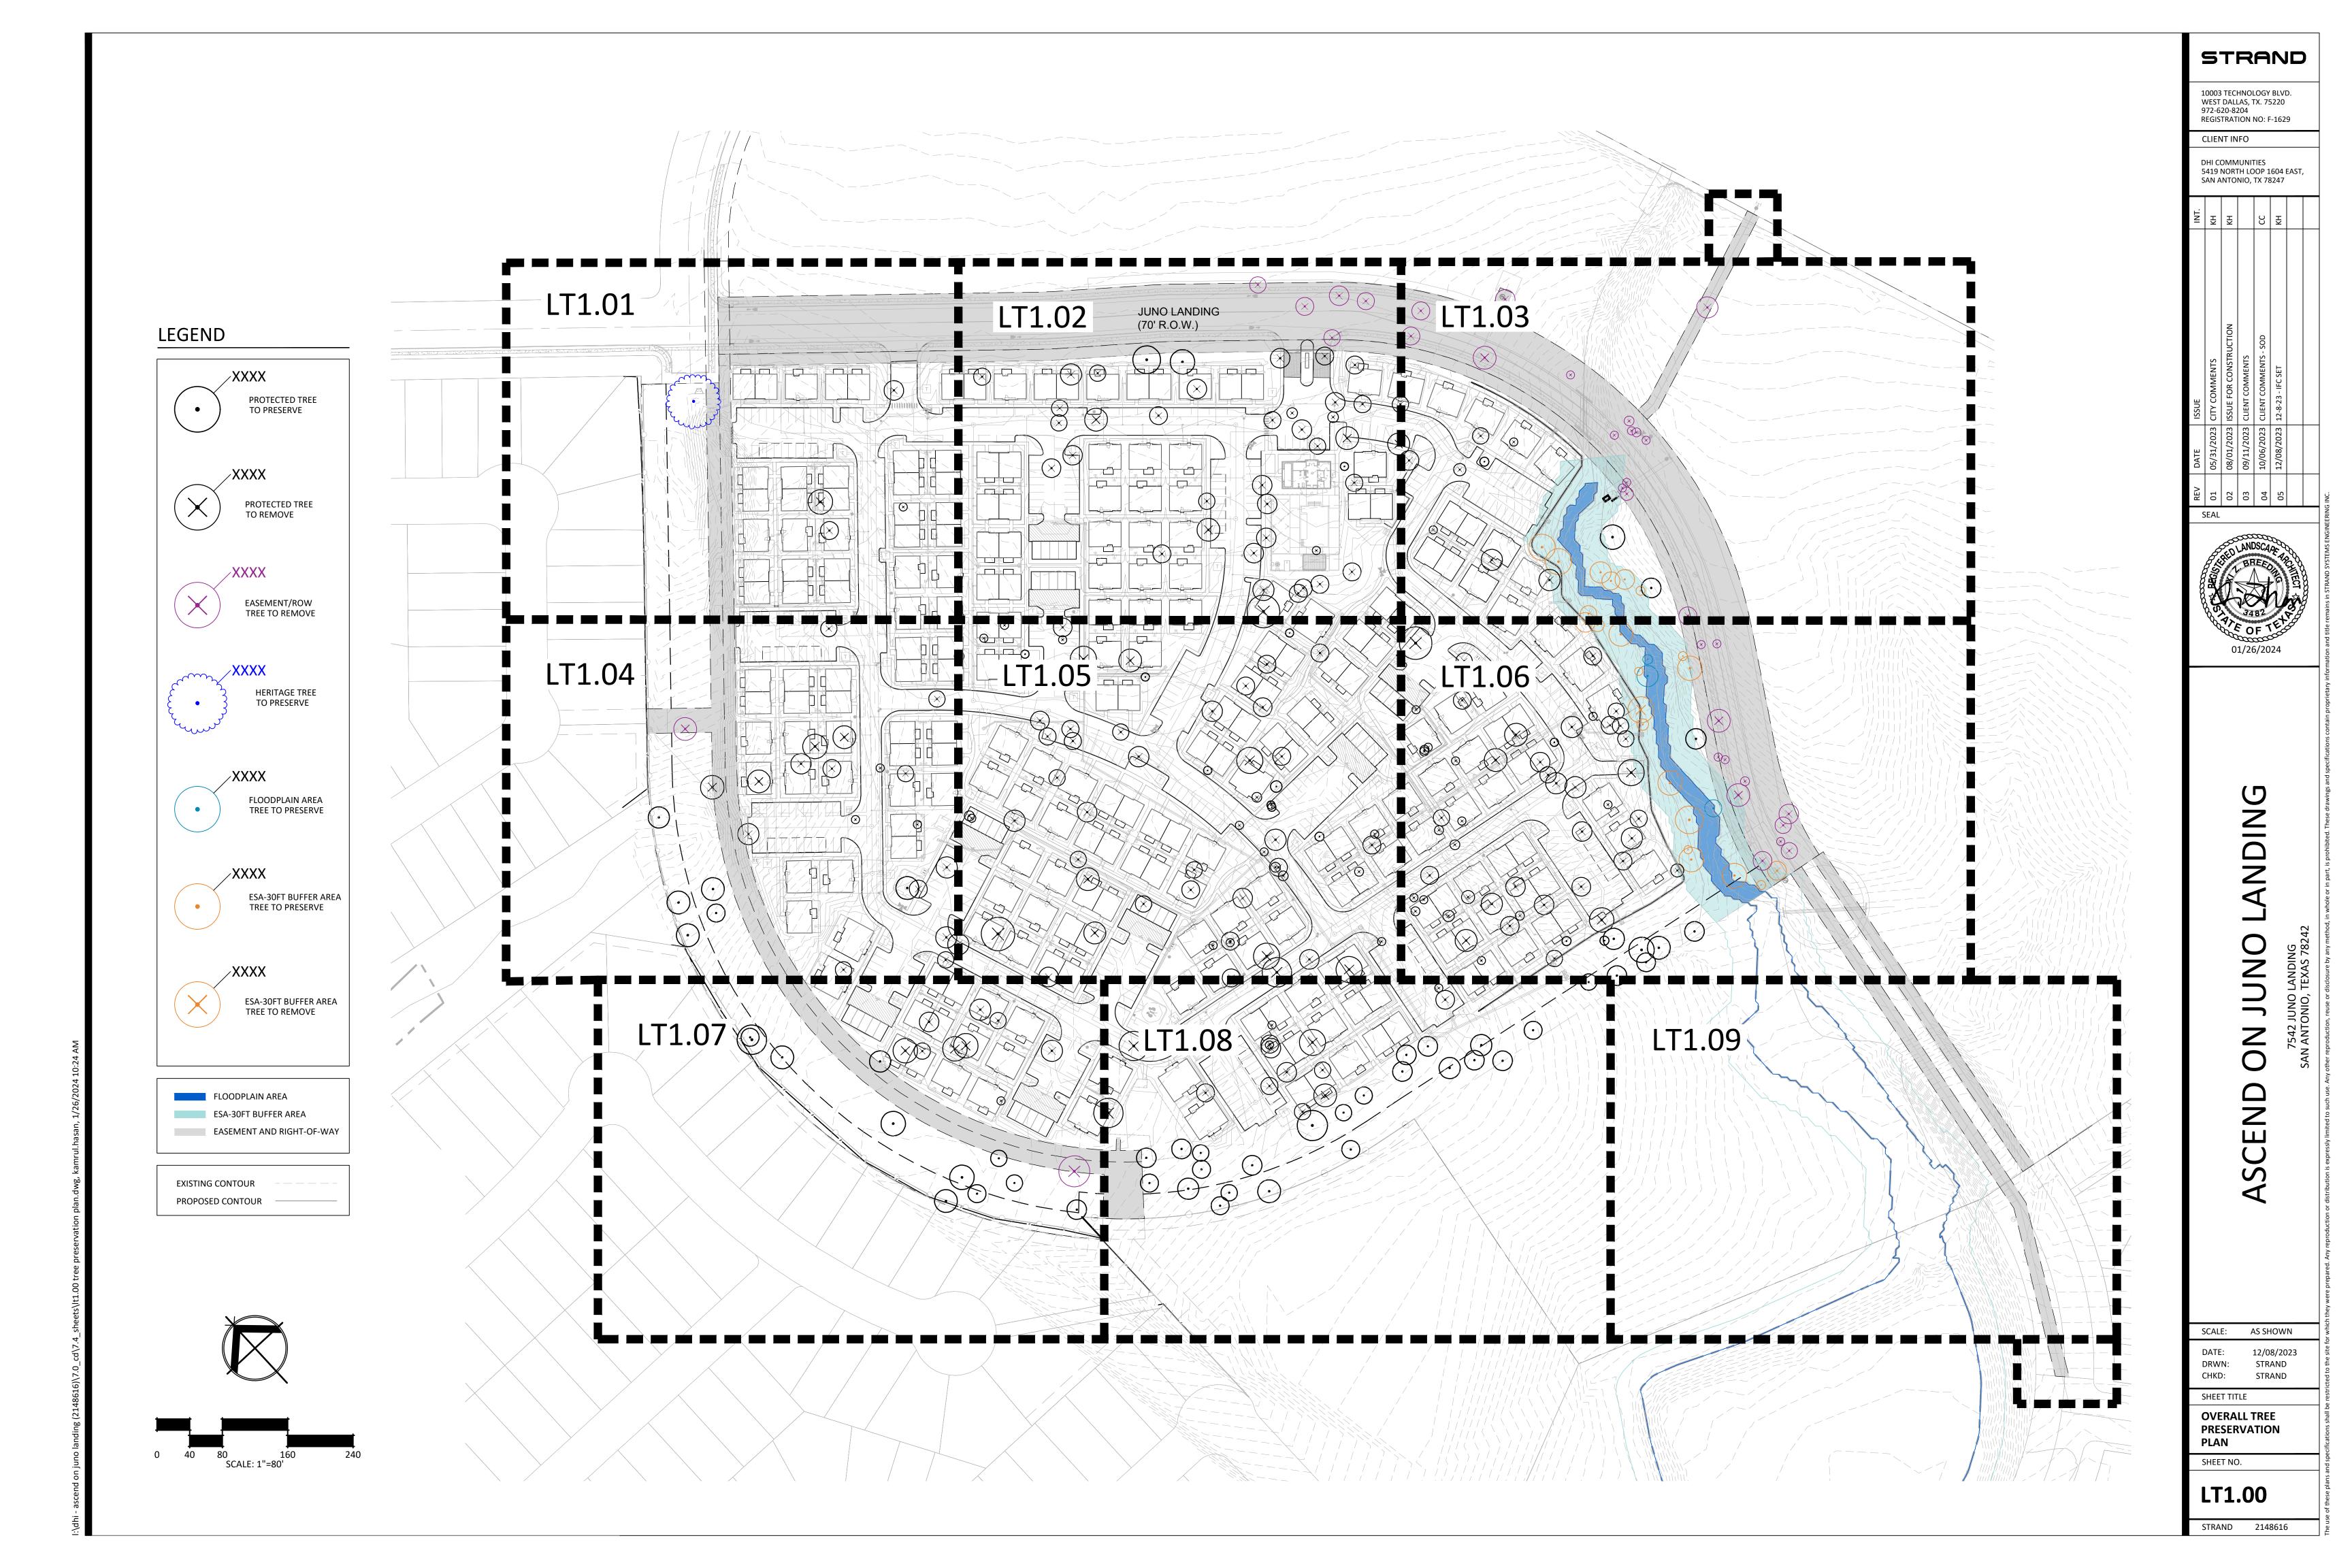


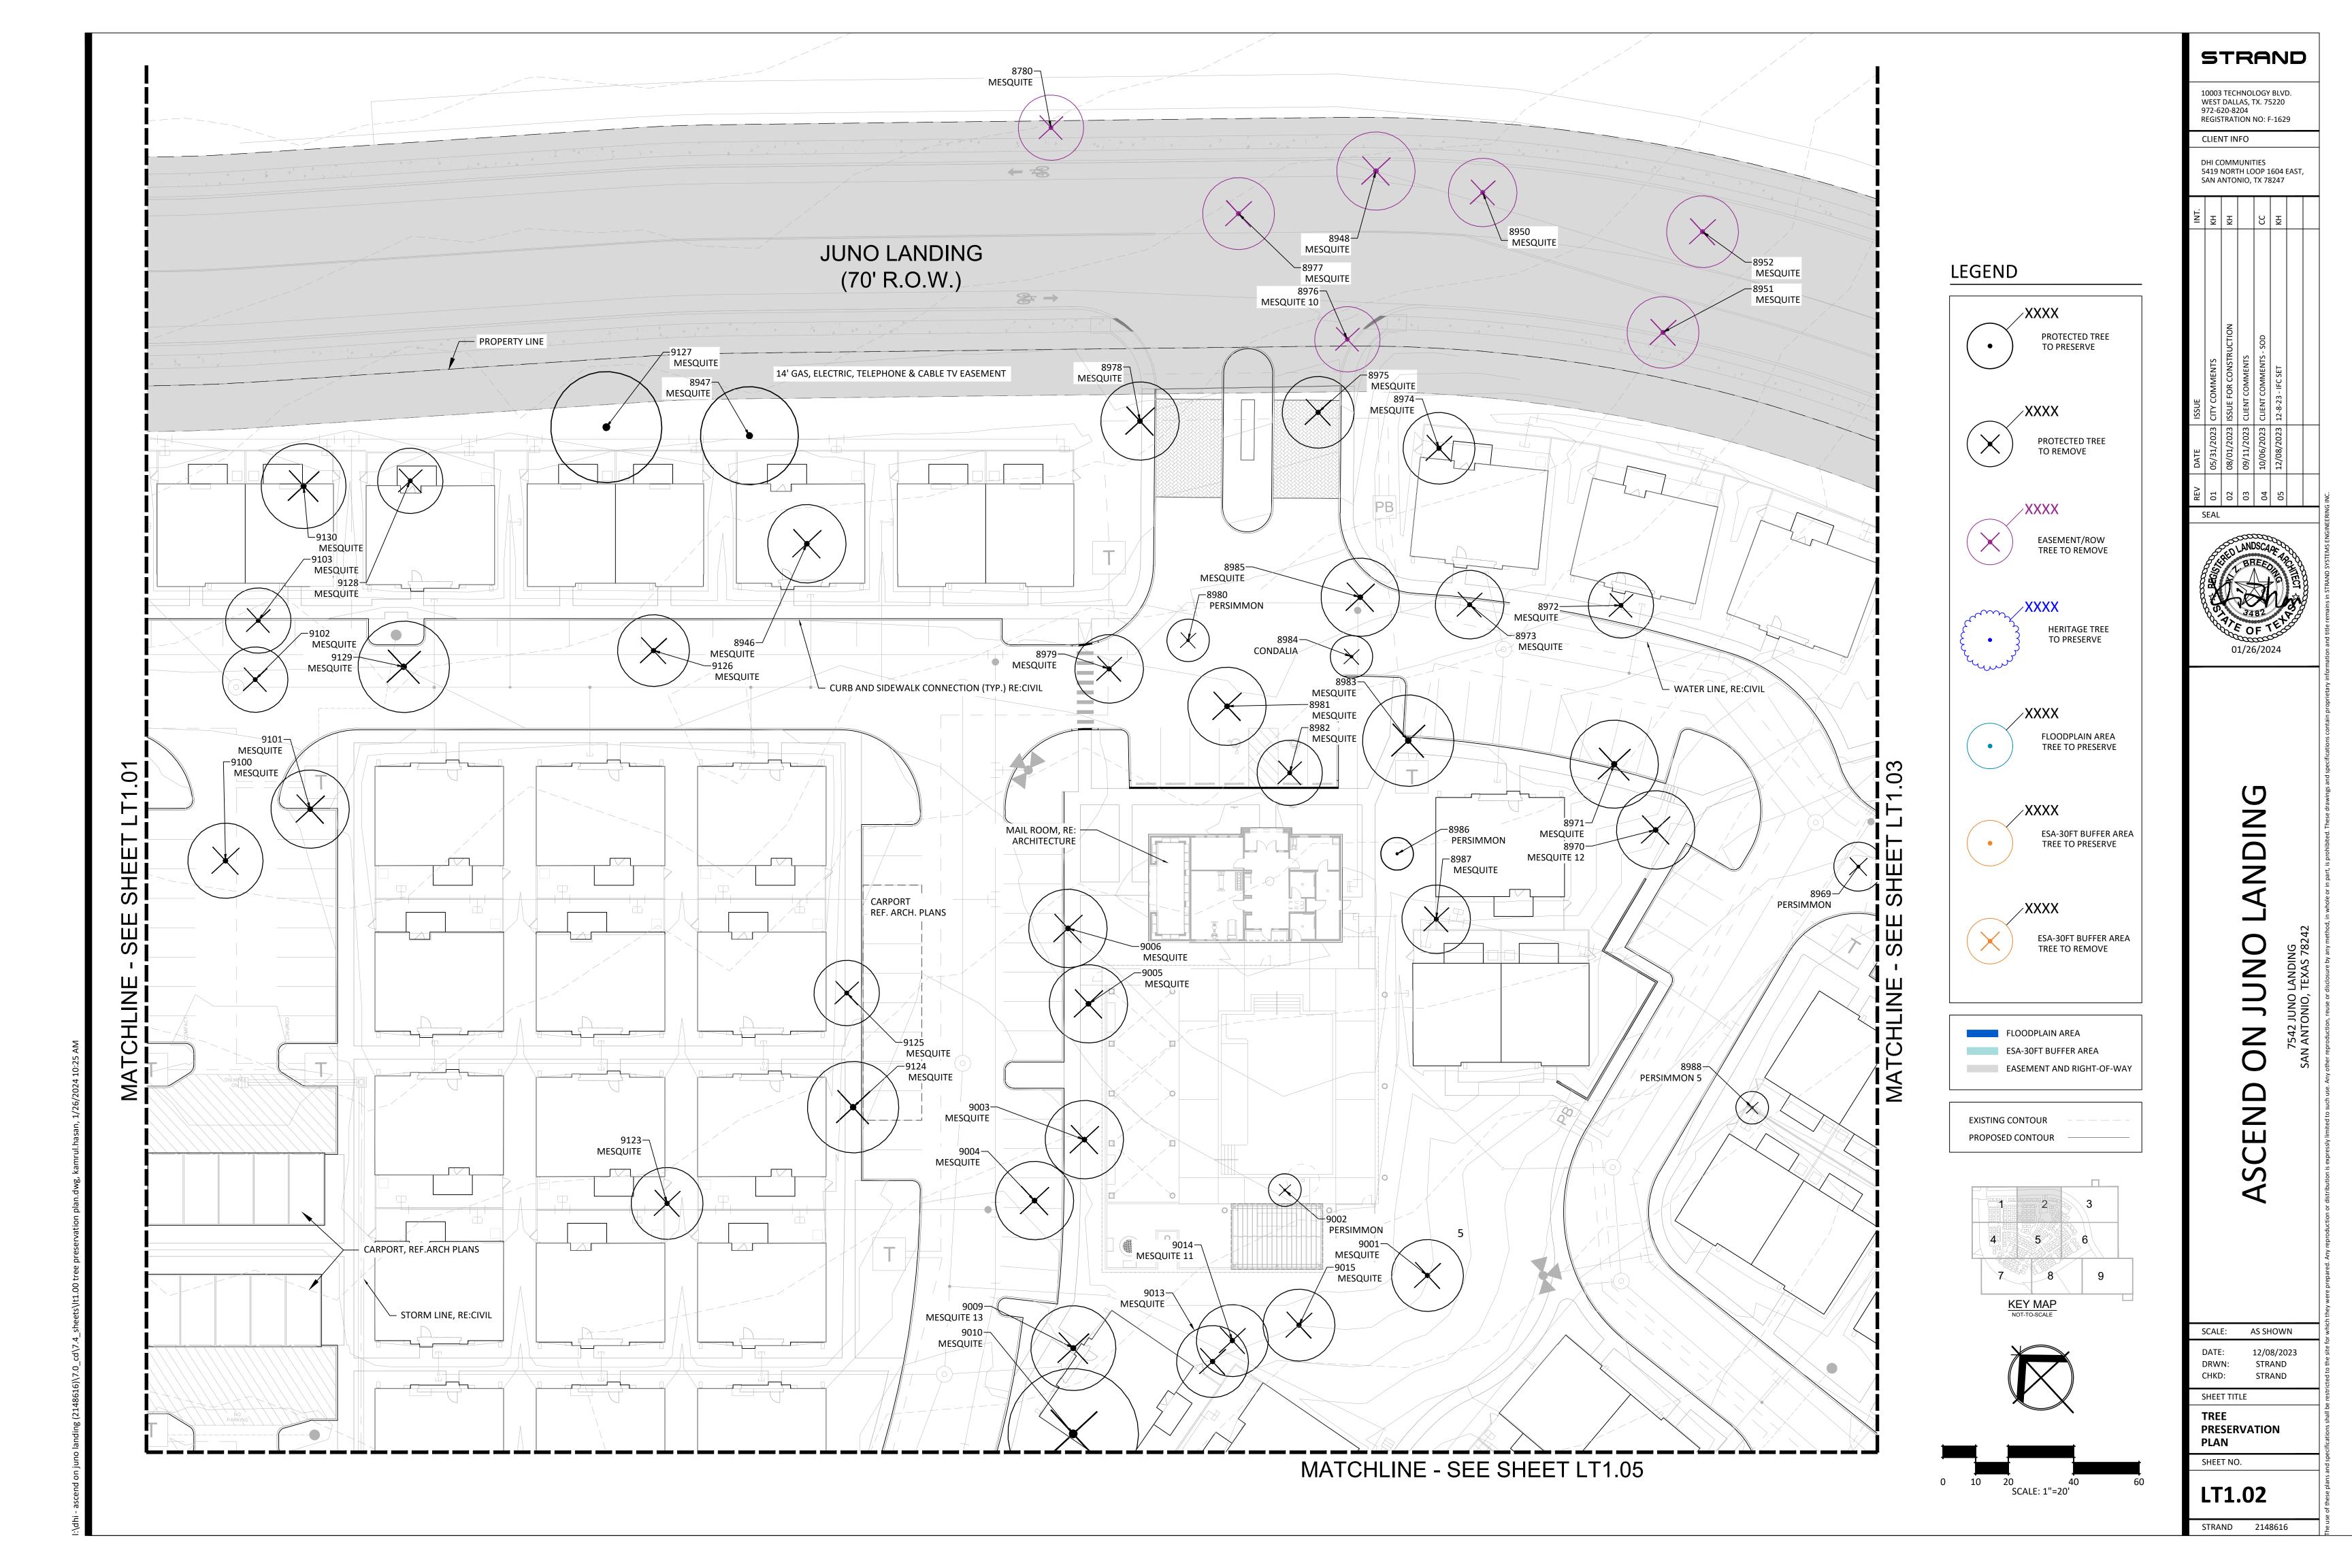


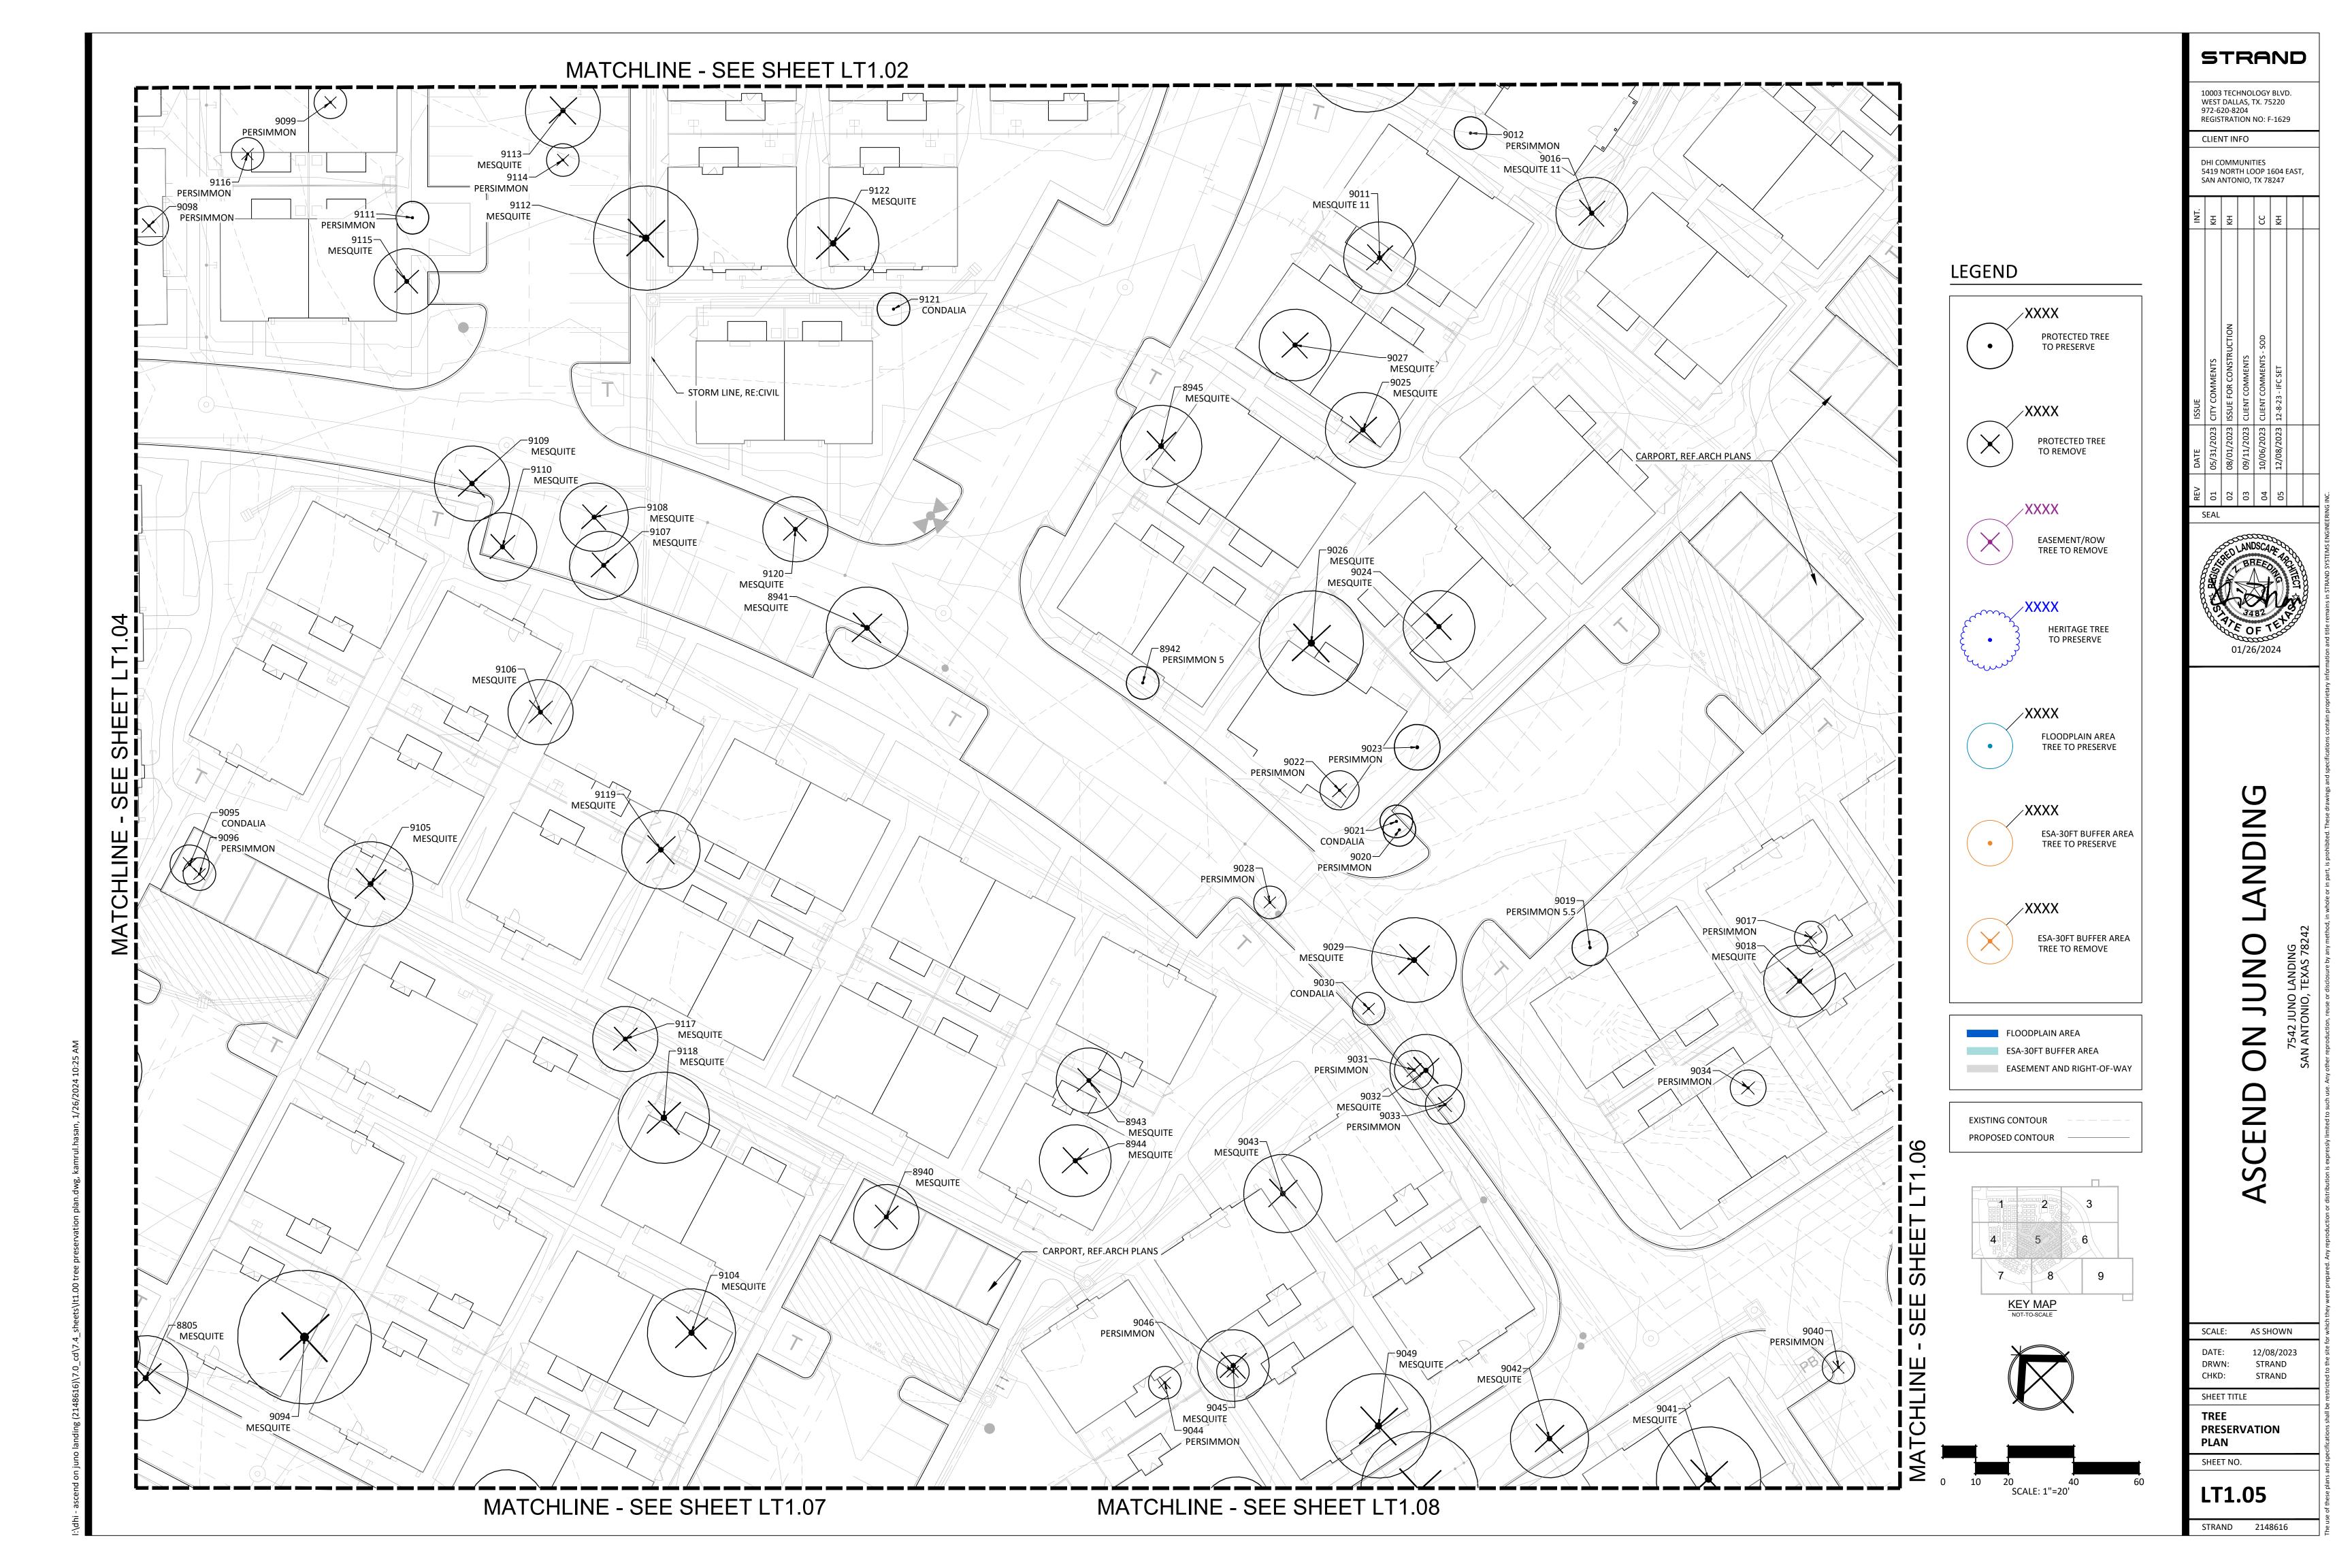

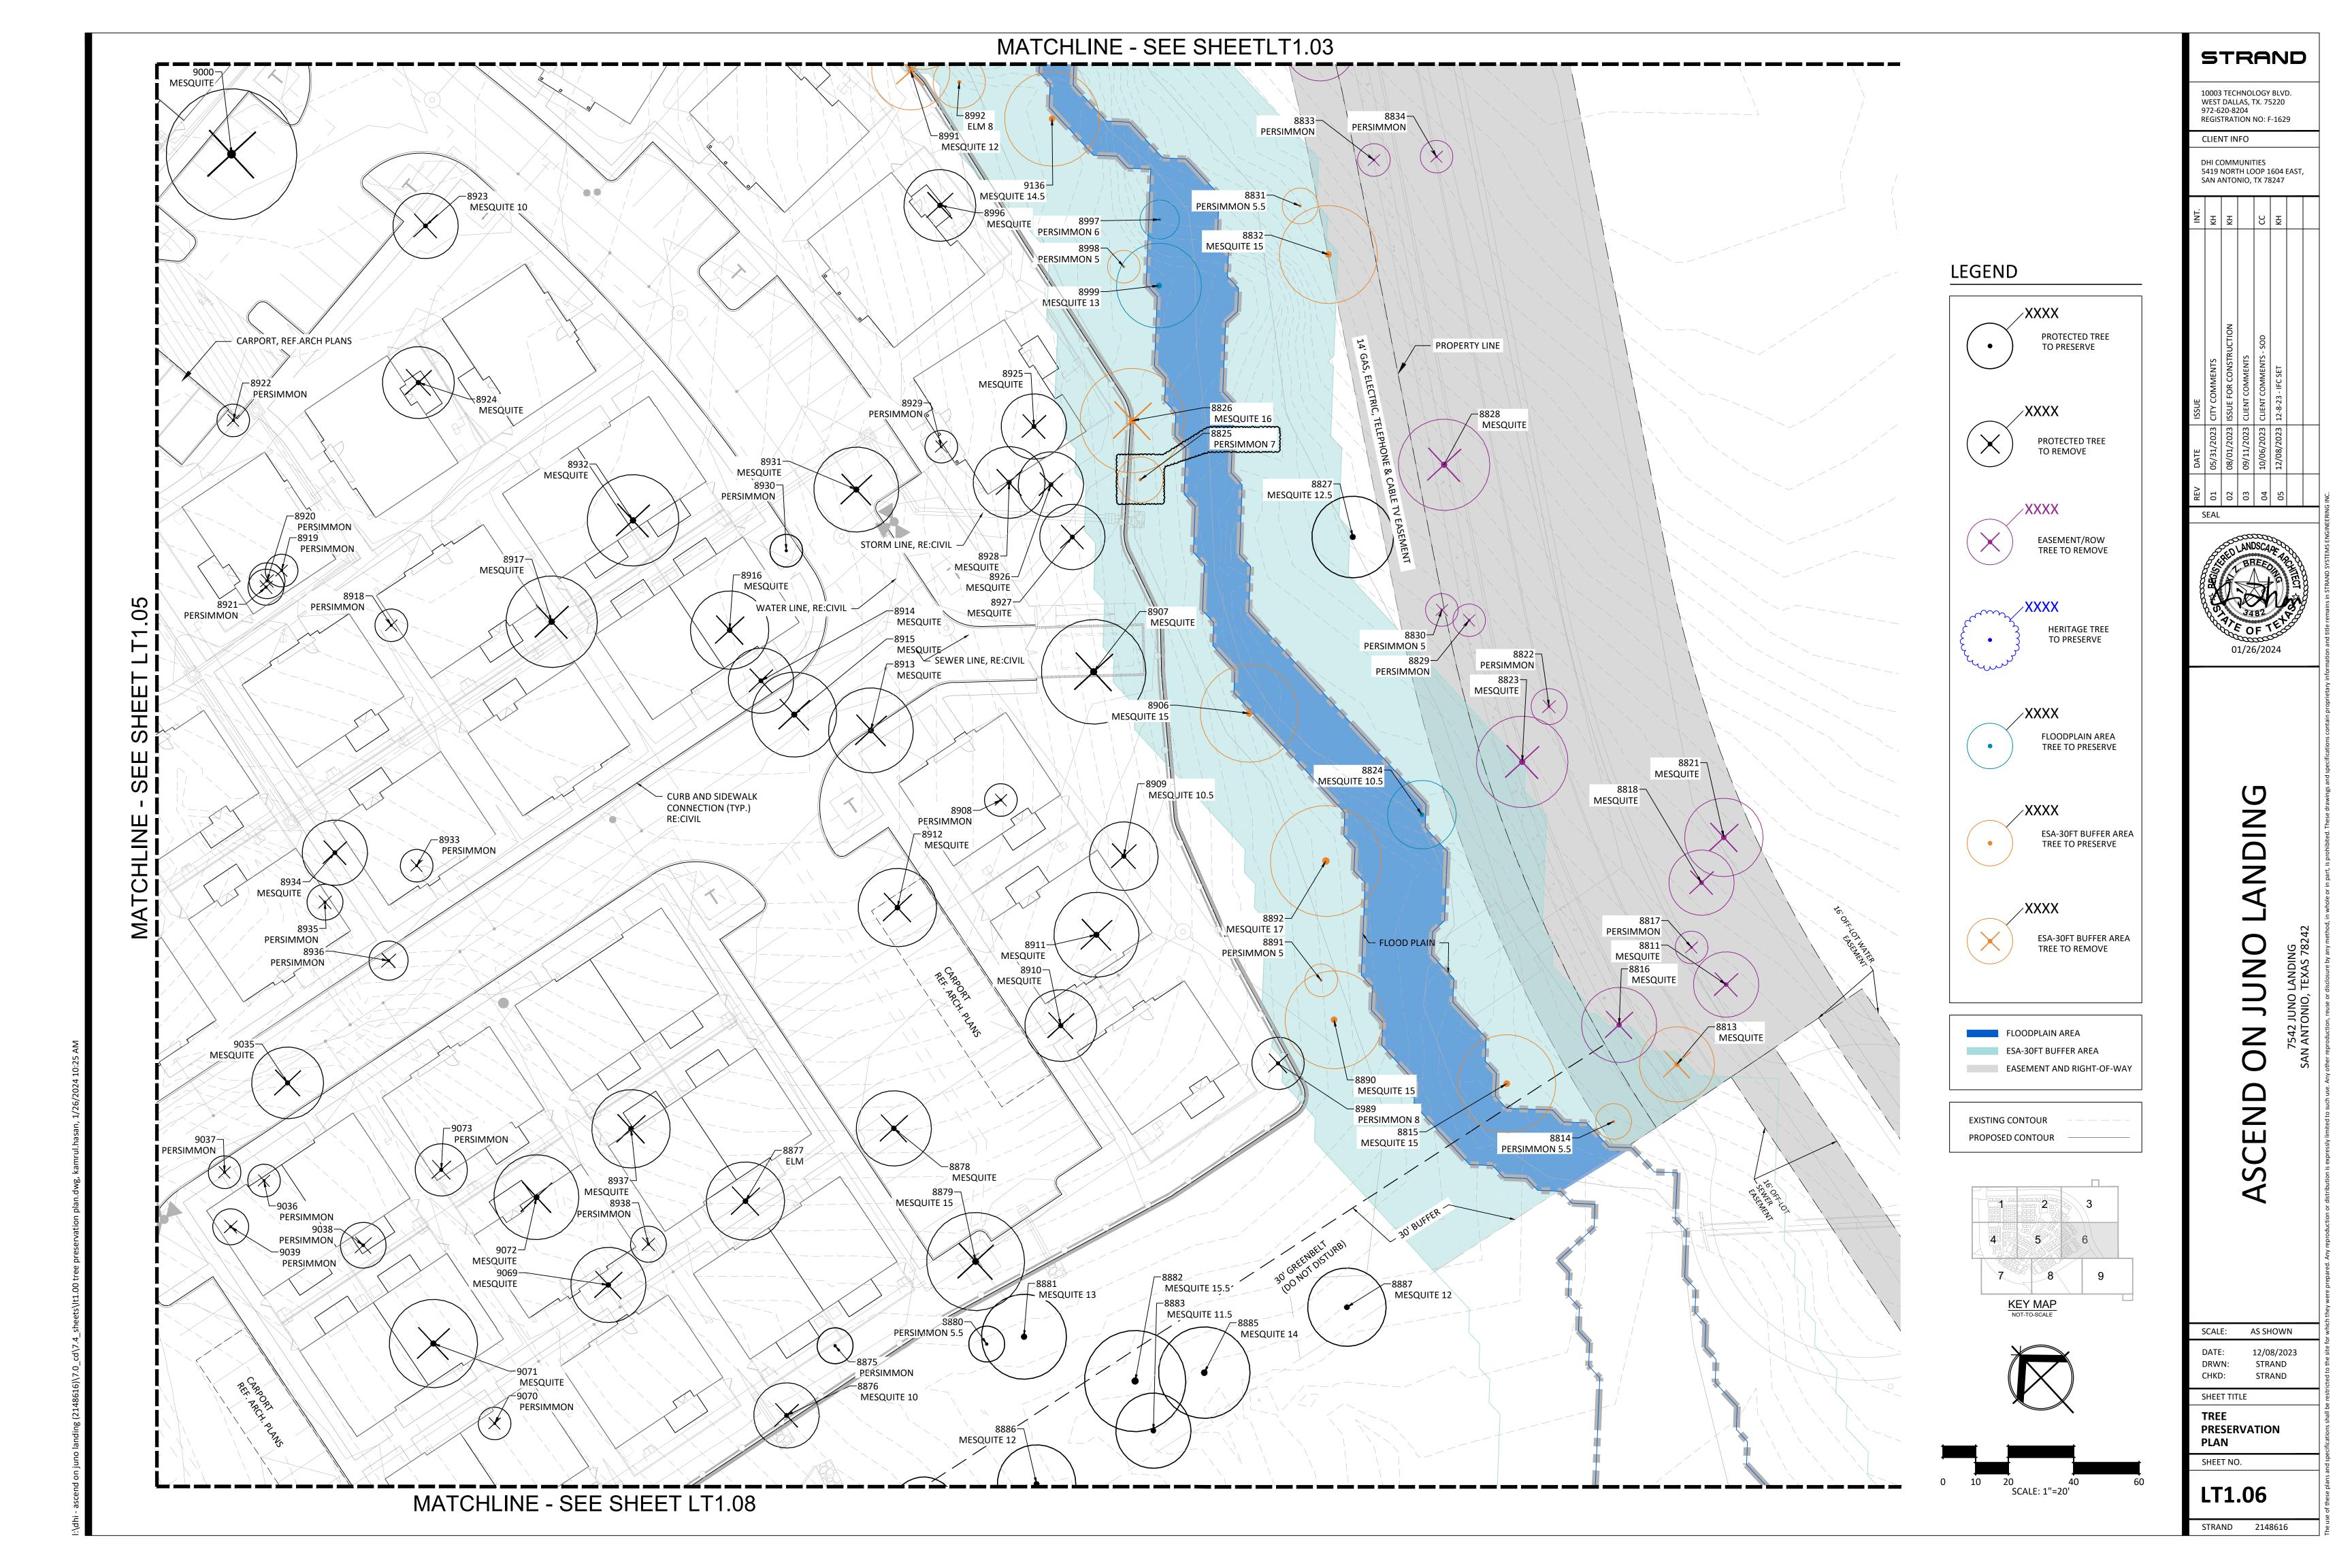

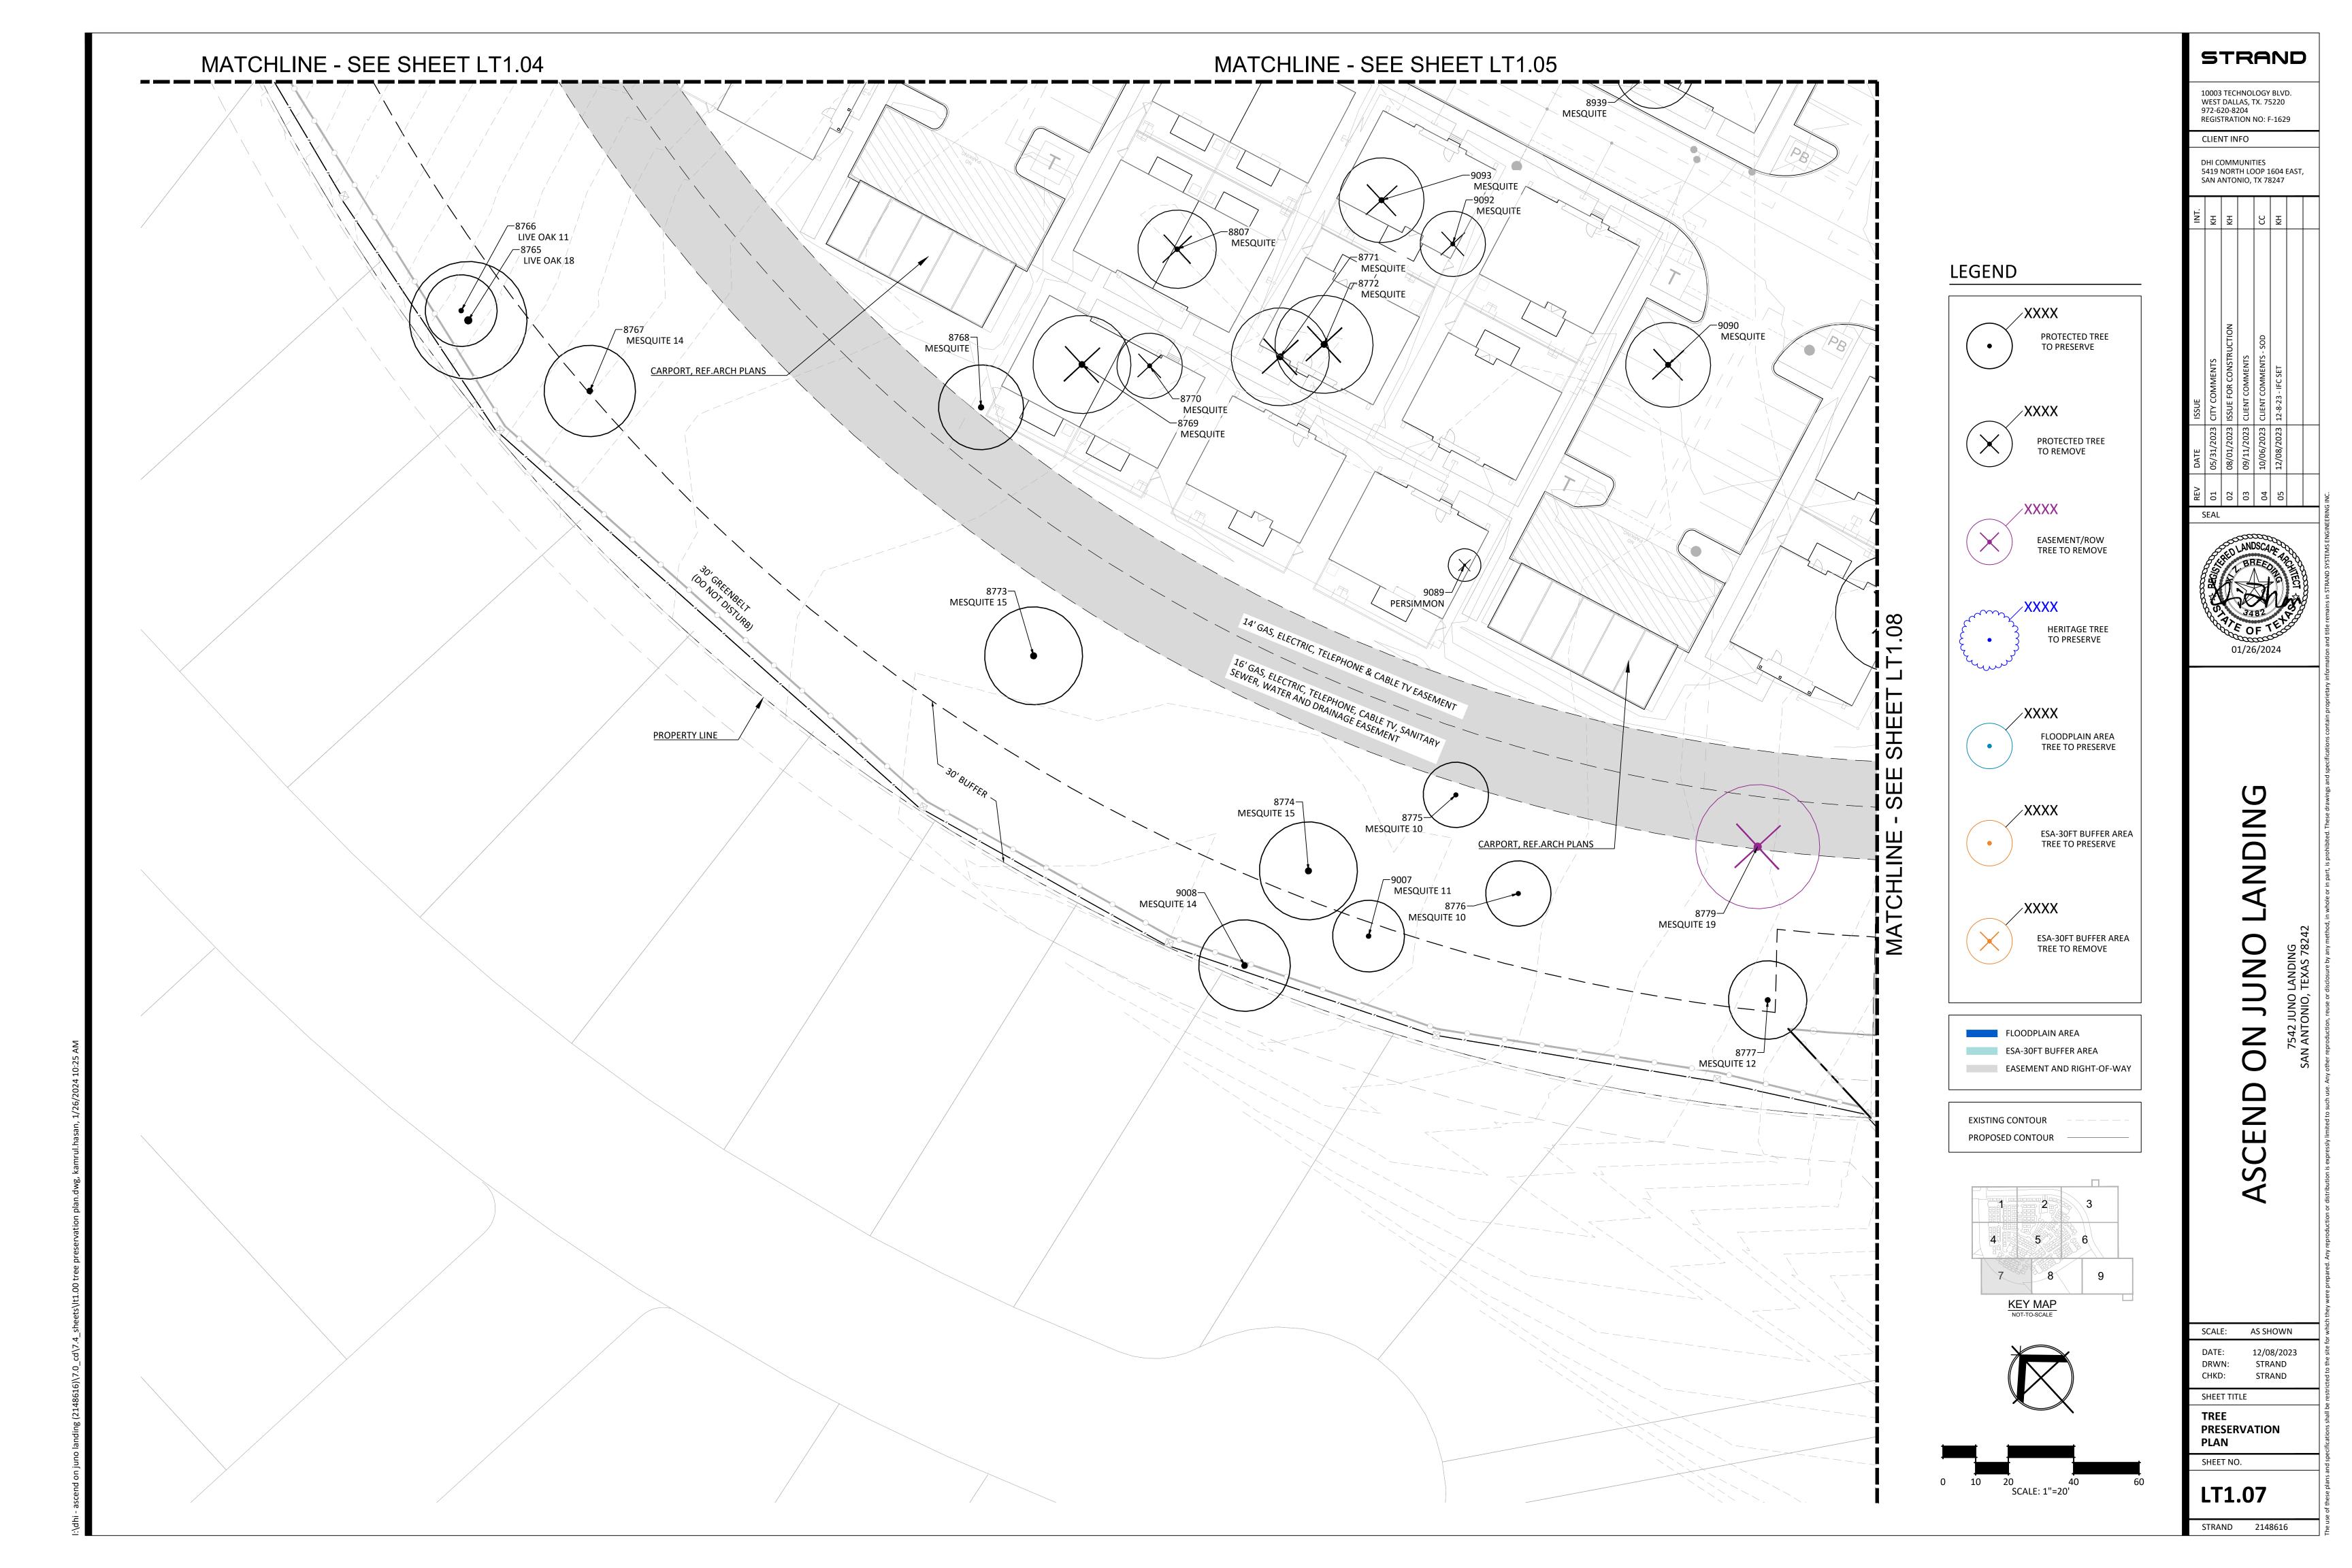

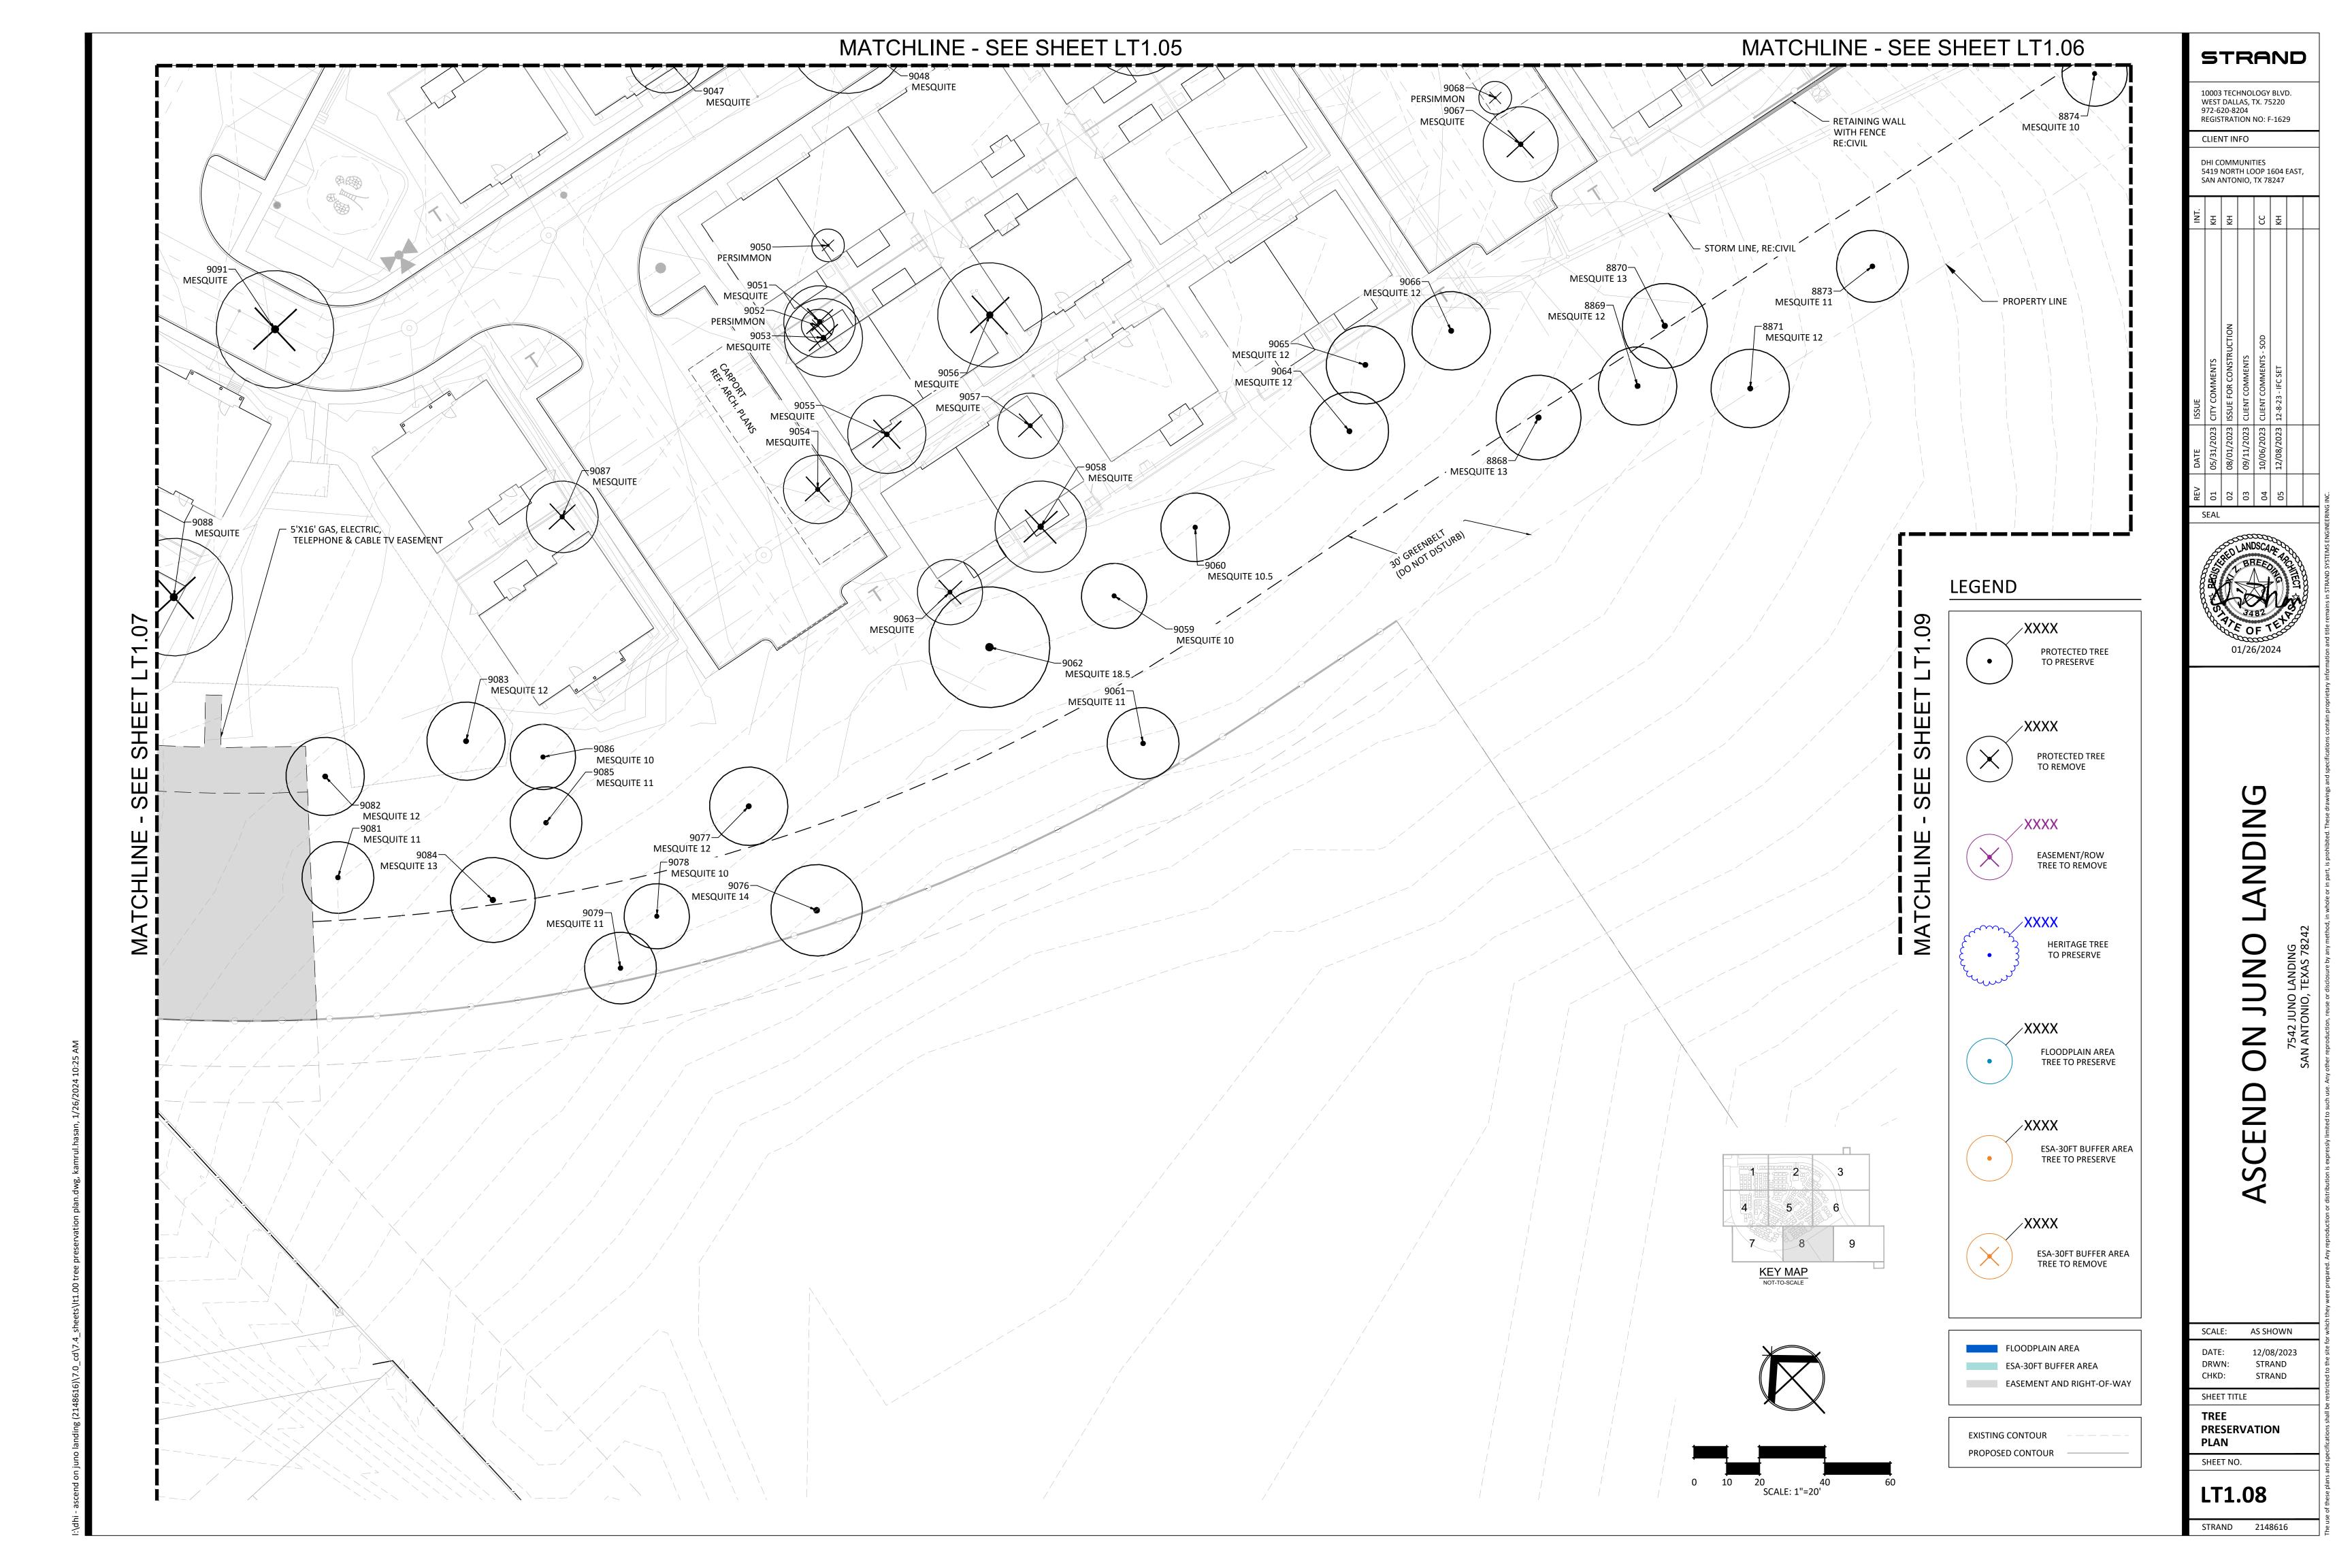

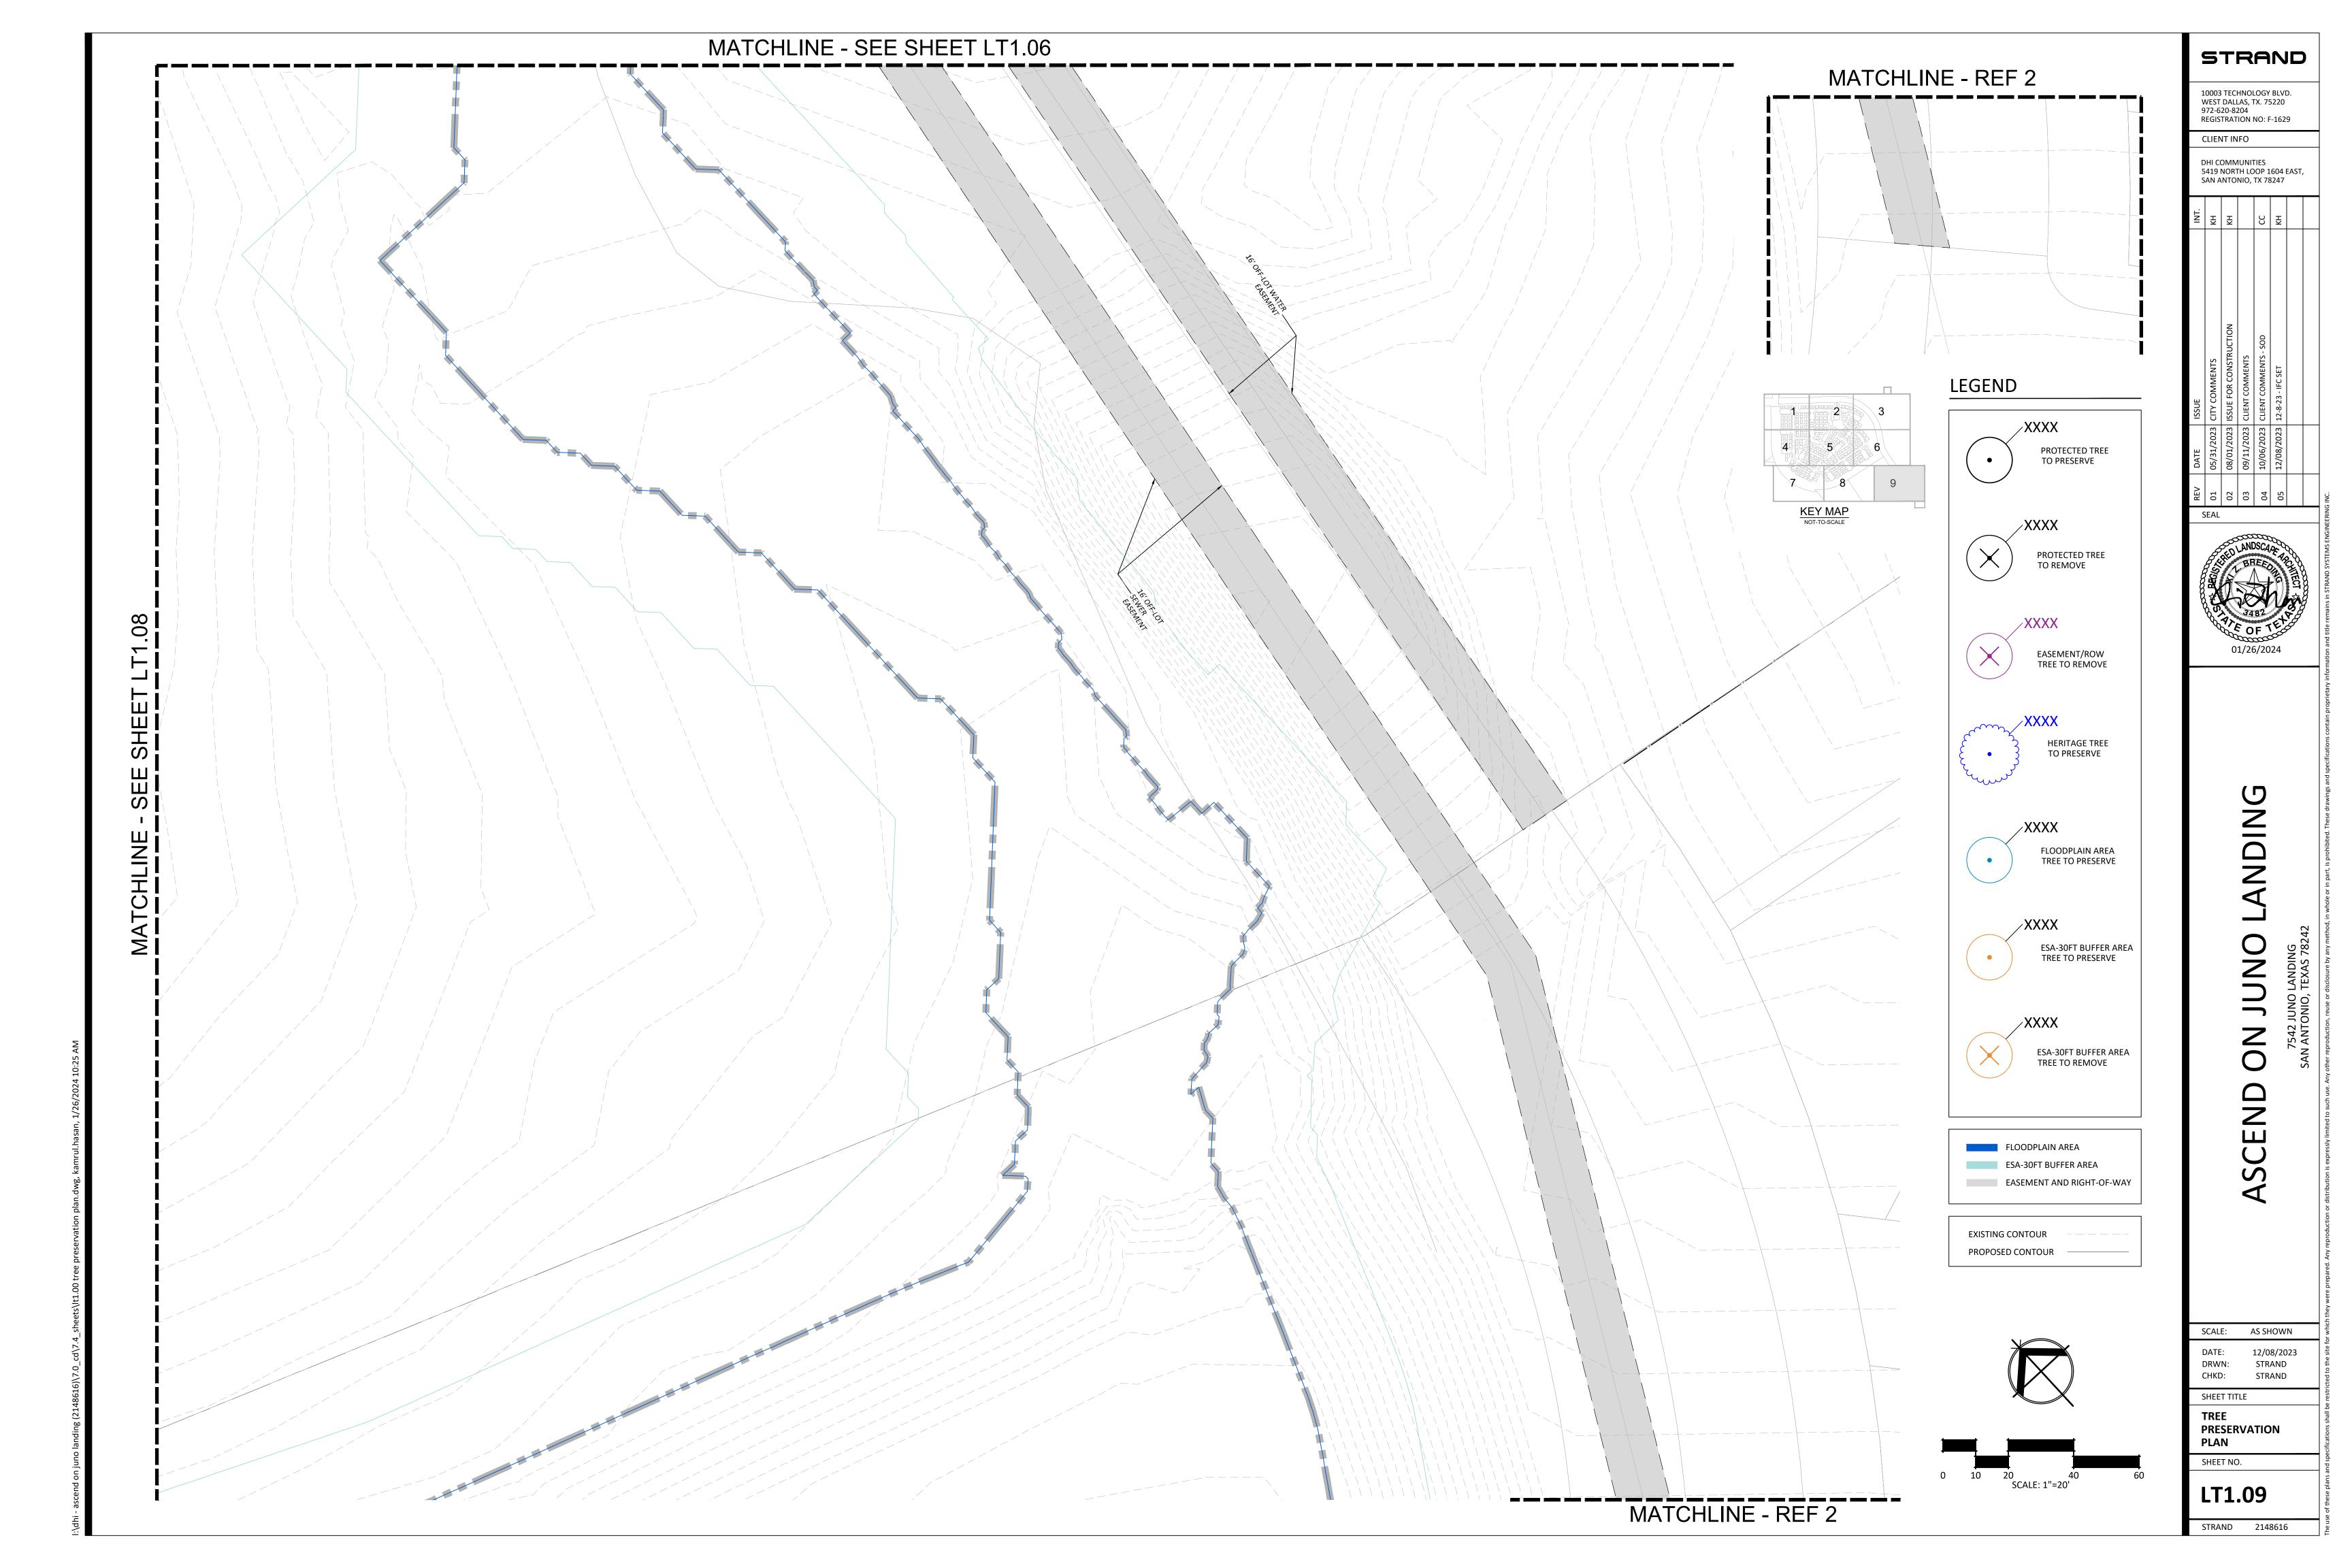

TREE INVENTORY TABLE

												ADDITIONAL		
		The second second second	CANT TREE ORY SPECIES)	SIGNIFI	CANT TREE	SIGNIFICANT TREE	HERITAGE 3:1	HERITAGE 1:1		ESA-30FT BUFFER (INCLUDING	EASEMENT/ROW TREE	INCHES		
TAG	SPECIES	_	'-11.5" PRESERVED	6.0' REMOVED	"-23.5" PRESERVED	10.0"-23.5" REMOVED PRESERVED	>24.0" REMOVED PRESERVED	>12" REMOVED PRESERVED	FLOODPLAIN AREA D REMOVED PRESERVED	REMOVED PRESERVE	(EXCLUDING ESA) D REMOVED PRESERVED	MITIGATION*** PRESERVED	CONDITION	COMMENTS
	SALIX ALBA / WILLOW						33.5						GOOD	
8758 8759	PROSOPIS GLANDULOSA / MESQUITE PROSOPIS GLANDULOSA / MESQUITE				13	3					14		FAIR FAIR	
8760 8761	PROSOPIS GLANDULOSA / MESQUITE PROSOPIS GLANDULOSA / MESQUITE			14.5	14	1							FAIR FAIR	
8762	PROSOPIS GLANDULOSA / MESQUITE				14	1							FAIR FAIR	
8763 8764	PROSOPIS GLANDULOSA / MESQUITE PROSOPIS GLANDULOSA / MESQUITE				11	1							FAIR	
8765 8766	QUERCUS VIRGINIANA / LIVE OAK QUERCUS VIRGINIANA / LIVE OAK				18								GOOD GOOD	
8767	PROSOPIS GLANDULOSA / MESQUITE				14	1							FAIR FAIR	
8768 8769	PROSOPIS GLANDULOSA / MESQUITE PROSOPIS GLANDULOSA / MESQUITE			15		5							FAIR	
8770 8771	PROSOPIS GLANDULOSA / MESQUITE PROSOPIS GLANDULOSA / MESQUITE			10 15									FAIR FAIR	
8772	PROSOPIS GLANDULOSA / MESQUITE			*15	15								IN DECLINE/HAZARD	
8773 8774	PROSOPIS GLANDULOSA / MESQUITE PROSOPIS GLANDULOSA / MESQUITE				*15								FAIR IN DECLINE	
8775 8776	PROSOPIS GLANDULOSA / MESQUITE PROSOPIS GLANDULOSA / MESQUITE				10								FAIR FAIR	
8777	PROSOPIS GLANDULOSA / MESQUITE				12	 					-		FAIR	
8779 8780	PROSOPIS GLANDULOSA / MESQUITE PROSOPIS GLANDULOSA / MESQUITE										*19 10		HAZARD FAIR	
8785 8786	PROSOPIS GLANDULOSA / MESQUITE PROSOPIS GLANDULOSA / MESQUITE			12 10.5									FAIR FAIR	
8787	DIOSPYROS KAKI / PERSIMMON	5											GOOD	
8788 8789	PROSOPIS GLANDULOSA / MESQUITE PROSOPIS GLANDULOSA / MESQUITE			14 15									FAIR FAIR	
8790 8791	PROSOPIS GLANDULOSA / MESQUITE PROSOPIS GLANDULOSA / MESQUITE			12.5 15									FAIR FAIR	
8792	PROSOPIS GLANDULOSA / MESQUITE			11									FAIR	
8793 8794	PROSOPIS GLANDULOSA / MESQUITE PROSOPIS GLANDULOSA / MESQUITE			10 14									FAIR FAIR	
8795 8796	PROSOPIS GLANDULOSA / MESQUITE DIOSPYROS KAKI / PERSIMMON			*13									HAZARD GOOD	
8797	PROSOPIS GLANDULOSA / MESQUITE	3		11									FAIR	
	PROSOPIS GLANDULOSA / MESQUITE DIOSPYROS KAKI / PERSIMMON	5		10									FAIR GOOD	
8800	DIOSPYROS KAKI / PERSIMMON	5		13									GOOD FAIR	
8801 8802	PROSOPIS GLANDULOSA / MESQUITE PROSOPIS GLANDULOSA / MESQUITE				14	1							FAIR	
8803 8804	PROSOPIS GLANDULOSA / MESQUITE PROSOPIS GLANDULOSA / MESQUITE			11	+							1	FAIR FAIR	
8805	PROSOPIS GLANDULOSA / MESQUITE			13	-								FAIR	
8806 8807	PROSOPIS GLANDULOSA / MESQUITE PROSOPIS GLANDULOSA / MESQUITE			10 12	+								FAIR FAIR	
8808 8811	PROSOPIS GLANDULOSA / MESQUITE PROSOPIS GLANDULOSA / MESQUITE			*10							10		IN DECLINE FAIR	
8813	PROSOPIS GLANDULOSA / MESQUITE									11.5			FAIR	
8814 8815	PROSOPIS GLANDULOSA / MESQUITE										5.5		GOOD FAIR	
8816 8817	PROSOPIS GLANDULOSA / MESQUITE DIOSPYROS KAKI / PERSIMMON										*11.5		HAZARD GOOD	
8818	PROSOPIS GLANDULOSA / MESQUITE										10		FAIR	
8821 8822	PROSOPIS GLANDULOSA / MESQUITE DIOSPYROS KAKI / PERSIMMON										*12		IN DECLINE GOOD	
8823 8824	PROSOPIS GLANDULOSA / MESQUITE PROSOPIS GLANDULOSA / MESQUITE								10.		14		FAIR FAIR	
8825	DIOSPYROS KAKI / PERSIMMON										7		GOOD	
8826 8827	PROSOPIS GLANDULOSA / MESQUITE PROSOPIS GLANDULOSA / MESQUITE				12.5	5				*16			HAZARD FAIR	
8828 8829	PROSOPIS GLANDULOSA / MESQUITE DIOSPYROS KAKI / PERSIMMON										14		FAIR GOOD	
8830	DIOSPYROS KAKI / PERSIMMON										5		GOOD	
8831 8832	DIOSPYROS KAKI / PERSIMMON											-		
8833	PROSOPIS GLANDULOSA / MESQUITE										5.5 15		GOOD FAIR	
	DIOSPYROS KAKI / PERSIMMON												GOOD FAIR FAIR	
8834 8835	DIOSPYROS KAKI / PERSIMMON DIOSPYROS KAKI / PERSIMMON PROSOPIS GLANDULOSA / MESQUITE												GOOD FAIR FAIR FAIR	
8834	DIOSPYROS KAKI / PERSIMMON DIOSPYROS KAKI / PERSIMMON				12	2					15 5 5		GOOD FAIR FAIR	
8834 8835 8836 8837 8838	DIOSPYROS KAKI / PERSIMMON DIOSPYROS KAKI / PERSIMMON PROSOPIS GLANDULOSA / MESQUITE PROSOPIS GLANDULOSA / MESQUITE DIOSPYROS KAKI / PERSIMMON PROSOPIS GLANDULOSA / MESQUITE				12						15 5 5 11 5.5 12		GOOD FAIR FAIR FAIR FAIR FAIR GOOD FAIR	
8834 8835 8836 8837	DIOSPYROS KAKI / PERSIMMON DIOSPYROS KAKI / PERSIMMON PROSOPIS GLANDULOSA / MESQUITE PROSOPIS GLANDULOSA / MESQUITE DIOSPYROS KAKI / PERSIMMON				12	2					15 5 5 11 5.5		GOOD FAIR FAIR FAIR FAIR FAIR GOOD	
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8834 8835 8836 8837 8838 8839 8840 8841 8843 8844 8845 8846 8847 8848	DIOSPYROS KAKI / PERSIMMON DIOSPYROS KAKI / PERSIMMON PROSOPIS GLANDULOSA / MESQUITE PROSOPIS GLANDULOSA / MESQUITE DIOSPYROS KAKI / PERSIMMON PROSOPIS GLANDULOSA / MESQUITE DIOSPYROS KAKI / PERSIMMON RHUS VIRENS / SUMAC DIOSPYROS KAKI / PERSIMMON										15		GOOD FAIR FAIR FAIR FAIR FAIR GOOD FAIR FAIR FAIR FAIR FOOD GOOD GOOD GOOD GOOD GOOD GOOD GOOD	
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8834 8835 8836 8837 8838 8839 8840 8841 8843 8844 8845 8846 8847 8848 8849 8850 8854 8868 8869 8870 8871 8873 8874 8875 8876 8877 8878 8879 8880 8881 8882 8883 8885 8886 8887 8887 8888 8889 8890 8891 8890 8900 8910 8910 8911	DIOSPYROS KAKI / PERSIMMON DIOSPYROS KAKI / PERSIMMON PROSOPIS GLANDULOSA / MESQUITE PROSOPIS GLANDULOSA / MESQUITE DIOSPYROS KAKI / PERSIMMON PROSOPIS GLANDULOSA / MESQUITE DIOSPYROS KAKI / PERSIMMON RHUS VIRENS / SUMAC DIOSPYROS KAKI / PERSIMMON PROSOPIS GLANDULOSA / MESQUITE DIOSPYROS KAKI / PERSIMMON PROSOPIS GLANDULOSA / MESQUITE PROSOPIS GLANDULO	5		*13 10 12 11.5 15 *13	13 12 13 12 11 10 13 15.5 11.5 14 *12	3 2 2 1 1 1 1 1 1 1 1 1 1 1 1 1 1 1 1 1					15		GOOD FAIR FAIR FAIR FAIR FAIR FAIR GOOD FAIR FAIR FAIR FAIR GOOD GOOD GOOD GOOD GOOD GOOD GOOD GOO	
8834 8835 8836 8837 8838 8839 8840 8841 8843 8844 8845 8846 8847 8848 8849 8850 8854 8868 8869 8870 8871 8873 8874 8875 8876 8877 8878 8879 8880 8881 8882 8883 8885 8886 8887 8878 8879 8870 8871 8873	DIOSPYROS KAKI / PERSIMMON DIOSPYROS KAKI / PERSIMMON PROSOPIS GLANDULOSA / MESQUITE PROSOPIS GLANDULOSA / MESQUITE DIOSPYROS KAKI / PERSIMMON PROSOPIS GLANDULOSA / MESQUITE DIOSPYROS KAKI / PERSIMMON RHUS VIRENS / SUMAC DIOSPYROS KAKI / PERSIMMON PROSOPIS GLANDULOSA / MESQUITE DIOSPYROS KAKI / PERSIMMON PROSOPIS GLANDULOSA / MESQUITE PROSOPIS GLANDULO	5		*13 *13 16 10.5 11 13 12 13 10 13	13 12 13 12 11 10 10 13 15.5 11.5 14 *12	3 2 2 1 1 1 1 1 1 1 1 1 1 1 1 1 1 1 1 1					15		GOOD FAIR FAIR FAIR FAIR FAIR FAIR GOOD FAIR FAIR FAIR FAIR FAIR FAIR GOOD GOOD GOOD GOOD GOOD GOOD GOOD GOO	
8834 8835 8836 8837 8838 8839 8840 8841 8843 8844 8845 8846 8847 8848 8849 8850 8854 8868 8869 8870 8871 8873 8874 8875 8876 8877 8878 8879 8880 8881 8882 8883 8885 8886 8887 8878 8879 8870 8871 8871 8873 8874 8875 8876 8877 8878 8879 8880 8881 8882 8883 8885 8886 8887 8888 8881 8882 8883 8885 8886 8887 8889 8890 8891 8890 8910 8911 8912 8913 8914 8915 8916 8917	DIOSPYROS KAKI / PERSIMMON DIOSPYROS KAKI / PERSIMMON PROSOPIS GLANDULOSA / MESQUITE PROSOPIS GLANDULOSA / MESQUITE DIOSPYROS KAKI / PERSIMMON PROSOPIS GLANDULOSA / MESQUITE DIOSPYROS KAKI / PERSIMMON RHUS VIRENS / SUMAC DIOSPYROS KAKI / PERSIMMON PROSOPIS GLANDULOSA / MESQUITE DIOSPYROS KAKI / PERSIMMON PROSOPIS GLANDULOSA / MESQUITE PROSOPIS GLANDULOSA / MESQUITE PROSOPIS GLANDULOSA / MESQUITE PROSOPIS GLANDULOSA / MESQUITE DIOSPYROS KAKI / PERSIMMON PROSOPIS GLANDULOSA / MESQUITE DIOSPYROS KAKI / PERSIMMON PROSOPIS GLANDULOSA / MESQUITE PROSO	5		*13 *13 16 10.5 11 13 12 13 10	13 12 13 12 11 10 10 13 15.5 11.5 14 *12	3 2 2 1 1 1 1 1 1 1 1 1 1 1 1 1 1 1 1 1					15		GOOD FAIR FAIR FAIR FAIR FAIR FAIR GOOD FAIR FAIR FAIR FAIR FAIR FAIR GOOD GOOD GOOD GOOD GOOD GOOD GOOD GOO	
8834 8835 8836 8837 8838 8839 8840 8841 8843 8844 8845 8846 8847 8848 8849 8850 8854 8868 8869 8870 8871 8873 8874 8875 8876 8877 8878 8879 8880 8881 8882 8883 8885 8886 8887 8878 8879 8870 8871 8871 8873 8874 8875 8876 8877 8878 8879 8880 8881 8882 8883 8885 8886 8887 8888 8881 8882 8883 8885 8886 8887 8889 8890 8891 8890 8910 8911 8912 8913 8914 8915 8916 8917	DIOSPYROS KAKI / PERSIMMON DIOSPYROS KAKI / PERSIMMON PROSOPIS GLANDULOSA / MESQUITE PROSOPIS GLANDULOSA / MESQUITE DIOSPYROS KAKI / PERSIMMON PROSOPIS GLANDULOSA / MESQUITE DIOSPYROS KAKI / PERSIMMON RHUS VIRENS / SUMAC DIOSPYROS KAKI / PERSIMMON PROSOPIS GLANDULOSA / MESQUITE DIOSPYROS KAKI / PERSIMMON PROSOPIS GLANDULOSA / MESQUITE PROSOPIS GLAN	5 5		*13 *13 16 10.5 11 13 12 13 10 13 *12	13 12 13 12 11 10 10 13 15.5 11.5 14 *12	3 2 2 1 1 1 1 1 1 1 1 1 1 1 1 1 1 1 1 1					15		GOOD FAIR FAIR FAIR FAIR FAIR FAIR FAIR GOOD FAIR FAIR FAIR GOOD GOOD GOOD GOOD GOOD GOOD GOOD GOO	

		(UNDERST	CANT TREE 'ORY SPECIES) "-11.5"	SIGNIFICANT TREE	100000000000000000000000000000000000000	CANT TREE "-23.5"	HERITAGE 3:1 >24.0"	HERITAGE 1:1 >12"	G GODDIAN ADEA	ESA-30FT BUFFER (INCLUDING	EASEMENT/ROW TREE	ADDITIONAL INCHES PRESERVED FOR MITIGATION***	
TAG	SPECIES	REMOVED		6.0"-23.5" REMOVED PRESERVED					REMOVED PRESERVED	REMOVED PRESERVED	(EXCLUDING ESA) REMOVED PRESERVED	121000000000000000	CONDITION COMMENTS
	DIOSPYROS KAKI / PERSIMMON DIOSPYROS KAKI / PERSIMMON	5.5											GOOD
	PROSOPIS GLANDULOSA / MESQUITE			10									FAIR
	PROSOPIS GLANDULOSA / MESQUITE PROSOPIS GLANDULOSA / MESQUITE			11									FAIR FAIR
8926	PROSOPIS GLANDULOSA / MESQUITE			10									FAIR
1.0000000000000000000000000000000000000	PROSOPIS GLAN DULOSA / MESQUITE PROSOPIS GLAN DULOSA / MESQUITE			10 11									FAIR FAIR
	DIOSPYROS KAKI / PERSIMMON	5											GOOD
	DIOSPYROS KAKI / PERSIMMON		5	12									GOOD
	PROSOPIS GLANDULOSA / MESQUITE PROSOPIS GLANDULOSA / MESQUITE			13 14									FAIR FAIR
	DIOSPYROS KAKI / PERSIMMON	5											GOOD
	PROSOPIS GLANDULOSA / MESQUITE DIOSPYROS KAKI / PERSIMMON	5.5		10									FAIR GOOD
8936	DIOSPYROS KAKI / PERSIMMON	6											GOOD
	PROSOPIS GLANDULOSA / MESQUITE DIOSPYROS KAKI / PERSIMMON	5.5		12									GOOD
	PROSOPIS GLANDULOSA / MESQUITE	3.5		12									FAIR
	PROSOPIS GLANDULOSA / MESQUITE PROSOPIS GLANDULOSA / MESQUITE			10 12.5									FAIR FAIR
	DIOSPYROS KAKI / PERSIMMON		5	12.5									FAIR
	PROSOPIS GLANDULOSA / MESQUITE			10									FAIR FAIR
	PROSOPIS GLANDULOSA / MESQUITE PROSOPIS GLANDULOSA / MESQUITE			11 12.5									FAIR
	PROSOPIS GLANDULOSA / MESQUITE			12									FAIR
	PROSOPIS GLANDULOSA / MESQUITE PROSOPIS GLANDULOSA / MESQUITE			15							12		FAIR FAIR
8950	PROSOPIS GLANDULOSA / MESQUITE										10.5		FAIR
	PROSOPIS GLANDULOSA / MESQUITE PROSOPIS GLANDULOSA / MESQUITE										11 11		FAIR FAIR
8955	PROSOPIS GLANDULOSA / MESQUITE										10.5		FAIR
	PROSOPIS GLANDULOSA / MESQUITE PROSOPIS GLANDULOSA / MESQUITE										14 12		FAIR GOOD
	DIOSPYROS KAKI / PERSIMMON										5		GOOD
	CONDALIA WARNOCKII / CONDALIA	5											FAIR FAIR
	DIOSPYROS KAKI / PERSIMMON DIOSPYROS KAKI / PERSIMMON	10	5.5										GOOD
	DIOSPYROS KAKI / PERSIMMON	7.5		*17									GOOD
8970 8971	PROSOPIS GLANDULOSA / MESQUITE PROSOPIS GLANDULOSA / MESQUITE			*12 *13.5									DECLINE DECLINE
8972	PROSOPIS GLANDULOSA / MESQUITE		_	*10									DECLINE
	PROSOPIS GLANDULOSA / MESQUITE PROSOPIS GLANDULOSA / MESQUITE			10.5									FAIR FAIR
8975	PROSOPIS GLANDULOSA / MESQUITE			11									FAIR
	PROSOPIS GLANDULOSA / MESQUITE PROSOPIS GLANDULOSA / MESQUITE										10 11		FAIR FAIR
Delinate to t	PROSOPIS GLANDULOSA / MESQUITE			12							11		FAIR
	PROSOPIS GLANDULOSA / MESQUITE			10.5									FAIR
	DIOSPYROS KAKI / PERSIMMON PROSOPIS GLANDULOSA / MESQUITE	6.5		12									GOOD FAIR
	PROSOPIS GLANDULOSA / MESQUITE			10									FAIR
	PROSOPIS GLANDULOSA / MESQUITE CONDALIA WARNOCKII / CONDALIA	6.5		*14									IN DECLINE FAIR
8985	PROSOPIS GLANDULOSA / MESQUITE			12									FAIR
	DIOSPYROS KAKI / PERSIMMON PROSOPIS GLANDULOSA / MESQUITE		5	10.5									GOOD FAIR
	DIOSPYROS KAKI / PERSIMMON	5		10.5									GOOD
5000000 to 10 10 10 10	DIOSPYROS KAKI / PERSIMMON	8		12									GOOD FAIR
	PROSOPIS GLANDULOSA / MESQUITE PROSOPIS GLANDULOSA / MESQUITE			13						12			FAIR
0.0000000000000000000000000000000000000	ULMUS AMERICANA / ELM									8	3		FAIR
	PROSOPIS GLANDULOSA / MESQUITE PROSOPIS GLANDULOSA / MESQUITE									10			FAIR FAIR
100000000000000000000000000000000000000	PROSOPIS GLANDULOSA / MESQUITE									16)		FAIR
	PROSOPIS GLANDULOSA / MESQUITE DIOSPYROS KAKI / PERSIMMON			11					6				FAIR GOOD
8998	DIOSPYROS KAKI / PERSIMMON										i i		FAIR
8999 9000	PROSOPIS GLANDULOSA / MESQUITE PROSOPIS GLANDULOSA / MESQUITE			*20					13				FAIR HAZARD/IN DECLINE
9001	PROSOPIS GLANDULOSA / MESQUITE			11									FAIR
	DIOSPYROS KAKI / PERSIMMON PROSOPIS GLANDULOSA / MESQUITE	5		12									GOOD FAIR
	PROSOPIS GLANDULOSA / MESQUITE			12									FAIR
	PROSOPIS GLANDULOSA / MESQUITE PROSOPIS GLANDULOSA / MESQUITE			12 12									FAIR FAIR
	PROSOPIS GLANDULOSA / MESQUITE			11									FAIR
Control of the Contro	PROSOPIS GLANDULOSA / MESQUITE			14									FAIR
9009 9010	PROSOPIS GLANDULOSA / MESQUITE PROSOPIS GLANDULOSA / MESQUITE			*13									HAZARD/IN DECLINE FAIR
	PROSOPIS GLANDULOSA / MESQUITE			11									FAIR
	DIOSPYROS KAKI / PERSIMMON PROSOPIS GLANDULOSA / MESQUITE		5	11									GOOD FAIR
9014	PROSOPIS GLANDULOSA / MESQUITE			*11									IN DECLINE
	PROSOPIS GLAN DULOSA / MESQUITE PROSOPIS GLAN DULOSA / MESQUITE			11 11									FAIR FAIR
9017	DIOSPYROS KAKI / PERSIMMON	5											GOOD
9018 9019	PROSOPIS GLANDULOSA / MESQUITE DIOSPYROS KAKI / PERSIMMON		5.5	*11									HAZARD/ IN DECLINE GOOD
	DIOSPYROS KAKI / PERSIMMON		5.5 5										GOOD
	CONDALIA WARNOCKII / CONDALIA	6	5										FAIR
	DIOSPYROS KAKI / PERSIMMON DIOSPYROS KAKI / PERSIMMON	В	7										GOOD GOOD
	PROSOPIS GLANDULOSA / MESQUITE			11									FAIR FAIR
	PROSOPIS GLANDULOSA / MESQUITE PROSOPIS GLANDULOSA / MESQUITE	<u>_</u> _		11.5 16								<u></u>	FAIR FAIR
	PROSOPIS GLANDULOSA / MESQUITE			11									FAIR
	DIOSPYROS KAKI / PERSIMMON PROSOPIS GLANDULOSA / MESQUITE	5		13									FAIR FAIR
9030	CONDALIA WARNOCKII / CONDALIA	5											FAIR
	DIOSPYROS KAKI / PERSIMMON PROSOPIS GLANDULOSA / MESQUITE	6		11									FAIR FAIR
9033	DIOSPYROS KAKI / PERSIMMON	6											GOOD
	DIOSPYROS KAKI / PERSIMMON PROSOPIS GLANDIJI OSA / MESOLITE	5.5		11									GOOD FAIR
T 188 T 193	PROSOPIS GLAN DULOSA / MESQUITE DIOSPYROS KAKI / PERSIMMON	5		.11									GOOD
9037	DIOSPYROS KAKI / PERSIMMON	5											GOOD
CONTRACTOR CONTRACTOR	DIOSPYROS KAKI / PERSIMMON DIOSPYROS KAKI / PERSIMMON	5.5											GOOD
9040	DIOSPYROS KAKI / PERSIMMON	5											FAIR
	PROSOPIS GLAN DULOSA / MESQUITE PROSOPIS GLAN DULOSA / MESQUITE			16 12									FAIR FAIR
7.00	PROSOPIS GLANDULOSA / MESQUITE PROSOPIS GLANDULOSA / MESQUITE			12									FAIR
	DIOSPYROS KAKI / PERSIMMON	5		*11									GOOD HAZARD IN DECLINE
004-	PROSOPIS GLANDULOSA / MESQUITE DIOSPYROS KAKI / PERSIMMON	5		*11									HAZARD/IN DECLINE GOOD
9045 9046				11									FAIR
9046 9047	PROSOPIS GLANDULOSA / MESQUITE										+ + + + + + + + + + + + + + + + + + + +		
9046 9047 9048			:	*18									HAZARD/IN DECLINE GOOD
9046 9047 9048 9049 9050	PROSOPIS GLANDULOSA / MESQUITE PROSOPIS GLANDULOSA / MESQUITE	5		*18									HAZARD/IN DECLINE

STRAND

10003 TECHNOLOGY BLVD. WEST DALLAS, TX. 75220 972-620-8204 REGISTRATION NO: F-1629

CLIENT INFO

DHI COMMUNITIES 5419 NORTH LOOP 1604 EAST, SAN ANTONIO, TX 78247

7542 JUNO LANDING SAN ANTONIO, TEXAS 78242 ON JUNO

SCALE: AS SHOWN DATE: 12/08/2023 DRWN: STRAND CHKD: STRAND

SHEET TITLE

TREE PRESERVATION CALCULATION

SHEET NO.

LT1.10

TREE INVENTORY TABLE

			SIGNIFICANT TREE						ESA-30FT BUFFER	1000000	ADDITIONAL INCHES		
			(UNDERSTORY SPECIES) 5.0"-11.5"	SIGNIFICANT TREE 6.0"-23.5"	SIGNIFICANT TREE 10.0"-23.5"	HERITAGE 3:1 >24.0"	HERITAGE 1:1 >12"	FLOODPLAIN AREA	(INCLUDING EASMENT/ROW)	EASEMENT/ROW TREE (EXCLUDING ESA)	PRESERVED FOR MITIGATION***		
	TAG	SPECIES	REMOVED PRESERVED		REMOVED PRESERVED	REMOVED PRESERVED	REMOVED PRESERVED	REMOVED PRESERVED	REMOVED PRESERVED	REMOVED PRESERVED		CONDITION	COMMENTS
		PROSOPIS GLANDULOSA / MESQUITE		12 10.5								FAIR FAIR	
	9054	PROSOPIS GLANDULOSA / MESQUITE PROSOPIS GLANDULOSA / MESQUITE		*12								HAZARD/IN DECLINE	
		PROSOPIS GLANDULOSA / MESQUITE		*16								HAZARD/ IN DECLINE	1
		PROSOPIS GLANDULOSA / MESQUITE		10								FAIR	
	9058	PROSOPIS GLANDULOSA / MESQUITE		*14								IN DECLINE	
		PROSOPIS GLANDULOSA / MESQUITE			10							FAIR	
		PROSOPIS GLANDULOSA / MESQUITE PROSOPIS GLANDULOSA / MESQUITE		10	.5							FAIR FAIR	
-		PROSOPIS GLANDULOSA / MESQUITE		18								FAIR	
		PROSOPIS GLANDULOSA / MESQUITE		10								FAIR	
	9064	PROSOPIS GLANDULOSA / MESQUITE			12							FAIR	
		PROSOPIS GLANDULOSA / MESQUITE			12							FAIR	
		PROSOPIS GLANDULOSA / MESQUITE PROSOPIS GLANDULOSA / MESQUITE			12							FAIR FAIR	
	A 8.A.A. 1	DIOSPYROS KAKI / PERSIMMON	5	11.5								GOOD	
		PROSOPIS GLANDULOSA / MESQUITE	3	11.5								FAIR	
- 4		DIOSPYROS KAKI / PERSIMMON	5									GOOD	
- 3	9071	PROSOPIS GLANDULOSA / MESQUITE		13.5								FAIR	
_		PROSOPIS GLANDULOSA / MESQUITE		13								FAIR	
		DIOSPYROS KAKI / PERSIMMON	8		14							GOOD	
		PROSOPIS GLANDULOSA / MESQUITE PROSOPIS GLANDULOSA / MESQUITE			14							FAIR FAIR	+
		PROSOPIS GLANDULOSA / MESQUITE			10							FAIR	
	9079	PROSOPIS GLANDULOSA / MESQUITE			11							FAIR	
		PROSOPIS GLANDULOSA / MESQUITE			11							FAIR	
		PROSOPIS GLANDULOSA / MESQUITE			12							FAIR	
		PROSOPIS GLANDULOSA / MESQUITE			12							FAIR FAIR	
		PROSOPIS GLANDULOSA / MESQUITE PROSOPIS GLANDULOSA / MESQUITE			11							FAIR	+
	9086	PROSOPIS GLANDULOSA / MESQUITE		*10								IN DECLINE	
	9087	PROSOPIS GLANDULOSA / MESQUITE		11								FAIR	
	9088	PROSOPIS GLANDULOSA / MESQUITE		*18								HAZARD	
		DIOSPYROS KAKI / PERSIMMON	5									FAIR	
	9090	PROSOPIS GLANDULOSA / MESQUITE		*13								HAZARD FAIR	
		PROSOPIS GLANDULOSA / MESQUITE PROSOPIS GLANDULOSA / MESQUITE		18								FAIR	+
		PROSOPIS GLANDULOSA / MESQUITE		13								FAIR	
	9094	PROSOPIS GLANDULOSA / MESQUITE		20.5								FAIR	
		CONDALIA WARNOCKII / CONDALIA	6							1		FAIR	
_		DIOSPYROS KAKI / PERSIMMON	5	10								GOOD	
		PROSOPIS GLANDULOSA / MESQUITE DIOSPYROS KAKI / PERSIMMON	6	10								FAIR GOOD	+
		DIOSPYROS KAKI / PERSIMMON	5									GOOD	
	9100	PROSOPIS GLANDULOSA / MESQUITE		11.5								FAIR	
	9101	PROSOPIS GLANDULOSA / MESQUITE		12								FAIR	
_	9102	PROSOPIS GLANDULOSA / MESQUITE		10								FAIR	
	9103	PROSOPIS GLANDULOSA / MESQUITE PROSOPIS GLANDULOSA / MESQUITE		10								FAIR	
	9104	PROSOPIS GLANDULOSA / MESQUITE PROSOPIS GLANDULOSA / MESQUITE		13.5								FAIR FAIR	
		PROSOPIS GLANDULOSA / MESQUITE		10								FAIR	
1 2	9107	PROSOPIS GLANDULOSA / MESQUITE		10.5								FAIR	
	9108	PROSOPIS GLANDULOSA / MESQUITE		10.5								FAIR	
	9109	PROSOPIS GLANDULOSA / MESQUITE		11.5								FAIR	
	9110	PROSOPIS GLANDULOSA / MESQUITE DIOSPYROS KAKI / PERSIMMON	-	10.5								FAIR GOOD	+
		PROSOPIS GLANDULOSA / MESQUITE	3	16								FAIR	
		PROSOPIS GLANDULOSA / MESQUITE		11.5								FAIR	
		DIOSPYROS KAKI / PERSIMMON	5								1	GOOD	
		PROSOPIS GLANDULOSA / MESQUITE		10								FAIR	
		DIOSPYROS KAKI / PERSIMMON	5	10								GOOD	
	9117 9118	PROSOPIS GLANDULOSA / MESQUITE PROSOPIS GLANDULOSA / MESQUITE		10 14								FAIR FAIR	
		PROSOPIS GLANDULOSA / MESQUITE PROSOPIS GLANDULOSA / MESQUITE		12								GOOD	1
	9120	PROSOPIS GLANDULOSA / MESQUITE		10							11	FAIR	
		CONDALIA WARNOCKII / CONDALIA	5									FAIR	
	9122	PROSOPIS GLANDULOSA / MESQUITE		14								FAIR	
	9123	PROSOPIS GLANDILLOSA / MESQUITE		*11							1	HAZARD	1
	9124	PROSOPIS GLANDULOSA / MESQUITE PROSOPIS GLANDULOSA / MESQUITE		14 10								FAIR FAIR	
		PROSOPIS GLANDULOSA / MESQUITE PROSOPIS GLANDULOSA / MESQUITE		11								FAIR	
	9127	PROSOPIS GLANDULOSA / MESQUITE			12							FAIR	
	9128	PROSOPIS GLANDULOSA / MESQUITE		10						J		FAIR	
	9129	PROSOPIS GLANDULOSA / MESQUITE		*14						ALCOHOLD BE A STREET		HAZARD	
	9130	PROSOPIS GLANDILLOSA / MESQUITE		13					445			FAIR	
	9136	PROSOPIS GLANDULOSA / MESQUITE							14.5			FAIR	
5 —		SUB TOTAL INCHES	272.5 69	1475.5 603.5	0 0	0 33.5	0 0	0 29.5	23.5 211	278	0		1
	TO	TAL EXISTING INCHES BY CATEGORY	341.5		2079	33.5	0	29.5	234.5	278			
	TOTA	AL PRESERVING INCHES BY CATEGORY	69	6	03.50	33.5	50	29.50	211.00	0			
	REO	UIRED PRESERVATION PERCENTAGE:	SIGNIFICANT TREE 40%	SIGNIFICA	ANT TREE 40%	HERITAGE T	REE 100%	FLOODPLAIN AREA TREE 809	% ESA AREA TREE 80%				
			1 X 1 X 1 X 1 X 1 X 1 X 1 X 1 X 1 X 1 X	The state of the s	CALTER A.A.	3 5 75 75	27 5334	25-74-74-74-74-74-74-74-74-74-74-74-74-74-		-			
		PRESERVATION PERCENTAGES =	20.20%	2	9.03%	100.0	JU%		N	+			
			SIGNIFICANT TREE	SIGNIFICANT TRE	E MITIGATION INCHES	HERITAGE TREE MIT	FIGATION INCHES		REE PRESERVATION SUMMARY				
		MITIGATION REQUIRED =	MITIGATION INCHES	a. a. micrati inc		THE WIT		THIS SHEET	FOR DETAILS				

PRESERVED- TREE TO REMAIN THAT MEETS ROOT PROTECTION REQUIRMENTS	DESCRIBED N SECTION35-523 OF THE UDC				
MITIGATION: 1:1 FOR SIGNIFICANT TRESS BELLOW MINIMUM PRESERVATION	EQUIRMENTS; 3:1 FOR HERITAGE TREES BELLOW 100%	PRESEVETION			
TREE NOTED FOR INVTORY PURPOSE- NOT USED IN CALCULATION					
NOTES:					
SMALL SPECIES: CONDALIA, REDBUD, TX. MOUNTAIN LAUREL, TX. PERSIMMON	, HOWTHOM, POSSUMHOW, THESE ARE MITIGATED AT 1	:1 FOR HEITAGE TREES			
ASHE JUNIPER, HUISACHE, MESQUITE, ARIZONA ASH, HACKBERRY PROTECTED	T 10" BDH AND MITIGATED 1:1 FOR HERITAGE TRESS				
MITIGATION OWED CALCULATIONS: SUM OF MITIGATION REQUIRED OF EACH	CATEGORY; UNPROTECTED-SIZED TREES TO BE USED FO	R MITIGATION CALCULATIONS; SUBS	TRACT INCHES FROM N	MITIGATION OWED	

FLOODPLAIN AND ESA AREA TREE PRESERVATION SUMMARY

				FLOODPL	AIN AREA				ESA-30FT BU	JFFER (INCL	JDING EASM	ENT/ROW)			
		(UNDE	ANT TREE ERSTORY CIES) -11.5"	1 1 1 1 1 1 1 1 1 1 1 1 1 1 1 1 1 1 1	ANT TREE	100000000000000000000000000000000000000	CANT TREE "-23.5"		ANT TREE PRY SPECIES) 11.5"		ANT TREE	0.000	ANT TREE '-23.5"		
TAG	SPECIES	REMOVED	PRESERVED	REMOVED	PRESERVED	REMOVED	PRESERVED	REMOVED	PRESERVED	REMOVED	PRESERVED	REMOVED	PRESERVED	CONDITION	сомм
8813	PROSOPIS GLANDULOSA / MESQUITE				1-7-1-1							11.5		FAIR	
8814	DIOSPYROS KAKI / PERSIMMON								5.5					GOOD	
8815	PROSOPIS GLANDULOSA / MESQUITE												15	FAIR	
8824	PROSOPIS GLANDULOSA / MESQUITE				E		10.5							FAIR	
8825	DIOSPYROS KAKI / PERSIMMON				1 1				7					GOOD	
8826	PROSOPIS GLANDULOSA / MESQUITE											*16		HAZARD	
8831	DIOSPYROS KAKI / PERSIMMON								5.5					GOOD	
8832	PROSOPIS GLANDULOSA / MESQUITE												15	FAIR	
8837	DIOSPYROS KAKI / PERSIMMON								5.5					GOOD	
8838	PROSOPIS GLANDULOSA / MESQUITE												12	FAIR	
8839	PROSOPIS GLANDULOSA / MESQUITE													FAIR	
8840	PROSOPIS GLANDULOSA / MESQUITE												13	FAIR	
8890	PROSOPIS GLANDULOSA / MESQUITE												15	FAIR	
8891	DIOSPYROS KAKI / PERSIMMON								5					GOOD	
8892	PROSOPIS GLANDULOSA / MESQUITE												17	FAIR	
8906	PROSOPIS GLANDULOSA / MESQUITE												15	FAIR	
8991	PROSOPIS GLANDULOSA / MESQUITE											12		FAIR	
8992	ULMUS AMERICANA / ELM				1 1						8			FAIR	
8993	PROSOPIS GLANDULOSA / MESQUITE												10	FAIR	
8994	PROSOPIS GLANDULOSA / MESQUITE													FAIR	
8995	PROSOPIS GLANDULOSA / MESQUITE													FAIR	
8997	DIOSPYROS KAKI / PERSIMMON		6											GOOD	
8998	DIOSPYROS KAKI / PERSIMMON								5					FAIR	
8999	PROSOPIS GLANDULOSA / MESQUITE						13							FAIR	
9136	PROSOPIS GLANDULOSA / MESQUITE												14.5	FAIR	
	SUB TOTAL INCHES	0	6	0	0	0	23.5	0	33.5	0	8	23.5	169.5		
тот	TAL EXISTING INCHES BY CATEGORY		6		0	2	3.5	33	3.5		8		.93		
TOTA	L PRESERVING INCHES BY CATEGORY		6		0	2	3.5	33	.50	8.	.00	16	9.50		
REQU	JIRED PRESERVATION PERCENTAGE:			FLOOD PLA	N AREA 80%					ESA AREA	TREE 80%				
	PRESERVATION PERCENTAGES =	10	00%	N	/A	100	0.00%	10	0%	10	00%	87	.82%		
	MITIGATION REQUIRED =	0	.00	0	.00	0	0.00	0.	00	0.	.00	0	.00		
TOTAL MITIGATION REQUIRED (CAL. INCHS) =					.00	-		0.00 0.00 0.00			0.00				

STRAND

10003 TECHNOLOGY BLVD. WEST DALLAS, TX. 75220 972-620-8204 REGISTRATION NO: F-1629

CLIENT INFO

DHI COMMUNITIES 5419 NORTH LOOP 1604 EAST, SAN ANTONIO, TX 78247

TE ISSUE INT.

31/2023 CITY COMMENTS

01/2023 ISSUE FOR CONSTRUCTION

11/2023 CLIENT COMMENTS

06/2023 CLIENT COMMENTS - SOD

08/2023 12-8-23 - IFC SET

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SCEND ON JUNO

SCALE: AS SHOWN

DATE: 12/08/2023

DRWN: STRAND

CHKD: STRAND

SHEET TITLE

PRESERVATION CALCULATION

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LANDSCAPE REQUIRMENTS TABLE

LANDSCAPE REQUIRMENTS AND MANDATORY CRITERIA **BUILDING A LAND USE:** A. MITIGATION SUMMARY

TOTAL MITIGATION REQUIRED (CAL.INCI	HES)		295.70		
TREE SPECIES	QTY.	CALIPER INCHES	MITIGATION INCHES		
BIG TOOTH MAPLE	4	1.5	6.00		
PECAN	17	1.5	25.50		
MEXICANA SYCAMORE	29	1.5	43.50		
TEXAS SYCAMORE	31	1.5	46.50		
BUR OAK	38	1.5	57.00		
SHUMARD OAK	38	1.5	57.00		
CEDAR ELM	4	1.5	6.00		
ANACACHO ORCHID TREE	24	1.5	36.00		
MEXICAN REDBUD	121	1.5	181.50		
DESERT WILLOW	123	1.5	184.50		
YAUPON HOLLY	27	1.5	40.50		
TEXAS EBONY	33	1.5	49.50		
TEXAS MOUNTAI LAUREL	16	1.5	24.00		
	TOTAL MITIGA	TION INCHES PROVIDED	757.50		
1	OTAL MITIGATION	I INCHES OUTSTANDING	102		
MITIGATION TO E	BE PAID IN TREE FU	JND (\$ 200.00 PER INCH)	719		

* Trees shall be a minimum of 1.5 caliper inches in size and from the aproved list found in Appendix "E" od City of San Antonio Unified Development

** No more than twenty-five (25) percent of the replacement trees shall be the same species for the purpose of mitigation

*** At least 20% of total protected trees/canopy must be preserved.

EEC	CANOPY COVERAGE											
	TOTAL SITE AREA (S.F.)				1,190,263.0							
	FLOODPLAIN AREA (S.F.)	LOODPLAIN AREA (S.F.)										
	NET AREA	1,179,714.00										
	TOTAL CANOPY REQUIRED (S.F.)		1,179,714.00	X 25%	294,928.50							
	EXIXTING TREE CANOPY PRESERVATION											
	TREE SPECIES	QTY.	CANOPY S.F.	VALUE	CANOPY PROVIDED							
{	DIOSPYROS KAKI / PERSIMMON	18	275	100%	4,950.00							
•	CONDALIA WARNOCKII / CONDALIA	2	275	100%	550.00							
	PROSOPIS GLANDULOSA / MESQUITE	60	550	100%	33,000.00							
	QUERCUS VIRGINIANA / LIVE OAK	2	875	100%	1,750.00							
	SALIX ALBA / WILLOW	1	875	100%	875.00							
	ULMUS AMERICANA / ELM	1	875	100%	875.00							
	TOTAL EXISTIN	G CANOPY	PROVIDED (S.F.)		41,450.00							

TREE SPECIES	QTY.	CANOPY S.F.	VALUE	CANOPY PROVIDED
BIG TOOTH MAPLE	4	550	90%	1,980.00
PECAN	17	1200	90%	18,360.00
MEXICANA SYCAMORE	29	1200	90%	31,320.00
TEXAS SYCAMORE	33,480.00			
BUR OAK	38	1200	90%	41,040.00
SHUMARD OAK	38	1200	90%	41,040.00
CEDAR ELM	4	875	90%	3,150.00
ANACACHO ORCHID TREE	24	275	90%	5,940.00
MEXICAN REDBUD	121	275	90%	29,947.50
DESERT WILLOW	123	275	90%	30,442.50
YAUPON HOLLY	27	275	90%	6,682.50
TEXAS EBONY	33	275	90%	8,167.50
TEXAS MOUNTAI LAUREL	16	275	90%	3,960.00
TOTAL PROPO	OSED CANOPY	PROVIDED (S.F.)		255,510.00
		TOTAL CANO	OPY PROVIDED (S.F.)	296,960.00

* Trees shall be a minimum of 1.5 caliper inches in size and from the aproved list found in Appendix "E" od City of San Antonio Unified Development ** No more than twenty-five (25) percent of the replacement trees shall be the same species for the purpose of mitigation

*** Multi-family and Nonresidential sites require a minimum tree canopy cover of twenty-five (25) percent of the total site area.

TOTAL TO BE PAID IN CANOPY REQUIRMENT TREE FUND (\$200.00 per Inch):

IG LOT SHADING	-			
DADKING LOT ADEA (C.E.)				74 205 00
PARKING LOT AREA (S.F.)		250/		74,385.00
TOTAL SHADE REQUIRED (S.F.)		25%		18,596.25
TOTAL SHADE PROVIDED (S.F.)		63%		47,187.50
PROPOSED TREES IN ISLAND OR PENINSULA				
TREE SPECIES	QTY.	CANOPY S.F.	VALUE	CANOPY PROVIDED
SHUMARD OAK	5	1200	75%	4,500.00
BUR OAK	5	1200	75%	4,500.00
TEXAS SYCAMORE	3	1200	75%	2,700.00
MEXICAN SYCAMORE	8	1200	75%	7,200.00
TOTAL EXISITING CANOPY PROVIDED				18,900.00
PROPOSED TREES ADJACENT TO PARKING LO	Т			
TREE SPECIES	QTY.	CANOPY S.F.	VALUE	CANOPY PROVIDED
BUR OAK	11	1200	50%	6,600.00
PECAN	1	1200	50%	600.00
MEXICAN SYCAMORE	6	1200	50%	3,600.00
TEXAS SYCAMORE	10	1200	50%	6,000.00
SHUMARD OAK	18	1200	50%	10,800.00
ANACACHO ORCHID	3	275	50%	412.50
TEXAS MOUNTAI LAUREL	2	275	50%	275.00
TOTAL EXISITING CANOPY PROVIDED	'			28,287.50
TOTAL TREE CANO	•	S.F.)		47,187.50
POINT	S EARNED			25

* Trees shall be a minimum of 1.5 caliper inches in size and from the aproved list found in Appendix "E" od City of San Antonio Unified Development


** Trees planted adjacent to the parking lot must be within twelve(12) feet from the parking lot to receive credit

*** Minimum square footage for tree planting areas is 162 SF **** Parking areas are parking lot that excluding driveways or garages

TREE PRESERVATION NOTES

- 1. A ROOT PROTECTION ZONE WILL BE ESTABLISHED AROUND EACH TREE OR ANY VEGETATION TO BE PRESERVED TO MEET THE LANDSCAPE OR TREE PRESERVATION ORDINANCES. THE ROOT PROTECTION ZONE SHALL BE AN AREA DEFINED BY THE RADIUS EXTENDING OUTWARD FROM THE TRUNK OF THE TREE A DISTANCE OF ONE (1) LINEAR FOOT FOR EACH INCH DIAMETER INCH AT BREAST HEIGHT (4.5 ') OF THE TREE. A 10-INCH DIAMETER TREE WILL HAVE A 10 FOOT RADIUS
- 2. NO WORK SHALL BEGIN WHERE TREE PROTECTION FENCING HAS NOT BEEN COMPLETED AND APPROVED. TREE PROTECTION FENCING SHALL BE INSTALLED, MAINTAINED AND REPAIRED BY THE CONTRACTOR DURING CONSTRUCTION. THE FENCING WILL BE A MINIMUM OF 4' HEIGHT.
- 3. ALL ROOTS LARGER THAN ONE-INCH IN DIAMETER ARE TO BE CUT CLEANLY AND OAK WOUNDS PAINTED WITHIN 30 MINUTES.
- 4. EXPOSED ROOTS SHALL BE COVERED AT THE END OF THE WORK DAY USING TECHNIQUES SUCH AS COVERING WITH SOIL, MULCH OR WET BURLAP.
- 5. NO EQUIPMENT, VEHICLES OR MATERIALS SHALL BE OPERATED OR STORED WITHIN THE ROOT PROTECTION ZONE. NO CLEAN-OUT AREAS WILL BE CONSTRUCTED SO THAT THE MATERIAL WILL BE IN OR MIGRATE TO THE ROOT PROTECTION
- 6. NO GRADE CHANGE MORE THAN 3" IS ALLOWED WITHIN THE ROOT PROTECTION ZONE.
- 7. ROOTS OR BRANCHES IN CONFLICT WITH CONSTRUCTION SHALL BE CUT CLEANLY ACCORDING TO PROPER PRUNING METHODS. ALL OAK WOUNDS SHALL BE PAINTED WITHIN 20 MINUTES TO PREVENT OAK WILT INFECTION.
- 8. ANY TREE REMOVAL SHALL BE APPROVED BY THE CITY ARBORIST.
- 9. TREES WHICH ARE DAMAGED OR LOST DUE TO THE CONTRACTOR'S NEGLIGENCE DURING CONSTRUCTION SHALL BE MITIGATED.
- 10. TREES MUST BE MAINTAINED IN GOOD HEALTH THROUGHOUT THE CONSTRUCTION PROCESS. MAINTENANCE MAY INCLUDE WATERING THE ROOT PROTECTION ZONE AND OR WASHING FOLIAGE.
- 11. NO WIRES, NAILS OR OTHER MATERIALS MAY BE ATTACHED TO PROTECTED TREES.
- 12. AVOID TRENCHING THROUGH THE CRZ OF PROTECTED TREES. ALTER ROUTES OF UNDERGROUND INFRASTRUCTURE OR USE ALTERNATE METHODS SUCH AS PIPE BORING OR HAND TRENCHING. DO NOT TRENCH OR EXCAVATE THE SOIL WITHIN CRZS. TUNNEL OR BORE AT LEAST 18 INCHES BENEATH CRZS TO INSTALL UTILITY LINES.

TREE PRESERVATION DETAILS

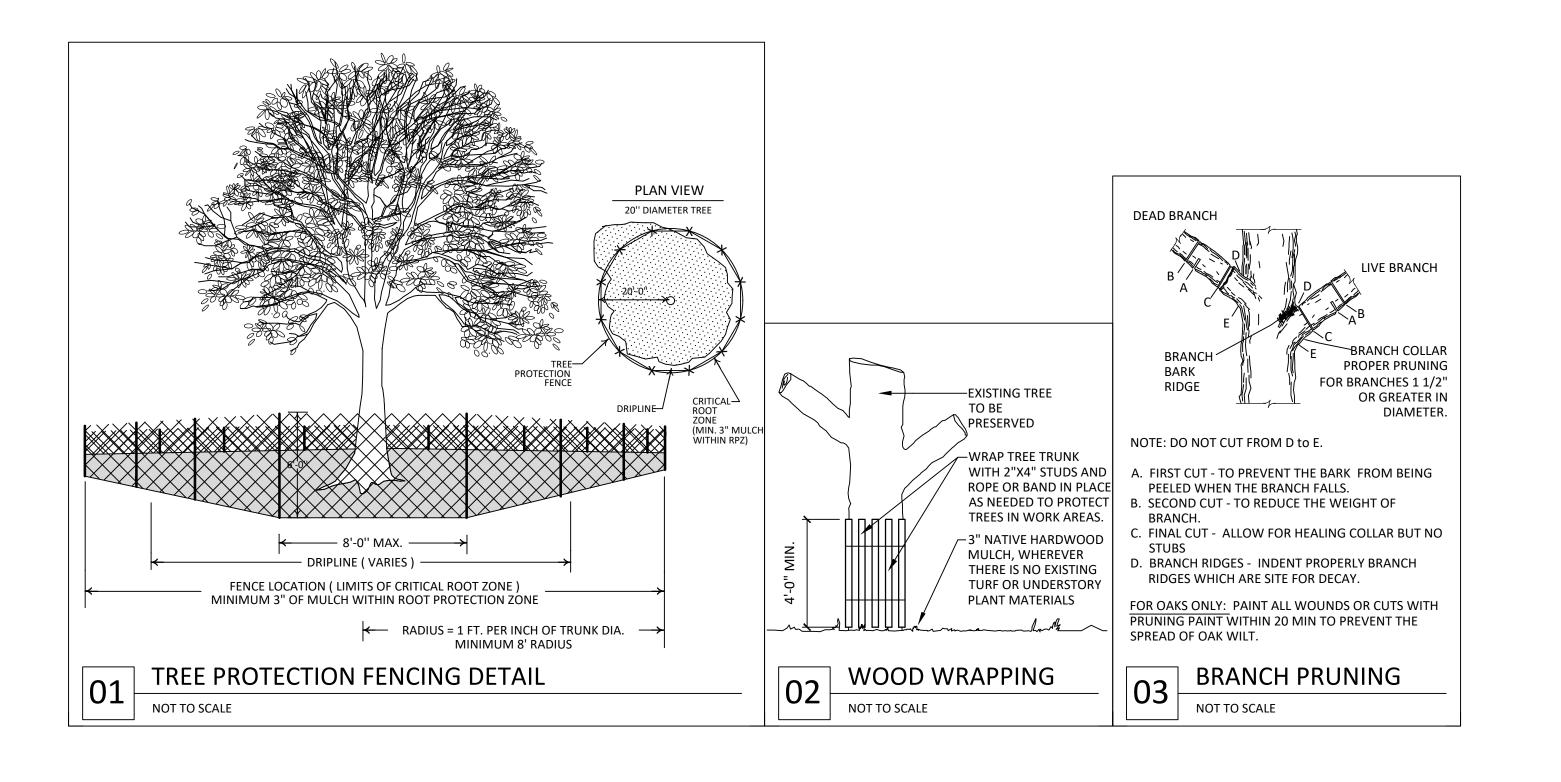


STRAND

10003 TECHNOLOGY BLVD. WEST DALLAS, TX. 75220 972-620-8204 REGISTRATION NO: F-1629

CLIENT INFO

DHI COMMUNITIES 5419 NORTH LOOP 1604 EAST, SAN ANTONIO, TX 78247

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DATE	05/31/2023	08/01/2023	09/11/2023	10/06/2023	12/08/2033	

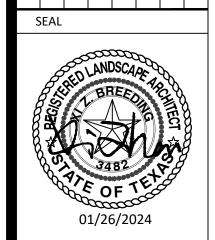

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SCALE: AS SHOWN 12/08/2023

STRAND

CHKD: STRAND

SHEET TITLE

DRWN:

PRESERVATION CALCULATION

SHEET NO.

LT1.12

CONO	CONCRETE/BRICK/STONE_SCHEDULE					
SYMBOL	DESCRIPTION	DETAIL	SPECS	REMARKS		
C-01	GRANITE COUNTERTOP	1/LH2.04	GRANITE COUNTERTOP, 1- 1/4" OR 3/4" THICKNESS,	CONTRACTOR TO PROVIDE SAMPLES OF BOTH 1- 1/4" OR 3/4" THICKNESS, FOR LANDSCAPE ARCHITECT OR OWNER'S REPRESENTATIVE APPROVAL PRIOR TO INSTALLATION.		
C-02	SUNRAY STONE BLOCK	1/LH2.05	2`X2`X4` QUARRY BLOCK, SAW CUT ALL FACES CHOP ENDS; CONTACT: TIM SHANAHAN 405-834-8280; MINICK MATERIALS; OR APPROVED EQUAL	SUBMIT PRODUCT DATA FOR LANDSCAPE ARCHITECT OR OWNER APPROVAL PRIOR TO INSTALLATION		

ELEC	ELECTRICAL_SCHEDULE						
SYMBOL	DESCRIPTION	DETAIL	SPECS	REMARKS			
E-02	BBQ GRILL	1/LH2.04	BBQ GRILL: S36T (PGS T-SERIES 39" STAINLESS STEEL COMMERCIAL GRILL WITH BUILT IN PGS FUELSTOP® 60 MINUTE TIMER); ACCESS DOOR: MDS L39; CONTACT: HTTPS://WWW.AEICORPORATION.COM/	INSTALL PER MANUFACTURER'S INSTRUCTION; SUBMIT PRODUCT DATA FOR LANDCAPE ARCHITECT OR CLIENT REPRESENTATIVE APPROVAL			
E-03	GFCI OUTLET	1/LH2.04	INDUSTRY STANDARD				
E-04	GFCI DUPLEX GROUND-MOUNTED	3/LL2.02	INDUSTRY STANDARD WITH WATER PROOF COVER				

MET	AL SCHEDULE			
SYMBOL	DESCRIPTION	DETAIL	SPECS	REMARKS
M-01	LETTERING	1/LH2.05	1" STANDOFF ALUMINUM LETTERING; COLOR CHARCOAL; PIN MOUNT TO STUCCO BOX; LOCAL SUPPLY	CONTRACTOR SUBMIT SHOP DRAWING FOR LANDSCAPE ARCHITECT OR OWNER'S APPROVAL PRIOR TO INSTALLATION

POOL	SCHEDULE			
SYMBOL	DESCRIPTION	DETAIL	SPECS	REMARKS
PO-01	POOL COPING/CAP	1/LH2.08	NAMARI PRECAST COPING, CLASSIC EASED EDGE, 12X24X2, COLOR TO BE SELECTED BY OWNER, CONTRACTOR TO SUBMIT PRODUCT FOR OWNER REVIEW PRIOR TO INSTALLATION	CONTRACT SUBMIT PRODUCTOR DATA FOR LANDSCAPE ARCHITECT OR OWNER'S APPROVAL PRIOR TO PURCHANCE AND INSTA:ATION
PO-02	POOL TILE	6/LH2.09	SEE DETAIL; OR APPROVED EQUAL	CONTRACTOR TO SUBMIT PRODUCTOR DATA FOR LANDSCAPE ARCHITECT OR OWNER'S APPROVAL PRIOR TO PURCHACE AND INSTALLATION
PO-03	POOL FINISH	7/LH2.09	NPT POLISHEDSCAPES, COLOR: BREAKWATER; CONTACT: WWW.NPTPOOL.COM; OR APPROVED EQUAL	CONTRACT SUBMIT PRODUCTOR DATA FOR LANDSCAPE ARCHITECT OR OWNER'S APPROVAL PRIOR TO PURCHACE AND INSTALLATION

PAVE	MENT SCHEDULE			
SYMBOL	DESCRIPTION	DETAIL	SPECS	REMARKS
PV-01	CONCRETE POOL DECK - ROCK SALT FINISH LIGHT GRAY	5/LH2.01	INTEGRAL COLORED POOL DECK WITH ROK SALT FINISH	SUBMIT 4'X8' MOCK UP FOR LANDSCAPE ARCHITECT OR OWNER'S APPROVAL
PV-02	CONCRETE POOL DECK - ROCK SALT FINISH DARK GRAY	5/LH2.01	INTEGRAL COLO VOIDECK WITH ROK SALT FINISH	SUBMIT 4'X8' MOCK UP FOR LANDSCAPE ARCHITECT OR OWNER'S APPROVAL
PV-03	ENTRY DRIVE - INPRINT CONCRETE	6/LH2.02	PRODUCT PATTERN: ASHLAR SLATE; COLOR: RC: R26 CAPE COD GRAY, BC: P31 GRAY LINEN; CONTACT: SCOTT BALCH 214.624.6511; WWW.BOMANITE.COM; OR APPROVED EQUAL	SUBMIT 4'X8' MOCK UP FOR LANDSCAPE ARCHITECT OR OWNER'S APPROVAL
PV-04	PLAYGROUND SURFACE - ENGINEERED WOOD FIBER	3/LH2.10	SEE DETAIL; OR APPROVED EQUAL	CONTRACTOR SUBMIT PRODUCTION DATA FOR LANDSCAPE ARCHTECT OR OWNER'S APPROVAL PRIOR TO PURCHASE AND INSTALLATION
PV-05	STABILIZED DECOMPOSED GRANITE		LOCAL SOURCE	CONTRACTOR TO SUBMIT PRODUCT DATA FOR LANDSCAPE ARCHITECT OR OWNER'S APPROVAL
PV-06	SYNTHETIC LAWN	7/LH2.02	SEE DETAIL; OR APPROVED EQUAL	SUBMIT PRODUCT DATA FOR LANDSCAPE ARCHITECT OR OWNER'S APPROVAL PRIOR TO INSTALLATION

SYMBOL	DESCRIPTION	DETAIL	SPECS	REMARKS
S-01	PLAY EQUIPMENT	1/LH2.10	SEE DETAIL; OR APPROVED EQUAL	SUBMIT PRODUCT SAMPLE/DATA FOR LANDCAPE ARCHITECT OR OWNER APPROVAL
S-02	DOG TRASH STATION	7/LH2.10	SEE DETAIL; OR APPROVED EQUAL	INSTALL PER MANUFACTURER'S INSTRUCTION; SUBMIT PRODUCT DATA FOR LANDSCAPE ARCHITECT OR OWNER'S APPROVAL
S-03	BENCH	5/LH2.10	SEE DETAIL; OR APPROVED EQUAL	INSTALL PER MANUFACTURER'S INSTRUCTION; SUBMIT PRODUCT DATA FOR LANDSCAPE ARCHITECT OR OWNER'S APPROVAL
S-04	BIKE RACK	8/LH2.10	SEE DETAIL; OR APPROVED EQUAL	INSTALL PER MANUFACTURER'S INSTRUCTION; SUBMIT PRODUCT DATA FOR LANDSCAPE ARCHITECT OR OWNER'S APPROVAL
S-05	FIREPIT (PROPANE)	5/LH2.09	SEE DETAIL; OR APPROVED EQUAL	INSTALL PER MANUFACTURER'S INSTRUCTION; SUBMIT PRODUCT DATA FOR LANDSCAPE ARCHITECT OR OWNER'S APPROVAL PRIOR TO PURCHASE
S-06	TRASH RECEPTACLE	6/LH2.10	SEE DETAIL; OR APPROVED EQUAL	INSTALL PER MANUFACTURER'S INSTRUCTION; SUBMIT PRODUCT DATA FOR LANDSCAPE ARCHITECT OR OWNER'S APPROVAL
S-07	PLAYGROUND TRASH RECEPTACLE	2/LH2.10	SEE DETAIL; OR APPROVED EQUAL	INSTALL PER MANUFACTURER'S INSTRUCTION; SUBMIT PRODUCT DATA FOR LANDSCAPE ARCHITECT OR OWNER'S APPROVAL
S-08	PICNIC TABLE	4/LH2.10	SEE DETAIL; OR APPROVED EQUAL	INSTALL PER MANUFACTURER'S INSTRUCTION; SUBMIT PRODUCT DATA FOR LANDSCAPE ARCHITECT OR OWNER'S APPROVAL
S-09	DOWNSPOUT SPLASH PAD	5/LH1.11	INDUSTRY STANDARD	SUBMIT PRODUCT SAMPLE/DATA FOR LANDCAPE ARCHITECT OR OWNER APPROVAL

10003 TECHNOLOGY BLVD. WEST DALLAS, TX. 75220 972-620-8204 REGISTRATION NO: F-1629

CLIENT INFO

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DATE	05/31/2023	08/01/2023	09/11/2023	10/06/2023	12/08/2023	
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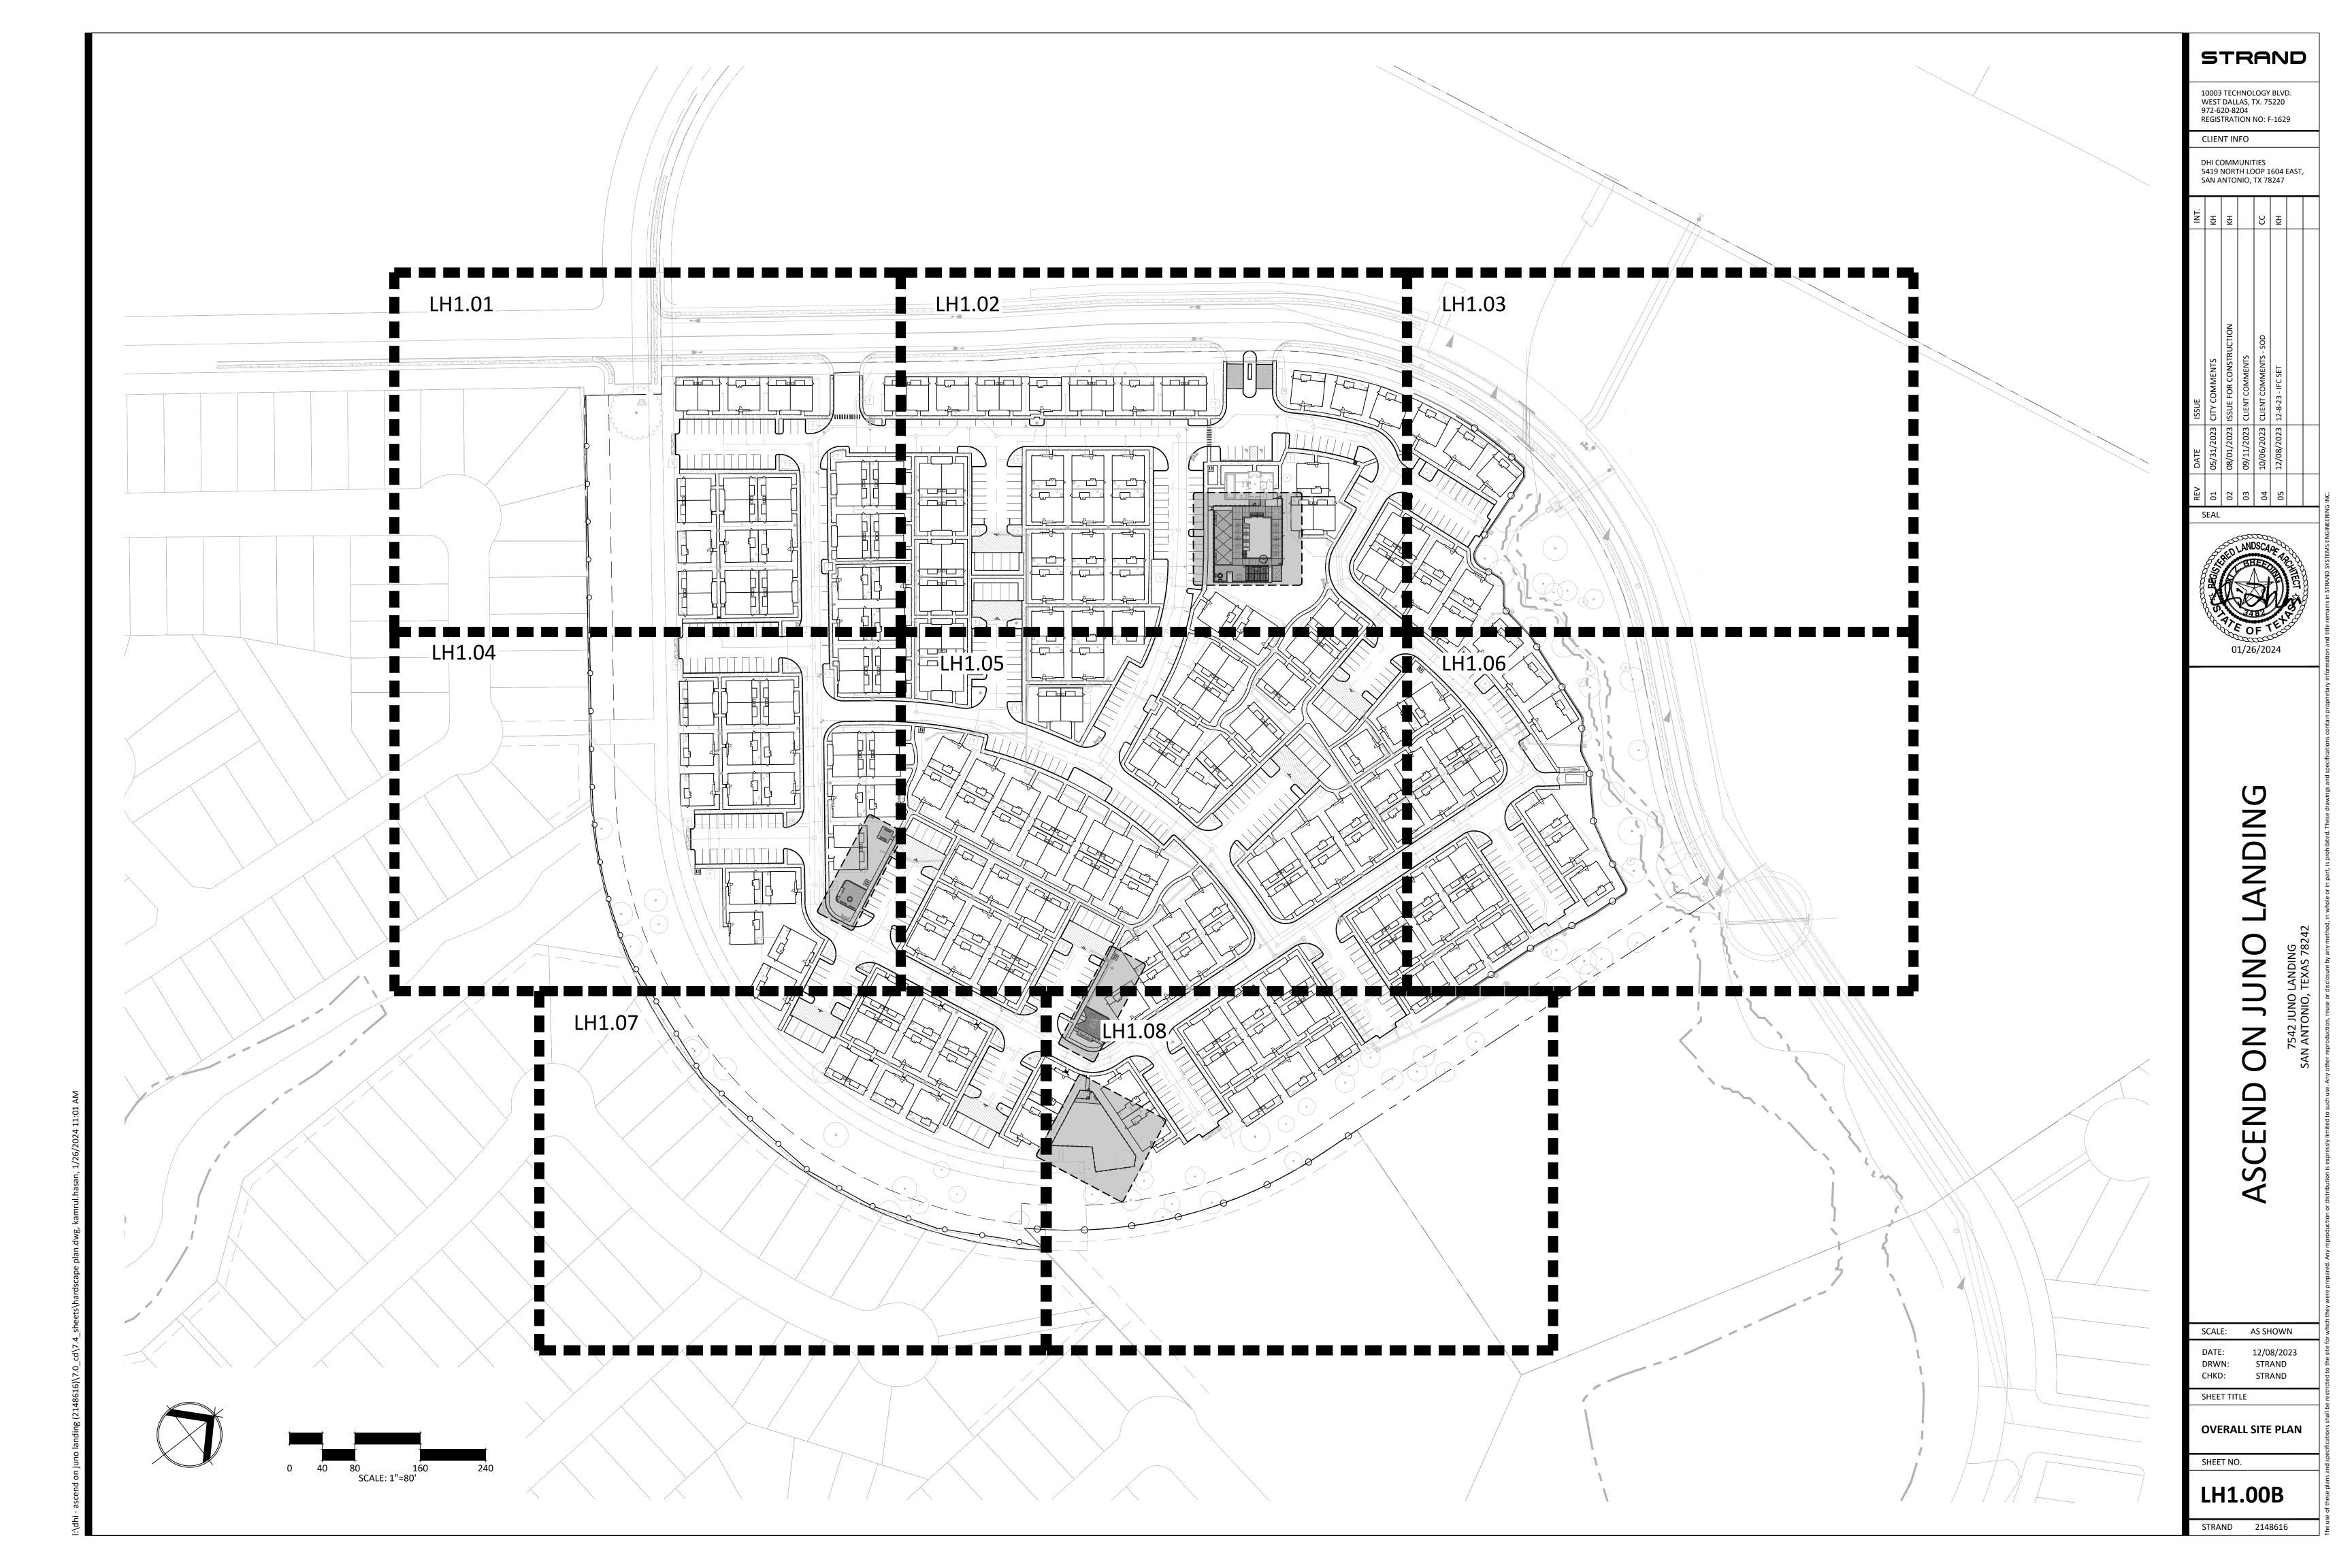
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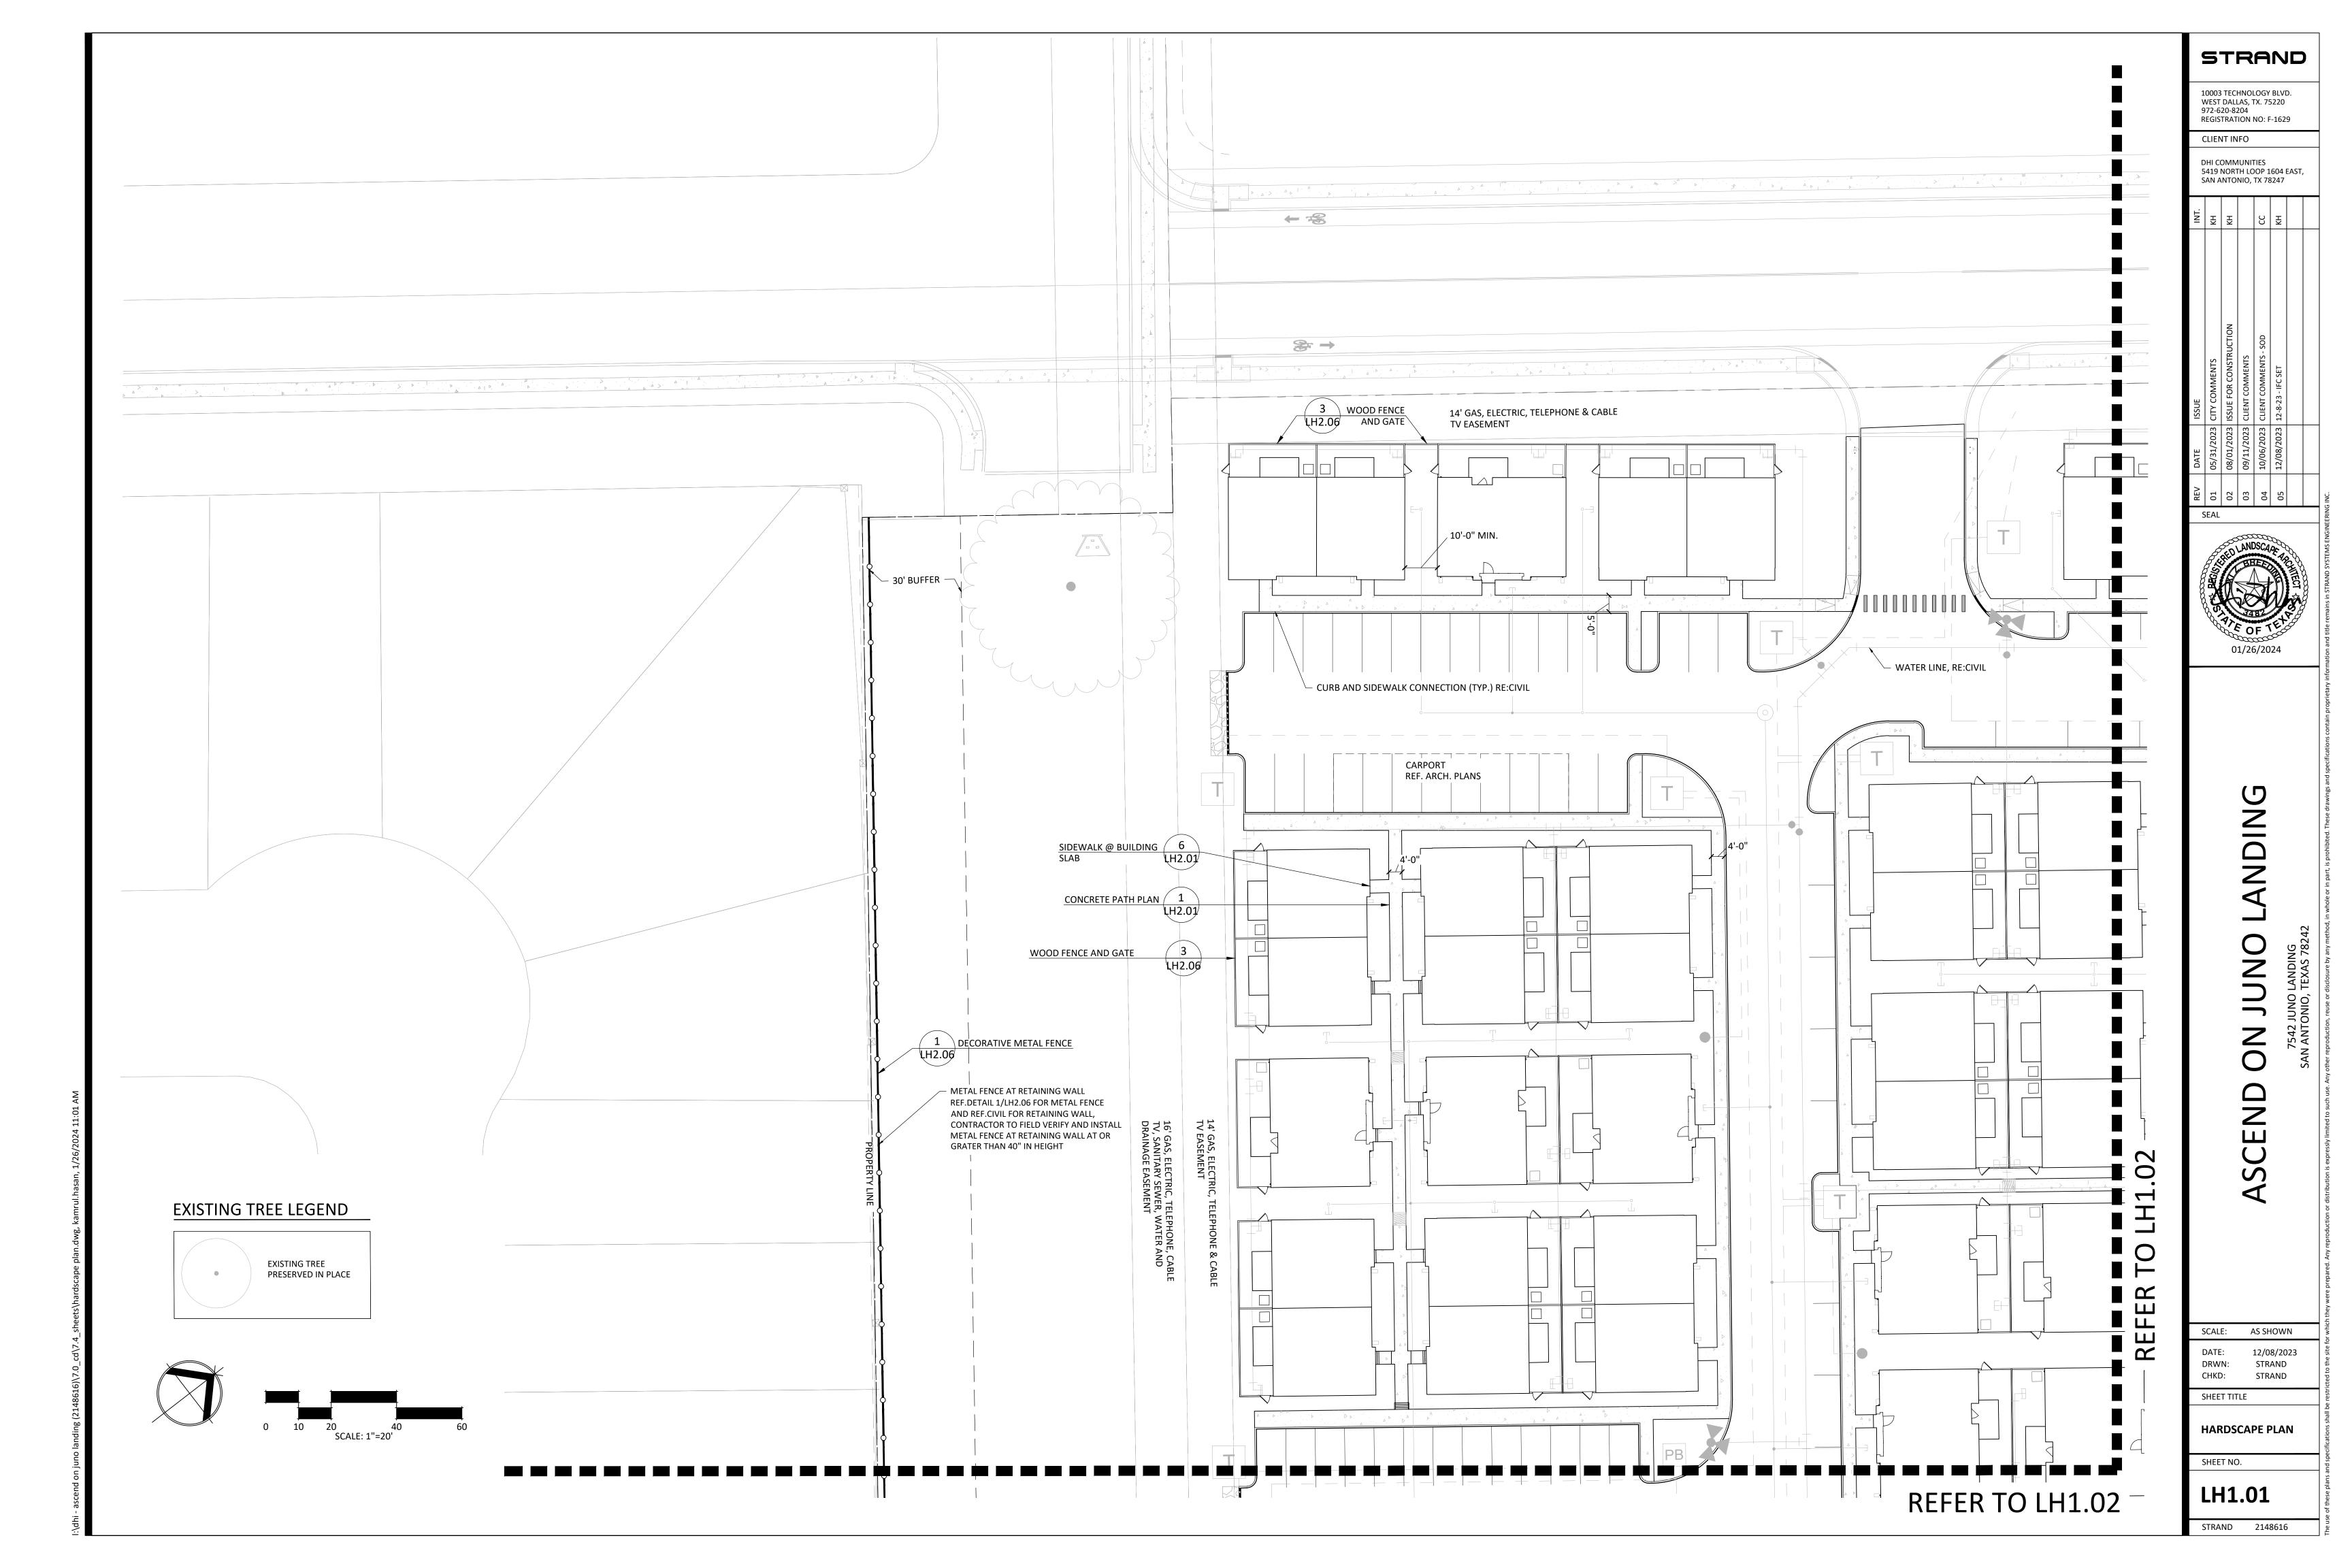
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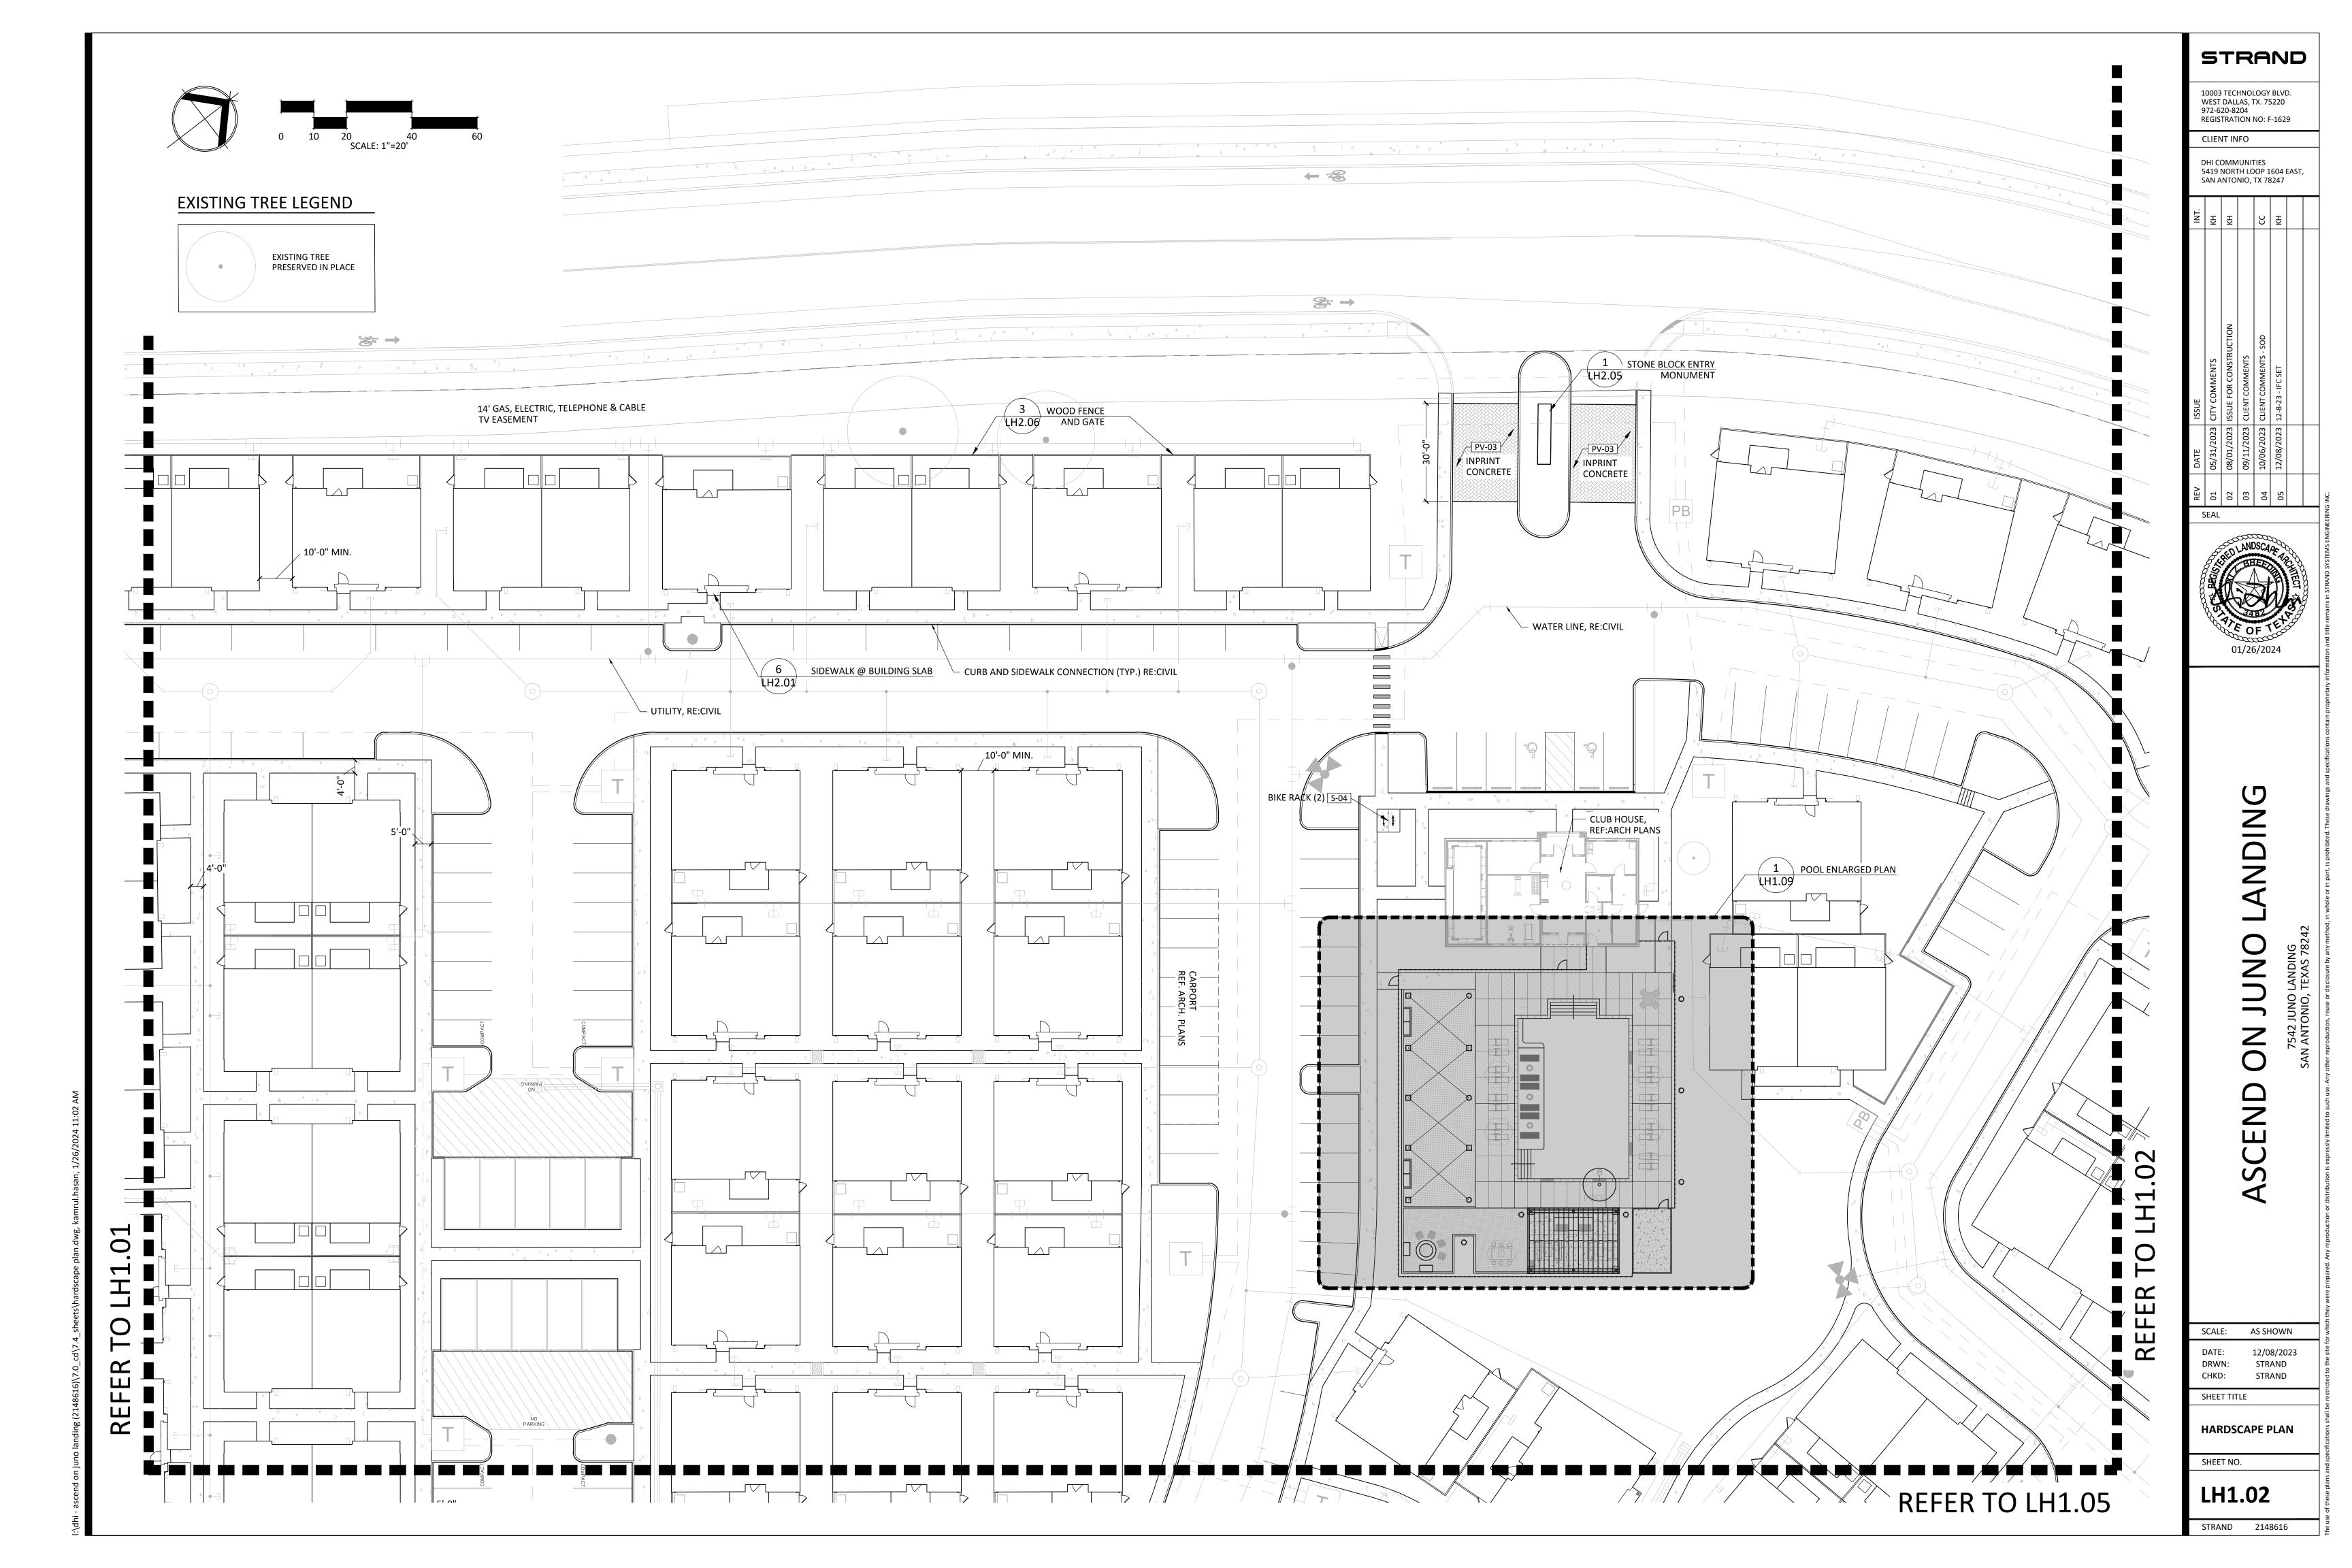
HARDSCAPE SCHEDULE


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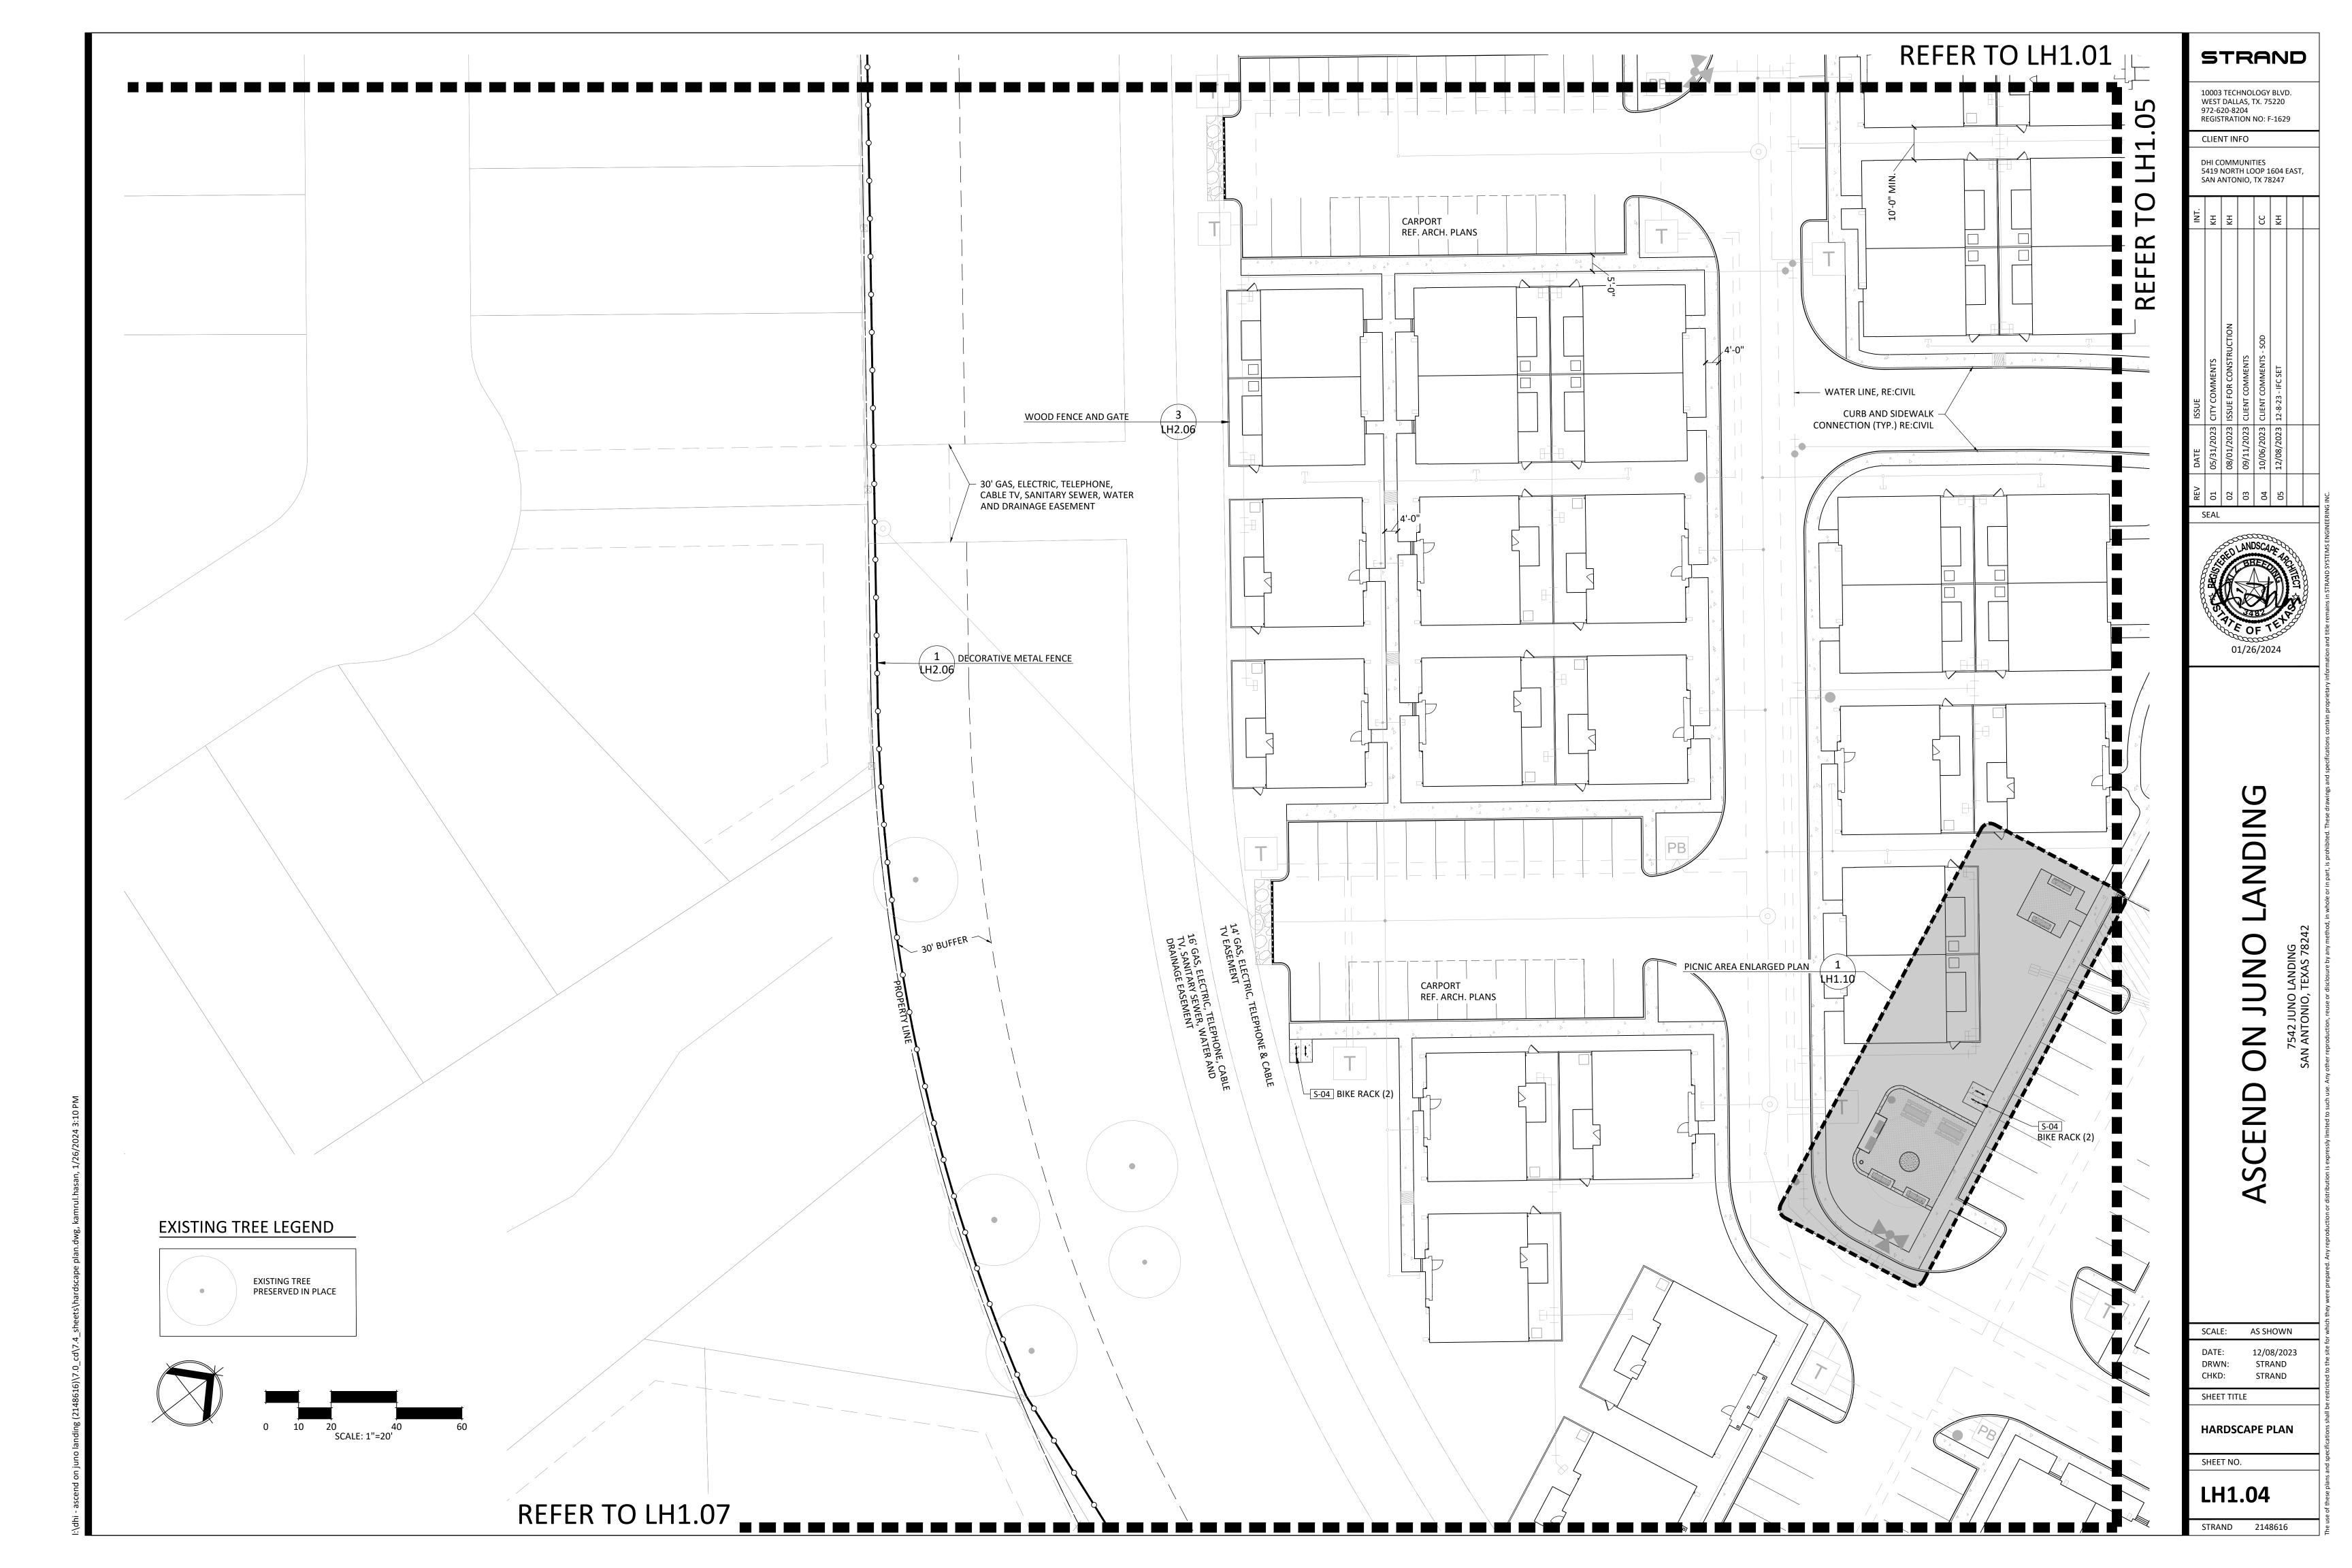



DHI COMMUNITIES 5419 NORTH LOOP 1604 EAST, SAN ANTONIO, TX 78247

SCALE: AS SHOWN


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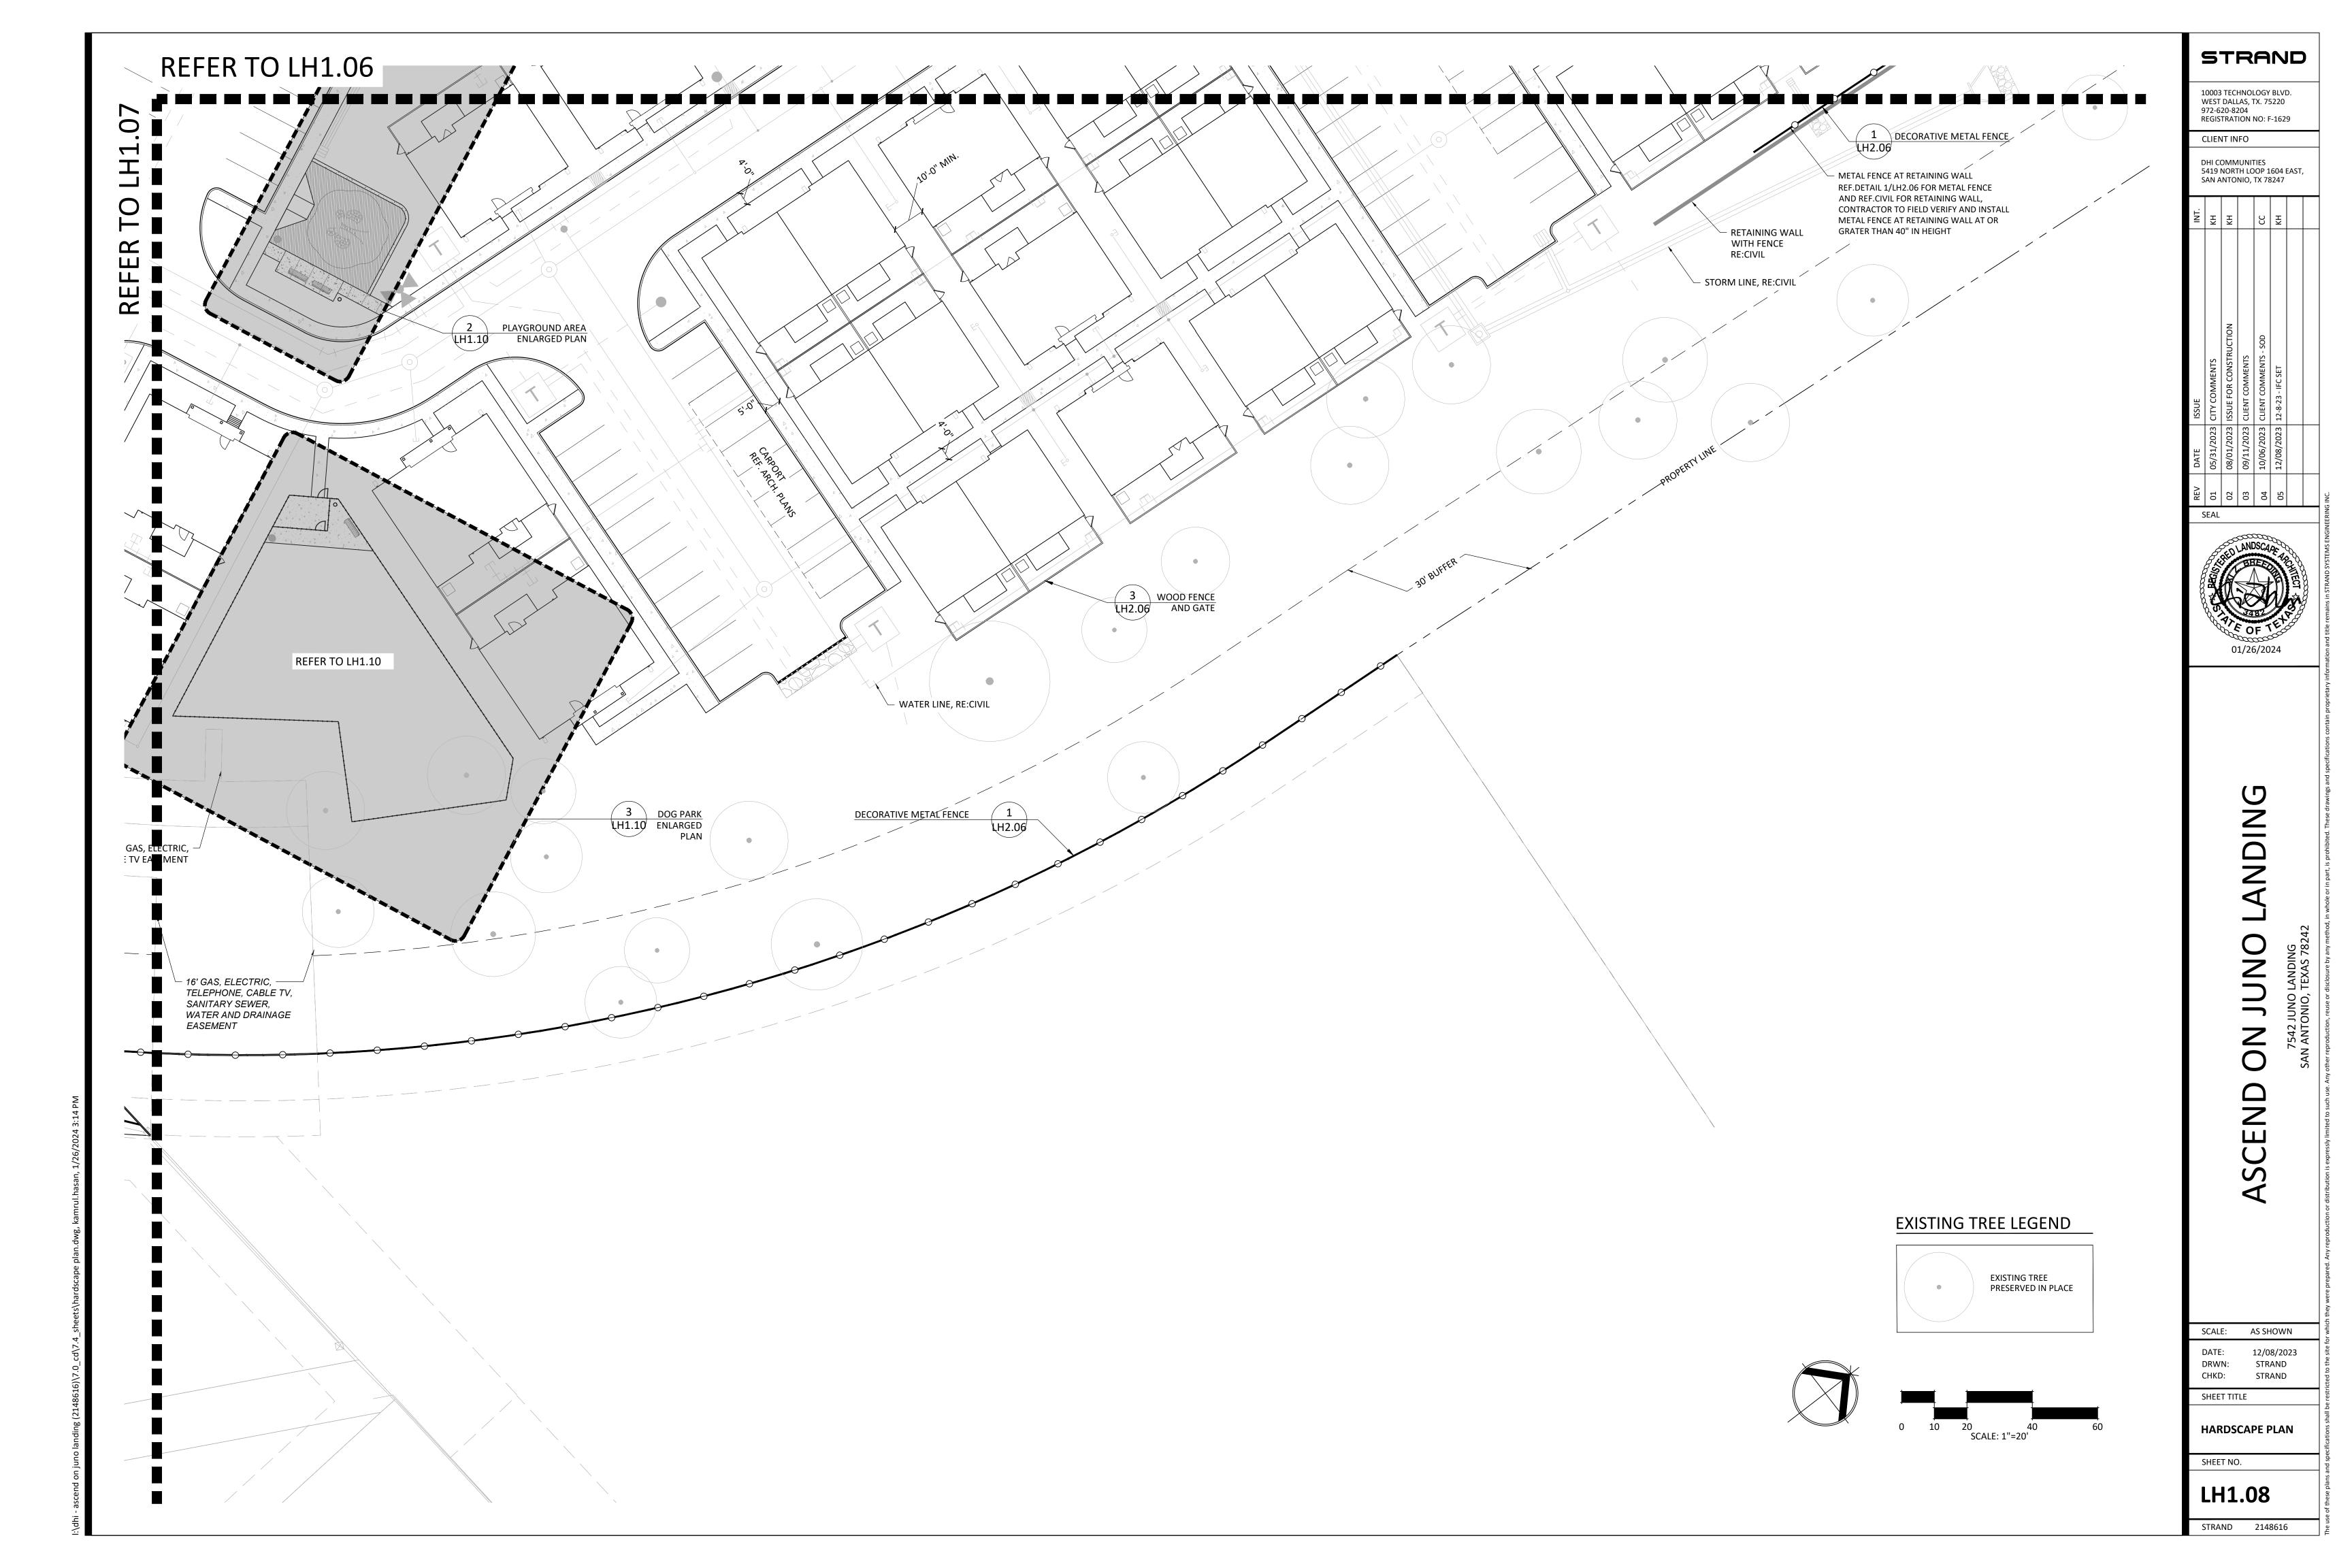
HARDSCAPE PLAN



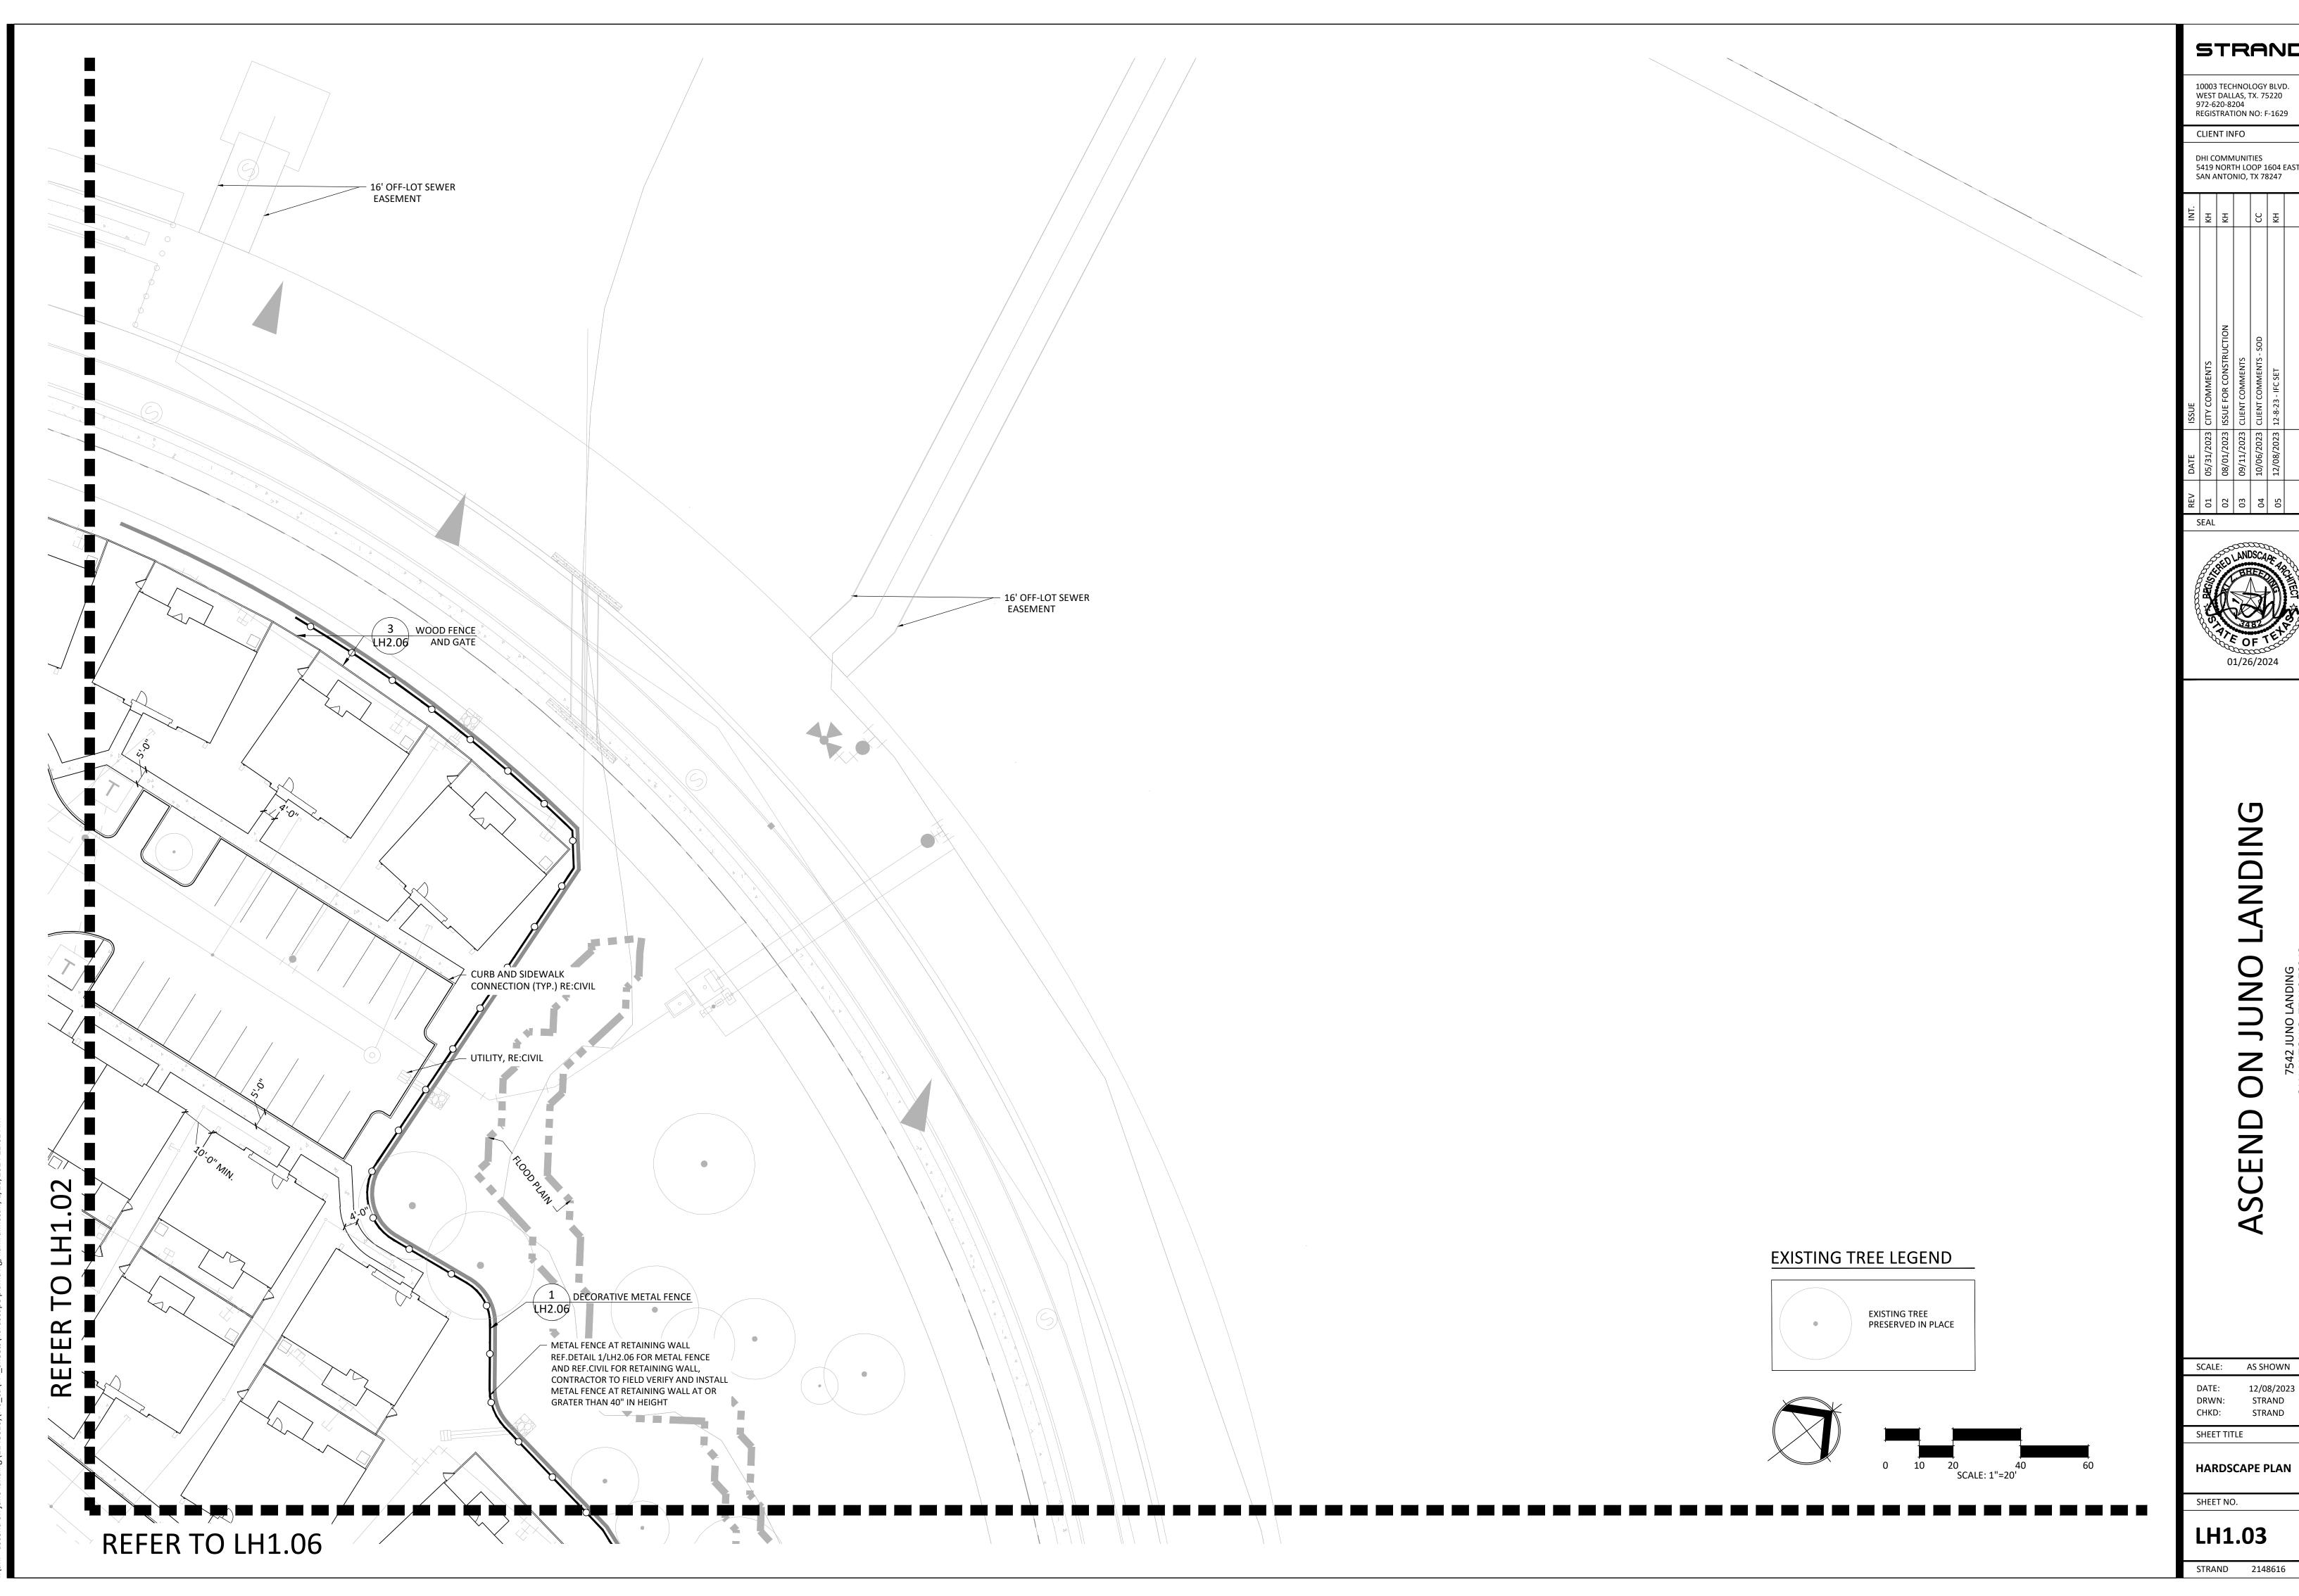

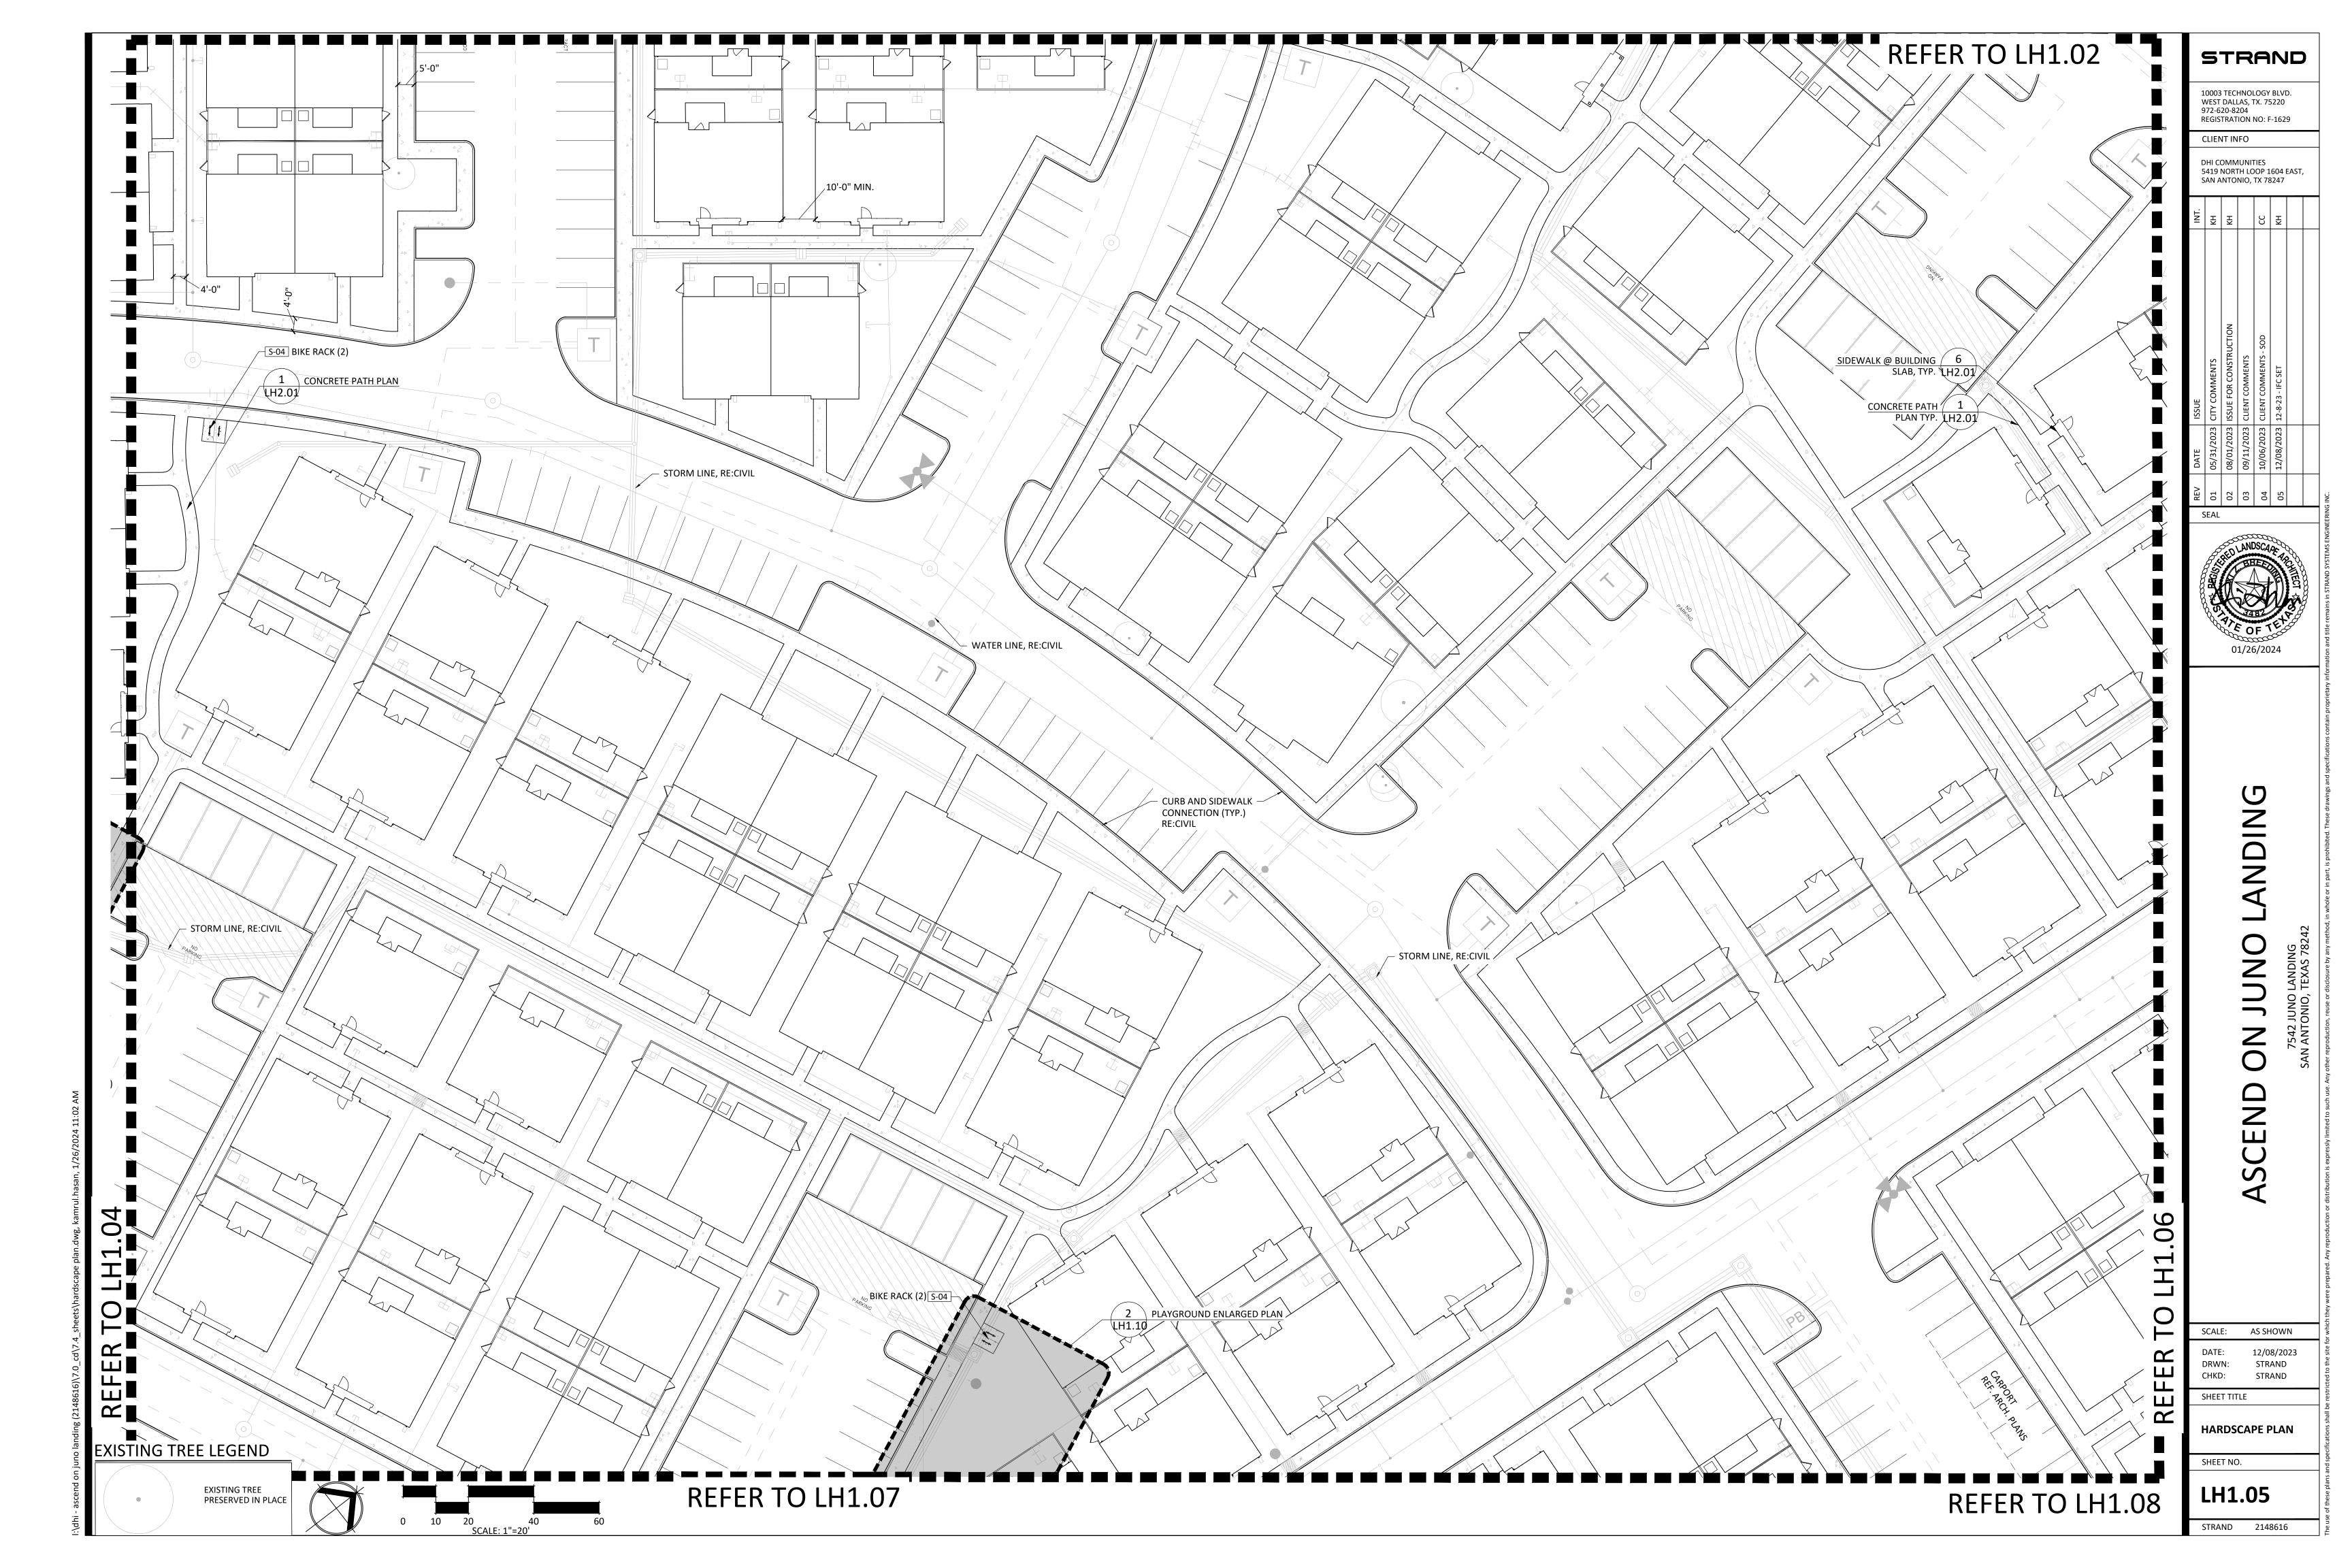




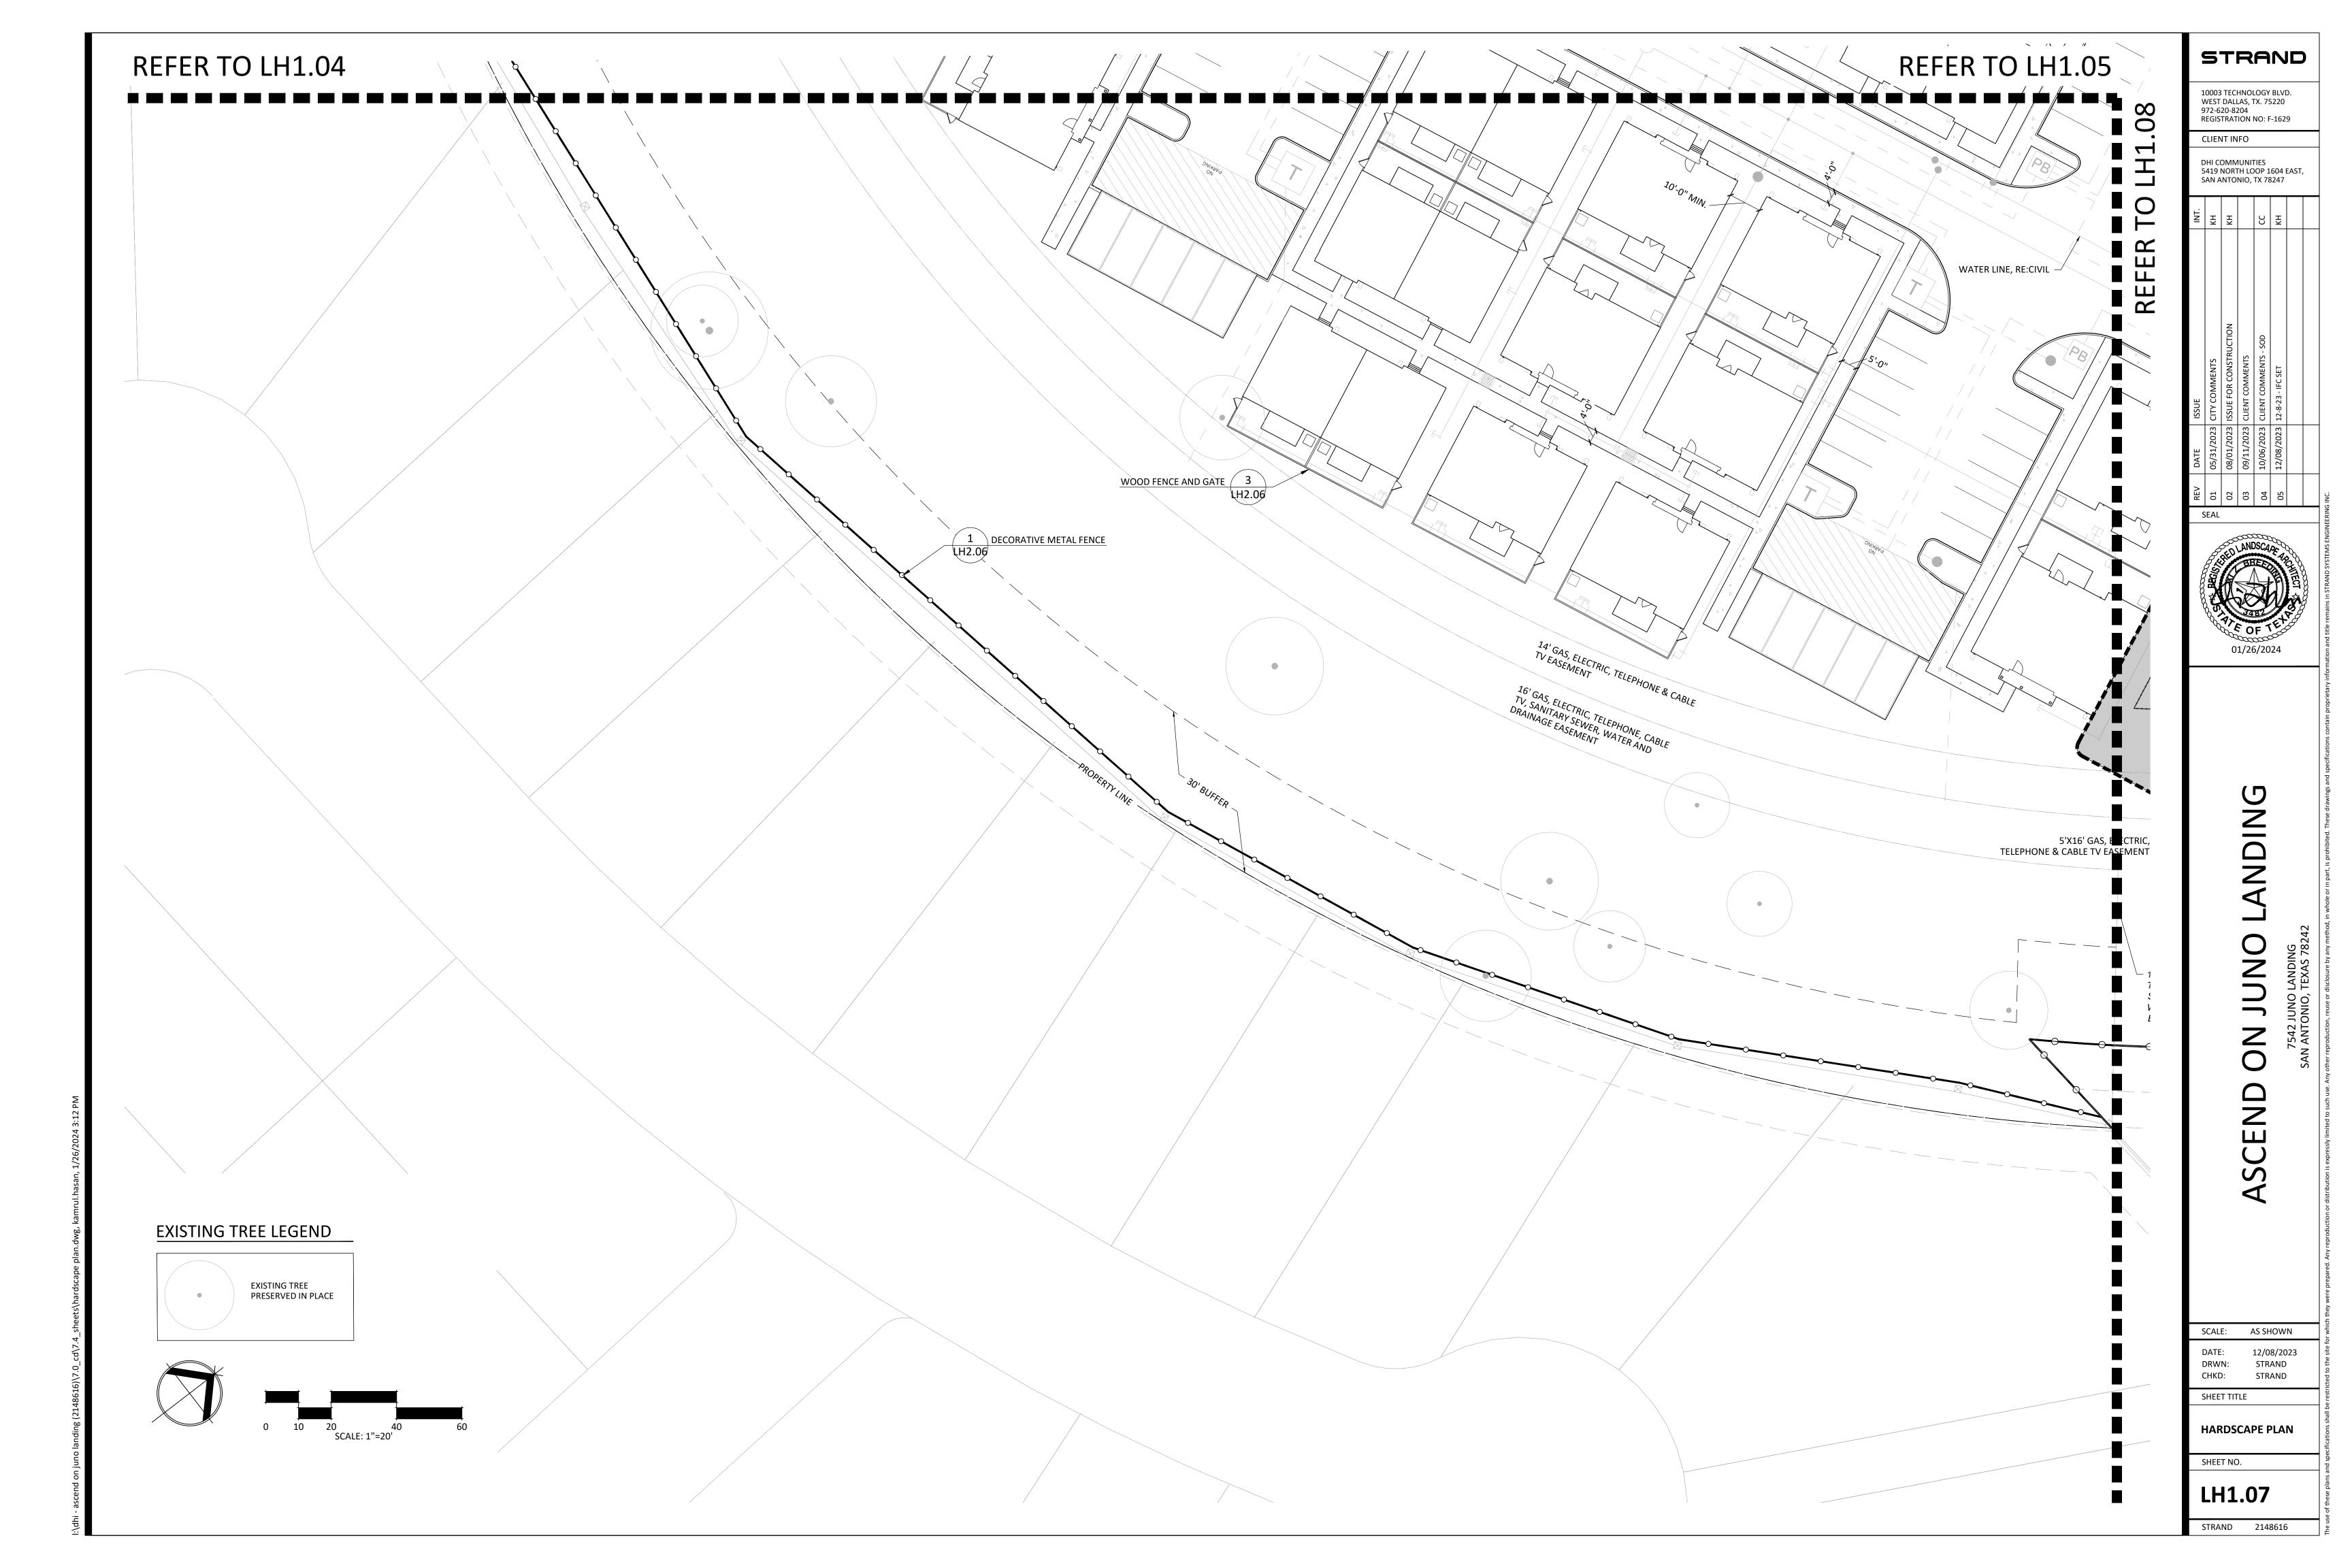



- 1. POOL SHALL COMPLY WITH ALL CURRENT TEXAS DEPARTMENT OF HEALTH STANDARDS FOR SWIMMING POOLS STANDARDS AND REGULATIONS.
- 2. CONTRACTOR TO SUBMIT ALL NECESSARY TECHNICAL CALCULATIONS, PLANS, DETAILS, AND SPECIFICATIONS TO LOCAL AND STATE JURISDICTIONAL AGENCIES FOR POOL PERMITTING.
- 3. CONTRACTOR SHALL BE RESPONSIBLE FOR ALL APPLICATIONS AND FEES.
- 4. CONTRACTOR SHALL SUBMIT A FULL SET OF SHOP DRAWINGS TO OWNER/LANDSCAPE ARCHITECT FOR REVIEW PRIOR TO SUBMITTING APPLICATION TO LOCAL AND STATE AGENCIES. DRAWINGS SHALL INCLUDED BUT NOT LIMITED TO REGULATORY COMPLIANCE TABLES, TECHNICAL INFORMATION, SUPPLIER SCHEDULE AND DETAILS, STRUCTURAL PLANS, ELECTRICAL PLANS, PLUMBING PLANS, MECHANICAL PLANS, POOL DETAILS, ETC.
- 5. CONTRACTOR SHALL SUBMIT SAMPLES FOR APPROVAL TO OWNER/LANDSCAPE ARCHITECT FOR COPING, WATERLINE TILE, TOE TILE, POOL FINISH, ETC PRIOR TO APPLICATION SUBMITTAL, ORDERING OF MATERIAL AND BEGINNING OF CONSTRUCTION.
- 6. POOL TILE AND FINISH COLOR TO BE DETERMINED BY LANDSCAPE ARCHITECT/OWNER.
- 7. A MINIMUM 4-FOOT BARRIER FENCE AND/OR WALL HAVE BEEN INCLUDED AROUND THE PERIMETER OF THE SWIMMING POOL THAT COMPLIES WITH LOCAL POOL CODE. NO FOOTHOLDS OR HANDHOLDS HAVE BEEN INCLUDED WITHIN THIS FENCE AND/OR WALL.
- 8. SELF CLOSING/LATCHING GATES SHALL BE PROVIDED PER CURRENT TEXAS DEPARTMENT OF HEALTH STANDARDS FOR SWIMMING POOLS AND SPAS.
- 9. 4 INCH MAXIMUM CLEARANCE BETWEEN ALL FENCE AND BUILDING/COLUMN CONNECTION POINTS.
- 10. FENCE AND/OR WALLS TO COMPLETELY ENCLOSE POOL AREA.
- 11. REFER TO ARCHITECTURAL PLANS FOR WINDOW / PATIO RAILING DETAILS THAT ARE WITHIN THE POOL AMENITY AREA.
- 12. REFER TO PLANS BY POOL CONTRACTOR FOR POOL, POOL DECK, ELECTRICAL, PLUMBING DESIGN AND DETAILS.
- 13. POOL NOTIFICATION SIGNAGE SHALL BE LOCATED AT ALL ENTRANCE POINTS LEADING INTO THE POOL/AMENITY AREA. SIGNAGE SHALL INDICATE NO GLASS IS TO BE ALLOWED WITHIN THE POOL AREA.
- 14. POOL OPERATION HOURS SIGNAGE SHALL BE INDICATED ON POOL NOTIFICATION SIGNAGE. SIGNAGE SHALL BE LOCATED IN A WELL-LIT LOCATION.
- 15. OUTDOOR POOL FURNITURE PROVIDED BY OWNER

PAVII	NG SCHEDULE	
SYMBOL	DESCRIPTION	DETAIL
PV-01	CONCRETE POOL DECK - ROCK SALT FINISH LIGHT GRAY	5/LH2.01
PV-02	CONCRETE POOL VOID K SALT FINISH DARK GRA	5/LH2.01
PV-03	ENTRY DRIVE - INPRINT CONCRETE	6/LH2.02
PV-04	PLAYGROUND SURFACE - ENGINEERED WOOD FIBER	3/LH2.10
PV-05	STABILIZED DECOMPOSED GRANITE	
PV-06	SYNTHETIC LAWN	7/LH2.02
SITE	FURNISHINGS SCHEDUL	E.
SYMBOL	DESCRIPTION	DETAIL
S-01	PLAY EQUIPMENT	1/LH2.10
S-03	BENCH	5/LH2.10
S-04	BIKE RACK	8/LH2.10
S-05	FIREPIT (PROPANE)	5/LH2.09
S-06	TRASH RECEPTACLE	6/LH2.10
S-07	PLAYGROUND TRASH RECEPTACLE	2/LH2.10

S-08 PICNIC TABLE 4/LH2.10 NOTE: QUANTITIES ONLY REFLECT THE ITEMS ON THIS PAGE.

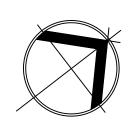

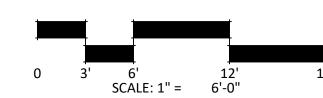


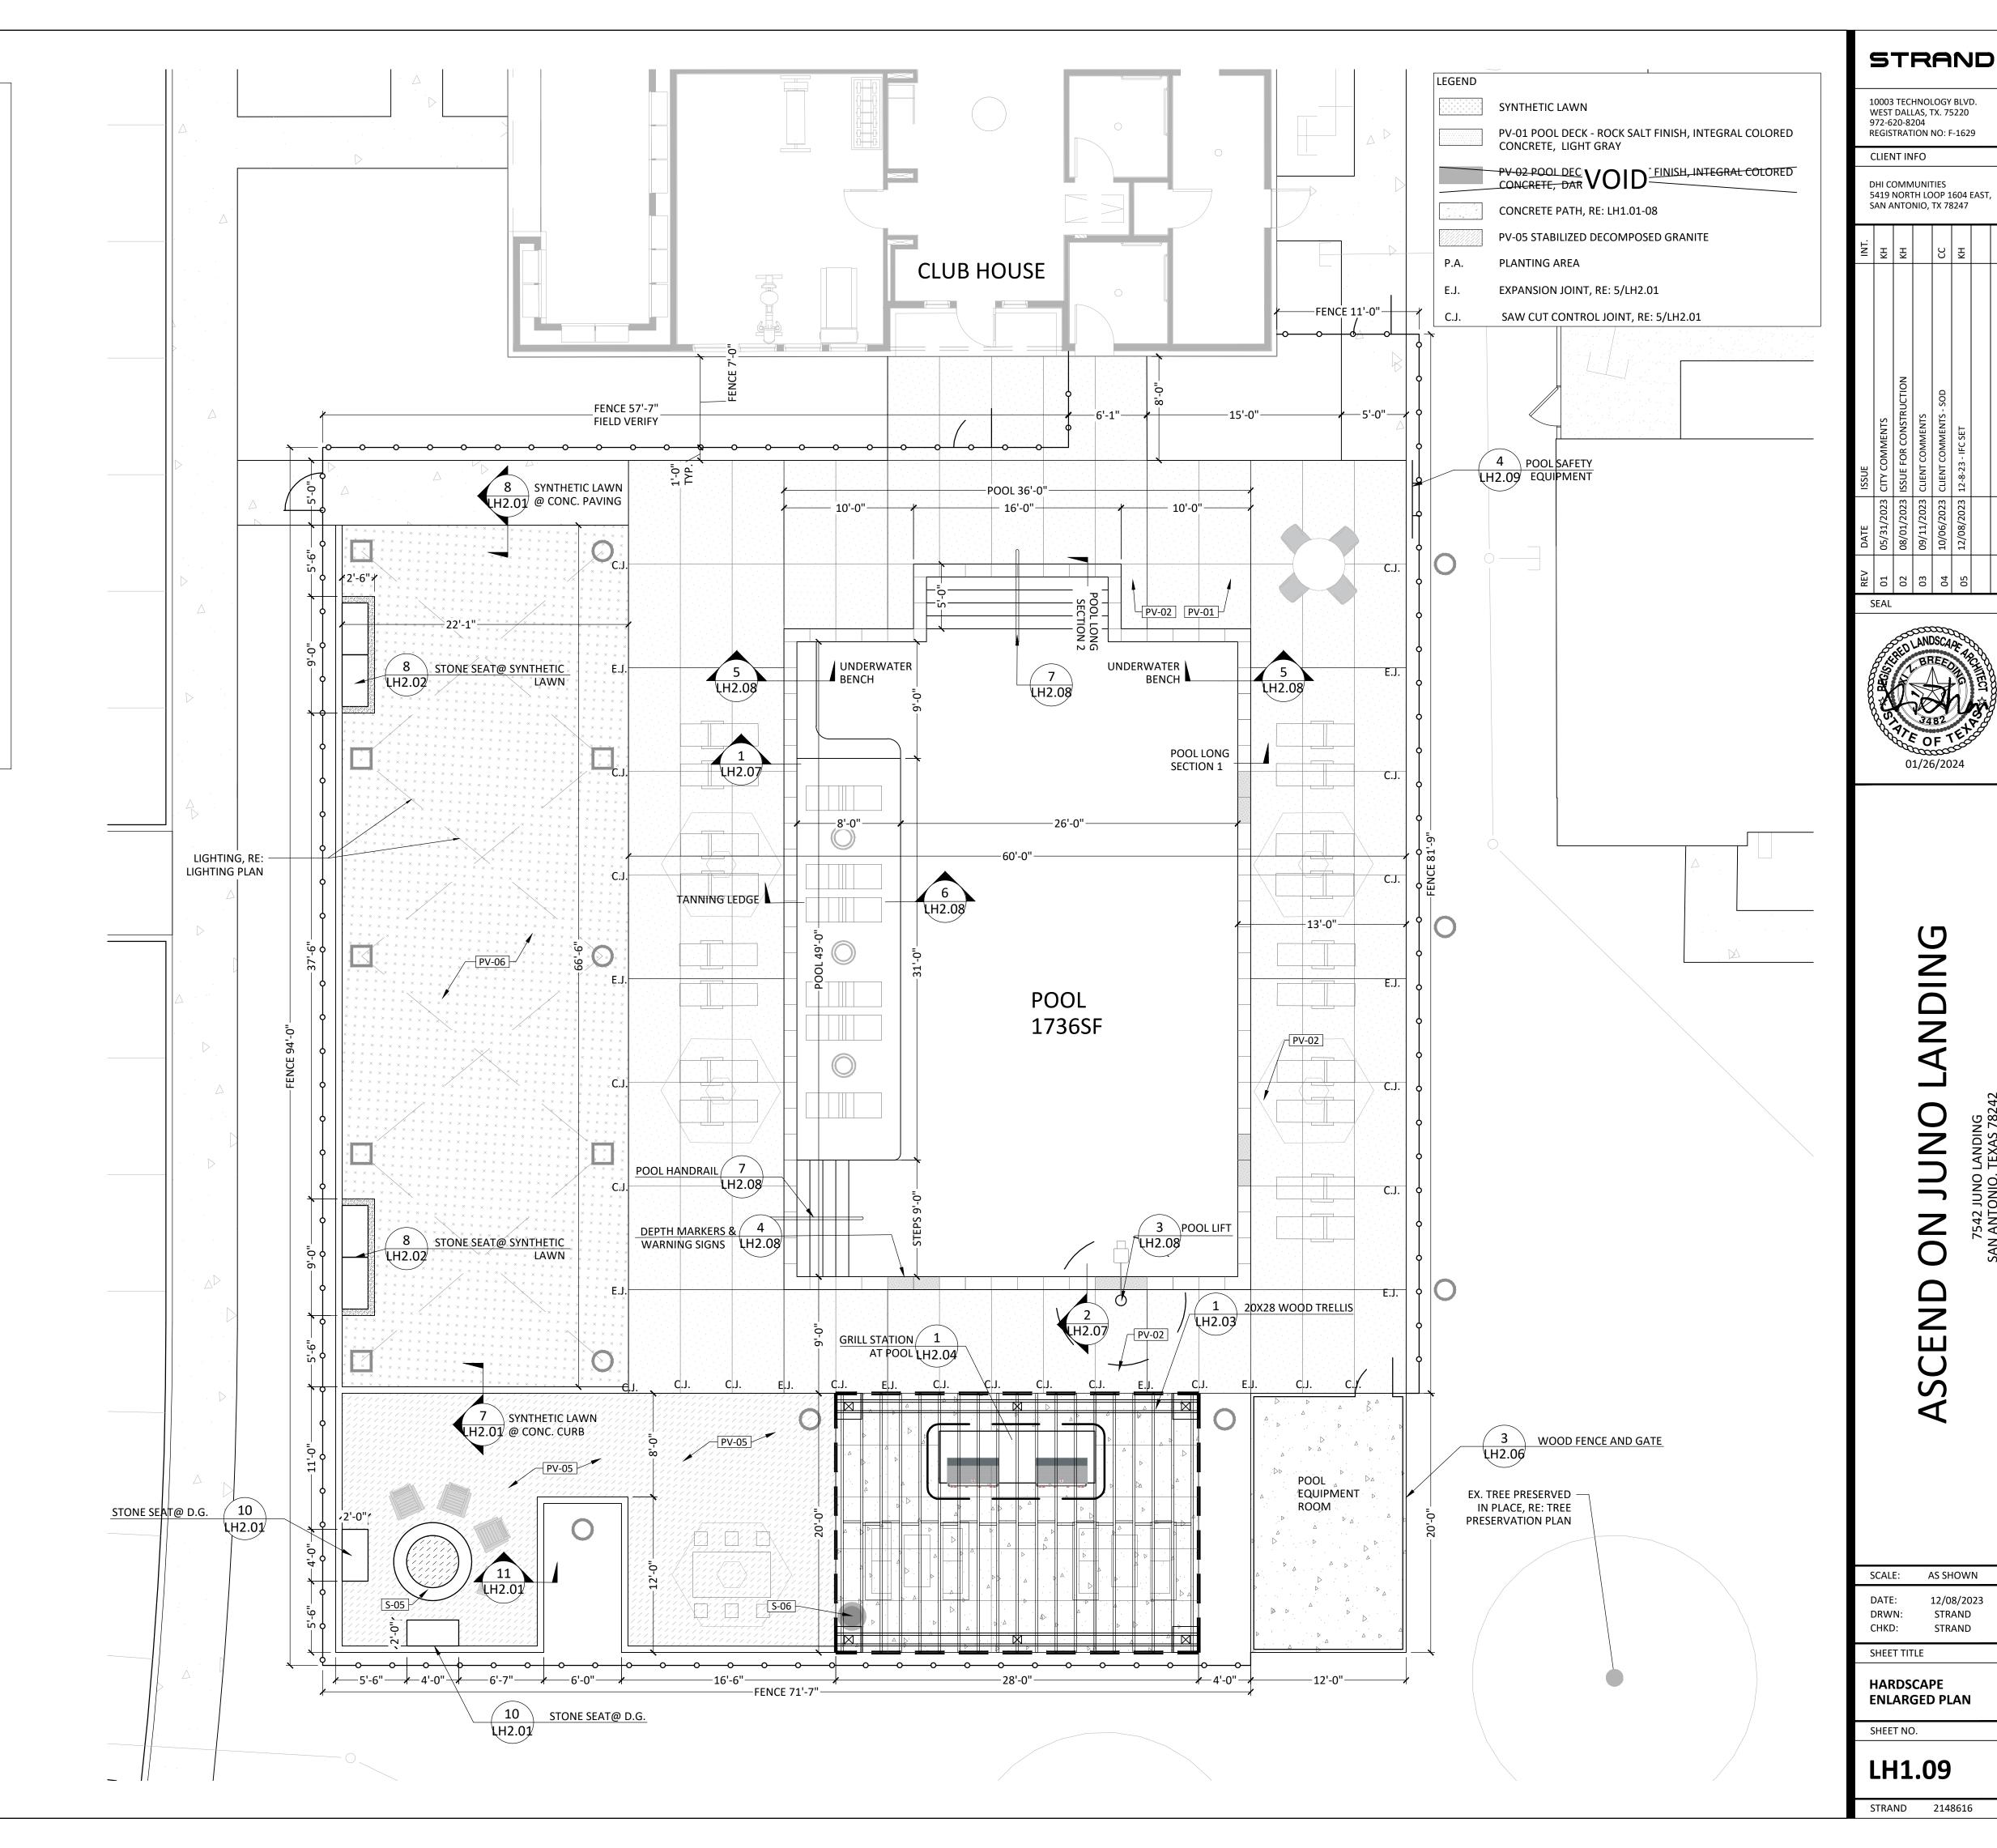

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10003 TECHNOLOGY BLVD. WEST DALLAS, TX. 75220 972-620-8204 REGISTRATION NO: F-1629

CLIENT INFO

DHI COMMUNITIES 5419 NORTH LOOP 1604 EAST,

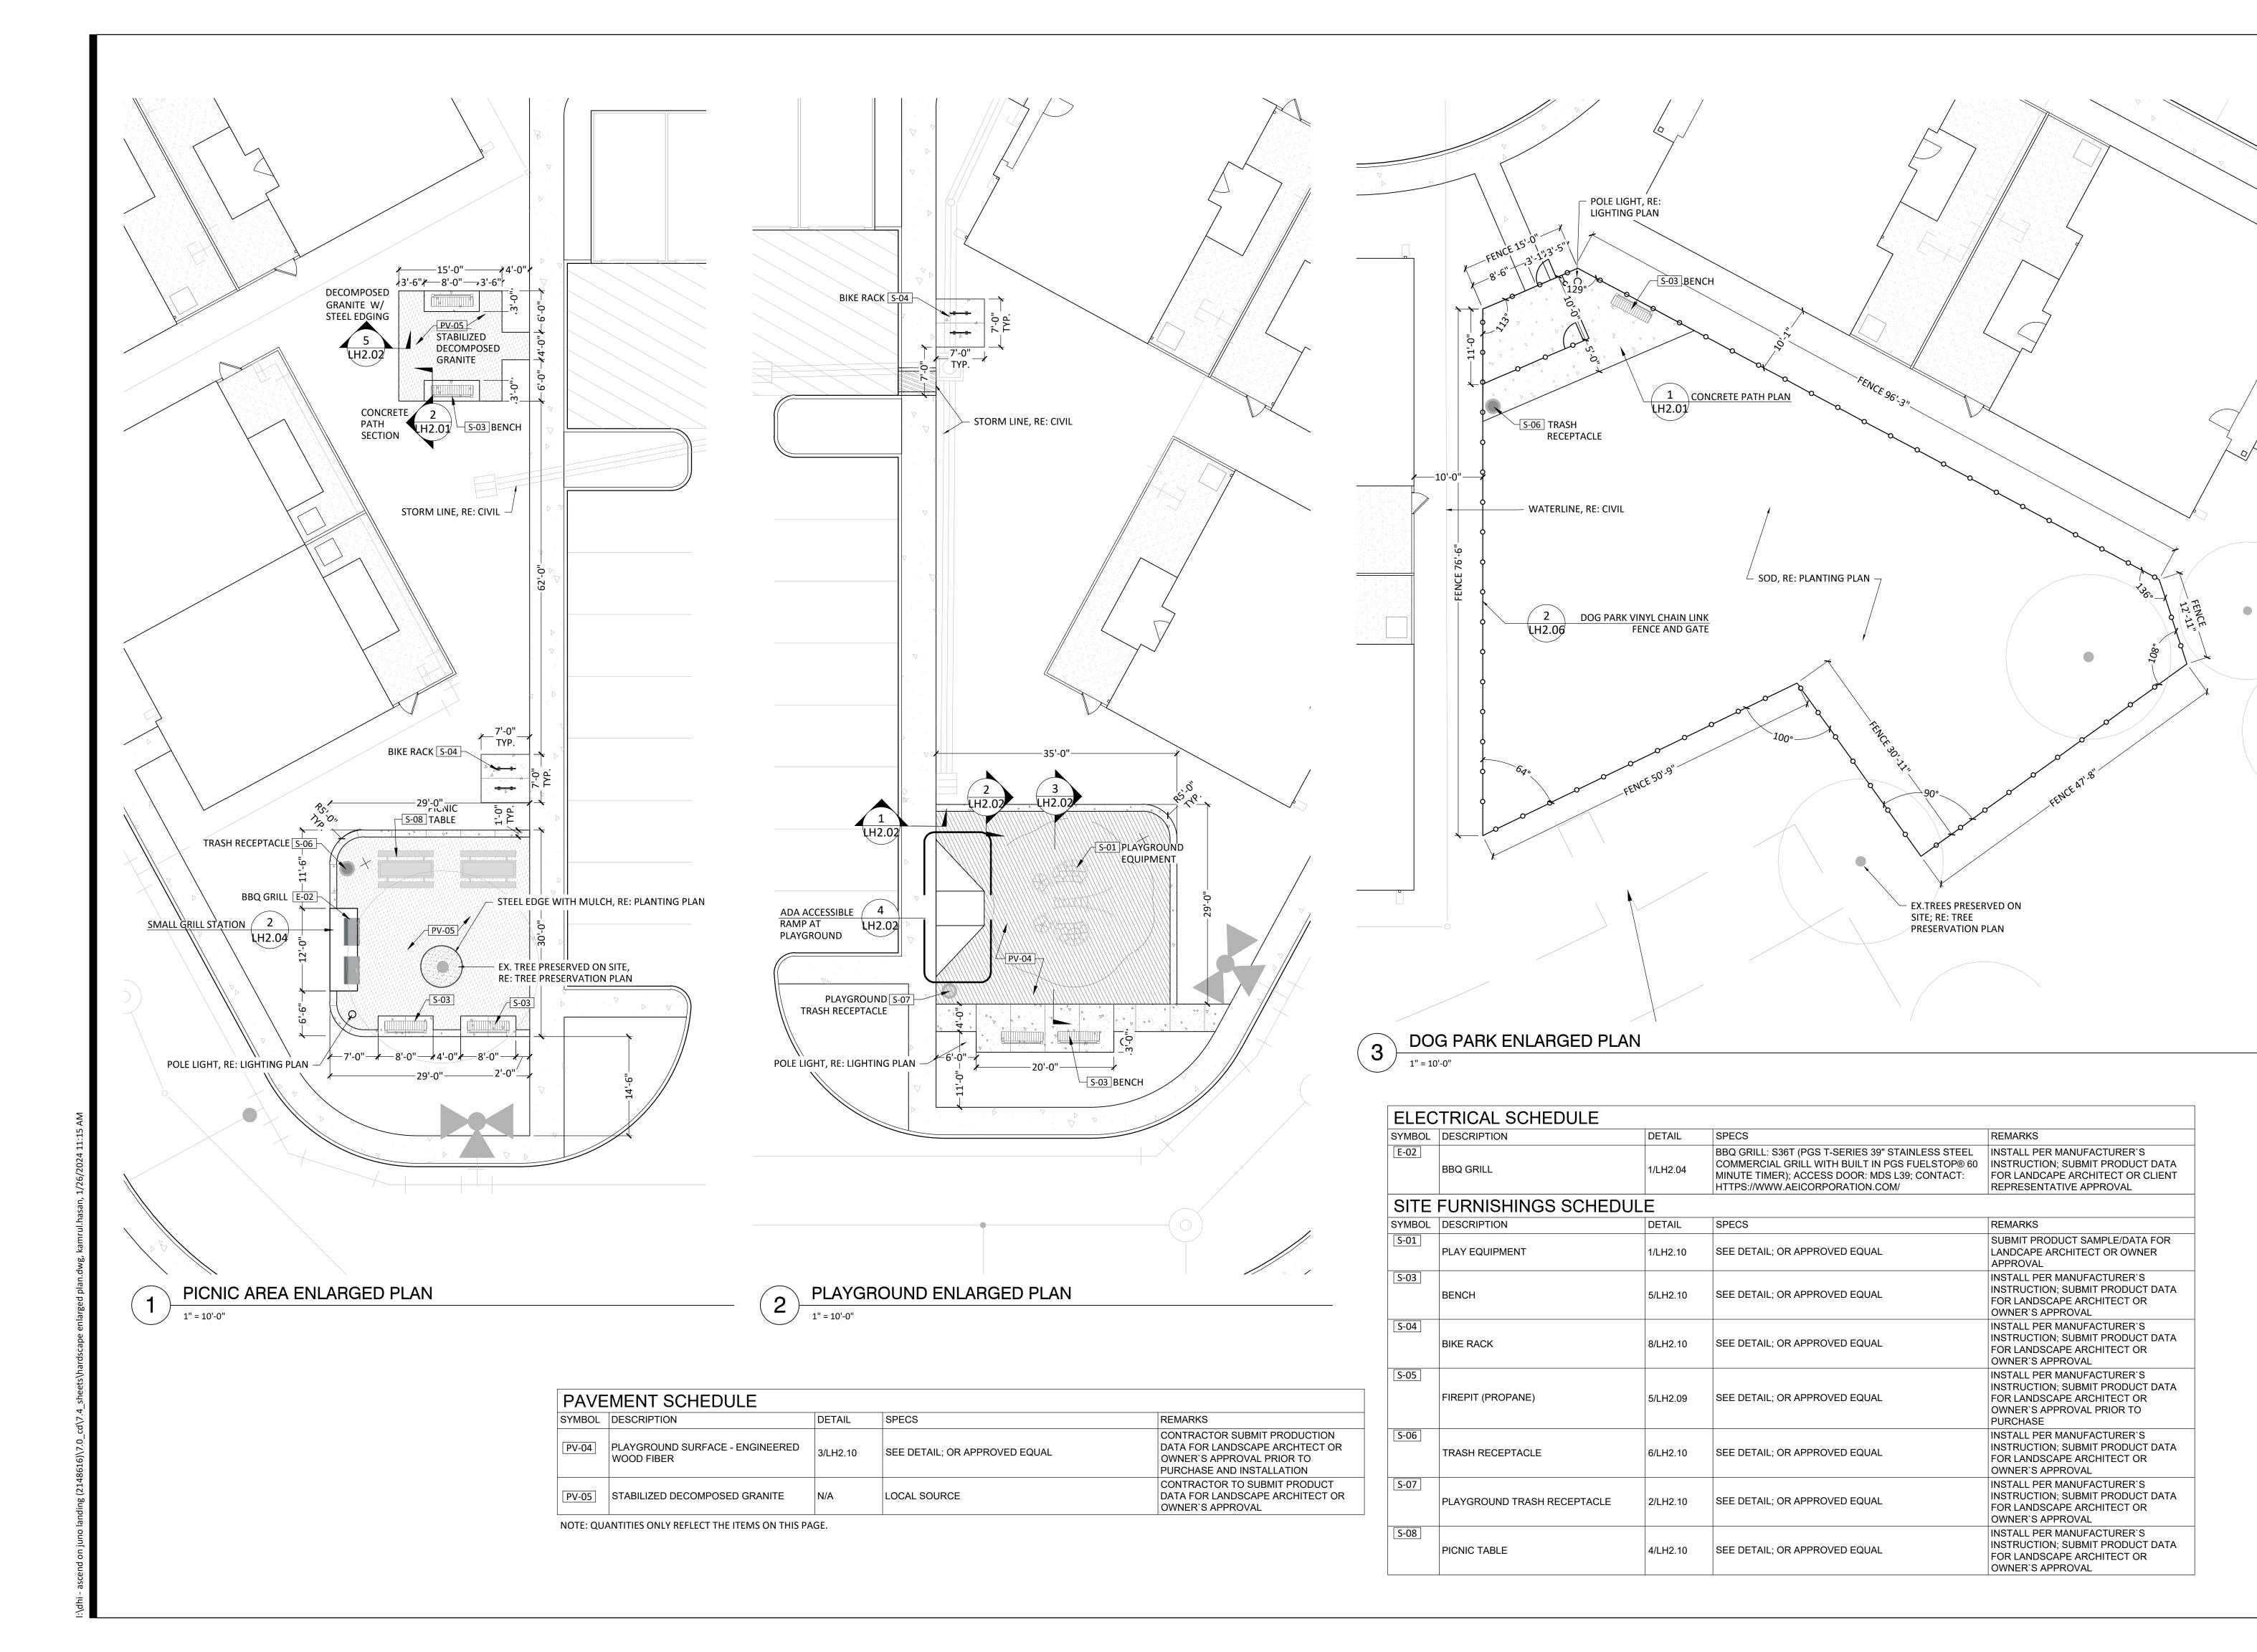DHI COMMUNITIES
5419 NORTH LOOP 1604 E
SAN ANTONIO, TX 78247

E ISSUE


1/2023 CITY COMMENTS

1/2023 ISSUE FOR CONSTRUCTION

1/2023 CLIENT COMMENTS

6/2023 CLIENT COMMENTS - SOD

8/2023 12-8-23 - IFC SET

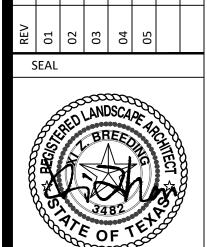

ON JUNO LANDING

ASCEN

SCALE: AS SHOWN


DATE: 12/08/2023
DRWN: STRAND
CHKD: STRAND

SHEET TITLE

HARDSCAPE ENLARGED PLAN

LH1.10

SHEET NO.

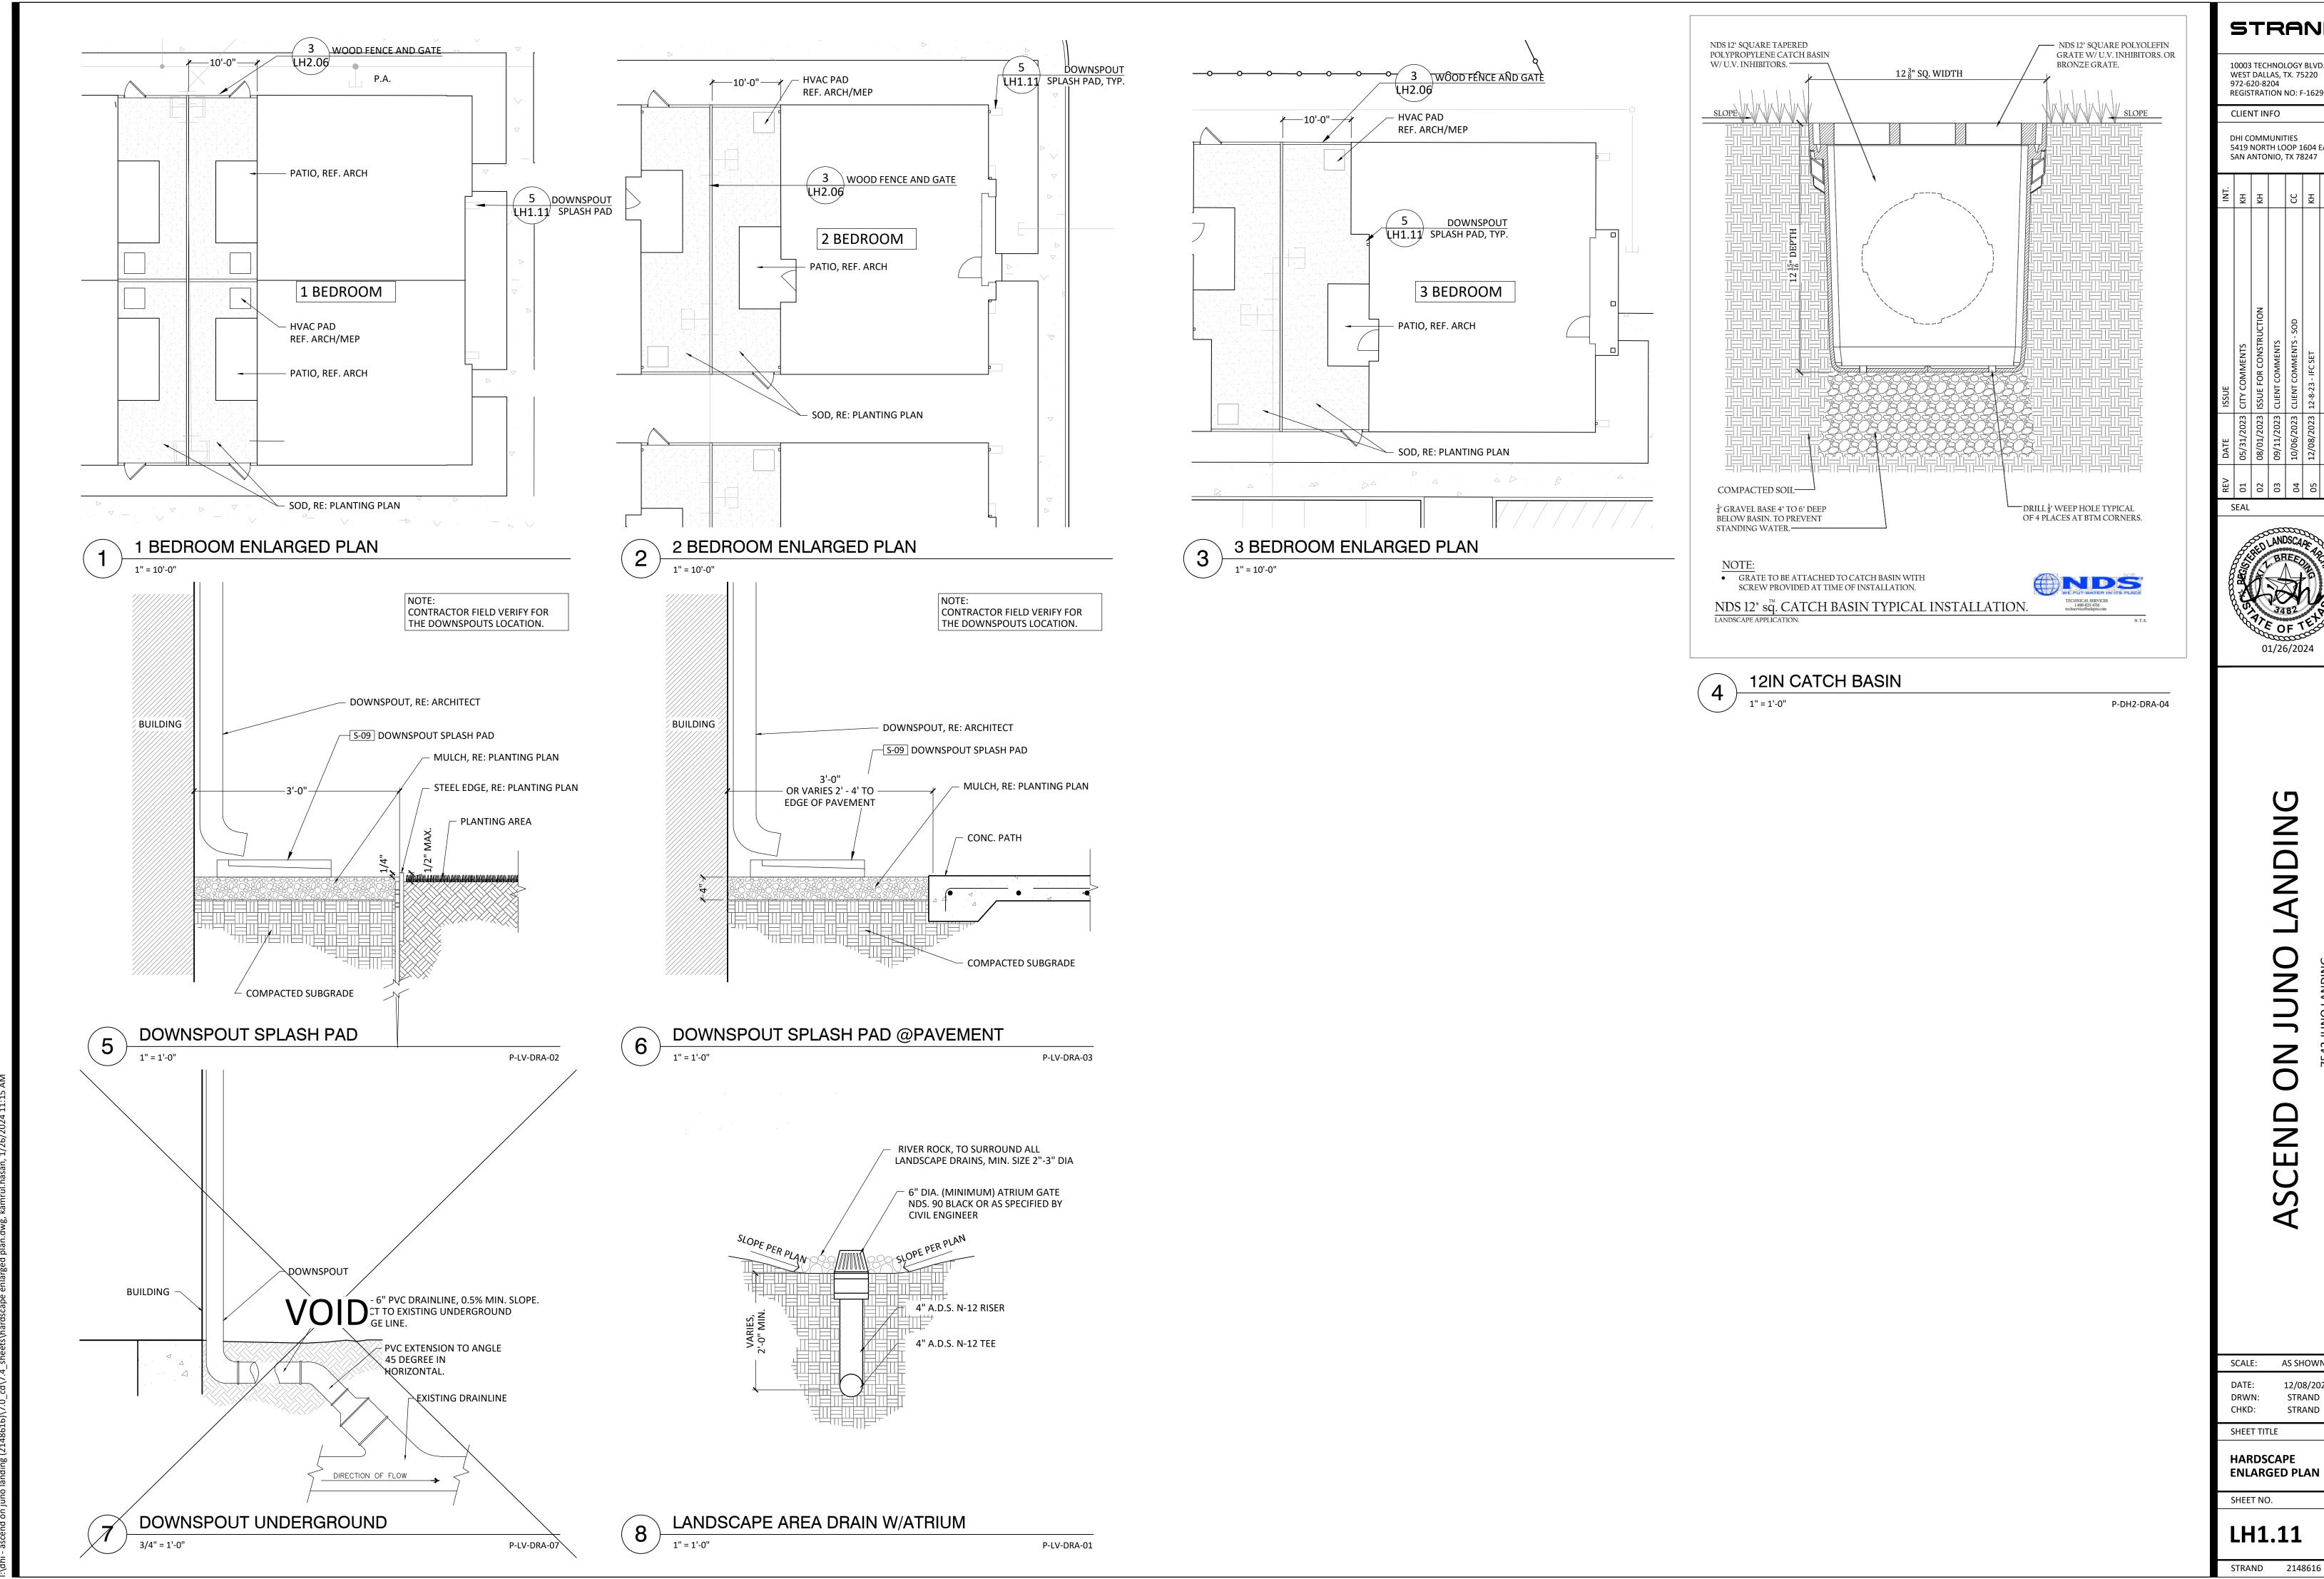

10003 TECHNOLOGY BLVD. WEST DALLAS, TX. 75220 972-620-8204 REGISTRATION NO: F-1629

CLIENT INFO

DHI COMMUNITIES 5419 NORTH LOOP 1604 EAST,


01/26/2024

NO O

SCALE: AS SHOWN 12/08/2023 STRAND STRAND

HARDSCAPE ENLARGED PLAN

LH1.11

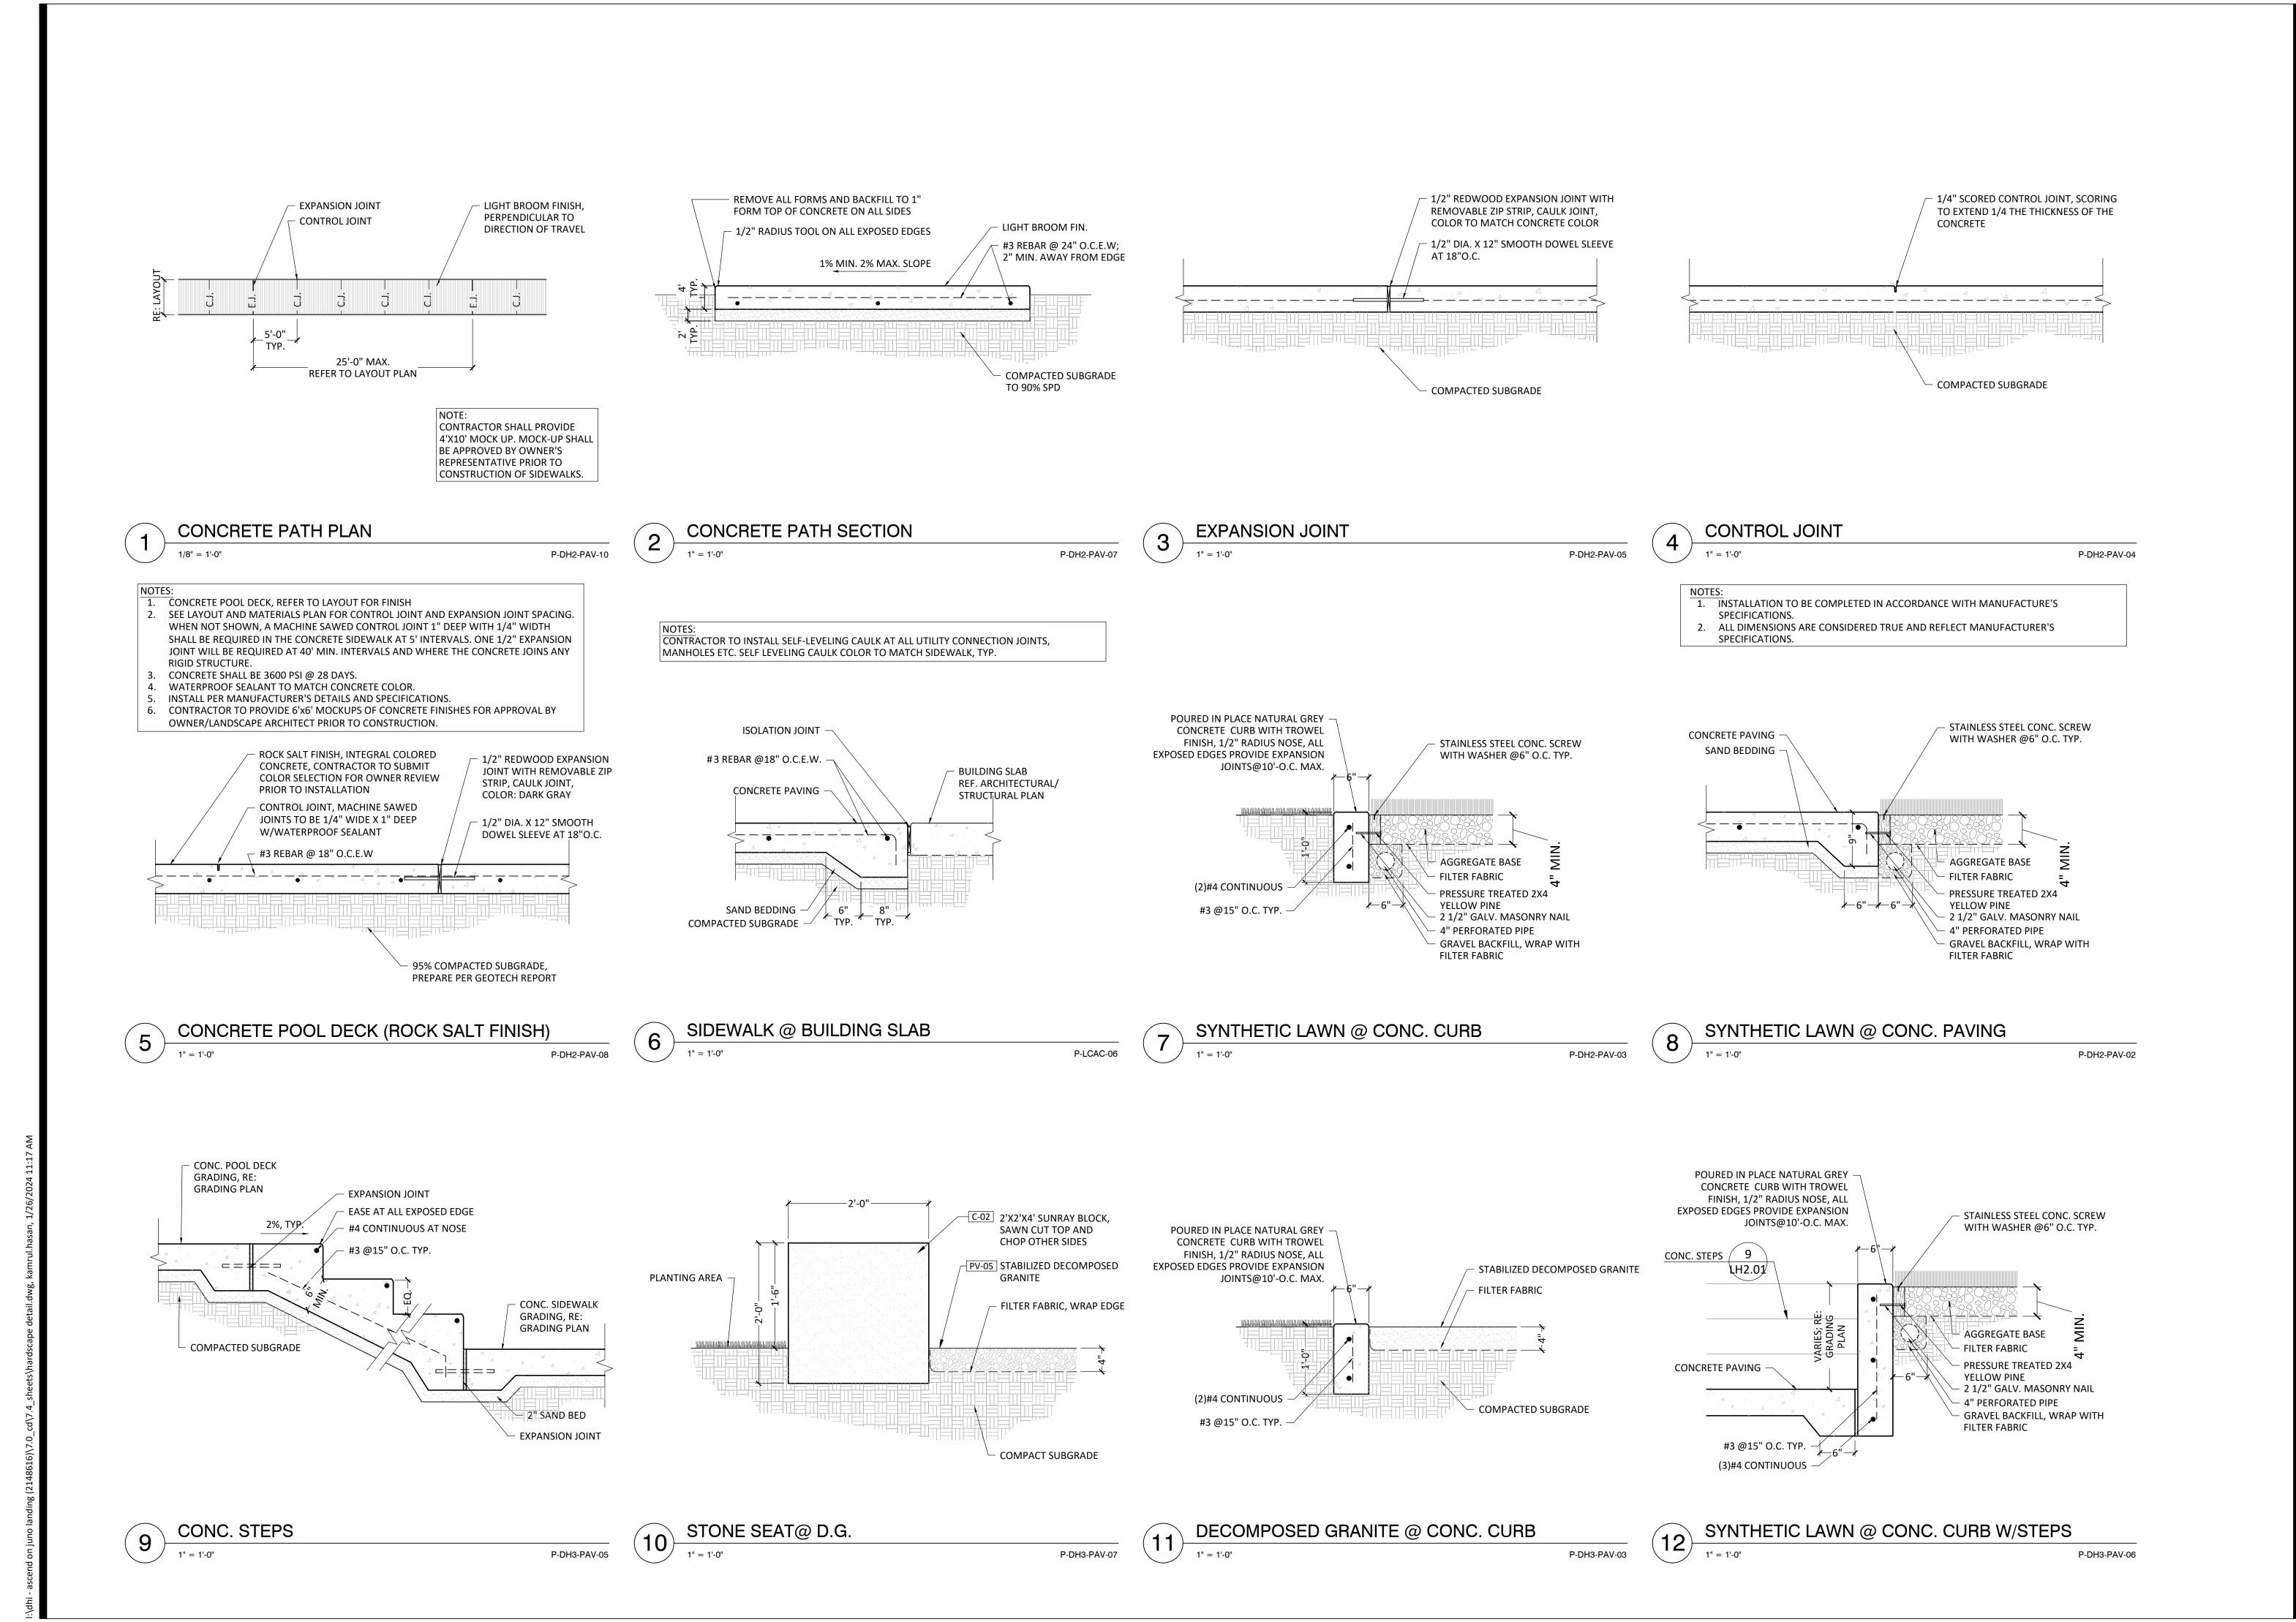

10003 TECHNOLOGY BLVD.


WEST DALLAS, TX. 75220 972-620-8204 REGISTRATION NO: F-1629

CLIENT INFO

DHI COMMUNITIES

5419 NORTH LOOP 1604 EAST, SAN ANTONIO, TX 78247

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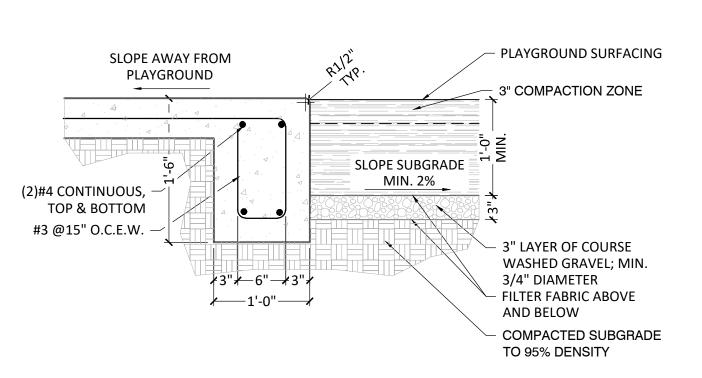
SCALE: AS SHOWN 12/08/2023 DATE: DRWN: STRAND CHKD: STRAND

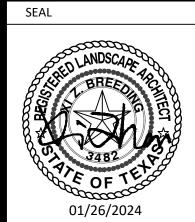HARDSCAPE DETAIL

SHEET NO.

LH2.01

SHEET TITLE




POURED IN PLACE NATURAL GREY CONCRETE CURB WITH TROWEL FINISH, 1/2" RADIUS NOSE, ALL **EXPOSED EDGES PROVIDE EXPANSION** JOINTS@10'-O.C. MAX. PLAYGROUND SURFACING SLOPE BOTTOM OF SUBGRADE TO DRAINLINE (2)#4 CONTINUOUS, TOP & BOTTOM COMPACTED SUBGRADE TO 95% DENSITY


CONCRETE PLAYGROUND EDGE AND SIDEWALK P-DH2-PAV-06

P-DH2-PAV-09 ENTRY DRIVE - INPRINT CONCRETE

PRODUCT PATTERN: ASHLAR SLATE; COLOR: RC: R26 CAPE COD GRAY, BC: P31 GRAY LINEN; CONTACT: SCOTT BALCH 214.624.6511; WWW.BOMANITE.COM OR APPROVED EQUAL

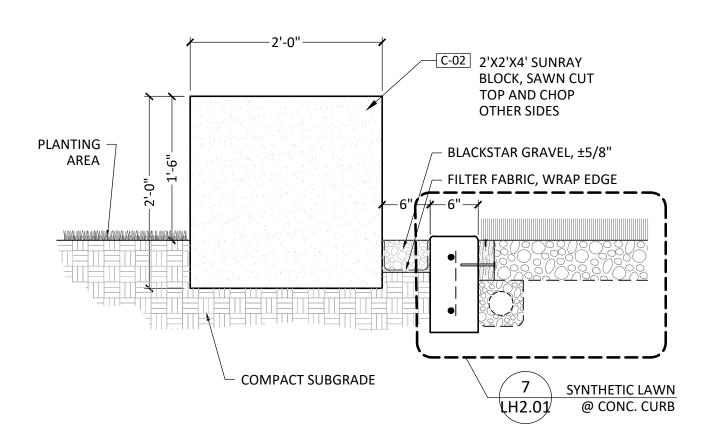


STONE SEAT@ SYNTHETIC LAWN P-DH3-PAV-08

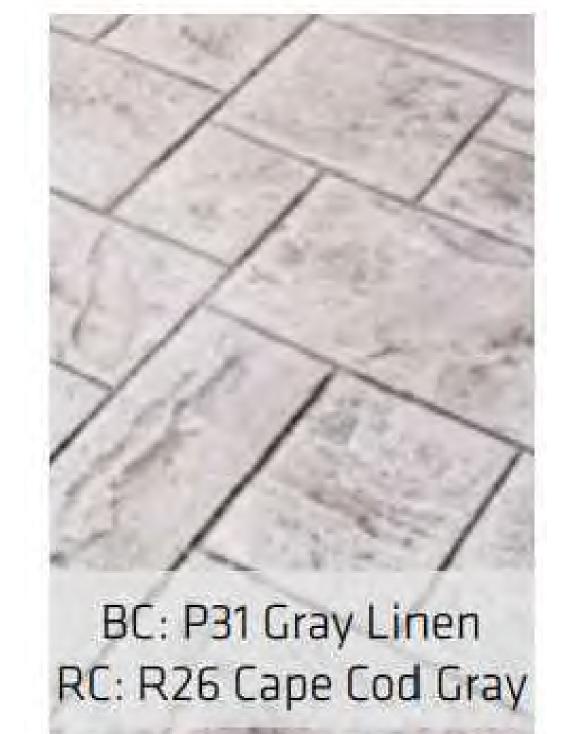


P-DH3-15



PAVING_SCHEDULE					
SYMBOL	DESCRIPTION	QTY	DETAIL		
PV-01	CONCRETE POOL DECK - ROCK SALT FINISH LIGHT GRAY		7/LH2.02		
PV-02	CONCRETE POOL DECK - ROCK SALT FINISH DARK GRAY		7/LH2.02		
PV-03	ENTRY DRIVE - INPRINT CONCRETE		6/LH2.02		
PV-04	PLAYGROUND SURFACE - ENGINEERED WOOD FIBER		3/LH2.10		
PV-05	STABILIZED DECOMPOSED GRANITE				
PV-06	SYNTHETIC LAWN		8/LH2.02		

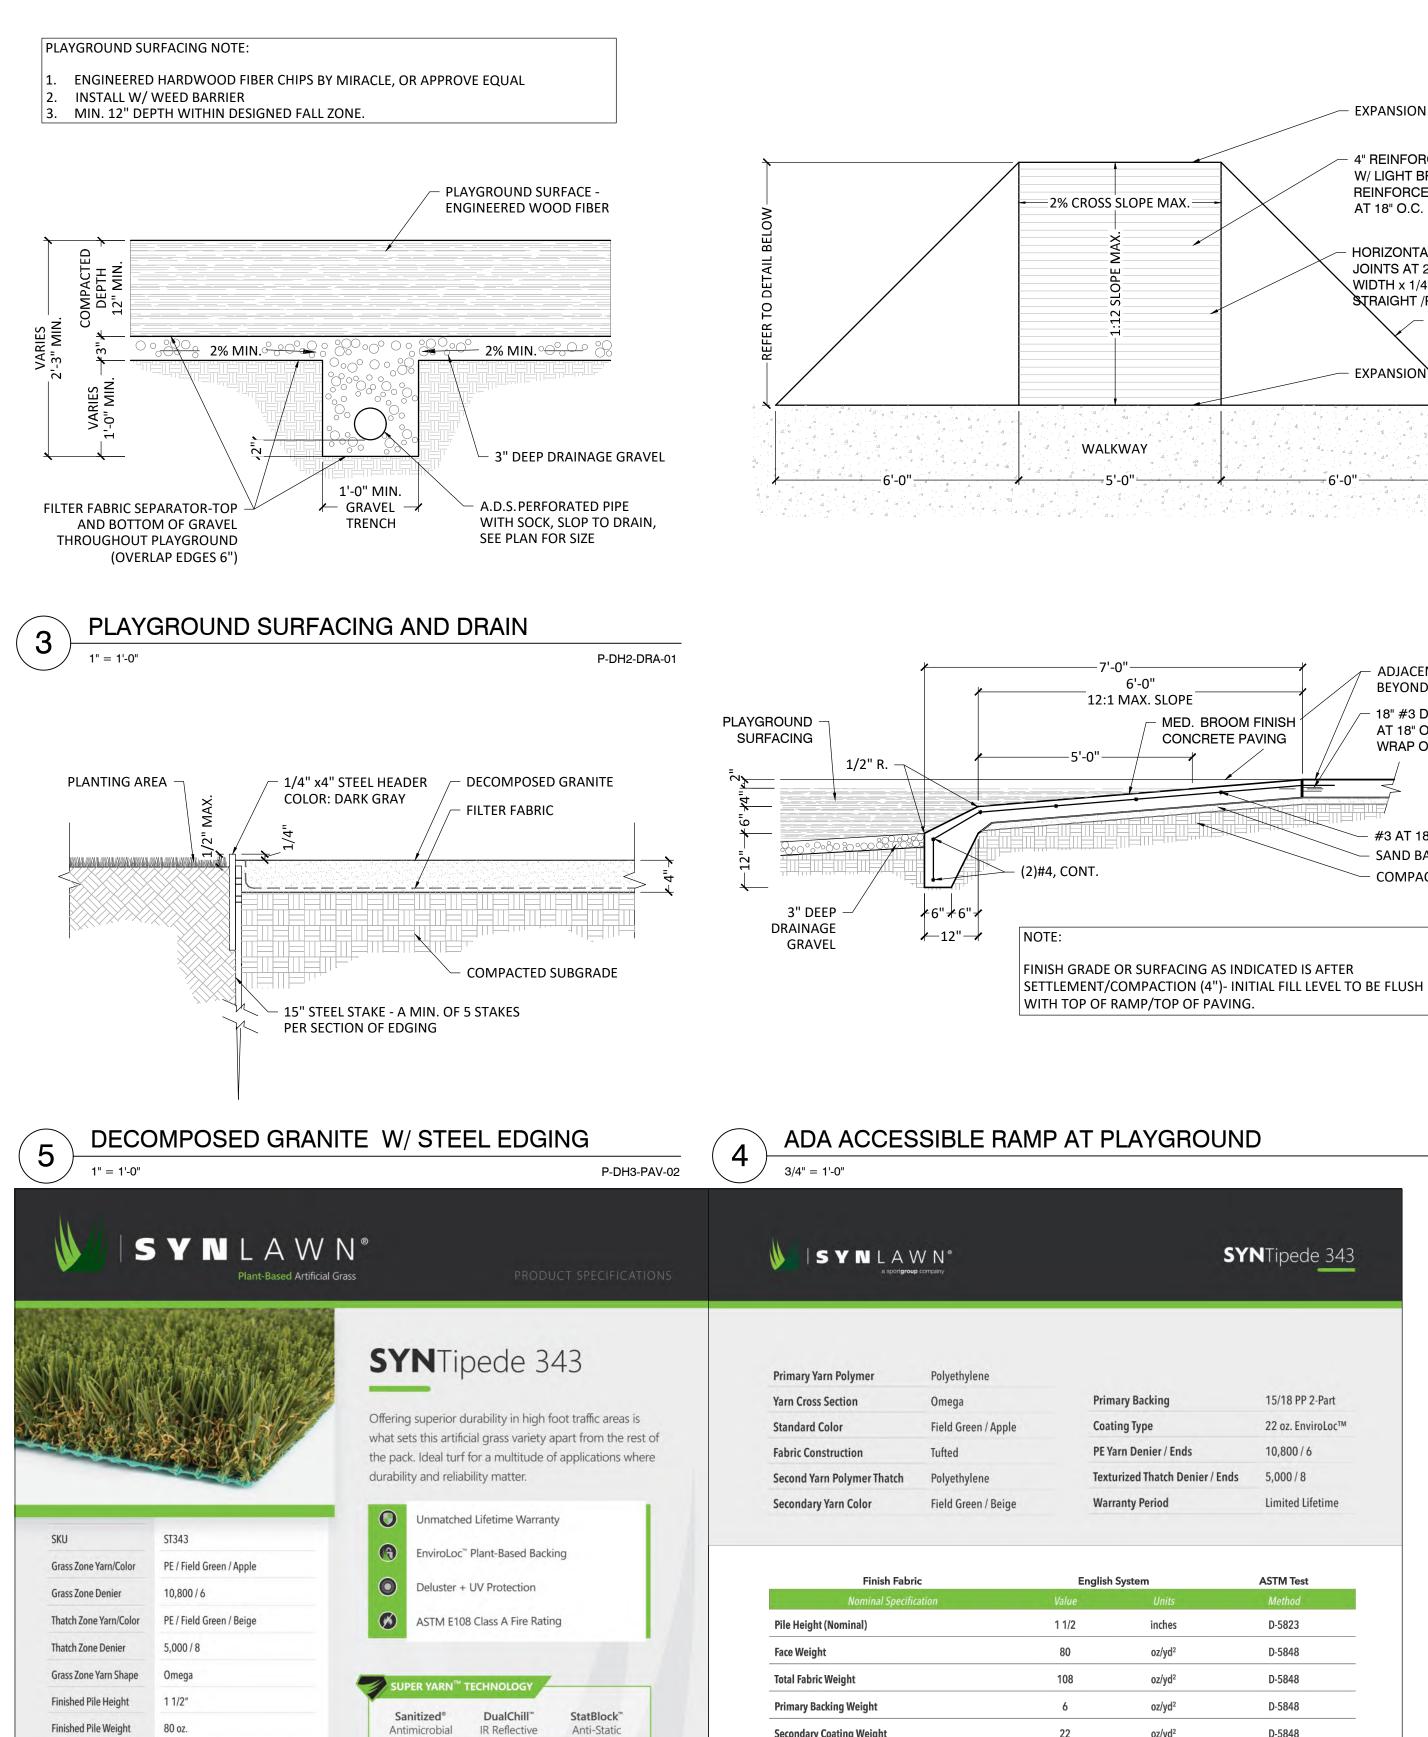

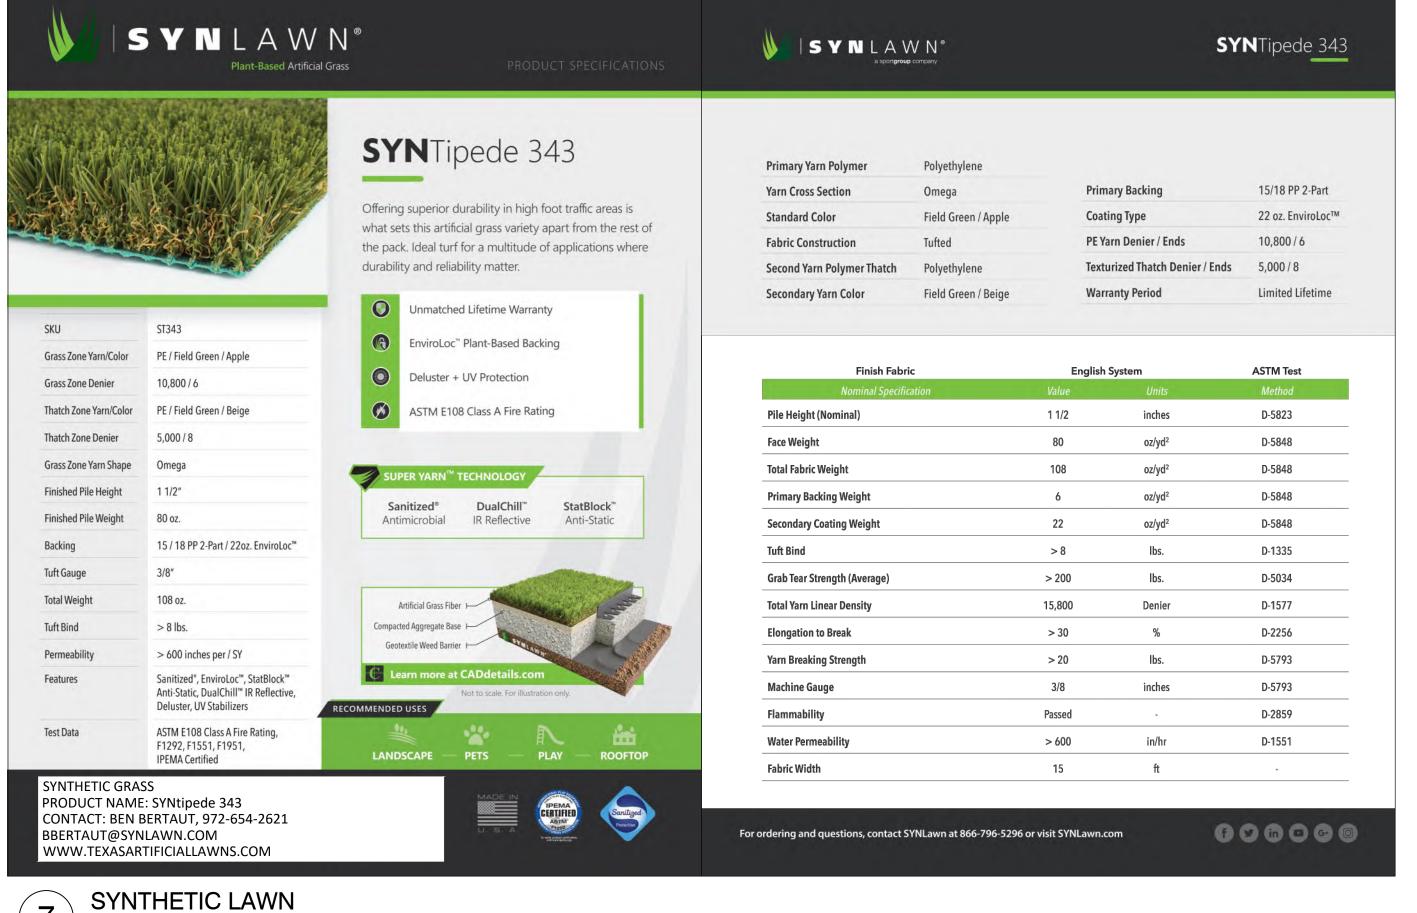

STRAND

10003 TECHNOLOGY BLVD. WEST DALLAS, TX. 75220 972-620-8204

EXPANSION JOINT

4" REINFORCED CONCRETE W/ LIGHT BROOM FINISH.

REINFORCE W/ # 3 REBAR

JOINTS AT 2-1/4" O.C. x 1/4"

- FLARED CURB

RETURN 1:12

SLOPE MAX.

AT 18" O.C. EACH WAY

HORIZONTAL TOOLED

WIDTH x 1/4" DEPTH;

EXPANSION XQINT

ADJACENT PAVING,

18" #3 DOWEL

WRAP ONE END

- #3 AT 18" O.C., B.W.

COMPACTED SUBGRADE

P-DH2-PAV-12

P-DH3-06

- SAND BASE, TYP.

AT 18" O.C.

BEYOND

12:1 MAX. SLOPE

MED. BROOM FINISH

CONCRETE PAVING

STRAIGHT /PARALLEL

REGISTRATION NO: F-1629 CLIENT INFO

DHI COMMUNITIES

5419 NORTH LOOP 1604 EAST, SAN ANTONIO, TX 78247 | 쥬 | 죠 | | 잉 | 죠 |

> LANDIN JUNO 7542 JUNO LANDING AN ANTONIO, TEXAS 782

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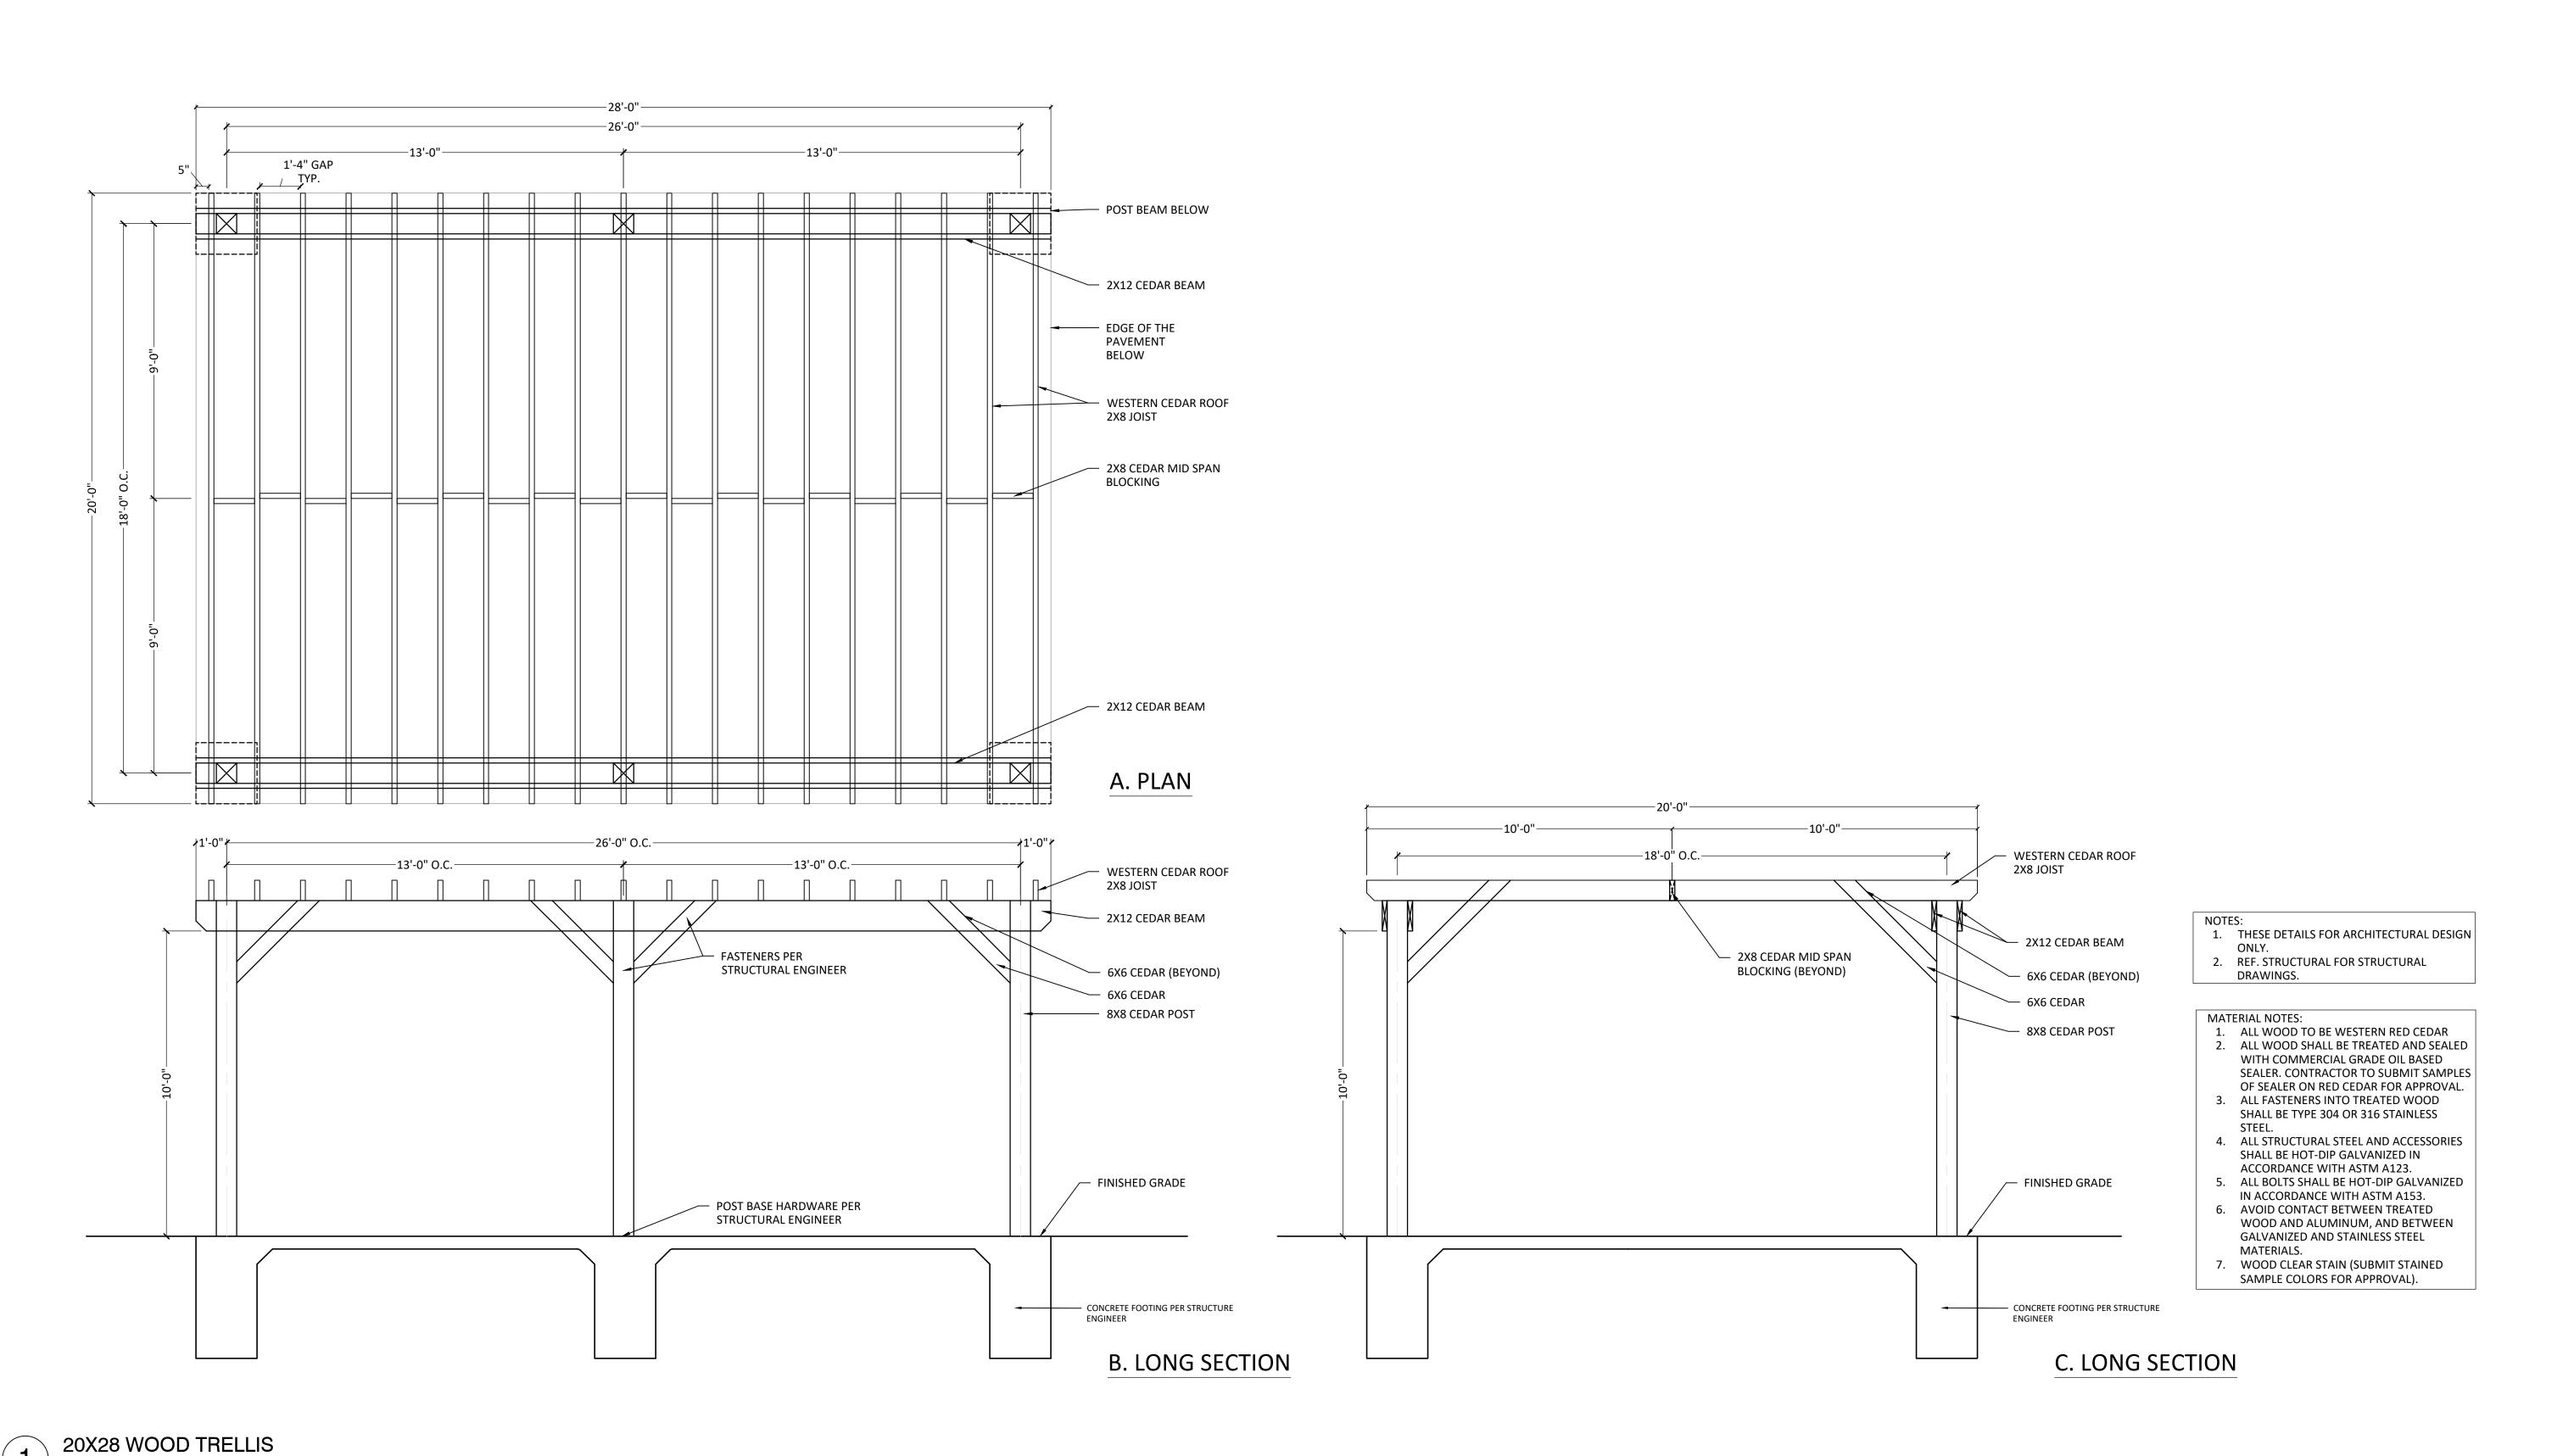
AS SHOWN 12/08/2023 STRAND CHKD: STRAND

HARDSCAPE DETAIL

LH2.02

SHEET TITLE

SHEET NO.



P-DH3-TRLS-01

SCALE: AS SHOWN 12/08/2023 DRWN: STRAND CHKD: STRAND

STRAND

10003 TECHNOLOGY BLVD. WEST DALLAS, TX. 75220 972-620-8204 REGISTRATION NO: F-1629

5419 NORTH LOOP 1604 EAST, SAN ANTONIO, TX 78247

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01/26/2024

CLIENT INFO


DHI COMMUNITIES

SHEET TITLE

SHEET NO.

HARDSCAPE DETAIL

LH2.03

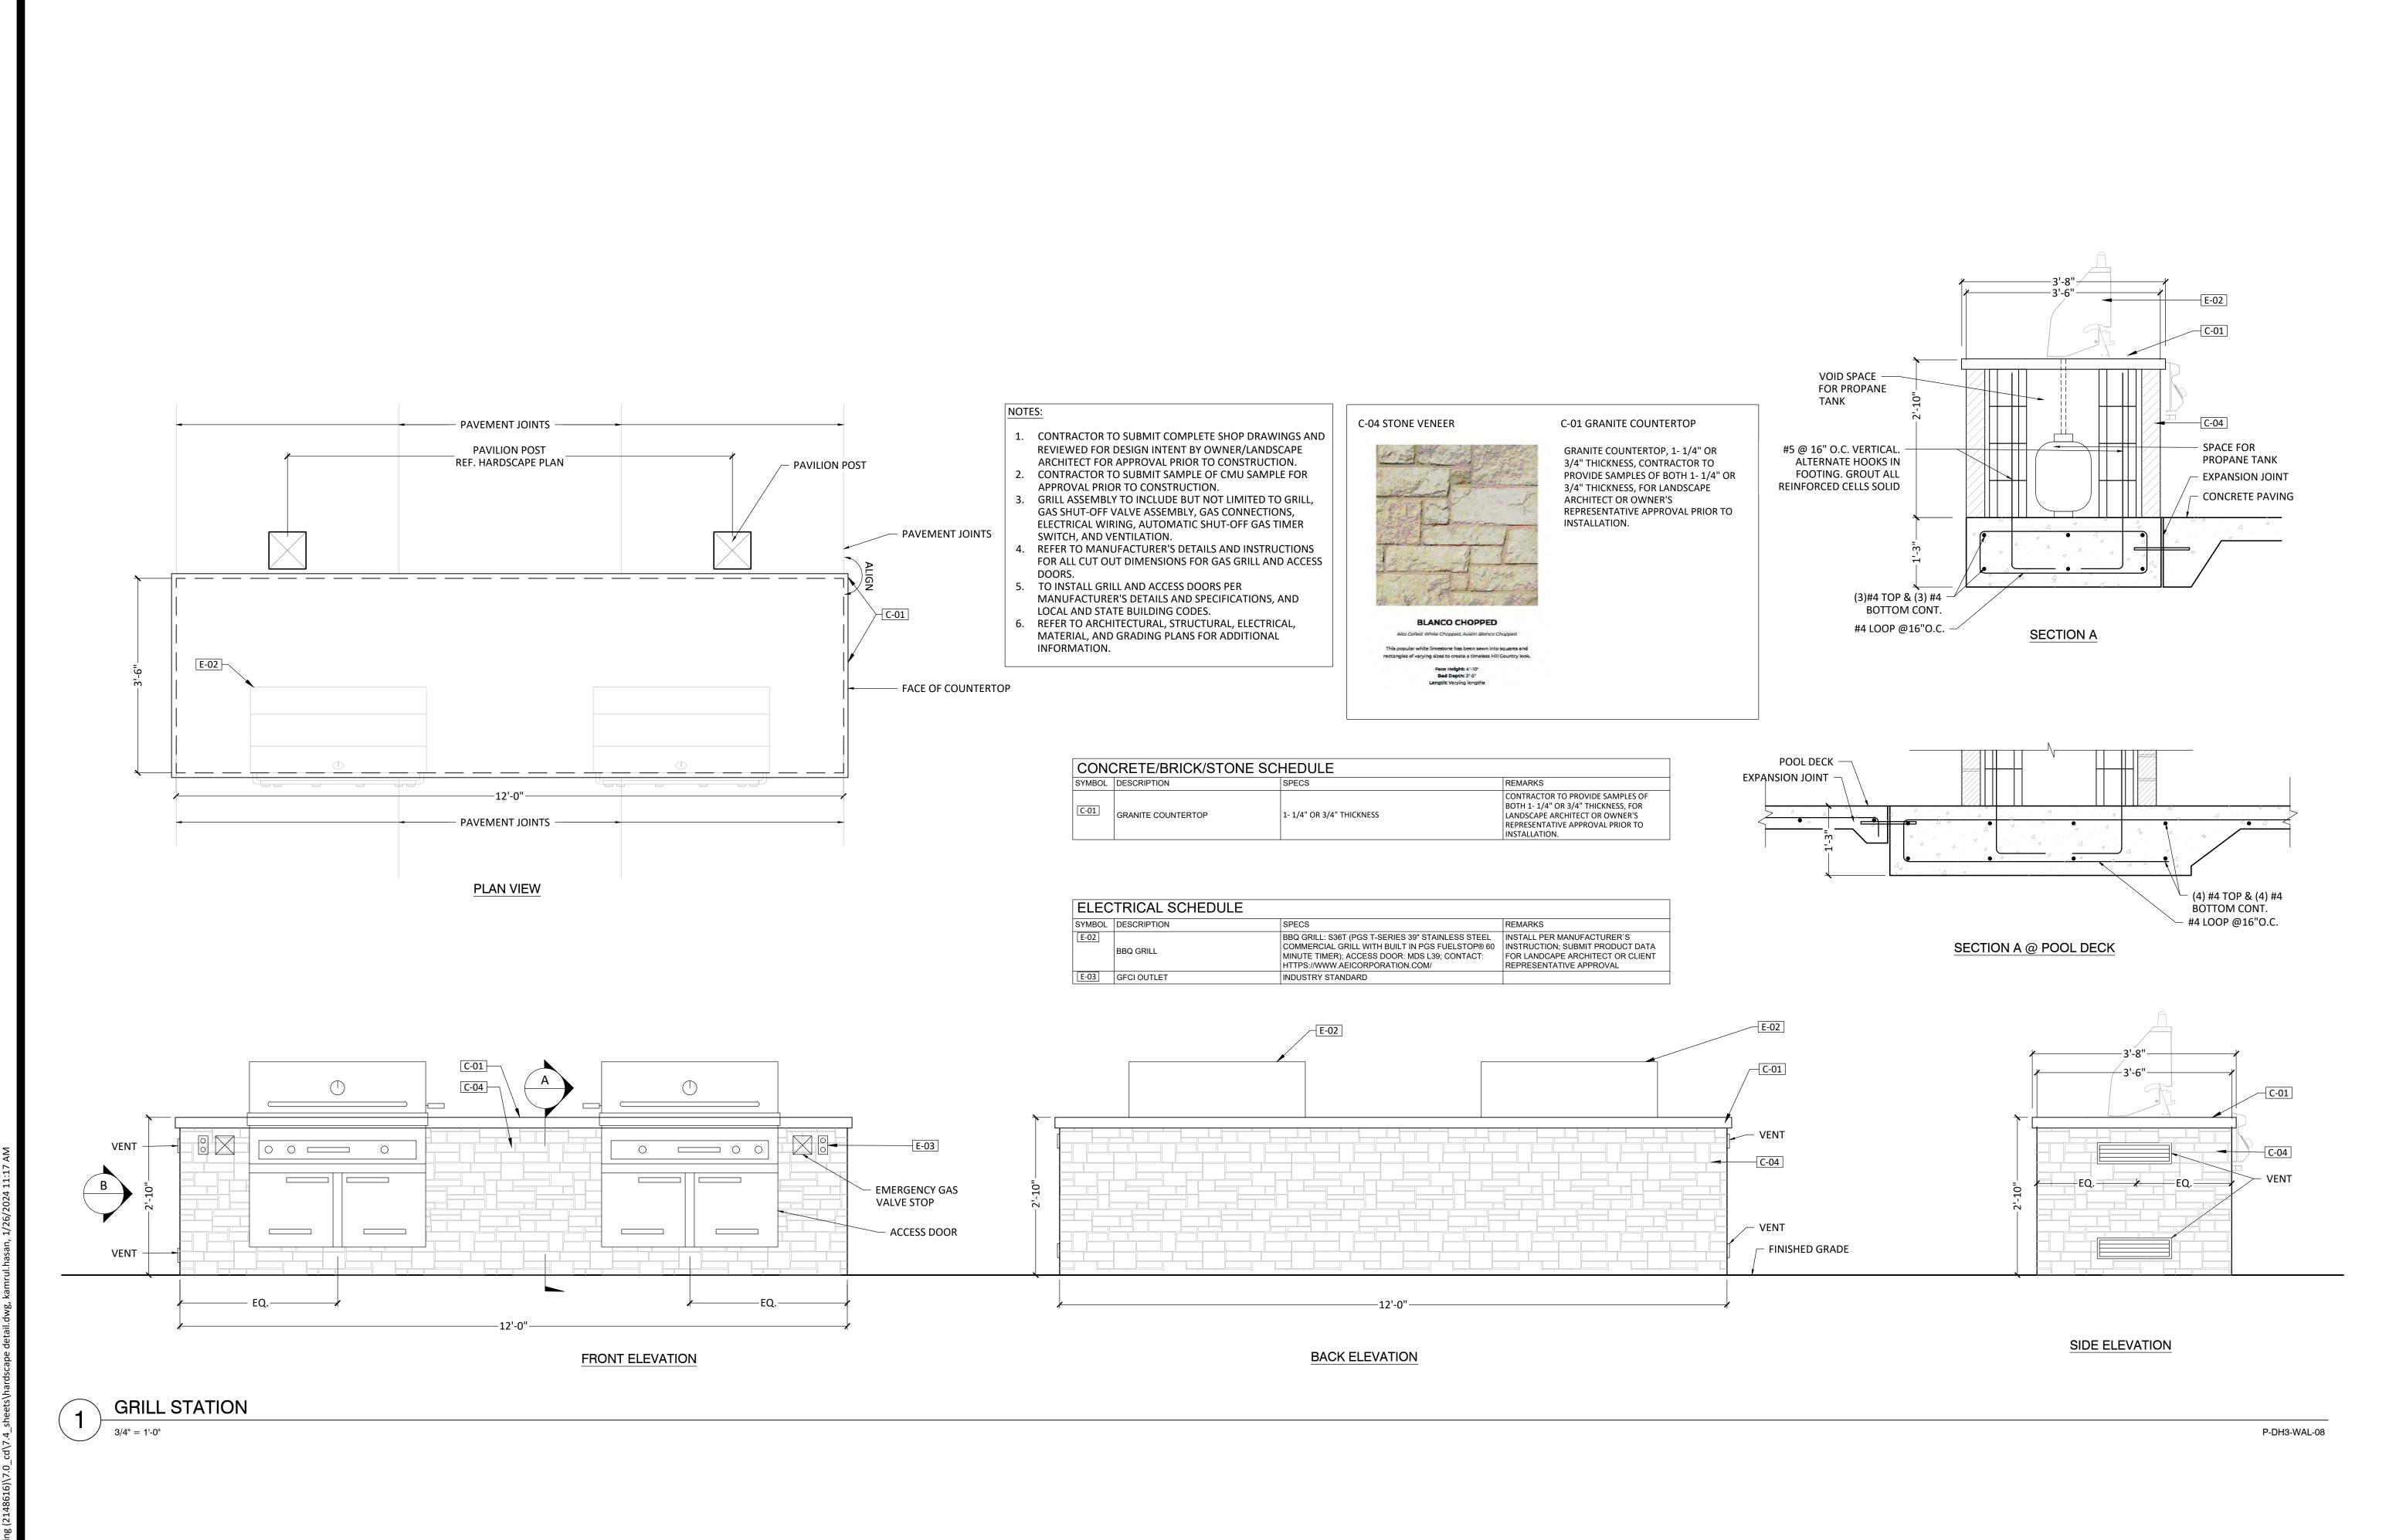

10003 TECHNOLOGY BLVD.

WEST DALLAS, TX. 75220 972-620-8204 REGISTRATION NO: F-1629

NEGISTINATION

CLIENT INFO

DHI COMMUNITIES

DHI COMMUNITIES
5419 NORTH LOOP 1604 EAST,
SAN ANTONIO, TX 78247

05/31/2023 CITY COMMENTS
08/01/2023 ISSUE FOR CONSTRUCTION
09/11/2023 CLIENT COMMENTS
10/06/2023 CLIENT COMMENTS - SOD
12/08/2023 12-8-23 - IFC SET

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7542 JUNO LANDING
SAN ANTONIO, TEXAS 782.

SCALE: AS SHOWN

DATE: 12/08/2023

DRWN: STRAND
CHKD: STRAND

SHEET TITLE

SHEET NO.

HARDSCAPE DETAIL

LH2.04


SYMBOL	DESCRIPTION	SPECS	REMARKS
C-02	SUNRAY STONE BLOCK	2'X2'X4' QUARRY BLOCK, SAW CUT ALL FACES CHOP ENDS; CONTACT: TIM SHANAHAN 405-834-8280; MINICK MATERIALS; OR APPROVED EQUAL	SUBMIT PRODUCT DATA FOR LANDSCAPE ARCHITECT OR OWNER APPROVAL PRIOR TO INSTALLATION
C-03	STUCCO	COLOR: SILVER GRAY; LAHABRA, LOCAL SOURCE; OR APPROVED EQUAL	SUBMIT PRODUCT DATA FOR LANDSCAPE ARCHITECT OR OWNER APPROVAL PRIOR TO INSTALLATION
SYMBOL	DESCRIPTION	SPECS	REMARKS
M-01	CHANNEL LETTERING	1.5" ALUMINUM REVERSE CHANNEL LETTERING, PAINTED COLOR: DARK GRAY; 1.5" OFFSET FROM WALL; BACK LIT HALO LETTER; LOCAL SOURCE	CONTRACTOR SUBMIT SHOP DRAWING FOR LANDSCAPE ARCHITECT OR OWNER'S APPROVAL PRIOR TO INSTALLATION
SYMBOL	DESCRIPTION	SPECS	REMARKS
LT-01	TAPE LIGHT	TOKISTAR LIGHITNG, TAPE LIGHT; LSW-30-WW-UB-WP / FOR USE; CONTACT: MARK TOUSSAINT, HOSSLEY LIGHTING & POWER SOLUTIONS, (214) 413-7044, HTTP://WWW.HOSSLEYLPS.COM; OR APPROVED EQUAL	INSTALL PER MANUFACTURER'S INSTRUCTION; SUBMIT PRODUCT DATA FOR LANDCAPE ARCHITECT OR CLIENT REPRESENTATIVE APPROVAL
		·	
SYMBOL	DESCRIPTION	SPECS	REMARKS
E-03	GFCI OUTLET	INDUSTRY STANDARD	



JTL	ES:
L.	THESE DETAILS FOR ARCHITECTURAL DESIGN ONLY. CONTRACTOR'S PRICING TO INCLUDE STRUCTURAL
	DESIGN.

- 2. CONTRACTOR TO SUBMIT COMPLETE SET OF SHOP DRAWINGS FOR REVIEW TO BE APPROVED BY OWNER/LANDSCAPE ARCHITECT PRIOR TO CONSTRUCTION. SHOP DRAWINGS TO BE DESIGNED AND SEALED BY LICENSED STRUCTURAL ENGINEER IN THE STATE OF TEXAS.
- CONTRACTOR TO SUBMIT DIGITAL FILE OF SIGN LETTERS FOR REVIEW TO BE APPROVED BY OWNER
- PRIOR TO ORDERING AND INSTALLATION.

M-01 LETTERING C-02 SUNRAY BLOCK, ASCEND SAWN CUT ALL SIDES CHOP ENDS ON JUNO LANDING ENSURE BLOCKS ARE ABUTTED, GAP NOT TO EXCEEDED 1/8" -20'-0"*-*A. ELEVATION

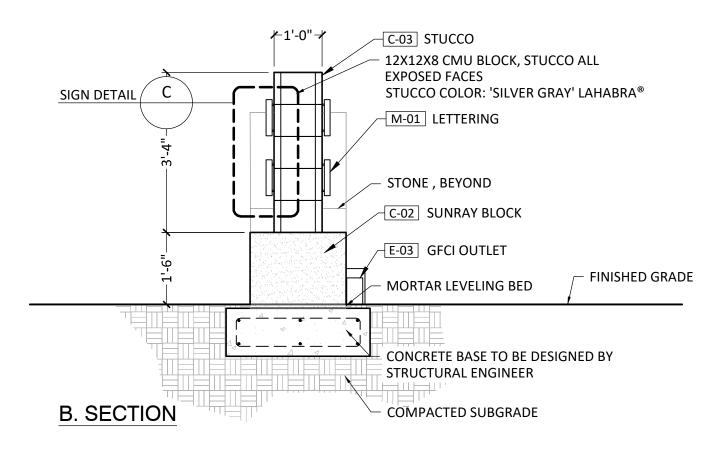

LETTERING NOTES:

LOGO AND LETTERS DIGITAL FILE PROVIDED BY LANDSCAPE ARCHITECT.

INSTALL ALL CHANNEL AND PIN MOUNTED LETTERING PER MFG INSTRUCTIONS AND PROVIDE SHOP DRAWINGS PRIOR TO FABRICATION AND INSTALLATION.


3. CHANNEL LETTERS TO HAVE LEXAN OR OTHER BACKING SUCH THAT A WEATHER TIGHT ENCLOSURE IS CREATED 4. PIN MOUNTED PAINTED ALUMINUM CHANNEL LETTERS WITH 1.5" RETURNS, FONT:

COPPERPLATE BOLD; ALL CAPITAL 5. CONTRACTOR TO SUBMIT COLOR SELECTIONS FOR APPROVAL BY LANDSCAPE

ARCHITECT PRIOR TO FABRICATION. 6. LETTERING TO BE INTERNALLY ILLUMINATED TO CREATE HALO LIGHTING EFFECT,

INCLUDE ALL REQUIRED ELECTRICAL, TIMERS, SWITCHES AND ADJUSTABLE LIGHT CONTROL, PHOTOCELL ON, TIMER CLOCK OFF. SUBMIT SHOP DRAWINGS AND PRODUCT DATE TO LANDSCAPE ARCHITECT FOR APPROVAL PRIOR TO PURCHASE & INSTALLATION. 7. DIMENSIONS, LOCATION, AND SIZE TO BE TEST FIT/MOCKED UP FOR APPROVAL

PRIOR TO FABRICATION AND INSTALLATION. 8. ALL J-BOXES, CONDUIT, FIXTURES, WIRES, ETC.. TO BE CONCEALED BY SIGN AND NOT IMMEDIATELY SEEN FROM PUBLIC VIEW.

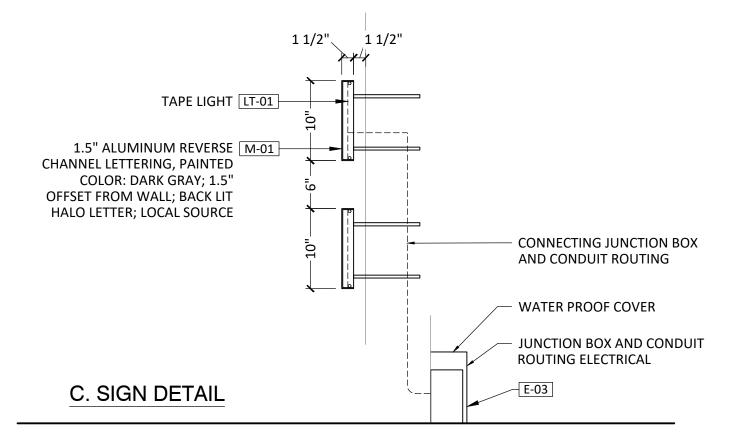

SIGN DETAIL

P-DH3-WAL-03

P-DH3-WAL-10

STONE BLOCK ENTRY MONUMENT

1/2" = 1'-0"

STRAND

10003 TECHNOLOGY BLVD.

WEST DALLAS, TX. 75220 972-620-8204 REGISTRATION NO: F-1629

CLIENT INFO

DHI COMMUNITIES 5419 NORTH LOOP 1604 EAST, SAN ANTONIO, TX 78247


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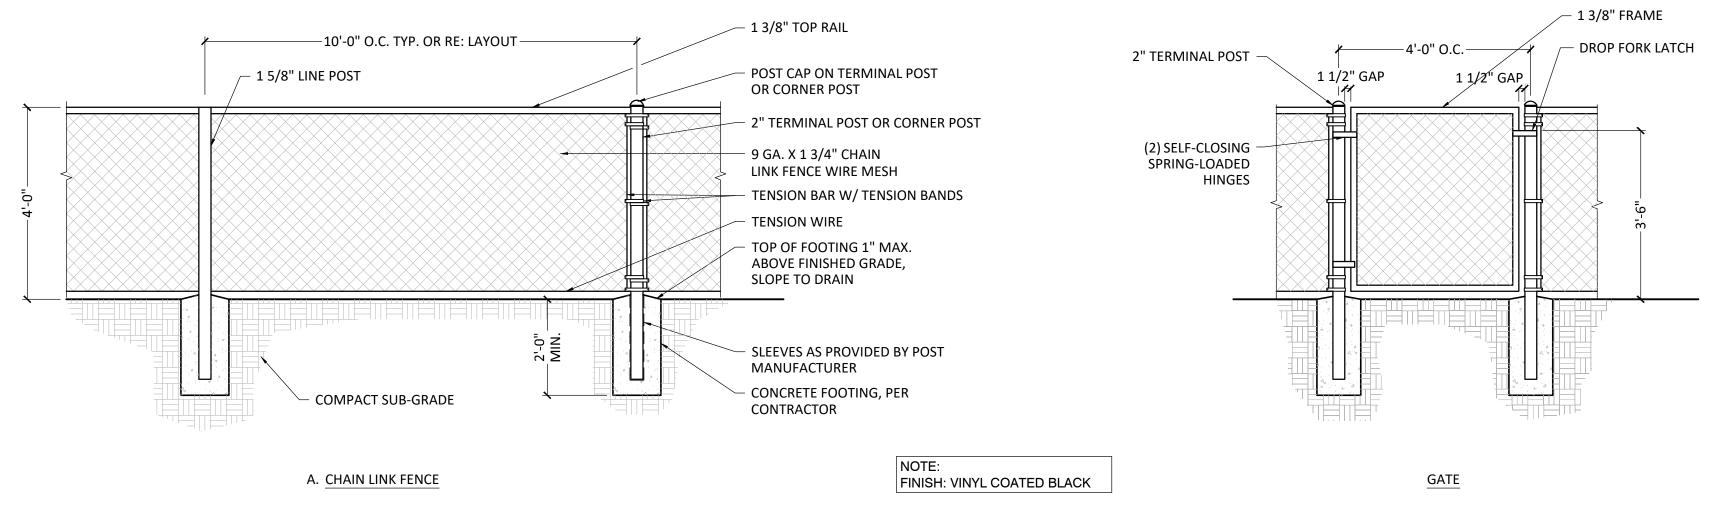


SCALE: AS SHOWN

HARDSCAPE DETAIL


LH2.05



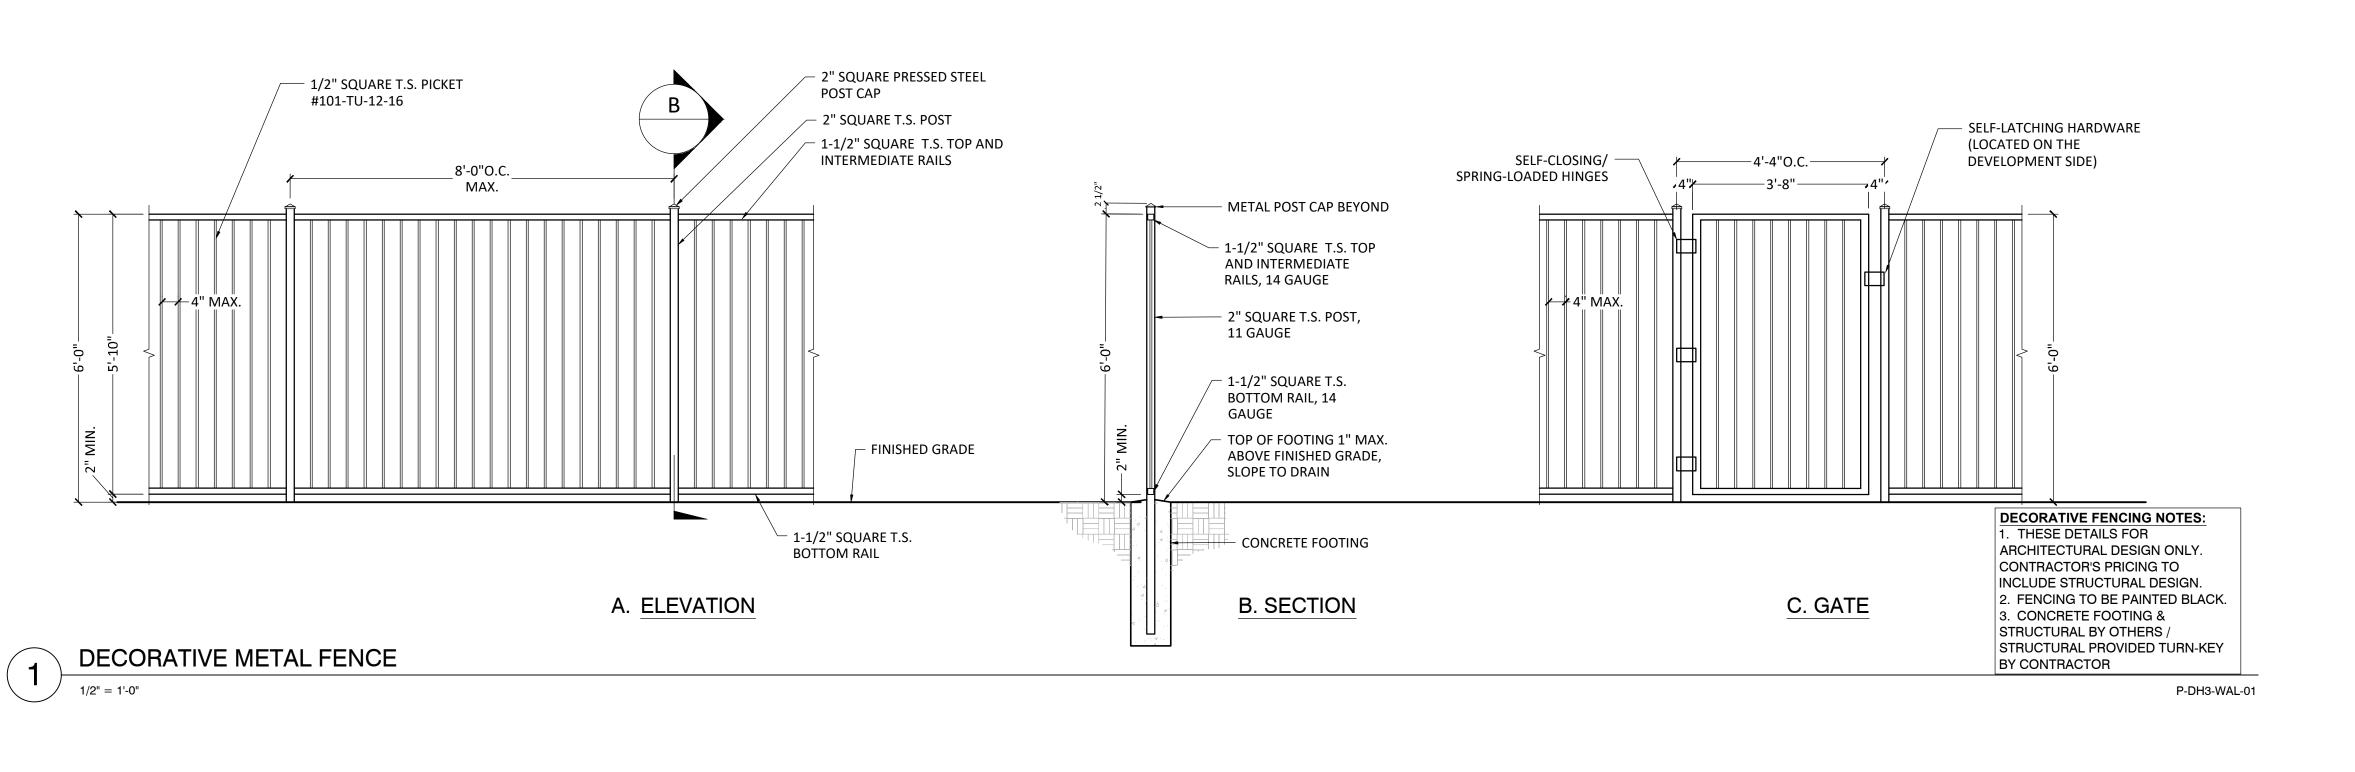

DOG PARK VINYL CHAIN LINK FENCE AND GATE

1/2" = 1'-0"
P-DH3-WAL-12

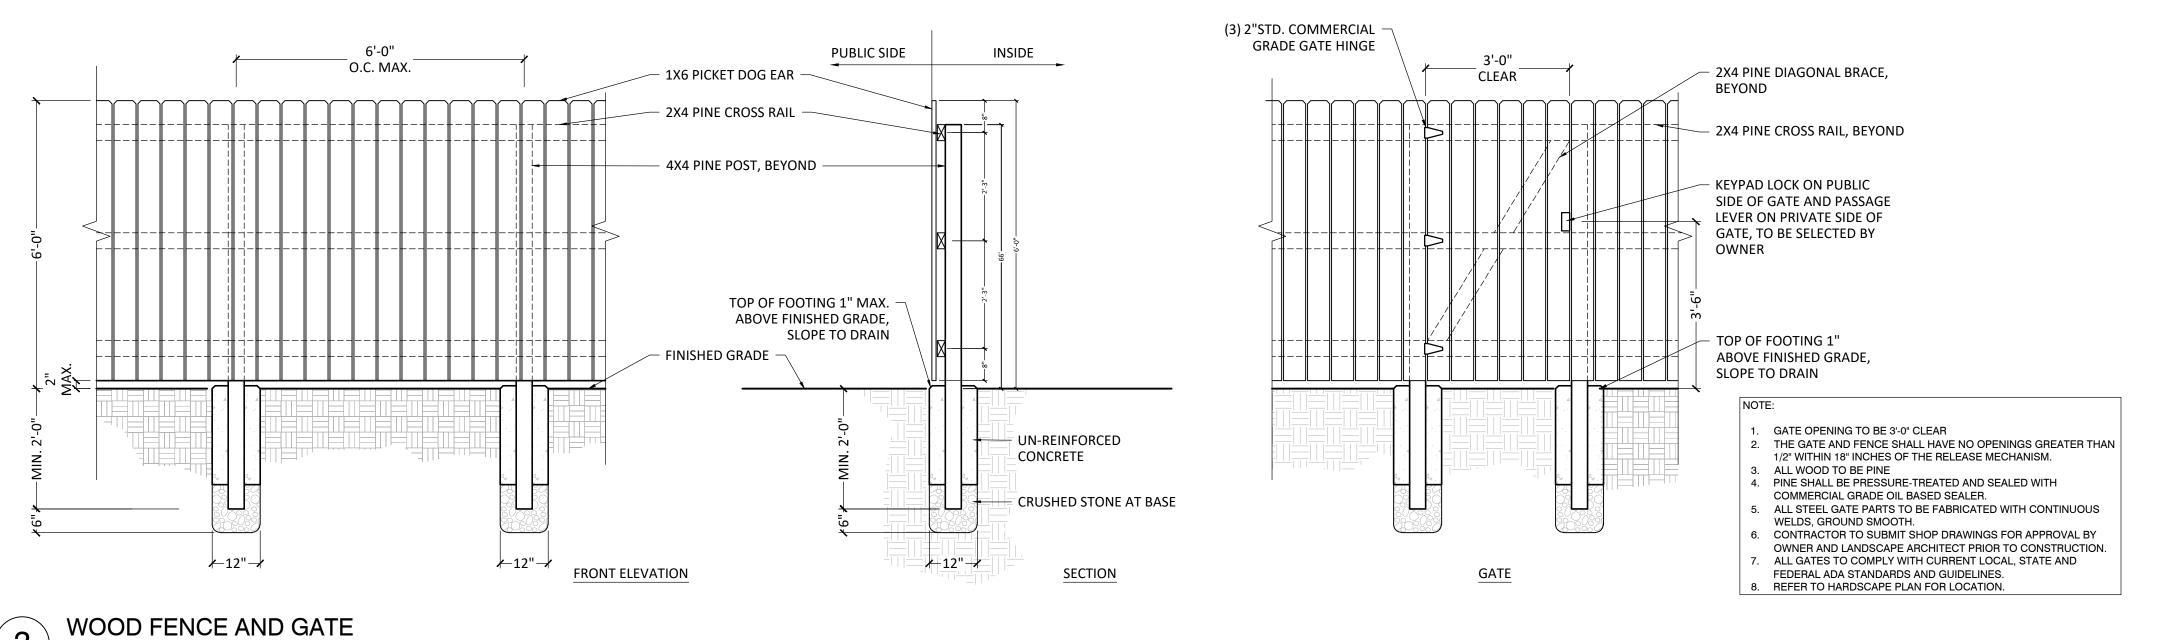

P-DH3-WAL-07

STRAND

10003 TECHNOLOGY BLVD.

WEST DALLAS, TX. 75220 972-620-8204 REGISTRATION NO: F-1629

CLIENT INFO

DHI COMMUNITIES

5419 NORTH LOOP 1604 EAST, SAN ANTONIO, TX 78247

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CO23 CLIENT COMMENTS - SOD


REV DATE 1

PM 01 05/31/2023 C

02 08/01/2023 IS

03 09/11/2023 C

04 10/06/2023 C

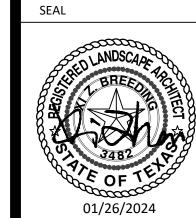

CEND ON JUNO LANDING

SCALE: AS SHOWN


DATE: 12/08/2023
DRWN: STRAND
CHKD: STRAND

SHEET TITLE

HARDSCAPE DETAIL

LH2.06

SHEET NO.

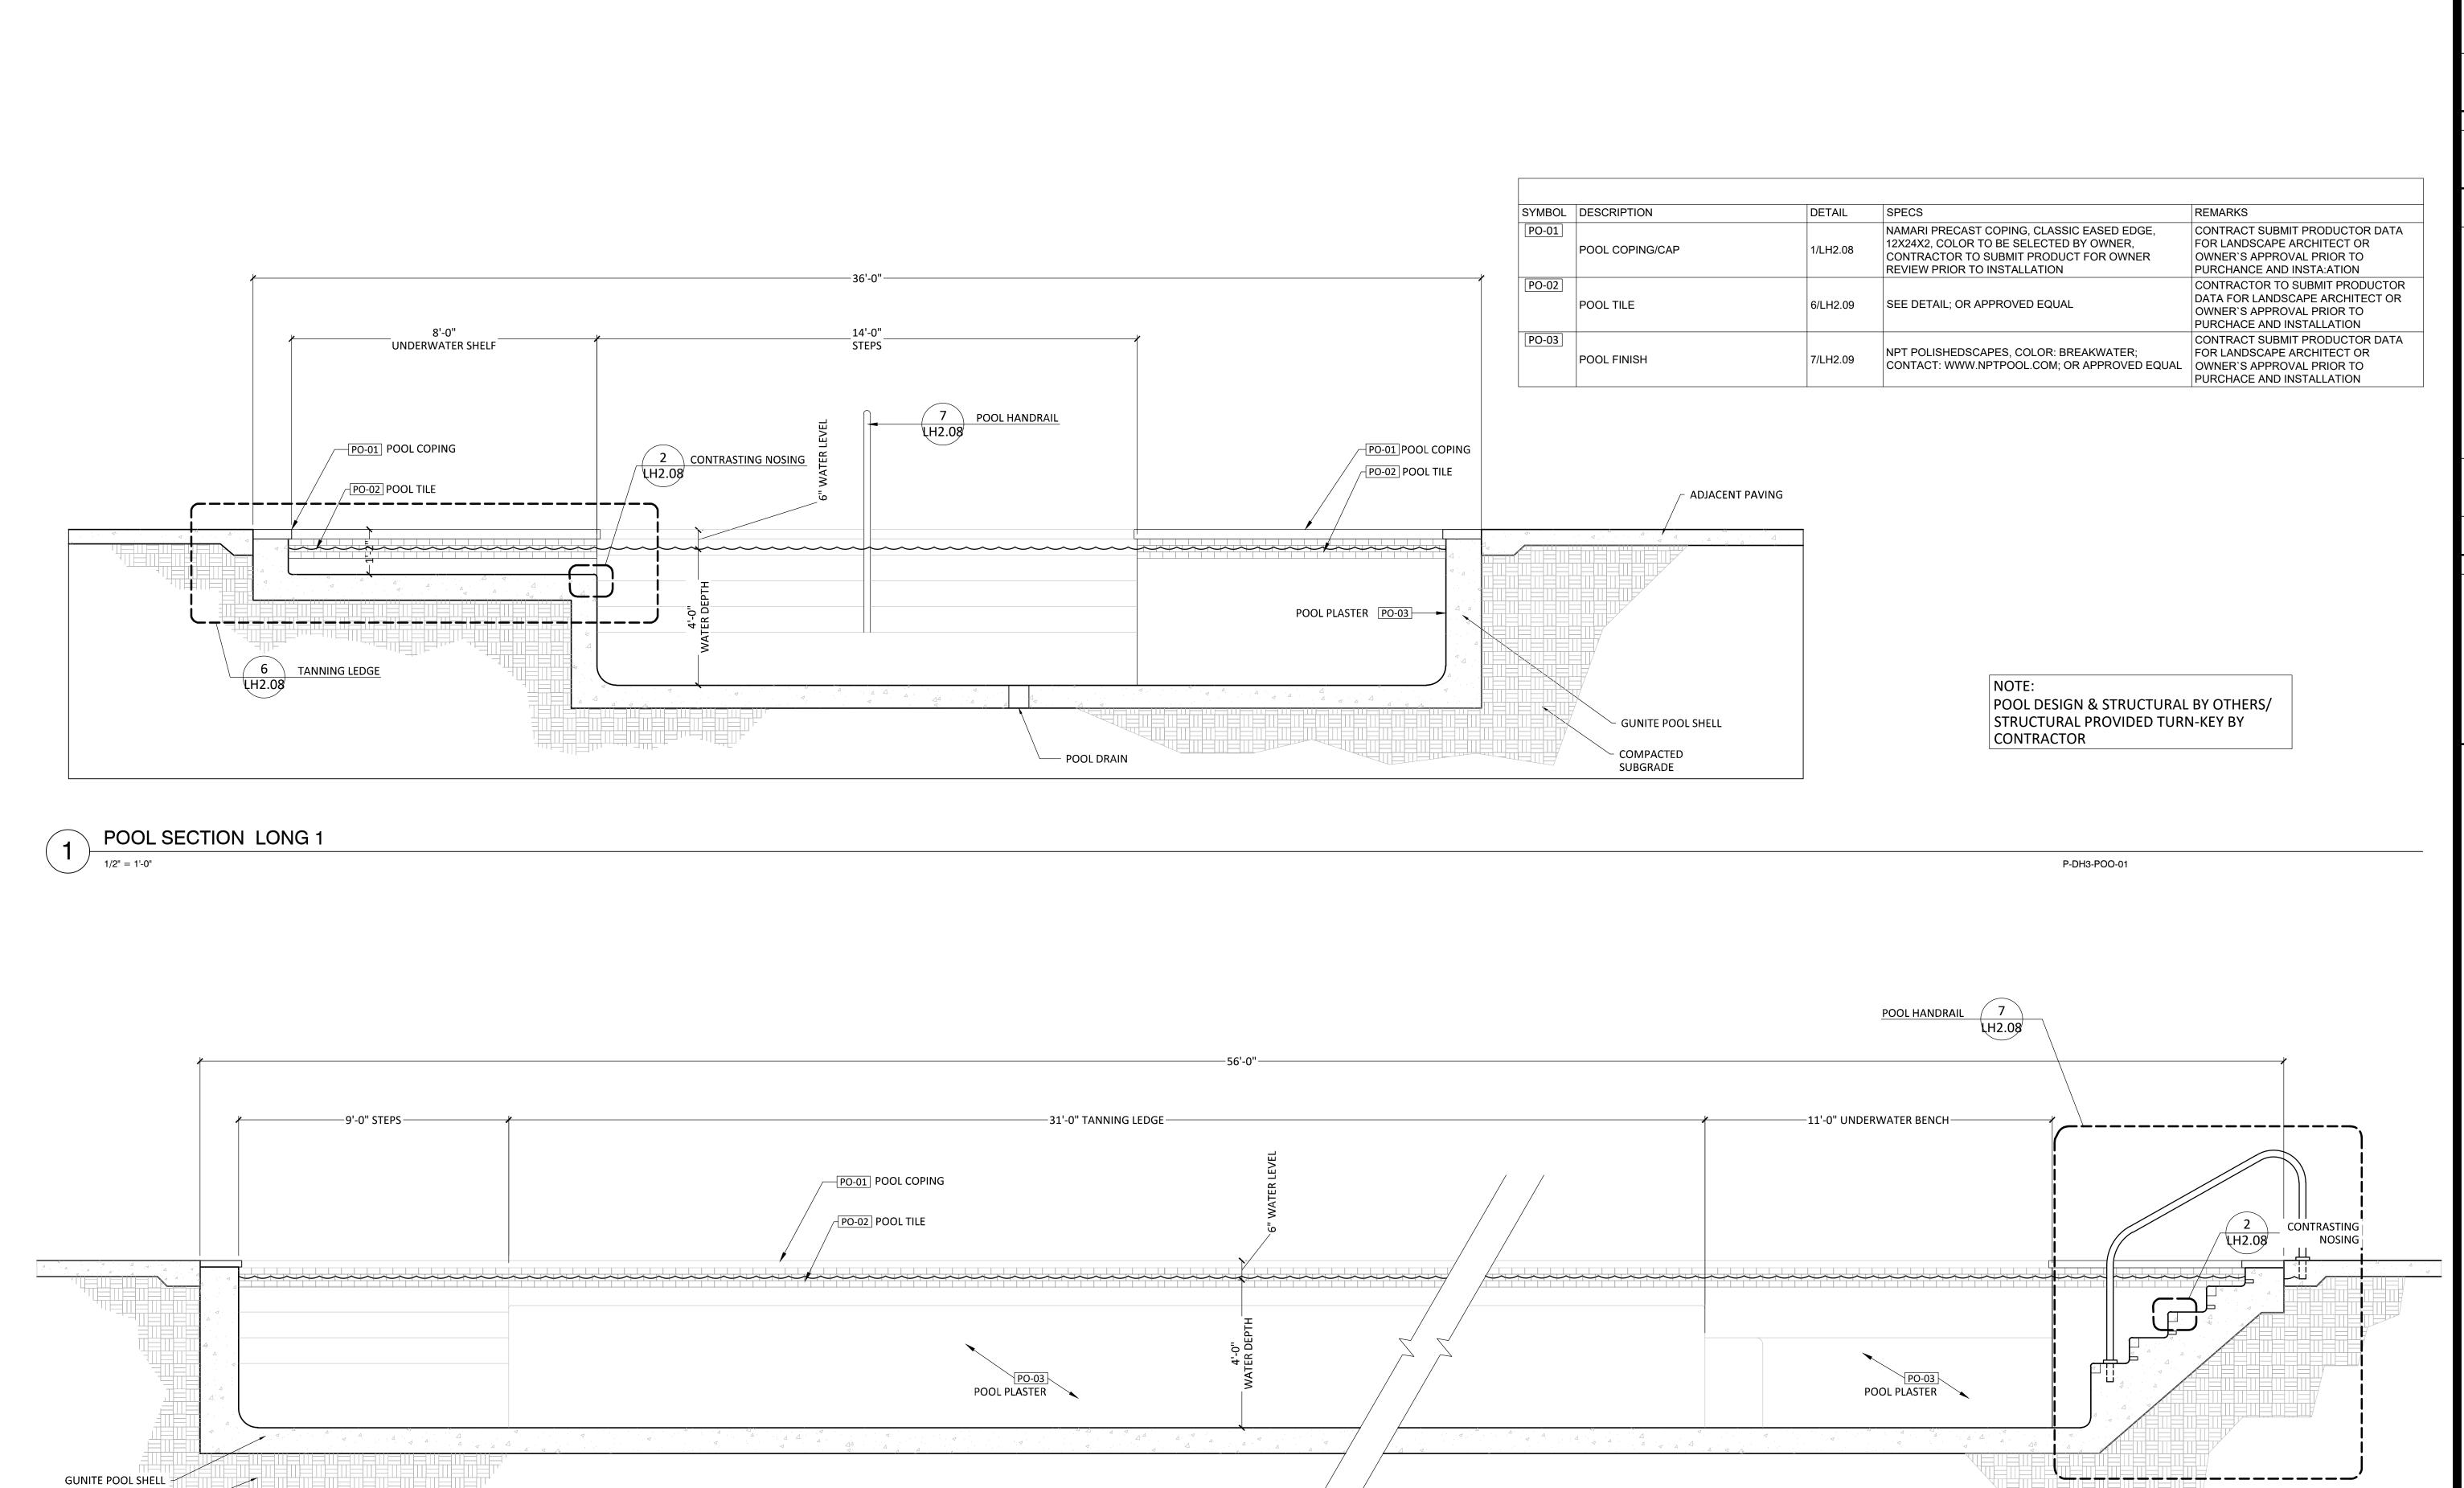

COMPACTED -SUBGRADE

POOL LONG SECTION 2

STRAND

10003 TECHNOLOGY BLVD. WEST DALLAS, TX. 75220 972-620-8204 REGISTRATION NO: F-1629

CLIENT INFO

DHI COMMUNITIES

5419 NORTH LOOP 1604 EAST, SAN ANTONIO, TX 78247 :|조|조| | 8|조|

01/26/2024

01 02 03 04 05

ON 10NO 7542 JUNO LANDING SAN ANTONIO, TEXAS 782

SCALE: AS SHOWN 12/08/2023 DRWN: STRAND

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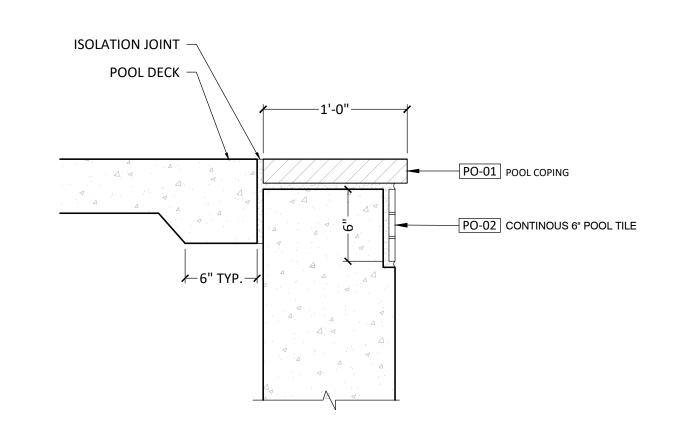
CHKD: SHEET TITLE


P-DH3-POO-02


HARDSCAPE DETAIL

SHEET NO.

LH2.07




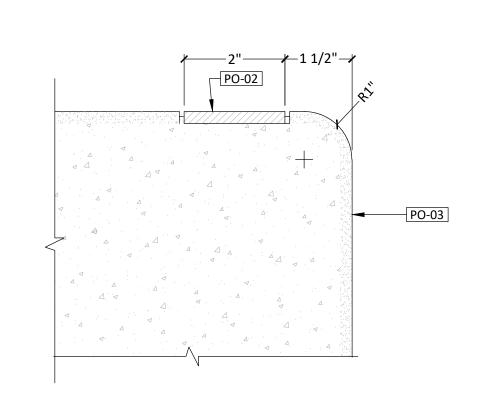

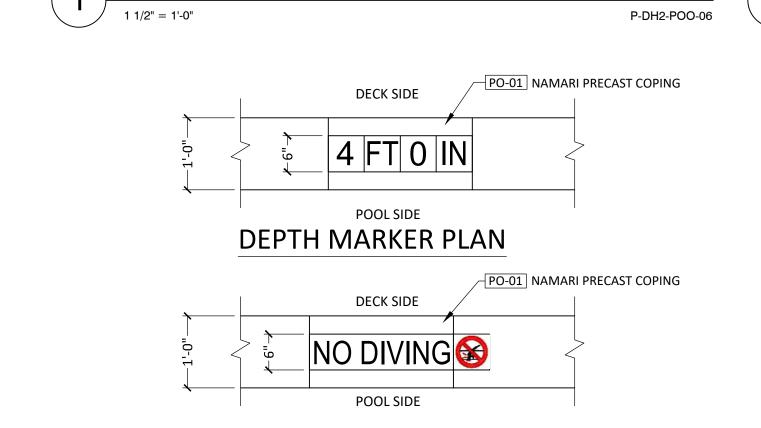


POOL COPING



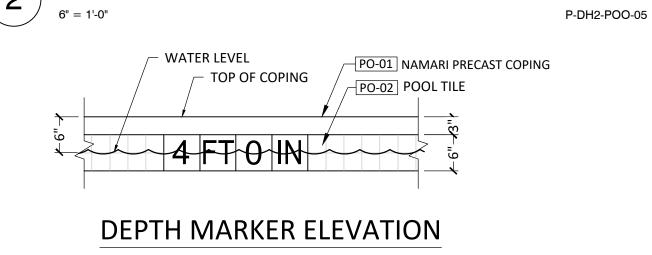

CONTRASTING NOSING

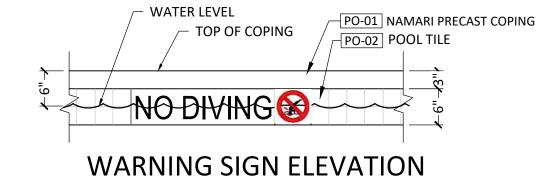


NOTE	
1.	DEPTH MARKERS AND WARNING SIGNS SHALL BE PROVIDED AS 6"X6" WHITE
	TILES WITH MINIMUM 4" TALL CONTRASTING LETTERS AND NUMBERS. COLOR:
	NAVY BLUE
2.	PROVIDE NO DIVING WARNING SIGNS WITH 6"X6" WHITE TILE DISPLAYING

INTERNATIONAL NO DIVING SYMBOL. ALL HORIZONTAL TILE INSTALLATIONS SHALL HAVE A SLIP RESISTANT FINISH. ALL VERTICAL TILE INSTALLATIONS SHALL HAVE A SMOOTH GLAZED FINISH.


4. LOCATE ALL DEPTH MARKER AND WARNING SIGN TILES SUCH THAT THEY DO NOT CONFLICT WITH PAVING JOINTS.



P-DH2-POO-10

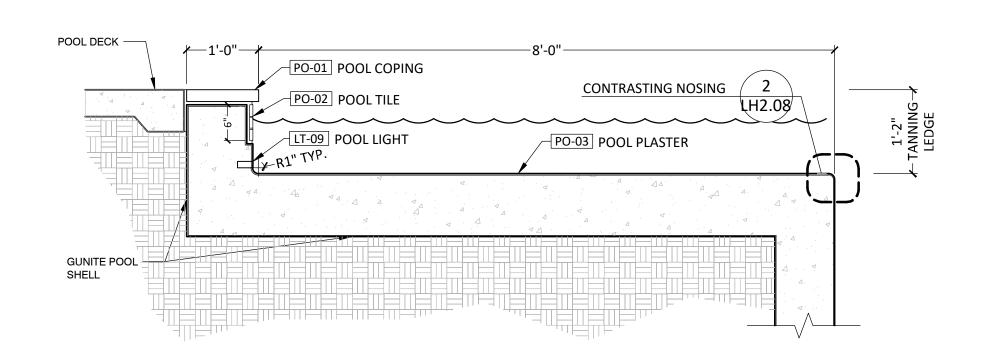




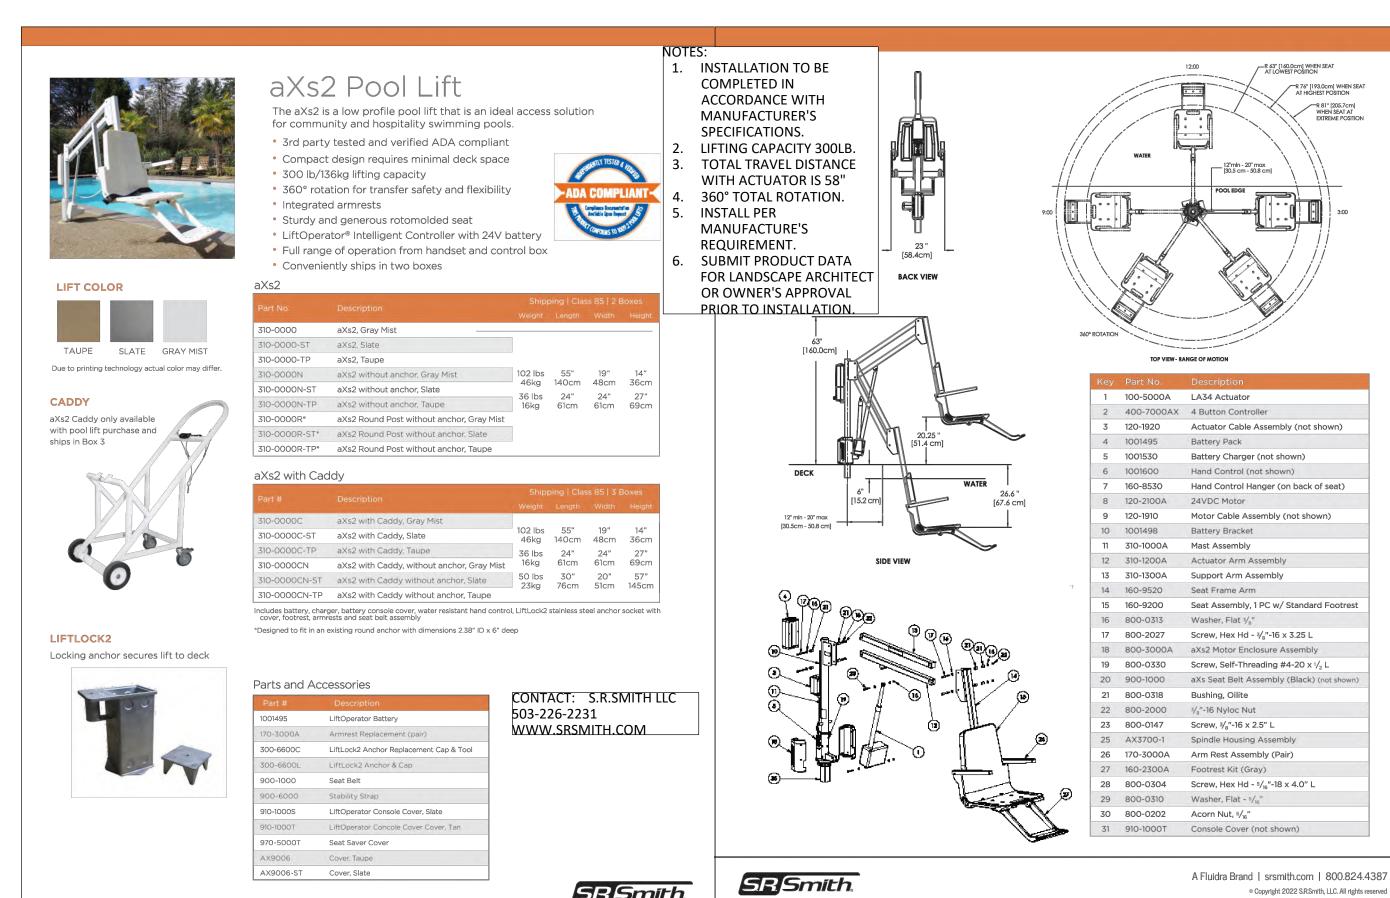


POOL LIFT 3/4" = 1'-0" P-DH3-POO-03 _____ 2" DIA.X1/4" S.S. HANDRAIL

SR/Smith.

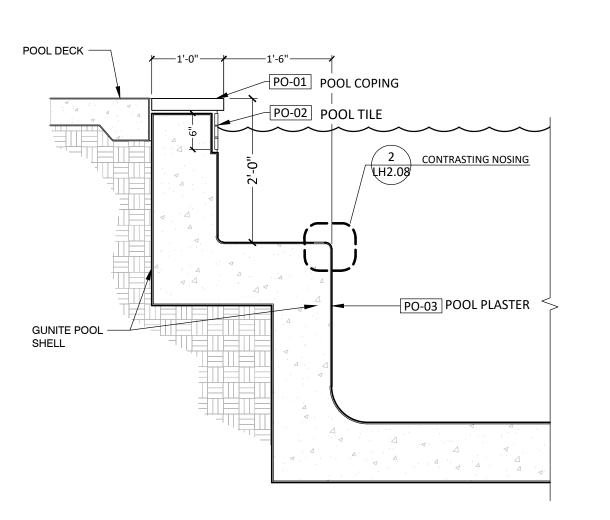

UNDERWATER BENCH

3/4" = 1'-0"

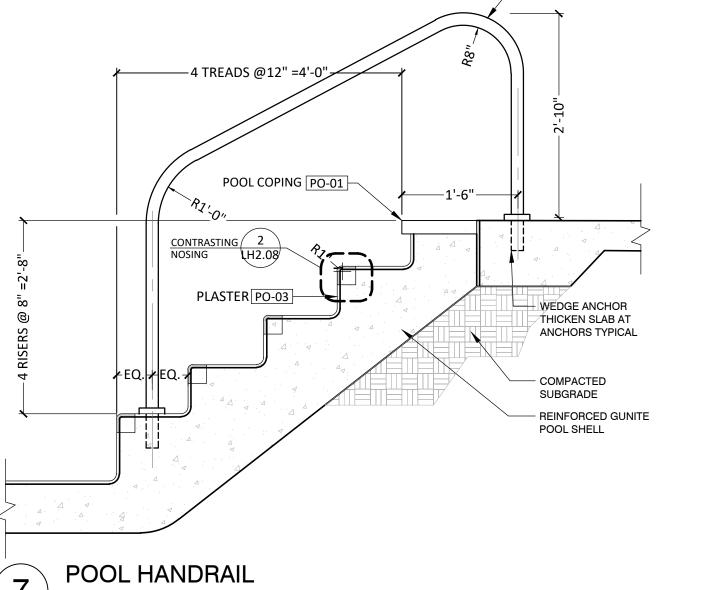

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P-DH2-POO-19

POOL SCHEDULE								
SYMBOL	DESCRIPTION	DETAIL	SPECS	REMARKS				
PO-01	POOL COPING/CAP	1/LH2.08	NAMARI PRECAST COPING, CLASSIC EASED EDGE, 12X24X2, COLOR TO BE SELECTED BY OWNER, CONTRACTOR TO SUBMIT PRODUCT FOR OWNER REVIEW PRIOR TO INSTALLATION	CONTRACT SUBMIT PRODUCTOR DATA FOR LANDSCAPE ARCHITECT OR OWNER'S APPROVAL PRIOR TO PURCHANCE AND INSTA:ATION				
PO-02	POOL TILE	6/LH2.09	SEE DETAIL; OR APPROVED EQUAL	CONTRACTOR TO SUBMIT PRODUCTOR DATA FOR LANDSCAPE ARCHITECT OR OWNER'S APPROVAL PRIOR TO PURCHACE AND INSTALLATION				
PO-03	POOL FINISH	7/LH2.09	NPT POLISHEDSCAPES, COLOR: BREAKWATER; CONTACT: WWW.NPTPOOL.COM; OR APPROVED EQUAL	CONTRACT SUBMIT PRODUCTOR DATA FOR LANDSCAPE ARCHITECT OR OWNER'S APPROVAL PRIOR TO PURCHACE AND INSTALLATION				

P-DH2-POO-20

STRAND

10003 TECHNOLOGY BLVD.

WEST DALLAS, TX. 75220 972-620-8204 REGISTRATION NO: F-1629

CLIENT INFO

DHI COMMUNITIES 5419 NORTH LOOP 1604 EAST, SAN ANTONIO, TX 78247

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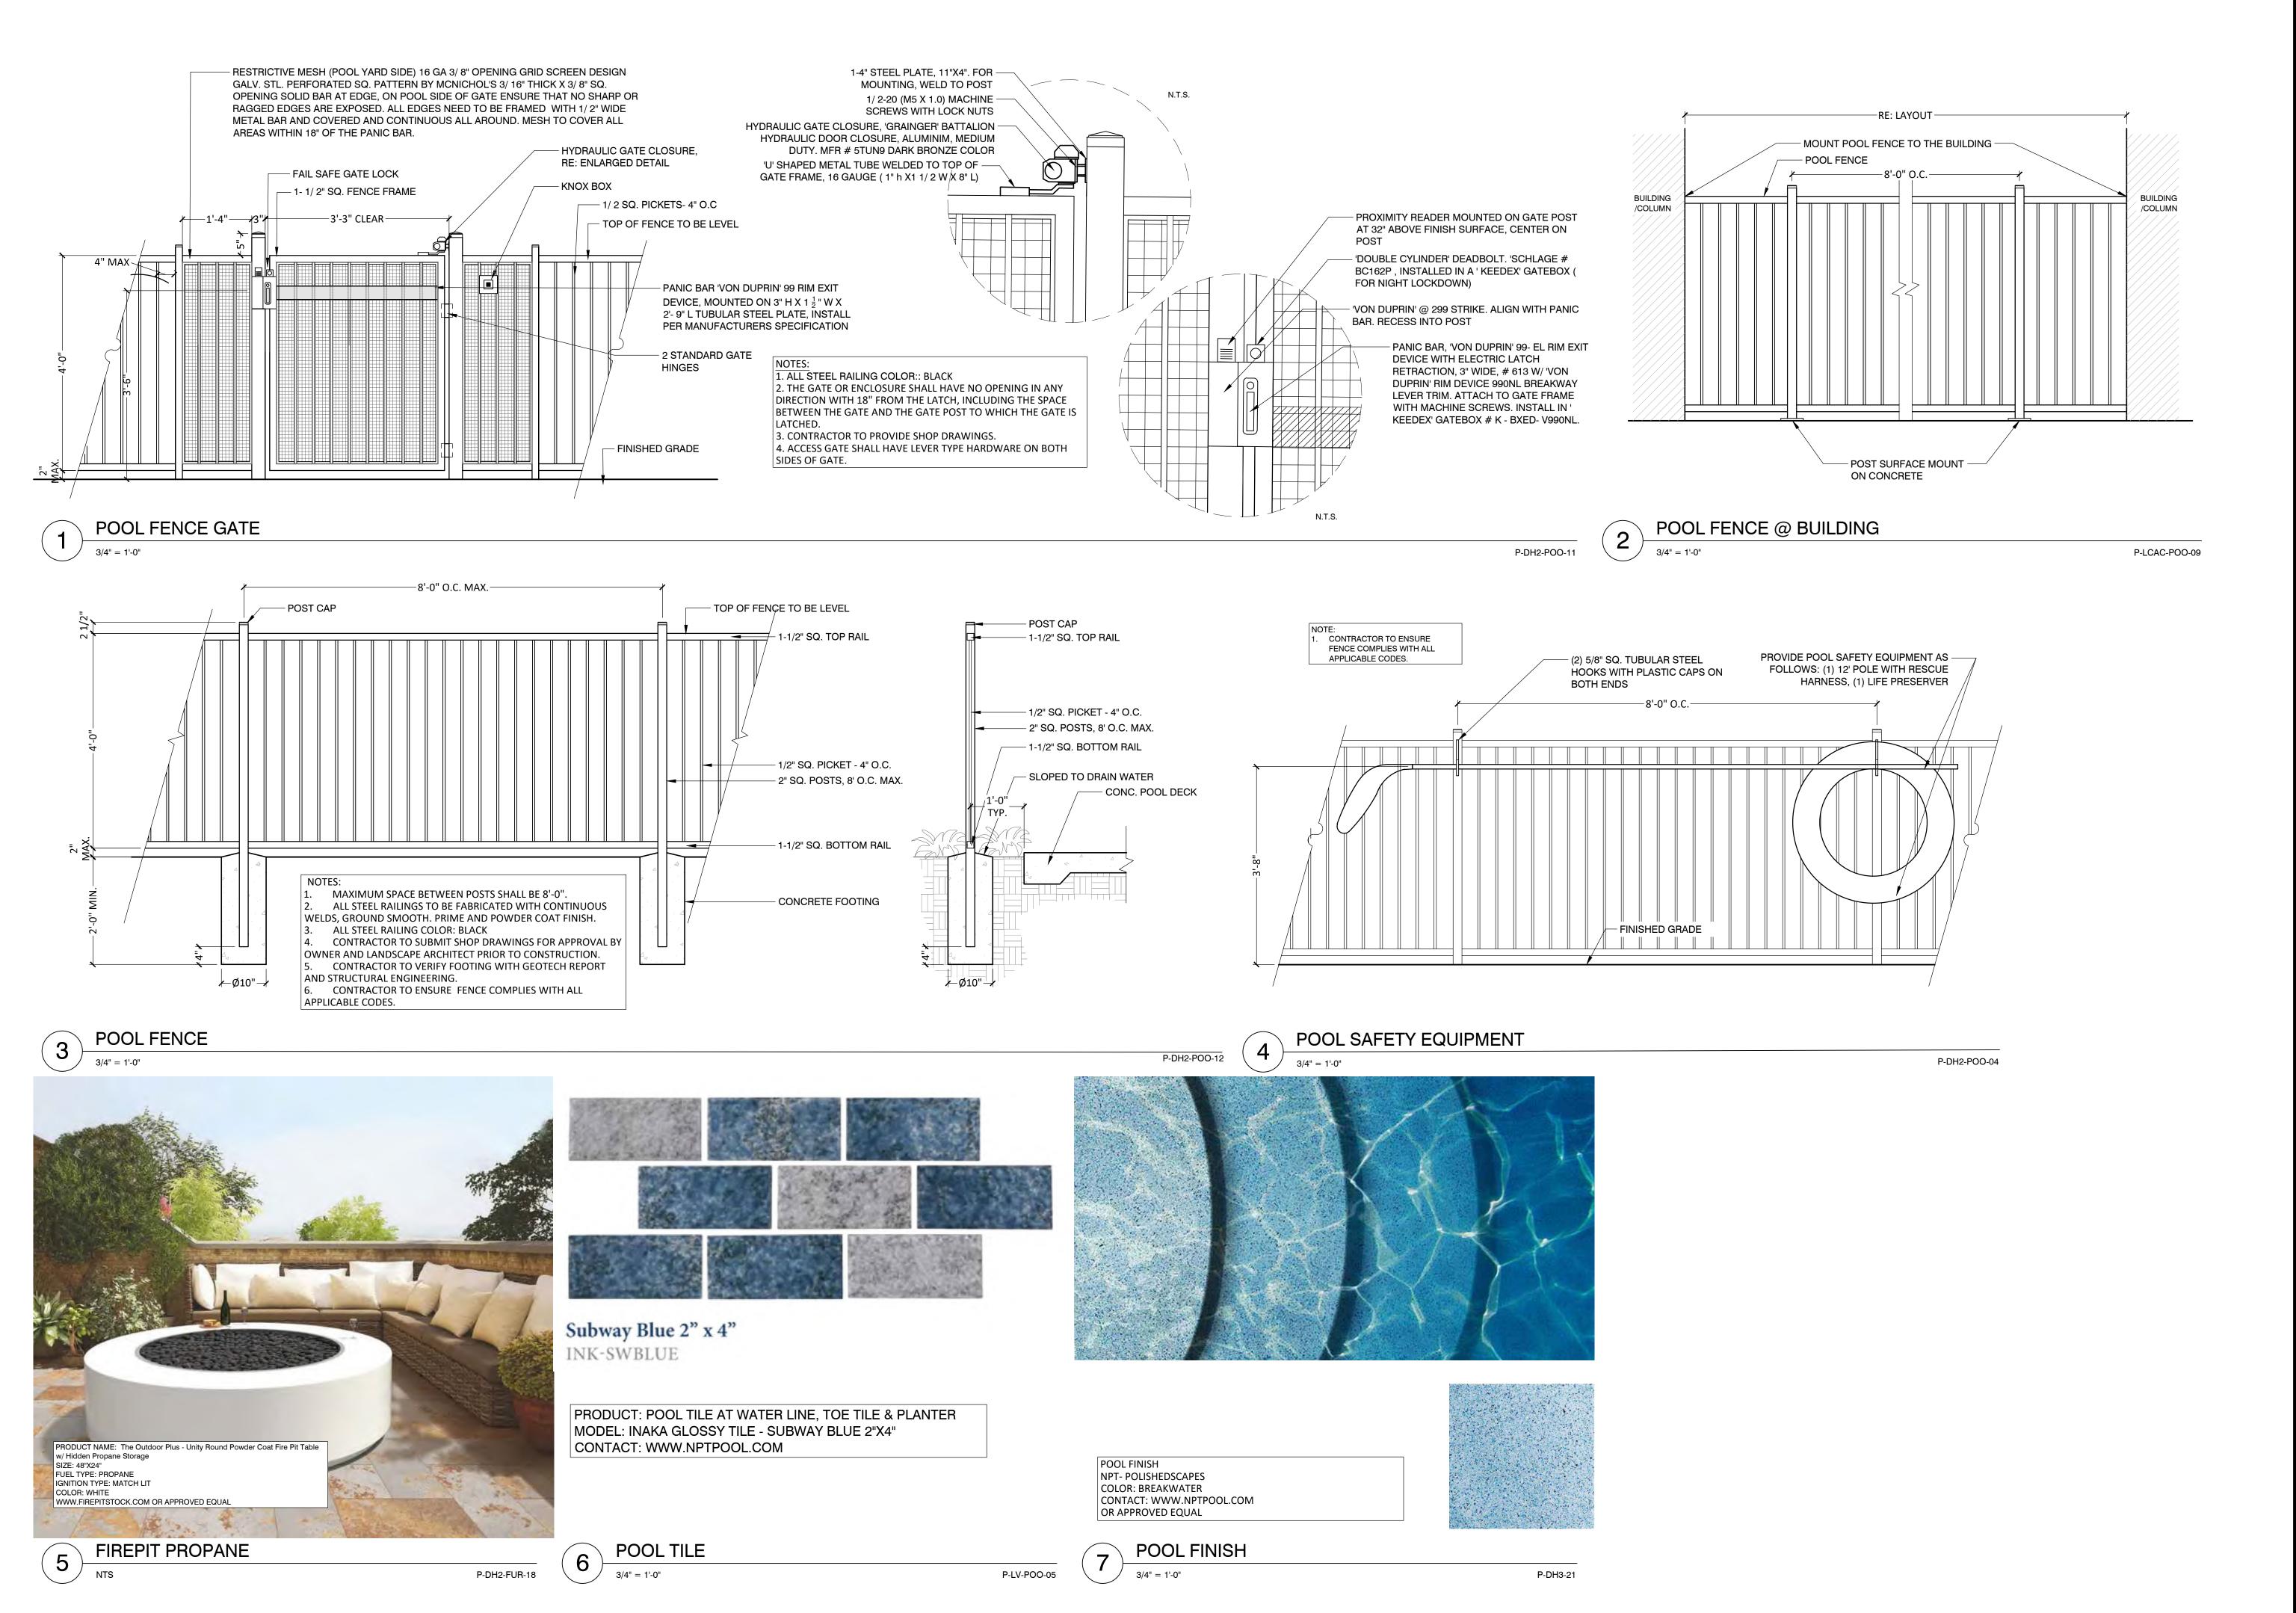
SCALE: AS SHOWN 12/08/2023 DRWN: STRAND CHKD: STRAND

SHEET TITLE

HARDSCAPE DETAIL

LH2.08

SHEET NO.




10003 TECHNOLOGY BLVD. WEST DALLAS, TX. 75220 972-620-8204

REGISTRATION NO: F-1629

CLIENT INFO DHI COMMUNITIES

5419 NORTH LOOP 1604 EAST, SAN ANTONIO, TX 78247

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SCALE: AS SHOWN 12/08/2023

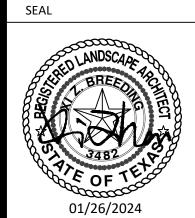
STRAND


CHKD: STRAND SHEET TITLE

HARDSCAPE DETAIL

SHEET NO.

LH2.09

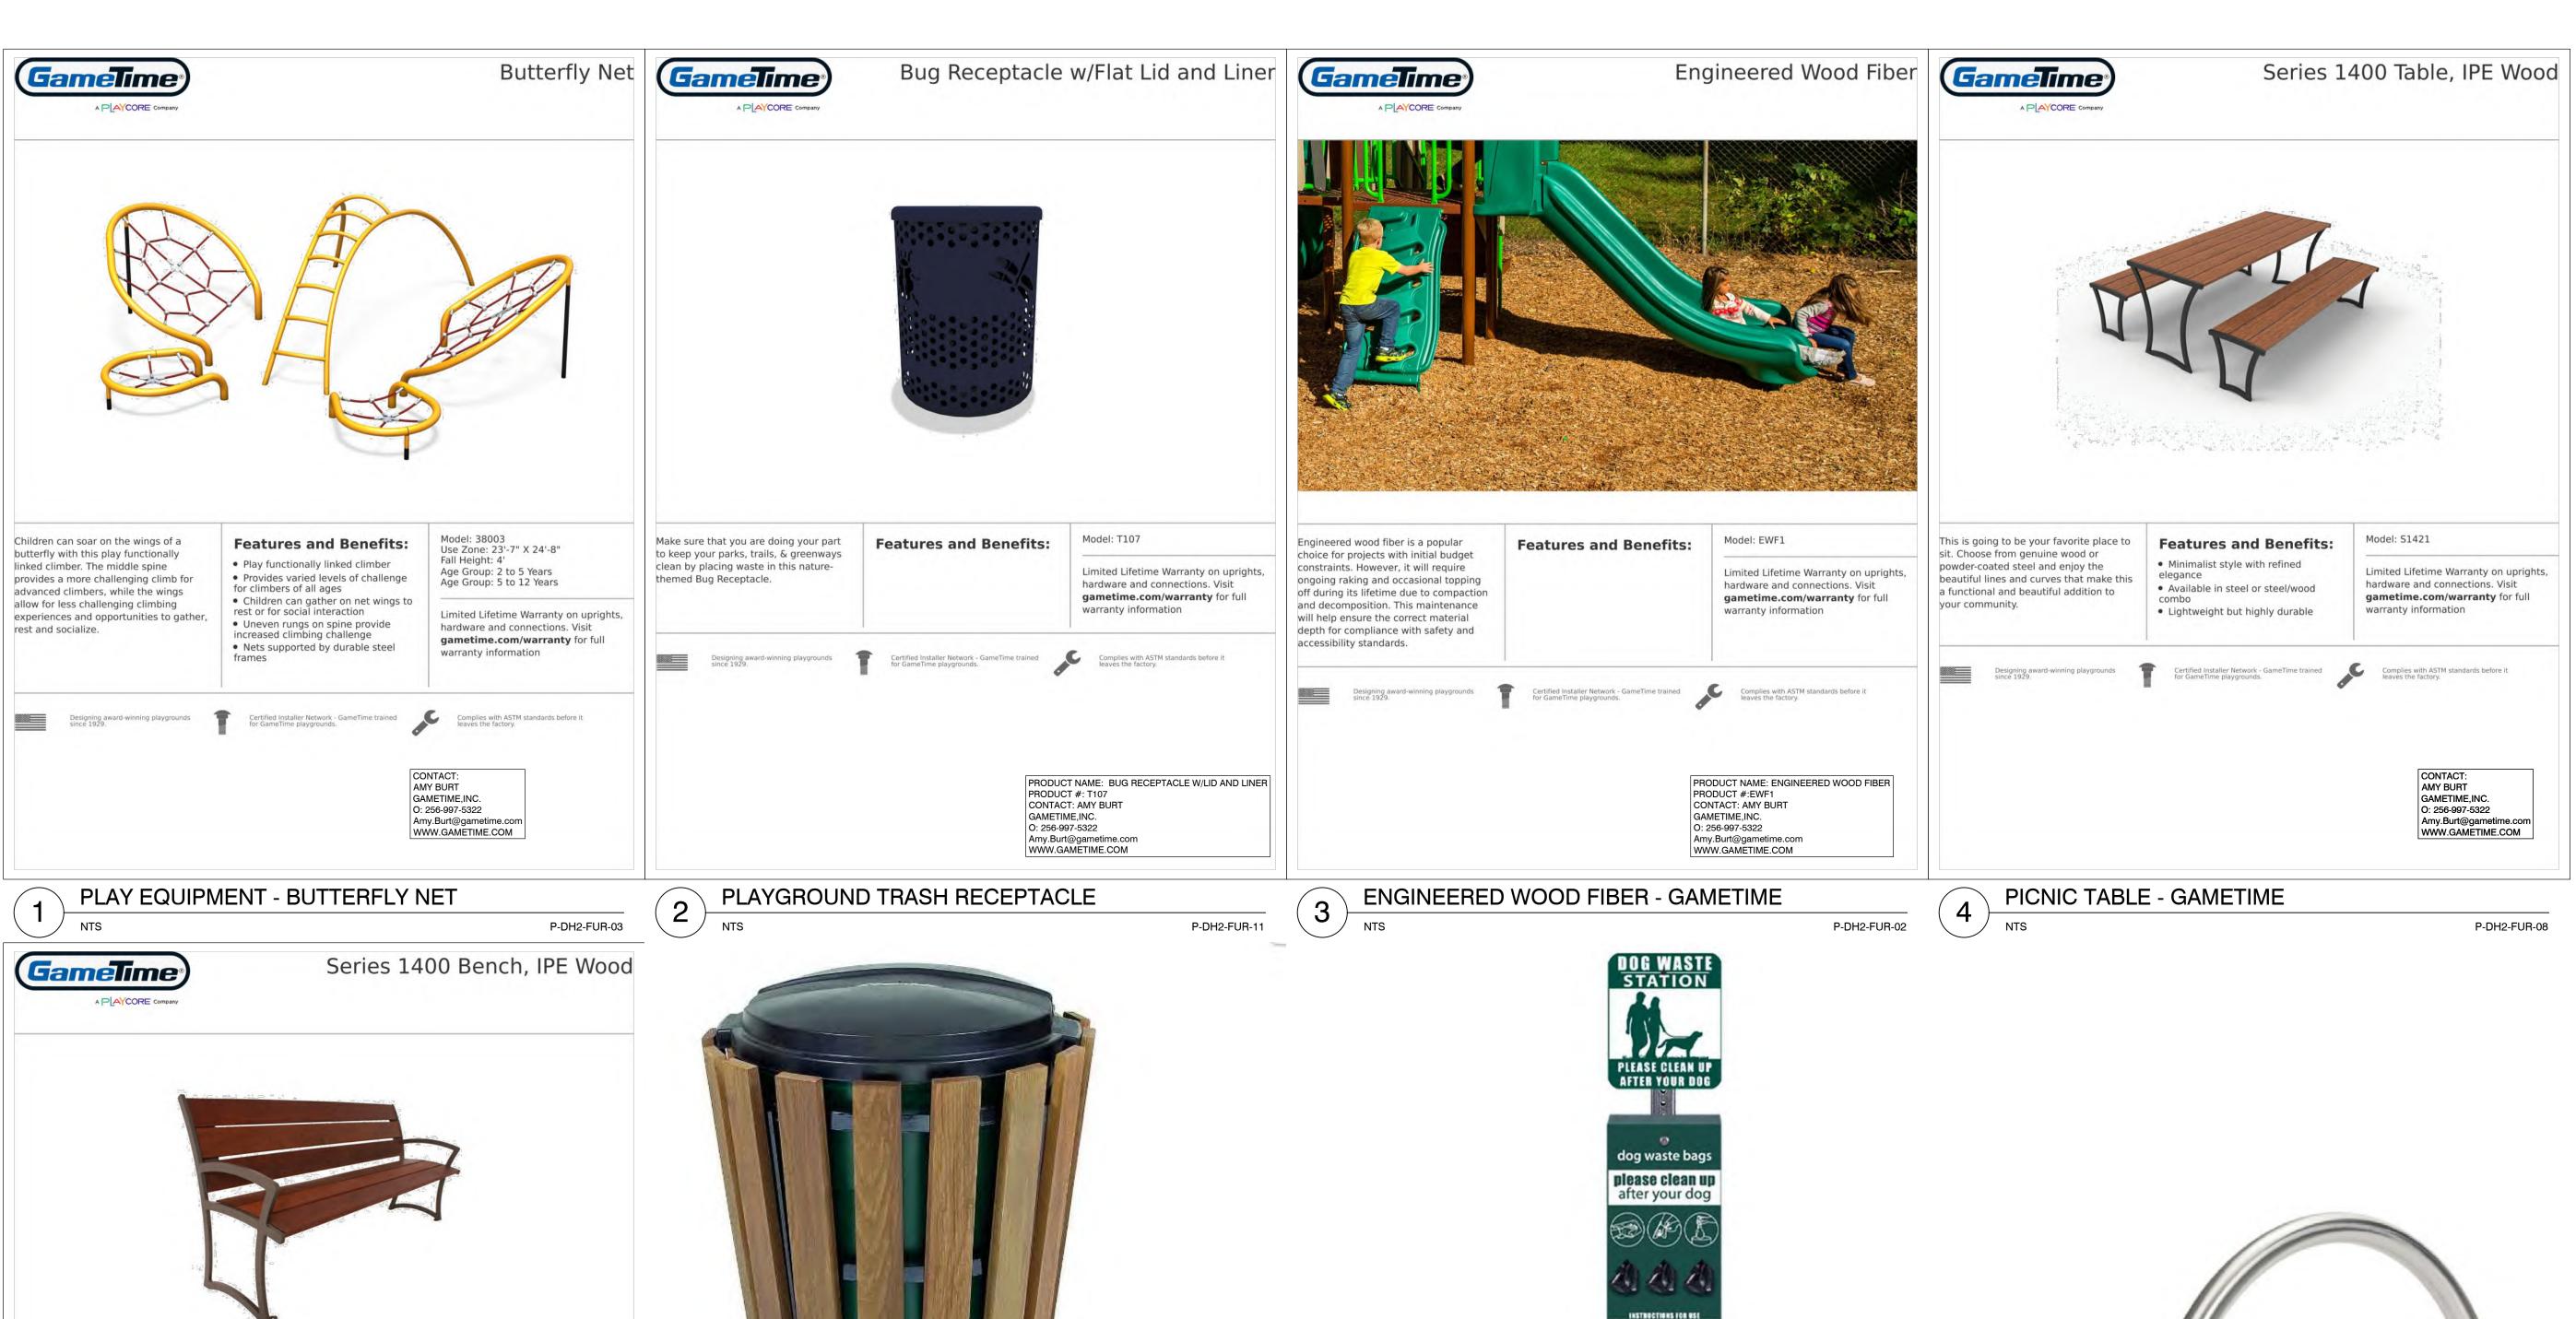

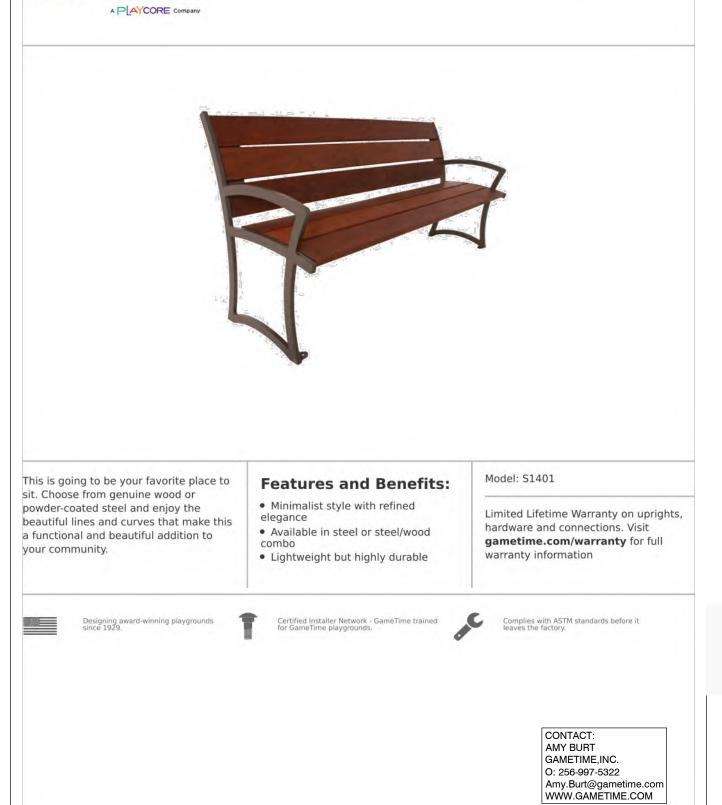

BENCH - GAMETIME



PRODUCT NAME: DELUXE LITTER RECEPTACLE PRODUCT #: 8728 CONTACT: AMY BURT GAMETIME,INC. O: 256-997-5322 Amy.Burt@gametime.com WWW.GAMETIME.COM

P-DH2-FUR-09

LITTER RECEPTACLE - GAMETIME

P-DH2-FUR-16

DOG WASTE STATION

PRODUCT NAME: DOG WASTE STATION WITH

SQUARE STEEL CAN AND ONEPUL BAG

CONTACT: WWW.ANOVAFURNINGS.COM

SYSTEMMODEL#: 7711

PRODUCT #: CIRCLEBRS2 PRODUCT NAME: TANDEM STAINLESS STEEL BIKE RACK, SURFACE MOUNT

CONTACT: ANOVAFURNISHINGS.COM

BIKE RACK

P-DH2-FUR-01

P-DH3-02

SCALE: AS SHOWN 12/08/2023 DRWN: STRAND

NO O

STRAND

10003 TECHNOLOGY BLVD. WEST DALLAS, TX. 75220 972-620-8204

REGISTRATION NO: F-1629

5419 NORTH LOOP 1604 EAST, SAN ANTONIO, TX 78247

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01 02 03 04 05

01/26/2024

CLIENT INFO


DHI COMMUNITIES

CHKD: STRAND SHEET TITLE

SHEET NO.

HARDSCAPE DETAIL

LH2.10

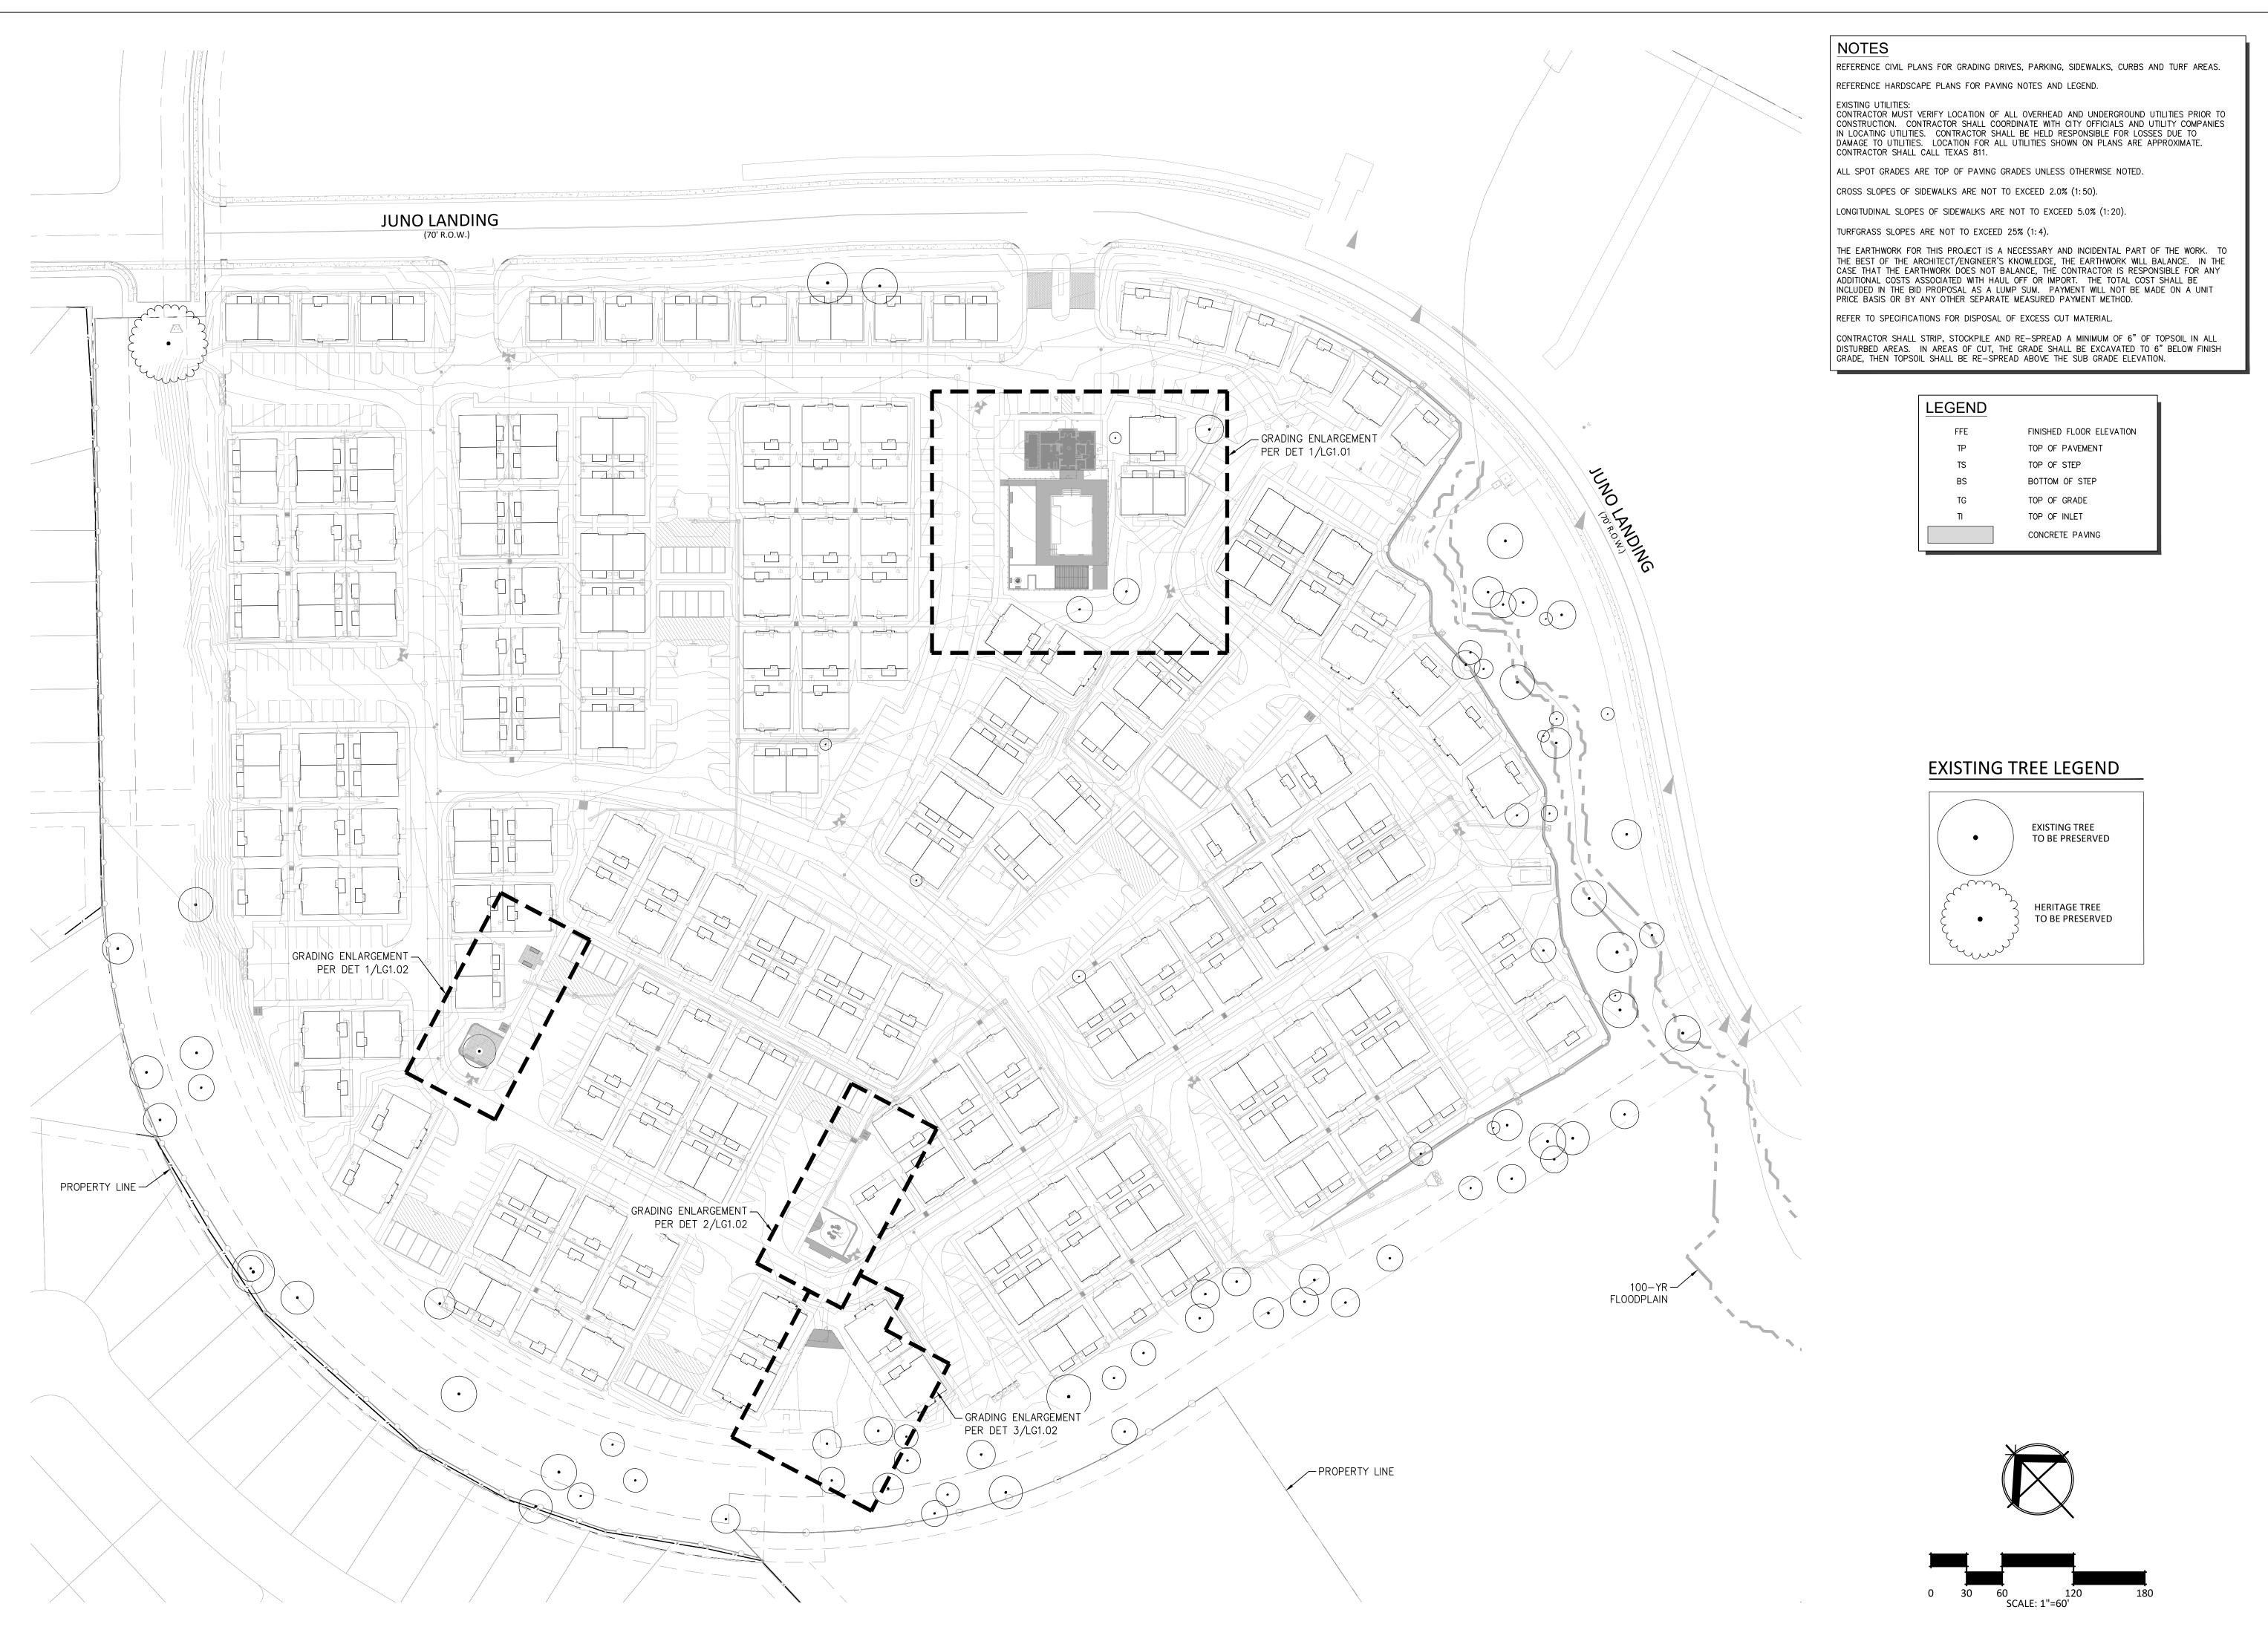


10003 TECHNOLOGY BLVD. WEST DALLAS, TX. 75220 972-620-8204 REGISTRATION NO: F-1629

CLIENT INFO

CLIENT NAME ADDRESS

CITY, STATE, ZIP CODE

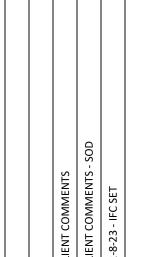

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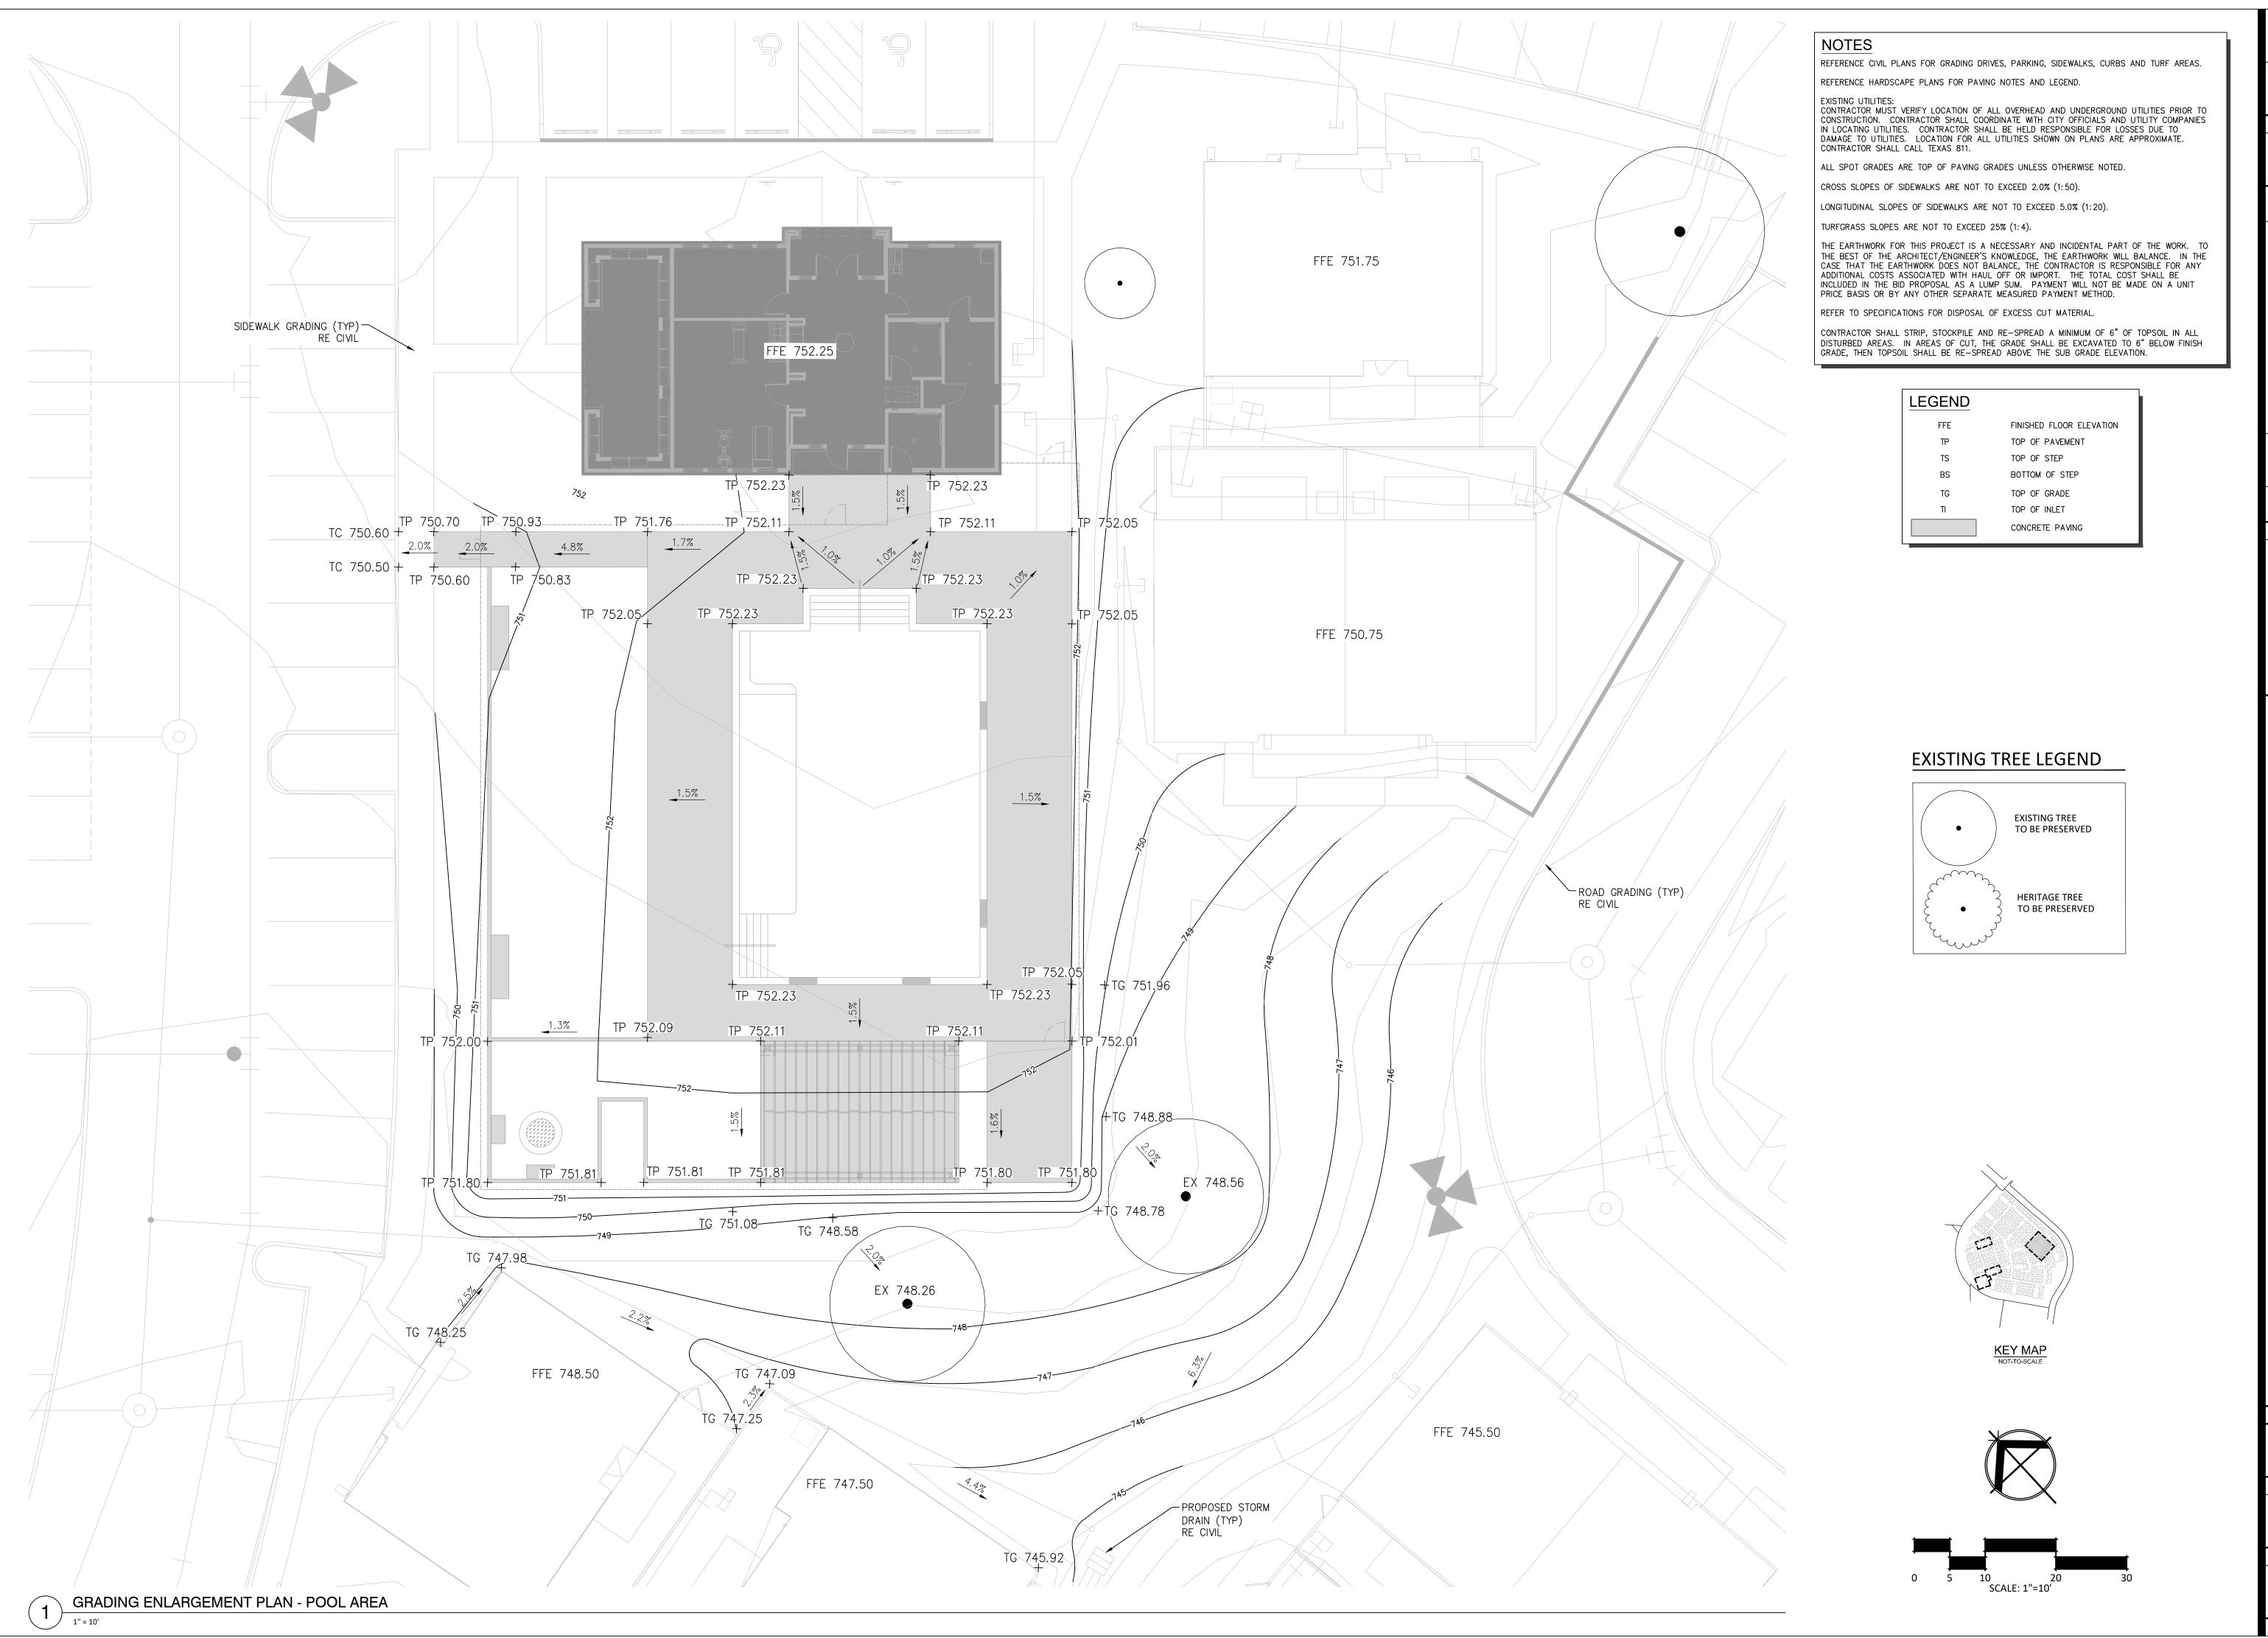
SCALE: AS SHOWN

CHKD: STRAND SHEET TITLE

OVERALL GRADING PLAN

LG1.00


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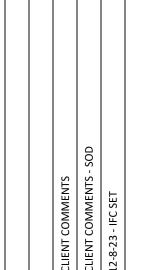


10003 TECHNOLOGY BLVD. WEST DALLAS, TX. 75220 972-620-8204 REGISTRATION NO: F-1629

CLIENT INFO

CLIENT NAME ADDRESS CITY, STATE, ZIP CODE



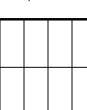



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ASCEND

SHEET TITLE **GRADING ENLARGEMENT** PLAN

SCALE: AS SHOWN

STRAND


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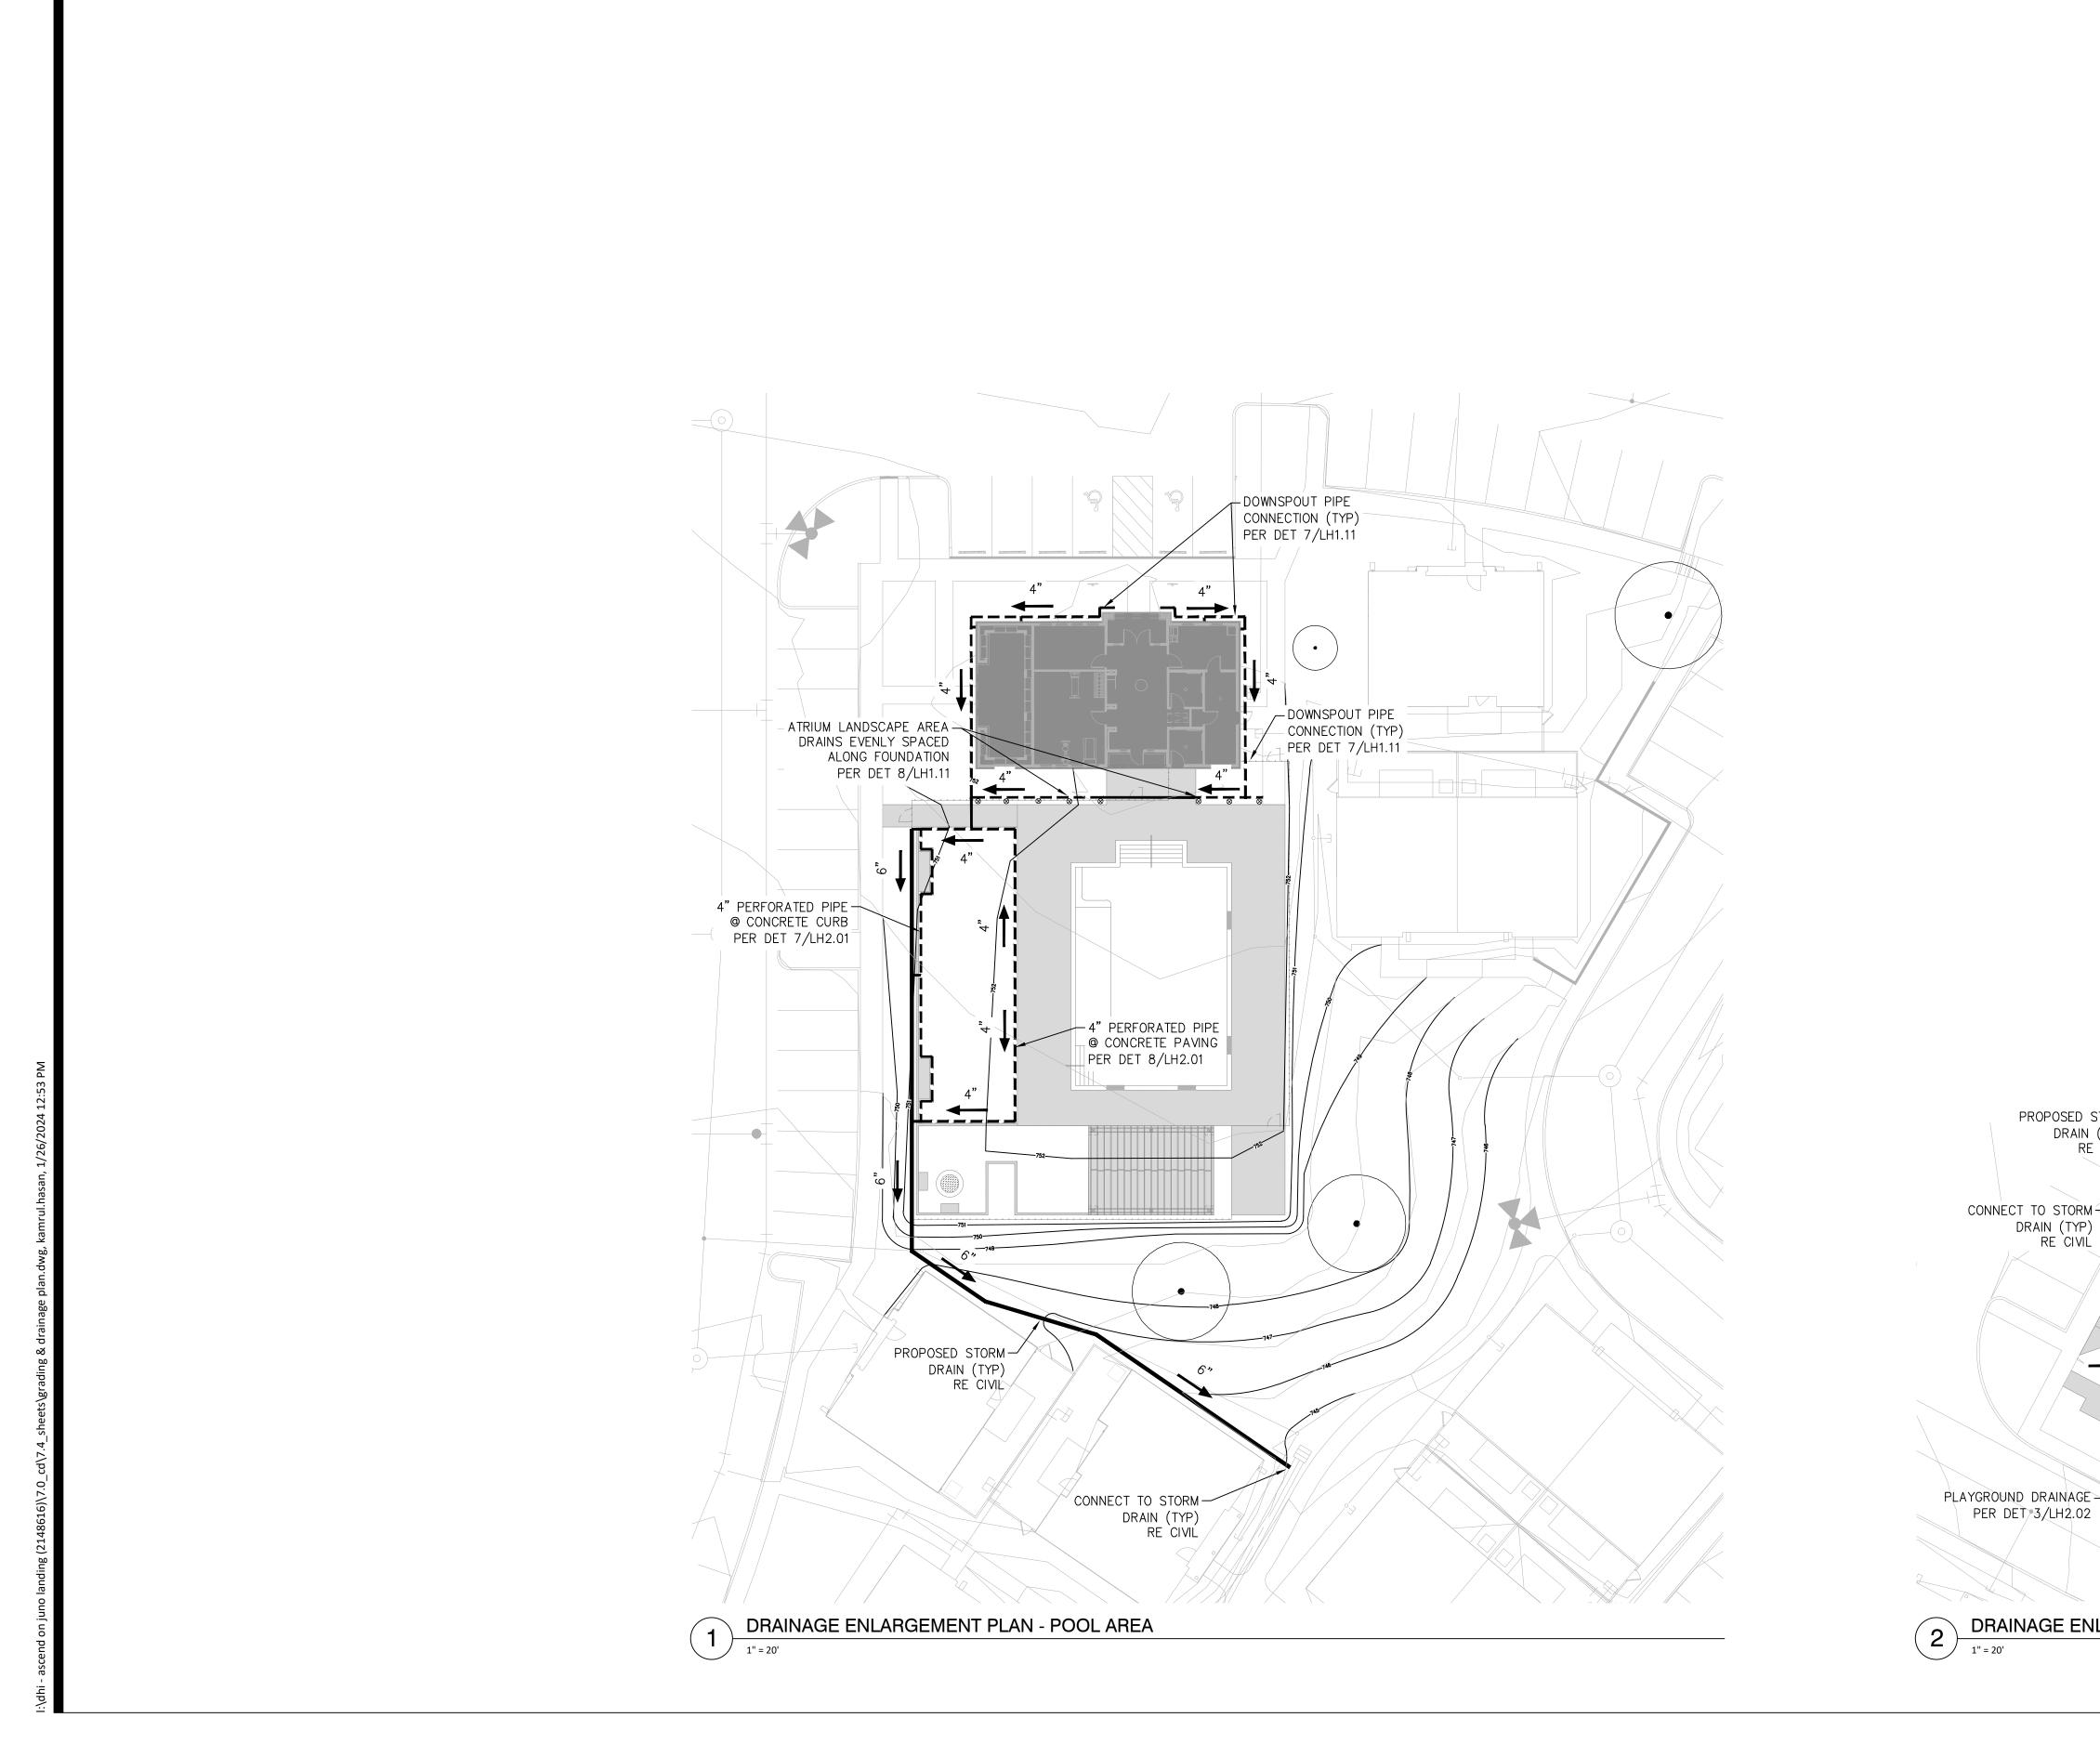
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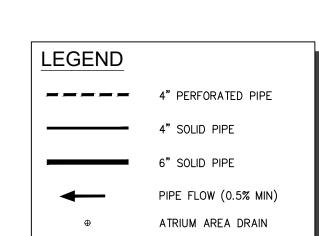
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SHEET NO.


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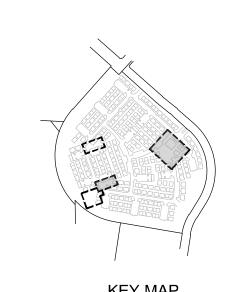






EXISTING TREE LEGEND

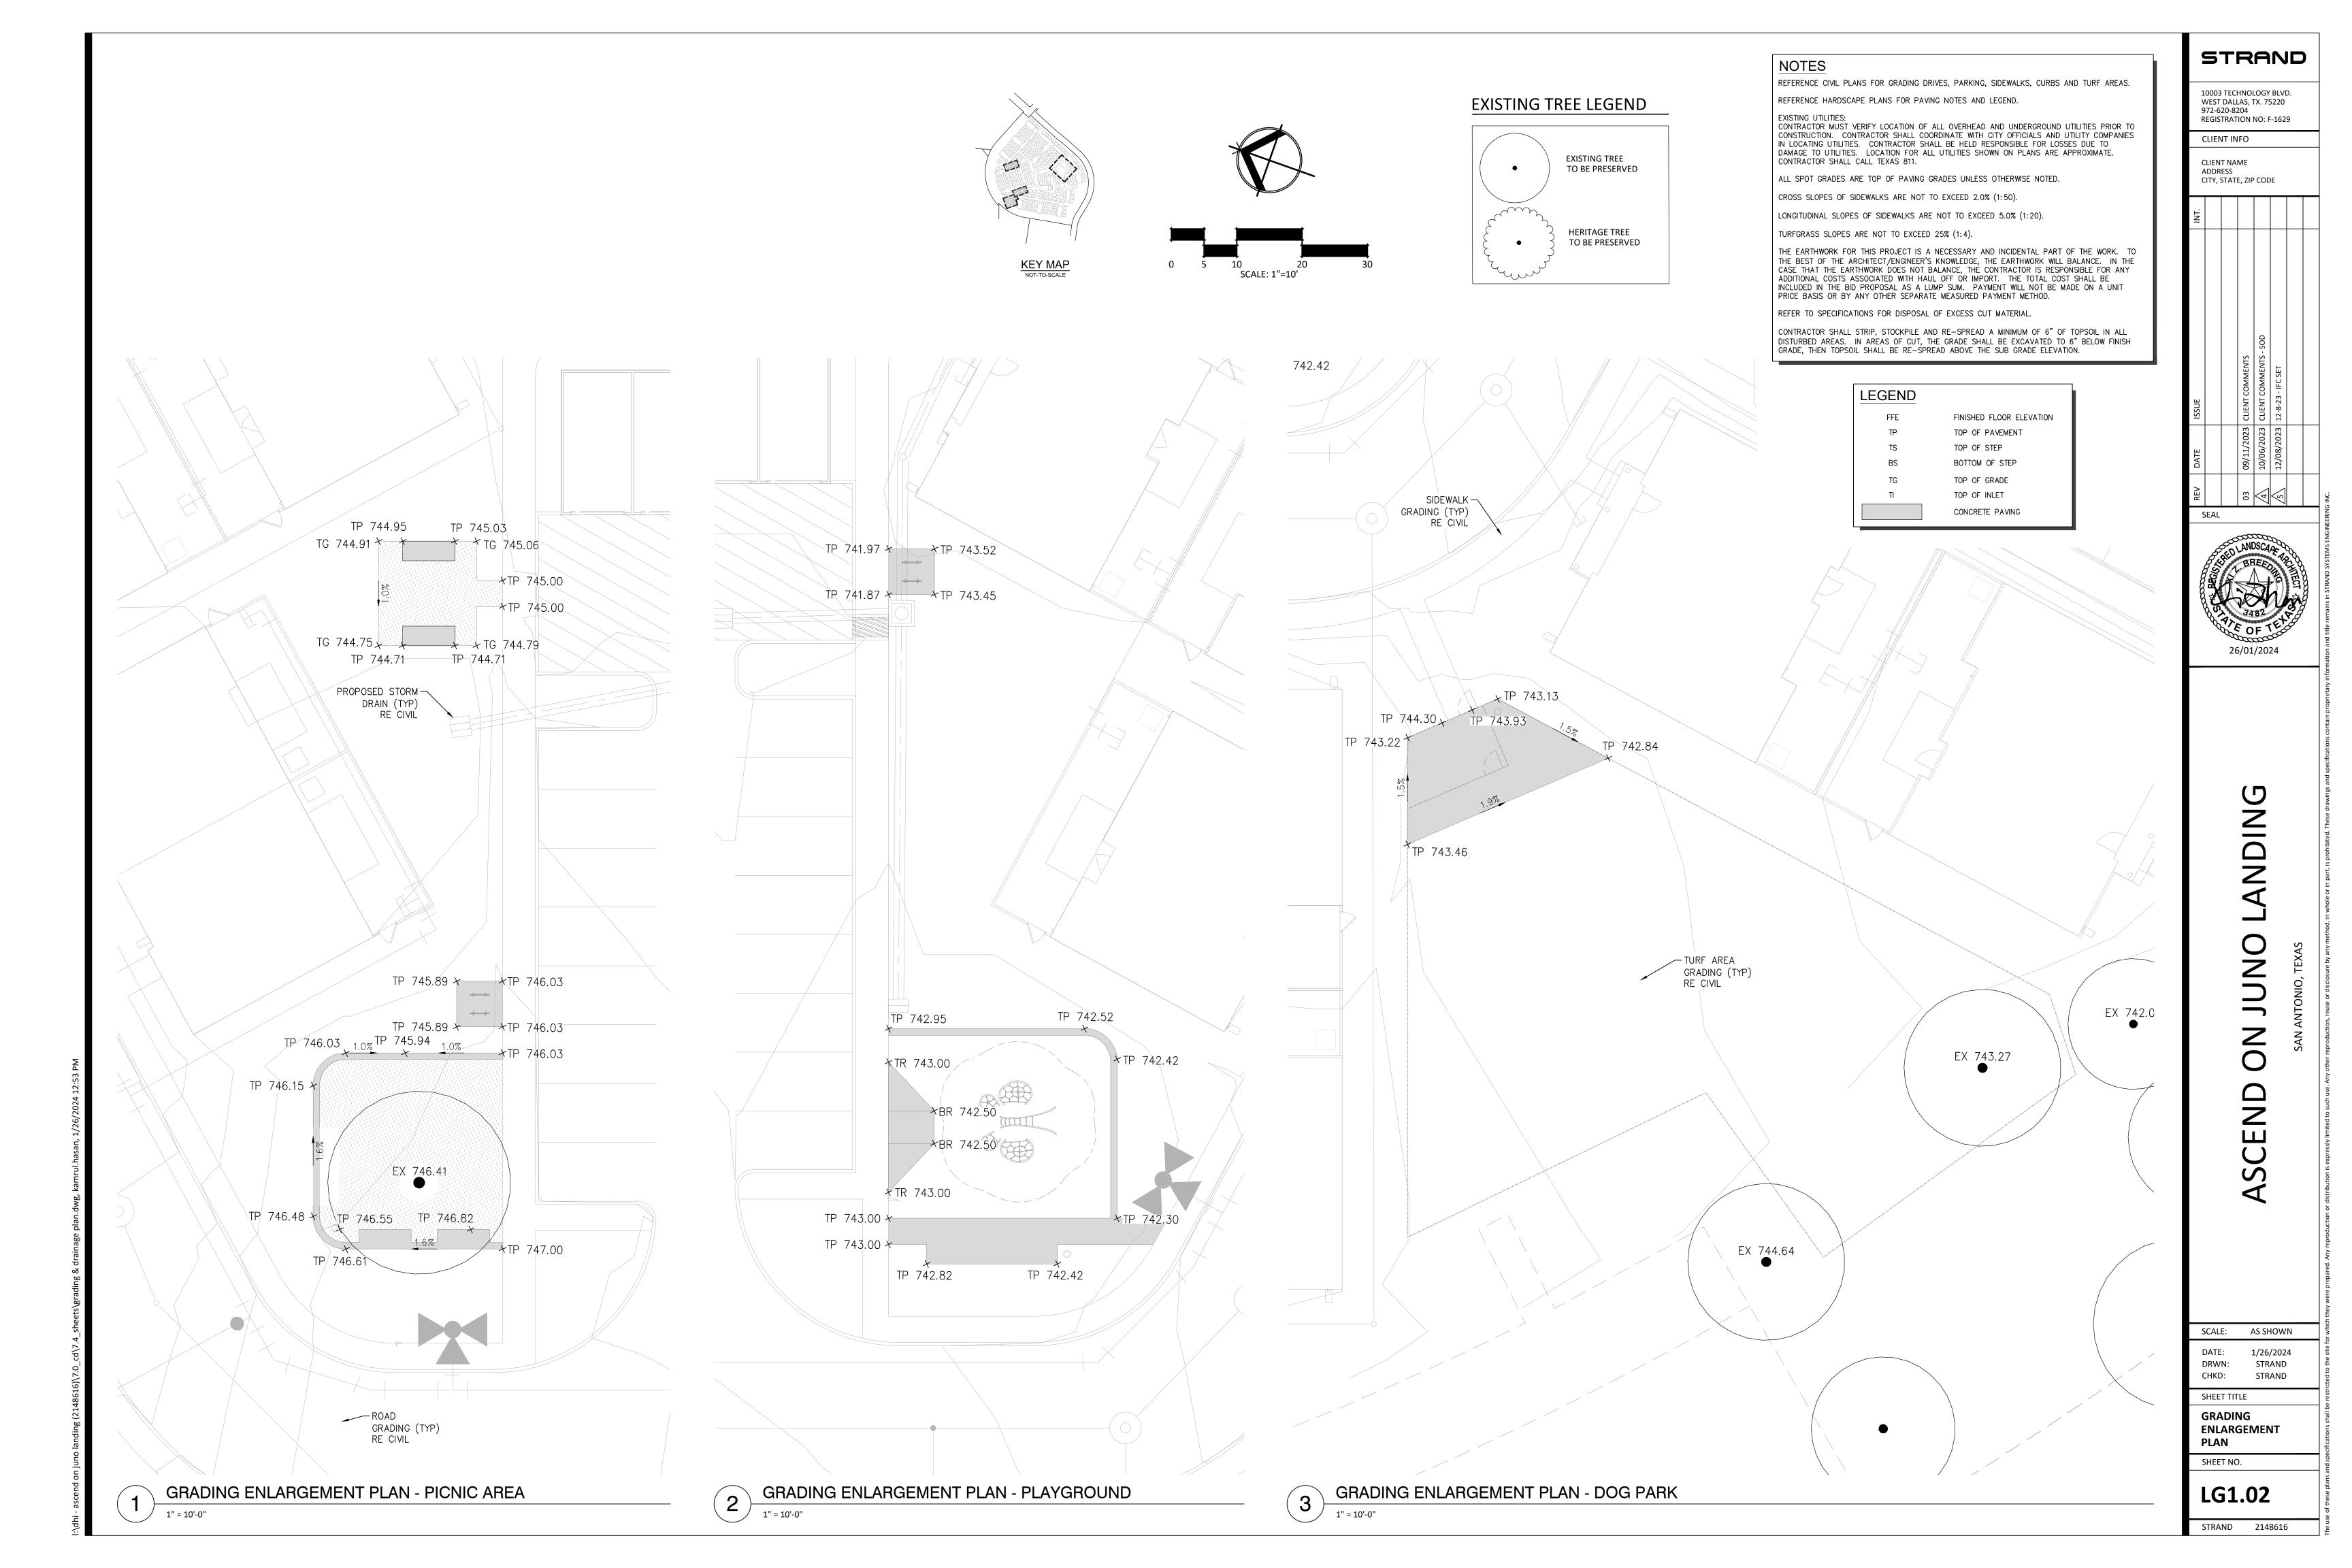

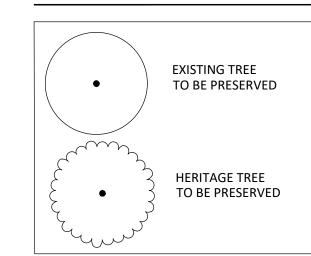

PROPOSED STORM-DRAIN (TYP)


CONNECT TO STORM—


DRAIN (TYP)

RE CIVIL

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DRAINAGE ENLARGEMENT PLAN - PLAYGROUND



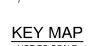

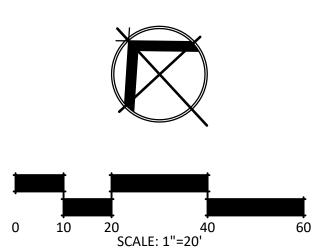LD1.01

SHEET TITLE

STRAND

10003 TECHNOLOGY BLVD. WEST DALLAS, TX. 75220 972-620-8204 REGISTRATION NO: F-1629

CLIENT INFO

CLIENT NAME

CITY, STATE, ZIP CODE


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SCALE: AS SHOWN 1/26/2024 DRWN: STRAND CHKD: STRAND

ASCEND

DRAINAGE ENLARGEMENT PLAN SHEET NO.



10003 TECHNOLOGY BLVD. WEST DALLAS, TX. 75220 972-620-8204 REGISTRATION NO: F-1629

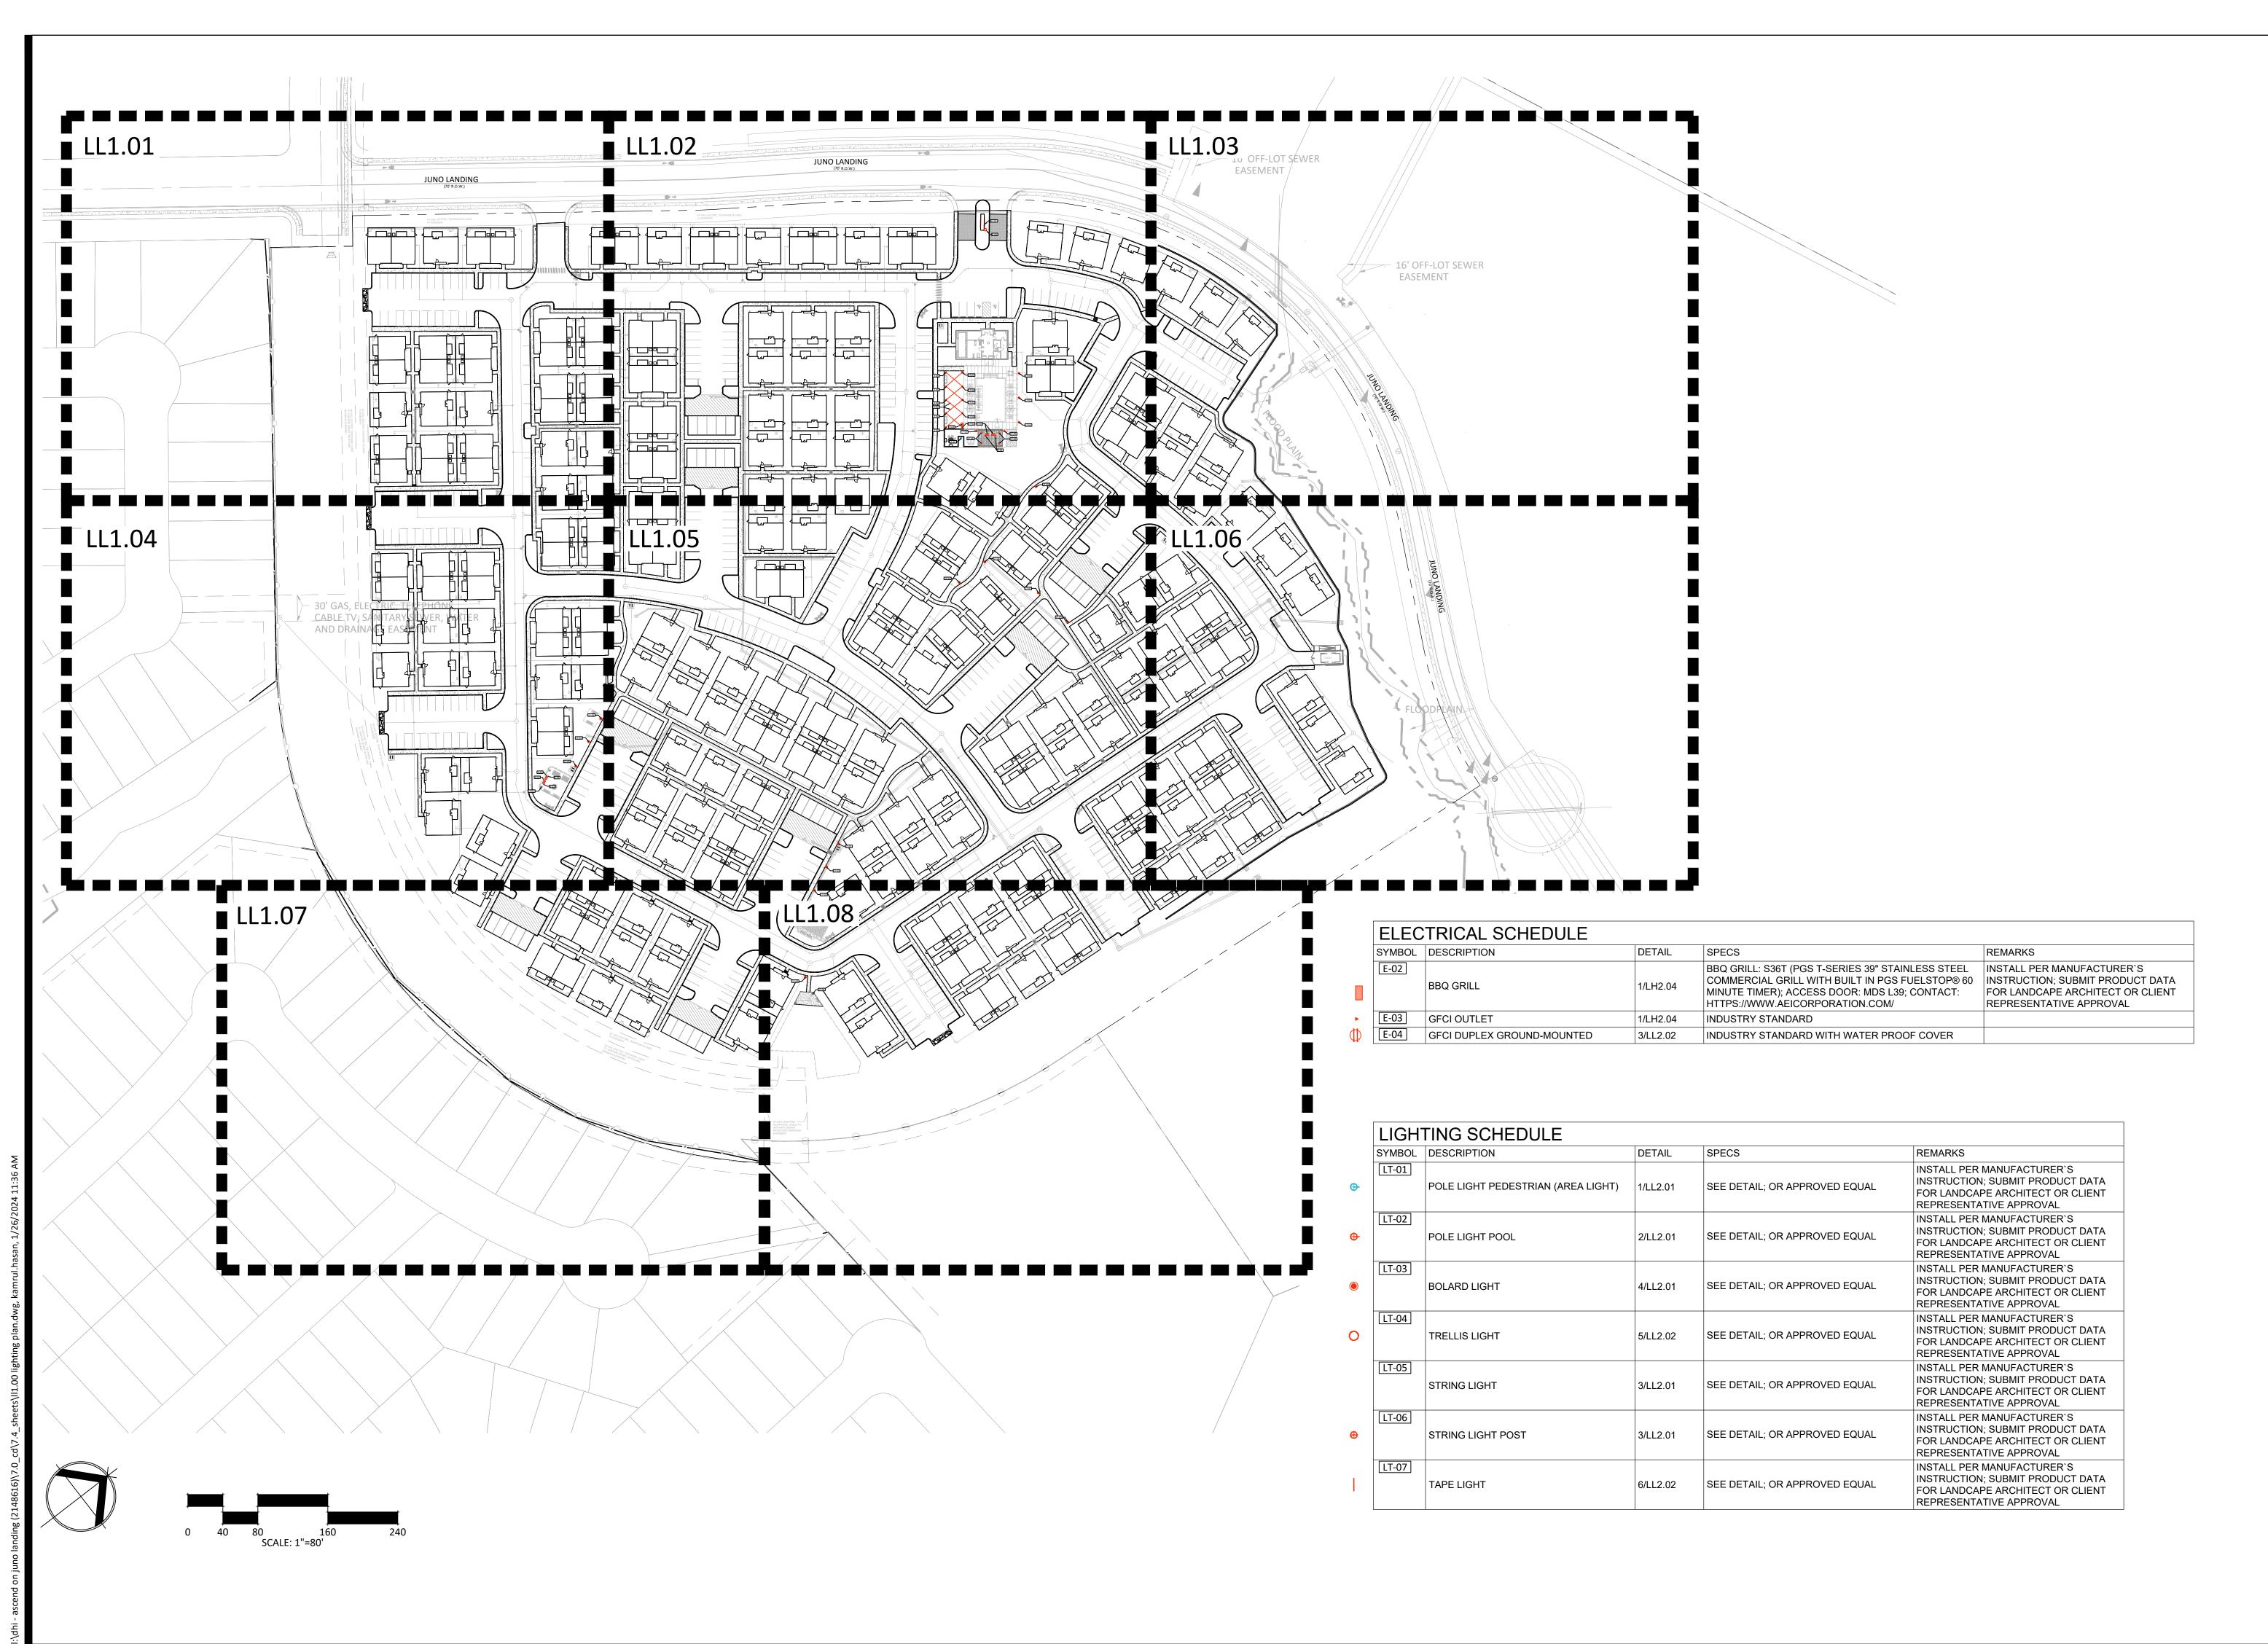CLIENT INFO

DHI COMMUNITIES 5419 NORTH LOOP 1604 EAST, SAN ANTONIO, TX 78247


SCALE: AS SHOWN DATE: 12/08/2023 DRWN: STRAND


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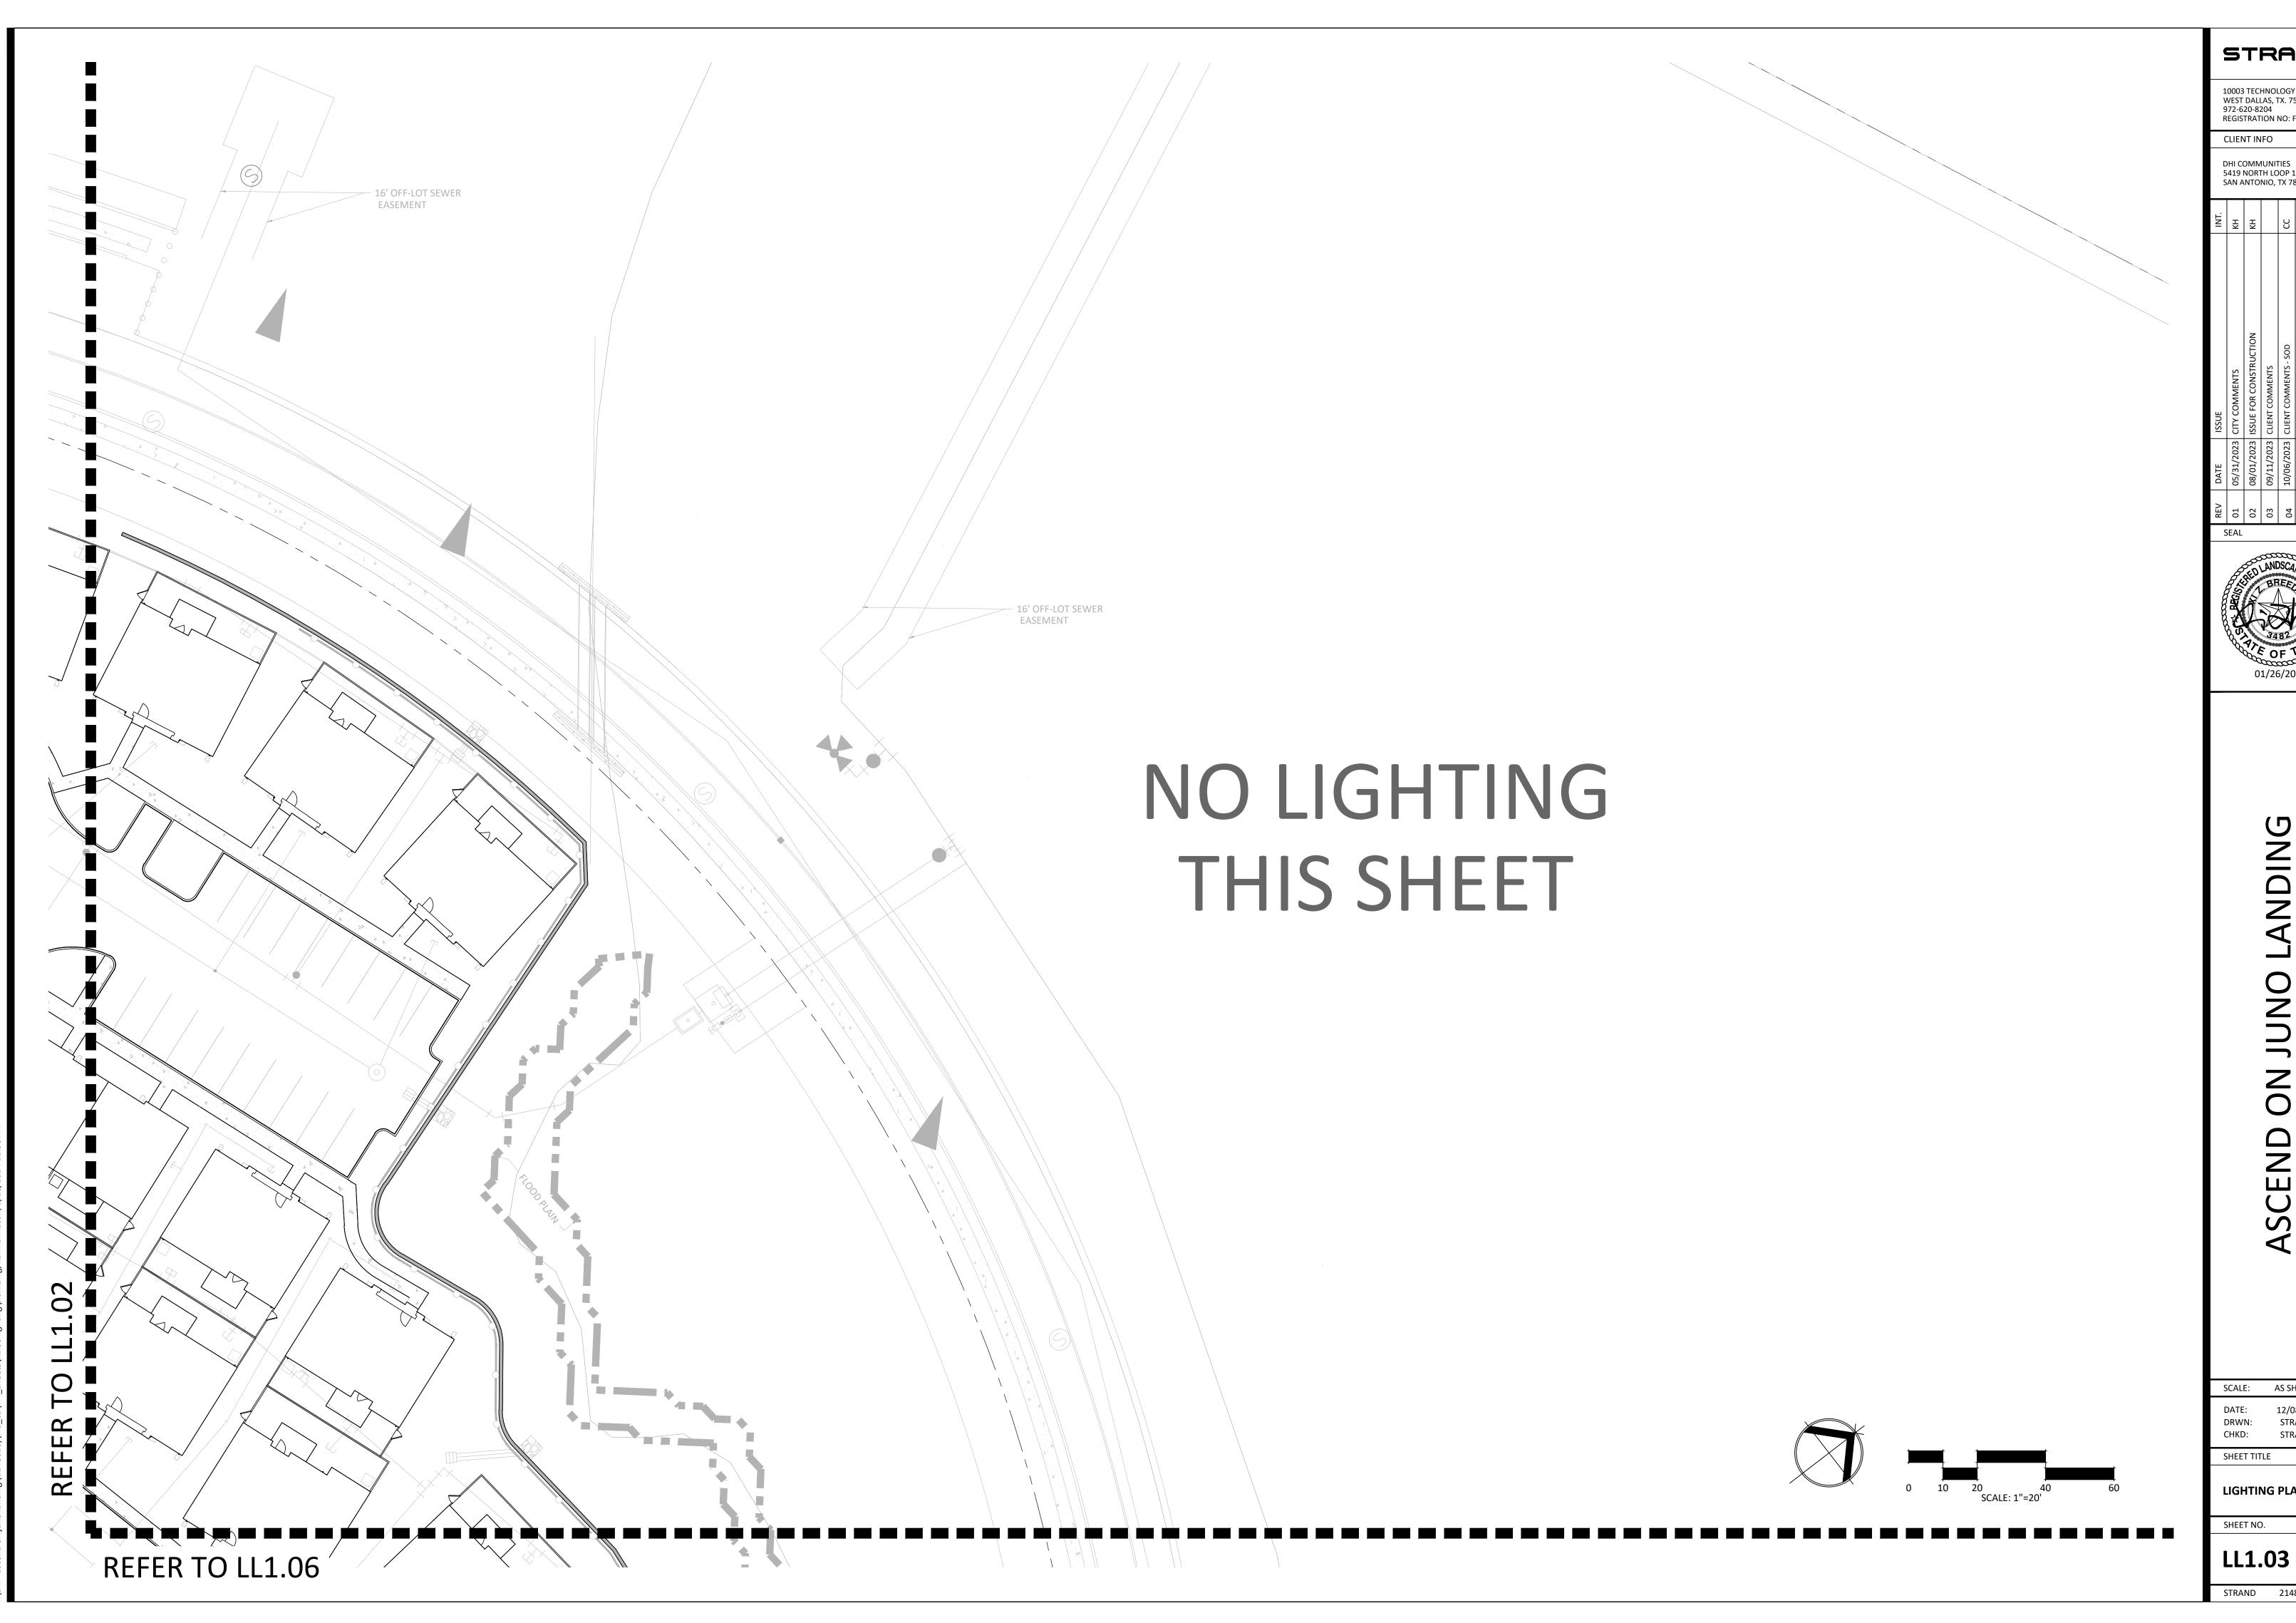
OVERALL LIGHTING PLAN

SHEET NO.

LL1.00




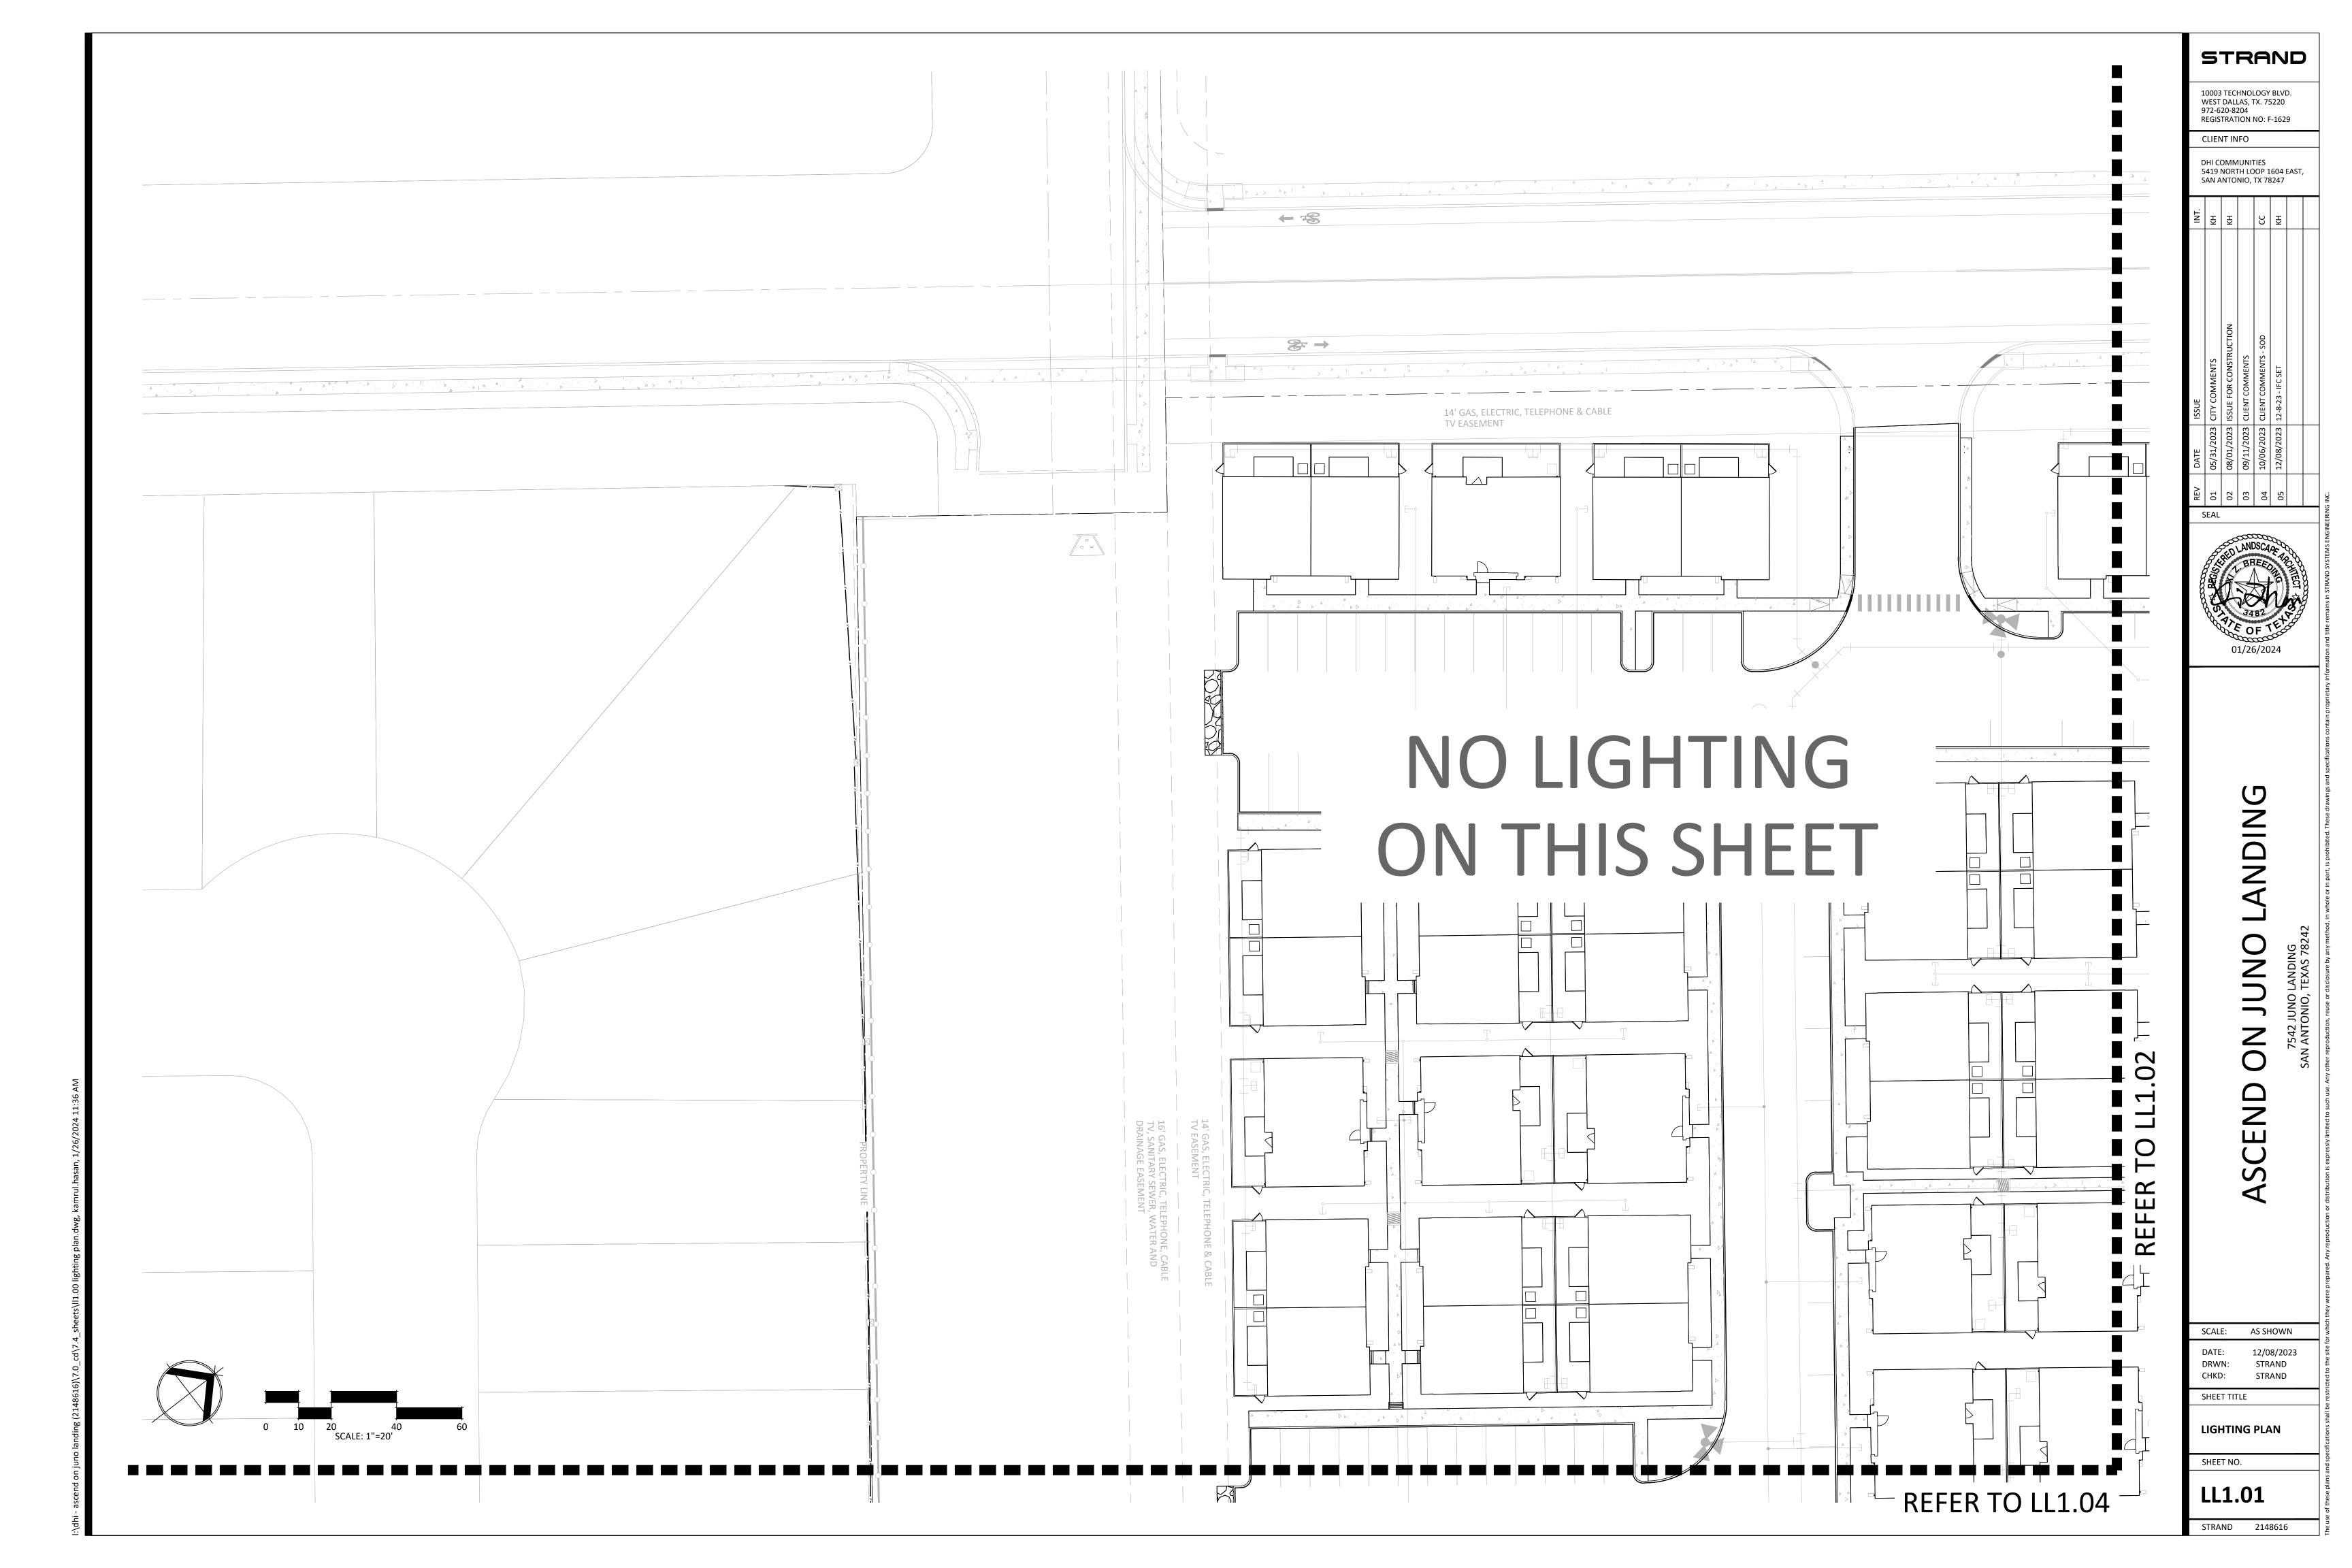


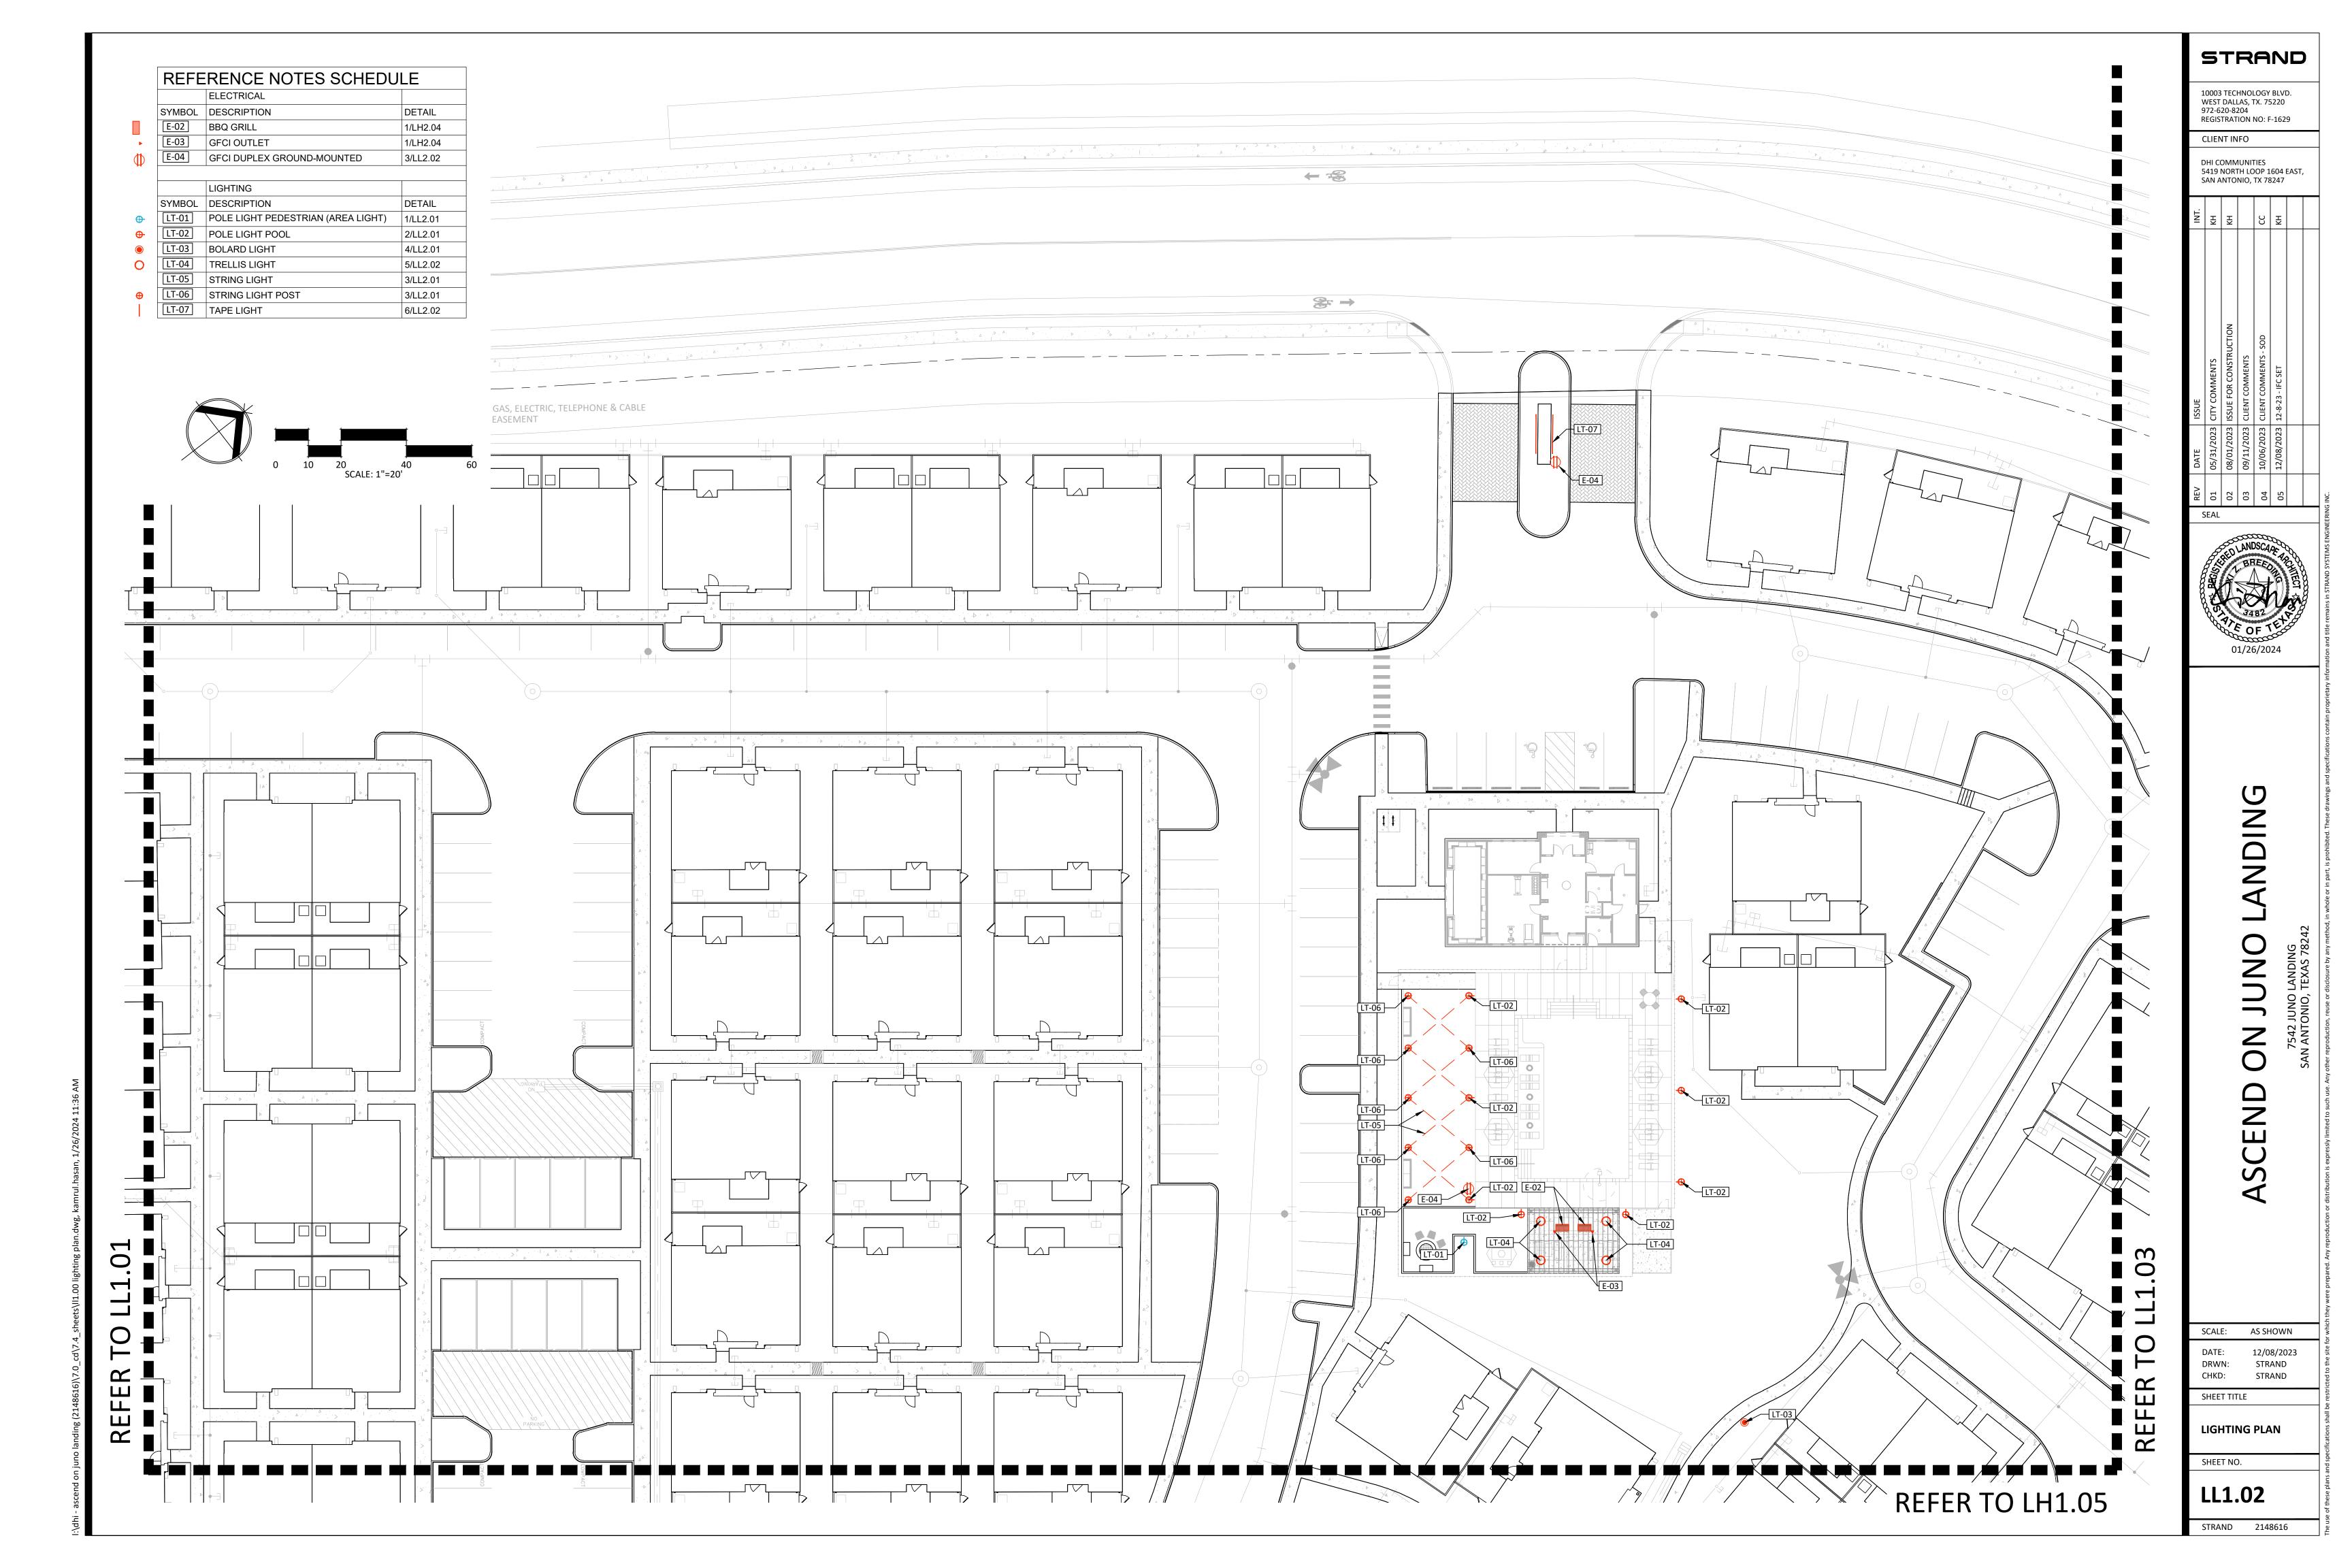

10003 TECHNOLOGY BLVD. WEST DALLAS, TX. 75220 972-620-8204 REGISTRATION NO: F-1629

DHI COMMUNITIES 5419 NORTH LOOP 1604 EAST, SAN ANTONIO, TX 78247

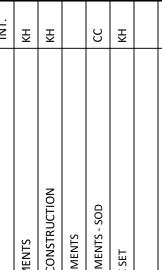


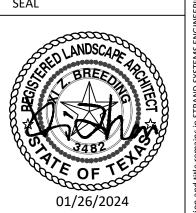



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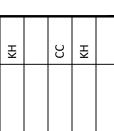
LIGHTING PLAN

LL1.03




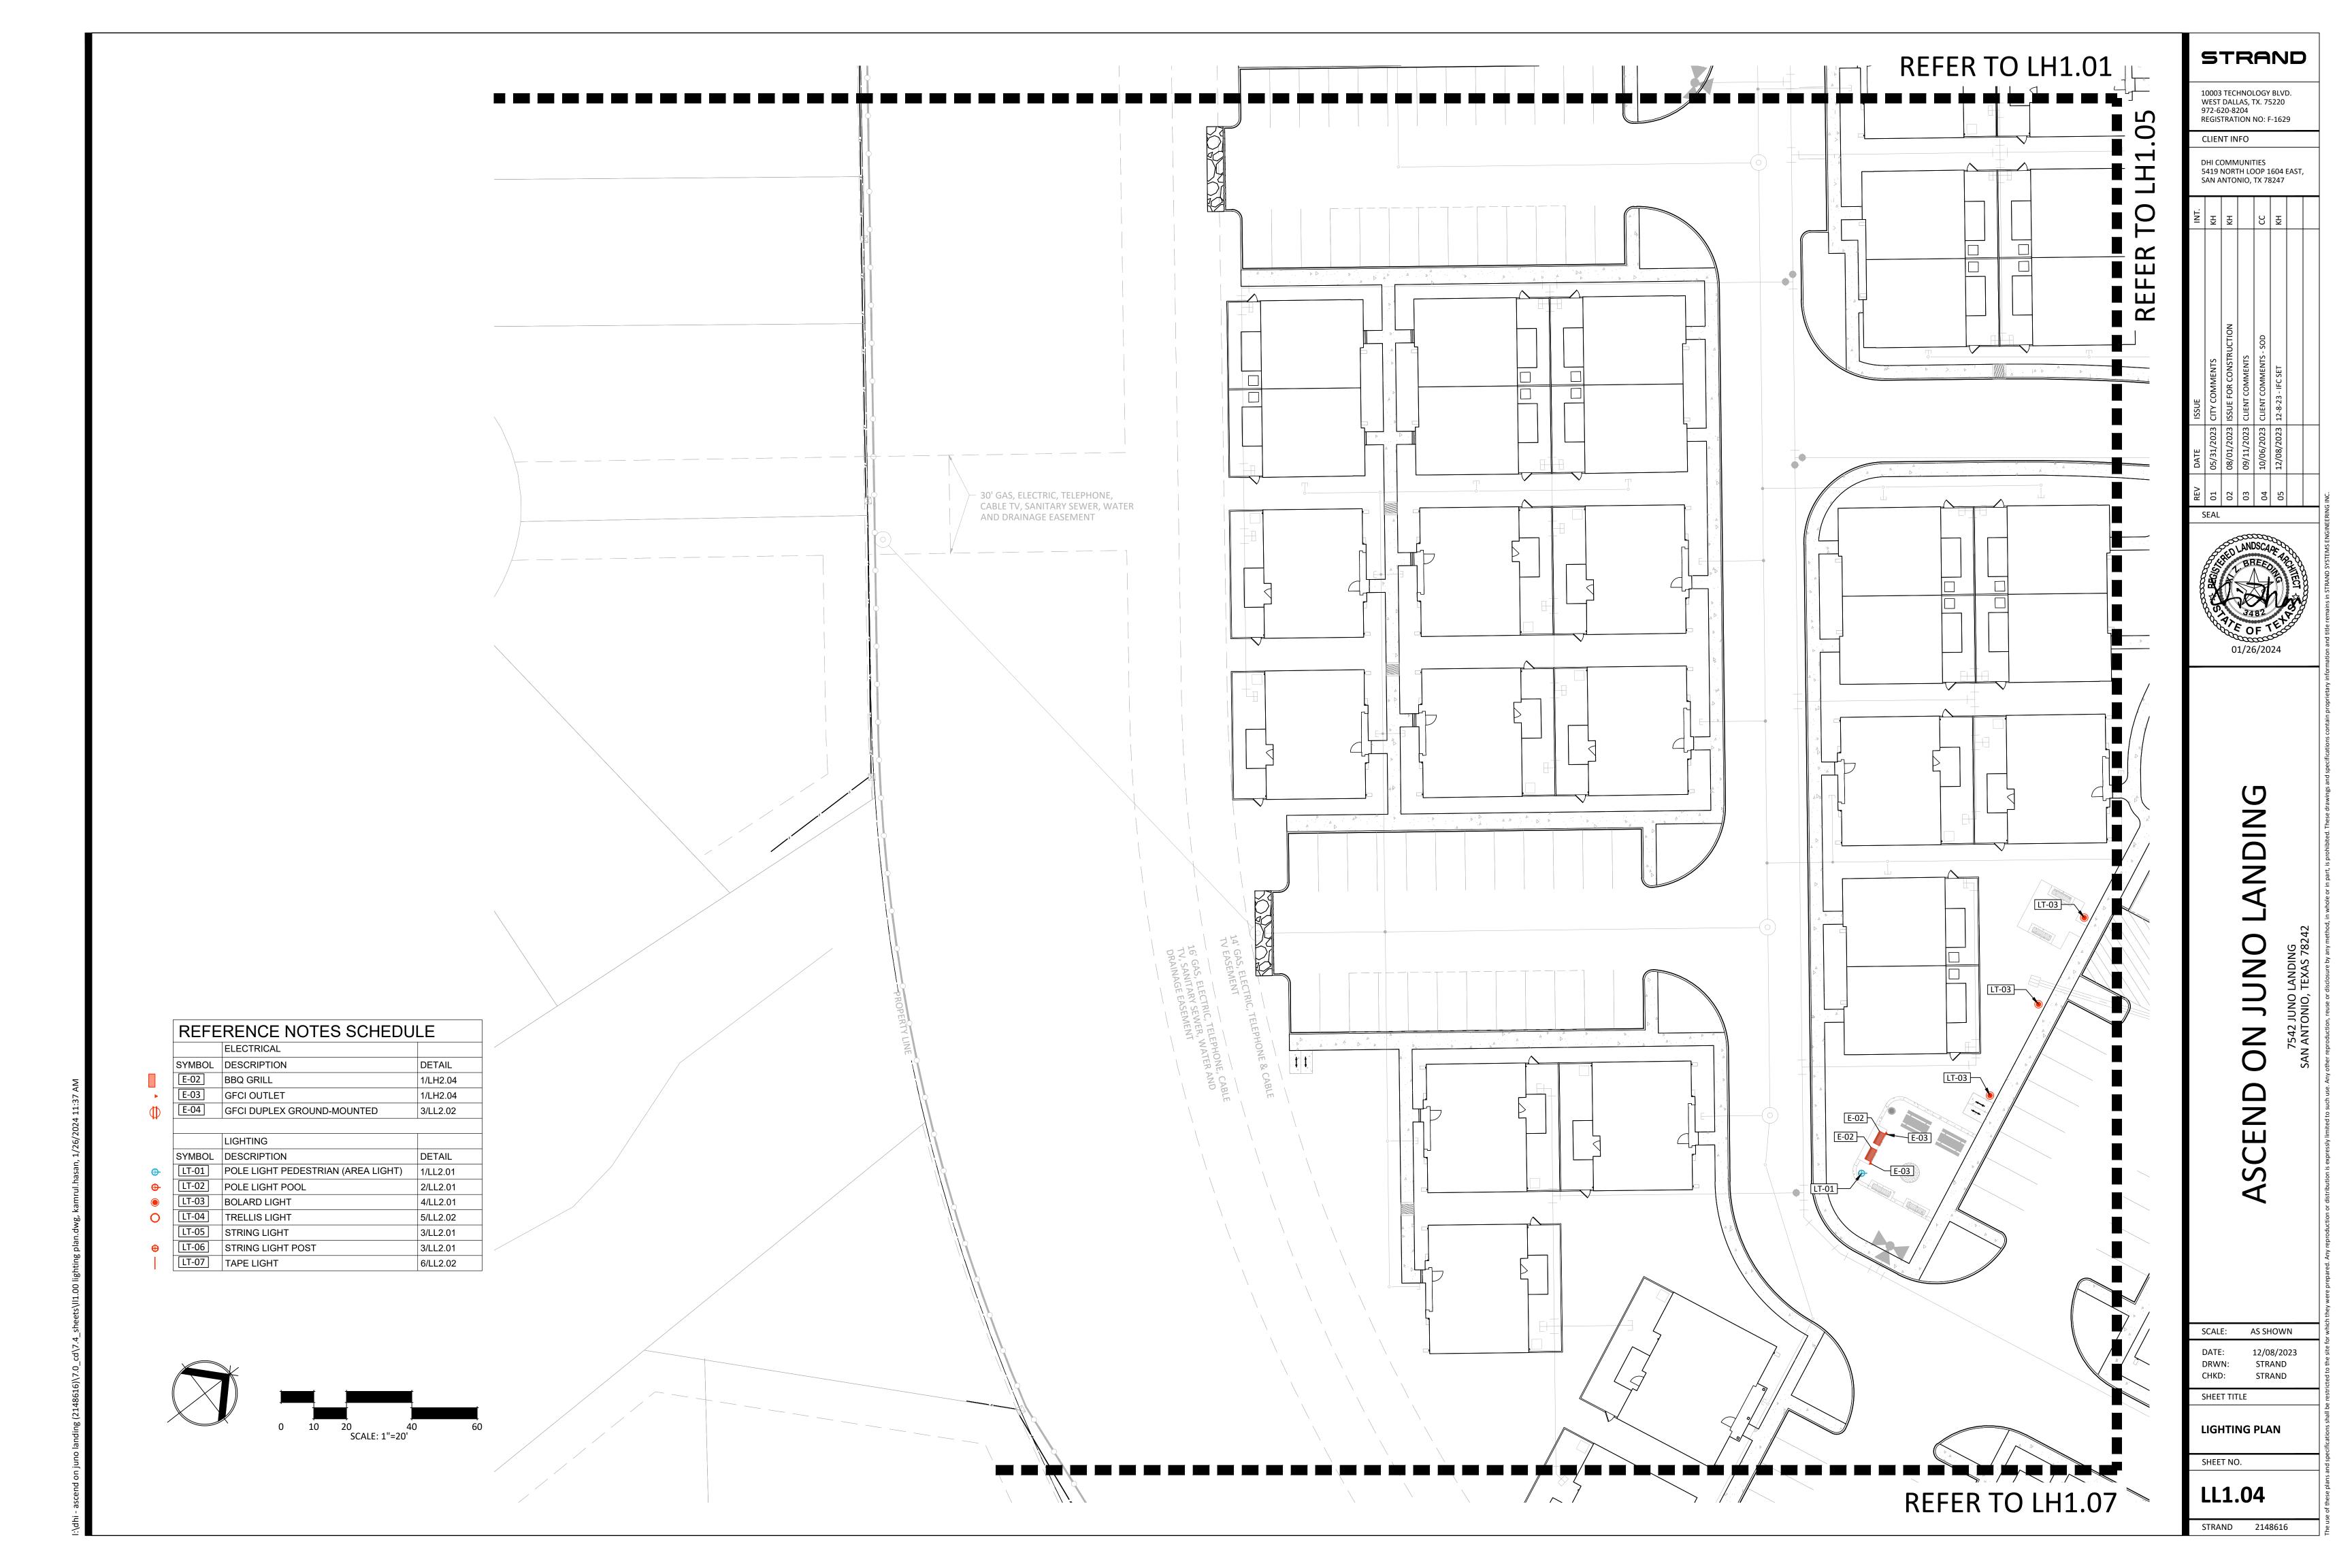


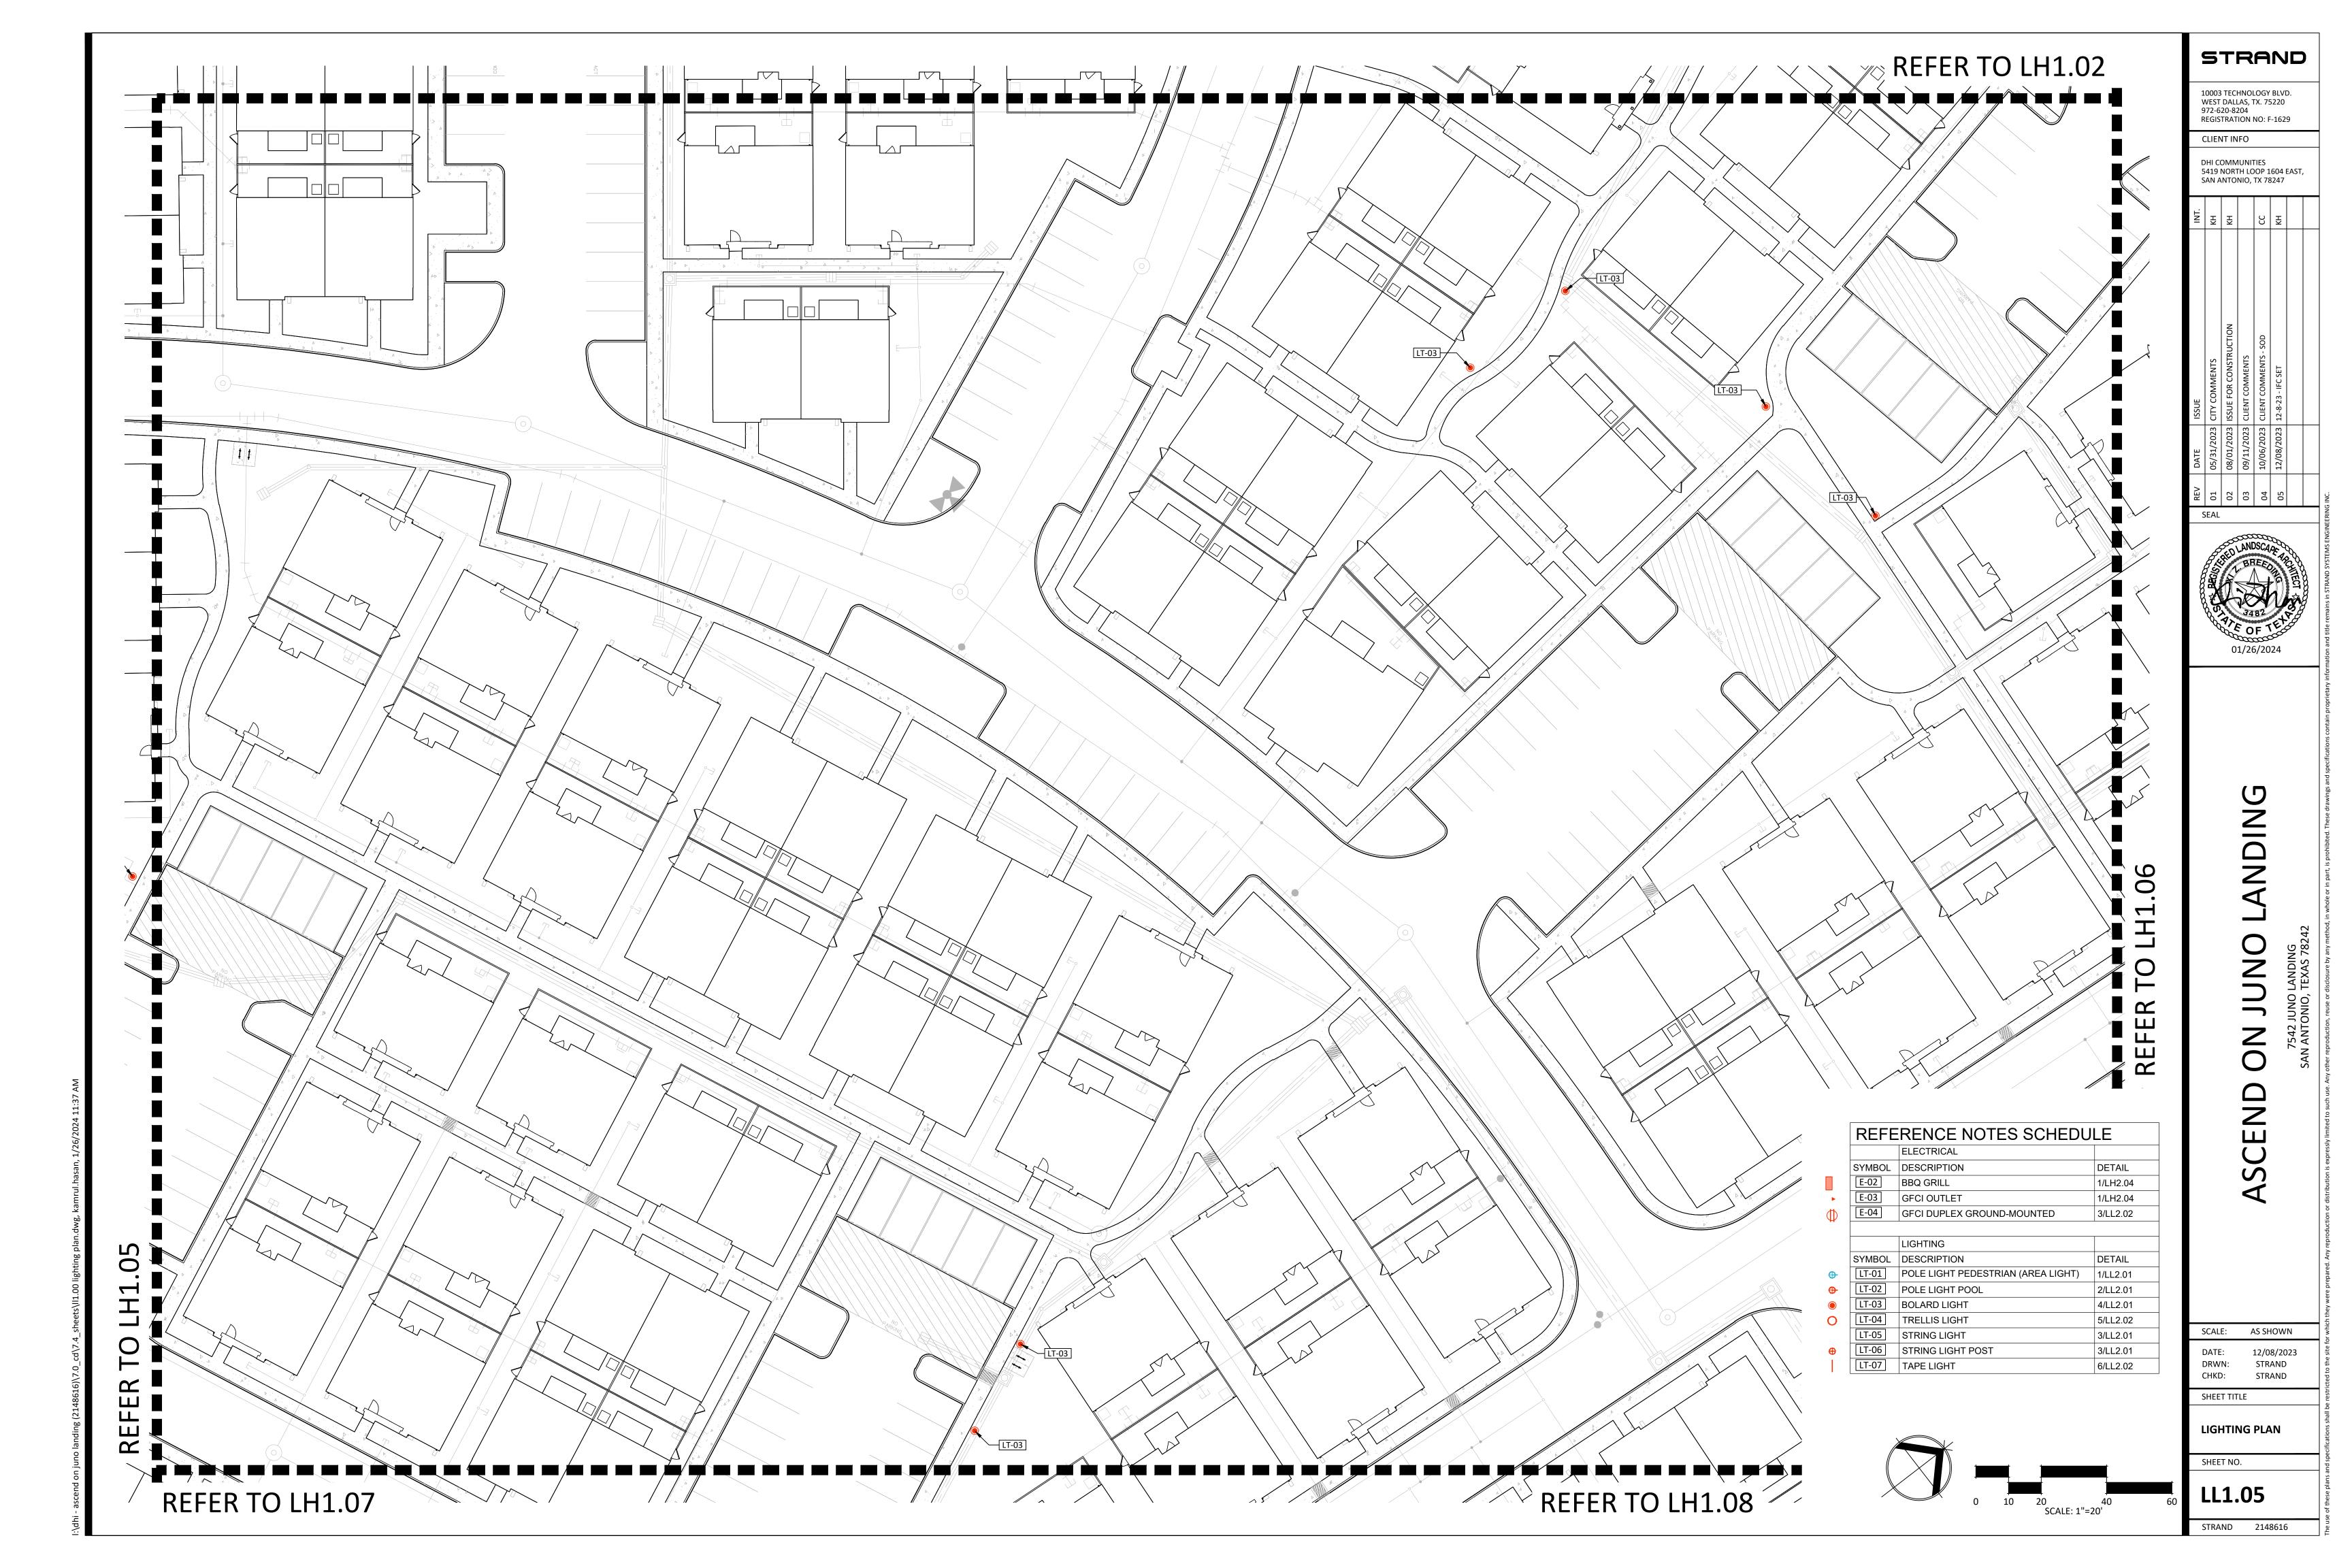


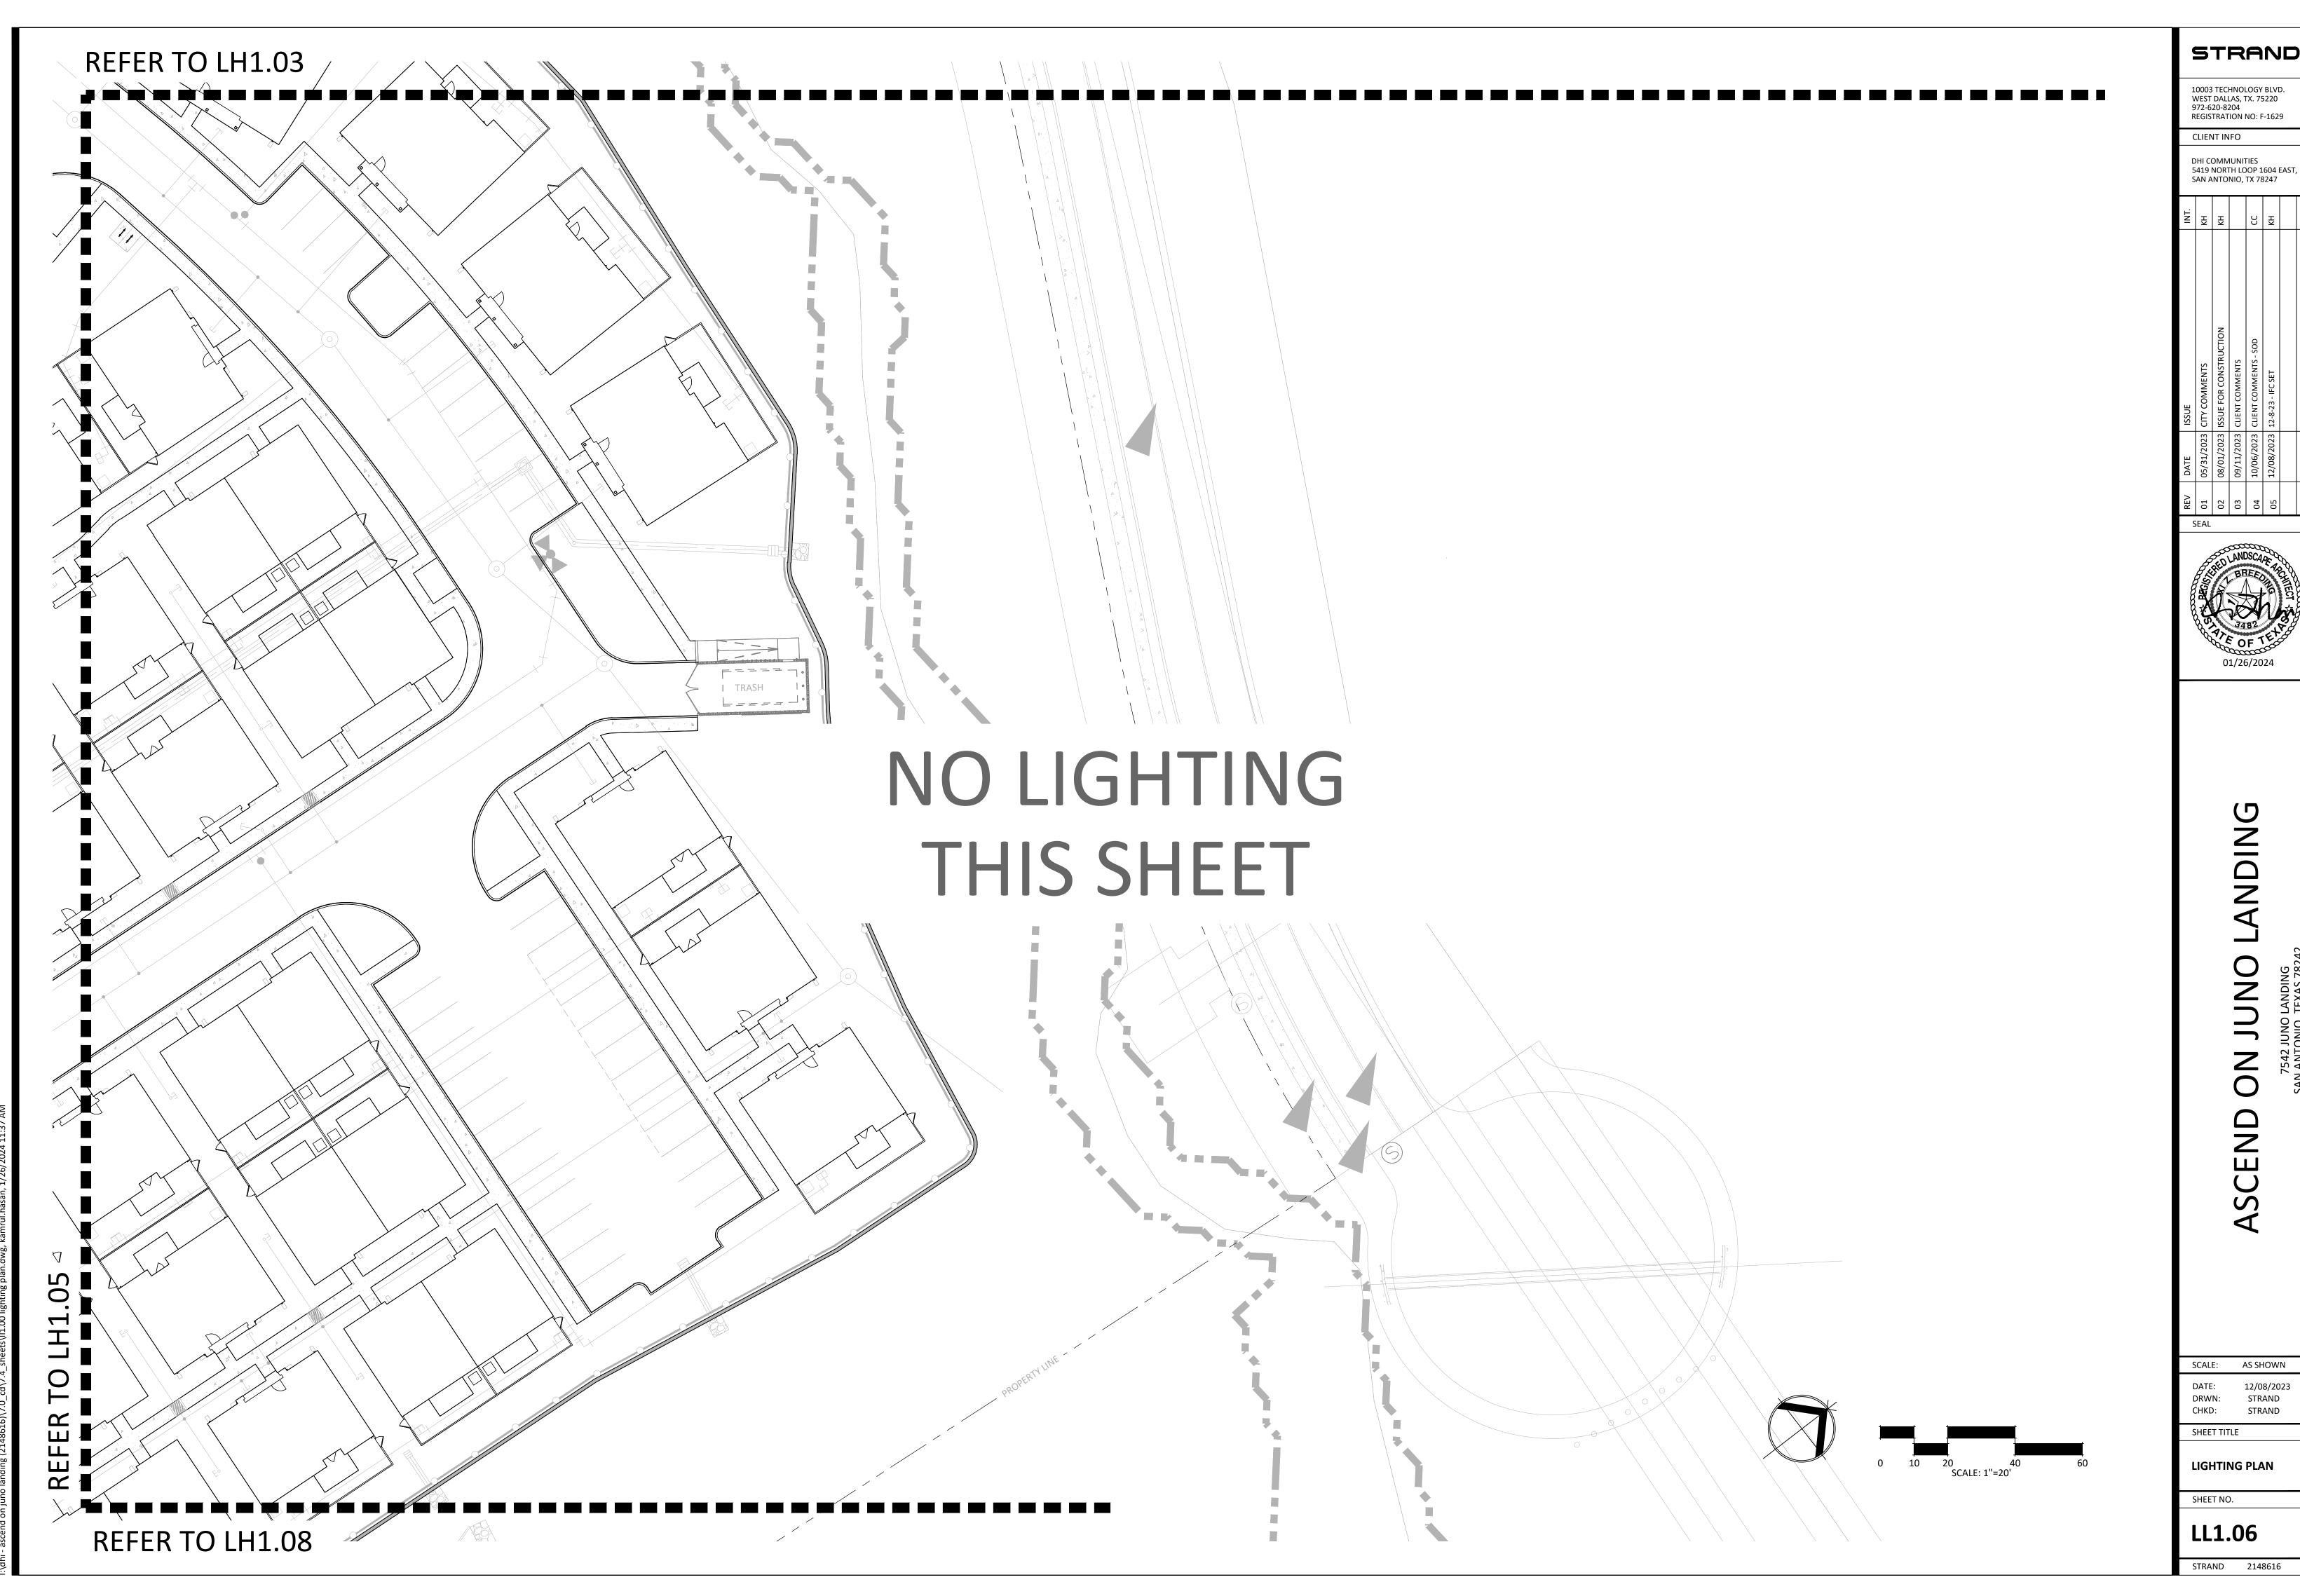


SCALE: AS SHOWN

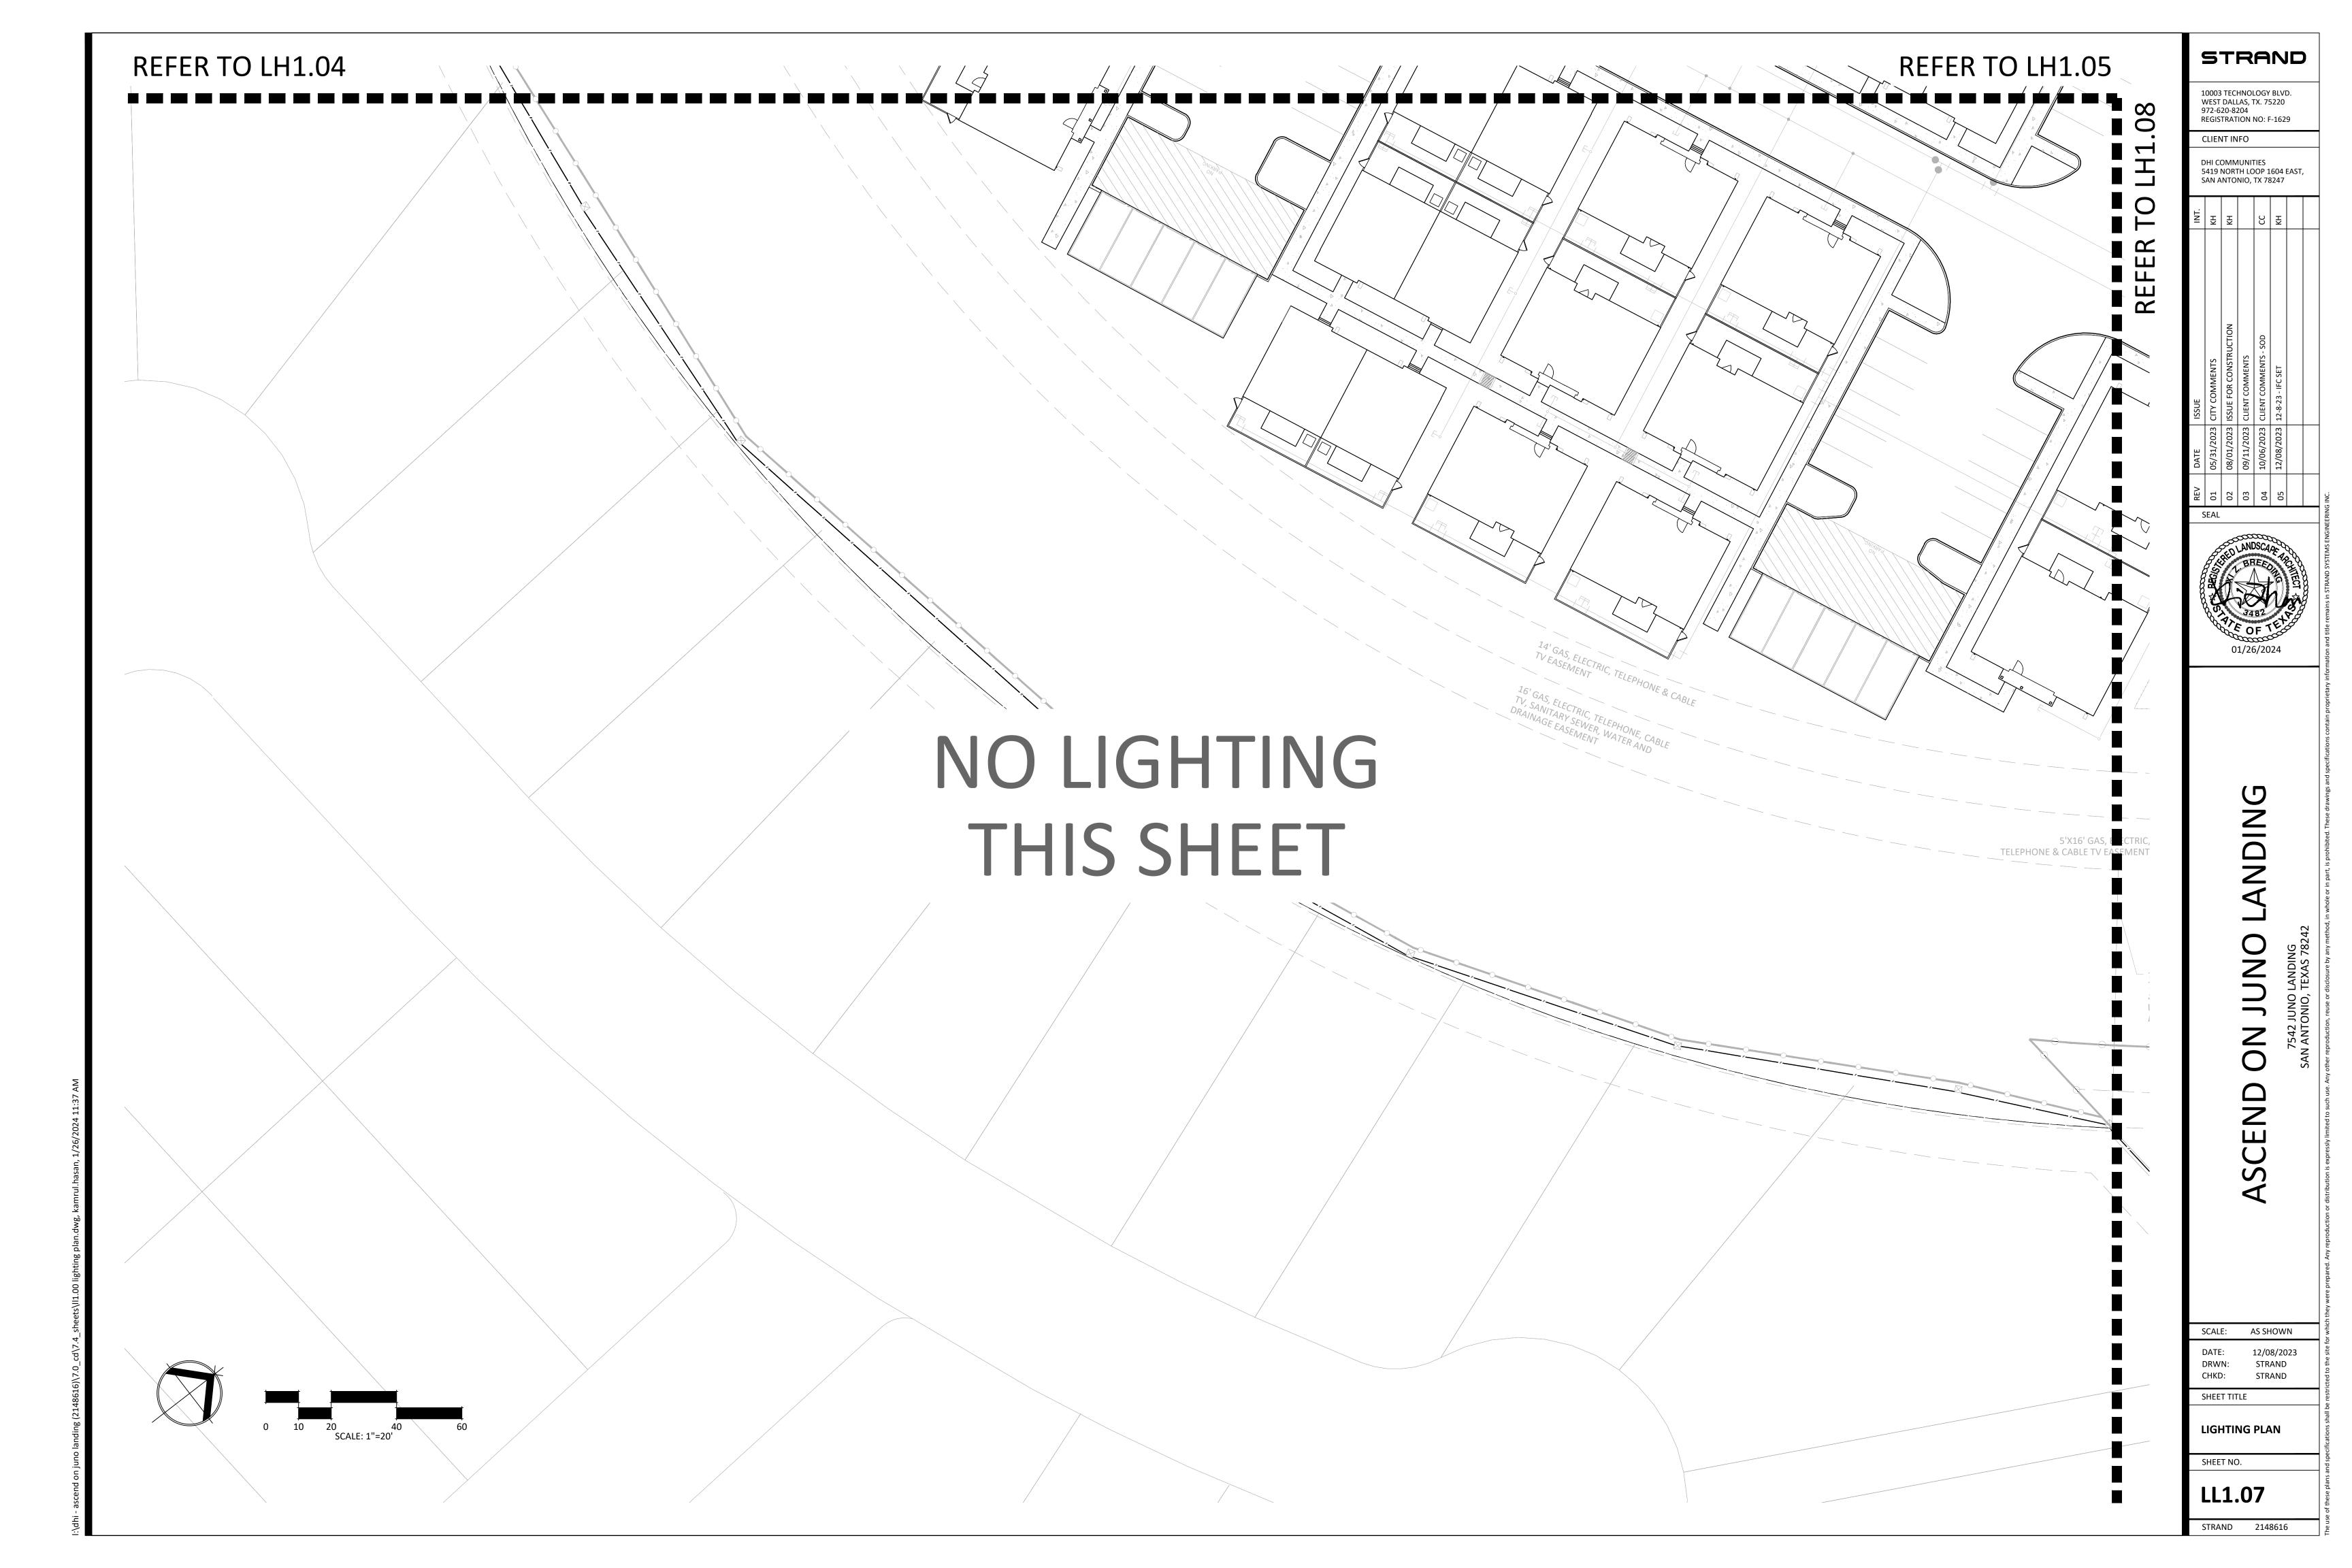


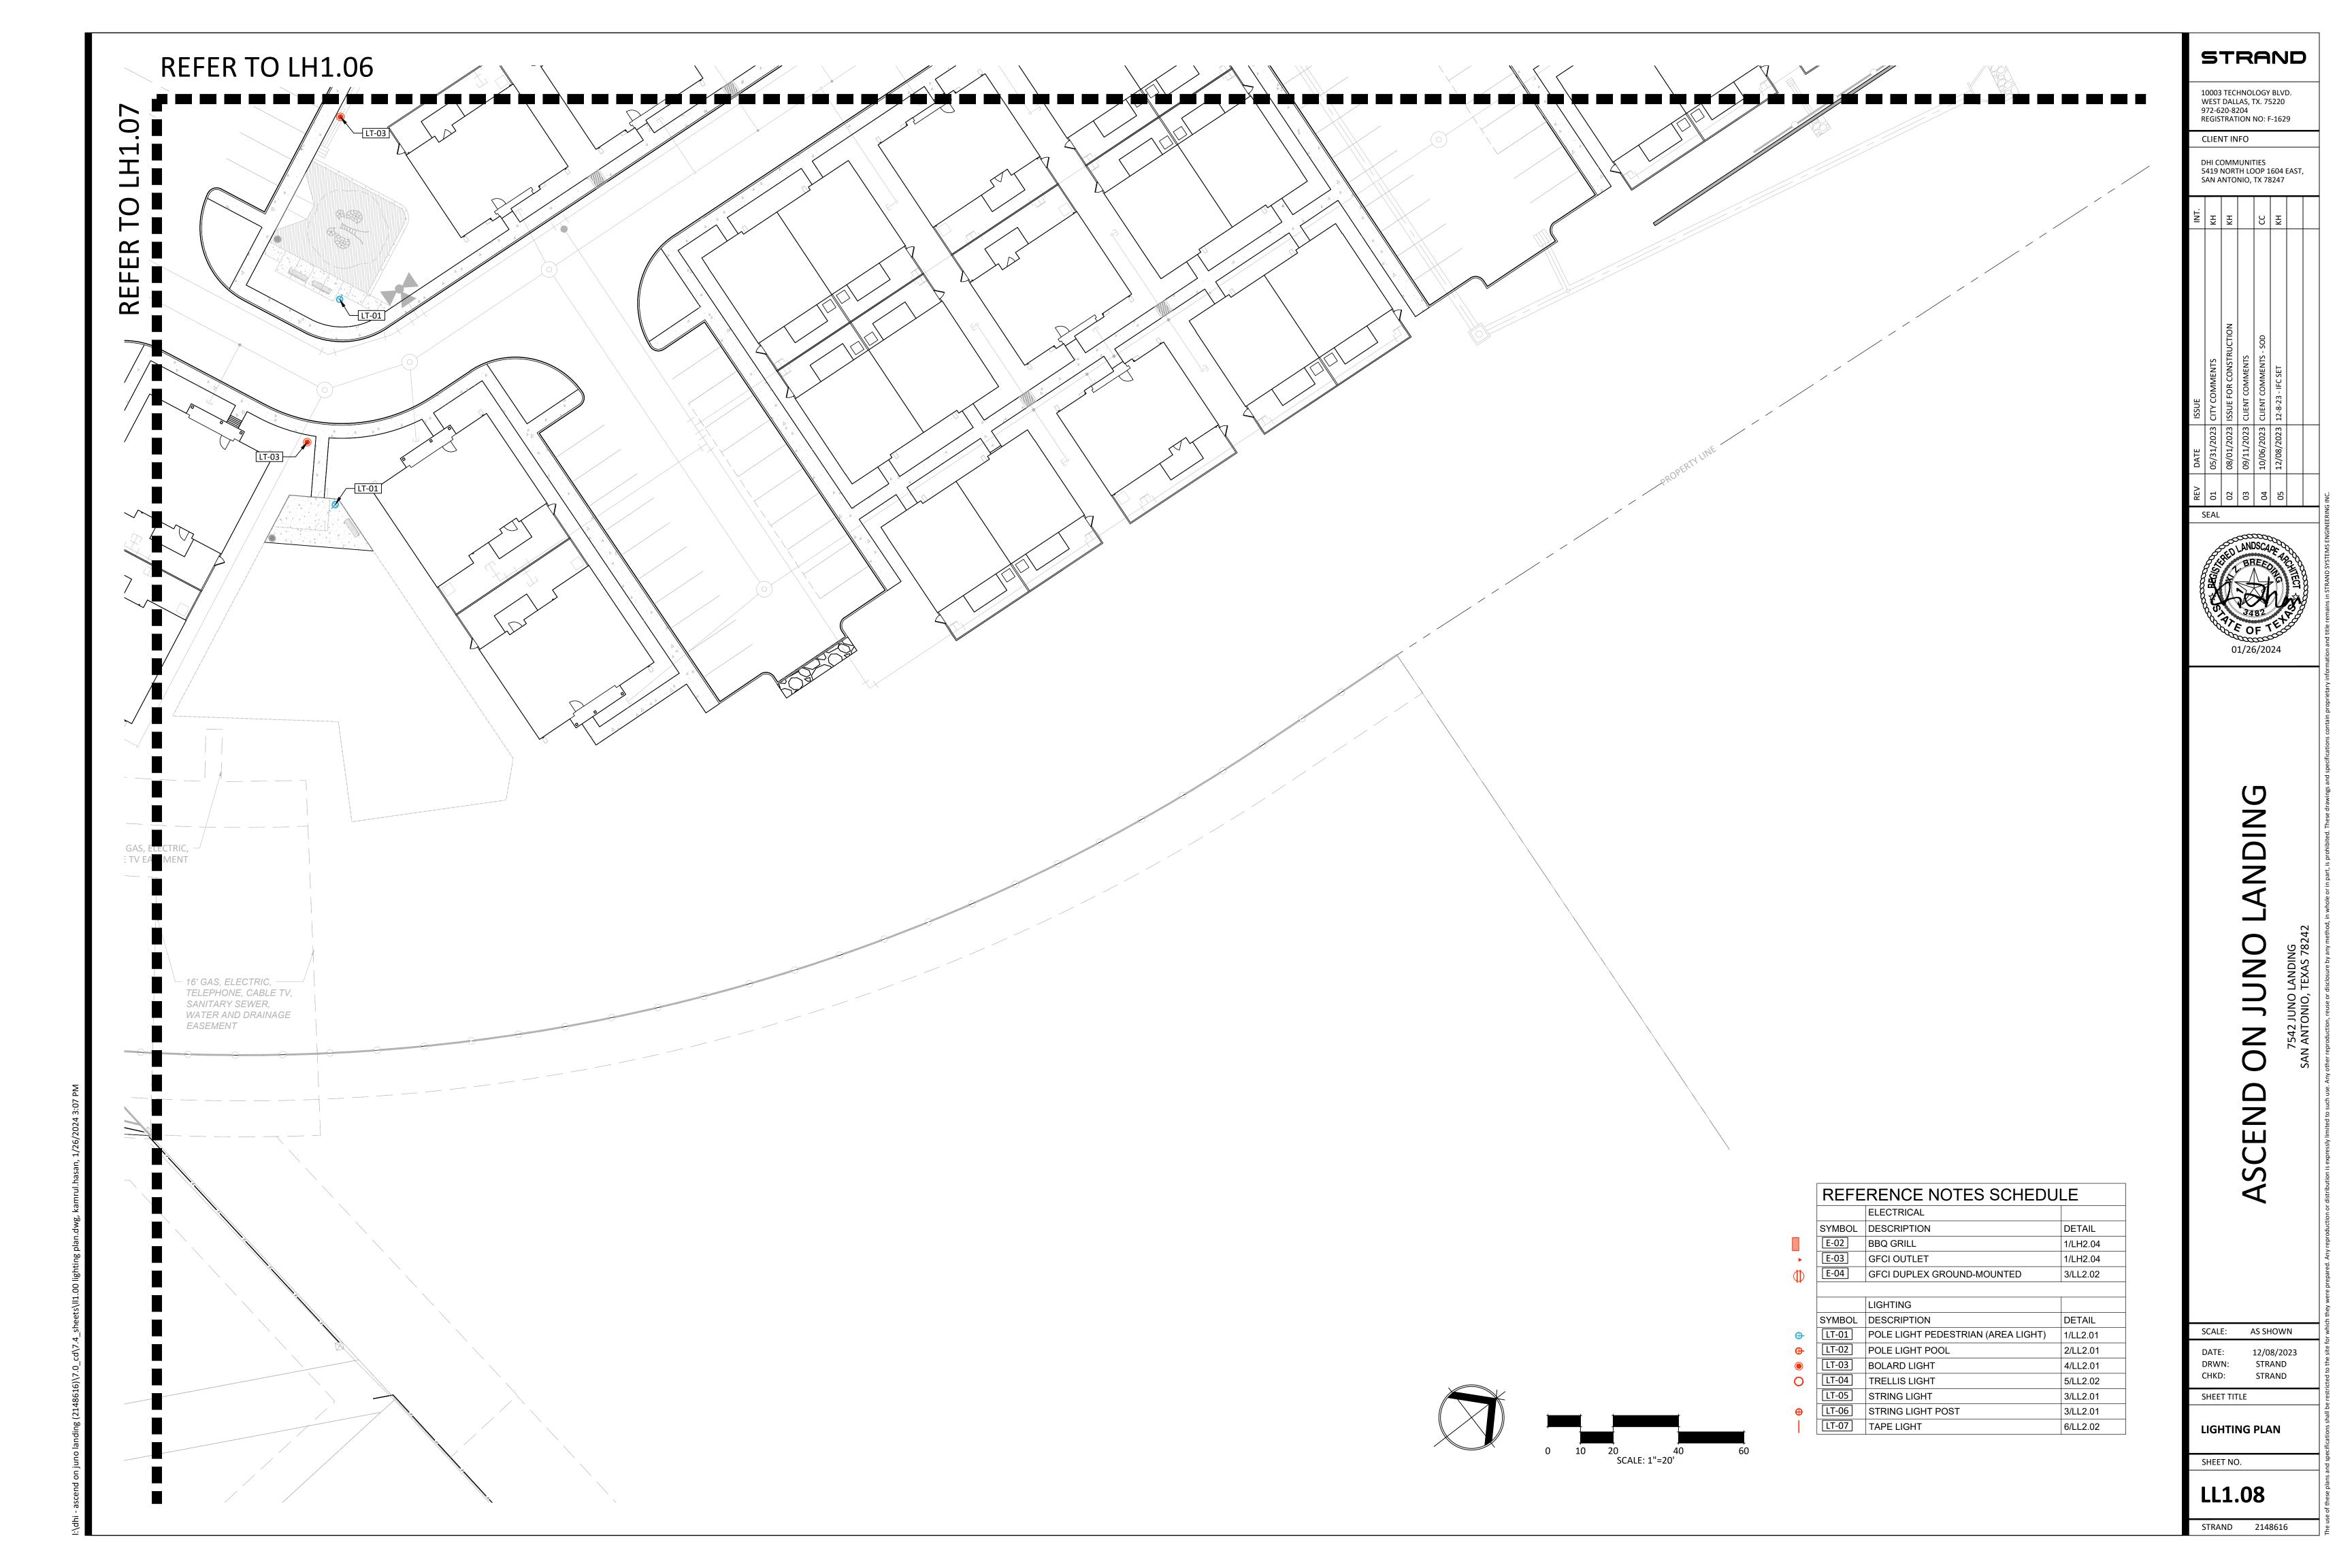

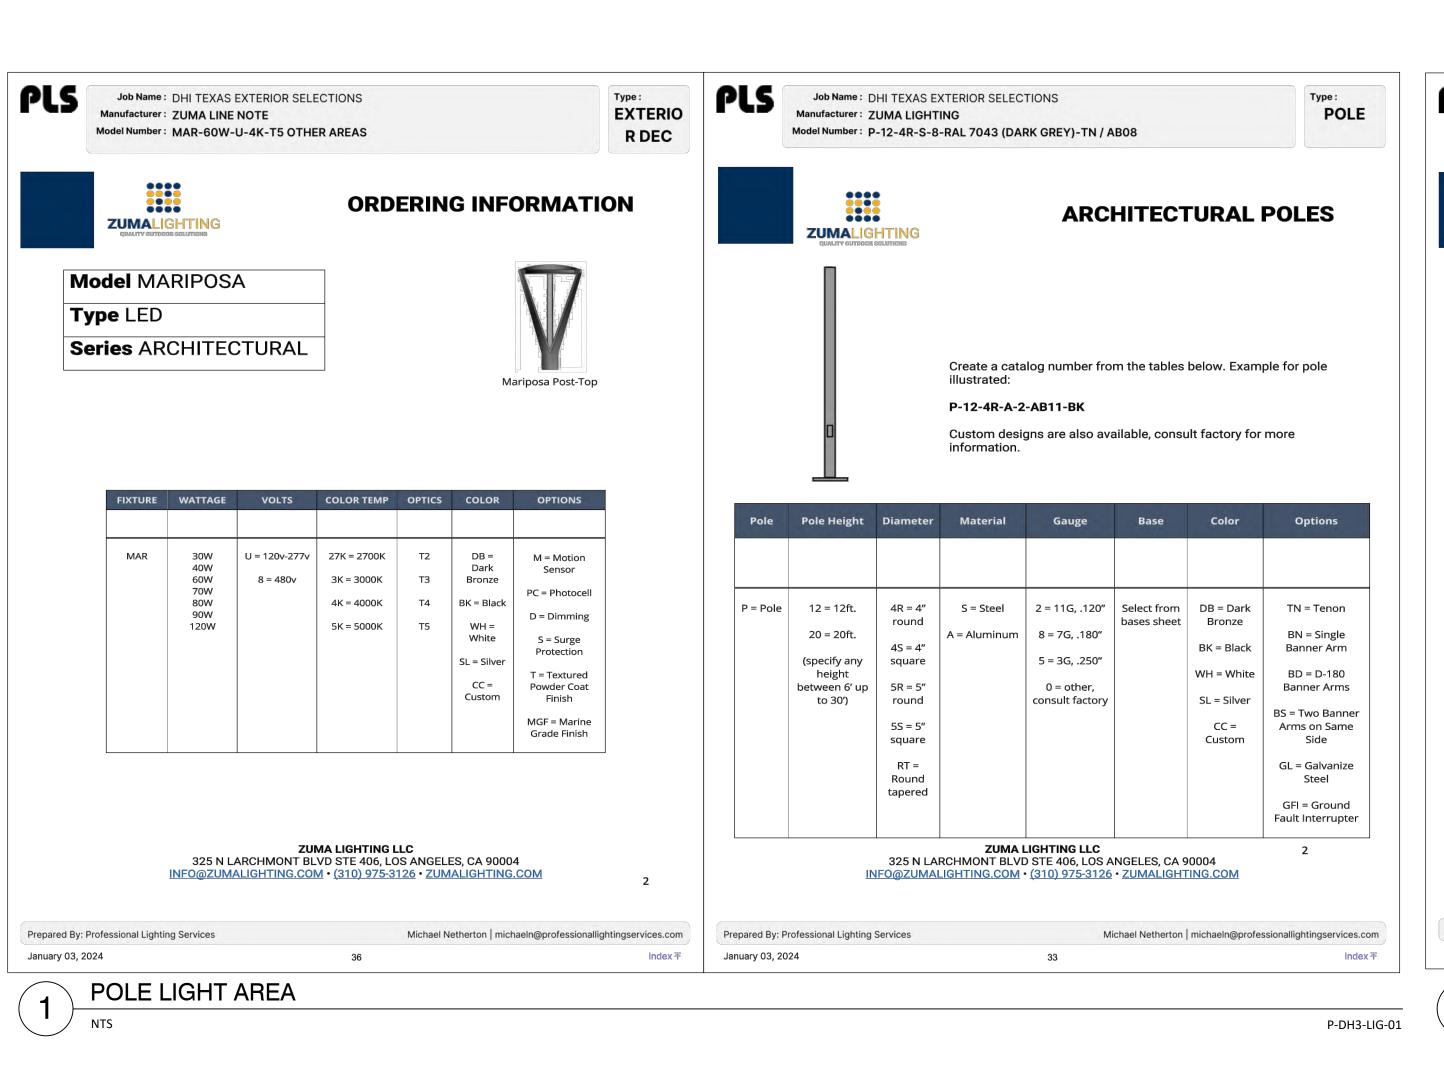

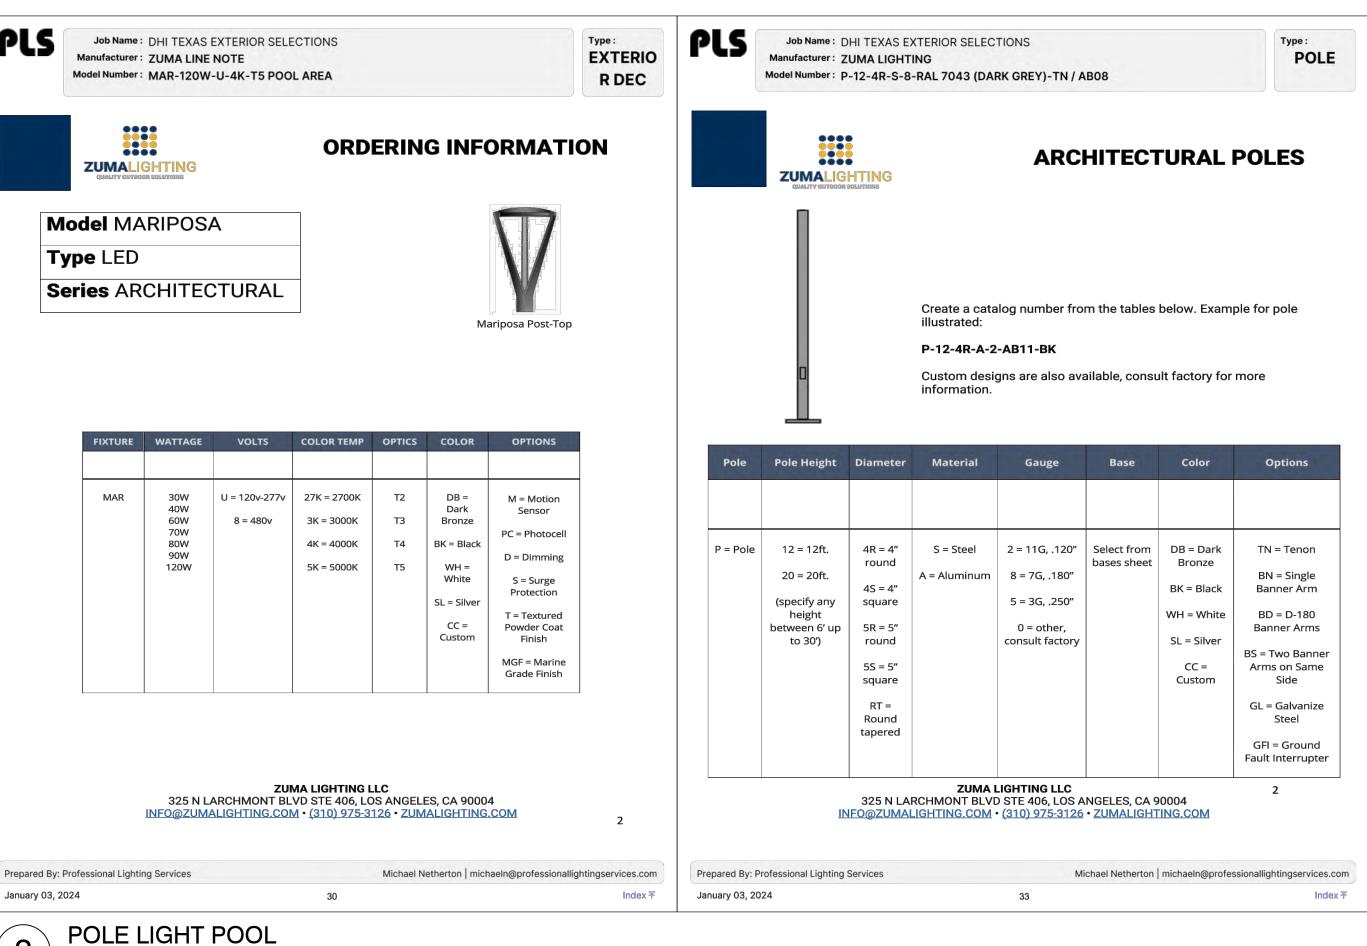

P-DH3-LIG-03

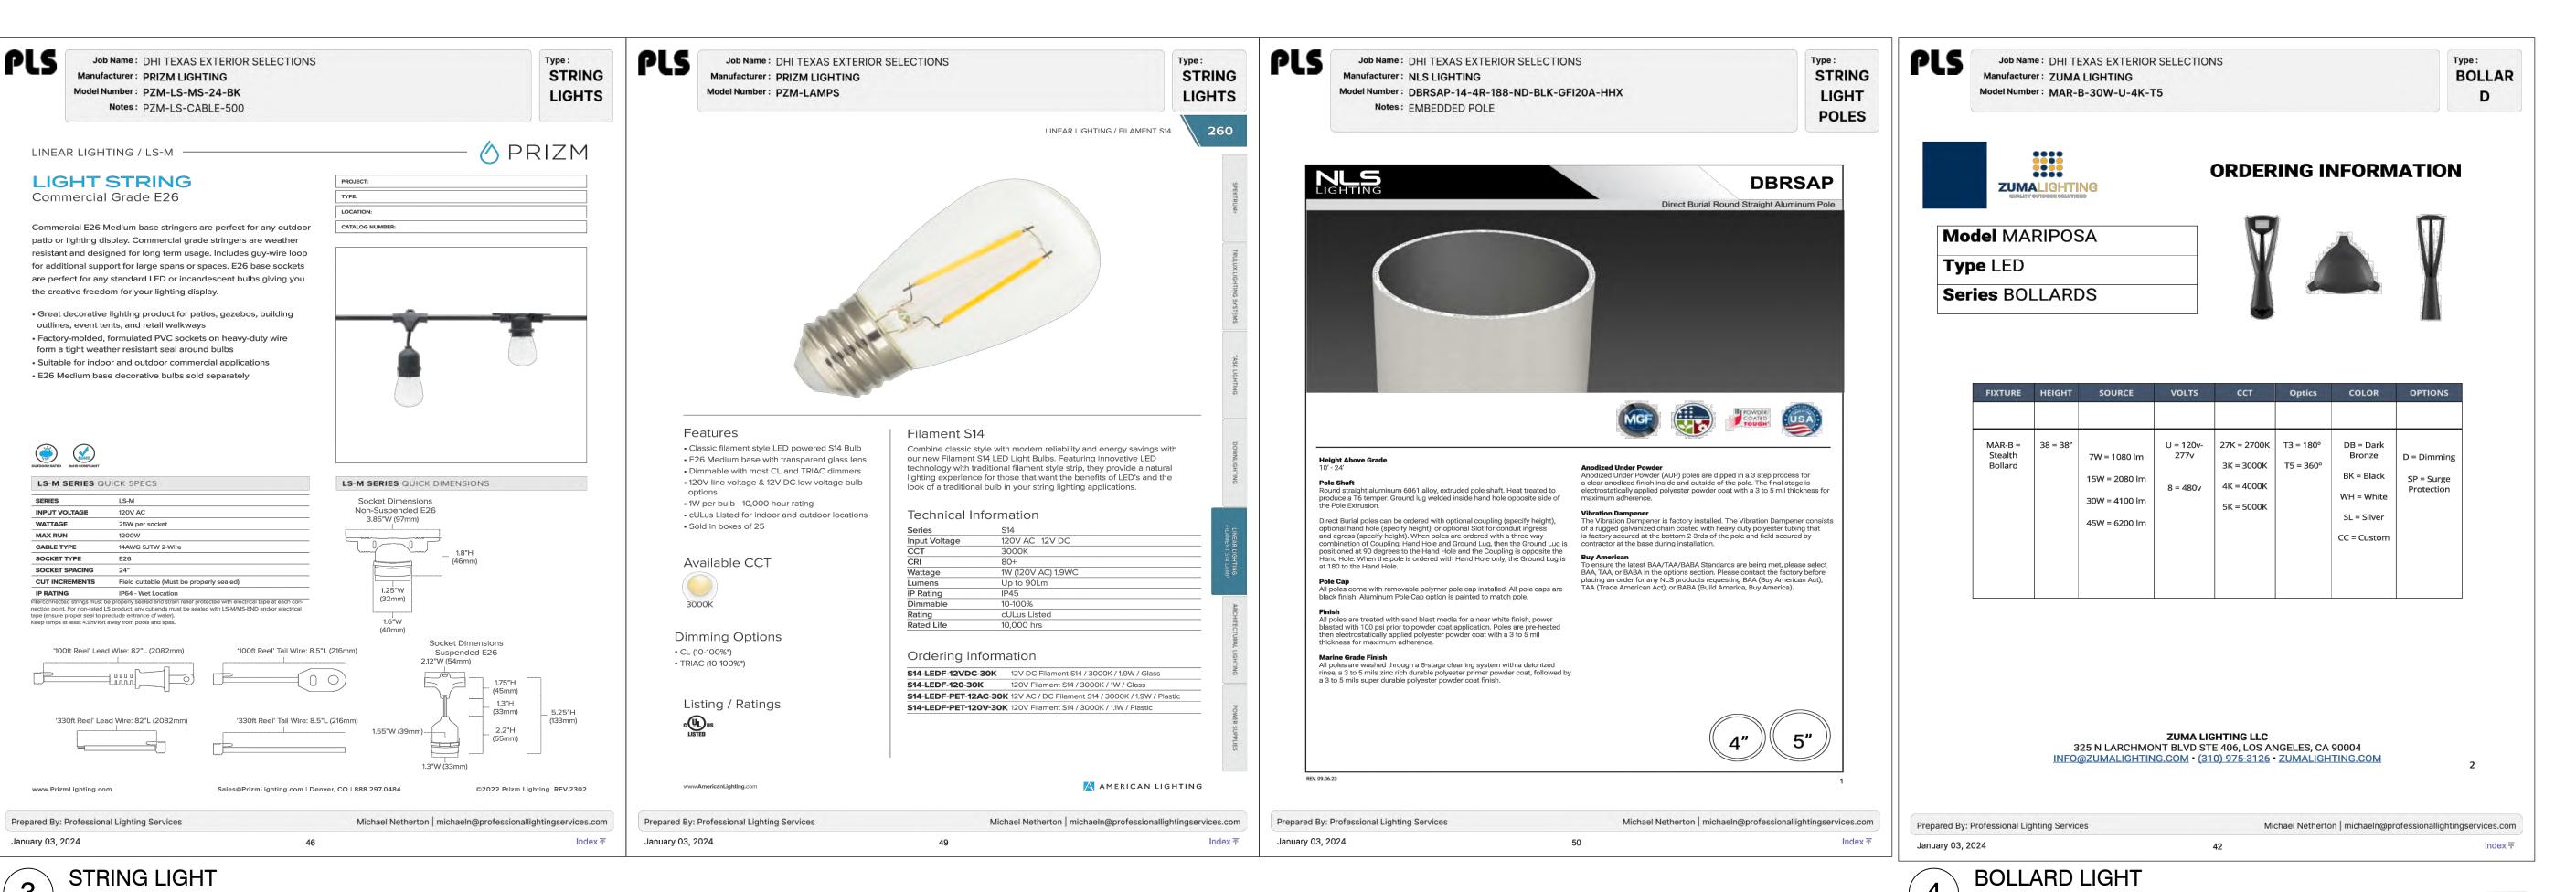

STRAND


10003 TECHNOLOGY BLVD. WEST DALLAS, TX. 75220

972-620-8204 REGISTRATION NO: F-1629

CLIENT INFO

DHI COMMUNITIES

5419 NORTH LOOP 1604 EAST, SAN ANTONIO, TX 78247

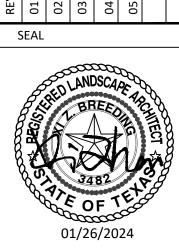

P-DH3-LIG-02


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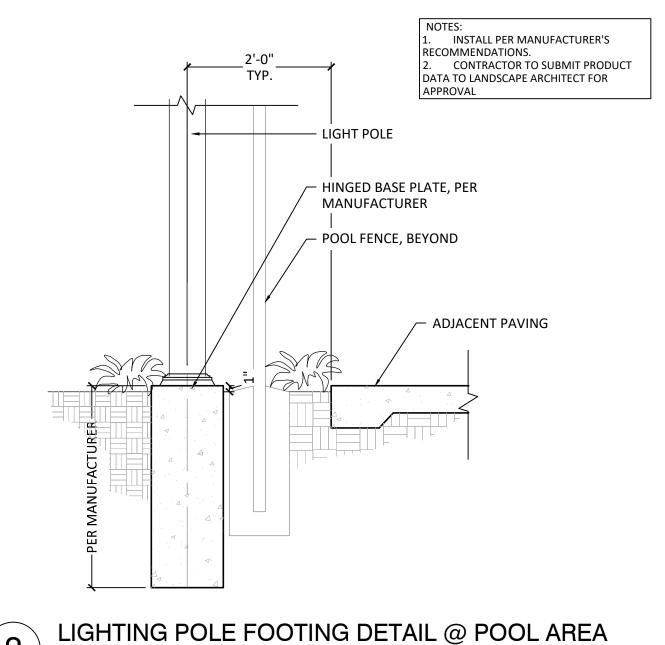
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SCALE: AS SHOWN DATE: 12/08/2023 DRWN: STRAND CHKD: STRAND

SHEET TITLE

LIGHTING DETAIL SHEET NO.



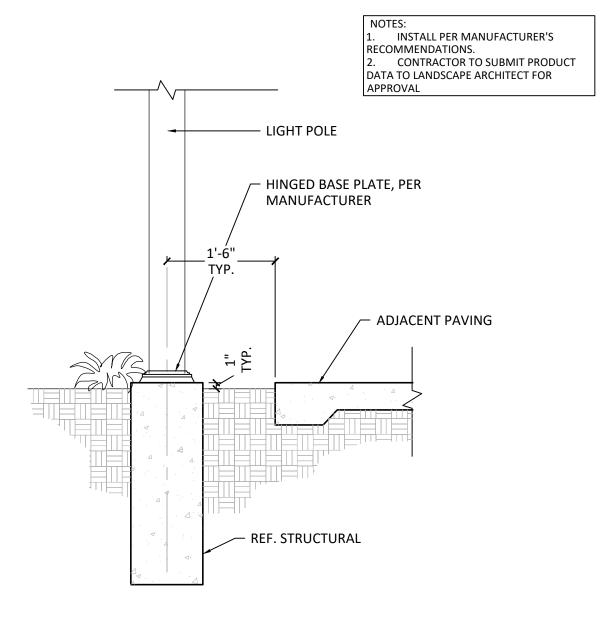


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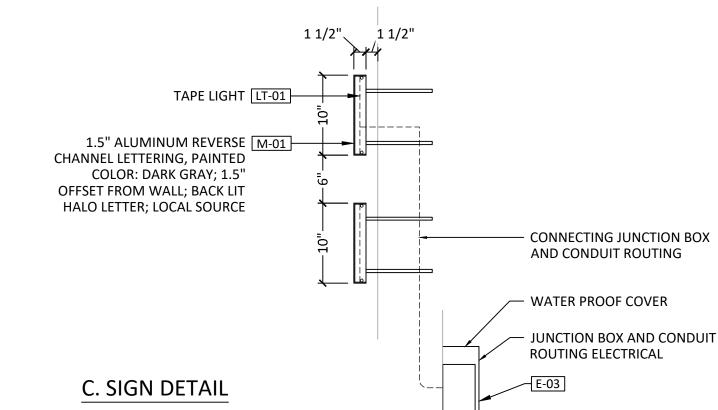
P-DH3-LIG-08

3/4" = 1'-0"

TAPE LIGHT

P-DH3-LIG-07



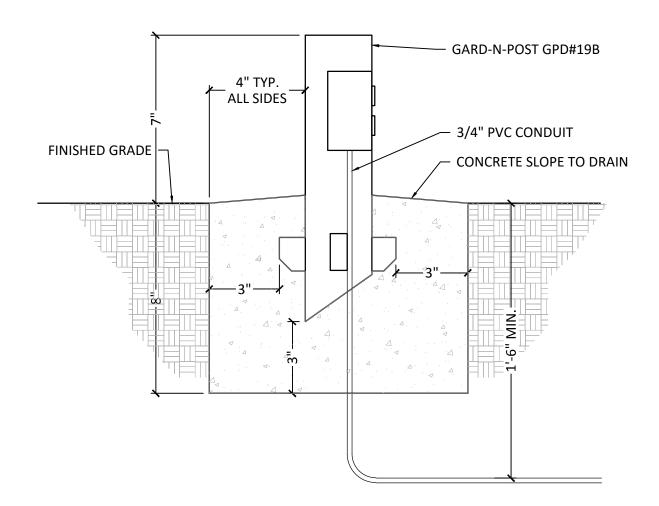

LOGO AND LETTERS DIGITAL FILE PROVIDED BY LANDSCAPE ARCHITECT

PROVIDE SHOP DRAWINGS PRIOR TO FABRICATION AND INSTALLATION.

INSTALL ALL CHANNEL AND PIN MOUNTED LETTERING PER MFG INSTRUCTIONS AND

3. CHANNEL LETTERS TO HAVE LEXAN OR OTHER BACKING SUCH THAT A WEATHER

4. PIN MOUNTED PAINTED ALUMINUM CHANNEL LETTERS WITH 1.5" RETURNS, FONT:

CONTRACTOR TO SUBMIT COLOR SELECTIONS FOR APPROVAL BY LANDSCAPE

LETTERING TO BE INTERNALLY ILLUMINATED TO CREATE HALO LIGHTING EFFECT,

DIMENSIONS, LOCATION, AND SIZE TO BE TEST FIT/MOCKED UP FOR APPROVAL

INCLUDE ALL REQUIRED ELECTRICAL, TIMERS, SWITCHES AND ADJUSTABLE LIGHT CONTROL, PHOTOCELL ON, TIMER CLOCK OFF. SUBMIT SHOP DRAWINGS AND PRODUCT

DATE TO LANDSCAPE ARCHITECT FOR APPROVAL PRIOR TO PURCHASE & INSTALLATION.

8. ALL J-BOXES, CONDUIT, FIXTURES, WIRES, ETC.. TO BE CONCEALED BY SIGN AND NOT

LETTERING NOTES:


TIGHT ENCLOSURE IS CREATED

COPPERPLATE BOLD; ALL CAPITAL


ARCHITECT PRIOR TO FABRICATION.

PRIOR TO FABRICATION AND INSTALLATION.

IMMEDIATELY SEEN FROM PUBLIC VIEW.

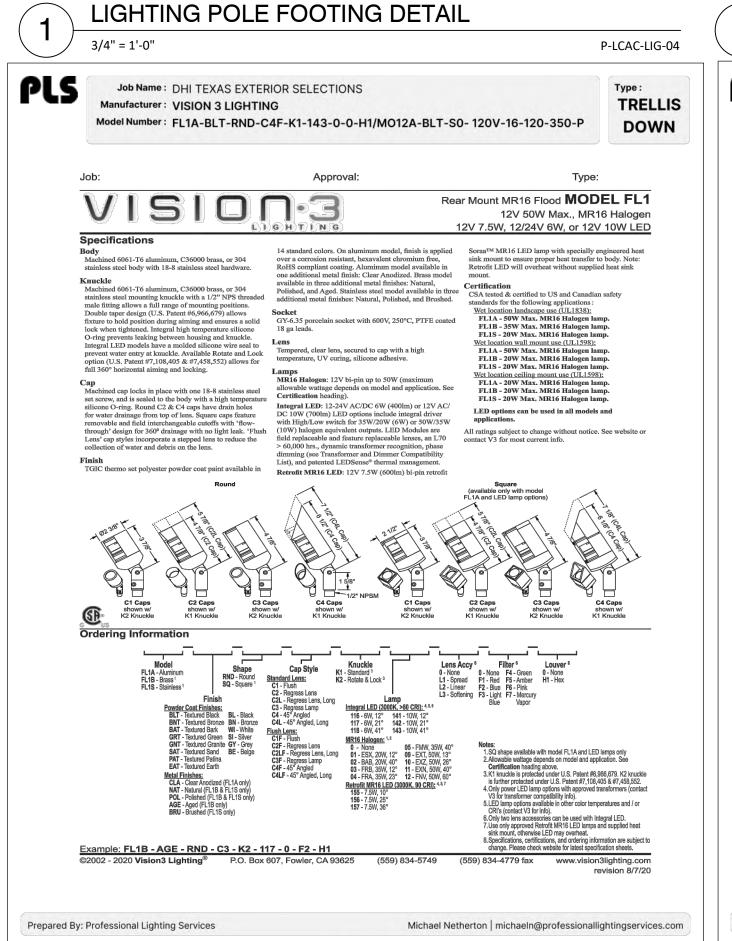

TRELLIS DOWN LIGHT

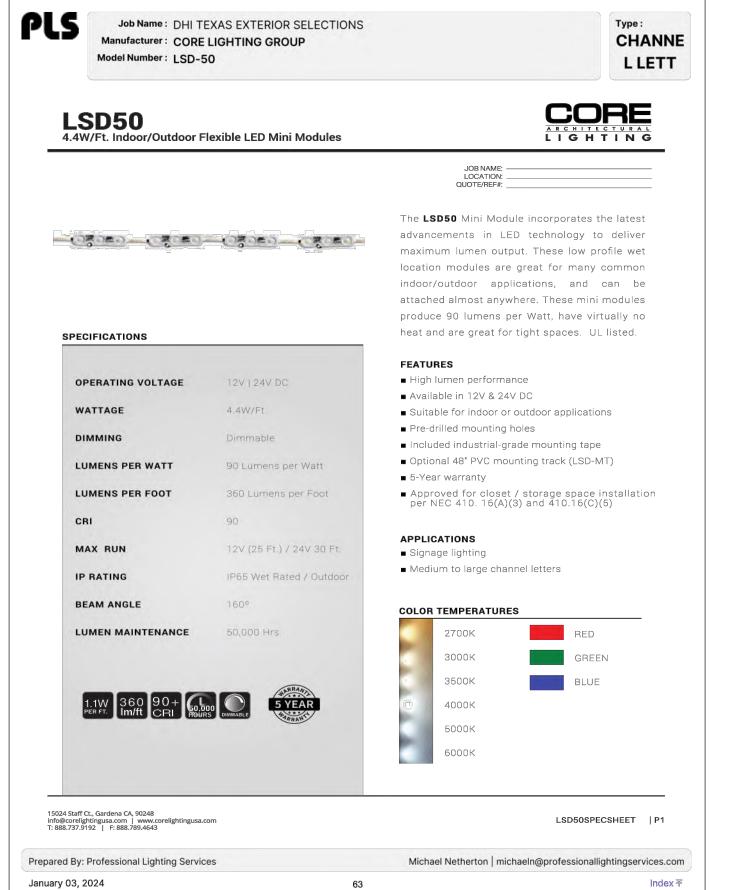

GROUND-MOUNTED DUPLEX RECEPTACLE (SIMILAR) SIGN DETAIL 1" = 1'-0" P-DH2-09

STRAND

10003 TECHNOLOGY BLVD.

WEST DALLAS, TX. 75220 972-620-8204 REGISTRATION NO: F-1629

CLIENT INFO

DHI COMMUNITIES 5419 NORTH LOOP 1604 EAST, SAN ANTONIO, TX 78247

01/26/2024

P-DH3-WAL-10

JUNO NO O

SCALE: AS SHOWN 12/08/2023


SHEET TITLE

LIGHTING DETAIL

LL2.02

STRAND 2148616

DRWN: STRAND CHKD: STRAND

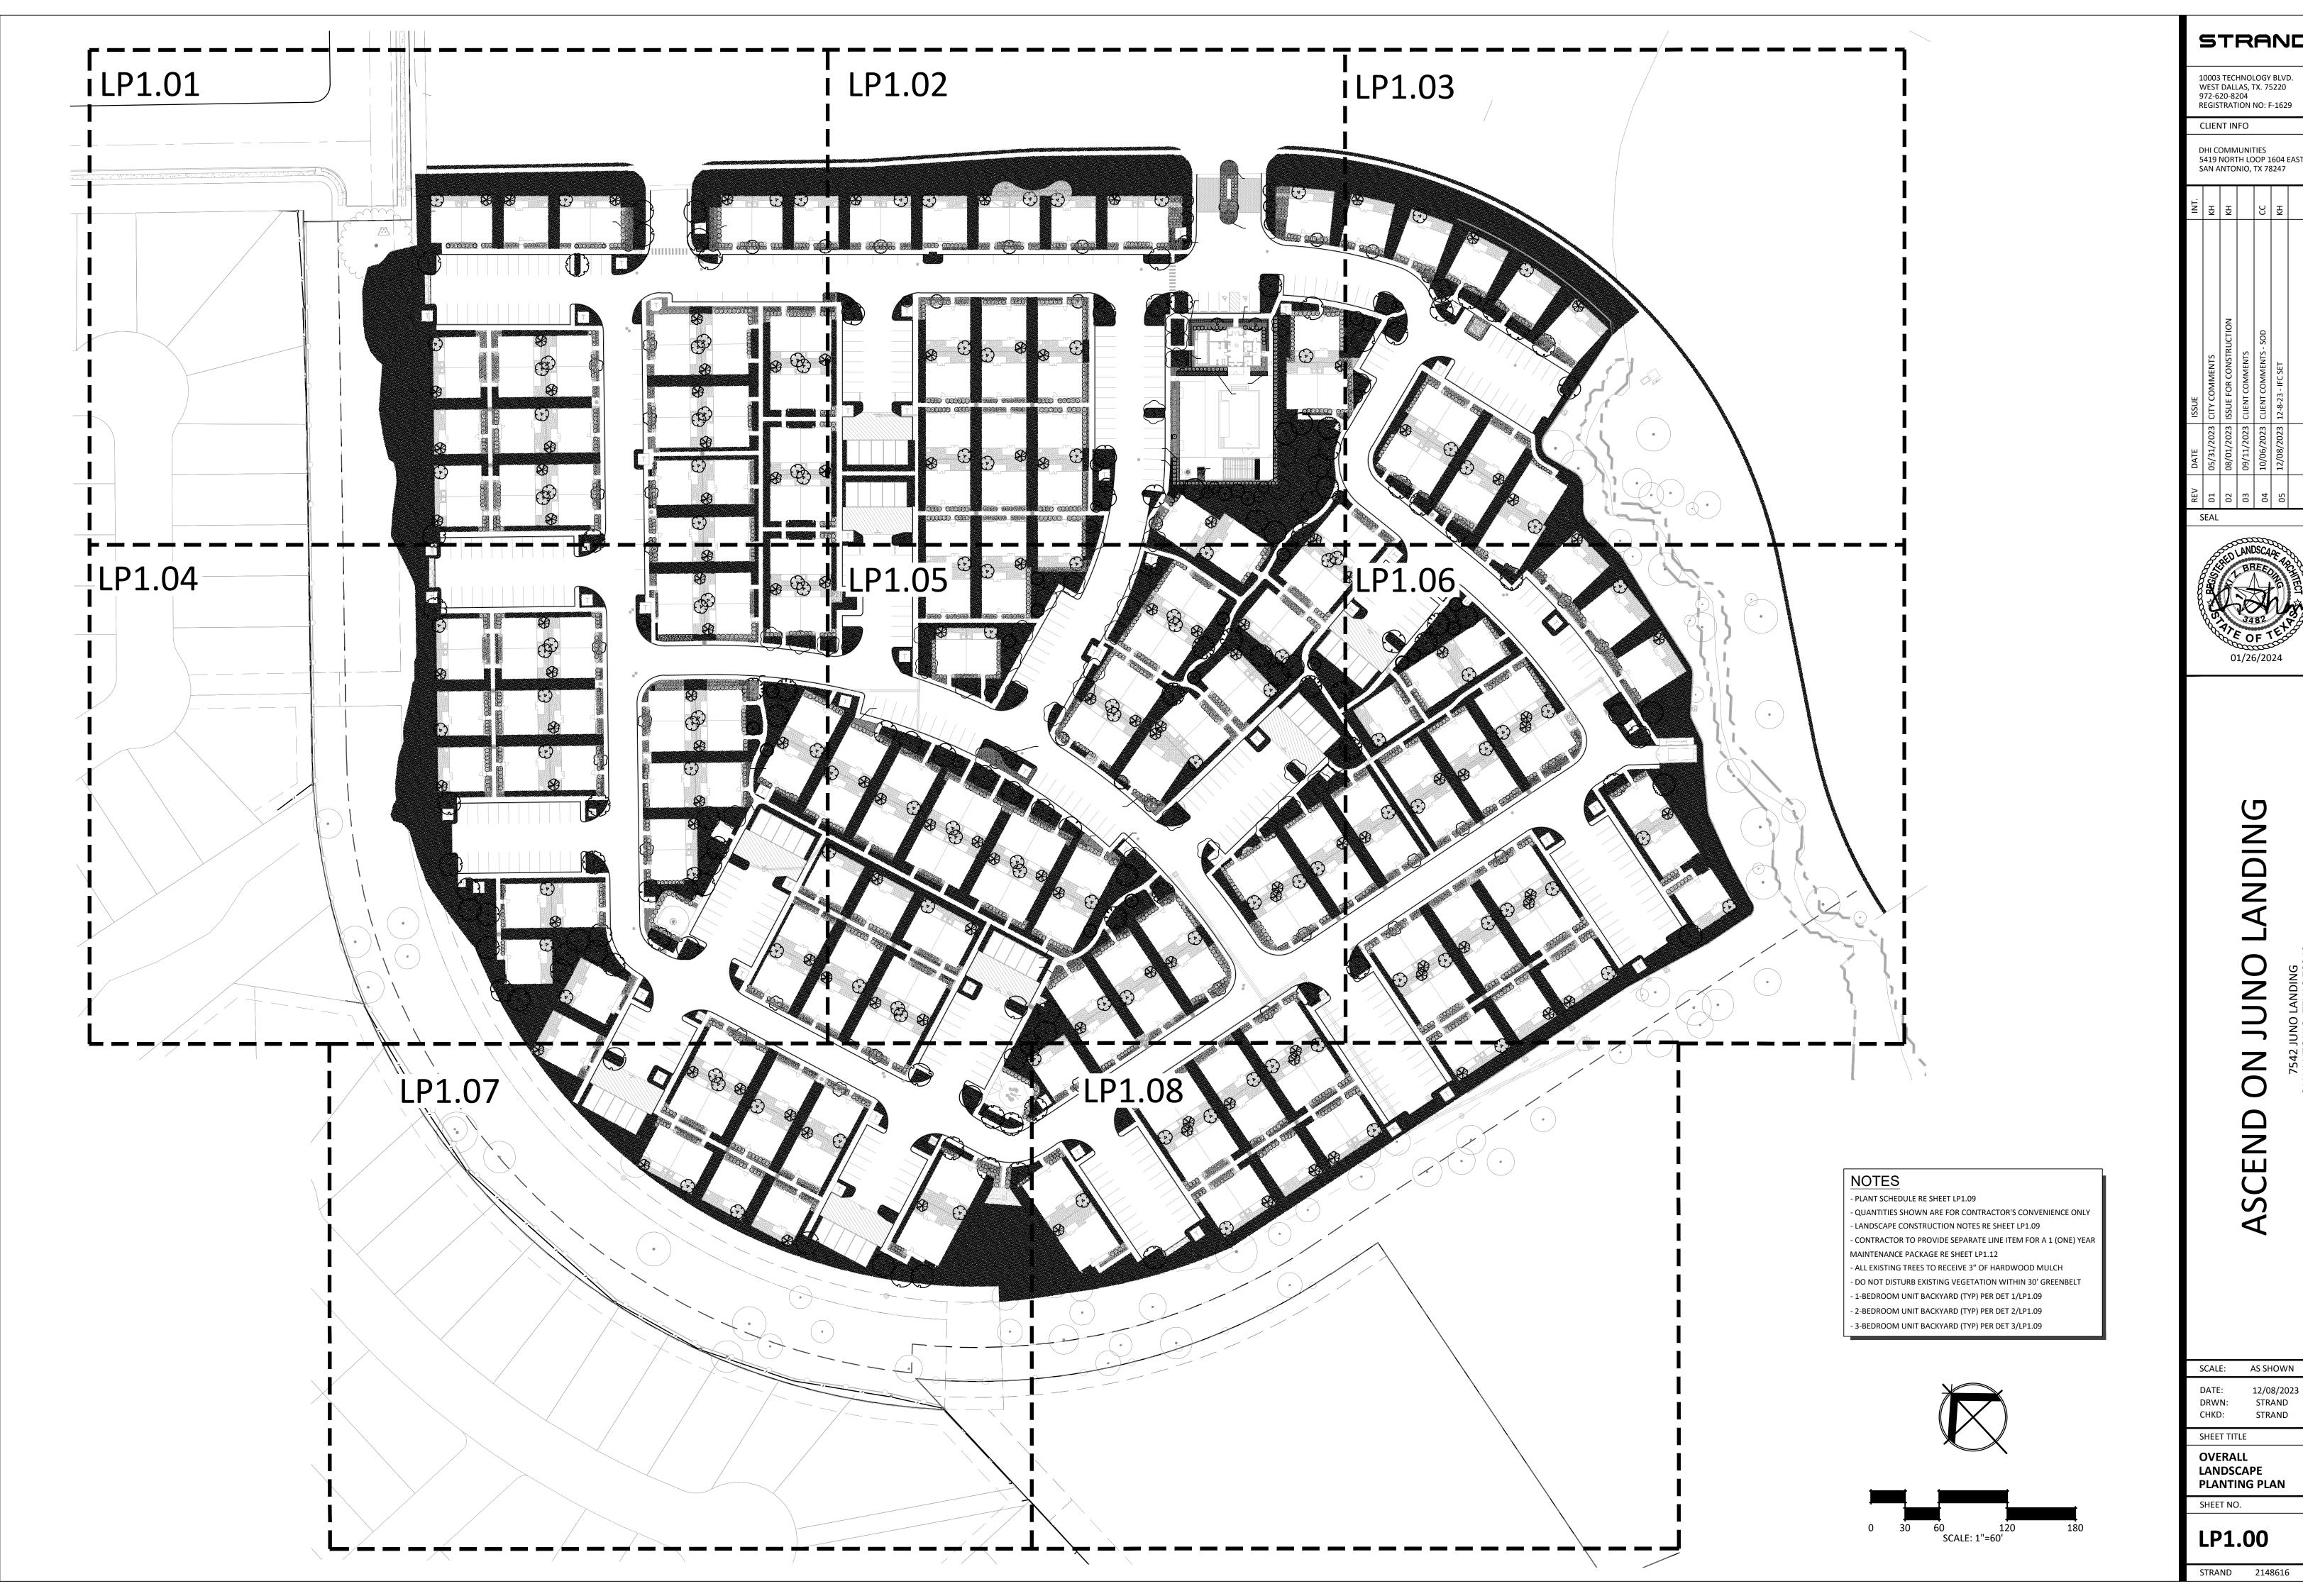

DHI COMMUNITIES 5419 NORTH LOOP 1604 EAST, SAN ANTONIO, TX 78247

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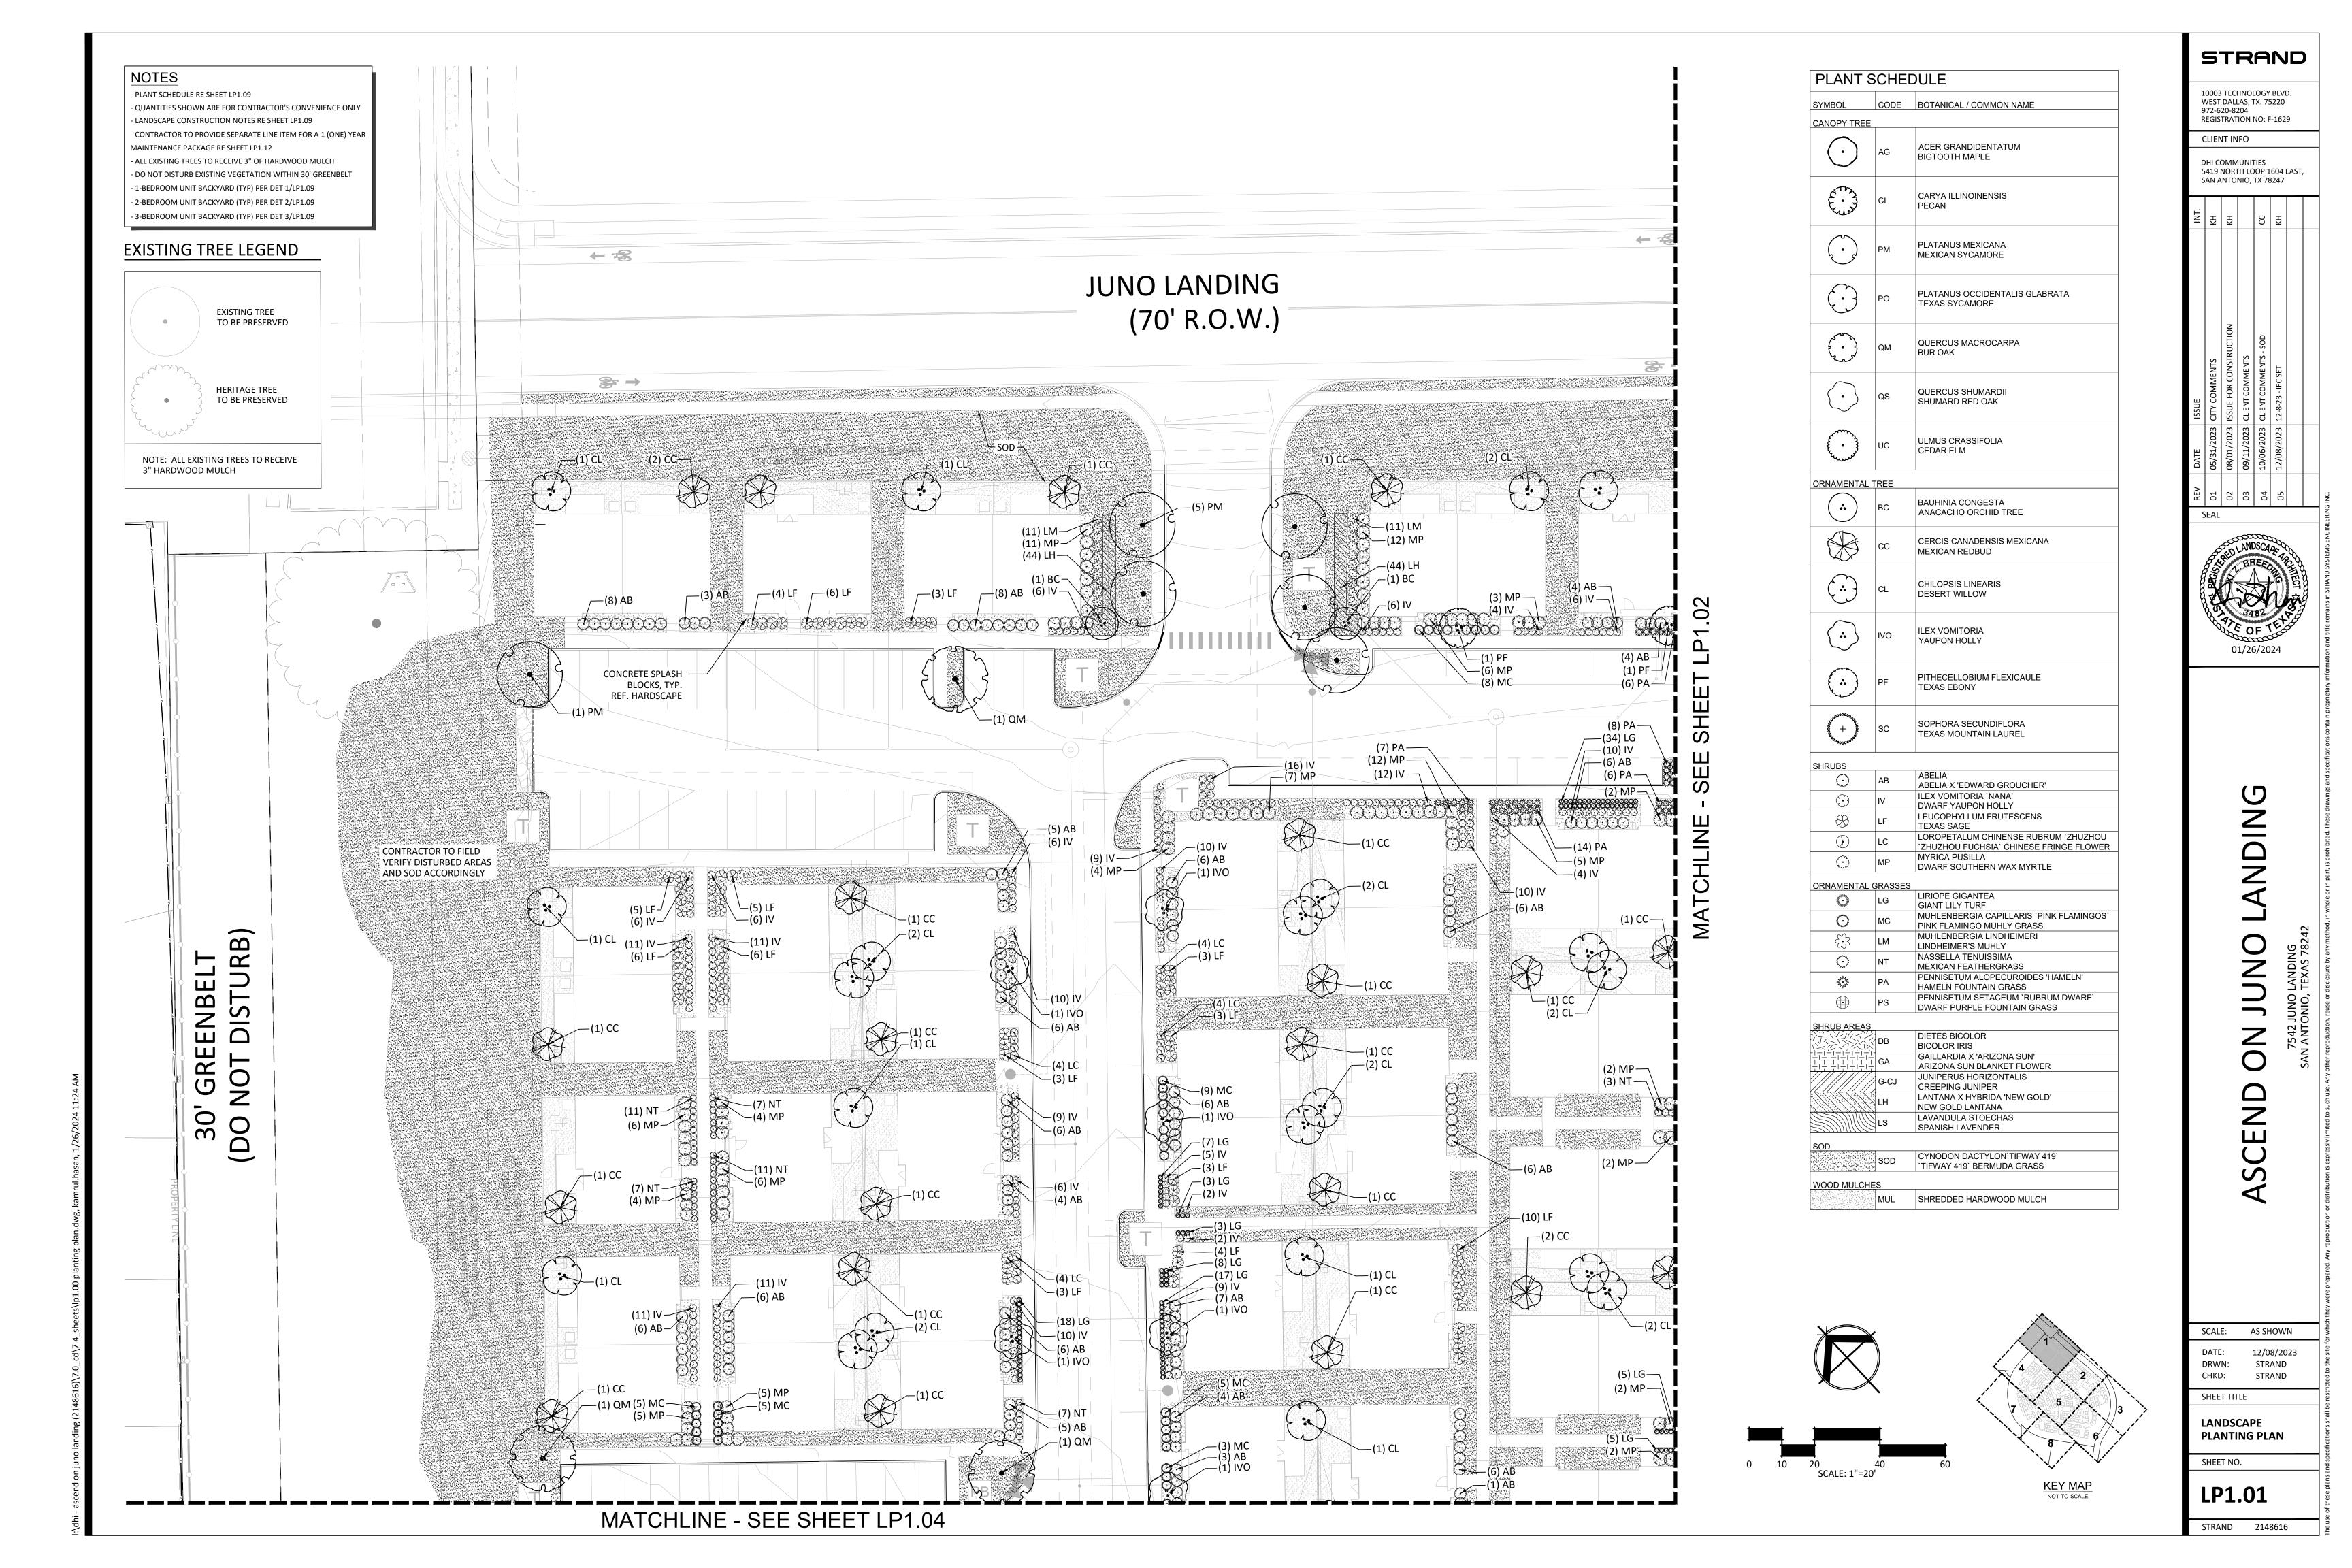



SCALE: AS SHOWN

12/08/2023 STRAND STRAND

LANDSCAPE PLANTING PLAN

LP1.00



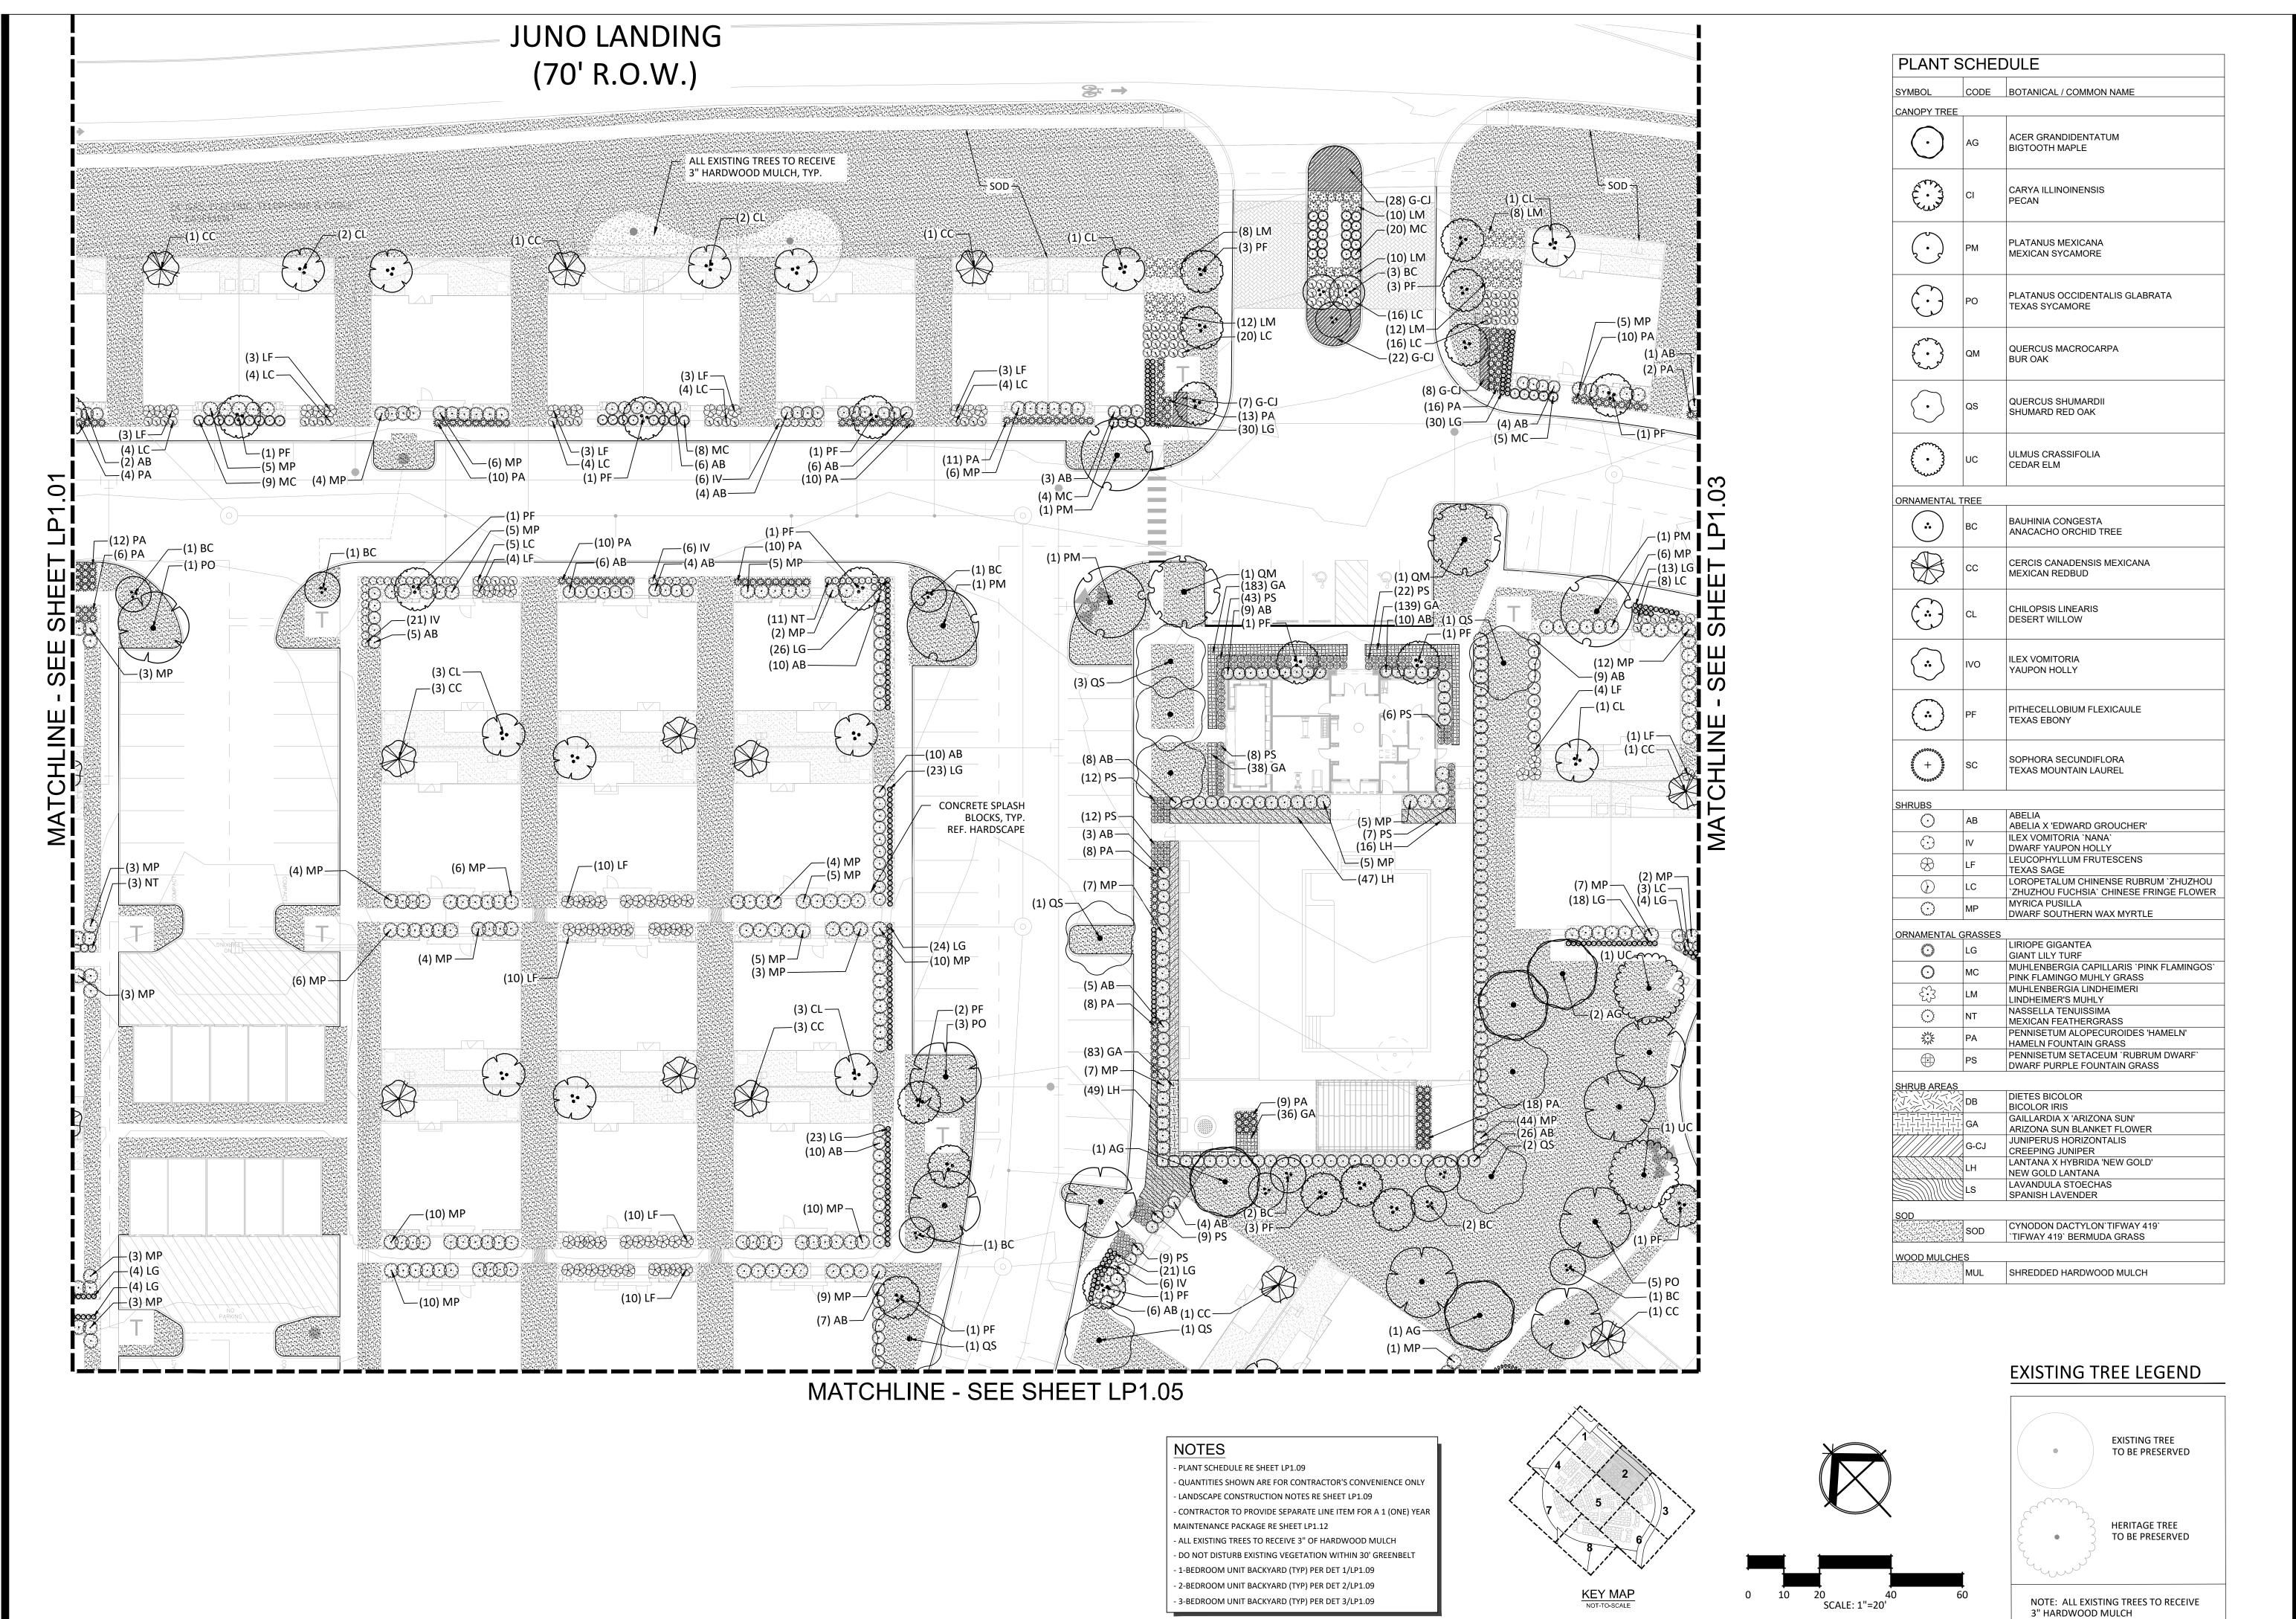

10003 TECHNOLOGY BLVD. WEST DALLAS, TX. 75220 972-620-8204

REGISTRATION NO: F-1629

CLIENT INFO

DHI COMMUNITIES 5419 NORTH LOOP 1604 EAST,

SAN ANTONIO, TX 78247 | 조 | 조 | | 8 | 조 |

01/26/2024

JUNO NO O


SCALE: AS SHOWN 12/08/2023 DRWN: STRAND

CHKD: STRAND SHEET TITLE

LANDSCAPE PLANTING PLAN

LP1.02

SHEET NO.

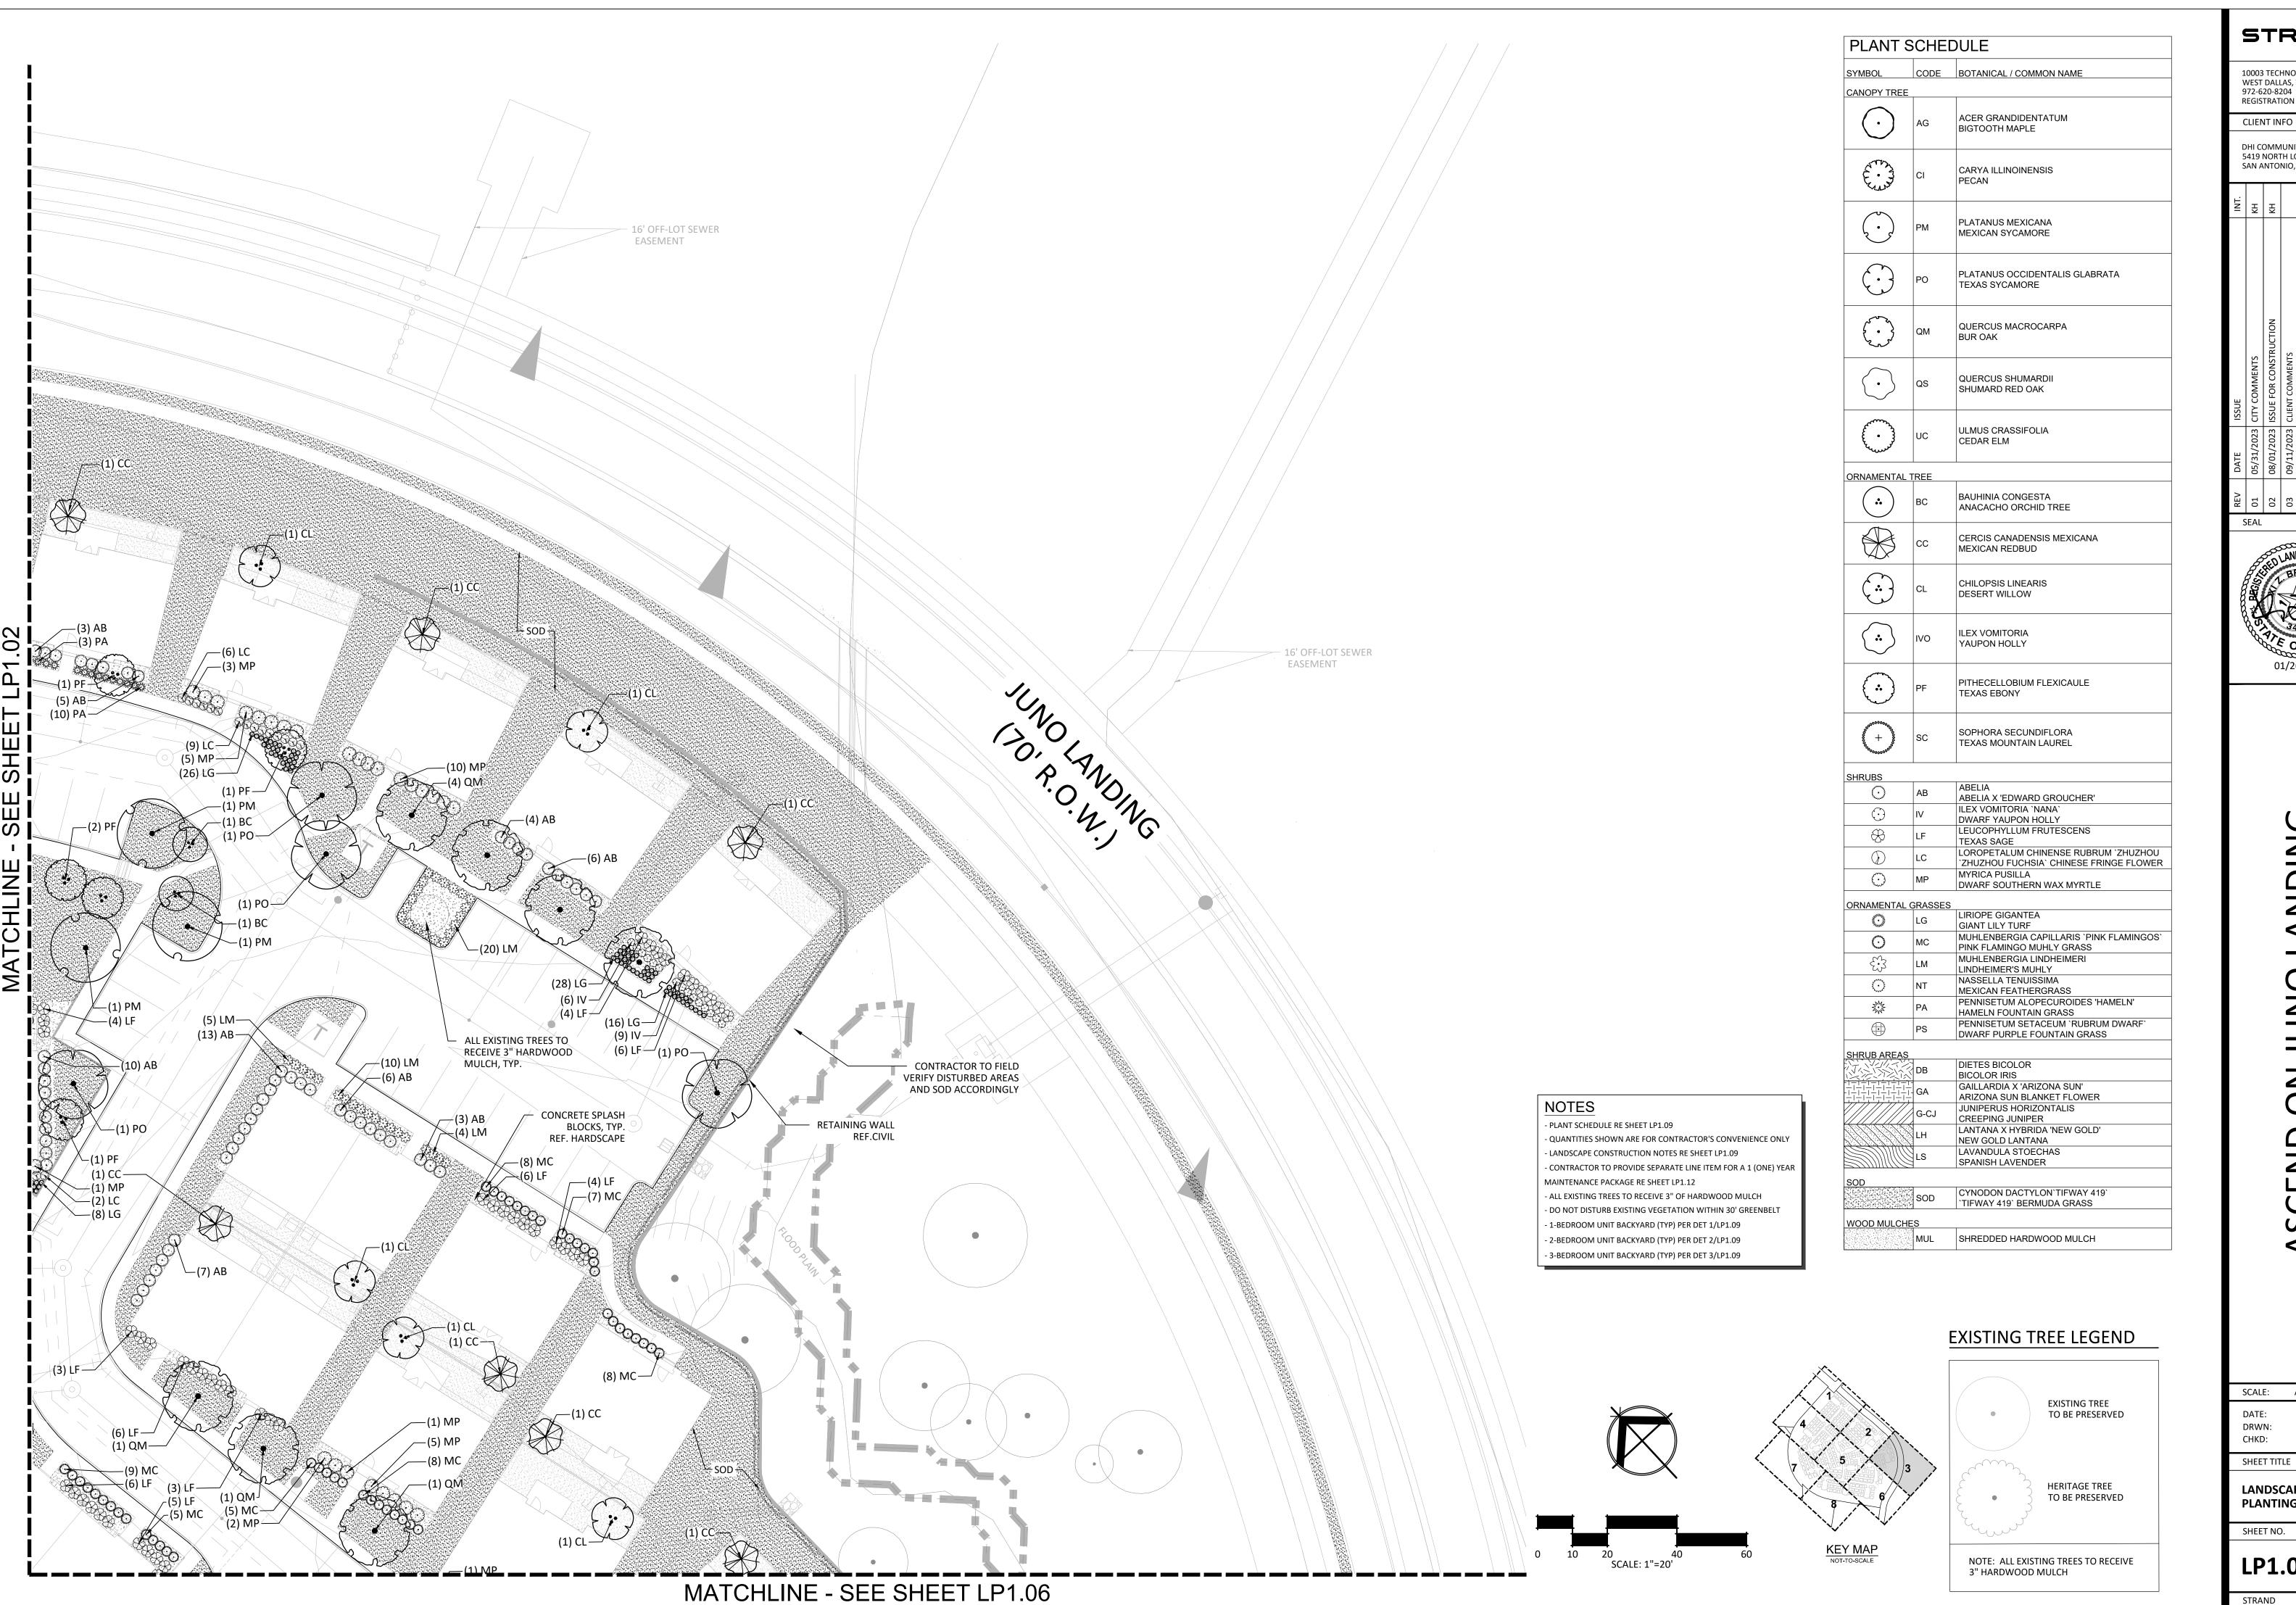

10003 TECHNOLOGY BLVD. WEST DALLAS, TX. 75220 972-620-8204

REGISTRATION NO: F-1629

CLIENT INFO

DHI COMMUNITIES

5419 NORTH LOOP 1604 EAST, SAN ANTONIO, TX 78247

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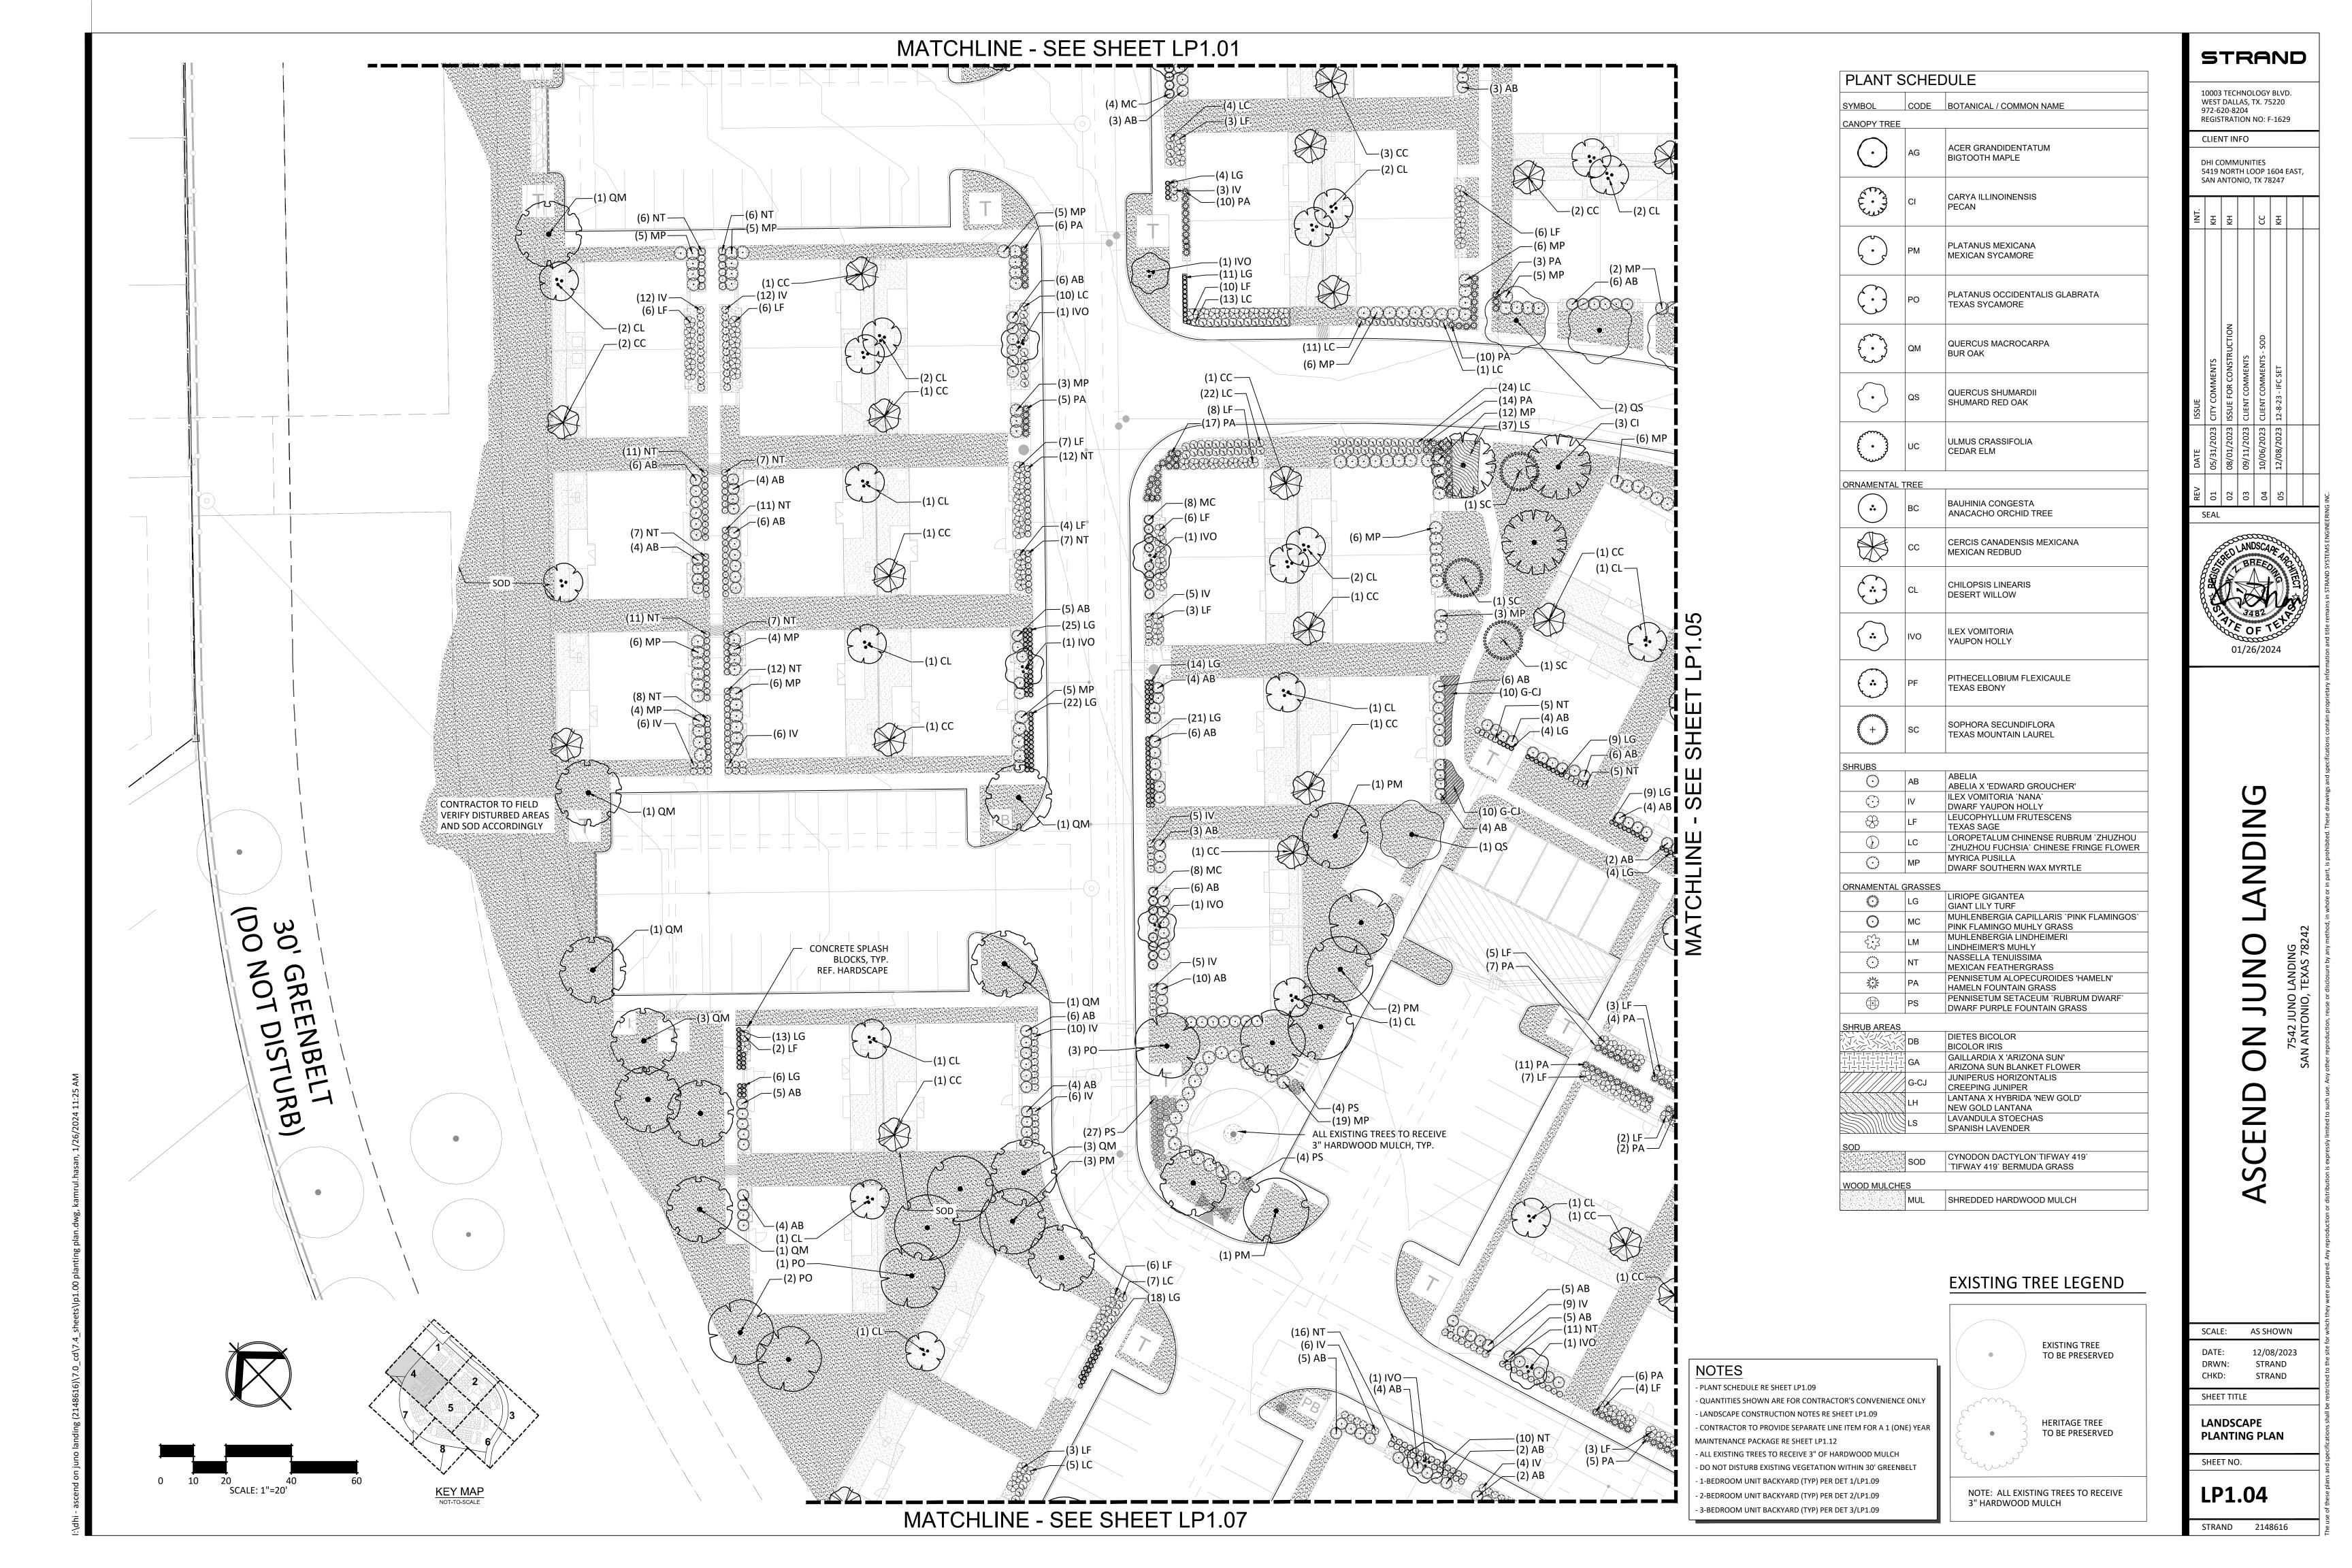
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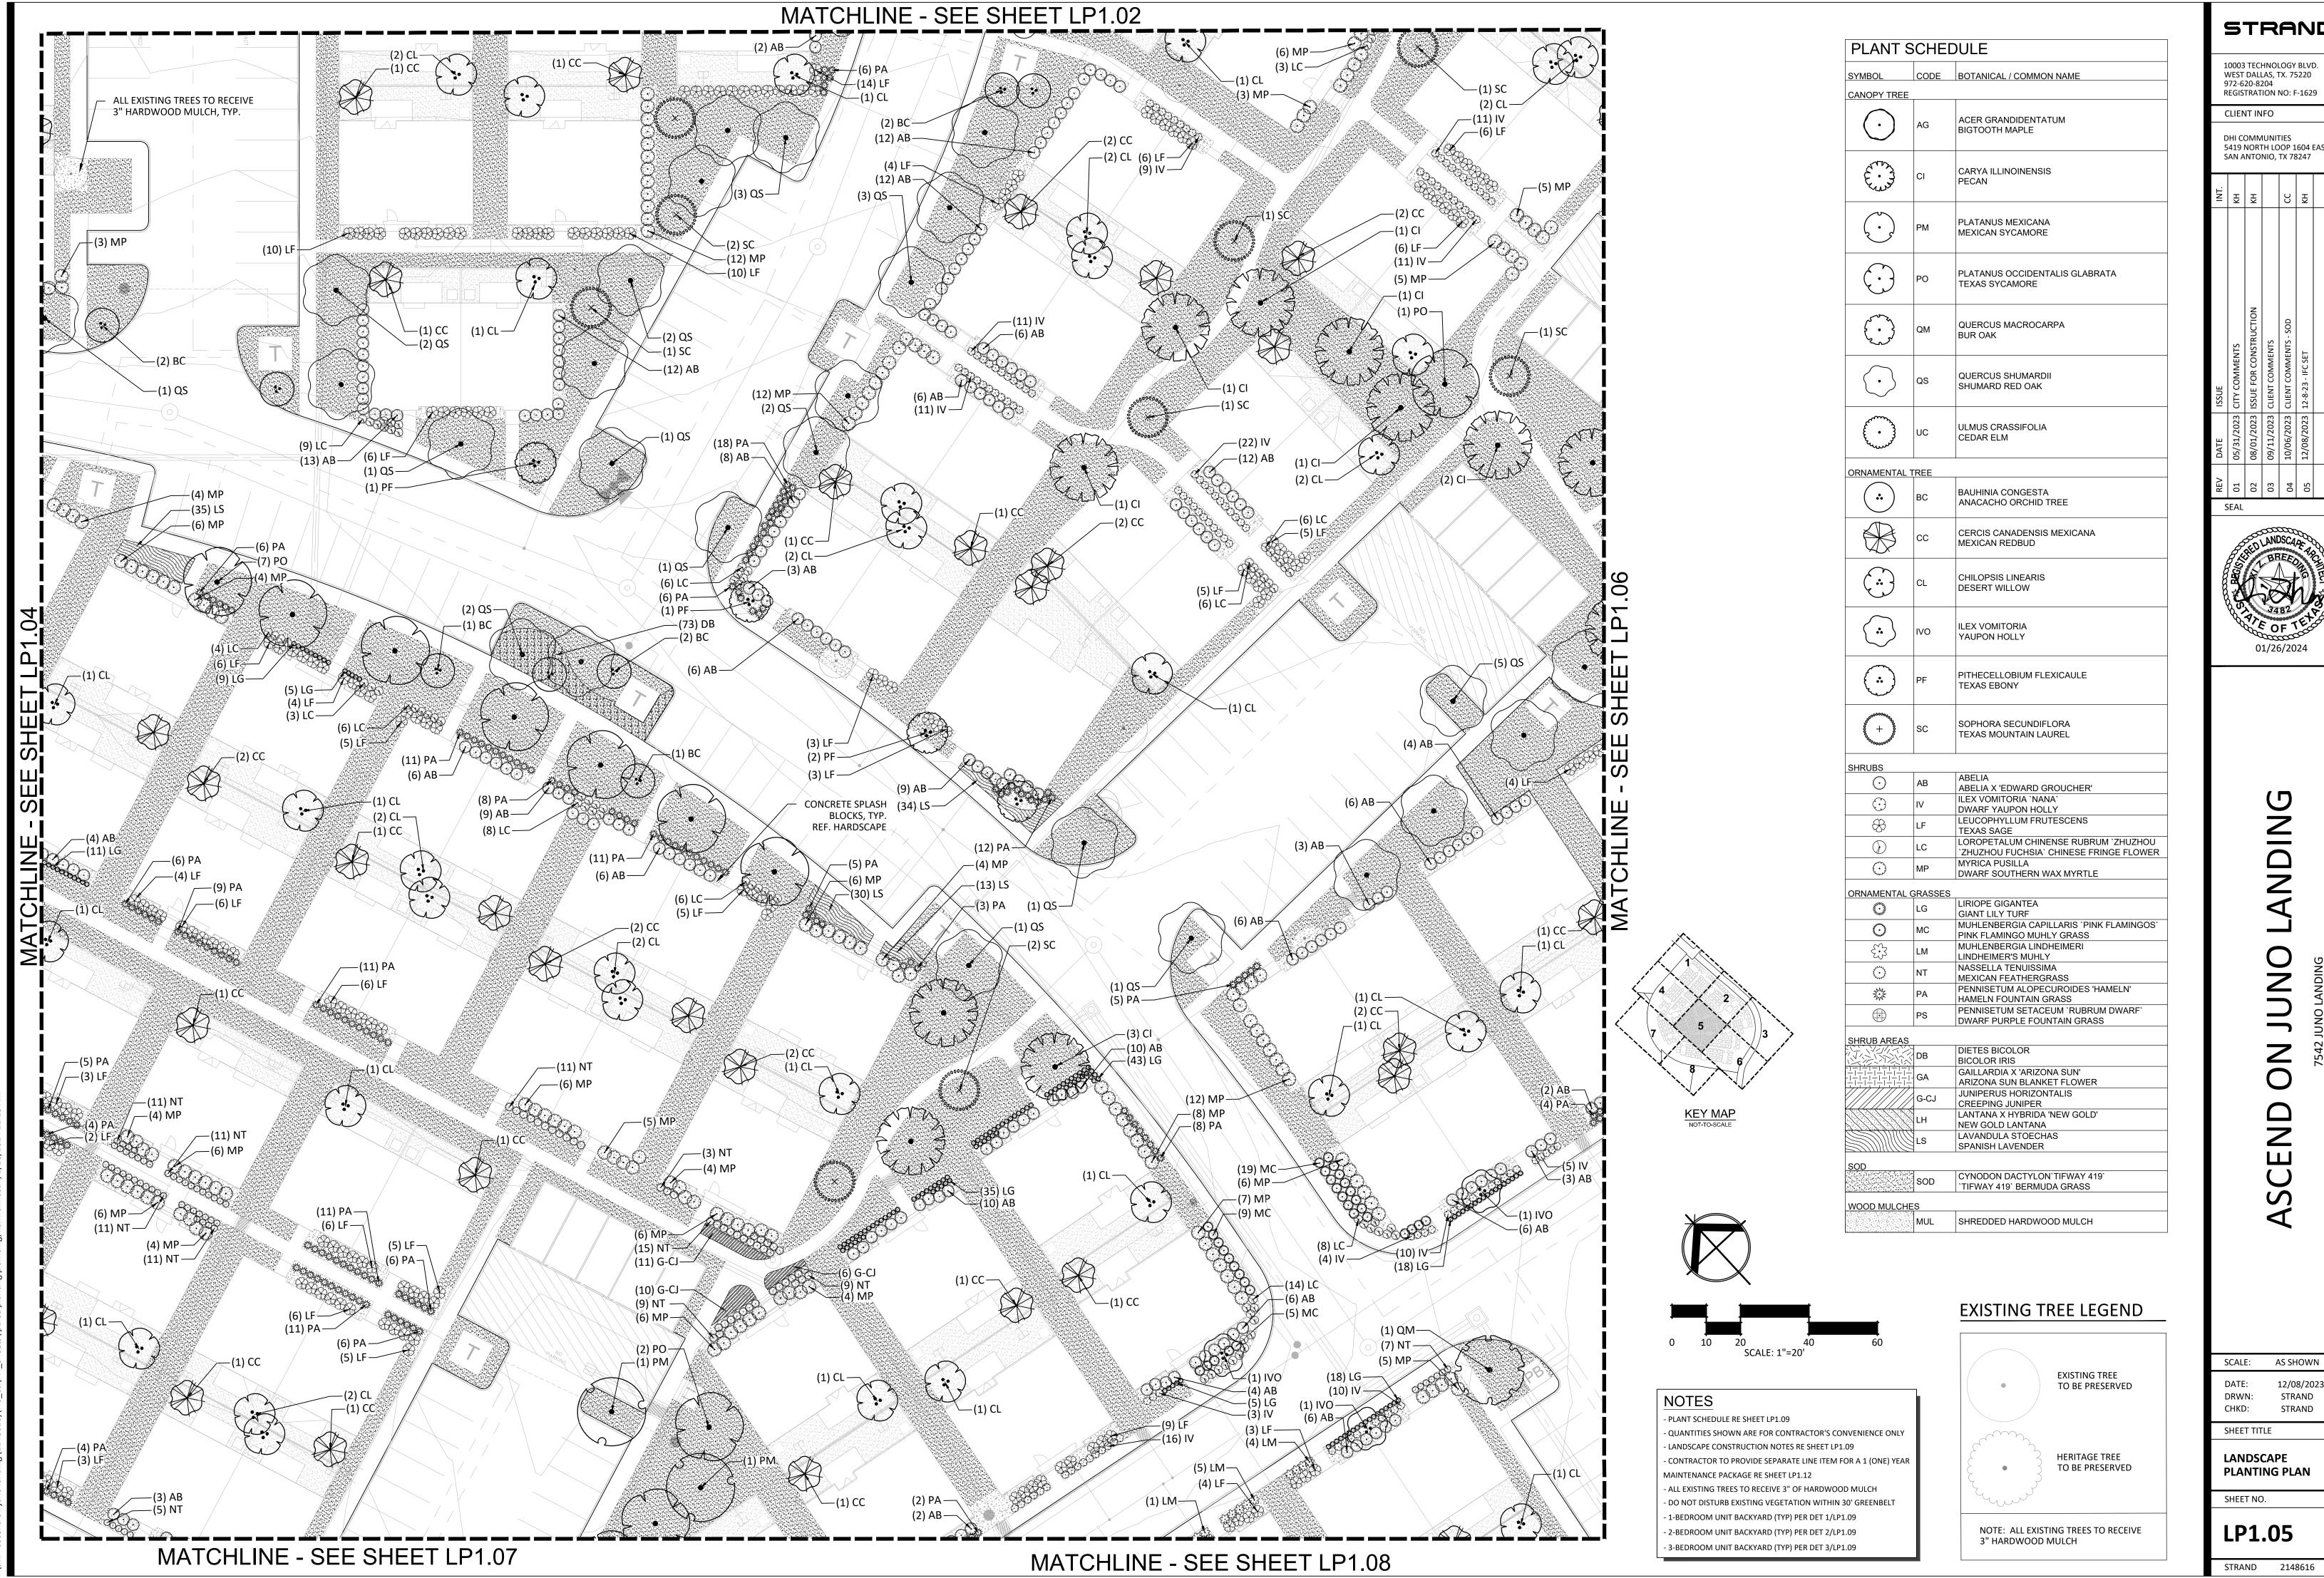
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LANDSCAPE PLANTING PLAN

SHEET NO.


LP1.03





5419 NORTH LOOP 1604 EAST,



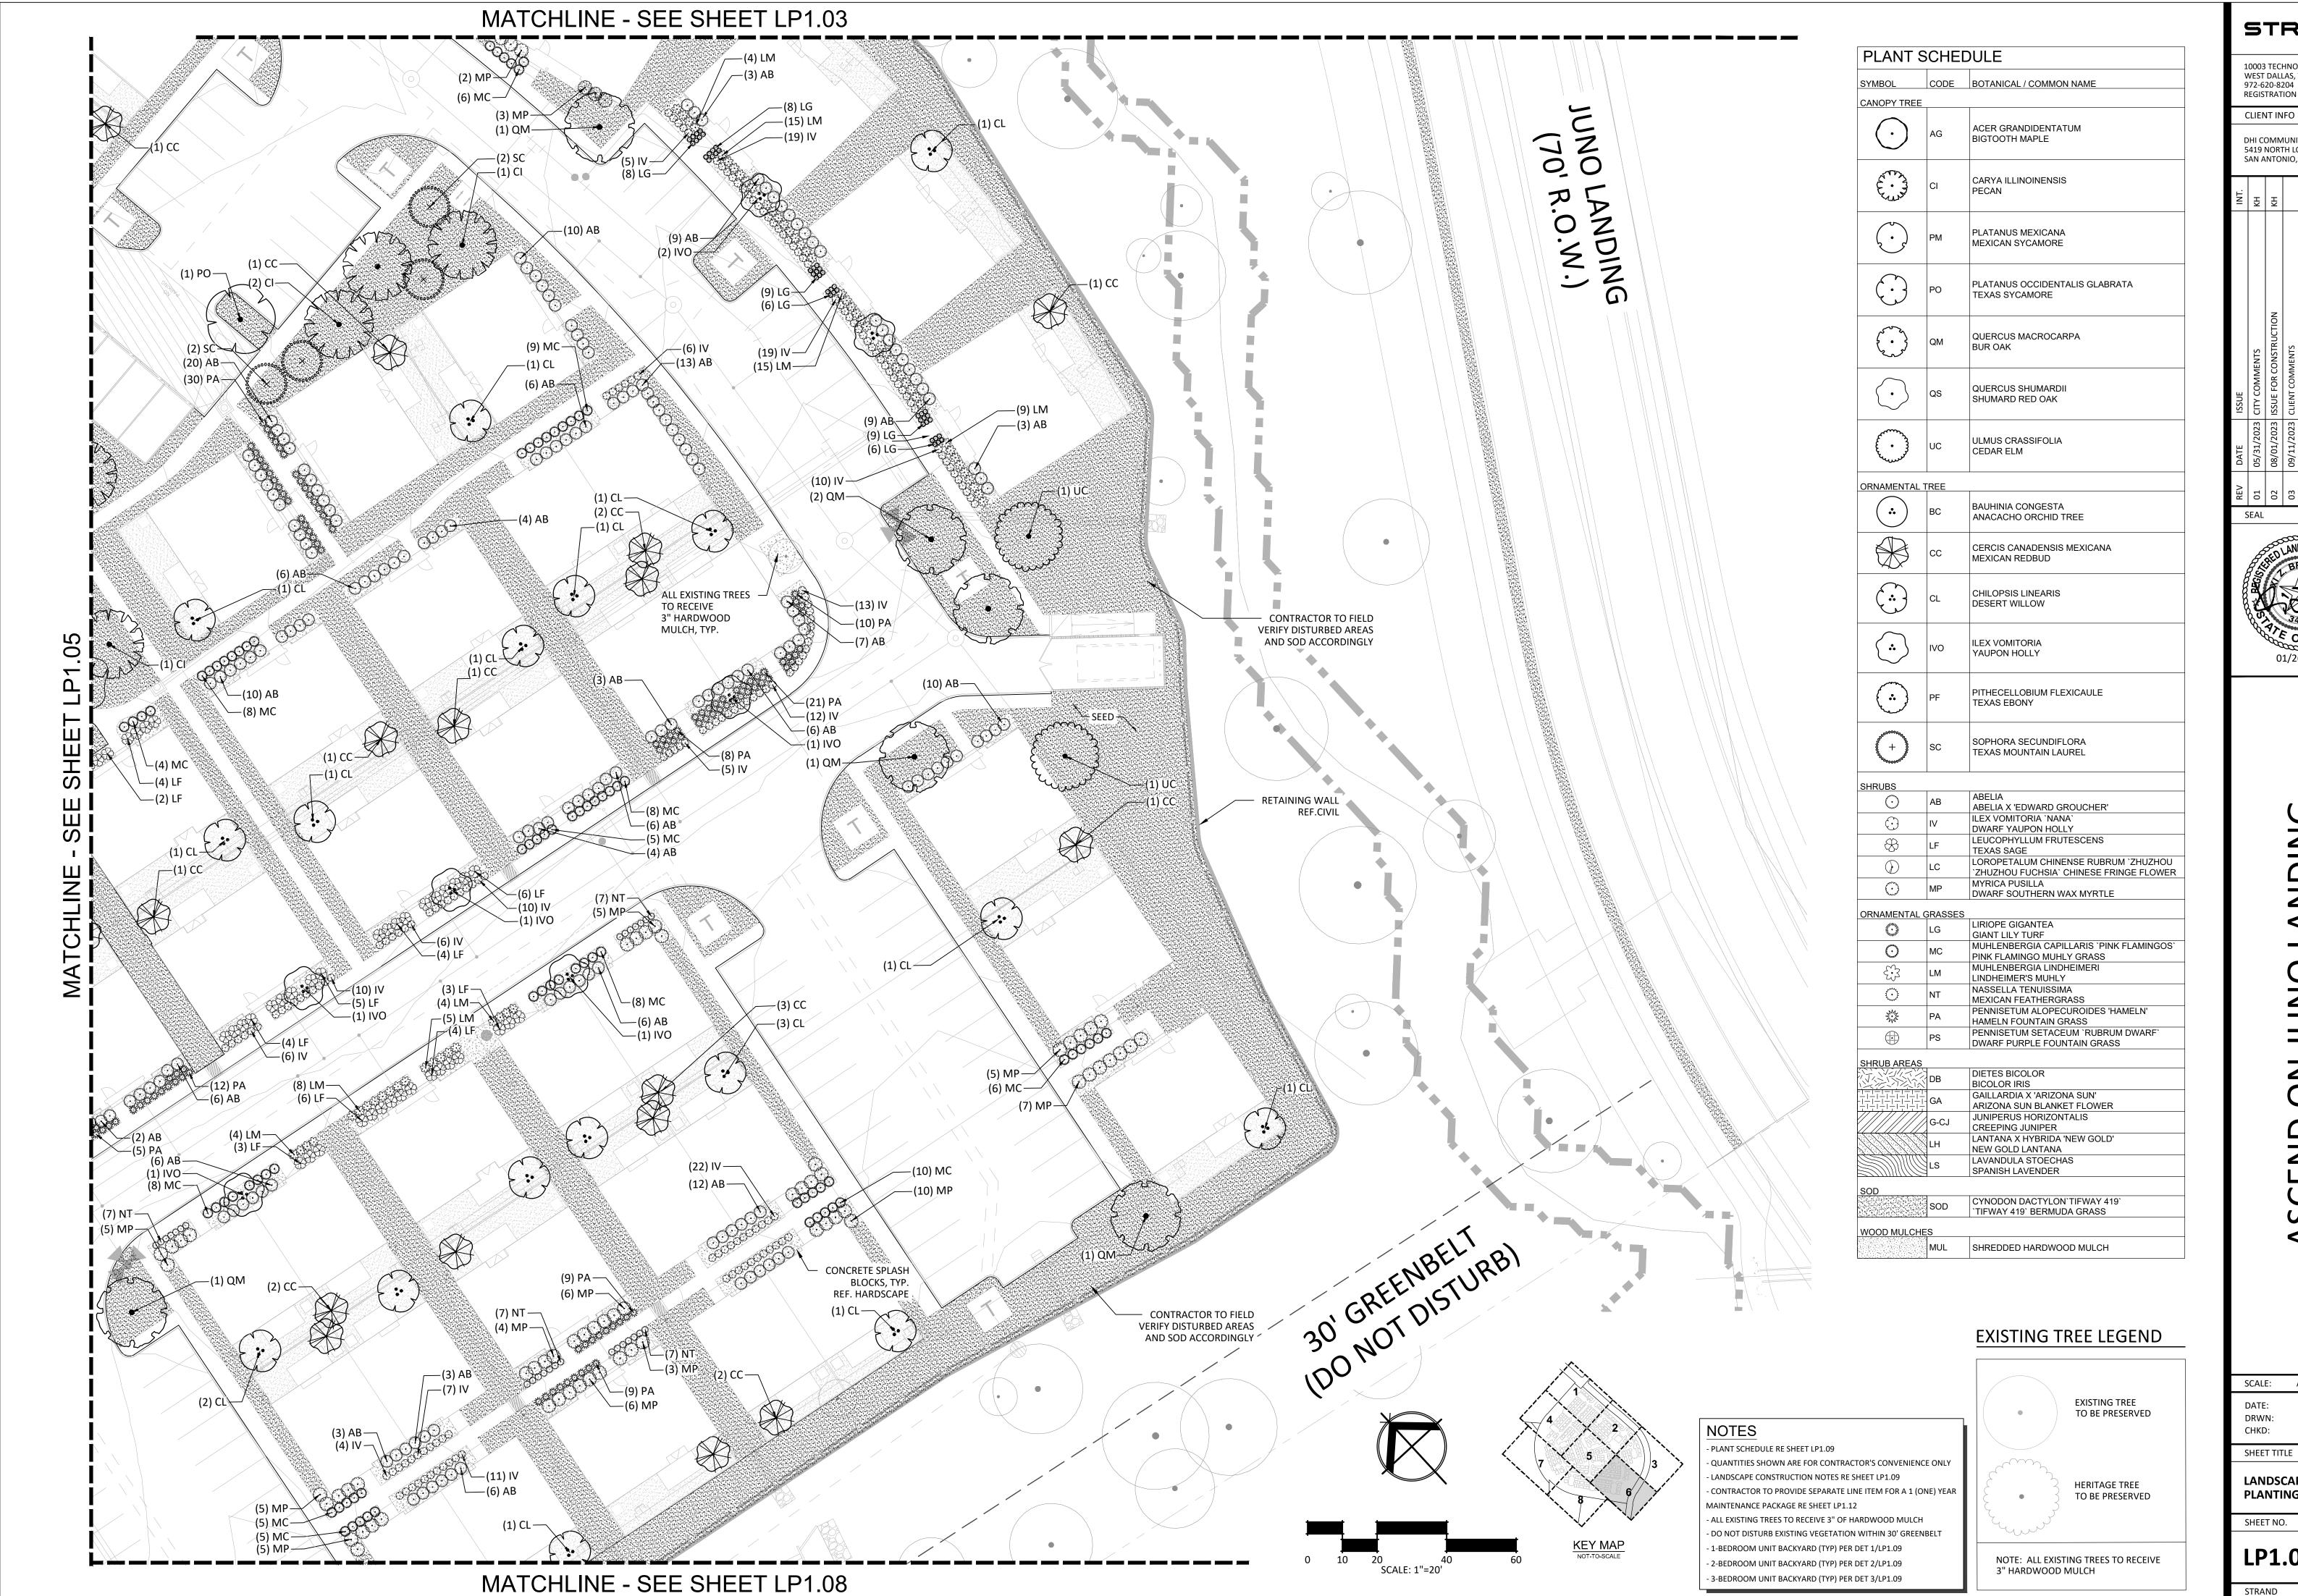

10003 TECHNOLOGY BLVD. WEST DALLAS, TX. 75220 972-620-8204 REGISTRATION NO: F-1629

CLIENT INFO

DHI COMMUNITIES 5419 NORTH LOOP 1604 EAST, SAN ANTONIO, TX 78247

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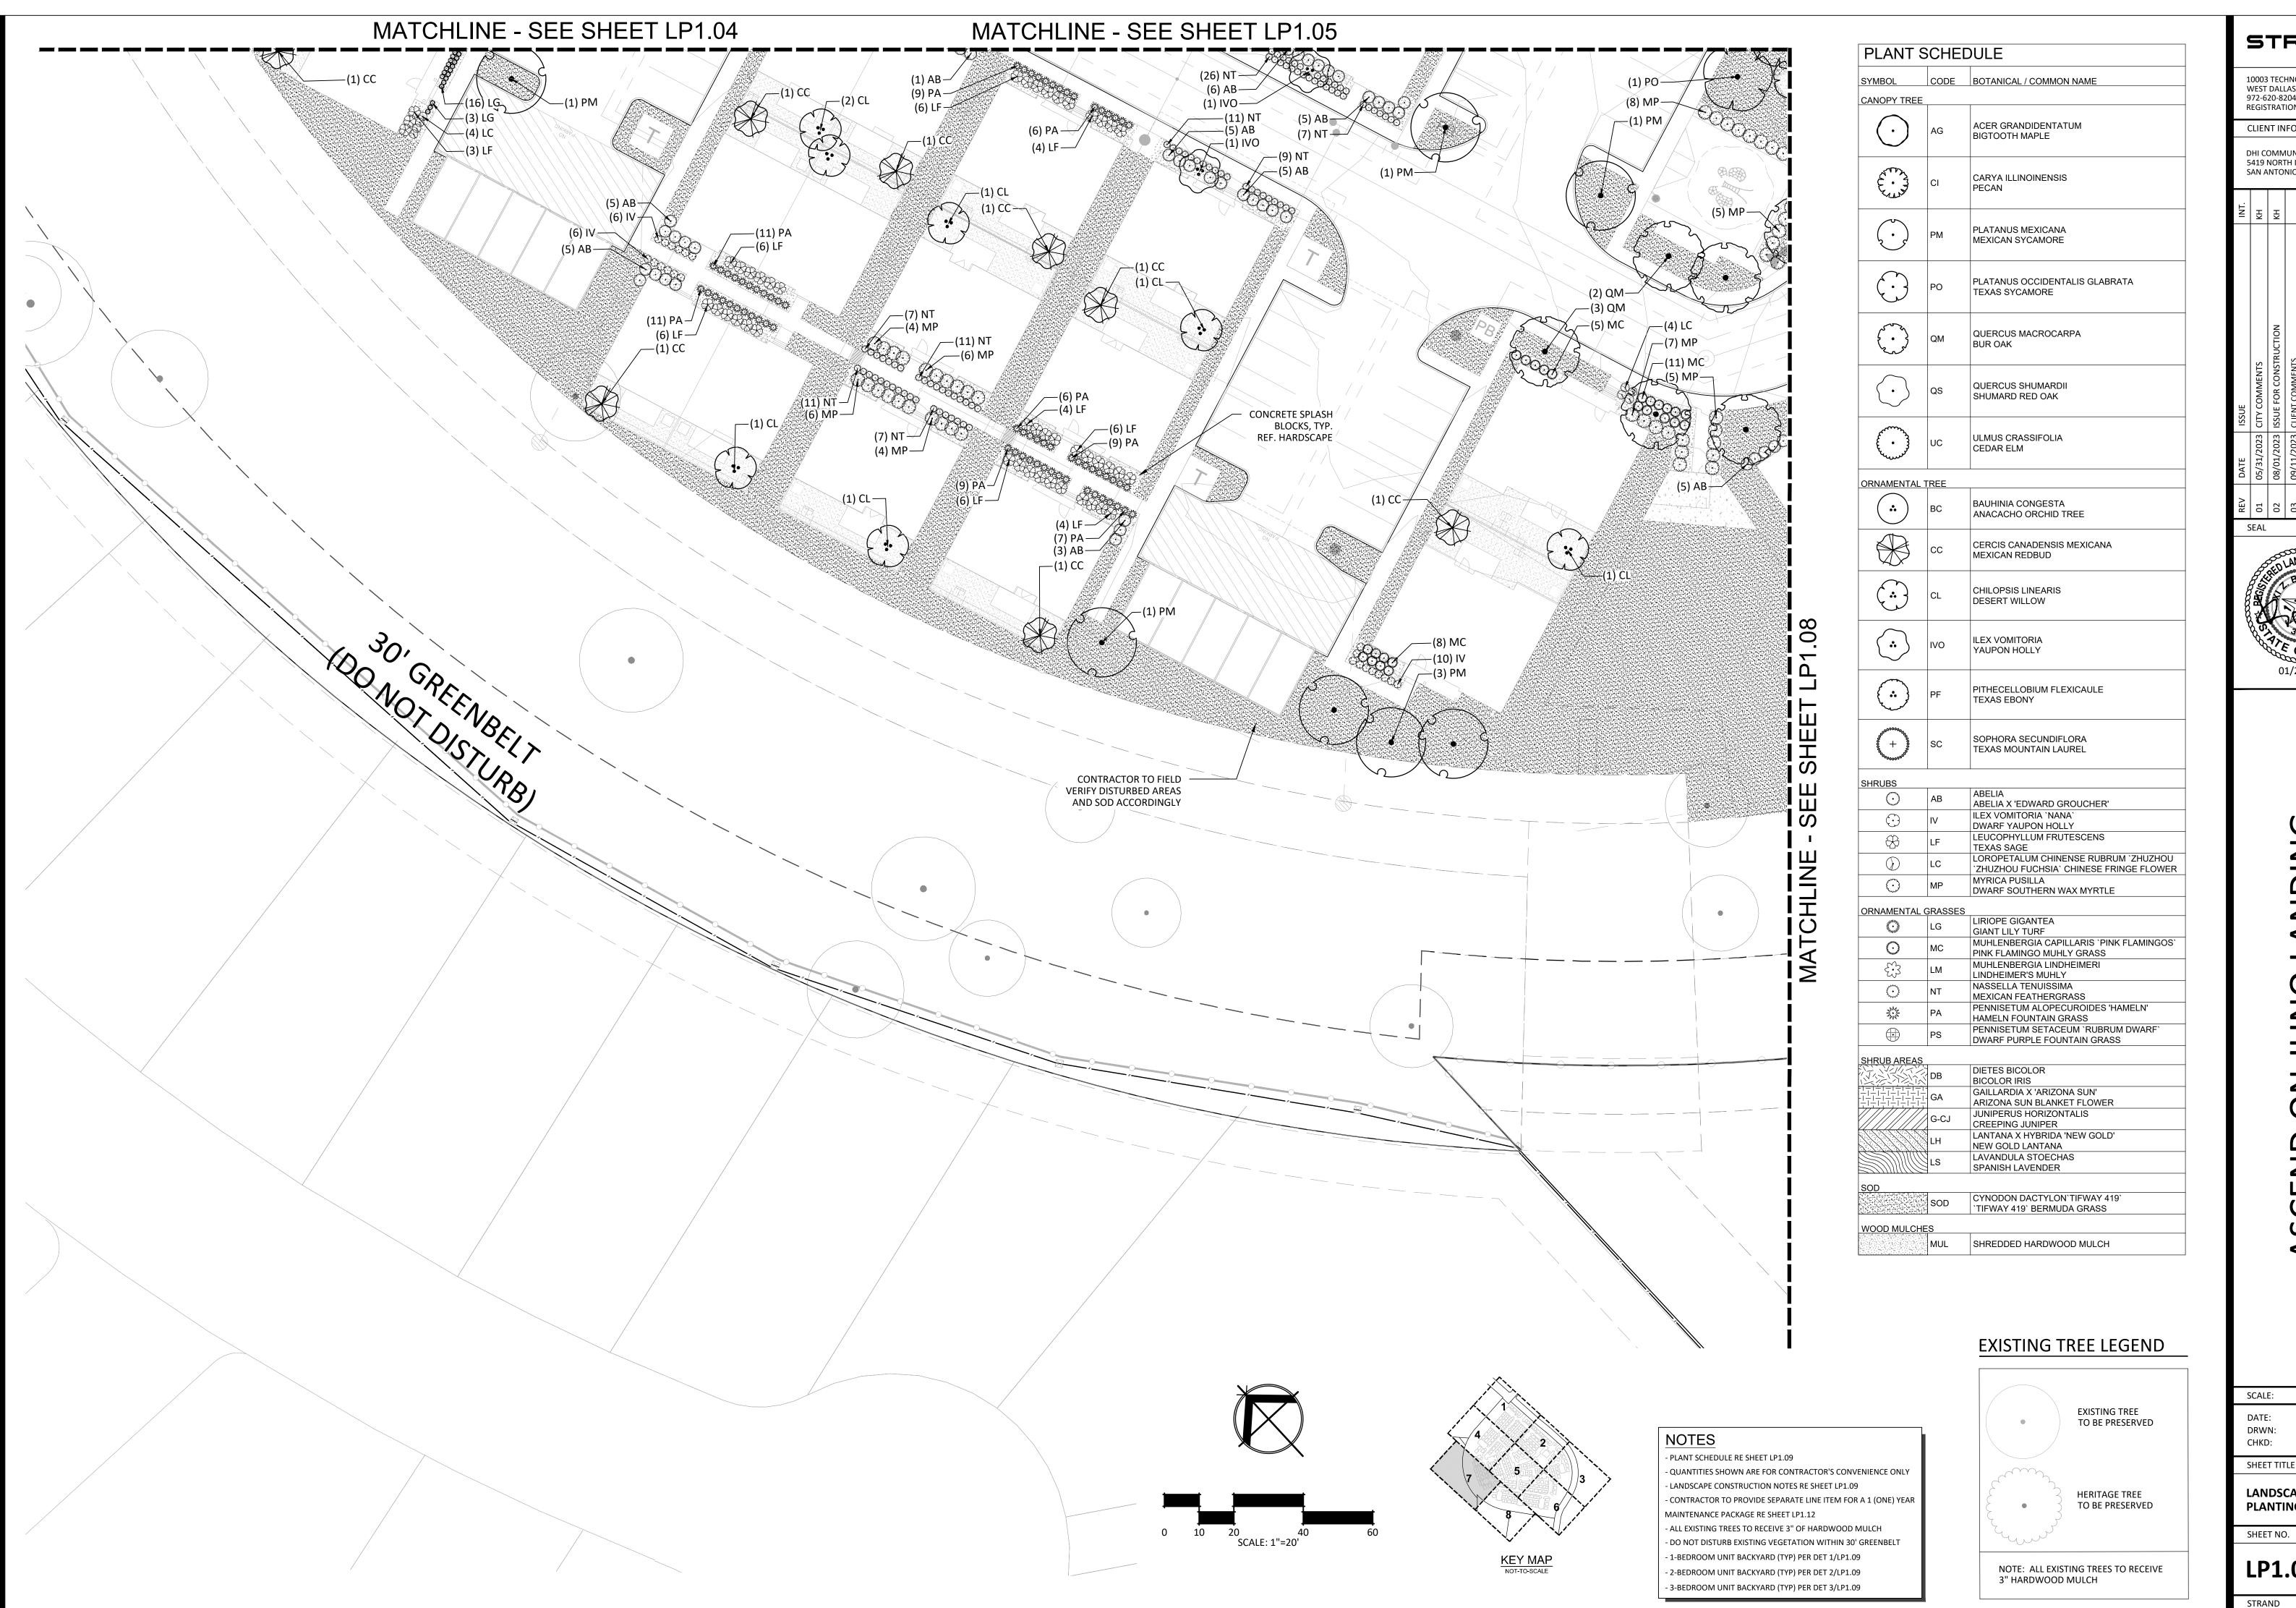
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SCALE: AS SHOWN 12/08/2023

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LANDSCAPE PLANTING PLAN

SHEET NO. LP1.06




STRAND 10003 TECHNOLOGY BLVD. WEST DALLAS, TX. 75220 972-620-8204 REGISTRATION NO: F-1629 CLIENT INFO DHI COMMUNITIES 5419 NORTH LOOP 1604 EAST, SAN ANTONIO, TX 78247 :|조|조| | 8|조| 01 02 03 04 05

SCALE: AS SHOWN 12/08/2023 DRWN: STRAND CHKD:

STRAND SHEET TITLE

LANDSCAPE PLANTING PLAN

LP1.07

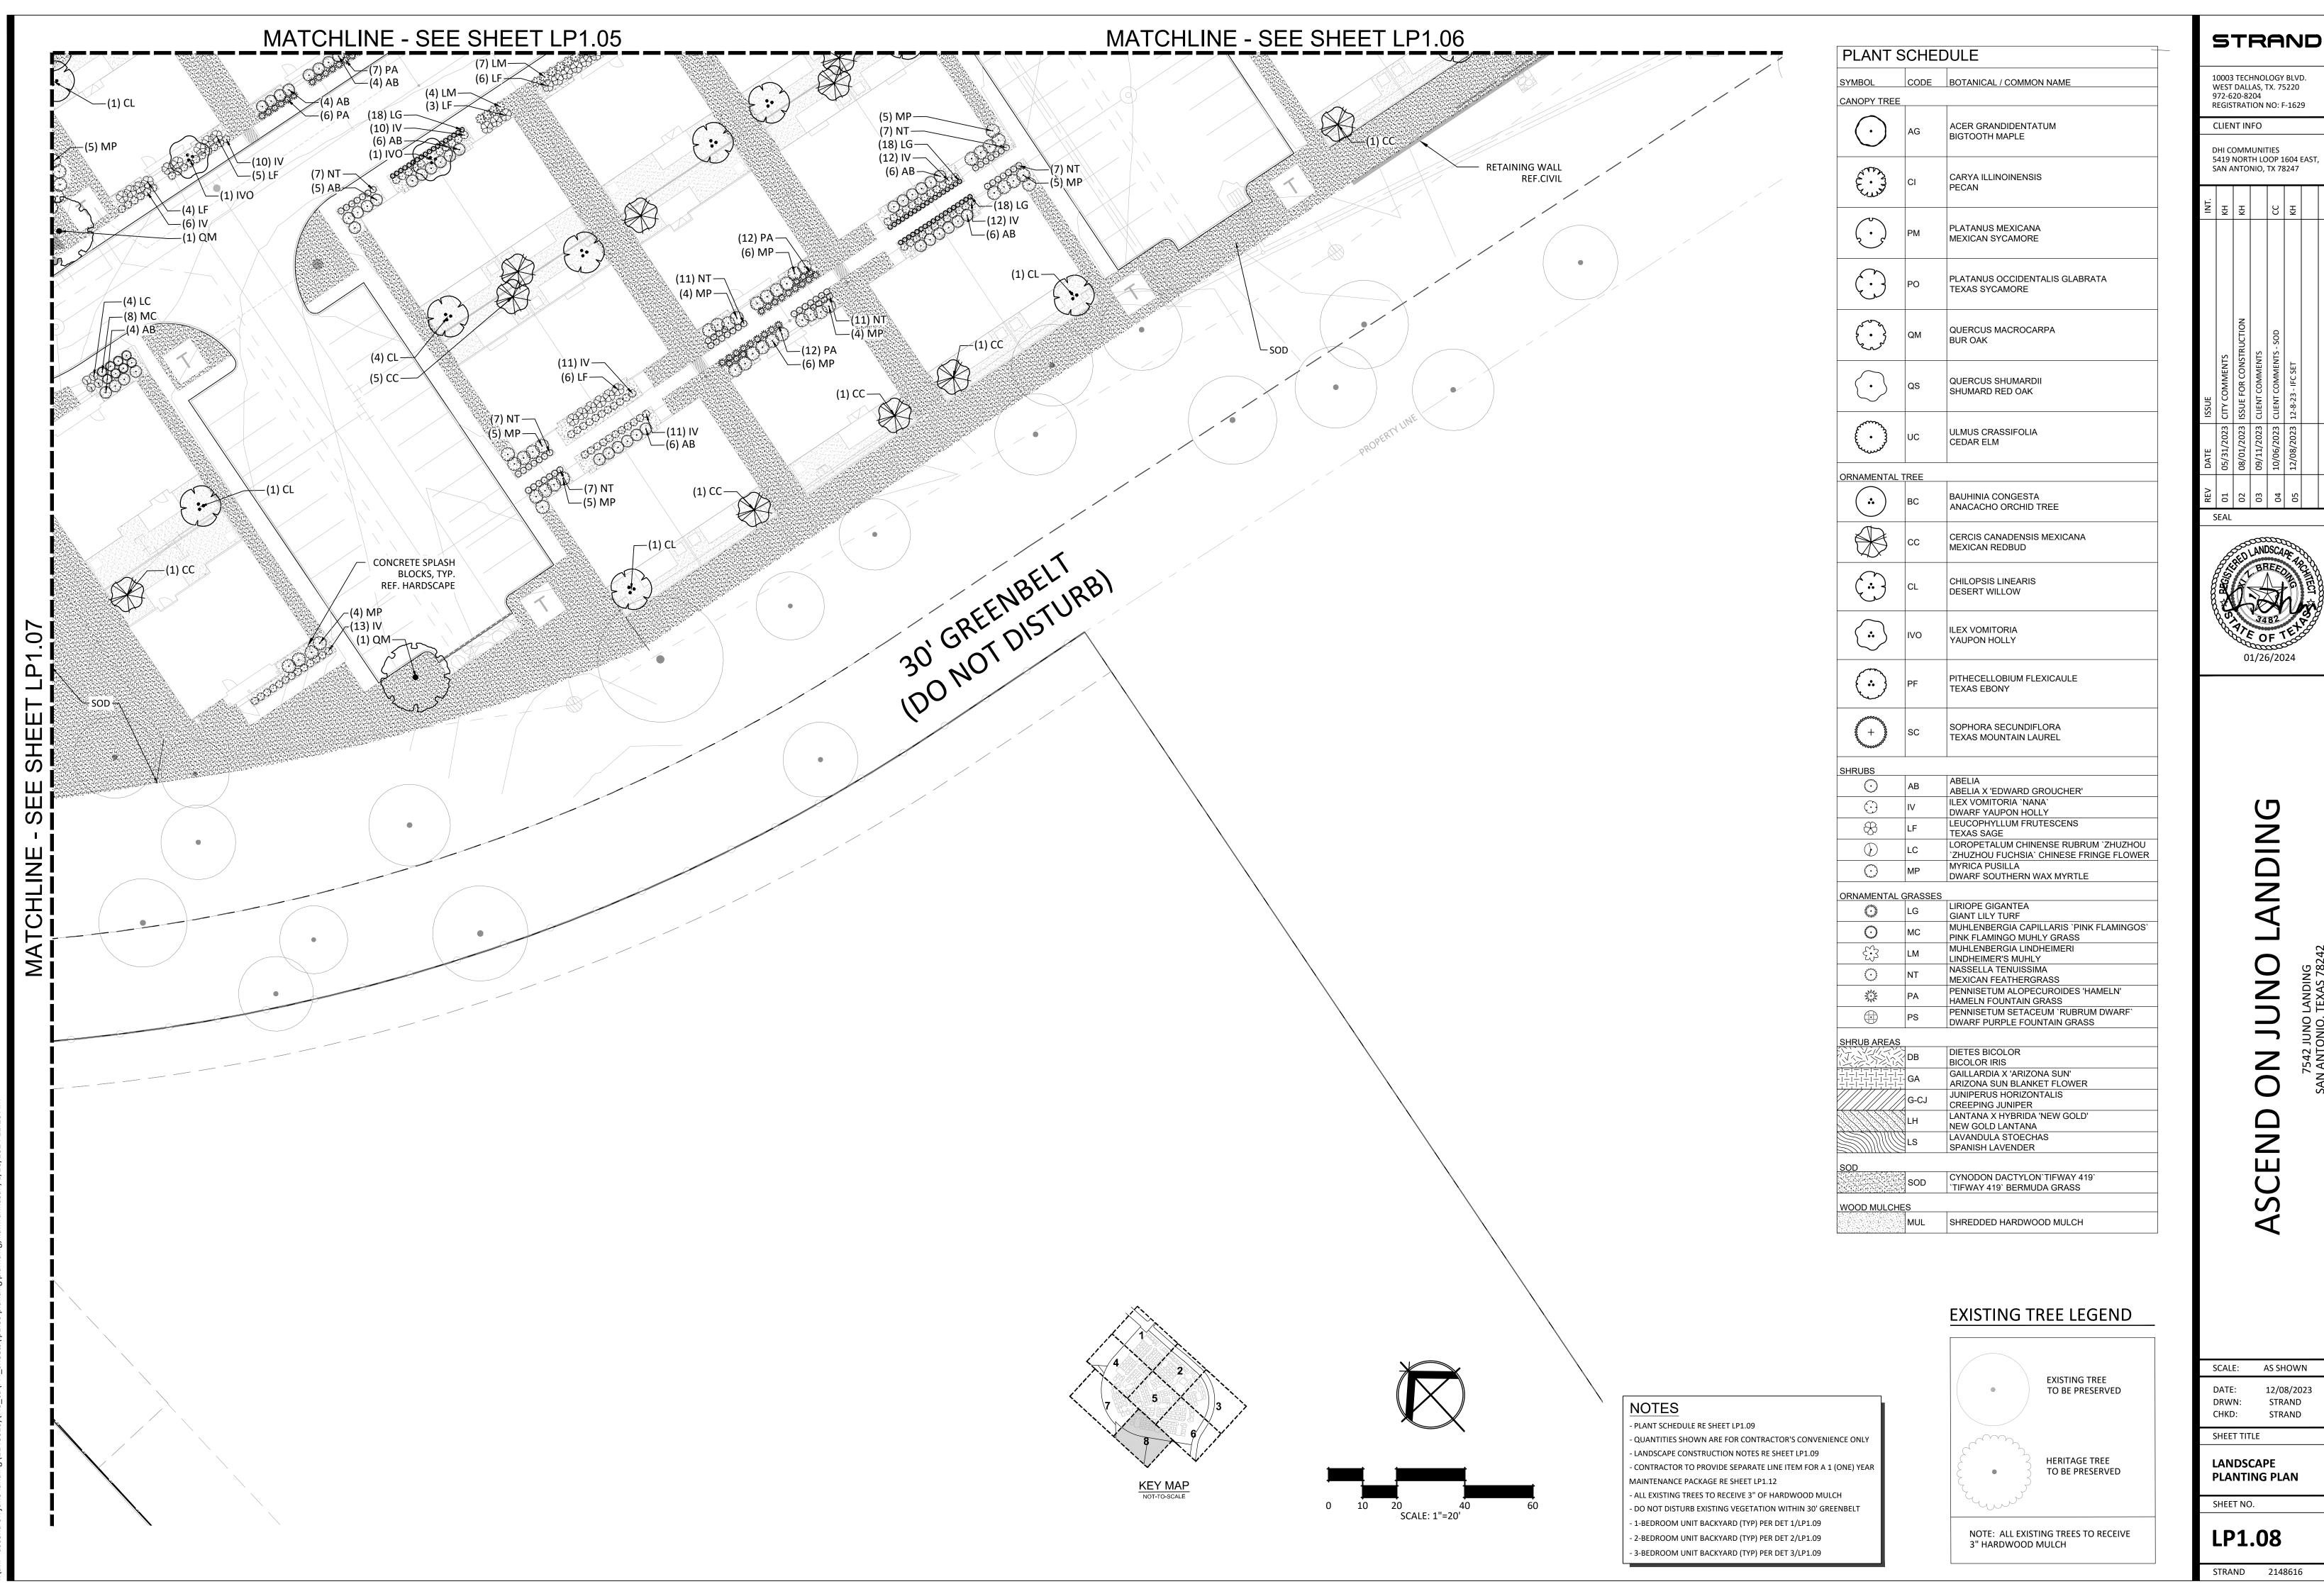

ALL TREES TO BE BID IN CALIPER INCHES. SINGLE TRUNK TREES SHALL BE MEASURED FROM 6 INCHES ABOVE GROUND AND MULTI-TRUNK TREES SHALL BE MEASURED FROM THE AVERAGE GRADE LEVEL OF THE IMMEDIATE PLANTING AREA.

2. CONTRACTOR TO PROVIDE BID ALTERNATE UNIT PRICES TO ALL TREES IN BARE ROOT, BALLED AND BURLAPPED (B&B), AND CONTAINER GROWN.

PLANT				0.55		0===	
SYMBOL	CODE	QTY	COMMON / BOTANICAL NAME	SIZE	HEIGHT	SPREAD	REMARKS
CANOPY TRI			RICTOOTH MADI E				
\bigcirc	AG	4	BIGTOOTH MAPLE ACER GRANDIDENTATUM	1.5" CAL.	8`-10`	4`-6`	BALL AND BURLAP, OR CONTAINER GROW
\(\frac{1}{2}\)	QM	38	BUR OAK QUERCUS MACROCARPA	1.5" CAL.	8`-10`	4`-6`	
£	UC	4	CEDAR ELM ULMUS CRASSIFOLIA	1.5" CAL.	8`-10`	4`-6`	
	РМ	29	MEXICAN SYCAMORE PLATANUS MEXICANA	1.5" CAL.	8`-10`	4`-6`	
E THE	CI	17	PECAN CARYA ILLINOINENSIS	1.5" CAL.	8`-10`	4`-6`	
\bigcirc	QS	38	SHUMARD RED OAK QUERCUS SHUMARDII	1.5" CAL.	8`-10`	4`-6`	
	РО	31	TEXAS SYCAMORE PLATANUS OCCIDENTALIS GLABRATA	1.5" CAL.	8`-10`	4`-6`	
ORNAMENT <i>I</i>	AL TREE					1	1
•	вс	24	ANACACHO ORCHID TREE BAUHINIA CONGESTA	1.5" CAL.	8`-10`	4`-6`	
	CL	123	DESERT WILLOW CHILOPSIS LINEARIS	1.5" CAL.	8`-10`	4`-6`	
	CC	121	MEXICAN REDBUD CERCIS CANADENSIS MEXICANA	1.5" CAL.	8`-10`	4`-6`	
	PF	33	TEXAS EBONY PITHECELLOBIUM FLEXICAULE	1.5" CAL.	8`-10`	4`-6`	
**************************************	sc	16	TEXAS MOUNTAIN LAUREL SOPHORA SECUNDIFLORA	1.5" CAL.	8`-10`	4`-6`	
	IVO	27	YAUPON HOLLY ILEX VOMITORIA	1.5" CAL.	8`-10`	4`-6`	
SHRUBS			`ZHUZHOU FUCHSIA` CHINESE FRINGE FLOWER				1
<u> </u>	LC	309	LOROPETALUM CHINENSE RUBRUM 'ZHUZHOU ABELIA X 'EDWARD GROUCHER'	3G			
£ • 33	AB	930	ABELIA	3G			
* * * * * * * * * * * * * * * * * * *	MP	790	DWARF SOUTHERN WAX MYRTLE MYRICA PUSILLA	5G			
	IV	746	DWARF YAUPON HOLLY ILEX VOMITORIA 'NANA'	3G			
	LF	543	TEXAS SAGE LEUCOPHYLLUM FRUTESCENS	5G			
DRNAMENTA	AL GRAS	SES					
	PS	163	DWARF PURPLE FOUNTAIN GRASS PENNISETUM SETACEUM 'RUBRUM DWARF'	1G			
	LG	842	GIANT LILY TURF LIRIOPE GIGANTEA	1G			
ZWZ	PA	698	HAMELN FOUNTAIN GRASS	3G	1		
M. S.	PA	090	PENNISETUM ALOPECUROIDES 'HAMELN' LINDHEIMER'S MUHLY	36	-		
	LM	206	MUHLENBERGIA LINDHEIMERI	3G			
,	NT	489	MEXICAN FEATHERGRASS NASSELLA TENUISSIMA	3G			
* WALLEY	МС	298	PINK FLAMINGO MUHLY GRASS MUHLENBERGIA CAPILLARIS 'PINK FLAMINGOS'	3G			
SHRUB AREA	AS	1		1			
_ _ _ - - - - - - - - - - - - -	GA	479	ARIZONA SUN BLANKET FLOWER GAILLARDIA X 'ARIZONA SUN'	1G			
	DB	73	BICOLOR IRIS DIETES BICOLOR	3G			
	G-CJ	112	CREEPING JUNIPER JUNIPERUS HORIZONTALIS	1G			
	LH	245	NEW GOLD LANTANA	1G			
DIMITE	LS	143	LANTANA X HYBRIDA 'NEW GOLD' SPANISH LAVENDER	1G			
SYMBOL	CODE	QTY	LAVANDULA STOECHAS COMMON / BOTANICAL NAME	-			REMARKS
	LOOPE		OSMAN DO ITANOME IMANE	ı		1	1
SOD							PLANT GRASS EDGE TO EDGE WITH
	SOD		`TIFWAY 419` BERMUDA GRASS CYNODON DACTYLON`TIFWAY 419`	-			STAGGERED JOINTS.TOPDRESS WITH SHAF SAND RANKED TO FILL JOINTS. ROLL TO ELIMINATE UNDULATIONS AND PROVIDE COMPLETE SOIL CONTACT.
WOOD MULC	HES	T					Т.
	мш	1.	SHREDDED HARDWOOD MULCH	1	1	1	INSTALL MULCH AT 3" DEPTH

SHREDDED HARDWOOD MULCH

GENERAL LANDSCAPE CONSTRUCTION NOTES

LANDSCAPE PLANTING NOTES

- 1. All proposed landscaping to be installed as per local city ordinances and codes.
- 2. Contractor shall be responsible for becoming aware of related existing conditions, utilities, pipes, and structures, etc. prior to building and construction. The contractor shall be held responsible for contracting all utility companies for field location of all underground utility lines, including depths, prior to any excavation. The contractor shall notify the Owner's Representative of apparent conflicts with construction and utilities so that adjustments can be planned prior to installation. Contractor shall take sole responsibility for any and all cost or other liabilities incurred due to damage of said utilities/structures/etc.
- 3. The contractor shall not willfully proceed with construction as designed when it is apparent that unknown obstructions and /or grade differences exist that may not have been known during design. Such conditions shall be immediately brought to the attention of the Owner's Representative for clarification. The Contractor shall assume full responsibility for all liabilities, including necessary revisions due to failure to give such notification.
- 4. Contractor shall be responsible for coordination with subcontractors and other contractors of related trades as required to accomplish the planting and replaced operations.
- 5. The acceptable tolerances for this project are minimal and specific layout is required as shown on the layout, planting and other plans. Final location and staking of all plant materials shall be accepted by the Owner's Representative in advance of plantings.
- 6. Coordinate installation of all plant material with installation or all adjacent irrigation, pavements, curb, and related structures Any damage to existing improvements is the responsibility of the
- 7. Contractor shall notify Owner's Representative 5 business days prior to commencement of work to coordinate project inspection schedules.
- 8. The Contractor shall take all necessary scheduling and other precautions to avoid climatic damage to plants. Preliminary approved planting dates include Spring time, March 20-June 20. Or Fall time September 22- December 21. A "planting" of specific calendar days is required to be submitted by the Contractor for approval and planting operations should occur per this approved schedule.
- 9. If conflicts arise between size of areas and plans, Contractor is required to contact Owner's Representative for resolution, Failure to make such conflicts known to the Owner's Representative will result in Contractor's liability to relocate the materials.
- 10.Plant names may be abbreviated on the drawings. See plant legend for symbols, abbreviations, botanical/common names, sizes, estimated quantities (if given) and other remarks.
- 11. Where provided, area takeoffs and plant quantity estimates in plant list are for information only. Contractor is responsible to do their own quantity Take-offs for all plant materials and sizes shown on plans. In case of any discrepancies, plans take precedence over call-outs and/or the plant list(s).
- 12.It is the Contractor's responsibility to furnish all plant materials free of pests or plant diseases Pre-selected or "tagged" material must be inspected by the Contractor and certified pest and disease free It is the Contractor's obligation to maintain and warranty all plant materials per the specifications. All plants shall be subject to Owner's approval prior to installation.
- 13. Contractor shall provide "per-unit costs" for every size of plant material, and by type, as called out on Planting Plans in the Bid Proposal. Unit cost to include the plant material itself and installation, including all labor, amendments, fertilizers, warranty, etc., as detailed and specified for each size,
- 14. The Contractor is responsible to restore all areas or the site, or adjacent areas, where disturbed by operations of or related to the Contractor's work. Sod areas disturbed shall be restored with new sod. Native areas disturbed, if not already improved to meet other requirements of this contract, shall be restored consistent with type, rates, and species of existing condition, or as
- 15. All plants shall be nursery grown, Grade I plants meeting American Nursery and Landscape Association (ANLA) standards set forth in the "American Standard for Nursery Stock" (ANSI Z60. l-200"1). Plants are to be typical in shape and size for species. Plants shall not be root-bound or loose in their containers Handle all plants with care in transporting, planting and maintenance until inspection and final acceptance. Plants shall be installed to present their best side facing the
- 16.Required landscape areas shall be maintained free of debris and litter. Required landscape material that dies shall be replaced at the minimum standard required by the city.
- 17. Contractor to provide separate line item for a one(1) year maintenance package. Warranty: Provide a one-year replacement warranty for all plant materials. Warranty shall cover plants which have died or partially died (thereby ruining their natural shape), but shall not include damage by hail, abnormal freezes, drought, or negligence by the Owner. The Warranty is intended to cover Contractor negligence, infestations, disease and damage or shock to planes. Plants replaced under Warranty will be warranted for one year following replacement
- 18. Container grown trees to be planted as specified in the specifications Section 329300. If specified, planting of b&b trees is allowed only from October 1st till march 31st. from April 1st till September 31.

ADDITIONAL NOTES:

INSTALL MULCH AT 3" DEPTH

- 1. QUANTITIES SHOWN ARE FOR CONTRACTOR'S CONVENIENCE ONLY. CONTRACTOR IS RESPONSIBLE FOR VERIFICATION OF ALL QUANTITIES.
- 2. CONTRACTOR TO PROVIDE SEPARATE LINE ITEM FOR A ONE(1) YEAR MAINTENANCE PACKAGE- SEE MAINTENANCE SPECIFICATION.
- 3. ALL EXISTING TREES TO RECEIVE 3" OF HARDWOOD MULCH.

PLANTING GRADING & PREPARATION NOTES


- 1. Contractor shall be responsible for finished grading of the project. The Contractor shall fine grade, rake and be responsible for positive drainage away from all structures and throughout site, with accurately set now lines. No low spots or ponding of surface water will be accepted in the final work. No rocks or debris will be accepted. Final grade tolerances are +/-0.1 foot maximum.
- 2. Prior to preparing Turf Sod, Turf Seed, and Plant Bed areas, eradicate all weeds, briars and vines with pose-emergent herbicide such as "Round-Up" applied by licensed personnel following manufacturers recommendations and caking all necessary precautions After weed eradication and removal and the specified waiting period apply 10 lb. of MicroLife Hummates Plus per 1,000 sq. ft. to restore soil health.
- 3. All topsoil areas shall be raked smooth, removing, and disposing of stones over 1" diameter and fine graded to feather into natural grade.
- 4. The Contractor shall excavate Plant Beds as required to accommodate a full 6" of prepared soil and 3" organic hardwood mulch or rock mulch layer. Clean, native topsoil removed from these beds may be spread on nearby areas to be Sodded or Seeded, Stones larger than 1" diameter shall be removed and disposed of off-site. Following excavation, place prepared soil in plant beds. Prepared planting soil shall consist of 4" topsoil (see specs) and 2" specified Soil Conditioner, thoroughly blended together. This mix shall also be used to backfill planting pits of all pit-planted shrubs and trees, In Bid Proposal furnish a unit price per cubic yard of Prepared Soil placed This unit price will be used in the adjustment or bed areas.

PLANTING LAYOUT & INSTALLATION NOTES

- 1. The Contractor shall be responsible for accurately laying out the planting beds and lawn areas by scaling the Drawings, The Contractor shall provide paint lines/stakes/hose or other means to fully indicate the specific layout geometry of all bed lines for approval by Owner's Representative prior to installation. The Contractor's Base Bid shall anticipate minor adjustments as directed by the Owner's Representative in the field Changes affecting quantities will be covered by unit prices.
- 2. Following the approval of layout, the Contractor shall closely coordinate the installation of the irrigation system to conform to the approved layout. If conflicts arise between landscape planting and landscape irrigation plans, Contractor is required to contact Owner's Representative for resolution. Failure to make such conflicts known to the Owner's Representative will result in Contractor's liability to relocate the materials.
- 3. Install edging following manufacture's installation instructions. Maintain an accurate layout with smooth curves and transitions, free of kinks and abrupt bends. Top of edging is to be 1" above soil level of adjacent turf. In Bid Proposal furnish a unite price per linear foot of edging installed. Bed edges where edging is not specified shall have a "spade edge".
- 4. Provide matching sizes and forms for all species of trees and plants installed on grid or spaced equally in rows as shown on drawings, Adjust spacing (to "equal-equal") as necessary, subject to acceptance by the Owner's Representative.

Unless otherwise indicated:

- a. All groupings of groundcover, perennials, ornamental grasses, and annuals shall be triangularly spaced (equal-equal).
- b. All planting areas including sod, seed and planting beds, shall receive soil amendments per the details, notes and specifications.
- c. Sodded lawn shall have been grown between 9 and 18 months and shall be vigorous, well-rooted and healthy turf. Minimum thatch thickness shall be 3/4 ".
- d. Specific plant bed areas may be called out to receive weed barrier fabric, see plans and details.
- 6. All Plant Beds and pit planted plants shall receive a layer of hardwood mulch or rock mulch as specified on the plans. Reference plans, planting & soil preparation details, and specifications for location and type of mulch used. In Bid Proposal furnish a unit price(s) per cubic yard of mulch(es) placed. This unit price(s) will be used in the adjustment of bed areas.
- 7. Plants shall be installed to present their best side facing the viewer.
- 5. Minimum 3' clear space around all fire hydrants.
- 6. Landscaping will be placed so as not to obstruct vehicular views of streets, drives, or parking
- 7. Owner's Representative shall have final approval of plant material layout.

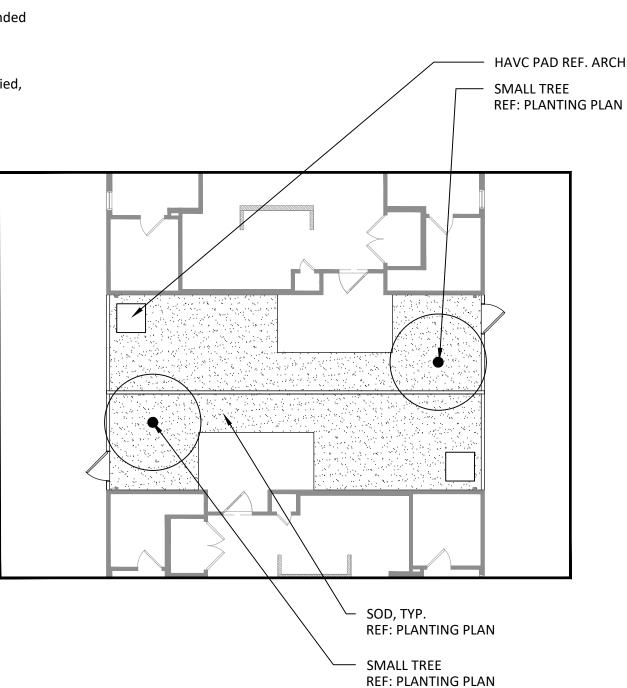

TYPICAL BACKYARD (2 BEDROOM UNIT)

HAVC PAD REF. ARCH SOD, TYP. REF: PLANTING PLAN SMALL TREE REF: PLANTING PLAN

SMALL TREE

SMALL TREE

REF: PLANTING PLAN

REF: PLANTING PLAN

TYPICAL BACKYARD (1 BEDROOM UNIT)

HAVC PAD REF. ARCH CONCRETE BLOCKS FOR DOWNSPOUT REF: HARDSCAPE PLAN SMALL TREE REF: PLANTING PLAN SOD, TYP. REF: PLANTING PLAN

TYPICAL BACKYARD (3 BEDROOM UNIT)

SMALL TREE

REF: PLANTING PLAN

STRAND


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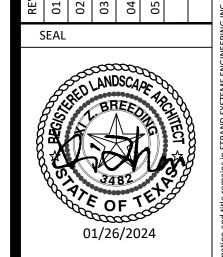
WEST DALLAS, TX. 75220 972-620-8204 REGISTRATION NO: F-1629

CLIENT INFO

DHI COMMUNITIES 5419 NORTH LOOP 1604 EAST, SAN ANTONIO, TX 78247

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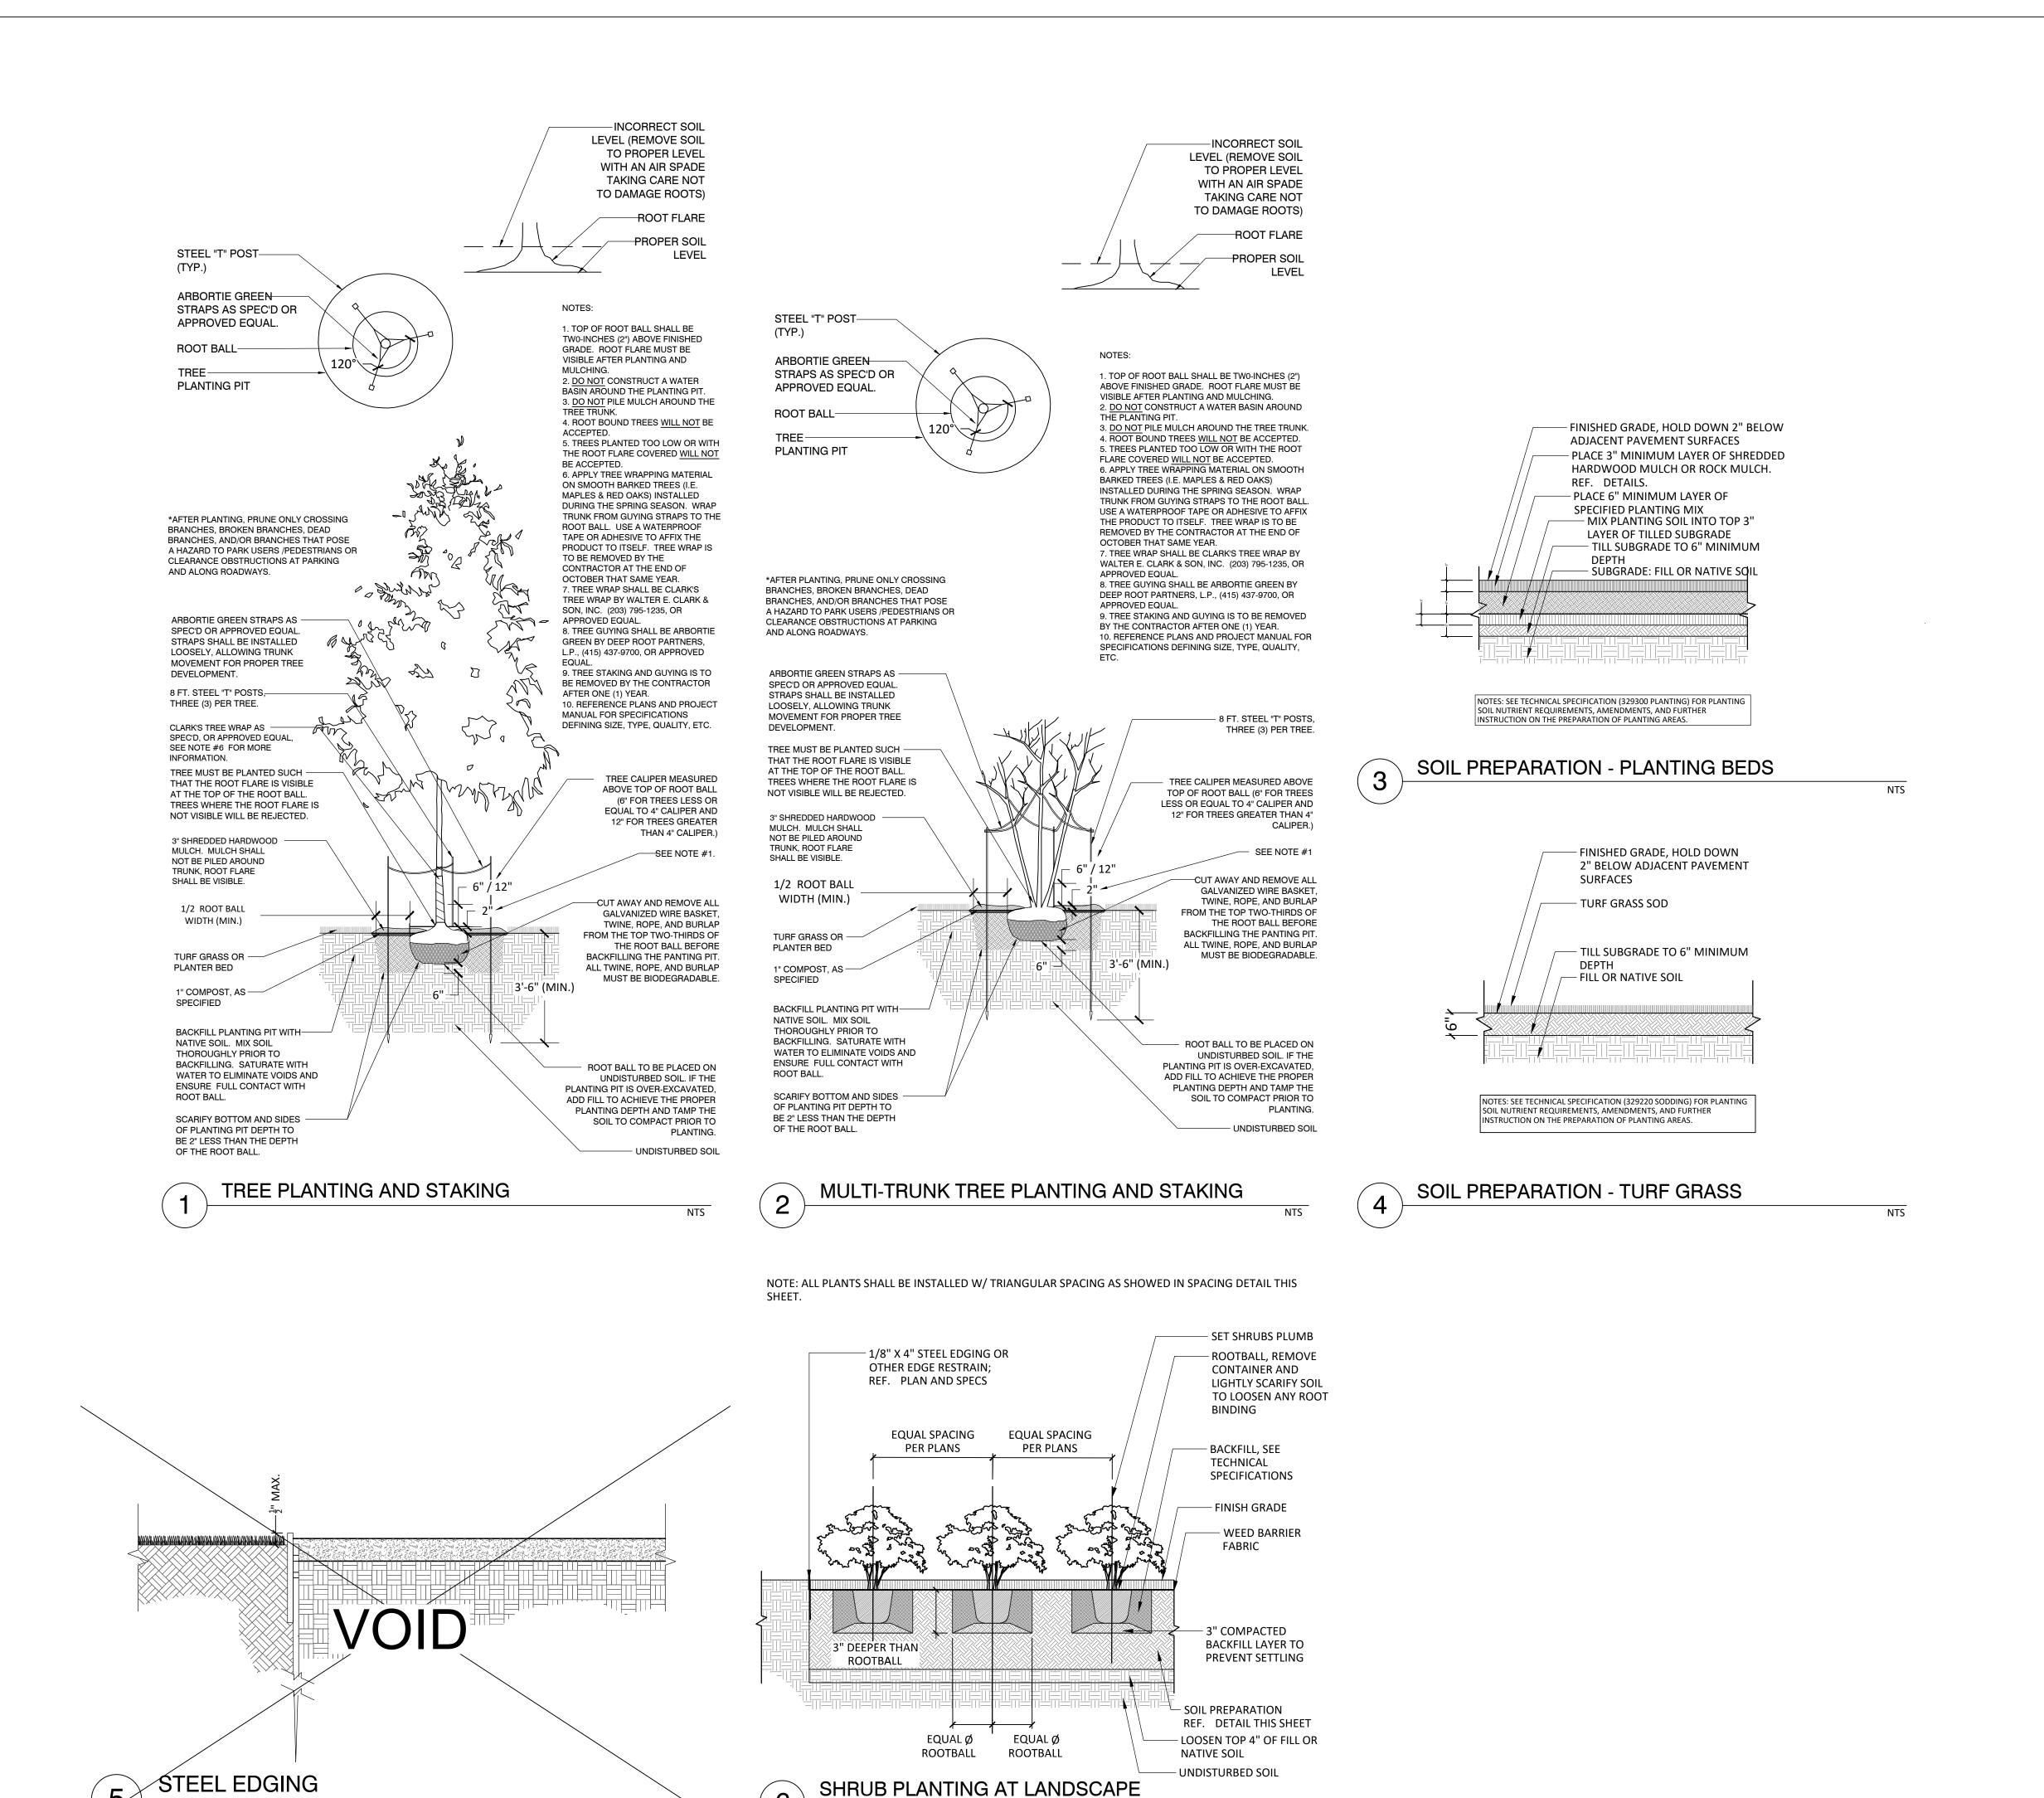
LANDSCAPE **PLANTING NOTES**

LP1.09
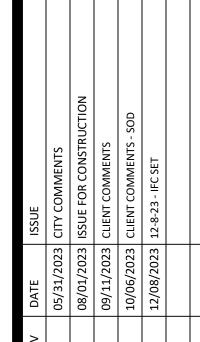
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WEST DALLAS, TX. 75220 972-620-8204 REGISTRATION NO: F-1629

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END ON JUNO LANDING

SCALE: AS SHOWN

DATE: 12/08/2023

DRWN: STRAND CHKD: STRAND

SHEET TITLE

LANDSCAPE PLANTING DETAILS

LP1.10

SHEET NO.

1.1 SUMMARY

- A. SECTION INCLUDES:
- SOD. FERTILIZATION.

1.2 DEFINITIONS

- A. RETAIN DEFINITION(S) REMAINING AFTER THIS SECTION HAS BEEN EDITED.
- B. FINISH GRADE: ELEVATION OF FINISHED SURFACE OF SOIL
- C. PESTICIDE: A SUBSTANCE OR MIXTURE INTENDED FOR PREVENTING, DESTROYING, REPELLING, OR MITIGATING A PEST. THIS INCLUDES INSECTICIDES, MITICIDES, HERBICIDES, FUNGICIDES, RODENTICIDES, AND MOLLUSCICIDES. IT ALSO INCLUDES SUBSTANCES OR MIXTURES INTENDED FOR USE AS A PLANT REGULATOR, DEFOLIANT, OR DESICCANT.
- D. PESTS: LIVING ORGANISMS THAT OCCUR WHERE THEY ARE NOT DESIRED OR THAT CAUSE DAMAGE TO PLANTS, ANIMALS, OR PEOPLE. THESE INCLUDE INSECTS, MITES, GRUBS, MOLLUSKS (SNAILS AND SLUGS), RODENTS (GOPHERS, MOLES, AND MICE), UNWANTED PLANTS (WEEDS), FUNGI. BACTERIA. AND VIRUSES.
- E. SUBGRADE: SURFACE OR ELEVATION OF SUBSOIL REMAINING AFTER EXCAVATION IS COMPLETE, OR TOP SURFACE OF A FILL OR BACKFILL BEFORE PLANTING SOIL IS PLACED.
- F. SUBSOIL: ALL SOIL BENEATH THE TOPSOIL LAYER OF THE SOIL PROFILE, AND TYPIFIED BY THE LACK OF ORGANIC MATTER AND SOIL ORGANISMS.

1.3 SUBMITTALS

- A. PRODUCT DATA: FOR EACH TYPE OF PRODUCT INDICATED.
- B. CERTIFICATION OF GRASS SOD.
 - SOD CERTIFICATION CERTIFICATION SHALL BE SUBMITTED FROM THE SOD NURSERY AS TO THE GRASS SPECIES, LOCATION OF THE FIELD FROM WHICH THE SOD HAS BEEN STRIPPED AND THE DATE OF STRIPPING. CERTIFICATION SHALL ACCOMPANY THE DELIVERY OF THE
- C. FERTILIZER CERTIFICATION: CERTIFICATION SHALL BE SUBMITTED FROM THE FERTILIZER MANUFACTURER AS TO THE CHEMICAL ANALYSIS OF THE FERTILIZER, A LISTING OF THE ELEMENTS CONTAINED THEREIN AND THEIR PERCENTAGES. CERTIFICATION SHALL ALSO INDICATE THAT THE FERTILIZER IS IN ACCORDANCE WITH THE REQUIREMENTS OF THE LOCAL AND STATE AUTHORITIES.

1.4 QUALITY ASSURANCE

- A. INSTALLER'S FIELD SUPERVISION: REQUIRE INSTALLER TO MAINTAIN AN EXPERIENCED FULL-TIME SUPERVISOR ON PROJECT SITE WHEN WORK IS IN PROGRESS.
- 1. PESTICIDE APPLICATOR: STATE LICENSED, COMMERCIAL.
- B. SOIL ANALYSIS: FOR EACH UNAMENDED SOIL TYPE, FURNISH SOIL ANALYSIS AND A WRITTEN REPORT BY A QUALIFIED SOIL-TESTING LABORATORY.
- 1. THE SOIL-TESTING LABORATORY SHALL OVERSEE SOIL SAMPLING.
- 2. REPORT SUITABILITY OF TESTED SOIL FOR TURF GROWTH.
 - a. STATE RECOMMENDATIONS FOR NITROGEN, PHOSPHORUS, AND POTASH NUTRIENTS AND SOIL AMENDMENTS TO BE ADDED TO PRODUCE SATISFACTORY PLANTING SOIL SUITABLE FOR HEALTHY, VIABLE PLANTS.
 - REPORT PRESENCE OF PROBLEM SALTS, MINERALS, OR HEAVY METALS; IF PRESENT, PROVIDE ADDITIONAL RECOMMENDATIONS FOR CORRECTIVE ACTION.

1.5 DELIVERY, STORAGE, AND HANDLING

- A. SOD DELIVERY SOD SHALL BE DELIVERED ON PALLETS WITH THE ROOT SYSTEM PROTECTED FROM EXPOSURE TO WIND AND SUN. STRIPPING AND DELIVERY SHALL BE TIMED SO THAT SOD WILL BE PLACED WITHIN 48 HOURS OF STRIPPING.
- B. FERTILIZER DELIVERY: FERTILIZER SHALL BE DELIVERED IN THE MANUFACTURER'S UNOPENED CONTAINERS, LABELED TO INDICATE THE MANUFACTURER'S NAME AND PRODUCT IDENTIFICATION. CONTAINERS SHALL BE STORED PROTECTED FROM GROUND CONTACT AND FROM THE ELEMENTS.

1.6 MAINTENANCE SERVICE

A. INITIAL TURF MAINTENANCE SERVICE: PROVIDE FULL MAINTENANCE BY SKILLED EMPLOYEES OF LANDSCAPE INSTALLER. MAINTAIN AS REQUIRED IN SECTION 329301. BEGIN MAINTENANCE IMMEDIATELY AFTER EACH AREA IS PLANTED AND CONTINUE UNTIL ACCEPTABLE TURF IS ESTABLISHED.

PART 2 - PRODUCTS

2.1 MATERIALS

- A. SOD SHALL BE NURSERY GROWN, TIFWAY 419 BERMUDA SOD HAVING A HEALTHY, VIRILE ROOT SYSTEM OF DENSE, THICKLY MATTED ROOTS THROUGHOUT THE SOIL OF THE SOD FOR A MINIMUM THICKNESS OF 1 INCH. SOD SHALL BE FREE OF NOXIOUS WEEDS AND UNDESIRABLE NATIVE GRASSES. SOIL ATTACHED TO THE SOD SHALL BE FREE OF STONES AND DEBRIS.
- B. SOD SHALL HAVE BEEN MOWED WITHIN 7 DAYS OF BEING STRIPPED. SOD SHALL BE PROVIDED IN RECTANGULAR PADS OF NOT LESS THAN 12 INCHES NOR MORE THAN 24 INCHES. DRY SOD WILL
- C. FERTILIZER: SHALL BE 13-13-13 GRADE, PELLETED, UNIFORM IN COMPOSITION, FREE-FLOWING, AND SUITABLE FOR APPLICATION WITH APPROVED EQUIPMENT. THE FERTILIZER SHALL BE DELIVERED TO THE SITE IN BAGS OR OTHER CONVENIENT CONTAINERS, EACH FULLY LABELED, CONFORMING TO THE APPLICABLE STATE FERTILIZER LAWS, AND BEARING THE NAME OR TRADEMARK AND WARRANTY OF THE PRODUCER.

PART 3 - EXECUTION

3.1 INSPECTIONS

A. SURFACES INDICATED TO RECEIVE SOD SHALL BE INSPECTED TO VERIFY THAT ALL PREPARATORY WORK IN THE AREA HAS BEEN COMPLETED. SOD INSTALLATION SHALL NOT START UNTIL ALL PREPARATORY WORK HAS BEEN COMPLETED. REQUESTS FOR INSPECTIONS SHALL BE MADE AT LEAST TWO DAYS PRIOR TO ANTICIPATED DATE OF INSPECTION.

3.2 PREPARATION

- A. STRIP EXISTING VEGETATION AND 1 INCH OF EXISTING SOIL FROM ALL AREAS TO RECEIVE SOD NOT STRIPPED AND GRADED UNDER PREVIOUS WORK.
- B. AFTER STRIPPING, LOOSEN SOIL TO A DEPTH OF 2 INCHES PRIOR TO LAYING SOD. BREAK UP COMPACTED SOIL. REMOVE ALL STONES, ROOTS, VEGETATION, RUBBISH, DEBRIS AND OTHER

- FOREIGN MATTER 1" IN DIAMETER OR LARGER FROM THE TOP 2" OF SOIL. NO FOREIGN MATTER MAY BE BURIED ON SITE.
- HAND RAKE TO ACHIEVE A UNIFORM LOOSE DEPTH TO 2 INCHES AND A SMOOTH, CONSISTENT GRADE IMMEDIATELY PRIOR TO LAYING SOD.
- D. FINISH GRADE TO BE 1" BELOW TOP OF ADJACENT HARDSCAPE.
- E. IMMEDIATELY PRIOR TO PLACING SOD, APPLY THE FERTILIZER AND LIGHTLY MOISTEN.

3.3 INSTALLATION

- A. ALL SOD SHALL BE CAREFULLY LAID IN PARALLEL ROWS IN A SMOOTH MANNER, ALTERNATING ALL SOD JOINTS. FIT SOD STRIPS TIGHTLY TOGETHER SO THAT NO JOINTS ARE VISIBLE AND TAMP FIRMLY. CUT PIECES OF SOD TO FILL ANY VOIDS LEFT.
- WATER SOD IMMEDIATELY AFTER PLANTING, SLOWLY BUT THOROUGHLY, TO SECURE AT LEAST SIX (6) INCHES PENETRATION INTO THE SOIL BELOW THE SOD. DO NOT ALLOW THE BLADES OF GRASS TO WILT. THE SODDED AREA SHALL BE THOROUGHLY ROLLED IN 2 DIRECTIONS TO FORM A THOROUGHLY EVEN, SOLID MAT. ANY VOIDS LEFT IN BLOCK SODDING SHALL BE FILLED WITH CUT SOD PIECES AND/OR TOPSOIL.
- C. FOLLOWING THE COMPLETION OF THE INSTALLATION, THE SOD SHALL BE WATERED IN AN AMOUNT AND AS OFTEN AS NECESSARY TO MAINTAIN HEALTHY GROWTH OF THE GRASS.
- D. TREAT ENTIRE AREAS OF SOD FOR FIRE ANTS DURING THE 60 DAY MAINTENANCE PERIOD AS PER MANUFACTURER'S INSTRUCTIONS AND SECTION 329300, PLANTS.
- APPLY SECOND APPLICATION OF FERTILIZER 60 DAYS AFTER PLANTING AS PER SECTION 329300,

3.4 MAINTENANCE OF SODDED AREAS

- A. SODDED AREA SHALL BE MAINTAINED IN GOOD CONDITION THROUGHOUT THE INSTALLATION PROCESS AND THROUGHOUT THE MAINTENANCE PERIOD AS SPECIFIED IN SECTION 329301, EXTERIOR LANDSCAPE MAINTENANCE.
- B. UPON COMPLETION OF WORK, CLEAN AREAS WITHIN CONTRACT LIMITS, REMOVE TOOLS, SUPPLIES AND EQUIPMENT. WASH DOWN CURBS AND PAVEMENT AREAS. SCRUB CURBS AND WALKS AS NECESSARY TO INSURE A CLEAN SURFACE. PROVIDE SITE CLEAN AND FREE OF MATERIALS AND SUITABLE FOR USE AS INTENDED.

3.5 GUARANTEE

- A. A WRITTEN GUARANTEE SHALL BE PROVIDED GUARANTEEING TO MAINTAIN THE TREATED AREAS IN A HEALTHY, VIGOROUS, UNDAMAGED CONDITION FOR A PERIOD OF 60 DAYS BEGINNING ON THE DATE OF WRITTEN ACCEPTANCE OF THE WORK.
- B. GUARANTEE SHALL PROVIDE FOR TIMELY FILLING, LEVELING AND REPAIRING ERODED AREAS, RESEEDING AREAS EXHIBITING LACK OF HEALTHY GROWTH AND MOWING AS NECESSARY TO MAINTAIN A NEAT APPEARANCE.

END OF SECTION 32 92 02

SECTION 32 93 00 PLANTS

PART 1 - GENERAL

1.1 SUMMARY

- A. SECTION INCLUDES:
- PLANTS. PLANTING SOILS.
- PLANT DRAINAGE.

1.2 DEFINITIONS

- A. BACKFILL: THE EARTH USED TO REPLACE OR THE ACT OF REPLACING EARTH IN AN EXCAVATION.
- B. FINISH GRADE: ELEVATION OF FINISHED SURFACE ADJACENT TO PLANTING BED.
- C. PREPARED BACKFILL MIX: SOIL PRODUCED OFF-SITE BY HOMOGENEOUSLY BLENDING MINERAL SOILS OR SAND WITH STABILIZED ORGANIC SOIL AMENDMENTS TO PRODUCE TOPSOIL OR PLANTING SOIL.
- D. PESTICIDE: A SUBSTANCE OR MIXTURE INTENDED FOR PREVENTING, DESTROYING, REPELLING, OR MITIGATING A PEST. THIS INCLUDES INSECTICIDES, MITICIDES, HERBICIDES, FUNGICIDES, RODENTICIDES, AND MOLLUSCICIDES. IT ALSO INCLUDES SUBSTANCES OR MIXTURES INTENDED FOR USE AS A PLANT REGULATOR, DEFOLIANT, OR DESICCANT.
- PESTS: LIVING ORGANISMS THAT OCCUR WHERE THEY ARE NOT DESIRED, OR THAT CAUSE DAMAGE TO PLANTS, ANIMALS, OR PEOPLE. THESE INCLUDE INSECTS, MITES, GRUBS, MOLLUSKS (SNAILS AND SLUGS), RODENTS (GOPHERS, MOLES, AND MICE), UNWANTED PLANTS (WEEDS), FUNGI, BACTERIA, AND VIRUSES.
- F. TOPSOIL: STANDARDIZED TOPSOIL; EXISTING, NATIVE SURFACE TOPSOIL; EXISTING, IN-PLACE SURFACE SOIL; IMPORTED TOPSOIL; OR MANUFACTURED TOPSOIL THAT IS MODIFIED WITH SOIL AMENDMENTS AND PERHAPS FERTILIZERS TO PRODUCE A SOIL MIXTURE BEST FOR PLANT GROWTH.
- G. ROOT FLARE: ALSO CALLED "TRUNK FLARE." THE AREA AT THE BASE OF THE PLANT'S STEM OR TRUNK WHERE THE STEM OR TRUNK BROADENS TO FORM ROOTS; THE AREA OF TRANSITION BETWEEN THE ROOT SYSTEM AND THE STEM OR TRUNK.
- H. SUBGRADE: SURFACE OR ELEVATION OF SUBSOIL REMAINING AFTER EXCAVATION IS COMPLETE, OR THE TOP SURFACE OF A FILL OR BACKFILL BEFORE PLANTING SOIL IS PLACED.
- SUBSOIL: ALL SOIL BENEATH THE TOPSOIL LAYER OF THE SOIL PROFILE, AND TYPIFIED BY THE LACK OF ORGANIC MATTER AND SOIL ORGANISMS.

1.3 SUBMITTALS

- A. WORK SCHEDULE: CONTRACTOR SHALL SUBMIT A WORK SCHEDULE FOR ALL PLANTING WORK PRIOR TO PURCHASE AND INSTALLATION OF PLANT MATERIAL.
- B. PRODUCT DATA: FOR EACH TYPE OF PRODUCT INDICATED, INCLUDING SOILS.
- C. SAMPLES OF BACKFILL MIX.
- D. SAMPLES OF MULCH.
- E. PRODUCT CERTIFICATES.
- F. MAINTENANCE INSTRUCTIONS: RECOMMENDED PROCEDURES TO BE ESTABLISHED BY OWNER FOR MAINTENANCE OF PLANTS DURING A CALENDAR YEAR. INCLUDING MANUFACTURER'S RECOMMENDATIONS AND INSTRUCTIONS RECOMMENDING PROCEDURES TO BE ESTABLISHED BY OWNER FOR MAINTENANCE OF PLANTING WORK. SUBMIT INSTRUCTIONS PRIOR TO EXPIRATION OF CONTRACTOR'S REQUIRED MAINTENANCE PERIOD.

1.4 QUALITY ASSURANCE

A. INSTALLER: INSTALLATION OF PLANTING WORK SHALL BE PERFORMED BY A SINGLE FIRM

SPECIALIZING IN LANDSCAPE AND PLANTING WORK. CONTRACTOR SHALL BE LICENSED BY THE TEXAS ASSOCIATION OF NURSERYMEN, SHALL POSSESS AN AGRICULTURAL CERTIFICATE, SHALL BE A LICENSED PEST APPLICATOR, AND SHALL HAVE NOT LESS THAN 5 YEARS OF EXPERIENCE IN THIS TYPE OF WORK.

- B. INSTALLER'S FIELD SUPERVISION: REQUIRE INSTALLER TO MAINTAIN AN EXPERIENCED FULL-TIME SUPERVISOR ON PROJECT SITE WHEN WORK IS IN PROGRESS.
- PESTICIDE APPLICATOR: STATE LICENSED, COMMERCIAL.
- C. PROVIDE QUALITY, SIZE, GENUS, SPECIES, AND VARIETY OF PLANTS INDICATED, COMPLYING WITH APPLICABLE REQUIREMENTS IN ANSI Z60.1. PROVIDE HEALTHY, VIGOROUS STOCK, GROWN IN RECOGNIZED NURSERY IN ACCORDANCE WITH GOOD HORTICULTURAL PRACTICE AND FREE OF DISEASE, INSECTS, EGGS, LARVAE AND DEFECTS SUCH AS KNOTS, SUN-SCALD, INJURIES, ABRASIONS OR DISFIGUREMENT.

D. DELIVERY, STORAGE AND HANDLING

- 1. COMPLIANCE: SHIP PLANTING MATERIALS WITH CERTIFICATES OF INSPECTION AS REQUIRED BY GOVERNING AUTHORITIES. COMPLY WITH ALL APPLICABLE LOCAL, STATE, AND FEDERAL REQUIREMENTS REGARDING MATERIALS, METHODS OF WORK, AND DISPOSAL OF EXCESS AND WASTE MATERIALS.
- 2. SUBSTITUTIONS: DO NOT MAKE SUBSTITUTIONS UNLESS APPROVED IN WRITING BY OWNER'S REPRESENTATIVE. IF SPECIFIED PLANTING MATERIAL IS NOT OBTAINABLE, SUBMIT PROOF OF NON-AVAILABILITY TO OWNER'S REPRESENTATIVE TOGETHER WITH PROPOSAL FOR USE OF EQUIVALENT MATERIAL. CONTRACTOR SHALL SUBMIT PROPOSAL IN A TIMELY MANNER AS TO NOT IMPACT PROJECT COMPLETION OR INSTALLATION OF OTHER WORK.
- 3. ANALYSIS AND STANDARDS: ALL PACKAGED PRODUCTS SHALL BE DELIVERED IN ORIGINAL MANUFACTURER'S SEALED CONTAINERS. FOR UNPACKAGED MATERIALS, SUBMIT ANALYSIS BY RECOGNIZED LABORATORY MADE IN ACCORDANCE WITH METHODS ESTABLISHED BY THE ASSOCIATION OF OFFICIAL AGRICULTURE CHEMISTS, WHEREVER APPLICABLE.
- 4. INSPECTION: NOTIFY OWNER'S REPRESENTATIVE AT LEAST 2 WEEKS PRIOR TO INSTALLATION, OF LOCATION WHERE MATERIALS THAT HAVE BEEN SELECTED FOR PLANTING MAY BE INSPECTED, EITHER AT PLACE OF GROWTH OR THE SITE PRIOR TO PLANTING. PLANT MATERIAL WILL BE INSPECTED FOR COMPLIANCE WITH REQUIREMENTS FOR GENUS, SPECIES, VARIETY, SIZE AND QUALITY. OWNER'S REPRESENTATIVE RETAINS RIGHT TO FURTHER INSPECT TREES FOR SIZE AND CONDITIONS OF BALLS AND ROOT SYSTEMS, INSECTS, INJURIES AND LATENT DEFECTS, AND TO REJECT UNSATISFACTORY OR DEFECTIVE MATERIAL AT ANY TIME DURING PROGRESS OF WORK. CONTRACTOR SHALL REMOVE REJECTED TREES IMMEDIATELY FROM SITE AND REPLACE WITH SPECIFIED MATERIALS. PLANT MATERIAL NOT INSTALLED IN ACCORDANCE WITH CONTRACT DOCUMENTS WILL BE REJECTED.

1.5 WARRANTY

- A. SPECIAL WARRANTY: INSTALLER AGREES TO REPAIR OR REPLACE PLANTINGS AND ACCESSORIES THAT FAIL IN MATERIALS, WORKMANSHIP, OR GROWTH WITHIN SPECIFIED WARRANTY PERIOD.
- 1. FAILURES INCLUDE, BUT ARE NOT LIMITED TO, THE FOLLOWING:
 - a. DEATH AND UNSATISFACTORY GROWTH, EXCEPT FOR DEFECTS RESULTING FROM ABUSE, LACK OF ADEQUATE MAINTENANCE, OR NEGLECT BY OWNER, OR INCIDENTS THAT ARE BEYOND CONTRACTOR'S CONTROL.
 - b. STRUCTURAL FAILURES INCLUDING PLANTINGS FALLING OR BLOWING OVER.
- 2. WARRANTY PLAN MATERIALS TO BE IN HEALTHY, VIGOROUS AND ATTRACTIVE GROWING CONDITION FOR PERIOD OF 1 YEAR AFTER FINAL ACCEPTANCE:
 - a. TREES, SHRUBS, VINES, AND ORNAMENTAL GRASSES: 12 MONTHS.
 - b. GROUND COVERS, BIENNIALS, PERENNIALS, AND OTHER PLANTS: 12 MONTHS.
- c. ANNUALS: 12 MONTHS.
- REMOVE AND REPLACE TREES, SHRUBS AND GROUNDCOVER FOUND TO BE DEAD OR IN UNHEALTHY CONDITION DURING WARRANTY PERIOD. REPLACE TREES, SHRUBS AND GROUNDCOVER WHICH ARE IN DOUBTFUL CONDITION AT END OF WARRANTY PERIOD. HOWEVER, IF IN THE OPINION OF OWNER, SUCH DOUBTFUL MATERIAL MAY SURVIVE, CONTRACTOR SHALL EXTEND THE WARRANTY PERIOD FOR A FULL GROWING SEASON. OWNER WILL DETERMINE WHICH ITEMS ARE IN DOUBTFUL CONDITION.

1.6 MAINTENANCE SERVICE

- A. INITIAL MAINTENANCE SERVICE: PROVIDE MAINTENANCE BY SKILLED EMPLOYEES OF LANDSCAPE INSTALLER. BEGIN MAINTENANCE IMMEDIATELY AFTER PLANTS ARE INSTALLED THROUGHOUT THE MAINTENANCE PERIOD. SEE SECTION 329301 - EXTERIOR LANDSCAPE MAINTENANCE.
- 1. REVISE MINIMUM MAINTENANCE PERIOD IN SUBPARAGRAPHS BELOW TO SUIT PROJECT.
- 2. MAINTENANCE PERIOD FOR TREES AND SHRUBS: 12 MONTHS FROM DATE OF FINAL ACCEPTANCE.
- 3. MAINTENANCE PERIOD FOR GROUND COVER AND OTHER PLANTS: 12 MONTHS FROM DATE OF FINAL ACCEPTANCE.
- 4. MAINTENANCE PERIOD FOR NEW LAWNS: 12 MONTHS FROM DATE OF FINAL ACCEPTANCE.

1.7 JOB CONDITIONS

- WORK SCHEDULING: PROCEED WITH AND COMPLETE PLANTING WORK IN A TIMELY MANNER, WORKING WITHIN SEASONAL LIMITATIONS FOR EACH KIND OF PLANTING WORK REQUIRED.
- 1. CORRELATE PLANTING WITH SPECIFIED MAINTENANCE PERIODS TO PROVIDE MAINTENANCE FROM DATE OF SUBSTANTIAL COMPLETION.
- PLANT FROST-TENDER TREES ONLY AFTER DANGER OF FROST IS PAST OR SUFFICIENTLY BEFORE FROST SEASON TO ALLOW FOR ESTABLISHMENT BEFORE FIRST FROST. DO NOT PLANT IN FROZEN GROUND.
- 3. PLANT TREES, SHRUBS AND GROUNDCOVER AFTER FINAL GRADES ARE ESTABLISHED AND PRIOR TO PLANTING OF LAWNS, UNLESS OTHERWISE DIRECTED BY OWNER'S REPRESENTATIVE IN WRITING. IF PLANTING OCCURS AFTER LAWN WORK, PROTECT LAWN AREAS AND PROMPTLY REPAIR DAMAGE TO LAWNS RESULTING FROM PLANTING OPERATIONS.
- C. UTILITIES: REFER TO DRAWINGS AND COORDINATE WITH UTILITY CONTRACTOR FOR LOCATION OF UTILITIES. CONTRACTOR SHALL BE RESPONSIBLE FOR DAMAGE TO EXISTING UTILITIES AND
- D. SECURITY: THE OWNER WILL NOT ASSUME ANY RESPONSIBILITY FOR SECURITY OF ANY MATERIALS, EQUIPMENT, ETC. DURING CONSTRUCTION OF THE PROJECT UNTIL PROJECT
- E. EXCAVATION: WHEN CONDITIONS DETRIMENTAL TO PLANT GROWTH ARE ENCOUNTERED, SUCH AS RUBBLE FILL, ADVERSE DRAINAGE CONDITIONS BEYOND THE SCOPE OF THIS CONTRACT, OR OBSTRUCTIONS, NOTIFY OWNER'S REPRESENTATIVE OF SUCH CONDITIONS, IMMEDIATELY AND BEFORE PLANTING.
- F. POLLUTION CONTROL: CONTROL DUST CAUSED BY PLANTING OPERATIONS. DAMPEN SURFACES AS NECESSARY. COMPLY WITH POLLUTION CONTROL REGULATIONS OF GOVERNING **AUTHORITIES.**

PART 2 - PRODUCTS

2.1 PLANT MATERIAL

A. GENERAL: FURNISH NURSERY-GROWN PLANTS TRUE TO GENUS, SPECIES, VARIETY, CULTIVAR, STEM FORM, SHEARING, AND OTHER FEATURES INDICATED IN PLANT SCHEDULE OR PLANT LEGEND SHOWN ON DRAWINGS AND COMPLYING WITH ANSI Z60.1; AND WITH HEALTHY ROOT SYSTEMS DEVELOPED BY TRANSPLANTING OR ROOT PRUNING. PROVIDE WELL-SHAPED, FULLY BRANCHED, HEALTHY, VIGOROUS STOCK, DENSELY FOLIATED WHEN IN LEAF AND FREE OF DISEASE, PESTS, EGGS, LARVAE, AND DEFECTS SUCH AS KNOTS, SUN SCALD, INJURIES, ABRASIONS, AND DISFIGUREMENT.

2.2 FERTILIZERS

- A. FERTILIZER FOR PLANTING AREAS SHALL BE GRANULAR FERTILIZER SHALL BE A COMMERCIAL FERTILIZER, UNIFORM IN COMPOSITION, FREE FLOWING, AND SUITABLE FOR APPLICATION WITH APPROVED EQUIPMENT. FERTILIZER WHICH HAS BEEN EXPOSED TO HIGH HUMIDITY AND MOISTURE, HAS BECOME CAKED OR OTHERWISE DAMAGED MAKING IT UNSUITABLE FOR USE, WILL NOT BE ACCEPTABLE. CONTRACTOR TO SUBMIT FOR REVIEW BEFORE INSTALLATION.
- B. PLANT TABLET SHALL BE AGRIFORM 20-10-5 PLANTING TABLETS SHALL BE EVENLY PLACED IN

PLANTING PITS AT THE FOLLOWING RATE: MATERIAL NO. OF TABLETS 1 GALLON/4" POTS 1/2 (OR GRANULAR FERTILIZER) 5 GALLON 15 GALLON

GREATER THAN 30 GALLON 1 - FOR EACH ½ INCH C. ADDITIONAL MICROLIFE ULTIMATE FERTILIZER SHALL BE EVENLY DISPERSED THROUGH SOIL IN

> MATERIAL NO. OF OUNCES PER PLANTING PIT 30 GALLON

D. TREE INOCULENT: RHIZANOVA MYCORRHIZAL INOCULANT AS SUPPLIED BY SAN JACINTO LANDSCAPE SUPPLY, HOUSTON, TX, SHALL BE APPLIED TO ALL TREES AND PLANT MATERIALS 65 GAL. AND LARGER AT THE RATE OF ONE 3 OZ. DRY PACK PER CALIPER INCH.

2.3 PLANTING SOILS

30 GALLON

65 GALLON

PLANTING PITS AT THE FOLLOWING RATE:

- A. PREPARED BACKFILL MIX: SHALL BE 33% TOPSOIL, 33% SHARP SAND, AND 33% ENRICHED BARK MULCH OR APPROVED COMMERCIALLY AVAILABLE SOIL MIX. ADD FERTILIZER AS PER SPECIFICATIONS. OR GARDEN & FLOWERBED MIX AS SUPPLIED BY NATURE'S WAY RESOURCES, CONROE, TX 936-321-6990, OR APPROVED EQUAL.
- B. COMPOST FOR BED PREP/SOIL BACKFILL MIX SHALL BE LEAF MOLD COMPOST AS SUPPLIED BY NATURE'S WAY RESOURCES, INC., CONROE, TEXAS OR APPROVED EQUAL. COMPOST SHALL BE AND ORGANIC COMPOST FREE FROM DELETERIOUS MATERIALS, 100% COMPOSTED VEGETATIVE MATERIAL AND HORSE. COMPOST MUST BE MADE FROM ORGANIC MATERIALS APPROVED BY THE STATE OF TEXAS AS SPECIFIED IN CHAPTER 332 OF THE HEALTH & SAFETY CODE AS LISTED IN THE TEXAS REGISTER. COMPOST MUST CONTAIN LESS THAN 1% BY DRY WEIGHT OF INERT CONTAMINANTS SUCH AS GLASS, PLASTIC, ROCKS, ETC. INDUSTRIAL OR HAZARDOUS WASTE CAN NOT BE USED IN THE PRODUCTION OF THE COMPOST (I.E. BOILER ASH, RICE HULL ASH, ETC.). COMPOST SHALL BE FREE OF FILLERS SUCH AS RICE HULLS OR PINE BARK. COMPOST SHALL NOT EXCEED THE HEAVY METAL LIMITS AS SPECIFIED IN THE US EPA PART 503 REGULATIONS.
- CONTRACTOR SHALL FURNISH COPIES OF MANUFACTURER'S LITERATURE, CERTIFICATIONS, SOURCES, SAMPLES, OR LABORATORY ANALYTICAL DATA FOR THE FOLLOWING ITEMS: CERTIFICATES OF INSPECTION REQUIRED FOR TRANSPORTATION SHALL ACCOMPANY EACH SHIPMENT OF MATERIALS. PROVIDE CERTIFICATES TO OWNER'S REPRESENTATIVE.

- a. CHEMICAL AND PHYSICAL ALL COMPOST COMPONENTS SHALL BE TESTED BY THE
- FOLLOWING TESTING LABORATORIES FOR CONFORMITY TO THE SPECIFICATIONS: b. TEXAS PLANT AND SOIL LAB, 5115 WEST MONTE CRISTO, EDINBURG, TEXAS 78539, (956) 383-0739; A&L PLAINS AGRICULTURAL LABORATORIES, INC., 302 34TH STREET, LUBBOCK, TEXAS 79404, (806) 763-4278; SOIL AND PLANT LABORATORY, INCORPORATED, POST OFFICE BOX 153, SANTA CLARA, CALIFORNIA 95052,
- c. BIOLOGICAL: SOIL FOOD WEB. 1128 NE 2ND STREET, SUITE 120, CORVALLIS, OREGON 97330, (541) 752-5066.
- d. IF HERBICIDE CONTAMINATION IS SUSPECTED, THEN A RADISH/RYE-GRASS GROWTH TRIAL MUST BE PERFORMED. FOR DELIVERED MATERIAL, TEST ONE GRAB SAMPLE FOR EACH FIFTY (50) CUBIC YARDS OF BULK MATERIAL DELIVERED TO THE SITE. TESTING WILL BE AT THE EXPENSE OF CONTRACTOR. DEVIATIONS GREATER THAN PLUS OR MINUS TWENTY (20%) PERCENT FROM CONTROL DATA MAY BE GROUNDS FOR REJECTION OF MIXES TESTED. NON-CONFORMING MATERIALS SHALL NOT BE USED AND SHALL BE REMOVED FROM THE SITE.
- a. SPECIFICATIONS: STABILITY/MATURITY (CARBON DIOXIDE EVOLUTION RATE) SHALL BE LESS THAN 8 MG CO2-C PER G OM (ORGANIC MATTER) PER DAY AND GREATER THAN 6.0 ON THE SOLVITATM COMPOST MATURITY TEST.
- b. BIOLOGICAL COMPONENTS: BACTERIA (ACTIVE) - MINIMUM OF 15-25 MICROGRAMS PER GRAM OF COMPOST;

3. BIOLOGICAL, PHYSICAL AND CHEMICAL SPECIFICATIONS:

NEMATODES ARE A BENEFIT)

- BACTERIA (TOTAL) MINIMUM OF 150 MICROGRAMS PER GRAM OF COMPOST; FUNGUS (ACTIVE) - MINIMUM OF 15-25 MICROGRAMS PER GRAM OF COMPOST; FUNGUS (TOTAL) - MINIMUM OF 150 MICROGRAMS PER GRAM OF COMPOST; FUNGUS (HYPHAL DIAMETER) - SHOULD BE GREATER THAN 1 MM; PROTOZOA: FLAGELLATES - 8,000 OR HIGHER PER GRAM OF COMPOST; AMOEBAE - 8,000 OR HIGHER PER GRAM OF COMPOST; CILIATES - 50-100 OR HIGHER PER GRAM OF COMPOST; ROOT FEEDING NEMATODES SHOULD NOT BE PRESENT (BENEFICIAL
- 4. PHYSICAL SPECIFICATIONS: MOISTURE CONTENT 30-60%, WET WEIGHT BASIS; MOISTURE HOLDING CAPACITY - 75-200% OF DRY WEIGHT; ORGANIC MATTER CONTENT - 30-70% (40-50% PREFERRED), DRY WEIGHT BASIS; PARTICLE SIZE: STANDARD GRADE COMPOST -100% PASSING THROUGH A 1" RECTANGULAR MESH SCREEN OR SMALLER; FINE GRADE COMPOST - 100% PASSING THROUGH A 3/8" RECTANGULAR MESH SCREEN OR SMALLER; BULK DENSITY - 700-1,200 (800-1,000 PREFERRED), POUNDS PER CUBIC YARD; ELECTRICAL CONDUCTIVITY (SOLUBLE SALT CONCENTRATION) -10 DS/M MAX., (2.0-3.6 OR LESS PREFERRED).
- 5. CHEMICAL SPECIFICATIONS: PH 6.0-8.5; TOTAL SALINITY-2,000 PPM OR LOWER; CHEMICAL COMPONENTS (H2O EXTRACTION): NITROGEN-10 PPM OR HIGHER, PHOSPHORUS-100 PPM OR HIGHER, POTASSIUM- 400 PPM OR HIGHER, CALCIUM-2000 PPM OR HIGHER, MAGNESIUM-200 PPM OR HIGHER, ZINC-6 PPM OR HIGHER, IRON-25 PPM OR HIGHER, MANGANESE - 8 PPM OR HIGHER, COPPER-1 PPM OR HIGHER, SODIUM-1000 PPM OR LESS, SULFUR-10 PPM OR HIGHER BORON-1 PPM OR HIGHER.

STRAND

10003 TECHNOLOGY BLVD. WEST DALLAS, TX. 75220 972-620-8204

REGISTRATION NO: F-1629 CLIENT INFO

DHI COMMUNITIES 5419 NORTH LOOP 1604 EAST,

SAN ANTONIO, TX 78247



SCALE: AS SHOWN

12/08/2023

DRWN: STRAND CHKD: STRAND SHEET TITLE

DATE:

LANDSCAPE PLANTING **SPECIFICATIONS** SHEET NO.

STRAND 2148616

LP1.11

- 1. PROVIDE TOPSOIL, WHICH IS FERTILE, FRIABLE, NATURAL LOAM, SURFACE SOIL, FREE OF SUBSOIL, CLAY LUMPS, BRUSH, WEEDS AND OTHER LITTER, AND FREE OF ROOTS, STUMPS, STONES LARGER THAN 2 INCHES IN ANY DIMENSION AND OTHER EXTRANEOUS OR TOXIC MATTER HARMFUL TO PLANT GROWTH.
- 2. OBTAIN TOPSOIL ONLY FROM NATURALLY, WELL-DRAINED SITES WHERE TOPSOIL OCCURS IN A DEPTH OF NOT LESS THAN 4 INCHES. TOPSOIL SHALL NOT BE COLLECTED FROM SITES THAT ARE INFECTED WITH GROWTH OF, OR THE REPRODUCTIVE PARTS OF NOXIOUS WEEDS, ESPECIALLY NUT GRASS. TOPSOIL SHALL NOT BE STRIPPED, COLLECTED OR DEPOSITED WHILE WET. TOPSOIL SHALL NOT BE EXCESSIVELY ACID OR ALKALINE OR CONTAIN TOXIC SUBSTANCES WHICH MAY BE HARMFUL TO PLANT GROWTH. TOPSOIL SHALL BE WITHOUT ADMIXTURE OF SUBSOIL.
- D. COMPOST MULCH FOR BED PREPARATION SHALL BE ORGANIC MULCH FREE FROM DELETERIOUS MATERIALS AND SUITABLE FOR TOP DRESSING OF TREES, SHRUBS OR PLANTS. MULCH SHALL BE COMPOSTED, WELL-ROTTED, BLENDED DOUBLE-SHREDDED HARDWOOD MULCH, BLACK OR DARK BROWN IN COLOR. MULCH PIECES SHALL BE SIZED TO PASS THROUGH A 1" SCREEN. COMPOST MULCH: ENRICHED BARK MULCH FOR BED PREP SHALL BE WITH ADDITIONAL ORGANIC OF PEAT AND/OR MANURE. NO DYES, MUSHROOM COMPOST OR OTHER ADDITIVES SHALL BE USED TO ARTIFICIALLY ENHANCE THE APPEARANCE OF THE LEVEL OF COMPOSTING.
- SHARP SAND: SAND SHALL BE THOROUGHLY WASHED. COARSE, GRADED SHARP, CONSTRUCTION OR BRICK SAND, FREE OF CLAY BALLS, WEEDS, AND GRASS. SO-CALLED CUSHION SAND, BLOW SAND, OR CREEK SILT IS NOT ACCEPTABLE FOR SUBSTITUTION WHERE SHARP SAND IS SPECIFIED.

2.4 MULCHES

- A. MULCH FOR TOP DRESSING: DOUBLE SHREDDED HARDWOOD MULCH FREE FROM DELETERIOUS MATERIALS AND SUITABLE FOR TOP DRESSING OF TREES, SHRUBS OR PLANTS. MULCH SHALL BE COMPOSTED, WELL-ROTTED, BLENDED DOUBLE-SHREDDED HARDWOOD MULCH, BLACK OR DARK BROWN IN COLOR. MULCH PIECES SHALL BE SIZED TO PASS THROUGH A 1" SCREEN. NO DYES, MUSHROOM COMPOST OR OTHER ADDITIVES SHALL BE USED TO ARTIFICIALLY ENHANCE THE APPEARANCE OF THE LEVEL OF COMPOSTING. MULCH SHALL BE NATIVE HARDWOOD MULCH AS SUPPLIED BY NATURES WAY RESOURCES, 101 SHERBROOK CIRCLE, CONROE, TX, OR APPROVED EQUAL.]
- B. PINE STRAW: PINE STRAW SHALL BE CLEAN, DRY COMMERCIALLY BALED PINE STRAW

COMPOST IS A WIDELY USED BULK ORGANIC MULCH AND A RECYCLED PRODUCT. CONSIDER EACH PLANT'S PH AND SOLUBLE SALT REQUIREMENTS AND HOW THEY RELATE TO THE COMPOST BEING USED.

C. ROCK MULCH:

- 1. SIZE RANGE: REFERENCE DRAWING, SUBMIT FOR LANDSCAPE ARCHITECT REVIEW PRIOR INSTALLATION.
- 2. COLOR: REFERENCE DRAWING, SUBMIT FOR LANDSCAPE ARCHITECT REVIEW PRIOR INSTALLATION.

2.5 WEED-CONTROL BARRIERS

- A. STEEL EDGING: REFERENCE DRAWING, OR APPROVED EQUAL.
- WEED BARRIER: WOVEN SOIL SEPARATOR/WEED BARRIER TO BE INSTALLED ON THE PATH SYSTEM SHALL BE PRO 5 WEED BARRIER AS MANUFACTURED BY DEWITT COMPANY, OR APPROVED EQUAL.

2.6 PLANTING DRAINAGE

A. REFERENCE DRAWINGS FOR BIORETENTION DRAINAGE.

2.7 PESTICIDES

A. GENERAL: PESTICIDE REGISTERED AND APPROVED BY EPA, ACCEPTABLE TO AUTHORITIES HAVING JURISDICTION, AND OF TYPE RECOMMENDED BY MANUFACTURER FOR EACH SPECIFIC PROBLEM AND AS REQUIRED FOR PROJECT CONDITIONS AND APPLICATION. DO NOT USE RESTRICTED PESTICIDES UNLESS AUTHORIZED IN WRITING BY AUTHORITIES HAVING JURISDICTION.

2.8 HERBICIDE

- A. PRE-EMERGENT HERBICIDE SHALL BE TEAM PRO AS MANUFACTURED BY BONUS CORP FERTILIZER, HOUSTON, TX, OR APPROVED EQUAL. APPLY PRE-EMERGENT OVER ALL PLANTING AREAS PRIOR TO SPREADING MULCH AT THE RATE OF 7 LBS./1000 SQ. FEET.
- B. IF NECESSARY, CONTACT HERBICIDE SHALL BE ROUNDUP BY MONSANTO, 800 N. LINDBERGH, ST. LOUIS, MO 63167, 314-694-1000, OR APPROVED EQUAL. APPLY ROUNDUP ONLY IF NECESSARY AND IF APPROVED BY OWNER OR OWNER'S REPRESENTATIVE. DO NOT EXCEED MANUFACTURER'S RECOMMENDED RATE OF APPLICATION.

2.9 STAKING AND GUYING

A. REFERENCE DRAWINGS FOR STAKING AND GUYING MATERIAL.

PART 3 - EXECUTION

3.1 PLANTING

- A. EXCAVATION FOR TREES AND LARGE SHRUBS
 - 1. EXCAVATE PITS WITH VERTICAL SIDES AND WITH BOTTOM OF EXCAVATION SLIGHTLY RAISED AT CENTER TO PROVIDE PROPER DRAINAGE. ROUGH UP SIDES OF PIT.
- 2. MAKE EXCAVATIONS AT LEAST HALF AGAIN AS WIDE AS THE BALL DIAMETER AND EQUAL TO THE BALL DEPTH, PLUS 4" ALLOWANCE FOR SETTING OF BALL ON A LAYER OF COMPACTED
- 3. DISPOSE OF SUBSOIL REMOVED FROM PLANTING EXCAVATIONS. DO NOT MIX WITH PLANTING SOIL OR USE AS BACKFILL

B. PLANTING TREES AND LARGE SHRUBS

- 1. SET STOCK ON LAYER OF COMPACTED PREPARED PLANTING SOIL BACKFILL MIX, PLUMB AND IN CENTER OF PIT AT SAME ELEVATION AS ADJACENT FINISHED PLANTING GRADES. DISTRIBUTE ADDITIONAL FERTILIZER EVENLY THROUGHOUT BACKFILL MIX IN HOLE AT SPECIFIED RATE. PLACE PREPARED PLANTING SOIL BACKFILL MIX AROUND BASE AND SIDES OF BALL AND WORK EACH LAYER TO SETTLE BACKFILL AND ELIMINATE VOIDS AND AIR POCKETS. WHEN EXCAVATION IS APPROXIMATELY 2/3 FULL, WATER THOROUGHLY BEFORE PLACING REMAINDER OF BACKFILL. FOR TREES, APPLY TREE INOCULANT AT RATE SPECIFIED ACCORDING TO SIZE OF TREE. REPEAT WATERING UNTIL NO MORE WATER IS ABSORBED. DISH TOP OF BACKFILL TO ALLOW FOR MULCHING.
- 2. PRUNE, THIN OUT, AND SHAPE SHRUBS IN ACCORDANCE WITH STANDARD HORTICULTURAL PRACTICE. PRUNE SHRUBS TO RETAIN NATURAL CHARACTER. REMOVE AND REPLACE EXCESSIVELY PRUNED OR MISFORMED STOCK RESULTING FROM IMPROPER PRUNING.
- 3. STAKE AND GUY TREES AS PER THE DRAWINGS.
- C. EXCAVATION AND SOIL PREPARATION FOR SHRUBS/GROUNDCOVERS IN PLANTING BEDS
- 1. EXCAVATE ENTIRE PLANTING BEDS TO A DEPTH OF 8 INCHES. PLANTING BEDS TO HAVE VERTICAL SIDES.
- 2. DISPOSE OF SUBSOIL REMOVED FROM PLANTING BEDS EXCAVATIONS. DO NOT MIX WITH PLANTING SOIL OR USE AS BACKFILL

- 3. TILL BOTTOM OF PLANTER 2"-4", LEAVE BOTTOM OF PLANTER UN-COMPACTED. BACKFILL WITH 8" OF PREPARED BACKFILL MIX.
- 4. STRIP EXISTING VEGETATION TO REMOVE ROOT LAYER. EXCAVATE ENTIRE PLANTING BEDS, MINIMUM 4" BELOW FINISHED GRADE, TO THE DEPTH REQUIRED TO ACHIEVE FINAL GRADE OF PLANTING BED.
- 5. DISPOSE OF SOIL REMOVED FROM PLANTING BEDS EXCAVATIONS. DO NOT MIX WITH PLANTING SOIL OR USE AS BACKFILL.
- 6. PLACE 4" OF PREPARED PLANTING SOIL BACKFILL MIX, INCLUDING FERTILIZER AND TILL INTO EXISTING SOIL TO A DEPTH OF 8" (4" INTO EXISTING SOIL). PLACE A MINIMUM OF 4" (AFTER SETTLING) ADDITIONAL PREPARED SOIL BACKFILL MIX AND FERTILIZER.

D. PLANTING OF TREES AND SHRUBS IN BEDS

 SET STOCK ON LAYER PLANTING SOIL MIXTURE, PLUMB AND AT THE SAME ELEVATION AS ADJACENT FINISHED PLANTING GRADES. PLACE FERTILIZER TABLETS PACED IN PLANTING BED AT SPECIFIED RATE. PLACE ADDITIONAL BACKFILL MIX AROUND BASE AND SIDES OF BALL AND WORK EACH LAYER TO SETTLE BACKFILL AND ELIMINATE VOIDS AND AIR POCKETS. WATER ENTIRE BED THOROUGHLY, ADJUSTS PLANT IF SETTLING OCCURS.

3.2 PLANT MAINTENANCE

- A. MAINTAIN PLANTINGS BY PRUNING, CULTIVATING, WATERING, WEEDING, FERTILIZING, MULCHING, RESTORING PLANTING SAUCERS, RESETTING TO PROPER GRADES OR VERTICAL POSITION, AND PERFORMING OTHER OPERATIONS AS REQUIRED TO ESTABLISH HEALTHY, VIABLE PLANTINGS. SPRAY OR TREAT AS REQUIRED TO KEEP TREES AND SHRUBS FREE OF INSECTS AND
- B. FILL IN AS NECESSARY SOIL SUBSIDENCE THAT MAY OCCUR BECAUSE OF SETTLING OR OTHER PROCESSES. REPLACE MULCH MATERIALS DAMAGED OR LOST IN AREAS OF SUBSIDENCE.
- C. APPLY TREATMENTS AS REQUIRED TO KEEP PLANT MATERIALS, PLANTED AREAS, AND SOILS FREE PART 3 EXECUTION OF PESTS AND PATHOGENS OR DISEASE. USE PRACTICES TO MINIMIZE THE USE OF PESTICIDES AND REDUCE HAZARDS.
- D. APPLY PESTICIDES AND OTHER CHEMICAL PRODUCTS AND BIOLOGICAL CONTROL AGENTS IN ACCORDANCE WITH AUTHORITIES HAVING JURISDICTION AND MANUFACTURER'S WRITTEN RECOMMENDATIONS. COORDINATE APPLICATIONS WITH OWNER'S OPERATIONS AND OTHERS IN PROXIMITY TO THE WORK. NOTIFY OWNER BEFORE EACH APPLICATION IS PERFORMED.
- PROTECT PLANTS FROM DAMAGE DUE TO LANDSCAPE OPERATIONS AND OPERATIONS OF OTHER CONTRACTORS AND TRADES. MAINTAIN PROTECTION DURING INSTALLATION AND MAINTENANCE PERIODS. TREAT, REPAIR, OR REPLACE DAMAGED PLANTINGS.

END OF SECTION 32 93 00

SECTION 32 93 01 LANDSCAPE MAINTENANCE

1.1 RELATED DOCUMENTS

A. DRAWINGS AND GENERAL PROVISIONS OF CONTRACT, INCLUDING GENERAL AND SUPPLEMENTARY CONDITIONS AND ALL APPLICABLE SPECIFICATION SECTIONS, APPLY TO THIS

1.2 WORK COVERED

A. FURNISH ALL LABOR, MATERIALS AND EQUIPMENT AS NECESSARY TO PROVIDE A LANDSCAPE MAINTENANCE PROGRAM IN STRICT ACCORDANCE WITH THE SPECIFICATIONS AND DRAWINGS.

1.3 RELATED WORK IN OTHER SECTIONS

A. EXAMINE ALL SECTION FOR WORK RELATED TO THIS SECTION.

1.4 REQUIREMENTS OF REGULATORY AGENCIES

A. PERFORM WORK IN ACCORDANCE WITH ALL APPLICABLE LAWS, CODES, AND REGULATIONS REQUIRED BY AUTHORITIES HAVING JURISDICTION OVER SUCH WORK AND PROVIDE FOR ALL PERMITS REQUIRED BY LOCAL AUTHORITIES.

1.5 CONTRACTOR RESPONSIBILITIES

- A. THE CONTRACTOR SHALL BEGIN MAINTENANCE IMMEDIATELY UPON STARTING ANY PORTION OF THE WORK OF THIS CONTRACT.
- B. THE CONTRACTOR'S MAINTENANCE PERIOD SHALL CONTINUE 12 MONTHS BEYOND FINAL ACCEPTANCE OF ALL WORK IN THIS CONTRACT.
- C. TREES, SHRUBS AND GROUNDCOVERS: THE CONTRACTOR'S MAINTENANCE OF NEW PLANTING SHALL CONSIST OF WATERING, CULTIVATING, WEEDING, MULCHING, RE-STAKING, TIGHTENING AND REPAIRING OF GUYS, RESETTING PLANTS TO PROPER GRADES OR UPRIGHT POSITION, RESTORATION OF THE PLANTING SAUCER, AND FURNISHING AND APPLYING SUCH SPRAYS AND INVIGORANTS AS ARE NECESSARY TO KEEP THE PLANTINGS FREE OF INSECTS AND DISEASE AND IN THRIVING CONDITION.
- D. IRRIGATION SYSTEM: MAINTENANCE OF IRRIGATION SYSTEM SHALL CONSIST OF MONITORING AND ADJUSTMENT OF THE DURATION AND FREQUENCY OF THE WATERING SCHEDULE, ADJUSTMENT OF HEADS FOR COVERAGE AND ELEVATION, REPAIR OF LEAKS IN BOTH MAINS AND LATERAL LINES AND ALL OTHER WORK REQUIRED TO ESTABLISH A COMPLETE WORKING IRRIGATION SYSTEM.
- E. LAWNS: MAINTENANCE OF NEW LAWNS SHALL CONSIST OF MOWING, WATERING, WEEDING, REPAIR OF ALL EROSION AND RESEEDING AS NECESSARY TO ESTABLISH A UNIFORM STAND OF
- F. TRASH PICK-UP: PICK UP TRASH ON SITE AND EMPTY TRASH RECEPTACLES AT EACH SITE VISIT.

A. PROTECT PLANTING AREAS AND LAWNS AT ALL TIMES AGAINST DAMAGE OF ALL KINDS FOR DURATION OF MAINTENANCE PERIOD. MAINTENANCE INCLUDES TEMPORARY PROTECTION FENCES, BARRIERS AND SIGNS AS REQUIRED FOR PROTECTION. IF ANY PLANTS BECOME DAMAGED OR INJURED, BECAUSE SUFFICIENT PROTECTION WAS NOT PROVIDED, TREAT OR REPLACE AS DIRECTED BY OWNER AT NO ADDITIONAL COST TO OWNER.

1.7 FINAL ACCEPTANCE

A. WORK UNDER THIS SECTION WILL BE ACCEPTED BY LANDSCAPE ARCHITECT UPON SATISFACTORY COMPLETION OF ALL WORK, INCLUDING MAINTENANCE, REPLACEMENT OF PLANT MATERIALS AND LAWNS UNDER THE WARRANTY PERIOD. UPON FINAL ACCEPTANCE, THE OWNER WILL ASSUME RESPONSIBILITY FOR MAINTENANCE OF THE WORK.

1.8 WARRANTIES AND REPLACEMENTS

A. REFER TO OTHER SECTIONS.

1.9 MAINTENANCE INSTRUCTIONS

A. AT THE COMPLETION OF WORK, FURNISH TWO (2) COPIES OF WRITTEN MAINTENANCE INSTRUCTIONS TO OWNER AND ONE (1) COPY TO LANDSCAPE ARCHITECT FOR MAINTENANCE AND CARE OF ALL PLANTING THROUGHOUT THE YEAR.

PART 2 - PRODUCTS

- 2.1 MATERIALS
- A. MATERIALS REQUIRED FOR INSTALLED ITEMS SHALL MATCH THOSE ALREADY IN USE.
- B. SAMPLES OF ALL MATERIALS NOT SPECIFIED UNDER OTHER SECTIONS OF THESE SPECIFICATIONS SHALL BE SUBMITTED FOR REVIEW BY LANDSCAPE ARCHITECT PRIOR TO USE.
- C. TOPDRESS FERTILIZER: COMMERCIAL FERTILIZER WITH GUARANTEED ANALYSIS OF 16-6-8 OR AS REQUIRED FOR APPLICATION USE. FERTILIZER SHALL HAVE A SALT INDEX PER NUTURIENT OF LESS THAN 65.

2.2 REQUIRED EQUIPMENT

- A. CONTRACTOR SHALL HAVE AVAILABLE FOR THEIR USE THE FOLLOWING MAINTENANCE EQUIPMENT:
- 1. LAWN MOWERS
- GASOLINE POWERED EDGERS
- TRASH COLLECTION EQUIPMENT
- 4. LINE TRIMMERS
- MISCELLANEOUS HAND TOOLS, RAKES, BROOMS, ETC.
- 6. BLOWERS OTHER AS NEEDED.

3.1 WATERING

- A. IT SHALL BE THE RESPONSIBILITY OF THE CONTRACTOR TO ASSURE THAT THE CORRECT WATERING OF PLANT MATERIALS IS BEING ACCOMPLISHED THROUGH THE FOLLOWING IRRIGATION TECHNIQUES:
- B. REGULAR DEEP WATERING TO ALL NEW TREES UNTIL THERE ARE DEFINITE SIGNS THAT THE TREES HAVE ESTABLISHED THEMSELVES, NEW GROWTH IS APPARENT, AND NO TREES ARE EXPERIENCING STRESS CONDITIONS.
- C. FREQUENT WATERING TO THE LAWN AREAS TO INSURE AGAINST DRYING. THIS MAY BE ACCOMPLISHED AS ABOVE, BY THE AUTOMATIC SPRINKLER SYSTEM, HAND WATERING OR PORTABLE SPRINKLERS. CONTRACTOR SHALL MONITOR SETTINGS OF AUTOMATIC SPRINKLER CONTROLS AND RECOMMEND NECESSARY ADJUSTMENTS ACCORDING TO CLIMATIC CHANGES
- D. CONTRACTOR SHALL BE RESPONSIBLE FOR WATERING AREAS WITHIN THE PROJECT LIMITS THAT DO NOT HAVE IRRIGATION SYSTEMS.
- E. CONTRACTOR SHALL BE RESPONSIBLE FOR DAMAGES TO IRRIGATION SYSTEM CAUSED BY MAINTENANCE OPERATIONS.

3.2 MAINTENANCE OF TURF AREAS

- A. MOWING LAWN/GRASS AREAS SHALL BE ACCOMPLISHED WITH SHARP, PROPERLY ADJUSTED MOWERS OF THE CORRECT SIZE FOR THE VARIOUS AREAS.
- B. MOWING FREQUENCY SHALL BE AS PER THE LANDSCAPE MAINTENANCE PROGRAM. BLADE HEIGHTS SHALL BE SET ACCORDING TO THE FOLLOWING SCHEDULE.
- 1. 1½ INCHES INITIAL MOWING
- APRIL NOVEMBER 2. 1 ½ INCHES
- 2 INCHES DECEMBER - MARCH
- C. IN THE EVENT OF A PROLONGED RAINY PERIOD AND A SURGE OF LEAF GROWTH IS ANTICIPATED, THE MOWER HEIGHT MAY BE READJUSTED TO PREVENT "SCALPING" OR SKINNING OF LAWN ON PRECEDING CUTS.
- D. LAWN SHALL BE EDGED EVENLY AT ALL WALKS, HEADERS AND OTHER STRUCTURES AS PER THE SCHEDULE. USE AN EGDER, NOT A LINE TRIMMER.
- E. UNTIL THE ESTABLISHMENT OF THE TURF, THE CONTRACTOR WILL BE RESPONSIBLE FOR REPLACING SOILS THAT HAVE ERODED ONTO THE PAVED AREAS. RESIDUAL SOILS ON PAVING WILL BE REMOVED AND IF NOT MINGLED WITH OBJECTIONABLE MATERIALS MAY BE RE-USED IN ERODED AREAS.
- F. IMMEDIATELY UPON OBSERVING ANY LAWN GRASS SPREADING INTO SHRUB OR GROUNDCOVER AREAS, THE CONTRACTOR SHALL INITIATE A PROGRAM OF REMOVAL AND MAINTAIN THIS PROGRAM THROUGHOUT THE MAINTENANCE PERIOD.
- G. ANY LAWN GRASS APPEARING IN PAVED AREAS SHALL RECEIVE AN APPLICATION OF SOIL STERILANT ACCORDING TO MANUFACTURER'S DIRECTION. THE STERILANT SHALL BE APPROVED AND WILL NOT BE DETRIMENTAL STRUCTURALLY TO PAVED AREAS.
- H. SPECIAL EFFORT SHALL BE GIVEN TO THE CONTROL TO FIRE ANTS INFESTING THE SITE. AFTER CONTROL IS ACCOMPLISHED, THE ANT MOUNDS SHALL BE LOWERED AND TAMPED TO THE EXISTING GRADE.
- I. APPLY TOP DRESS FERTILIZER AFTER GRASSING, IF NEEDED.

3.3 MAINTENANCE OF TREES AND SHRUBS

- A. CONTRACTOR SHALL ADJUST AND TIGHTEN AS REQUIRED ALL TREE STAKING AND GUYING. REMOVAL AS DIRECTED BY OWNER'S REPRESENTATIVE.
- B. ALL WEEDS WITHIN THE MULCHED AREA AROUND EACH TREE AND IN EACH SHRUB BED SHALL BE REMOVED AS OFTEN AS REQUIRED. UNDER NO CIRCUMSTANCES SHALL WEEDS AND GRASS WITHIN PLANTED AREAS BE ALLOWED TO ATTAIN MORE THAN 4 INCHES GROWTH.
- C. CONTRACTOR SHALL BE CONTINUOUSLY ALERT FOR SIGNS OF INSECT PRESENCE OR DAMAGE OR THE PRESENCE OR DAMAGE FROM PLANT FUNGI. UPON LOCATING SUCH EVIDENCE, THE CONTRACTOR SHALL REPORT IT TO THE OWNER'S REPRESENTATIVE AND TAKE ACTION AS

3.4 MAINTENANCE OF IRRIGATION SYSTEM

A. IRRIGATION SYSTEM: MAINTENANCE OF IRRIGATION SYSTEM SHALL CONSIST OF MONITORING AND ADJUSTMENT OF THE DURATION AND FREQUENCY OF THE WATERING SCHEDULE, ADJUSTMENT OF HEADS FOR COVERAGE AND ELEVATION, REPAIR OF LEAKS IN BOTH MAINS AND LATERAL LINES AND ALL OTHER WORK REQUIRED TO ESTABLISH A COMPLETE WORKING IRRIGATION SYSTEM.

3.5 TRASH COLLECTION

A. REMOVAL OF DEBRIS FROM THE SITE UNRELATED TO HORTICULTURAL MAINTENANCE (PAPER, BOTTLES, CAN, "PIRATE" SIGNS, ETC.) SHALL BE THE RESPONSIBILITY OF THE CONTRACTOR. CONTRACTOR SHALL PICK UP TRASH AND EMPTY TRASH RECEPTACLES AT EACH SITE VISIT. FREQUENCY AS PER LANDSCAPE MAINTENANCE PROGRAM.

3.6 DE-WATERING

B. CONTRACTOR SHALL DE-WATER BY PUMPING OR SIPHONING AS OFTEN AS NECESSARY TO

REMOVE EXCESS MOISTURE FROM SOIL IN PLANTING AREAS AND TREE BALLS. DE-WATERING TO OCCUR DURING SCHEDULED VISITS AS REQUIRED.

PART 4 - SCHEDULES

4.1 THE EXECUTION ITEMS OF PART 3 IN THIS SPECIFICATION SHALL BE PERFORMED AS PER THE FOLLOWING SCHEDULE AS APPLICABLE FOR THE MAINTENANCE PERIOD:

MONTH # OF VISITS PER MONTH JANUARY **FEBRUARY** MARCH APRIL JUNE JULY AUGUST **SEPTEMBER** OCTOBER NOVEMBER DECEMBER

4.2 TOPDRESS FERTILIZER

A. THIRTY (30) DAYS AFTER SEEDING.

4.3 MULCHING, WEEDING, WEED CONTROL, GUYING AND STAKING ADJUSTMENT

A. AS REQUIRED AT EACH VISIT.

4.4 MEETING

A. CONTRACTOR SHALL MEET ONCE EACH MONTH AND AT THE END OF THE MAINTENANCE PERIOD WITH THE OWNER'S ON-SITE MAINTENANCE PERSONNEL. CONTRACTOR SHALL REVIEW IRRIGATION SYSTEM SCHEDULE AND OPERATION AND OTHER PERTINENT AND HELPFUL MAINTENANCE INFORMATION AT EACH MEETING.

END OF SECTION 32 93 01


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10003 TECHNOLOGY BLVD. WEST DALLAS, TX. 75220 972-620-8204 **REGISTRATION NO: F-1629**

CLIENT INFO

DHI COMMUNITIES 5419 NORTH LOOP 1604 EAST,

SAN ANTONIO, TX 78247



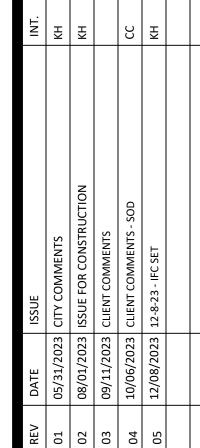

SCALE: AS SHOWN

12/08/2023

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SHEET TITLE LANDSCAPE

PLANTING


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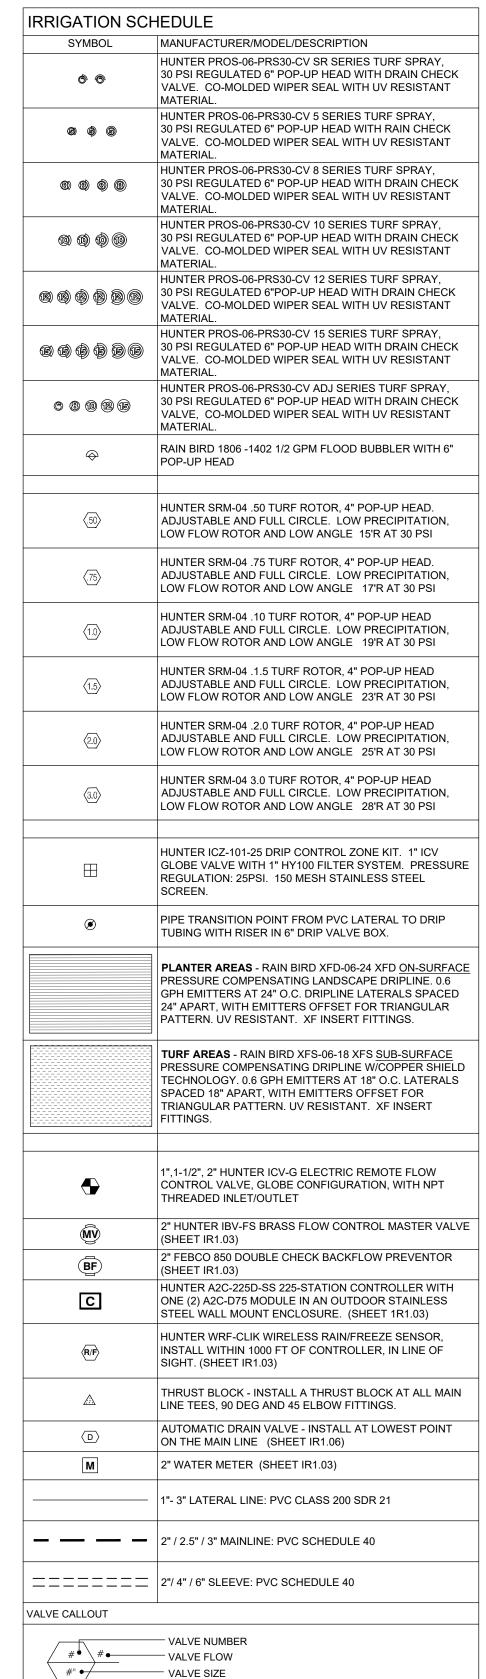
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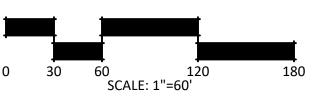




NOTE:

CONTRACTOR TO PROVIDE PIPE APPROPRIATE SIZED SLEEVES (2X GREATER THAN PIPE SIZE) WHERE LATERAL AND MAIN LINES CROSS UNDER SIDEWALKS AND PAVEMENT.



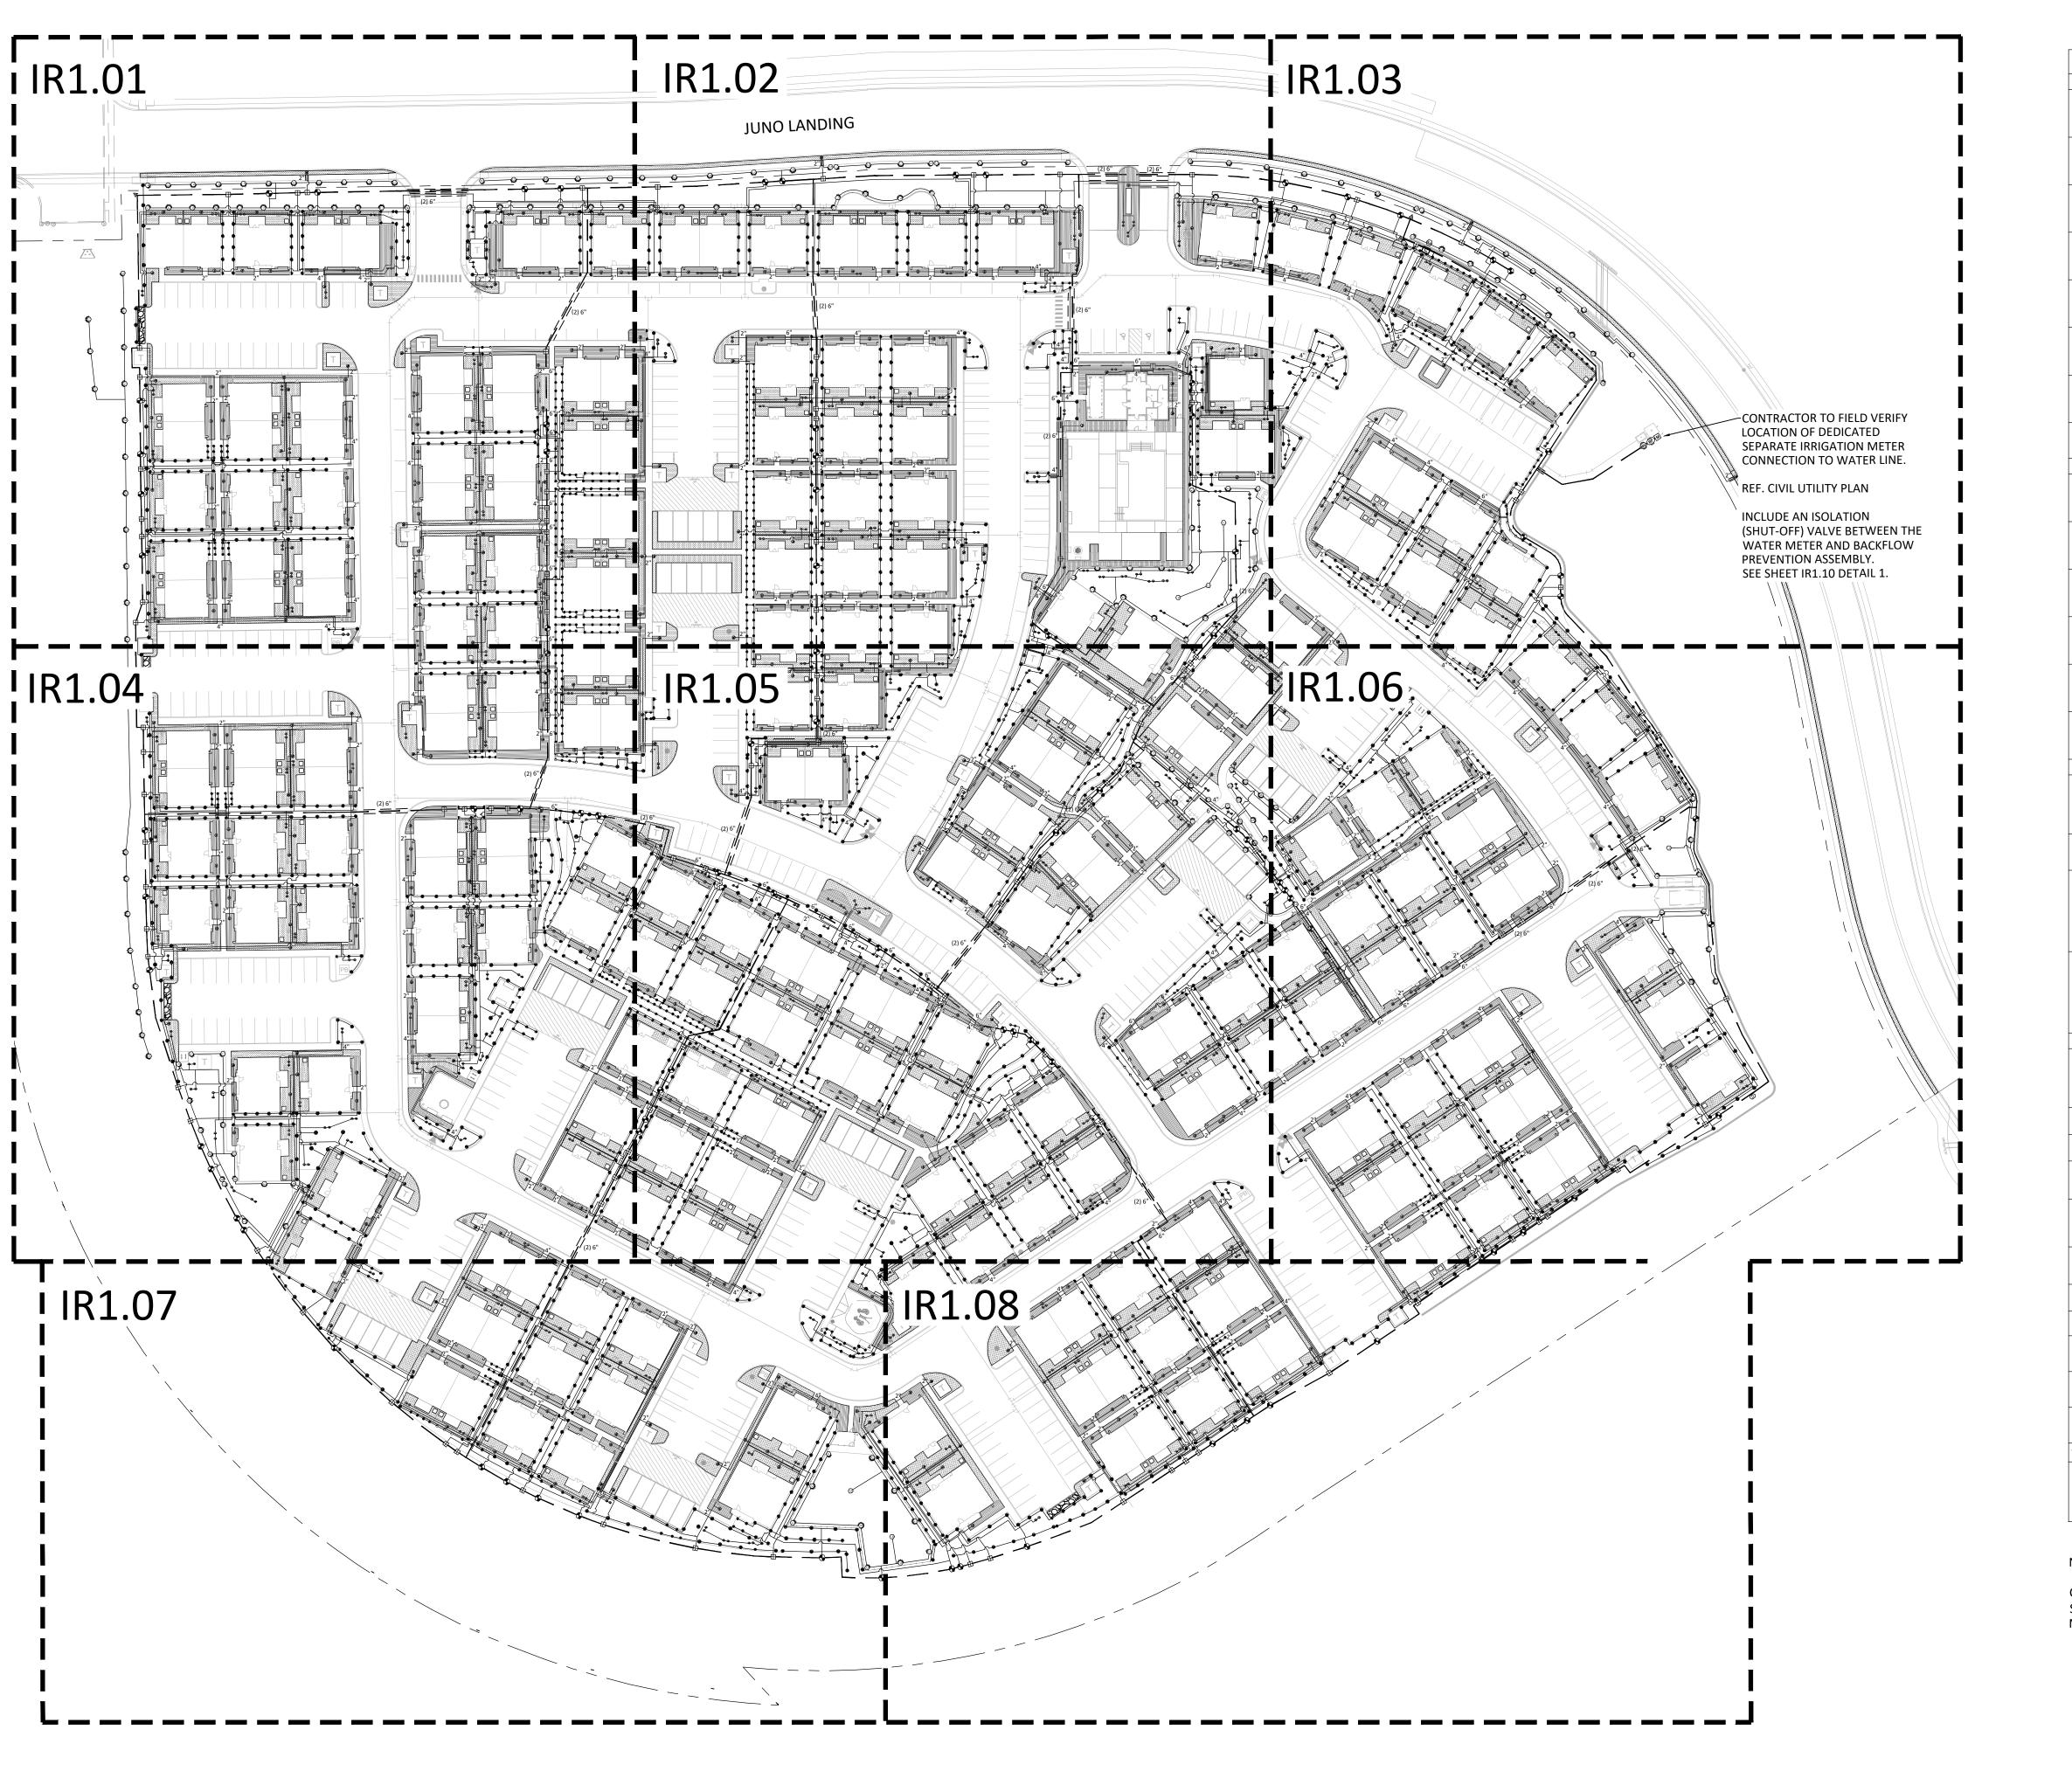

10003 TECHNOLOGY BLVD. WEST DALLAS, TX. 75220 972-620-8204 REGISTRATION NO: F-1629

CLIENT INFO

CLIENT NAME
ADDRESS
CITY, STATE, ZIP CODE

IMMENTS
IMMENTS - SOD
FC SET

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LANDING

SAN ANTONIO, TEX.

SCALE: AS SHOWN

DATE: 1/26/2024


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OVERALL IRRIGATION PLAN


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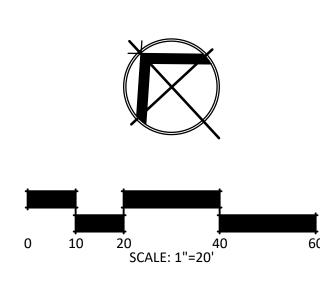
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RRIGATION SCI	MANUFACTURER/MODEL/DESCRIPTION
	HUNTER PROS-06-PRS30-CV SR SERIES TURF SPRAY, 30 PSI REGULATED 6" POP-UP HEAD WITH DRAIN CHECK
(b) (c)	VALVE. CO-MOLDED WIPER SEAL WITH UV RESISTANT MATERIAL.
	HUNTER PROS-06-PRS30-CV 5 SERIES TURF SPRAY, 30 PSI REGULATED 6" POP-UP HEAD WITH RAIN CHECK
6) 6) 6)	VALVE. CO-MOLDED WIPER SEAL WITH UV RESISTANT MATERIAL.
	HUNTER PROS-06-PRS30-CV 8 SERIES TURF SPRAY, 30 PSI REGULATED 6" POP-UP HEAD WITH DRAIN CHECK
(a) (b) (b) (c)	VALVE. CO-MOLDED WIPER SEAL WITH UV RESISTANT MATERIAL.
60 60 60	HUNTER PROS-06-PRS30-CV 10 SERIES TURF SPRAY, 30 PSI REGULATED 6" POP-UP HEAD WITH DRAIN CHECK
a a a a	VALVE. CO-MOLDED WIPER SEAL WITH UV RESISTANT MATERIAL.
	HUNTER PROS-06-PRS30-CV 12 SERIES TURF SPRAY, 30 PSI REGULATED 6"POP-UP HEAD WITH DRAIN CHECK
Ø Ø Ø Ø Ø	VALVE. CO-MOLDED WIPER SEAL WITH UV RESISTANT MATERIAL.
(a) (b) (b) (b) (c)	HUNTER PROS-06-PRS30-CV 15 SERIES TURF SPRAY, 30 PSI REGULATED 6" POP-UP HEAD WITH DRAIN CHECK
	VALVE. CO-MOLDED WIPER SEAL WITH UV RESISTANT MATERIAL.
O (8) (10) (12) (16)	HUNTER PROS-06-PRS30-CV ADJ SERIES TURF SPRAY, 30 PSI REGULATED 6" POP-UP HEAD WITH DRAIN CHECK
	VALVE, CO-MOLDED WIPER SEAL WITH UV RESISTANT MATERIAL.
\Leftrightarrow	RAIN BIRD 1806 -1402 1/2 GPM FLOOD BUBBLER WITH 6" POP-UP HEAD
⟨.50⟩	HUNTER SRM-04 .50 TURF ROTOR, 4" POP-UP HEAD. ADJUSTABLE AND FULL CIRCLE. LOW PRECIPITATION,
\ <u>```</u>	LOW FLOW ROTOR AND LOW ANGLE 15'R AT 30 PSI
⟨.75⟩	HUNTER SRM-04 .75 TURF ROTOR, 4" POP-UP HEAD. ADJUSTABLE AND FULL CIRCLE. LOW PRECIPITATION,
<u></u>	LOW FLOW ROTOR AND LOW ANGLE 17'R AT 30 PSI
(1.0)	HUNTER SRM-04 .10 TURF ROTOR, 4" POP-UP HEAD ADJUSTABLE AND FULL CIRCLE. LOW PRECIPITATION,
	LOW FLOW ROTOR AND LOW ANGLE 19'R AT 30 PSI
(1.5)	HUNTER SRM-04 .1.5 TURF ROTOR, 4" POP-UP HEAD ADJUSTABLE AND FULL CIRCLE. LOW PRECIPITATION,
	LOW FLOW ROTOR AND LOW ANGLE 23'R AT 30 PSI
(2.0)	HUNTER SRM-04 .2.0 TURF ROTOR, 4" POP-UP HEAD ADJUSTABLE AND FULL CIRCLE. LOW PRECIPITATION,
_	LOW FLOW ROTOR AND LOW ANGLE 25'R AT 30 PSI
(3.0)	HUNTER SRM-04 3.0 TURF ROTOR, 4" POP-UP HEAD ADJUSTABLE AND FULL CIRCLE. LOW PRECIPITATION, LOW FLOW ROTOR AND LOW ANGLE 28'R AT 30 PSI
	LOW FLOW ROTOR AND LOW ANGLE 20 R AT 30 F31
	HUNTER ICZ-101-25 DRIP CONTROL ZONE KIT. 1" ICV
	GLOBE VALVE WITH 1" HY100 FILTER SYSTEM. PRESSURI REGULATION: 25PSI. 150 MESH STAINLESS STEEL SCREEN.
	PIPE TRANSITION POINT FROM PVC LATERAL TO DRIP
③	TUBING WITH RISER IN 6" DRIP VALVE BOX.
	PLANTER AREAS - RAIN BIRD XFD-06-24 XFD ON-SURFAC PRESSURE COMPENSATING LANDSCAPE DRIPLINE. 0.6
	GPH EMITTERS AT 24" O.C. DRIPLINE LATERALS SPACED 24" APART, WITH EMITTERS OFFSET FOR TRIANGULAR
	PATTERN. UV RESISTANT. XF INSERT FITTINGS.
	TURF AREAS - RAIN BIRD XFS-06-18 XFS SUB-SURFACE
	PRESSURE COMPENSATING DRIPLINE W/COPPER SHIELD TECHNOLOGY. 0.6 GPH EMITTERS AT 18" O.C. LATERALS SPACED 18" APART, WITH EMITTERS OFFSET FOR
	TRIANGULAR PATTERN. UV RESISTANT. XF INSERT FITTINGS.
	1",1-1/2", 2" HUNTER ICV-G ELECTRIC REMOTE FLOW
\	CONTROL VALVE, GLOBE CONFIGURATION, WITH NPT THREADED INLET/OUTLET
(MV)	2" HUNTER IBV-FS BRASS FLOW CONTROL MASTER VALV
(BF)	(SHEET IR1.03) 2" FEBCO 850 DOUBLE CHECK BACKFLOW PREVENTOR (CLIEFT IR1.03)
<u> </u>	(SHEET IR1.03) HUNTER A2C-225D-SS 225-STATION CONTROLLER WITH
С	ONE (2) A2C-D75 MODULE IN AN OUTDOOR STAINLESS STEEL WALL MOUNT ENCLOSURE. (SHEET 1R1.03)
⟨ R / F ⟩	HUNTER WRF-CLIK WIRELESS RAIN/FREEZE SENSOR, INSTALL WITHIN 1000 FT OF CONTROLLER, IN LINE OF
\n/r/	SIGHT. (SHEET IR1.03)
	THRUST BLOCK - INSTALL A THRUST BLOCK AT ALL MAIN LINE TEES, 90 DEG AND 45 ELBOW FITTINGS.
(D)	AUTOMATIC DRAIN VALVE - INSTALL AT LOWEST POINT
M	ON THE MAIN LINE (SHEET IR1.06) 2" WATER METER (SHEET IR1.03)
141	
	1"- 3" LATERAL LINE: PVC CLASS 200 SDR 21
	2" / 2.5" / 3" MAINLINE: PVC SCHEDULE 40
	2"/ 4" / 6" SI EE\/E- D\/C SCHED! !! E 40
	2"/ 4" / 6" SLEEVE: PVC SCHEDULE 40
ALVE CALLOUT	
# # # •	── VALVE NUMBER ── VALVE FLOW
#" •	─ VALVE SIZE

CONTRACTOR TO PROVIDE PIPE APPROPRIATE SIZED SLEEVES (2X GREATER THAN PIPE SIZE) WHERE LATERAL AND MAIN LINES CROSS UNDER SIDEWALKS AND PAVEMENT.



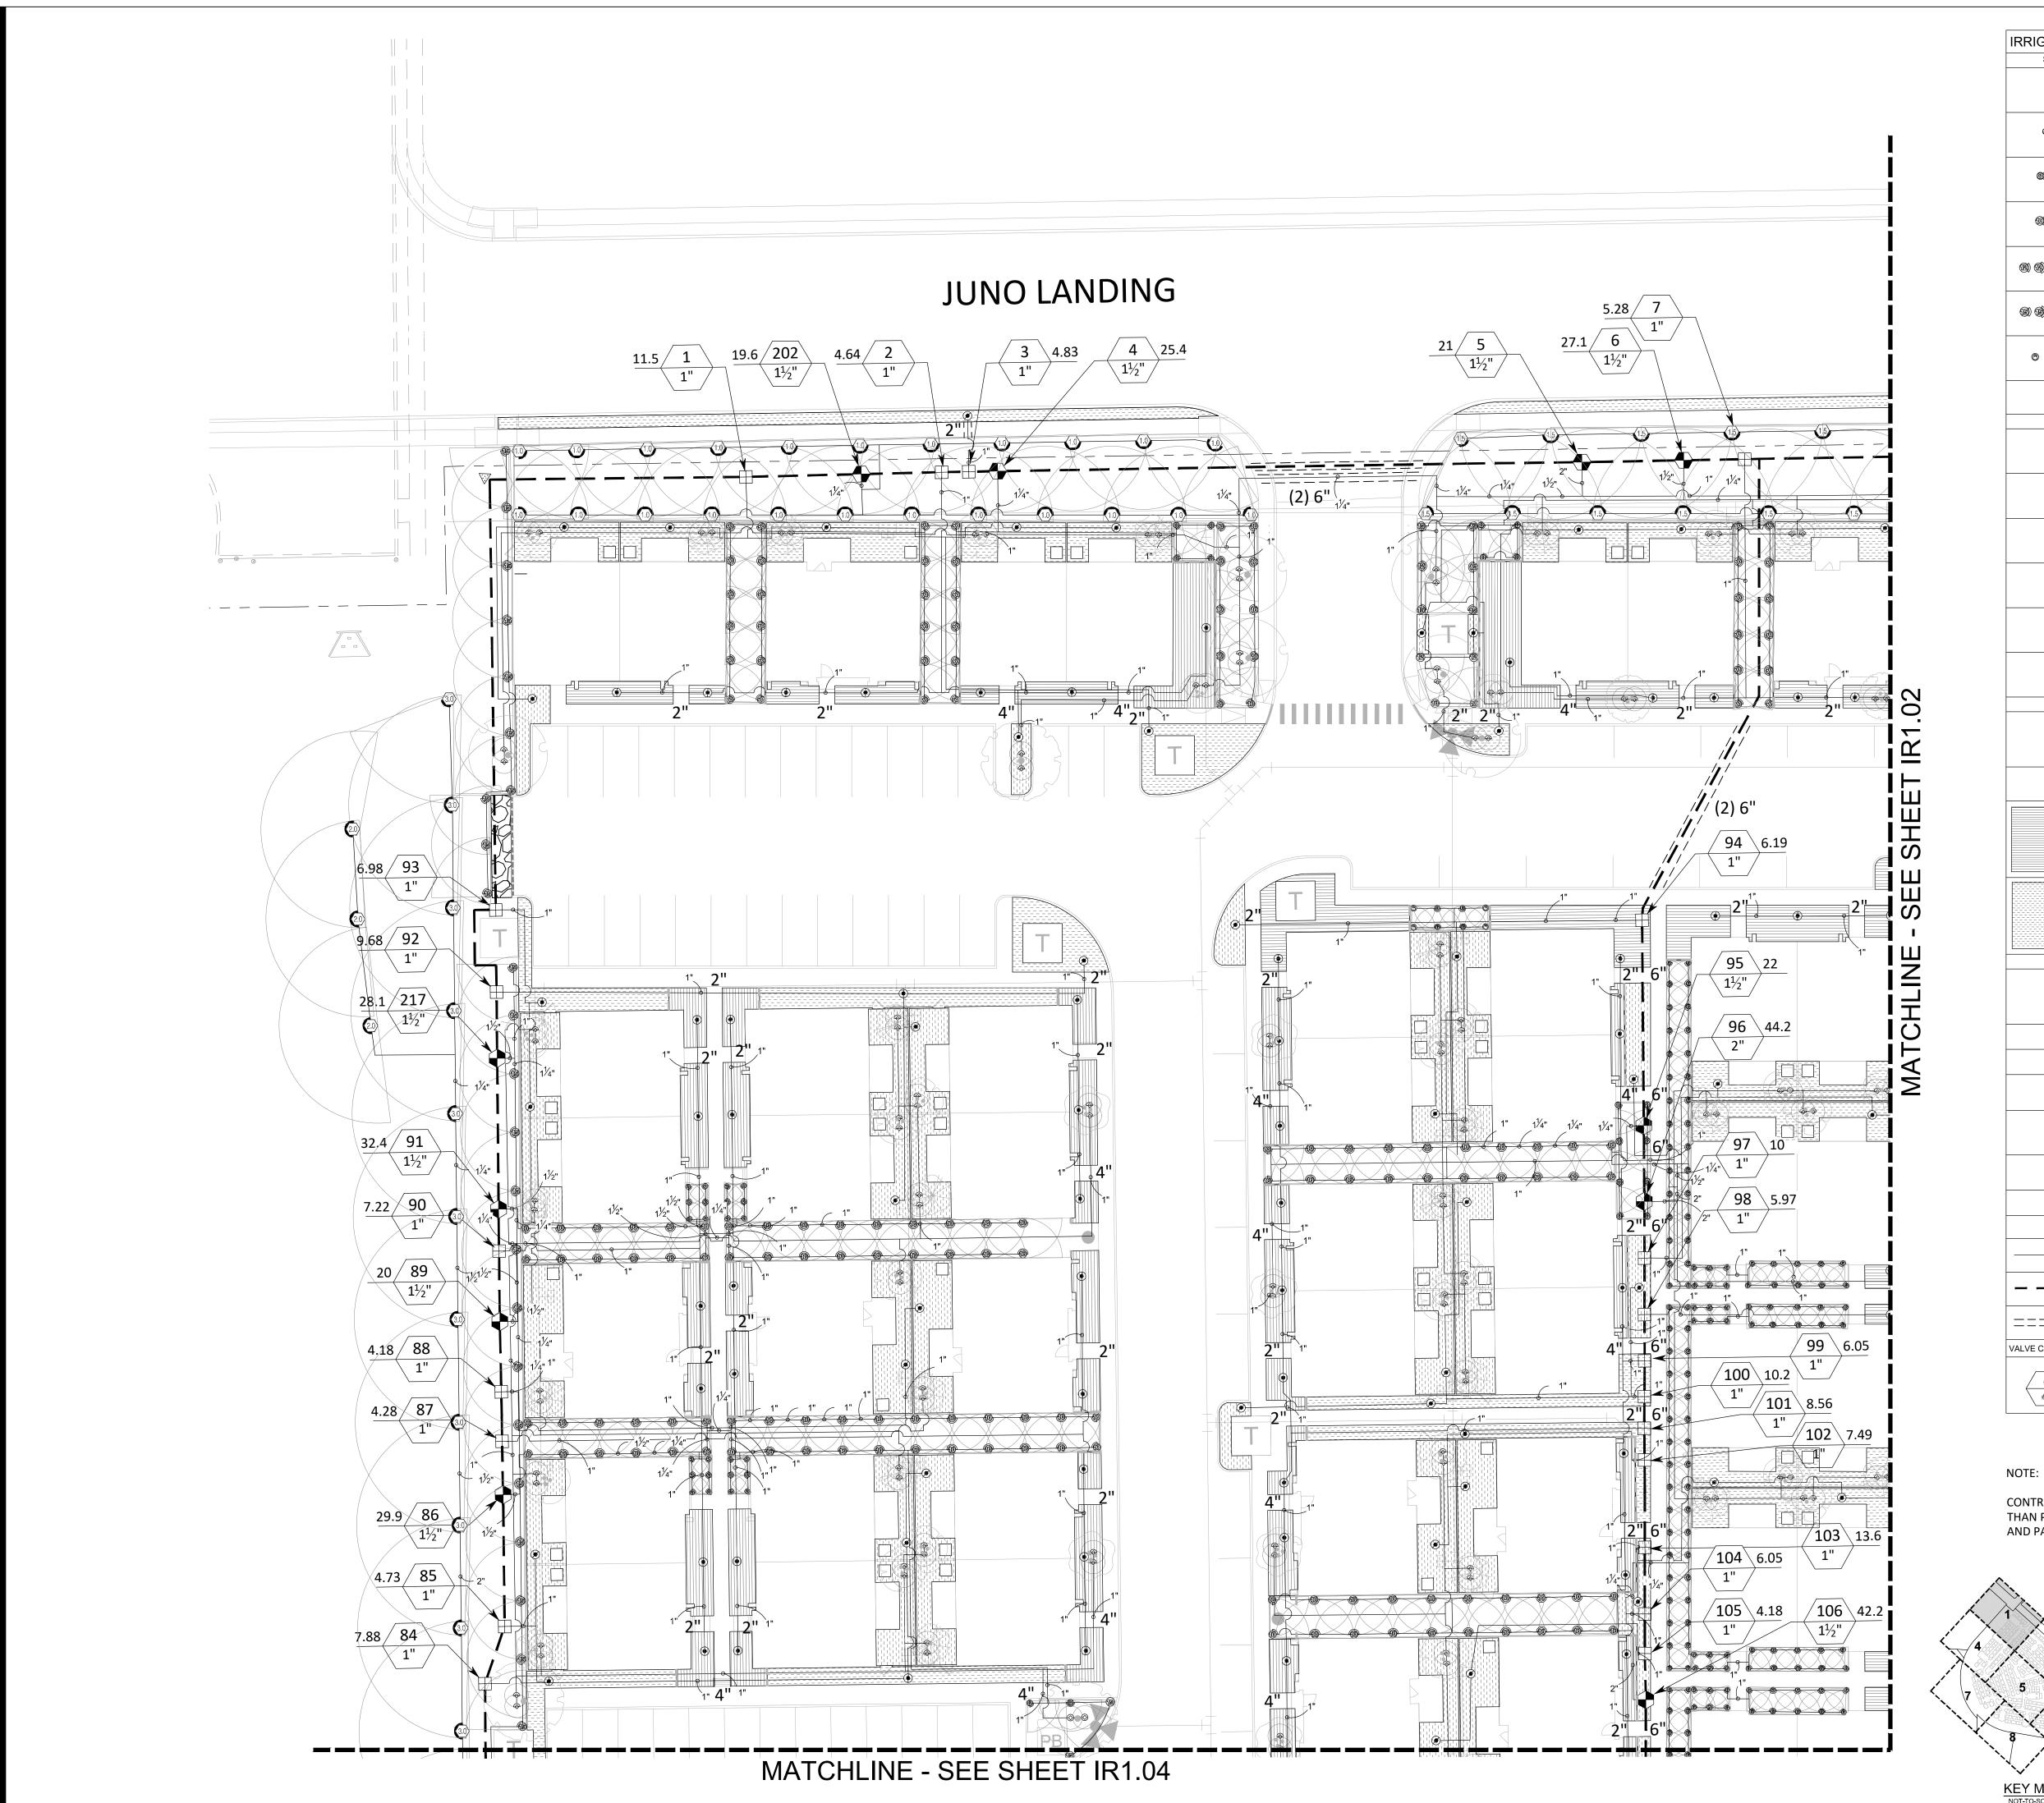

STRAND

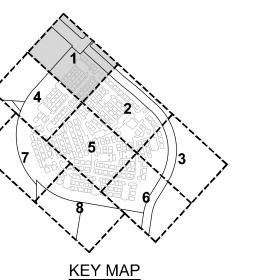10003 TECHNOLOGY BLVD. WEST DALLAS, TX. 75220 972-620-8204 REGISTRATION NO: F-1629

CLIENT NAME

CITY, STATE, ZIP CODE

SCALE: AS SHOWN 1/26/2024 STRAND


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IRRIGATION PLAN

SHEET NO.

STRAND 2148616


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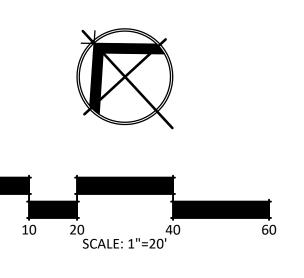


SYMBOL	MANUFACTURER/MODEL/DESCRIPTION
· ···- • -	HUNTER PROS-06-PRS30-CV SR SERIES TURF SPRAY,
6 6	30 PSI REGULATED 6" POP-UP HEAD WITH DRAIN CHE VALVE. CO-MOLDED WIPER SEAL WITH UV RESISTAN MATERIAL.
(3) (6) (6)	HUNTER PROS-06-PRS30-CV 5 SERIES TURF SPRAY, 30 PSI REGULATED 6" POP-UP HEAD WITH RAIN CHEC VALVE. CO-MOLDED WIPER SEAL WITH UV RESISTAN MATERIAL.
30 49 49 89	HUNTER PROS-06-PRS30-CV 8 SERIES TURF SPRAY, 30 PSI REGULATED 6" POP-UP HEAD WITH DRAIN CHE VALVE. CO-MOLDED WIPER SEAL WITH UV RESISTAN MATERIAL.
@ @ @	HUNTER PROS-06-PRS30-CV 10 SERIES TURF SPRAY, 30 PSI REGULATED 6" POP-UP HEAD WITH DRAIN CHE VALVE. CO-MOLDED WIPER SEAL WITH UV RESISTAN MATERIAL.
® ® ® ®	HUNTER PROS-06-PRS30-CV 12 SERIES TURF SPRAY, 30 PSI REGULATED 6"POP-UP HEAD WITH DRAIN CHEVALVE. CO-MOLDED WIPER SEAL WITH UV RESISTAN MATERIAL.
69 69 69 69 69	HUNTER PROS-06-PRS30-CV 15 SERIES TURF SPRAY, 30 PSI REGULATED 6" POP-UP HEAD WITH DRAIN CHE VALVE. CO-MOLDED WIPER SEAL WITH UV RESISTAN MATERIAL.
© ® 10 12 15	HUNTER PROS-06-PRS30-CV ADJ SERIES TURF SPRAY 30 PSI REGULATED 6" POP-UP HEAD WITH DRAIN CHE VALVE, CO-MOLDED WIPER SEAL WITH UV RESISTAN MATERIAL.
⇔	RAIN BIRD 1806 -1402 1/2 GPM FLOOD BUBBLER WITH POP-UP HEAD
(50)	HUNTER SRM-04 .50 TURF ROTOR, 4" POP-UP HEAD. ADJUSTABLE AND FULL CIRCLE. LOW PRECIPITATION LOW FLOW ROTOR AND LOW ANGLE 15'R AT 30 PSI
\(\frac{75}\)	HUNTER SRM-04 .75 TURF ROTOR, 4" POP-UP HEAD. ADJUSTABLE AND FULL CIRCLE. LOW PRECIPITATION LOW FLOW ROTOR AND LOW ANGLE 17'R AT 30 PSI
(1.0)	HUNTER SRM-04 .10 TURF ROTOR, 4" POP-UP HEAD ADJUSTABLE AND FULL CIRCLE. LOW PRECIPITATION LOW FLOW ROTOR AND LOW ANGLE 19'R AT 30 PSI
(1.5)	HUNTER SRM-04 .1.5 TURF ROTOR, 4" POP-UP HEAD ADJUSTABLE AND FULL CIRCLE. LOW PRECIPITATION LOW FLOW ROTOR AND LOW ANGLE 23'R AT 30 PSI
20	HUNTER SRM-04 .2.0 TURF ROTOR, 4" POP-UP HEAD ADJUSTABLE AND FULL CIRCLE. LOW PRECIPITATION LOW FLOW ROTOR AND LOW ANGLE 25'R AT 30 PSI
3.0	HUNTER SRM-04 3.0 TURF ROTOR, 4" POP-UP HEAD ADJUSTABLE AND FULL CIRCLE. LOW PRECIPITATION LOW FLOW ROTOR AND LOW ANGLE 28'R AT 30 PSI
Ш	HUNTER ICZ-101-25 DRIP CONTROL ZONE KIT. 1" ICV GLOBE VALVE WITH 1" HY100 FILTER SYSTEM. PRESS REGULATION: 25PSI. 150 MESH STAINLESS STEEL SCREEN.
③	PIPE TRANSITION POINT FROM PVC LATERAL TO DRIP TUBING WITH RISER IN 6" DRIP VALVE BOX.
	PLANTER AREAS - RAIN BIRD XFD-06-24 XFD ON-SURI PRESSURE COMPENSATING LANDSCAPE DRIPLINE. 0. GPH EMITTERS AT 24" O.C. DRIPLINE LATERALS SPAC 24" APART, WITH EMITTERS OFFSET FOR TRIANGULAI PATTERN. UV RESISTANT. XF INSERT FITTINGS.
	TURF AREAS - RAIN BIRD XFS-06-18 XFS SUB-SURFACE PRESSURE COMPENSATING DRIPLINE W/COPPER SHITECHNOLOGY. 0.6 GPH EMITTERS AT 18" O.C. LATERAL SPACED 18" APART, WITH EMITTERS OFFSET FOR TRIANGULAR PATTERN. UV RESISTANT. XF INSERT FITTINGS.
•	1",1-1/2", 2" HUNTER ICV-G ELECTRIC REMOTE FLOW CONTROL VALVE, GLOBE CONFIGURATION, WITH NPT THREADED INLET/OUTLET
	2" HUNTER IBV-FS BRASS FLOW CONTROL MASTER V.
(MV) (BF)	(SHEET IR1.03) 2" FEBCO 850 DOUBLE CHECK BACKFLOW PREVENTO (SHEET IR1.03)
C	HUNTER A2C-225D-SS 225-STATION CONTROLLER WIT ONE (2) A2C-D75 MODULE IN AN OUTDOOR STAINLESS STEEL WALL MOUNT ENCLOSURE. (SHEET 1R1.03)
(R/F)	HUNTER WRF-CLIK WIRELESS RAIN/FREEZE SENSOR, INSTALL WITHIN 1000 FT OF CONTROLLER, IN LINE OF SIGHT. (SHEET IR1.03)
<u> </u>	THRUST BLOCK - INSTALL A THRUST BLOCK AT ALL M LINE TEES, 90 DEG AND 45 ELBOW FITTINGS.
(D)	AUTOMATIC DRAIN VALVE - INSTALL AT LOWEST POIN ON THE MAIN LINE (SHEET IR1.06)
M	2" WATER METER (SHEET IR1.03)
	1"- 3" LATERAL LINE: PVC CLASS 200 SDR 21
	2" / 2.5" / 3" MAINLINE: PVC SCHEDULE 40
	2"/ 4" / 6" SLEEVE: PVC SCHEDULE 40
/ALVE CALLOUT	
THE VICTORIES	
	— \/AL\/E NUMBED
# # # #	── VALVE NUMBER ── VALVE FLOW

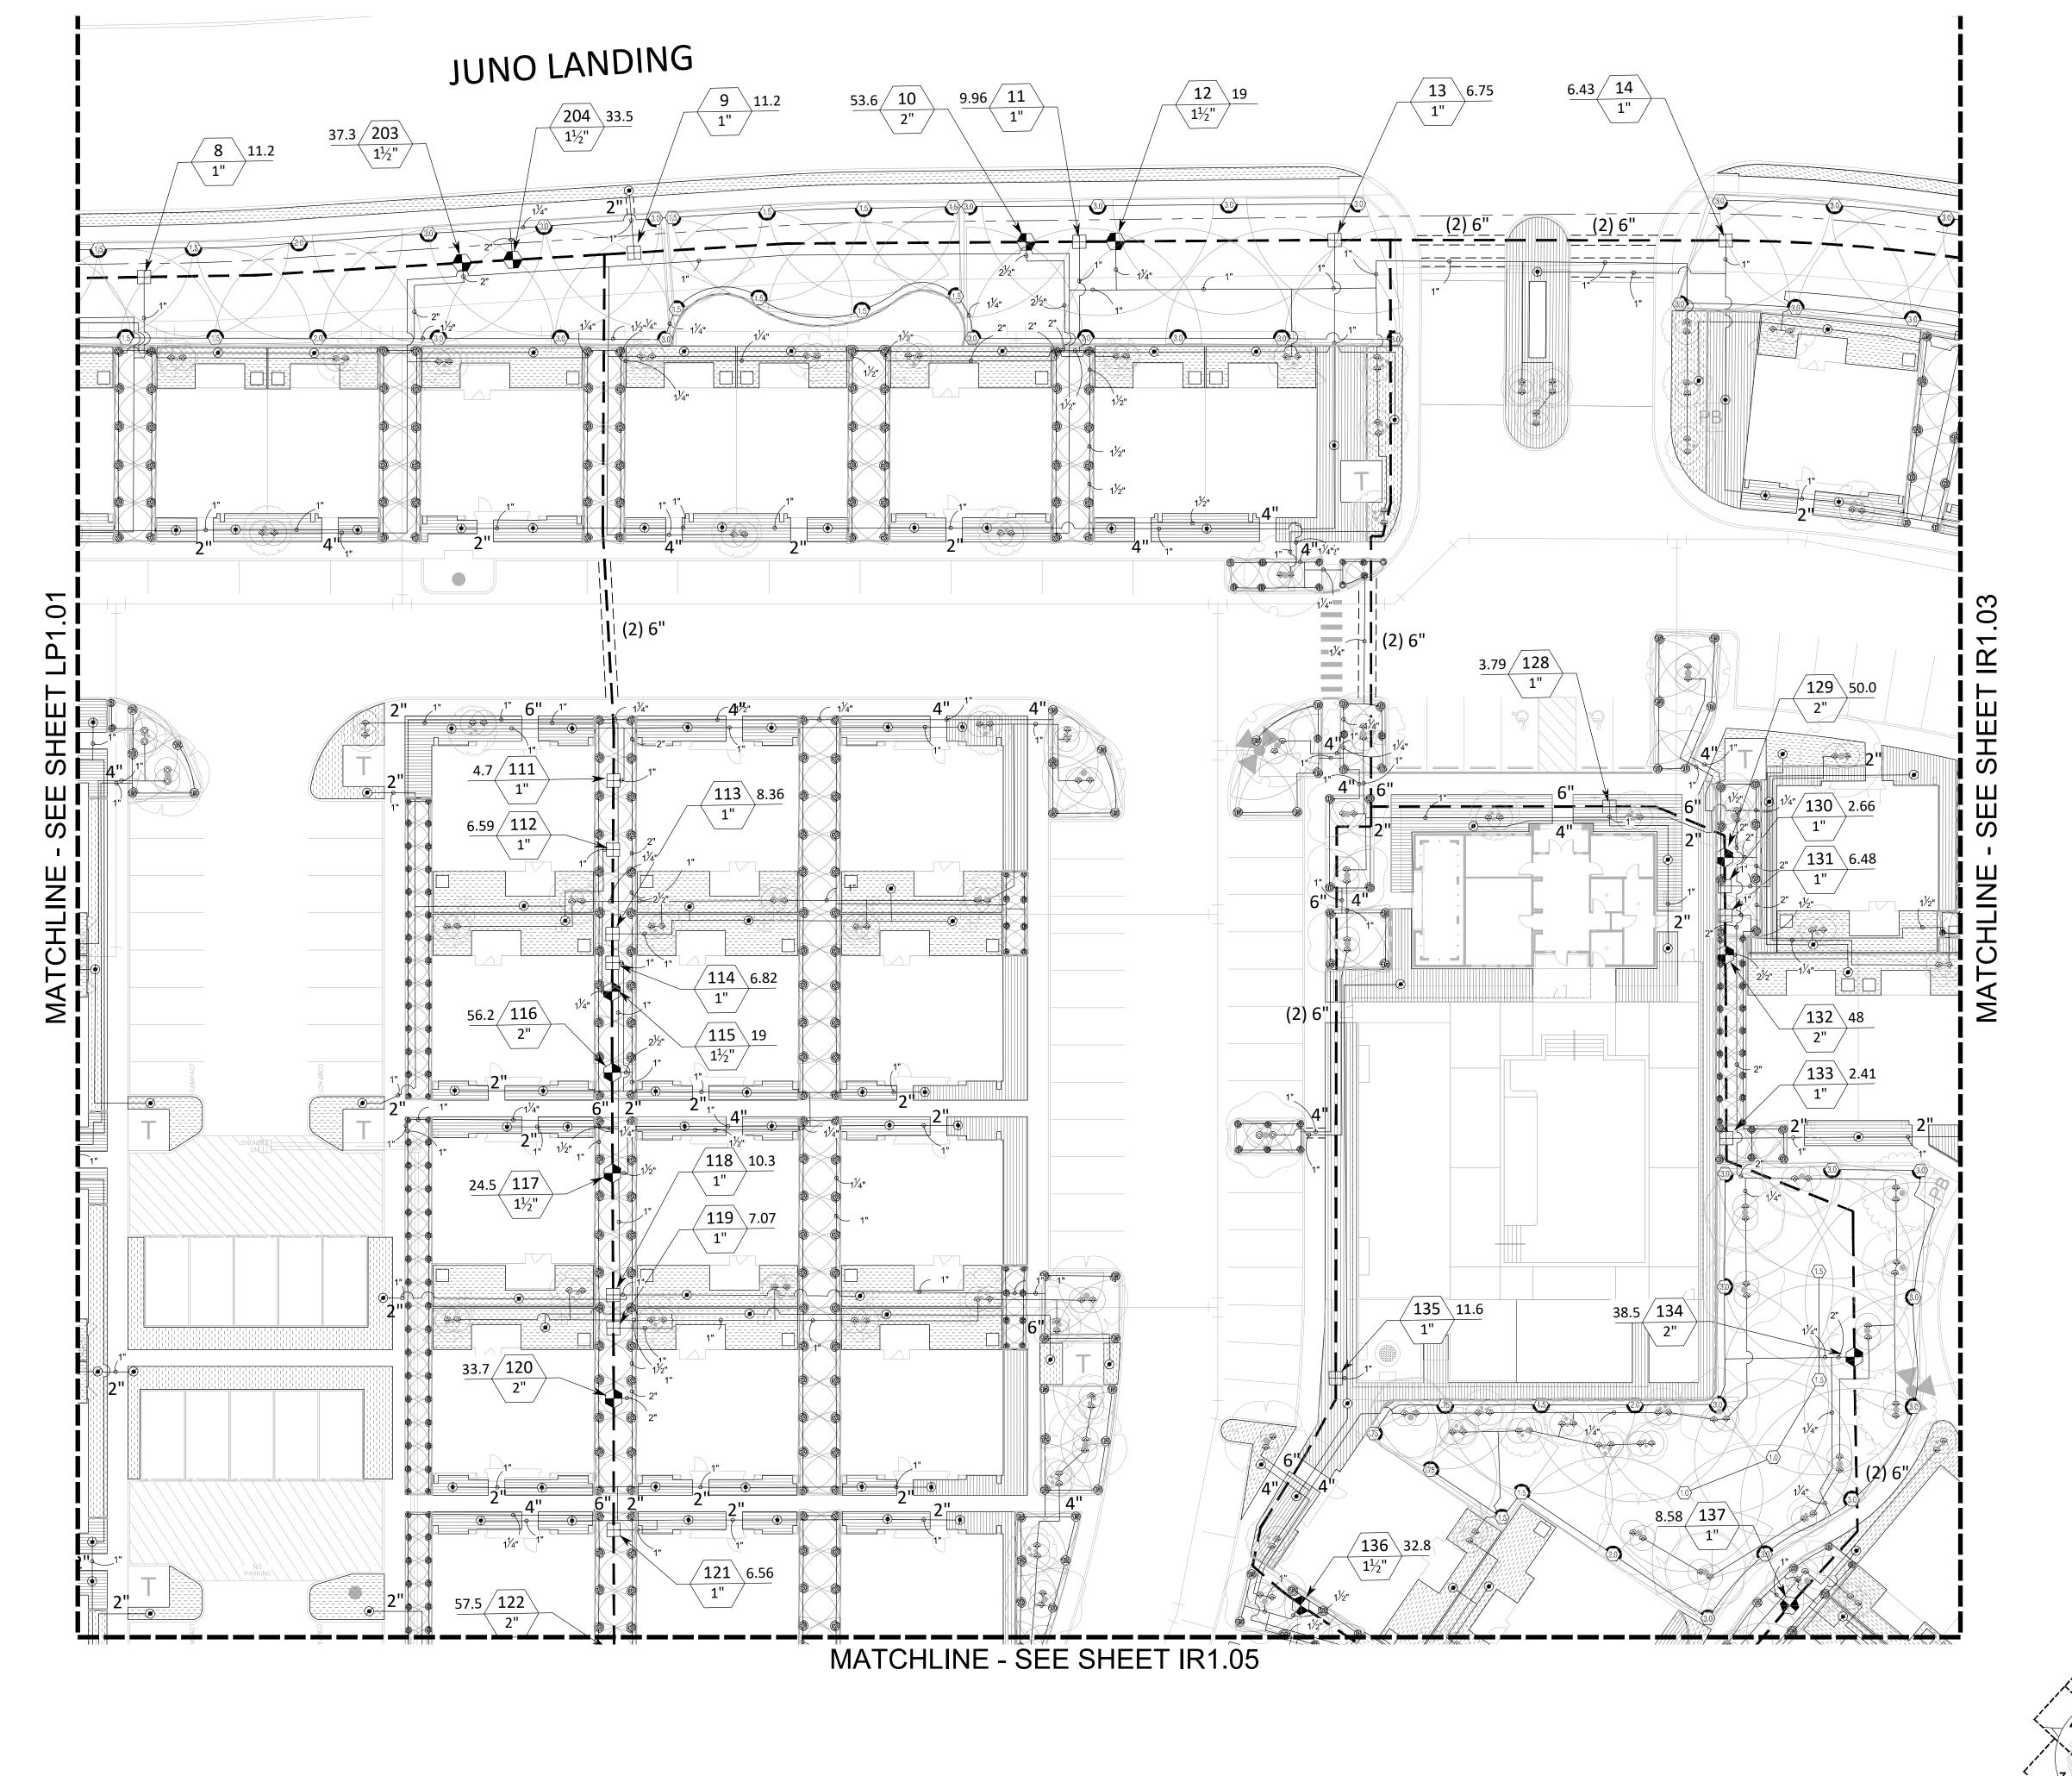NOTE:

CONTRACTOR TO PROVIDE PIPE APPROPRIATE SIZED SLEEVES (2X GREATER THAN PIPE SIZE) WHERE LATERAL AND MAIN LINES CROSS UNDER SIDEWALKS AND PAVEMENT.



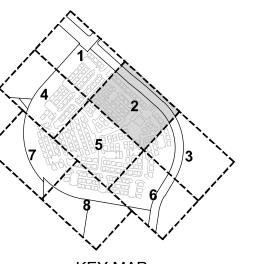

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10003 TECHNOLOGY BLVD. WEST DALLAS, TX. 75220 972-620-8204 REGISTRATION NO: F-1629

CLIENT INFO

CLIENT NAME ADDRESS CITY, STATE, ZIP CODE

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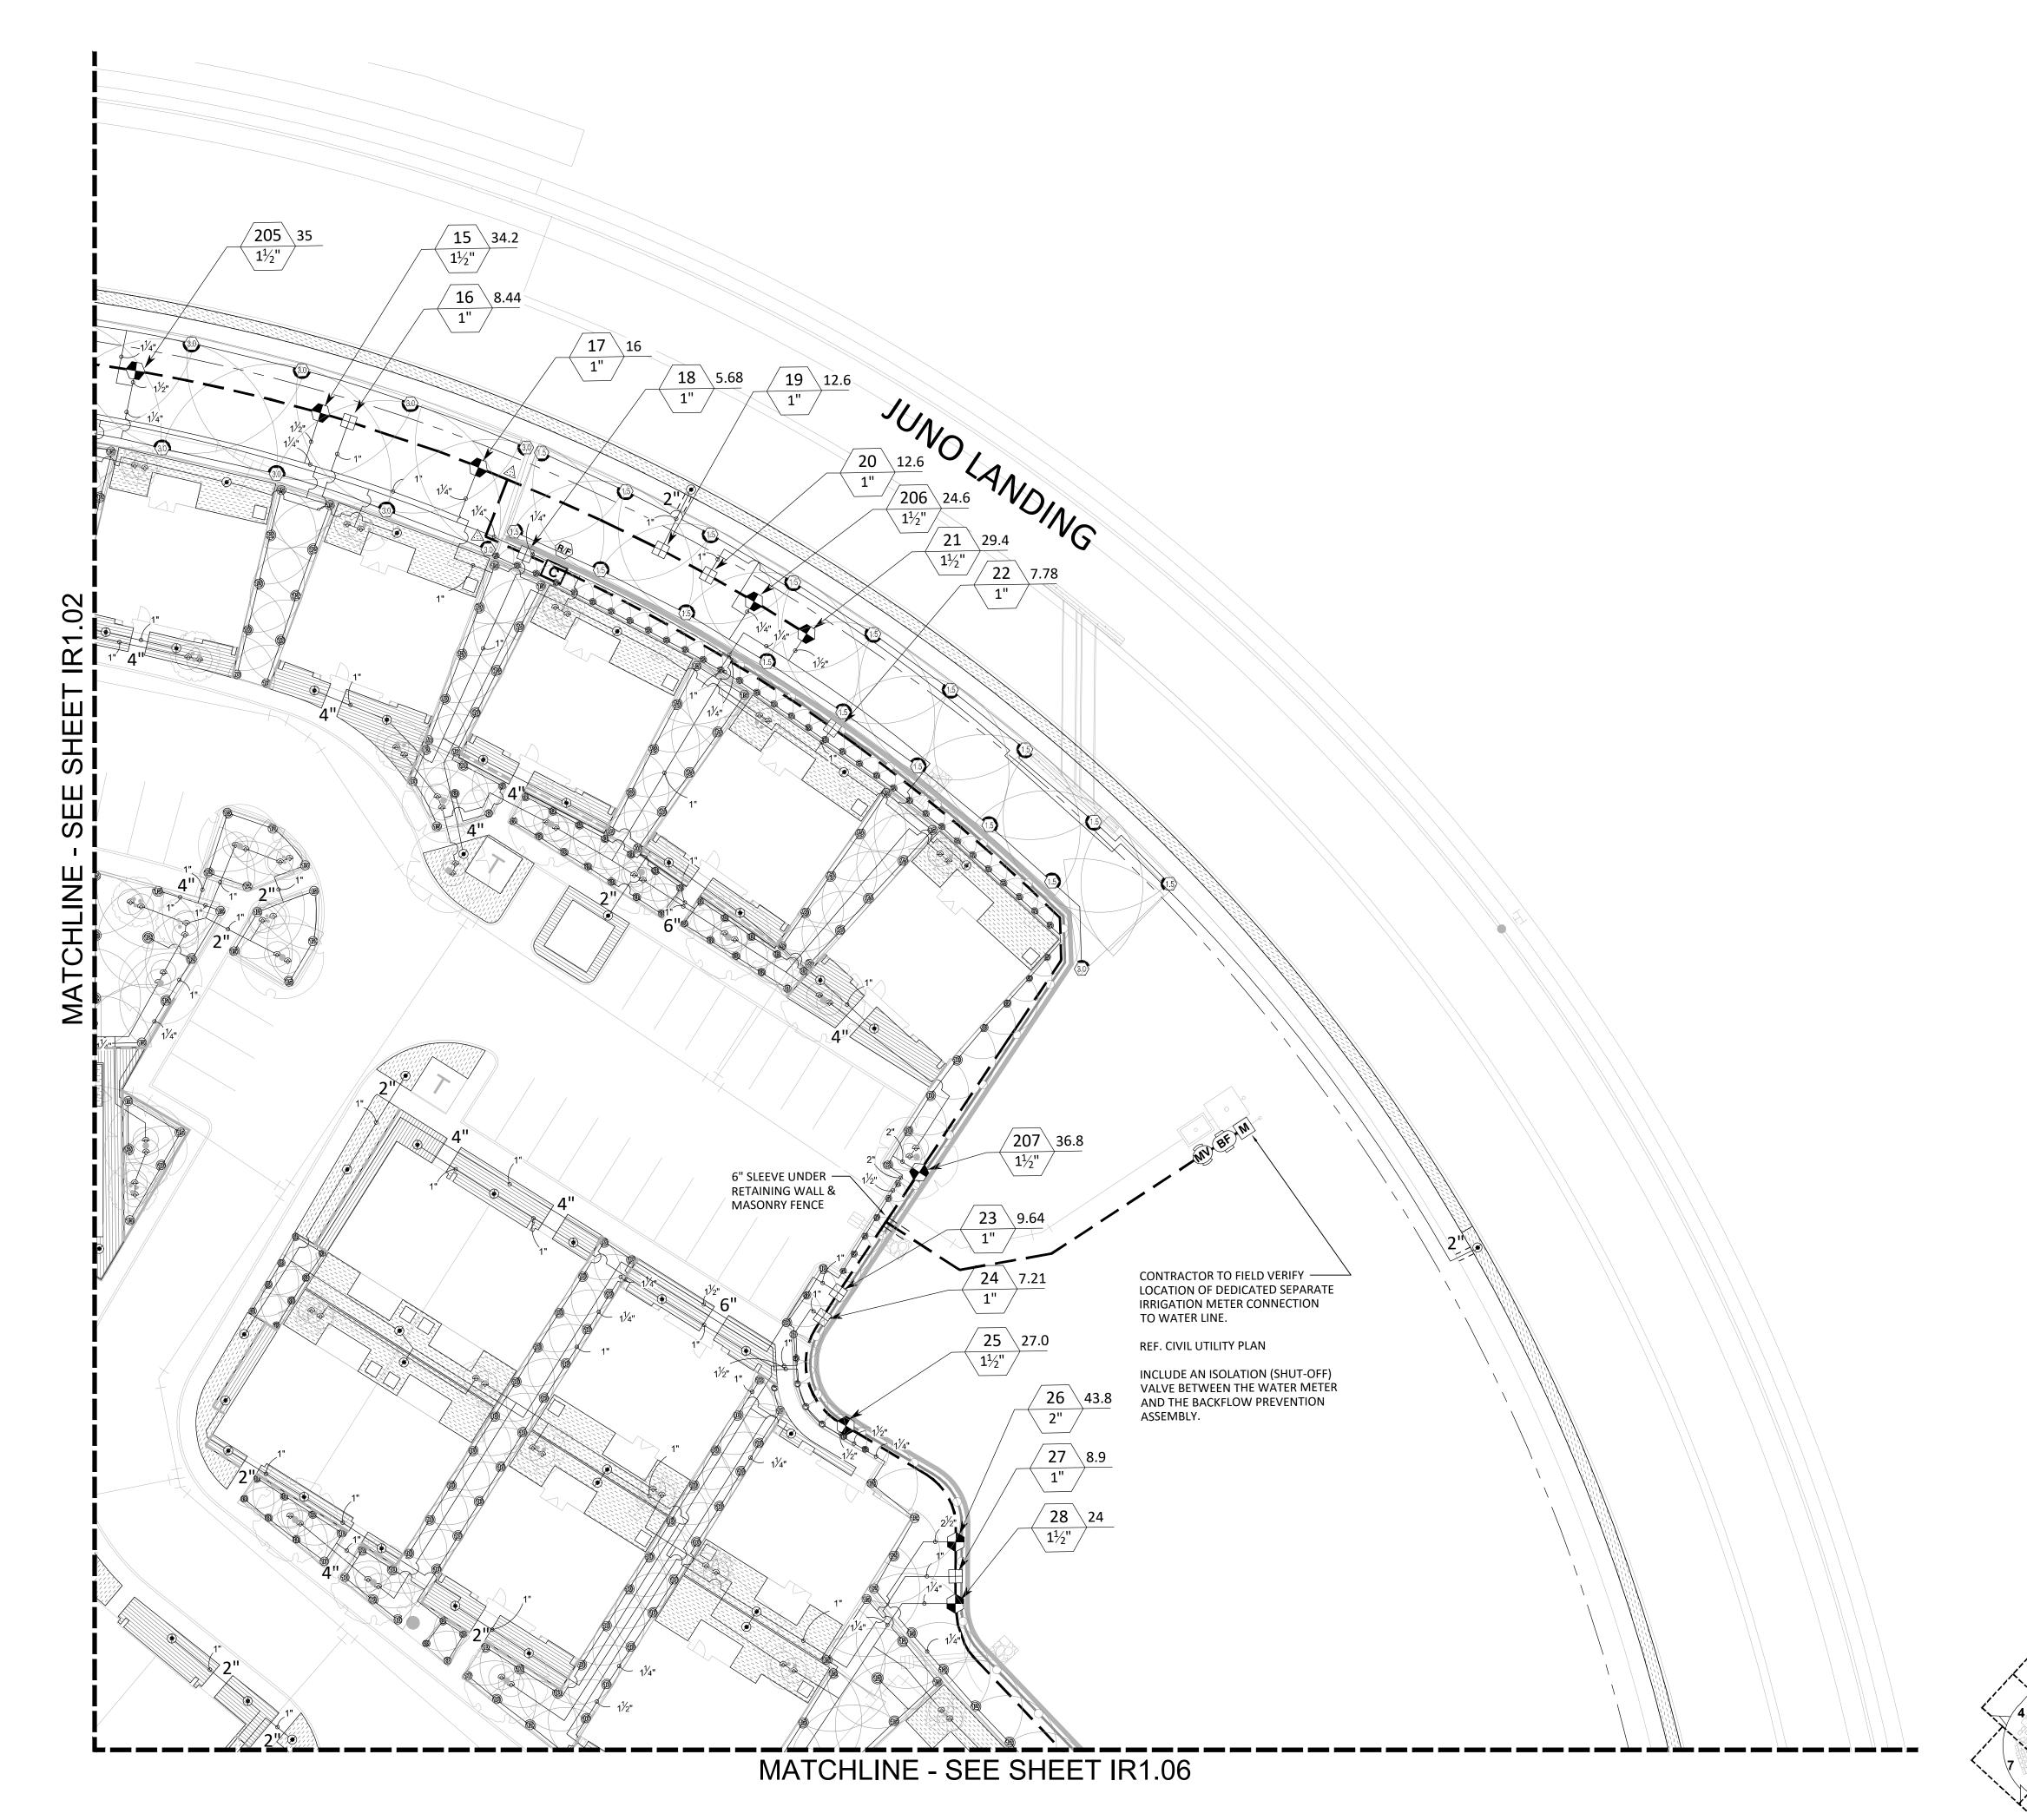
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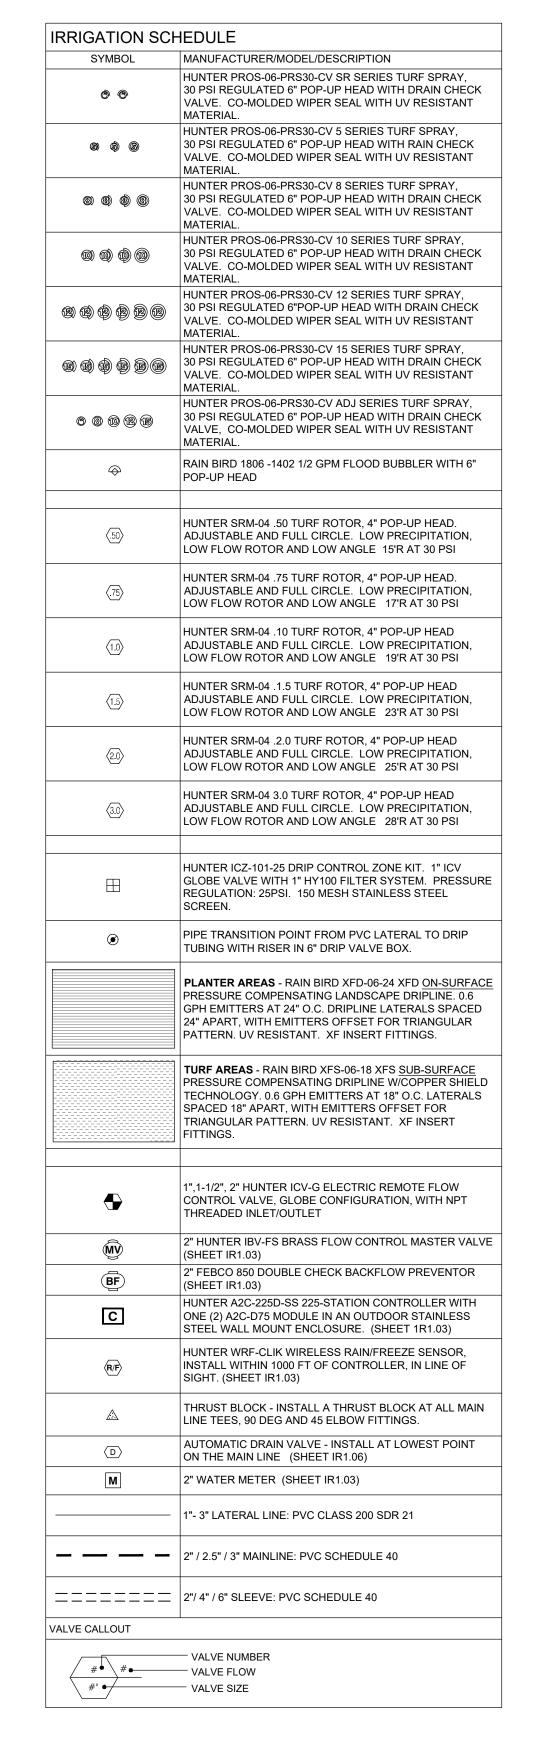
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IRRIGATION PLAN

SHEET NO.


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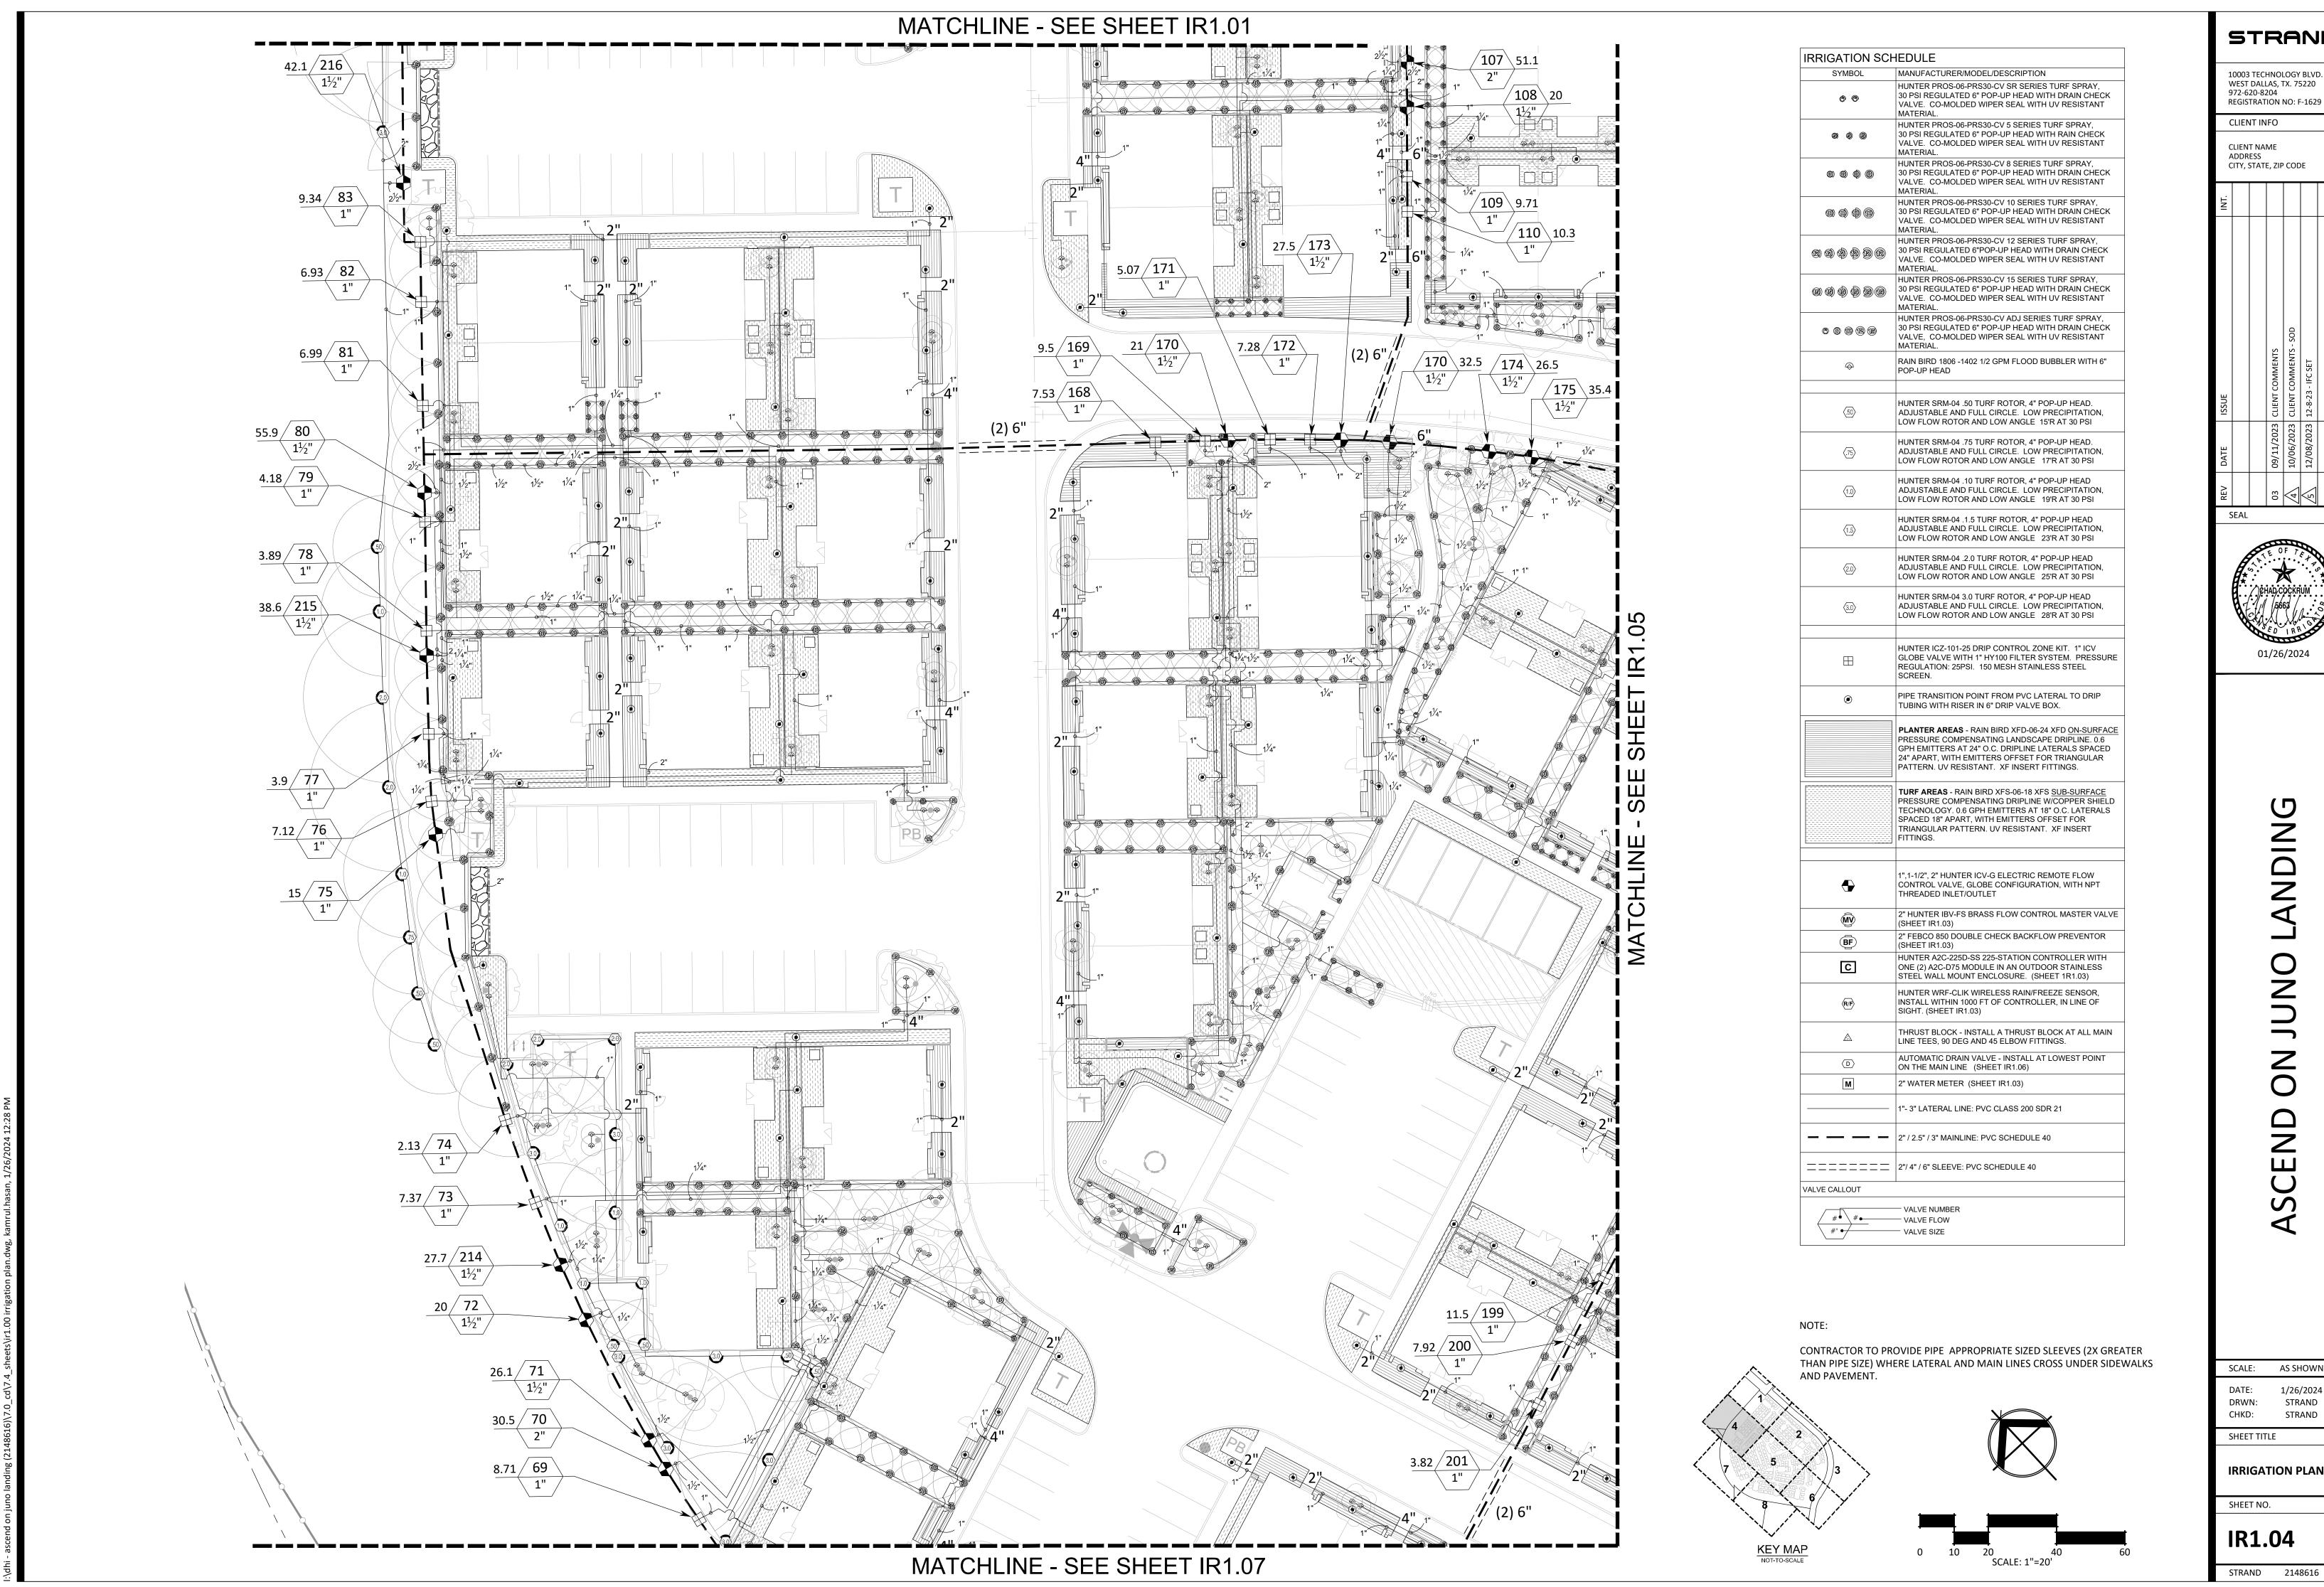
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IRRIGATION PLAN

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SHEET NO.



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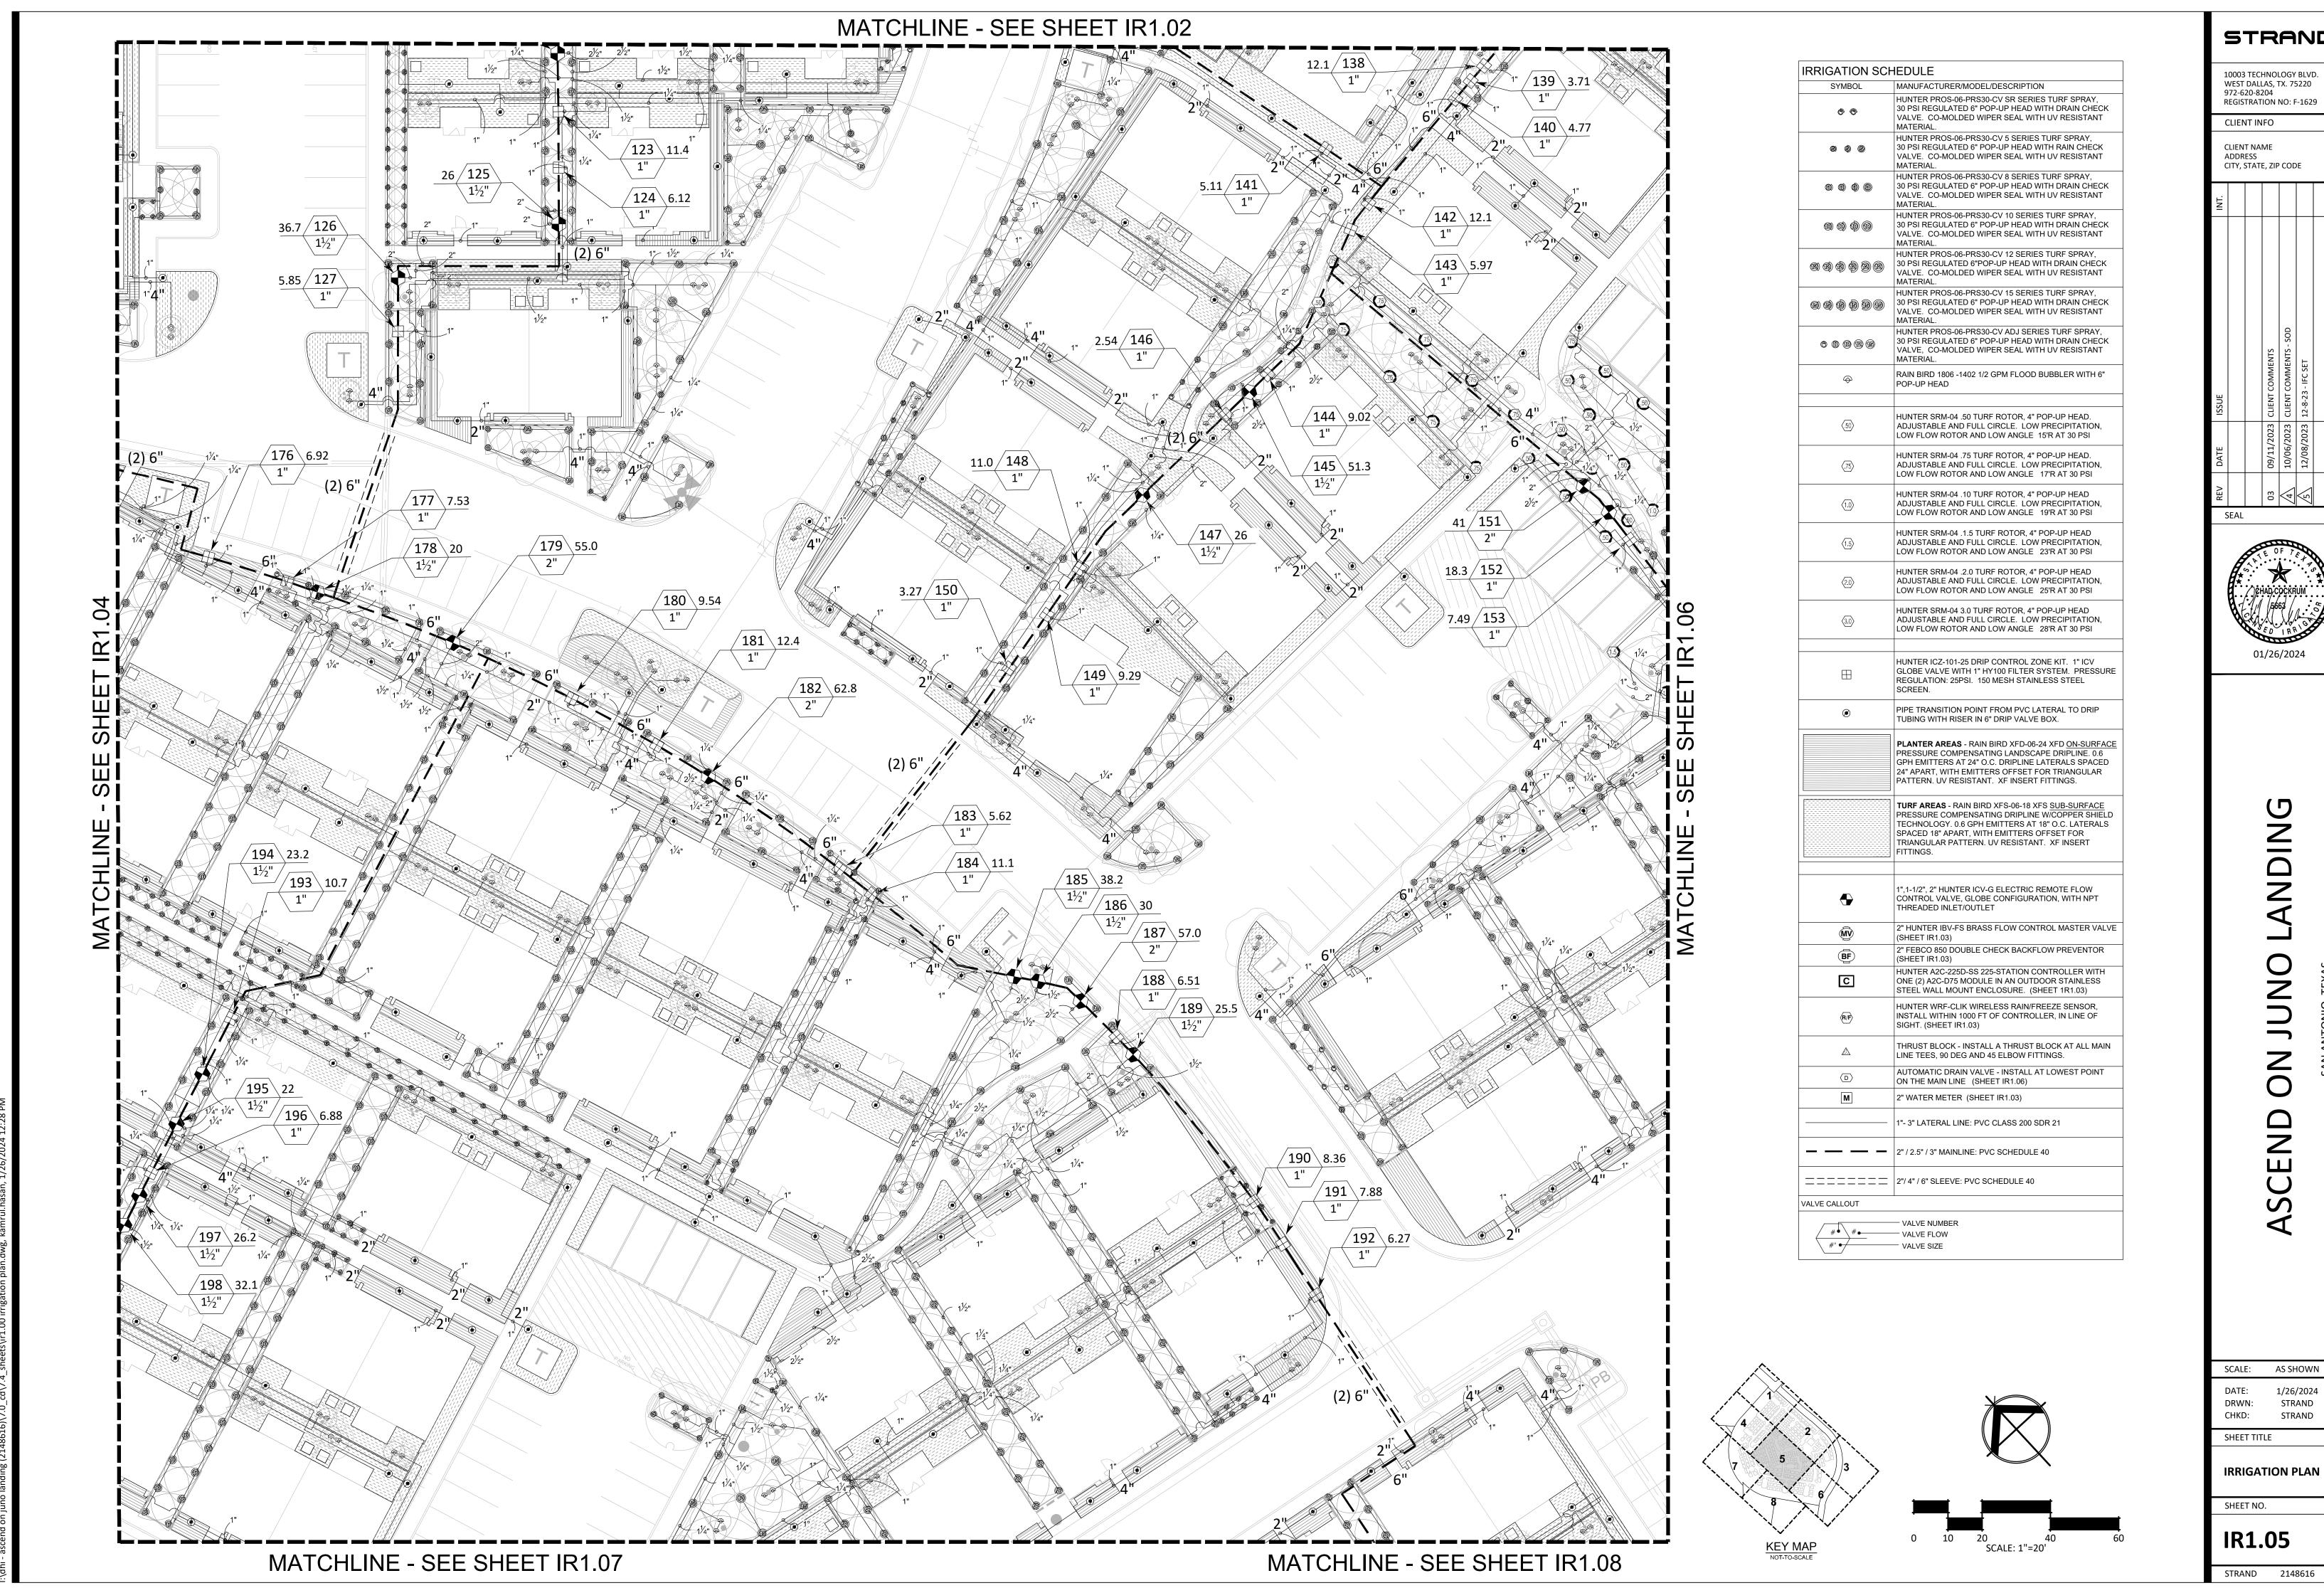
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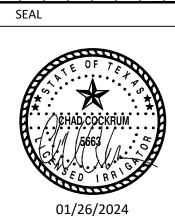
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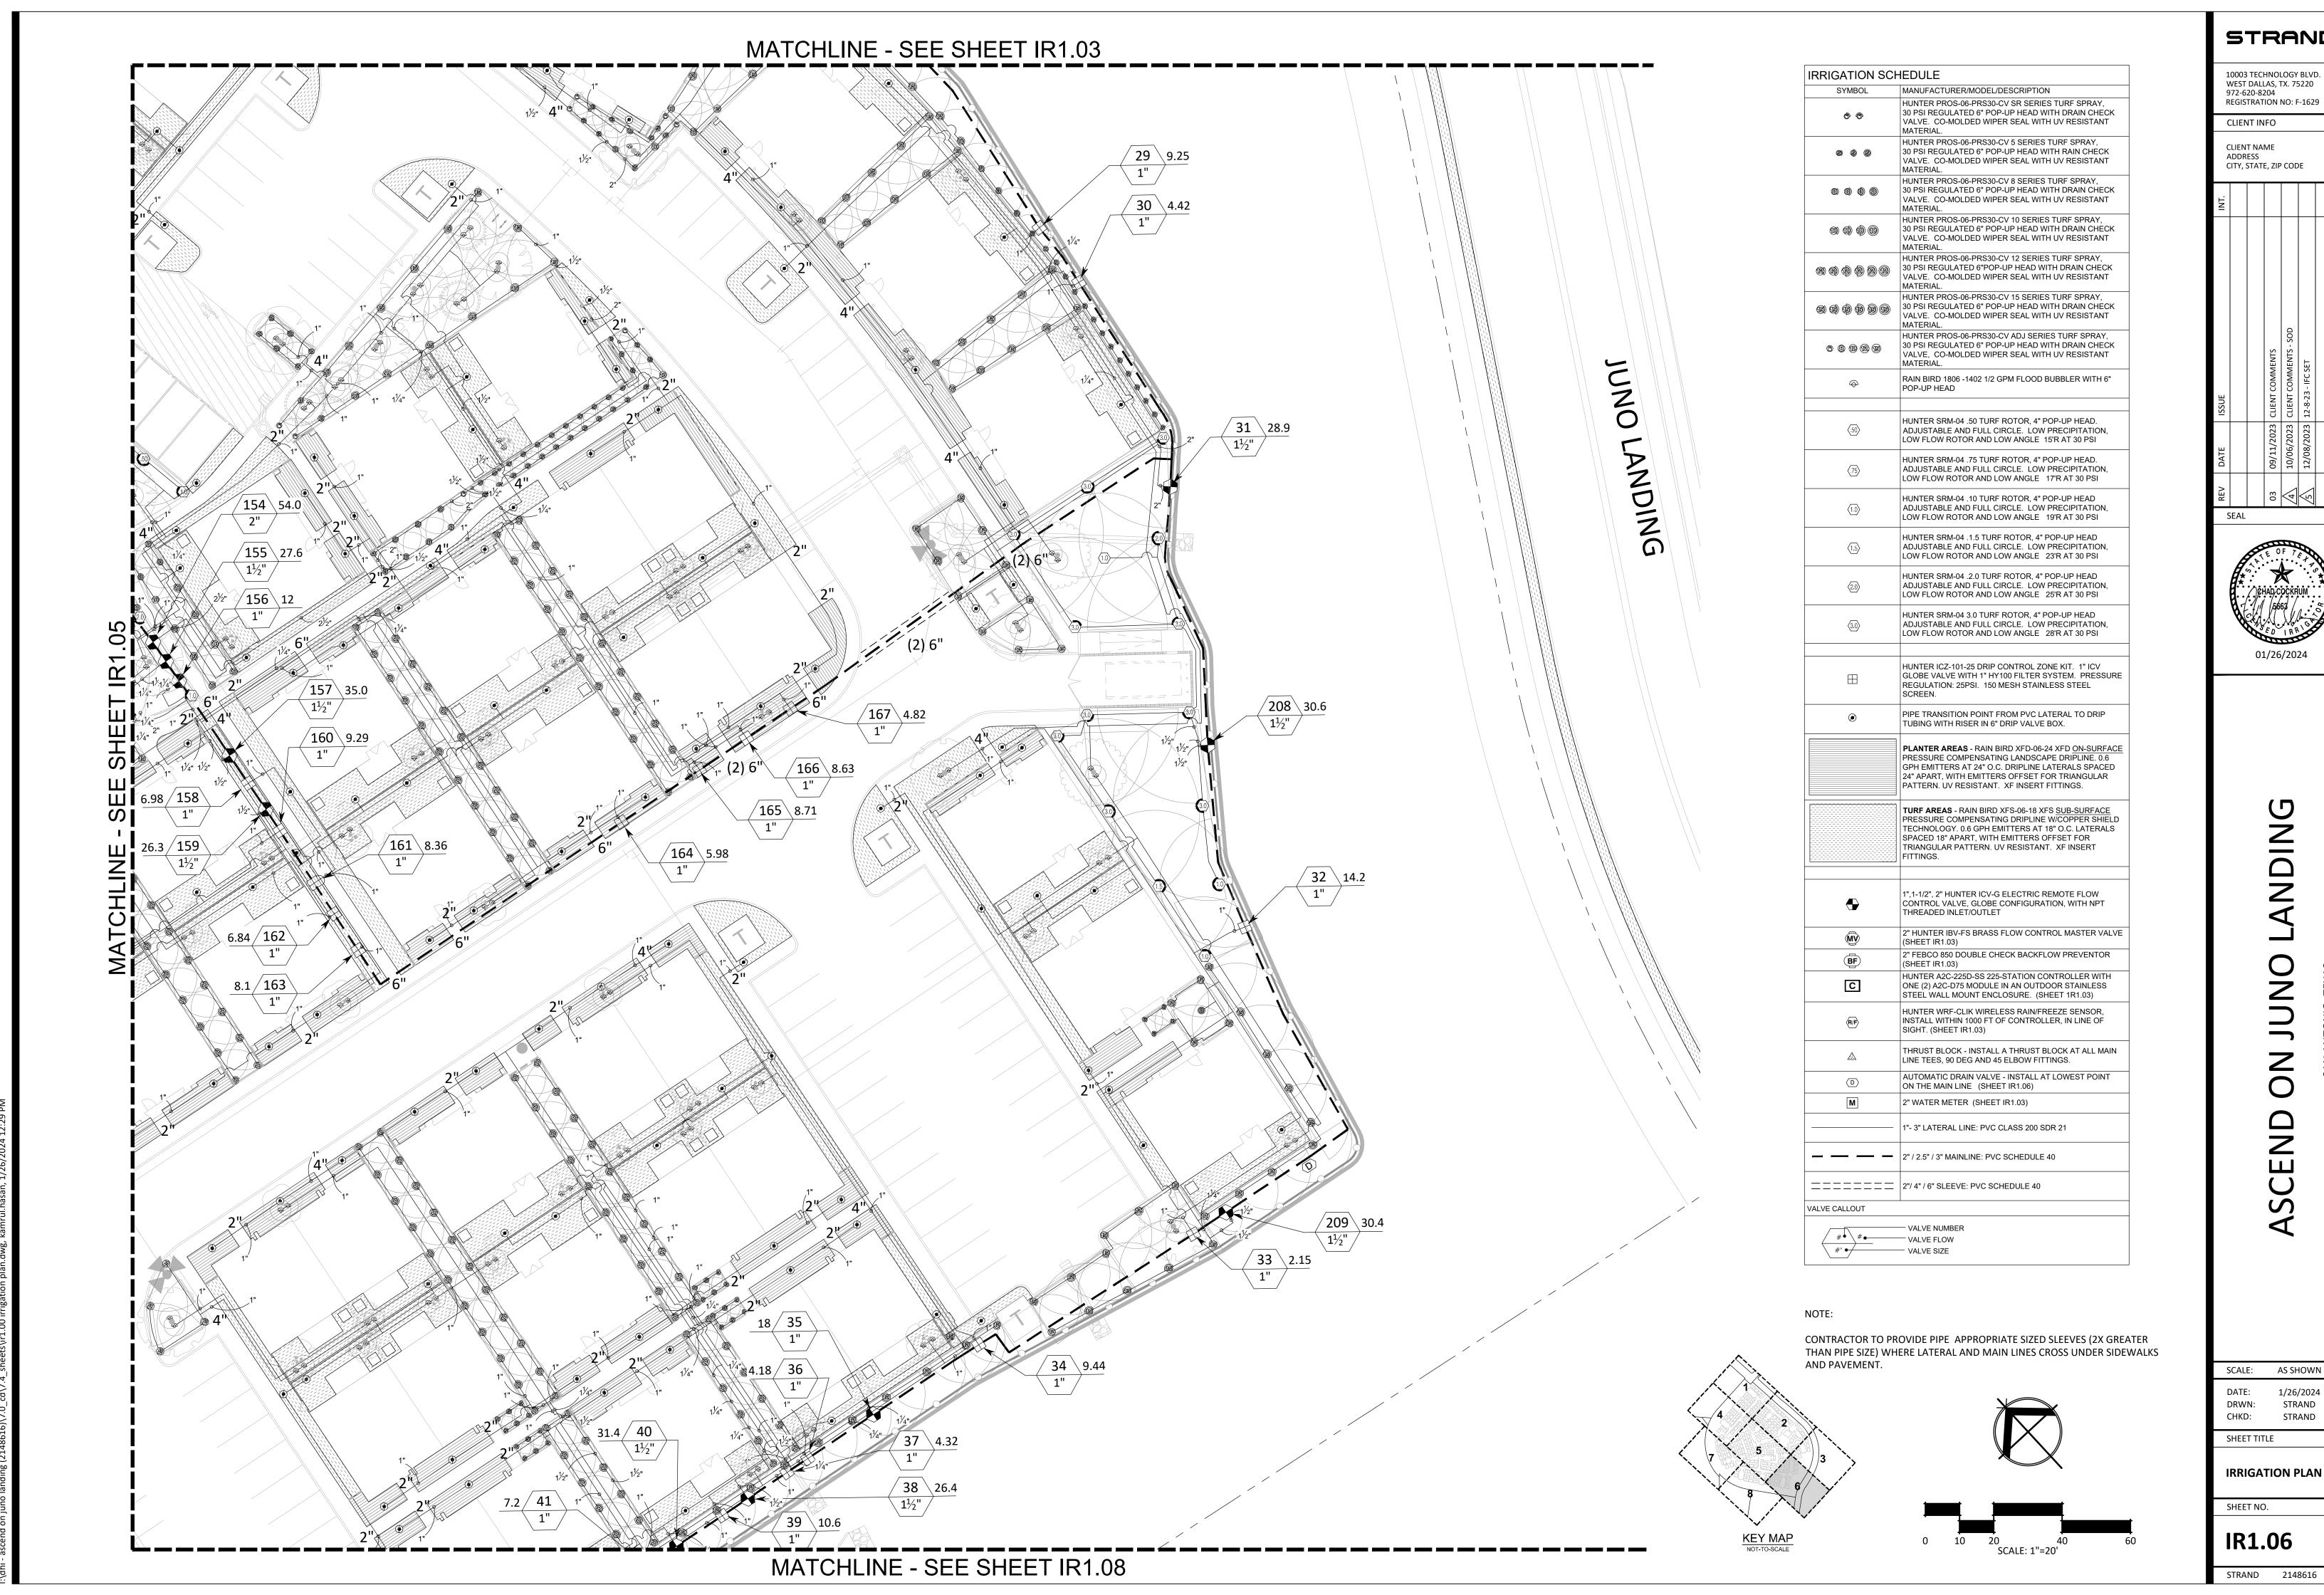
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IRRIGATION PLAN




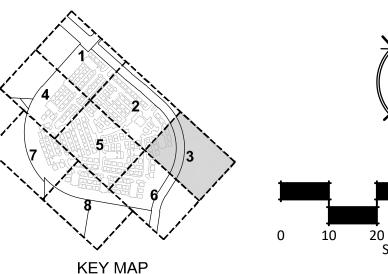

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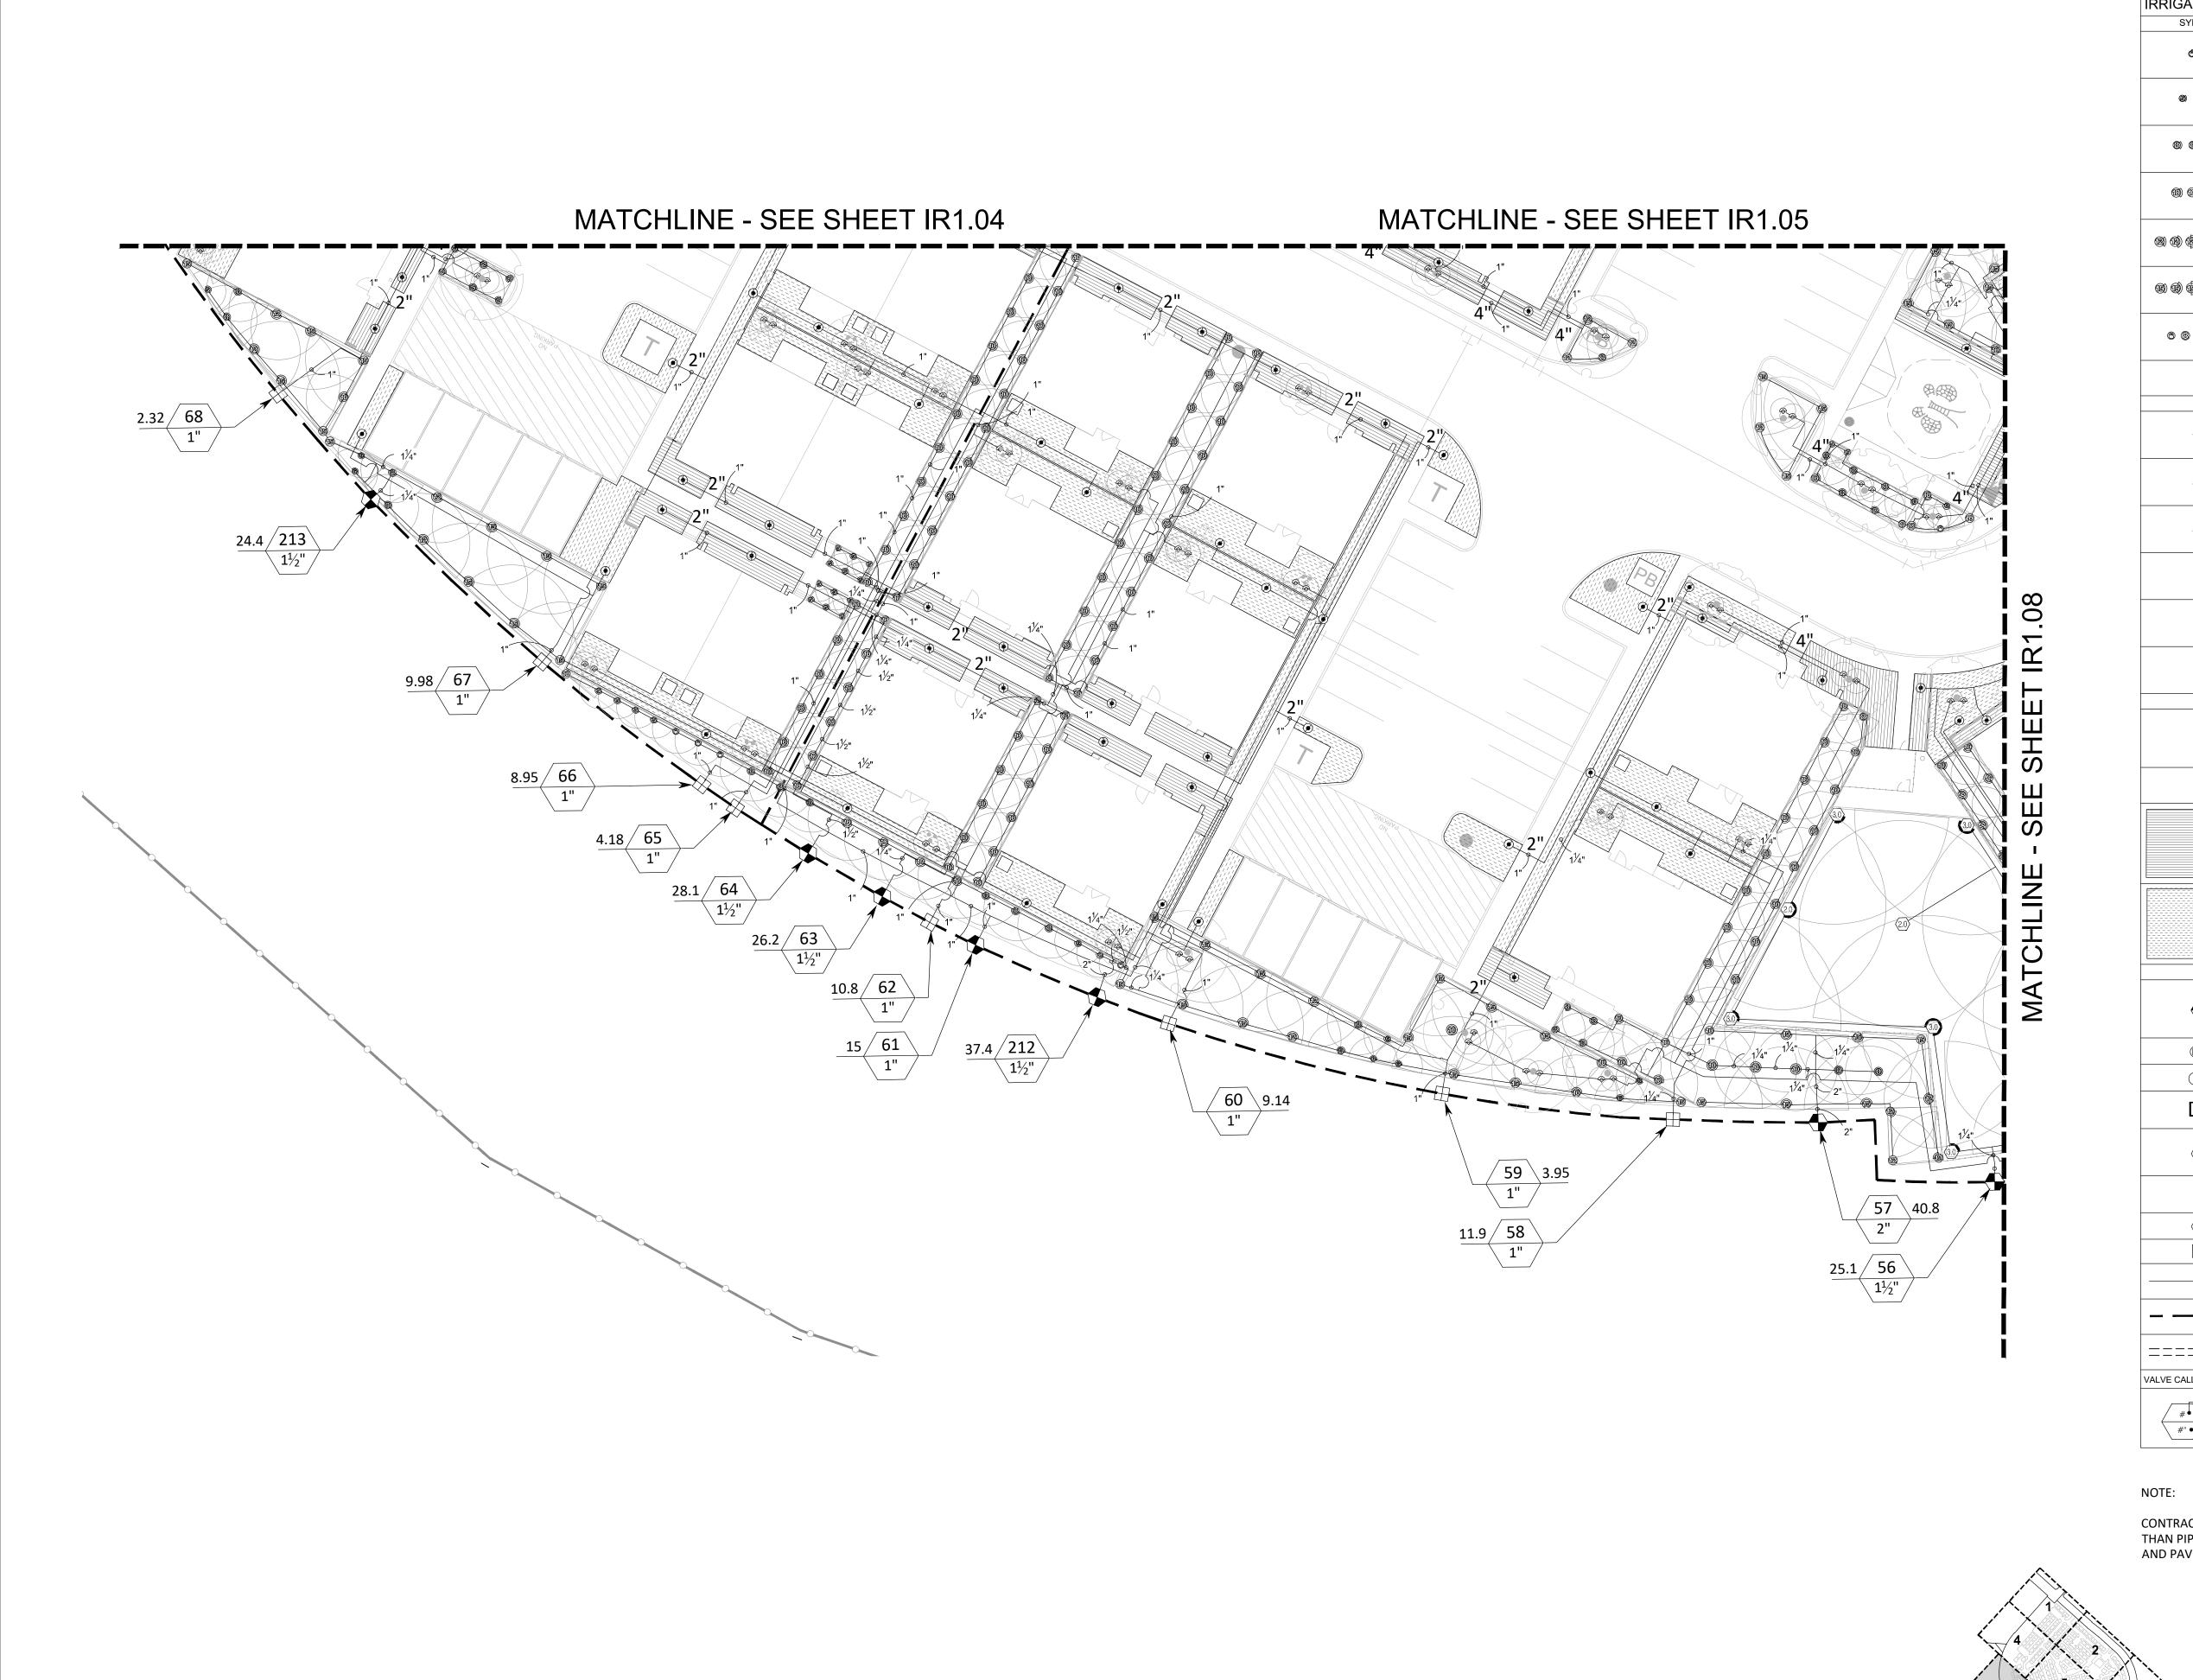
WEST DALLAS, TX. 75220 972-620-8204



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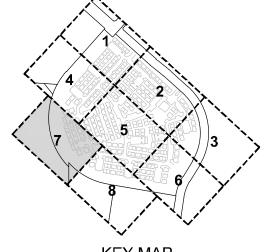
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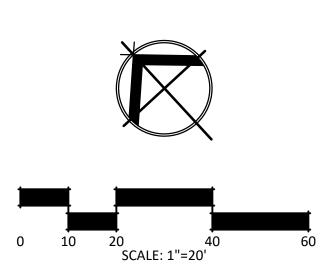
IRRIGATION PLAN

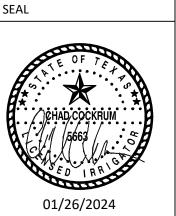

SYMBOL	MANUFACTURER/MODEL/DESCRIPTION
	HUNTER PROS-06-PRS30-CV SR SERIES TURF SPRAY,
6	30 PSI REGULATED 6" POP-UP HEAD WITH DRAIN CHEC VALVE. CO-MOLDED WIPER SEAL WITH UV RESISTANT
	MATERIAL. HUNTER PROS-06-PRS30-CV 5 SERIES TURF SPRAY,
69 69 69	30 PSI REGULATED 6" POP-UP HEAD WITH RAIN CHECK
	VALVE. CO-MOLDED WIPER SEAL WITH UV RESISTANT MATERIAL.
(3) (3) (3) (3)	HUNTER PROS-06-PRS30-CV 8 SERIES TURF SPRAY, 30 PSI REGULATED 6" POP-UP HEAD WITH DRAIN CHEC
<u> </u>	VALVE. CO-MOLDED WIPER SEAL WITH UV RESISTANT MATERIAL.
	HUNTER PROS-06-PRS30-CV 10 SERIES TURF SPRAY,
(3) (4) (4) (6)	30 PSI REGULATED 6" POP-UP HEAD WITH DRAIN CHEC VALVE. CO-MOLDED WIPER SEAL WITH UV RESISTANT
	MATERIAL. HUNTER PROS-06-PRS30-CV 12 SERIES TURF SPRAY,
Ø Ø Ø Ø Ø	30 PSI REGULATED 6"POP-UP HEAD WITH DRAIN CHEC VALVE. CO-MOLDED WIPER SEAL WITH UV RESISTANT
	MATERIAL.
60 60 60 60 60 60 60 60 60 60 60 60 60 6	HUNTER PROS-06-PRS30-CV 15 SERIES TURF SPRAY, 30 PSI REGULATED 6" POP-UP HEAD WITH DRAIN CHEC
	VALVE. CO-MOLDED WIPER SEAL WITH UV RESISTANT MATERIAL.
	HUNTER PROS-06-PRS30-CV ADJ SERIES TURF SPRAY, 30 PSI REGULATED 6" POP-UP HEAD WITH DRAIN CHEC
O 3 10 12 15	VALVE, CO-MOLDED WIPER SEAL WITH UV RESISTANT
	MATERIAL.
⇔	RAIN BIRD 1806 -1402 1/2 GPM FLOOD BUBBLER WITH 6 POP-UP HEAD
	HUNTER SRM-04 .50 TURF ROTOR, 4" POP-UP HEAD.
(.50)	ADJUSTABLE AND FULL CIRCLE. LOW PRECIPITATION, LOW FLOW ROTOR AND LOW ANGLE 15'R AT 30 PSI
	HUNTER SRM-04 .75 TURF ROTOR, 4" POP-UP HEAD.
(.75)	ADJUSTABLE AND FULL CIRCLE. LOW PRECIPITATION, LOW FLOW ROTOR AND LOW ANGLE 17'R AT 30 PSI
	LOW FLOW ROTOR AND LOW ANGLE 17 R AT 30 F31
(1.0)	HUNTER SRM-04 .10 TURF ROTOR, 4" POP-UP HEAD ADJUSTABLE AND FULL CIRCLE. LOW PRECIPITATION,
	LOW FLOW ROTOR AND LOW ANGLE 19'R AT 30 PSI
_	HUNTER SRM-04 .1.5 TURF ROTOR, 4" POP-UP HEAD ADJUSTABLE AND FULL CIRCLE. LOW PRECIPITATION,
⟨1.5⟩	LOW FLOW ROTOR AND LOW ANGLE 23'R AT 30 PSI
	HUNTER SRM-04 .2.0 TURF ROTOR, 4" POP-UP HEAD
2.0	ADJUSTABLE AND FULL CIRCLE. LOW PRECIPITATION, LOW FLOW ROTOR AND LOW ANGLE 25'R AT 30 PSI
(3.0)	HUNTER SRM-04 3.0 TURF ROTOR, 4" POP-UP HEAD ADJUSTABLE AND FULL CIRCLE. LOW PRECIPITATION,
_	LOW FLOW ROTOR AND LOW ANGLE 28'R AT 30 PSI
Ħ	HUNTER ICZ-101-25 DRIP CONTROL ZONE KIT. 1" ICV GLOBE VALVE WITH 1" HY100 FILTER SYSTEM. PRESSL
Ш	REGULATION: 25PSI. 150 MESH STAINLESS STEEL SCREEN.
	PIPE TRANSITION POINT FROM PVC LATERAL TO DRIP
●	TUBING WITH RISER IN 6" DRIP VALVE BOX.
	PLANTER AREAS - RAIN BIRD XFD-06-24 XFD ON-SURFA
	PRESSURE COMPENSATING LANDSCAPE DRIPLINE. 0.6 GPH EMITTERS AT 24" O.C. DRIPLINE LATERALS SPACE
	24" APART, WITH EMITTERS OFFSET FOR TRIANGULAR
	PATTERN. UV RESISTANT. XF INSERT FITTINGS.
	TUBE ABEAG DAIN DIDD VEG ON 40 VEG OUD OUDEAGE
	PRESSURE COMPENSATING DRIPLINE W/COPPER SHIE TECHNOLOGY. 0.6 GPH EMITTERS AT 18" O.C. LATERAL
	PRESSURE COMPENSATING DRIPLINE W/COPPER SHIE
	PRESSURE COMPENSATING DRIPLINE W/COPPER SHIE TECHNOLOGY. 0.6 GPH EMITTERS AT 18" O.C. LATERAL SPACED 18" APART, WITH EMITTERS OFFSET FOR
	PRESSURE COMPENSATING DRIPLINE W/COPPER SHIE TECHNOLOGY. 0.6 GPH EMITTERS AT 18" O.C. LATERAL SPACED 18" APART, WITH EMITTERS OFFSET FOR TRIANGULAR PATTERN. UV RESISTANT. XF INSERT
	PRESSURE COMPENSATING DRIPLINE W/COPPER SHIE TECHNOLOGY. 0.6 GPH EMITTERS AT 18" O.C. LATERAL SPACED 18" APART, WITH EMITTERS OFFSET FOR TRIANGULAR PATTERN. UV RESISTANT. XF INSERT FITTINGS. 1",1-1/2", 2" HUNTER ICV-G ELECTRIC REMOTE FLOW
	PRESSURE COMPENSATING DRIPLINE W/COPPER SHIE TECHNOLOGY. 0.6 GPH EMITTERS AT 18" O.C. LATERAL SPACED 18" APART, WITH EMITTERS OFFSET FOR TRIANGULAR PATTERN. UV RESISTANT. XF INSERT FITTINGS.
•	PRESSURE COMPENSATING DRIPLINE W/COPPER SHIE TECHNOLOGY. 0.6 GPH EMITTERS AT 18" O.C. LATERAL SPACED 18" APART, WITH EMITTERS OFFSET FOR TRIANGULAR PATTERN. UV RESISTANT. XF INSERT FITTINGS. 1",1-1/2", 2" HUNTER ICV-G ELECTRIC REMOTE FLOW CONTROL VALVE, GLOBE CONFIGURATION, WITH NPT THREADED INLET/OUTLET
(W)	PRESSURE COMPENSATING DRIPLINE W/COPPER SHIE TECHNOLOGY. 0.6 GPH EMITTERS AT 18" O.C. LATERAL SPACED 18" APART, WITH EMITTERS OFFSET FOR TRIANGULAR PATTERN. UV RESISTANT. XF INSERT FITTINGS. 1",1-1/2", 2" HUNTER ICV-G ELECTRIC REMOTE FLOW CONTROL VALVE, GLOBE CONFIGURATION, WITH NPT THREADED INLET/OUTLET 2" HUNTER IBV-FS BRASS FLOW CONTROL MASTER VA (SHEET IR1.03)
•	PRESSURE COMPENSATING DRIPLINE W/COPPER SHIE TECHNOLOGY. 0.6 GPH EMITTERS AT 18" O.C. LATERAL SPACED 18" APART, WITH EMITTERS OFFSET FOR TRIANGULAR PATTERN. UV RESISTANT. XF INSERT FITTINGS. 1",1-1/2", 2" HUNTER ICV-G ELECTRIC REMOTE FLOW CONTROL VALVE, GLOBE CONFIGURATION, WITH NPT THREADED INLET/OUTLET 2" HUNTER IBV-FS BRASS FLOW CONTROL MASTER VA (SHEET IR1.03)
MV BF	PRESSURE COMPENSATING DRIPLINE W/COPPER SHIE TECHNOLOGY. 0.6 GPH EMITTERS AT 18" O.C. LATERAL SPACED 18" APART, WITH EMITTERS OFFSET FOR TRIANGULAR PATTERN. UV RESISTANT. XF INSERT FITTINGS. 1",1-1/2", 2" HUNTER ICV-G ELECTRIC REMOTE FLOW CONTROL VALVE, GLOBE CONFIGURATION, WITH NPT THREADED INLET/OUTLET 2" HUNTER IBV-FS BRASS FLOW CONTROL MASTER VA (SHEET IR1.03) 2" FEBCO 850 DOUBLE CHECK BACKFLOW PREVENTOR (SHEET IR1.03) HUNTER A2C-225D-SS 225-STATION CONTROLLER WITH
(MV) (BF)	PRESSURE COMPENSATING DRIPLINE W/COPPER SHIE TECHNOLOGY. 0.6 GPH EMITTERS AT 18" O.C. LATERAL SPACED 18" APART, WITH EMITTERS OFFSET FOR TRIANGULAR PATTERN. UV RESISTANT. XF INSERT FITTINGS. 1",1-1/2", 2" HUNTER ICV-G ELECTRIC REMOTE FLOW CONTROL VALVE, GLOBE CONFIGURATION, WITH NPT THREADED INLET/OUTLET 2" HUNTER IBV-FS BRASS FLOW CONTROL MASTER VA (SHEET IR1.03) 2" FEBCO 850 DOUBLE CHECK BACKFLOW PREVENTOR (SHEET IR1.03) HUNTER A2C-225D-SS 225-STATION CONTROLLER WITH
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MV BF C	PRESSURE COMPENSATING DRIPLINE W/COPPER SHIE TECHNOLOGY. 0.6 GPH EMITTERS AT 18" O.C. LATERAL SPACED 18" APART, WITH EMITTERS OFFSET FOR TRIANGULAR PATTERN. UV RESISTANT. XF INSERT FITTINGS. 1",1-1/2", 2" HUNTER ICV-G ELECTRIC REMOTE FLOW CONTROL VALVE, GLOBE CONFIGURATION, WITH NPT THREADED INLET/OUTLET 2" HUNTER IBV-FS BRASS FLOW CONTROL MASTER VA (SHEET IR1.03) 2" FEBCO 850 DOUBLE CHECK BACKFLOW PREVENTOR (SHEET IR1.03) HUNTER A2C-225D-SS 225-STATION CONTROLLER WITH ONE (2) A2C-D75 MODULE IN AN OUTDOOR STAINLESS STEEL WALL MOUNT ENCLOSURE. (SHEET 1R1.03)
MW BF C	PRESSURE COMPENSATING DRIPLINE W/COPPER SHIE TECHNOLOGY. 0.6 GPH EMITTERS AT 18" O.C. LATERAL SPACED 18" APART, WITH EMITTERS OFFSET FOR TRIANGULAR PATTERN. UV RESISTANT. XF INSERT FITTINGS. 1",1-1/2", 2" HUNTER ICV-G ELECTRIC REMOTE FLOW CONTROL VALVE, GLOBE CONFIGURATION, WITH NPT THREADED INLET/OUTLET 2" HUNTER IBV-FS BRASS FLOW CONTROL MASTER VA (SHEET IR1.03) 2" FEBCO 850 DOUBLE CHECK BACKFLOW PREVENTOF (SHEET IR1.03) HUNTER A2C-225D-SS 225-STATION CONTROLLER WITH ONE (2) A2C-D75 MODULE IN AN OUTDOOR STAINLESS STEEL WALL MOUNT ENCLOSURE. (SHEET 1R1.03) HUNTER WRF-CLIK WIRELESS RAIN/FREEZE SENSOR, INSTALL WITHIN 1000 FT OF CONTROLLER, IN LINE OF SIGHT. (SHEET IR1.03)
MW BF C RIF	PRESSURE COMPENSATING DRIPLINE W/COPPER SHIE TECHNOLOGY. 0.6 GPH EMITTERS AT 18" O.C. LATERAL SPACED 18" APART, WITH EMITTERS OFFSET FOR TRIANGULAR PATTERN. UV RESISTANT. XF INSERT FITTINGS. 1",1-1/2", 2" HUNTER ICV-G ELECTRIC REMOTE FLOW CONTROL VALVE, GLOBE CONFIGURATION, WITH NPT THREADED INLET/OUTLET 2" HUNTER IBV-FS BRASS FLOW CONTROL MASTER VA (SHEET IR1.03) 2" FEBCO 850 DOUBLE CHECK BACKFLOW PREVENTOF (SHEET IR1.03) HUNTER A2C-225D-SS 225-STATION CONTROLLER WITH ONE (2) A2C-D75 MODULE IN AN OUTDOOR STAINLESS STEEL WALL MOUNT ENCLOSURE. (SHEET 1R1.03) HUNTER WRF-CLIK WIRELESS RAIN/FREEZE SENSOR, INSTALL WITHIN 1000 FT OF CONTROLLER, IN LINE OF SIGHT. (SHEET IR1.03)
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(MV) (BF) (C) (R/F) (A) (D) (M) (D) (M) (D) (D) (D) (D) (D) (D) (D) (D) (D) (D	TRIANGULAR PATTERN. UV RESISTANT. XF INSERT FITTINGS. 1",1-1/2", 2" HUNTER ICV-G ELECTRIC REMOTE FLOW CONTROL VALVE, GLOBE CONFIGURATION, WITH NPT THREADED INLET/OUTLET 2" HUNTER IBV-FS BRASS FLOW CONTROL MASTER VAI (SHEET IR1.03) 2" FEBCO 850 DOUBLE CHECK BACKFLOW PREVENTOR (SHEET IR1.03) HUNTER A2C-225D-SS 225-STATION CONTROLLER WITH ONE (2) A2C-D75 MODULE IN AN OUTDOOR STAINLESS STEEL WALL MOUNT ENCLOSURE. (SHEET 1R1.03) HUNTER WRF-CLIK WIRELESS RAIN/FREEZE SENSOR, INSTALL WITHIN 1000 FT OF CONTROLLER, IN LINE OF SIGHT. (SHEET IR1.03) THRUST BLOCK - INSTALL A THRUST BLOCK AT ALL MALINE TEES, 90 DEG AND 45 ELBOW FITTINGS. AUTOMATIC DRAIN VALVE - INSTALL AT LOWEST POINT ON THE MAIN LINE (SHEET IR1.03) 1"- 3" LATERAL LINE: PVC CLASS 200 SDR 21 2" / 2.5" / 3" MAINLINE: PVC SCHEDULE 40

CONTRACTOR TO PROVIDE PIPE APPROPRIATE SIZED SLEEVES (2X GREATER THAN PIPE SIZE) WHERE LATERAL AND MAIN LINES CROSS UNDER SIDEWALKS AND PAVEMENT.





STRAND

10003 TECHNOLOGY BLVD. WEST DALLAS, TX. 75220 972-620-8204 REGISTRATION NO: F-1629


CLIENT NAME ADDRESS CITY, STATE, ZIP CODE


SCALE: AS SHOWN

CHKD: STRAND SHEET TITLE


IRRIGATION PLAN SHEET NO.


IR1.07

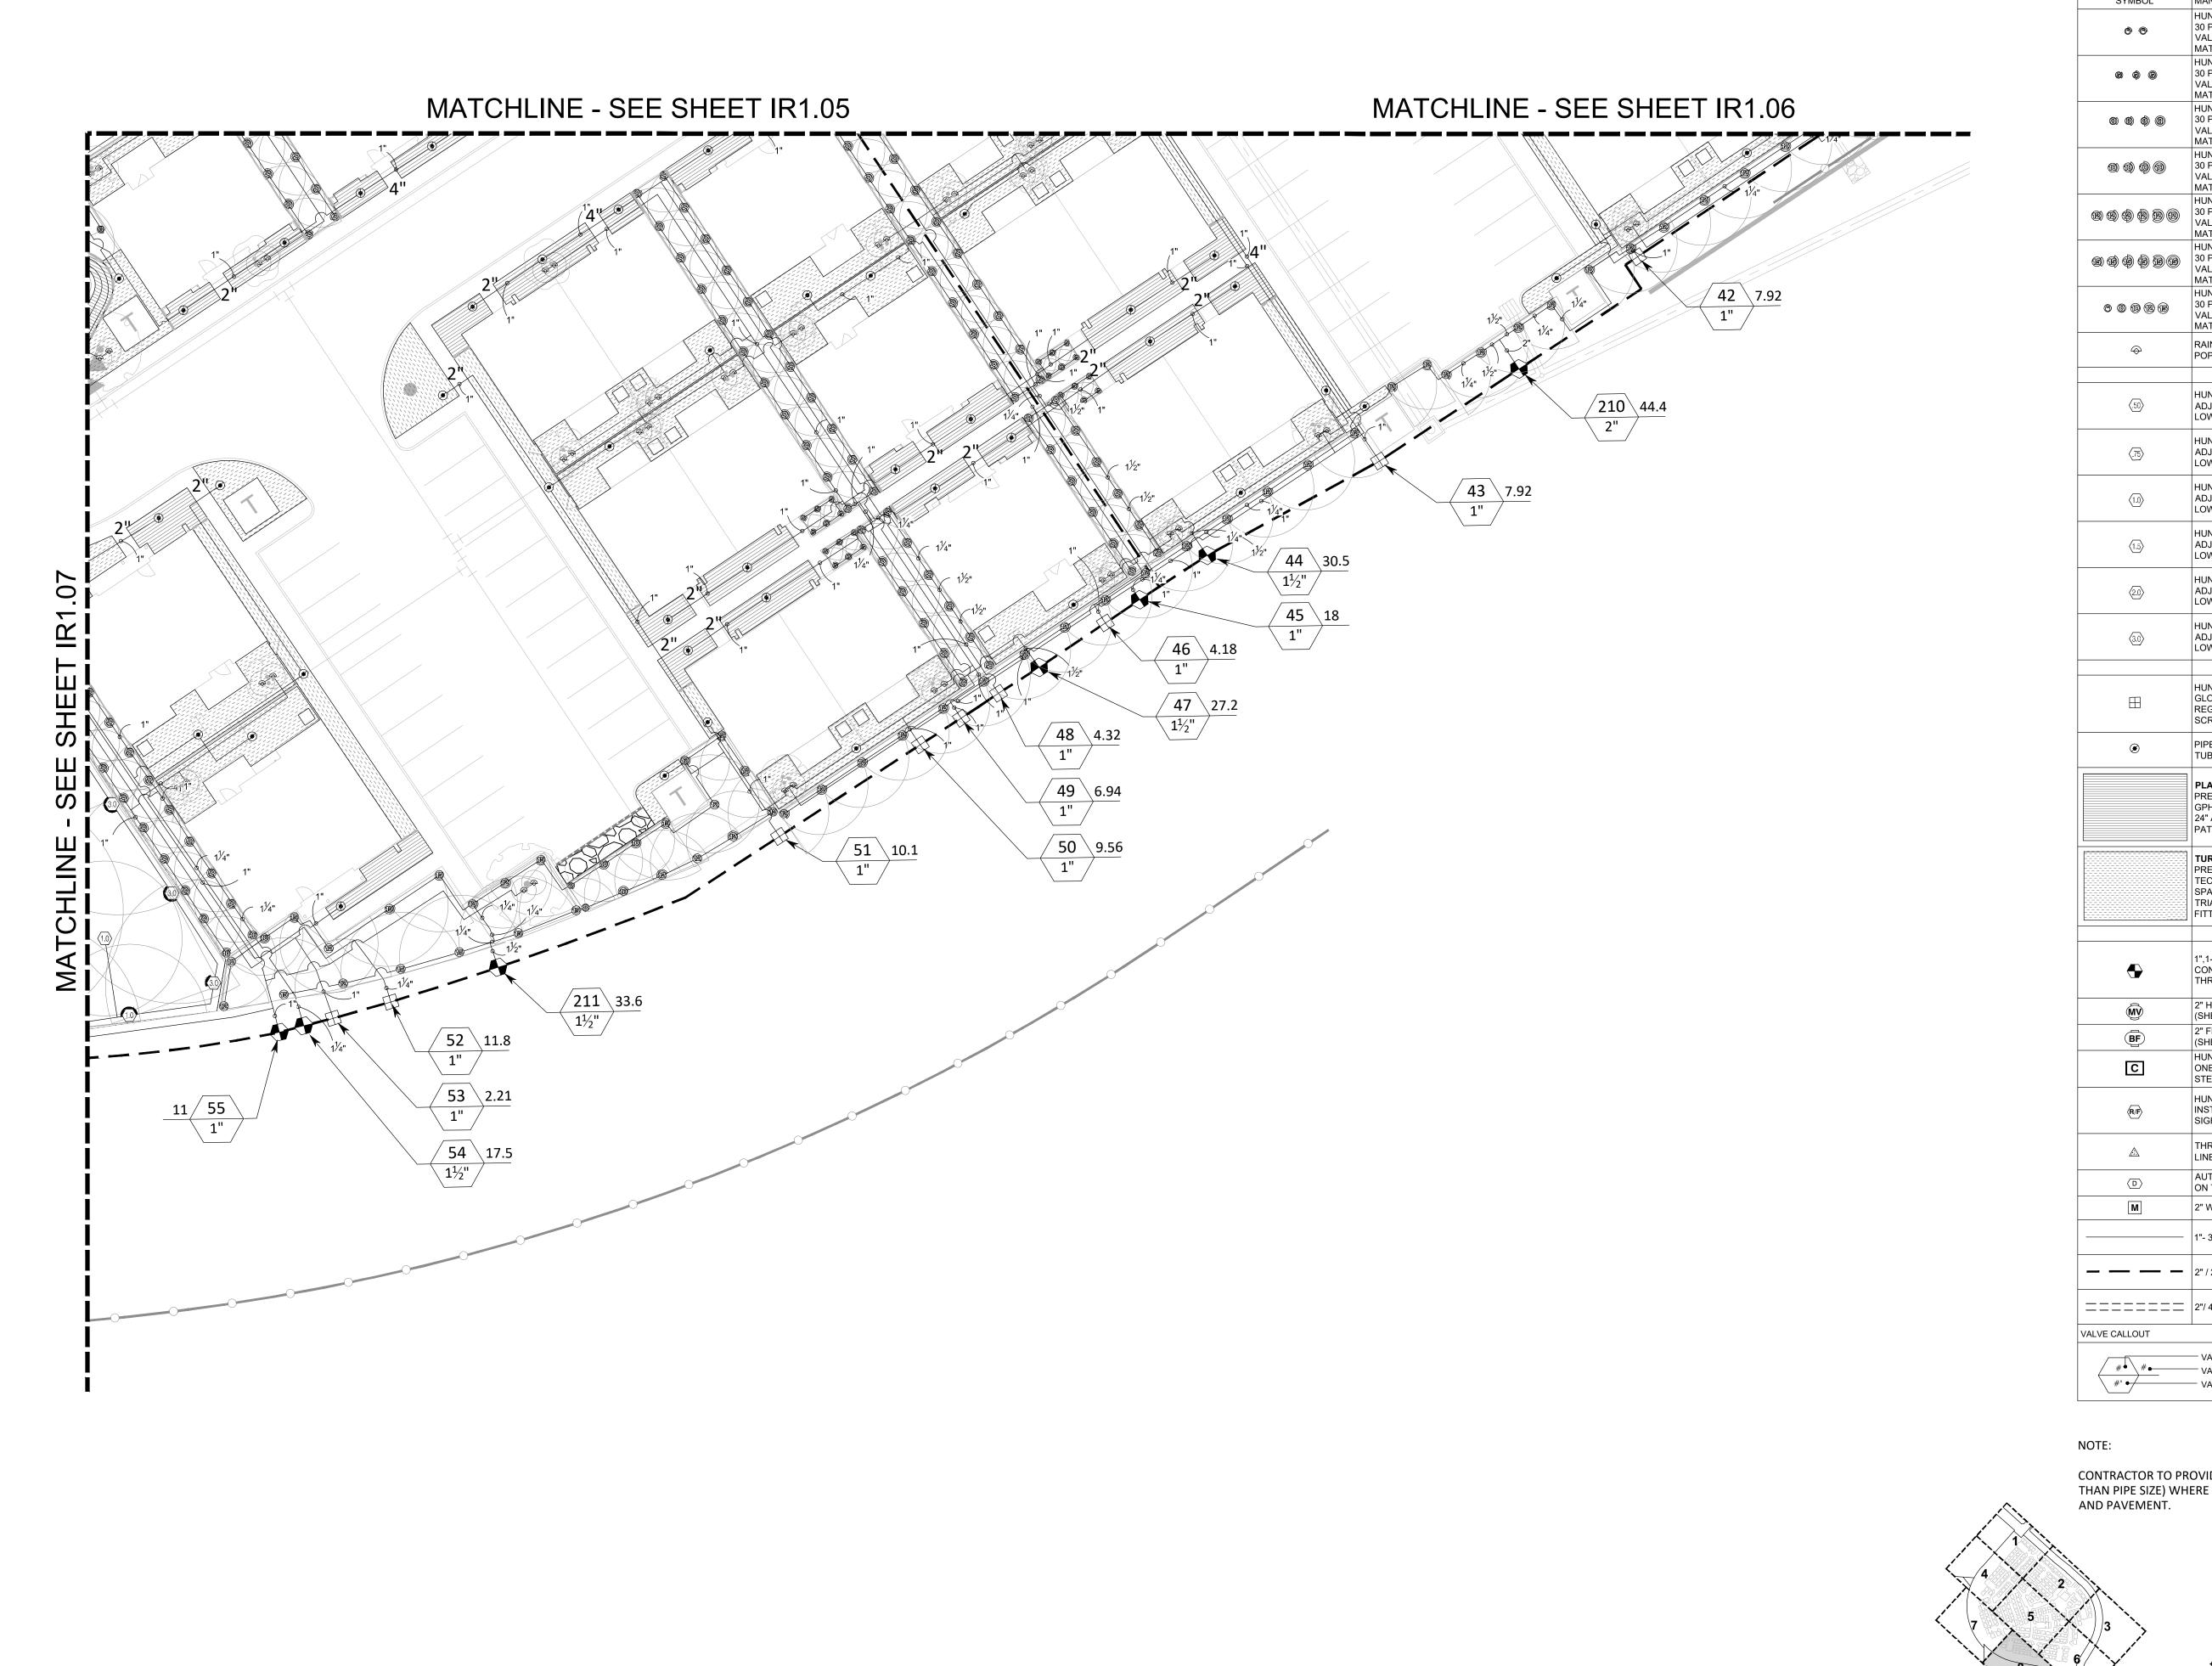

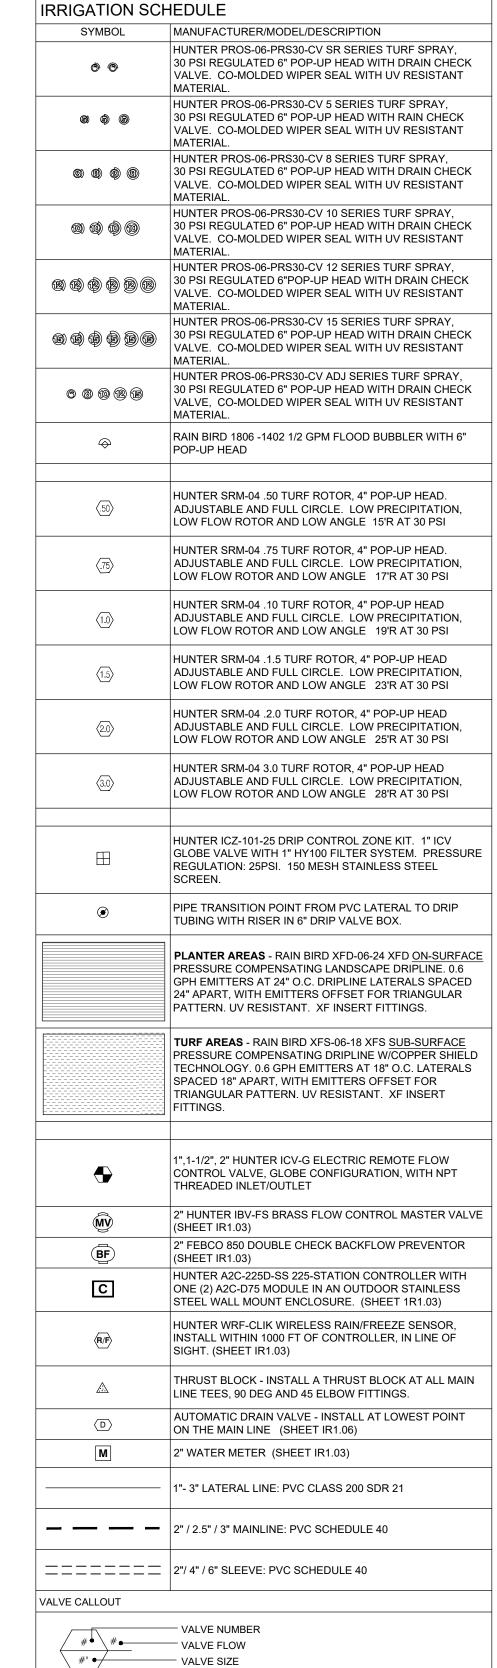

CONTRACTOR TO PROVIDE PIPE APPROPRIATE SIZED SLEEVES (2X GREATER THAN PIPE SIZE) WHERE LATERAL AND MAIN LINES CROSS UNDER SIDEWALKS

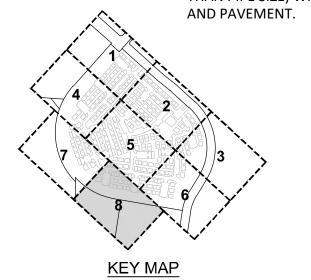

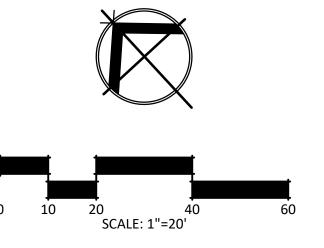

STRAND

10003 TECHNOLOGY BLVD. WEST DALLAS, TX. 75220 972-620-8204 REGISTRATION NO: F-1629

CLIENT INFO

CLIENT NAME CITY, STATE, ZIP CODE

01/26/2024

SCALE: AS SHOWN 1/26/2024 DRWN: STRAND

CHKD: STRAND SHEET TITLE

IRRIGATION PLAN

IR1.08

SHEET NO.

VALVI NUMBER	E SCHEDULE MODEL	SIZE	TYPE	GPM	FRICTION LOSS	VALVE LOSS	PSI
2	HUNTER ICZ-101-25	1"	AREA FOR DRIPLINE	11.52	0.81	8.91	29.7
	HUNTER ICZ-101-25 HUNTER ICZ-101-25	1"	AREA FOR DRIPLINE AREA FOR DRIPLINE	4.64	0.28	4.76 4.89	25.0 24.9
	HUNTER ICV-G HUNTER ICV-G	1-1/2"	TURF SPRAY BUBBLER	25.36 21	1.76 1.21	1.5	33.3 22.7
	HUNTER ICV-G HUNTER ICZ-101-25	1-1/2"	TURF SPRAY AREA FOR DRIPLINE	27.14 5.28	1.31 0.35	1.5 5.17	32.8 25.5
	HUNTER ICZ-101-25	1"	AREA FOR DRIPLINE AREA FOR DRIPLINE	11.2	0.71	8.72 8.7	29.4
0	HUNTER ICV-G	2"	TURF SPRAY	53.6	2.58	1.38	34.0
2	HUNTER ICZ-101-25 HUNTER ICV-G	1"	AREA FOR DRIPLINE BUBBLER	9.96	0.61 1.65	7.98 1.5	28.6
3 4	HUNTER ICZ-101-25 HUNTER ICZ-101-25	1"	AREA FOR DRIPLINE AREA FOR DRIPLINE	6.75 6.43	0.77	6.05 5.86	26.8 26.1
5	HUNTER ICV-G HUNTER ICZ-101-25	1-1/2"	TURF SPRAY AREA FOR DRIPLINE	34.19 8.44	2.62 0.67	1.58 7.06	34.2
7	HUNTER ICV-G	1"	BUBBLER	16	1.9	3	24.9
9	HUNTER ICZ-101-25 HUNTER ICZ-101-25	1"	AREA FOR DRIPLINE AREA FOR DRIPLINE	5.68 12.56	0.44	5.41 9.54	25.8 29.9
0 1	HUNTER ICZ-101-25 HUNTER ICV-G	1" 1-1/2"	AREA FOR DRIPLINE TURF SPRAY	12.63 29.4	6.39 2.08	9.58 1.5	36.0
3	HUNTER ICZ-101-25 HUNTER ICZ-101-25	1"	AREA FOR DRIPLINE AREA FOR DRIPLINE	7.78 9.64	0.24	6.67 7.78	26.9
4	HUNTER ICZ-101-25	1"	AREA FOR DRIPLINE	7.21	0.4	6.33	26.7
5 6	HUNTER ICV-G HUNTER ICV-G	1-1/2"	TURF SPRAY TURF SPRAY	27.02 43.78	2.86	1.5 0.95	34.4
7 8	HUNTER ICZ-101-25 HUNTER ICV-G	1"	AREA FOR DRIPLINE BUBBLER	8.9	0.98 3.17	7.34 1.5	28.3
9	HUNTER ICZ-101-25 HUNTER ICZ-101-25	1"	AREA FOR DRIPLINE AREA FOR DRIPLINE	9.25 4.42	0.24 0.27	7.55 4.61	27.8
1	HUNTER ICV-G	1-1/2"	TURF SPRAY	28.89	1.83	1.5	33.3
3	HUNTER ICZ-101-25 HUNTER ICZ-101-25	1"	AREA FOR DRIPLINE AREA FOR DRIPLINE	14.23 2.15	0.07	3.1	32.3 23.2
4 5	HUNTER ICZ-101-25 HUNTER ICV-G	1"	AREA FOR DRIPLINE BUBBLER	9.44	1.59 1.99	7.66	29.3 25.0
6 7	HUNTER ICZ-101-25	1"	AREA FOR DRIPLINE AREA FOR DRIPLINE	4.18 4.32	0.4	4.45 4.55	24.9 25.1
8	HUNTER ICV-G	1-1/2"	TURF SPRAY	26.36	1.83	1.5	33.3
9	HUNTER ICZ-101-25 HUNTER ICV-G	1" 1-1/2"	AREA FOR DRIPLINE TURF SPRAY	10.64 31.42	0.37 2.34	8.38 1.53	33.9
2	HUNTER ICZ-101-25 HUNTER ICZ-101-25	1"	AREA FOR DRIPLINE AREA FOR DRIPLINE	7.2 7.92	0.75 1.18	6.32 6.75	27.1 27.9
3	HUNTER ICZ-101-25	1"	AREA FOR DRIPLINE TURF SPRAY	7.92 30.55	1.21	12.9 1.51	34 1
5	HUNTER ICV-G HUNTER ICV-G	1"	BUBBLER	18	1.17	3	24.2
6 7	HUNTER ICZ-101-25 HUNTER ICV-G	1"	AREA FOR DRIPLINE TURF SPRAY	4.18 27.18	1.8	1.5	30.4
8 9	HUNTER ICZ-101-25	1"	AREA FOR DRIPLINE AREA FOR DRIPLINE	4.32 6.94	0.55 0.52	4.55 6.16	25.1 26.7
0	HUNTER ICZ-101-25	1"	AREA FOR DRIPLINE	9.56	0.64	7.74 8.08	28.4
2	HUNTER ICZ-101-25	1"	AREA FOR DRIPLINE	11.76	1.1	9.06	30.2
4	HUNTER ICZ-101-25 HUNTER ICV-G	1"	AREA FOR DRIPLINE TURF SPRAY	2.21 17.52	0.08 1.74	3.14 1.5	33.2
5 6	HUNTER ICV-G HUNTER ICV-G	1" 1-1/2"	BUBBLER TURF ROTOR	11 25.1	1.47 1.75	1.5	33.2
7	HUNTER ICV-G HUNTER ICZ-101-25	2"	TURF SPRAY AREA FOR DRIPLINE	40.77 11.92	1.03 0.97	0.83 9.15	31.9
9	HUNTER ICZ-101-25	1"	AREA FOR DRIPLINE	3.95	0.11	4.3	24.4
0 1	HUNTER ICZ-101-25 HUNTER ICV-G	1"	BUBBLER	9.14 15	1.53	7.48	29.0
3	HUNTER ICZ-101-25 HUNTER ICV-G	1"	AREA FOR DRIPLINE TURF SPRAY	10.81 26.24	0.78 2.5	8.49 1.5	29.3 34.0
4 5	HUNTER ICV-G HUNTER ICZ-101-25	1-1/2"	TURF SPRAY AREA FOR DRIPLINE	28.12 4.18	1.89	1.5	33.4
6	HUNTER ICZ-101-25	1"	AREA FOR DRIPLINE	8.95	1.34	14.0	35.3
8	HUNTER ICZ-101-25 HUNTER ICZ-101-25	1"	AREA FOR DRIPLINE AREA FOR DRIPLINE	9.98 2.32	1.67 0.06	7.99 10	29.7 30.1
9 0	HUNTER ICZ-101-25 HUNTER ICV-G	1" 2"	AREA FOR DRIPLINE TURF SPRAY	8.71 30.54	0.63 2.76	7.23 0.8	33.6
2	HUNTER ICV-G	1-1/2"	TURF SPRAY BUBBLER	26.06	2.51 1.35	1.5	34.0
3	HUNTER ICZ-101-25	1"	AREA FOR DRIPLINE	7.37	0.9	12.4	33.3
4 5	HUNTER ICZ-101-25 HUNTER ICV-G	1"	AREA FOR DRIPLINE BUBBLER	2.13 15	0.08 1.57	3	30.1 24.6
6 7	HUNTER ICZ-101-25 HUNTER ICZ-101-25	1"	AREA FOR DRIPLINE AREA FOR DRIPLINE	7.12 3.9	0.95	12.1 4.27	33.1 24.3
8 9	HUNTER ICZ-101-25	1"	AREA FOR DRIPLINE AREA FOR DRIPLINE	3.89 4.18	0.46 0.43	10	30.5
0	HUNTER ICV-G	1-1/2"	TURF SPRAY	55.89	2.39	2.67	35.1
2	HUNTER ICZ-101-25 HUNTER ICZ-101-25	1"	AREA FOR DRIPLINE AREA FOR DRIPLINE	6.99 6.93	0.57	6.19 6.16	26.3
3 4	HUNTER ICZ-101-25 HUNTER ICZ-101-25	1"	AREA FOR DRIPLINE AREA FOR DRIPLINE	9.34 7.88	1.61	7.6 12.9	34.1
5 6	HUNTER ICZ-101-25 HUNTER ICV-G	1"	AREA FOR DRIPLINE TURF SPRAY	4.73 29.94	0.06 2.38	10	30.1
7	HUNTER ICZ-101-25	1"	AREA FOR DRIPLINE	4.28	0.54	10	30.5
9	HUNTER ICZ-101-25 HUNTER ICV-G	1-1/2"	AREA FOR DRIPLINE BUBBLER	4.18	0.41 1.91	1.5	23.4
0 1	HUNTER ICZ-101-25 HUNTER ICV-G	1" 1-1/2"	AREA FOR DRIPLINE TURF SPRAY	7.22 32.36	0.52 2.7	12.2 1.55	32.7
2	HUNTER ICZ-101-25 HUNTER ICZ-101-25	1" 1"	AREA FOR DRIPLINE AREA FOR DRIPLINE	9.68 6.98	1.62 0.38	7.81 12.0	29.4 32.4
4	HUNTER ICZ-101-25	1"	AREA FOR DRIPLINE	6.19	0.41	5.71	26.7
5 6	HUNTER ICV-G HUNTER ICV-G	2"	TURF SPRAY	44.21	1.67	0.97	32.6
7 8	HUNTER ICZ-101-25 HUNTER ICZ-101-25	1"	AREA FOR DRIPLINE AREA FOR DRIPLINE	10 5.97	1.15 0.55	5.58	29.1
9	HUNTER ICZ-101-25	1"	AREA FOR DRIPLINE	6.05 10.17	0.23 0.76	11.1	31.3
01	HUNTER ICZ-101-25 HUNTER ICZ-101-25	1"	AREA FOR DRIPLINE AREA FOR DRIPLINE	8.56 7.49	1.27	7.14	28.4
03	HUNTER ICZ-101-25	1"	AREA FOR DRIPLINE	13.63	1.62	10.2	31.8
)4)5	HUNTER ICZ-101-25 HUNTER ICZ-101-25	1"	AREA FOR DRIPLINE AREA FOR DRIPLINE	6.05 4.18	0.21	11.1	30.2
06 07	HUNTER ICV-G HUNTER ICV-G	1-1/2"	TURF SPRAY TURF SPRAY	42.24 51.1	1.8 2.44	1.81 1.25	33.6
08	HUNTER ICV-G HUNTER ICZ-101-25	1-1/2"	BUBBLER AREA FOR DRIPLINE	20	1.13	1.5	22.6
10	HUNTER ICZ-101-25	1"	AREA FOR DRIPLINE	10.28	1.07	8.17	29.2
11 12	HUNTER ICZ-101-25 HUNTER ICZ-101-25	1"	AREA FOR DRIPLINE AREA FOR DRIPLINE	4.7 6.59	0.14	10 5.95	30. ²
13 14	HUNTER ICZ-101-25	1" 1"	AREA FOR DRIPLINE	8.36 6.82	0.46 0.54	13.4 6.09	33.8 26.6
15	HUNTER ICV-G	1-1/2"	BUBBLER	19	1.79	1.5	23.3
16 17	HUNTER ICV-G HUNTER ICV-G	2"	TURF SPRAY TURF SPRAY	56.19 24.49	2.94	1.51	34.5
18 19	HUNTER ICZ-101-25 HUNTER ICZ-101-25	1"	AREA FOR DRIPLINE AREA FOR DRIPLINE	10.29 7.07	0.32	8.17 6.24	28.5 26.5
20	HUNTER ICV-G HUNTER ICZ-101-25	2"	TURF SPRAY AREA FOR DRIPLINE	33.72 6.56	2.12 0.19	0.8	32.9
22	HUNTER ICV-G	2"	TURF SPRAY	57.5	2.72	1.57	34.3
23 24	HUNTER ICZ-101-25 HUNTER ICZ-101-25	1"	AREA FOR DRIPLINE AREA FOR DRIPLINE	11.4 6.12	0.54	8.84 5.67	29.4
25 26	HUNTER ICV-G HUNTER ICV-G	1-1/2" 1-1/2"	BUBBLER TURF SPRAY	26 36.66	1.64 2.71	1.5 1.63	23.7 34.3
27	HUNTER ICZ-101-25	1"	AREA FOR DRIPLINE	5.85	0.32	5.51	25.8

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128	HUNTER ICZ-101-25	1"	AREA FOR DRIPLINE	3.79	0.03	4.19	24.2
129	HUNTER ICV-G	2"	TURF SPRAY	50.02	2.97	1.2	34.2
130	HUNTER ICZ-101-25	1"	AREA FOR DRIPLINE	2.66	0.06	3.44	23.5
131	HUNTER ICZ-101-25	1"	AREA FOR DRIPLINE	6.48	0.33	5.89	26.2
132	HUNTER ICV-G	2"	BUBBLER	48	1.57	1.12	22.7
133	HUNTER ICZ-101-25	1"	AREA FOR DRIPLINE	2.41	0.07	3.27	23.3
134	HUNTER ICV-G	2"	TURF ROTOR	38.52	1.98	0.8	32.8
135	HUNTER ICZ-101-25		AREA FOR DRIPLINE	11.62 32.84	0.35	8.97	29.3 34.3
136	HUNTER ICV C	1-1/2"	TURF SPRAY		0.15	1.56 2.86	33.0
137	HUNTER ICV-G	1"	TURF SPRAY	8.58	1.21	9.25	
138	HUNTER ICZ-101-25	1"	AREA FOR DRIPLINE AREA FOR DRIPLINE	12.09 3.71	0.08	10	30.5
140	HUNTER ICZ-101-25	1"	AREA FOR DRIPLINE	4.77	0.08	10	30.1
141	HUNTER ICZ-101-25	1"	AREA FOR DRIPLINE	5.11	0.19	10.1	30.2
142	HUNTER ICZ-101-25	1"	AREA FOR DRIPLINE	12.05	1.08	9.23	30.3
143	HUNTER ICZ-101-25	1"	AREA FOR DRIPLINE	5.97	0.35	11.0	31.3
144	HUNTER ICZ-101-25	1"	AREA FOR DRIPLINE	9.02	1.06	7.41	28.5
145	HUNTER ICV-G	1-1/2"	TURF SPRAY	51.32	2.27	2.31	34.6
146	HUNTER ICZ-101-25	1"	AREA FOR DRIPLINE	2.54	0.07	3.36	23,4
147	HUNTER ICV-G	1-1/2"	BUBBLER	26	1,48	1.5	23.0
148	HUNTER ICZ-101-25	1"	AREA FOR DRIPLINE	11.02	0.27	8.61	28.9
149	HUNTER ICZ-101-25	1"	AREA FOR DRIPLINE	9.29	0.56	7.57	28.1
150	HUNTER ICZ-101-25	1"	AREA FOR DRIPLINE	3.27	0.06	3.85	23.9
151	HUNTER ICV-G	2"	BUBBLER	41	1.97	0.84	22.8
152	HUNTER ICV-G	1"	TURF ROTOR	18.26	0.83	3	33.8
153	HUNTER ICZ-101-25	1"	AREA FOR DRIPLINE	7.49	0.42	6.49	26.9
154	HUNTER ICV-G	2"	TURF SPRAY	53.96	2.01	1.4	33.4
155	HUNTER ICV-G	1-1/2"	TURF SPRAY	27.6	1.7	1.5	33.2
156	HUNTER ICV-G	1"	BUBBLER	12	1.87	3	24.9
157	HUNTER ICV-G	1-1/2"	TURF SPRAY	35.04	1.69	1.6	33.3
158	HUNTER ICZ-101-25	1"	AREA FOR DRIPLINE	6.98	0.21	6.19	26.4
159	HUNTER ICV-G	1-1/2"	TURF SPRAY	26.32	2.81	1.5	34.3
160	HUNTER ICZ-101-25	1"	AREA FOR DRIPLINE	9.29	1.09	7.57	28.7
161	HUNTER ICZ-101-25	1"	AREA FOR DRIPLINE	8.36	0.58	13.4	33.9
162	HUNTER ICZ-101-25	1"	AREA FOR DRIPLINE	6.84	0.53	11.8	32.4
163	HUNTER ICZ-101-25	1"	AREA FOR DRIPLINE	8.1	0.35	6.86	27.2
164	HUNTER ICZ-101-25	1"	AREA FOR DRIPLINE	5.98	0.41	11.0	31.4
165	HUNTER ICZ-101-25	1"	AREA FOR DRIPLINE	8.71	1.48	7.23	28.7
166	HUNTER ICZ-101-25	1"	AREA FOR DRIPLINE	8.63	1.18	13.6	34.8
167	HUNTER ICZ-101-25	1"	AREA FOR DRIPLINE	4.82	0.18	10	30.2
168	HUNTER ICZ-101-25	1"	AREA FOR DRIPLINE	7.53	0.92	12.5	33.5
169	HUNTER ICZ-101-25	1"	AREA FOR DRIPLINE	9.5	0.77	14.5	35.3
170	HUNTER ICV-G	1-1/2"	TURF SPRAY	32.54	2.77	1.55	34.3
170	HUNTER ICV-G	1-1/2"	BUBBLER	21	1.76	1.5	23.3
171	HUNTER ICZ-101-25	1"	AREA FOR DRIPLINE	5.07	0.78	5.04	25.8
172	HUNTER ICZ-101-25	1"	AREA FOR DRIPLINE	7.28	0.69	12.3	33.0
173	HUNTER ICV-G	1-1/2"	TURF SPRAY	27.48	2.72	1.5	34.2
174	HUNTER ICV-G	1-1/2"	TURF SPRAY	26.47	2.57	1.5	34.1
175	HUNTER ICV-G	1-1/2"	TURF SPRAY	35.37	2.52	1.61	34.1
176	HUNTER ICZ-101-25	1"	AREA FOR DRIPLINE	6.92	0.34	6.15	26.5
177	HUNTER ICZ-101-25	1"	AREA FOR DRIPLINE	7.53	1.01	12.5	33.5
178	HUNTER ICV-G	1-1/2"	BUBBLER	20	1.23	1.5	22.7
179	HUNTER ICV-G	2"	TURF SPRAY	54.99	2.58	1.45	34.0
180	HUNTER ICZ-101-25	1"	AREA FOR DRIPLINE	9.54	0.57	7.72	28.3
181	HUNTER ICZ-101-25	1"	AREA FOR DRIPLINE	12.36	1.7	9.42	31.1
182	HUNTER ICV-G	2"	TURF SPRAY	62.84	1.55	1.83	33.4
183	HUNTER ICZ-101-25	1"	AREA FOR DRIPLINE	5.62	0.62	5.37	26.0
184	HUNTER ICZ-101-25	1"	AREA FOR DRIPLINE	11.11	1.08	8.67	29.7
185	HUNTER ICV-G	1-1/2"	TURF SPRAY	38.19	2.55	1.66	34.2
186	HUNTER ICV G	1-1/2"	BUBBLER TUBE SERAY	30	6.73	1.5	28.2
187	HUNTER ICV-G HUNTER ICZ-101-25	2"	AREA FOR DRIPLINE	56.96	0.58	1.55	34.0 32.1
188		-		6.51			
189	HUNTER ICV-G HUNTER ICZ-101-25	1-1/2"	TURF SPRAY	25.45	0.43	1.5	34.4
190	HUNTER ICZ-101-25	1"	AREA FOR DRIPLINE	7.88	0.43 1.52	6.73	28.2
191 192	HUNTER ICZ-101-25	1"	AREA FOR DRIPLINE AREA FOR DRIPLINE	6.27	0.55	11.3	31.8
192	HUNTER ICZ-101-25	1"	AREA FOR DRIPLINE	10.67	0.55	8.4	29.0
193	HUNTER ICZ-101-25	1-1/2"	TURF SPRAY	23.2	1.47	1.5	33.0
194	HUNTER ICV-G	1-1/2"	BUBBLER	23.2	1.47	1.5	23.4
195	HUNTER ICZ-101-25	1"	AREA FOR DRIPLINE	6.88	0.14	6.13	26.3
196	HUNTER ICV-G	1-1/2"	TURF SPRAY	26.16	0.14	1.5	32.3
197	HUNTER ICV-G	1-1/2"	TURF SPRAY	32.09	2.6	1.54	34.1
199	HUNTER ICZ-101-25	1"	AREA FOR DRIPLINE	11.51	0.54	8.91	29.4
200	HUNTER ICZ-101-25	1"	AREA FOR DRIPLINE	7.92	0.99	12.9	33.9
200	HUNTER ICZ-101-25	1"	AREA FOR DRIPLINE	3.82	0.99	10	30.1
201	HUNTER ICV-G	1-1/2"	TURF ROTOR	19.55	0.09	1.5	31.9
202	HUNTER ICV-G	1-1/2"	TURF ROTOR	37.3	2.78	1.65	34.4
204	HUNTER ICV-G	1-1/2"	TURF ROTOR	33.5	2.88	1.57	34.5
205	HUNTER ICV-G	1-1/2"	TURF ROTOR	35	1.01	1.6	32.6
206	HUNTER ICV-G	1-1/2"	TURF ROTOR	24.6	0.96	1.5	32.5
207	HUNTER ICV-G	1-1/2"	TURF SPRAY	36.83	2.84	1.64	34.5
208	HUNTER ICV-G	1-1/2"	TURF ROTOR	30.55	2.04	1.51	33.6
209	HUNTER ICV-G	1-1/2"	TURF SPRAY	30.39	2.5	1.51	34.0
	HUNTER ICV-G	2"	TURF SPRAY	44.36	3	0.97	34.0
210	HUNTER ICV-G	1-1/2"	TURF SPRAY	33.58	1.04	1.57	32.6
210 211		1-1/2"	TURF SPRAY	37.43	2.2	1.65	33.8
	HUNTER ICV-G	1-1/2	i i				
211	HUNTER ICV-G HUNTER ICV-G	1-1/2"	TURF SPRAY	24.38	0.72	1.5	32.2
211 212			TURF SPRAY TURF ROTOR	24.38 27.68	0.72 1.63	1.5 1.5	32.2 33.1
211 212 213	HUNTER ICV-G	1-1/2"					
211 212 213 214	HUNTER ICV-G HUNTER ICV-G	1-1/2"	TURF ROTOR	27.68	1.63	1.5	33.1
211 212 213 214 215	HUNTER ICV-G HUNTER ICV-G HUNTER ICV-G	1-1/2" 1-1/2" 1-1/2"	TURF ROTOR TURF SPRAY	27.68 38.64	1.63 2.07	1.5 1.67	33.1 33.7

CRITICAL ANALYSIS

Water Source Information:

Backflow, Master Valve, Meter: Critical Station Pressure at POC: Pressure Available:	17.4 PSI 56.2 PSI 63 PSI
Critical Station Pressure at POC:	56.2 PSI
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Losses thru Main Line, Fittings,	
Pressure Req. at Critical Station:	38.8 PSI
Loss through Valve:	17.6 PSI
Friction Loss:	1.23 PSI
Design Pressure:	20 PSI
Critical Station:	28
Pressure Available:	63 PSI
Length of Service Line:	20 ft
Service Line Size:	2'
Elevation Change:	2.00 ft
Static Pressure at POC:	65 PSI
PRESSURE AVAILABLE	
Flow Available	70.55 GPM
Water Meter Size:	2"
FLOW AVAILABLE	

GENERAL NOTES

- 1. Coordinate irrigation installation with planting plan and site conditions to provide complete coverage with minimum over spray. Over-spray on any non-permeable surface is prohibited. The irrigation contractor shall make minor adjustments to ensure proper coverage at no additional cost to the owner.
- 2. The irrigation contractor shall comply with all local and state mandated irrigation ordinances and codes, and will secure all required permits. I.i.c. shall pay any associated fees unless otherwise noted. All local codes shall prevail over any discrepancies herein and shall be addressed before any construction begins.
- 3. System is designed per 65 PSI static pressure at the point of connection (P.O.C.) If the static water pressure EXCEEDS the design pressure by 15 PSI or more in any zone, a flow control device shall be installed. Also see note 35.
- 4. Lateral pipe shall be installed at a minimum depth of 12 inches. mainline pipe and wires shall be installed at a minimum depth of 18 inches. no machine trenching shall be permitted within existing tree root zones. when hand trenching within existing tree root zones, no roots larger than 1" diameter shall be cut.
- 5. Electric power shall be provided within five feet of controller location by general contractor. l.i.c. to provide final hard-wire to controller.
- 6. 24 volt valve wire shall be a minimum of #14 gauge, u.f. approved for direct burial, single conductor "irrigation wire". wire splices shall include dby connectors as manufactured by 3m company. all field splices shall be located in a round valve box of sufficient size to allow inspection.
- 7. Valve boxes shall be installed flush with grade, supported by bricks as detailed, with 3 inches of clean pea gravel located below the valve. use 12" x 17" rectangular valve boxes with a purple lid for any quick coupling valves, and 14" x 20" rectangular boxes for electric valves unless noted otherwise. d.c.a., with upstream ball valve and wye filter shall be boxed and located according to local code. the wye filter shall be installed at a 45 degree angle from horizontal, with adequate clearance to enable the removal of the filter screen without digging or the removal of the gravel or the valve box.
- 8. All spray heads shall be connected with a swing joint assembly. all pop-up rotary heads shall include a rigid sch. 40 pvc swing joint assembly of the same size as the head inlet.
- 9. Contractor is to contact appropriate authorities and locate all utilities prior to construction.
- 10. The proposed locations of all above- ground equipment including back-flow preventors, controllers and weather sensors shall be staked by the contractor for approval by the owner's representative before these items are installed.
- 11. All heads shall be installed a minimum of 4" from pavement edges. (6" or greater where required by local code.) Final head adjustments by the contractor shall include the addition of check valves where needed to prevent excessive low head drainage. the contractor shall budget for, and install check valves for up 10% of the total number of heads when needed, with no additional cost to the owner.
- 12. All sleeves shall be marked with a 3" curb saw cut on each side of the pavement crossing. where a change of main line or lateral line depth is required to accommodate sleeve depths, the main line and lateral line shall include 45 degree elbow fittings, not 90 degree fittings.
- 13. Where shown on the plans, selected turf areas shall include drip tube with pre-installed .6 gph drip emitters every 12", installed in center-fed grids with rows spaced 12" apart. Individual drip tube runs shall not exceed 200 l.f. See drip grid details for header and exhaust pipe sizes. Where required, pvc lateral "trunk" lines shall be installed 10" deep and drip tube shall be set 4" below finished soil grade. Automatic or manual flush valves (1/2" pvc ball valve) shall be installed at the farthest points from the zone valve. Use 17 mm barbed or insert fittings for drip line connections, pressure testing all connections before backfilling. Drip tubing shall be installed perpendicular to slope face. Each drip zone shall include one drip irrigation head which shall consist of a 12" pop-up spray head and completely closed spray nozzle. The pop-up head shall be connected to the drip zone pipe, set flush with grade, and located at the farthest distance from the drip valve assembly. Install the "flag" head adjacent to edging or in low plantings for ease of viewing. When installing subsurface drip line, install air/vacuum relief valves in a 6" round valve box, at the highest elevations of all turf (subsurface) drip zones.
- 14. If additional zones are needed due to the length of runs, then the contractor shall indicate to the licensed irrigator prior to bidding and/or construction. After bidding and construction has commenced it shall be the contractor's responsibility to add additional zones (including materials and labor) at no additional cost to the owner.
- 15. Pipe sleeves maybe combined into one sleeve, as long as the sleeve is twice the size of the pipes being installed. Pipe sleeves are shown on plans. Contractor to ensure pipe sleeves are to be installed for any pipe under pavement.
- 16. Main line and lateral lines are diagrammatic. Adjust accordingly to accommodate existing field conditions and achieve complete coverage.
- 17. Extreme care shall be exercised in excavating and working near utilities. Contractor shall verify the location and condition of
- The licensed irrigation contractor (l.i.c.) is required by law to notify one of the following (2) working days prior to any
- excavation: a. Texas One Call; 800-245-4545
- b. Texas Excavation Safety System (TESS); 800-344-8377c. Lone Star Notification Center; 800-669-8344

all utilities and will be responsible for any damage to existing utilities.

- 18. All main line piping shall be buried to have a minimum cover of 18". All lateral lines downstream of the main line shall have a minimum cover of 12". Schedule 40 PVC and gray conduit sleeves under pavement shall have a minimum cover of 24".
- 19. At low points (6" per every 100 ft) in main lines, automatic drain valves are to be installed in a valve box with gravel sump to facilitate drainage of system during freezing temperatures.
- 20. Contractor shall install flush line valves at low points in the irrigation drip lines as required to prevent freeze damage.
- 21. All valve boxes shall be black in color w/green lids and purple lids if reclaim water is being used. Valve boxes shall be 12" x 16" for station valves and 24" x 33" for a double check backflow preventer assembly. Quick couplers, ball valves, wire junctions, and rods for grounding are to be in 10" circular valve boxes. Dripline air relief and flush line valves shall be in 6" circular valve boxes.
- 22. All pipes and fittings to be cleaned before assembly, free from dirt and debris, with open ends closed off.
- 23. All wiring from the irrigation controller to the remote control valves shall be the gauge appropriate for the distance between valves and the controller , single conductor, direct burial approved. Waterproof connectors to be used on all wire connections. Provide gray conduit for station wire under paved areas as required.
- Contractor shall not disturb the roots of existing trees. There shall be no machine trenching below the drip line of existing trees.
- 25. All irrigation installation shall conform to the local and state codes and regulations.
- 26. Contractor shall provide a new or adjusted seasonal watering schedule to the owner's representative at completion of the irrigation system installation per state regulation.
- 27. Contractor shall provide copies of manufacturer's literature, certifications, and operation instructions for the complete list of materials for the controller, backflow preventer, ball valves, pipe and fittings, control valves, valve boxes, and any applicable sensors for rain, freeze, and soil moisture.
- 28. The contractor shall be a registered licensed irrigator in the state of texas. contractor must conform to all codes as stated in section 34 of the texas water code and the texas commission on environmental quality (TCEQ).
- 29. Contractor shall obtain permit, pay all fees and give all necessary notices for the completion of work.
- 30. Preliminary review of completed installation will be made by the landscape architect prior to backfilling of trenches and during hydrostatic testing.
- 31. Final review shall be made in conjunction with the final review of the lawn, shrub and tree plantings.
- 32. Contractor shall provide as-built drawings for the complete irrigation system in accordance with the general and special conditions.
- 33. Contractor to clean up and remove all debris from entire work area prior to final acceptance to satisfaction of owner.
- 34. In addition to the manufacturer's warranties, the contractor shall warrant all work for one year from the date of final acceptance against defects in material, equipment and workmanship. Contractor shall not be held responsible for failures due to the neglect by the city, vandalism, etc.
- 35. The trusted LOWEST available static water pressure in an annual 12 month period is 65 PSI. The contractor is to verify the pressure prior to system installation. Future pressures may vary due to new development and/or other unforeseen circumstances. The licensed irrigator shall bear no responsibility for future deviations in pressure and any resulting effects on the performance of the irrigation system.


STRAND

10003 TECHNOLOGY BLVD. WEST DALLAS, TX. 75220 972-620-8204 REGISTRATION NO: F-1629

CITY, STATE, ZIP CODE

CLIENT INFO

CLIENT NAME

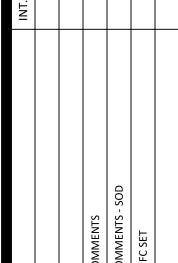

DATE ISSUE

09/11/2023 CLIENT COMMENTS

10/06/2023 CLIENT COMMENTS - SOD

12/08/2023 12-8-23 - IFC SET

SEAT SEAT



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SAN ANTONIO, TEX

SCALE: AS SHOWN

DATE: 1/26/2024 DRWN: STRAND


CHKD: STRAND

SHEET TITLE

IRRIGATION NOTES, ANALYIS, & SCHEDULE

SHEET NO.

IR1.09

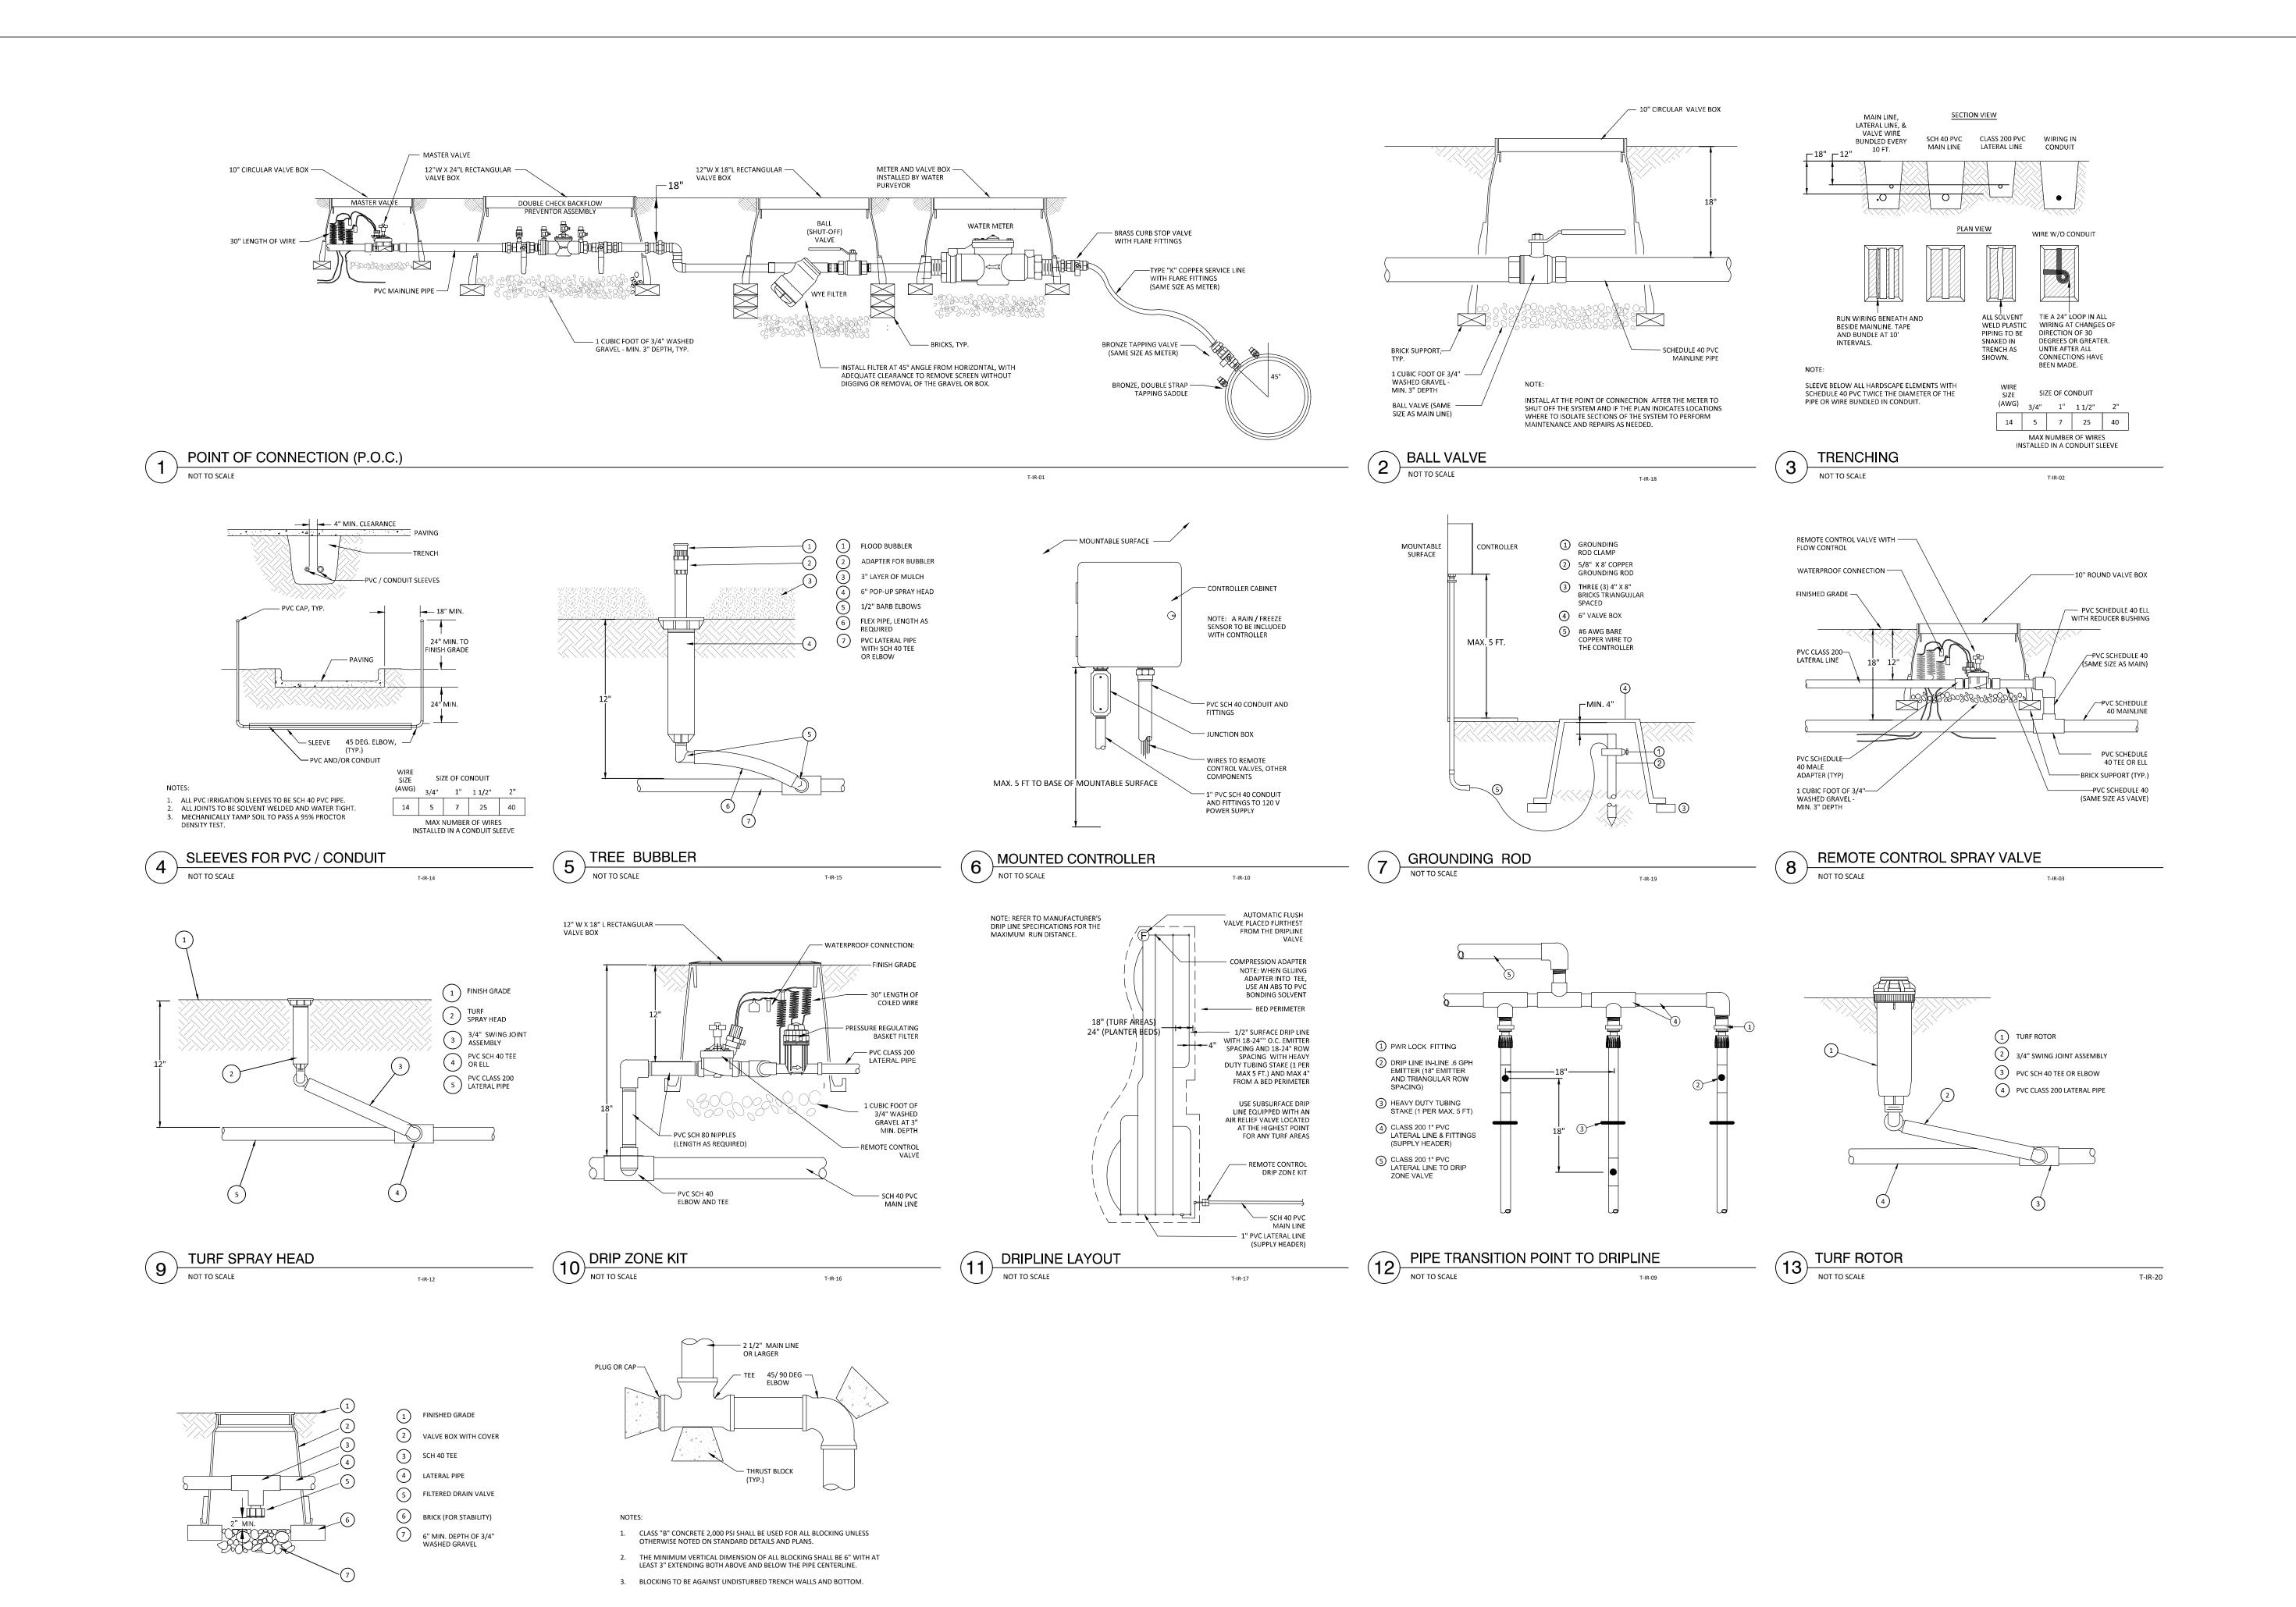

MAIN LINE DRAIN VALVE

NOT TO SCALE

THRUST BLOCKS

NOT TO SCALE

STRAND

10003 TECHNOLOGY BLVD. WEST DALLAS, TX. 75220 972-620-8204 REGISTRATION NO: F-1629

CLIENT INFO

CLIENT NAME **ADDRESS** CITY, STATE, ZIP CODE

03

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JUNO

SCALE: AS SHOWN DATE: 1/26/2024 DRWN: STRAND


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DETAILS

IRRIGATION

SHEET NO.

IR1.10

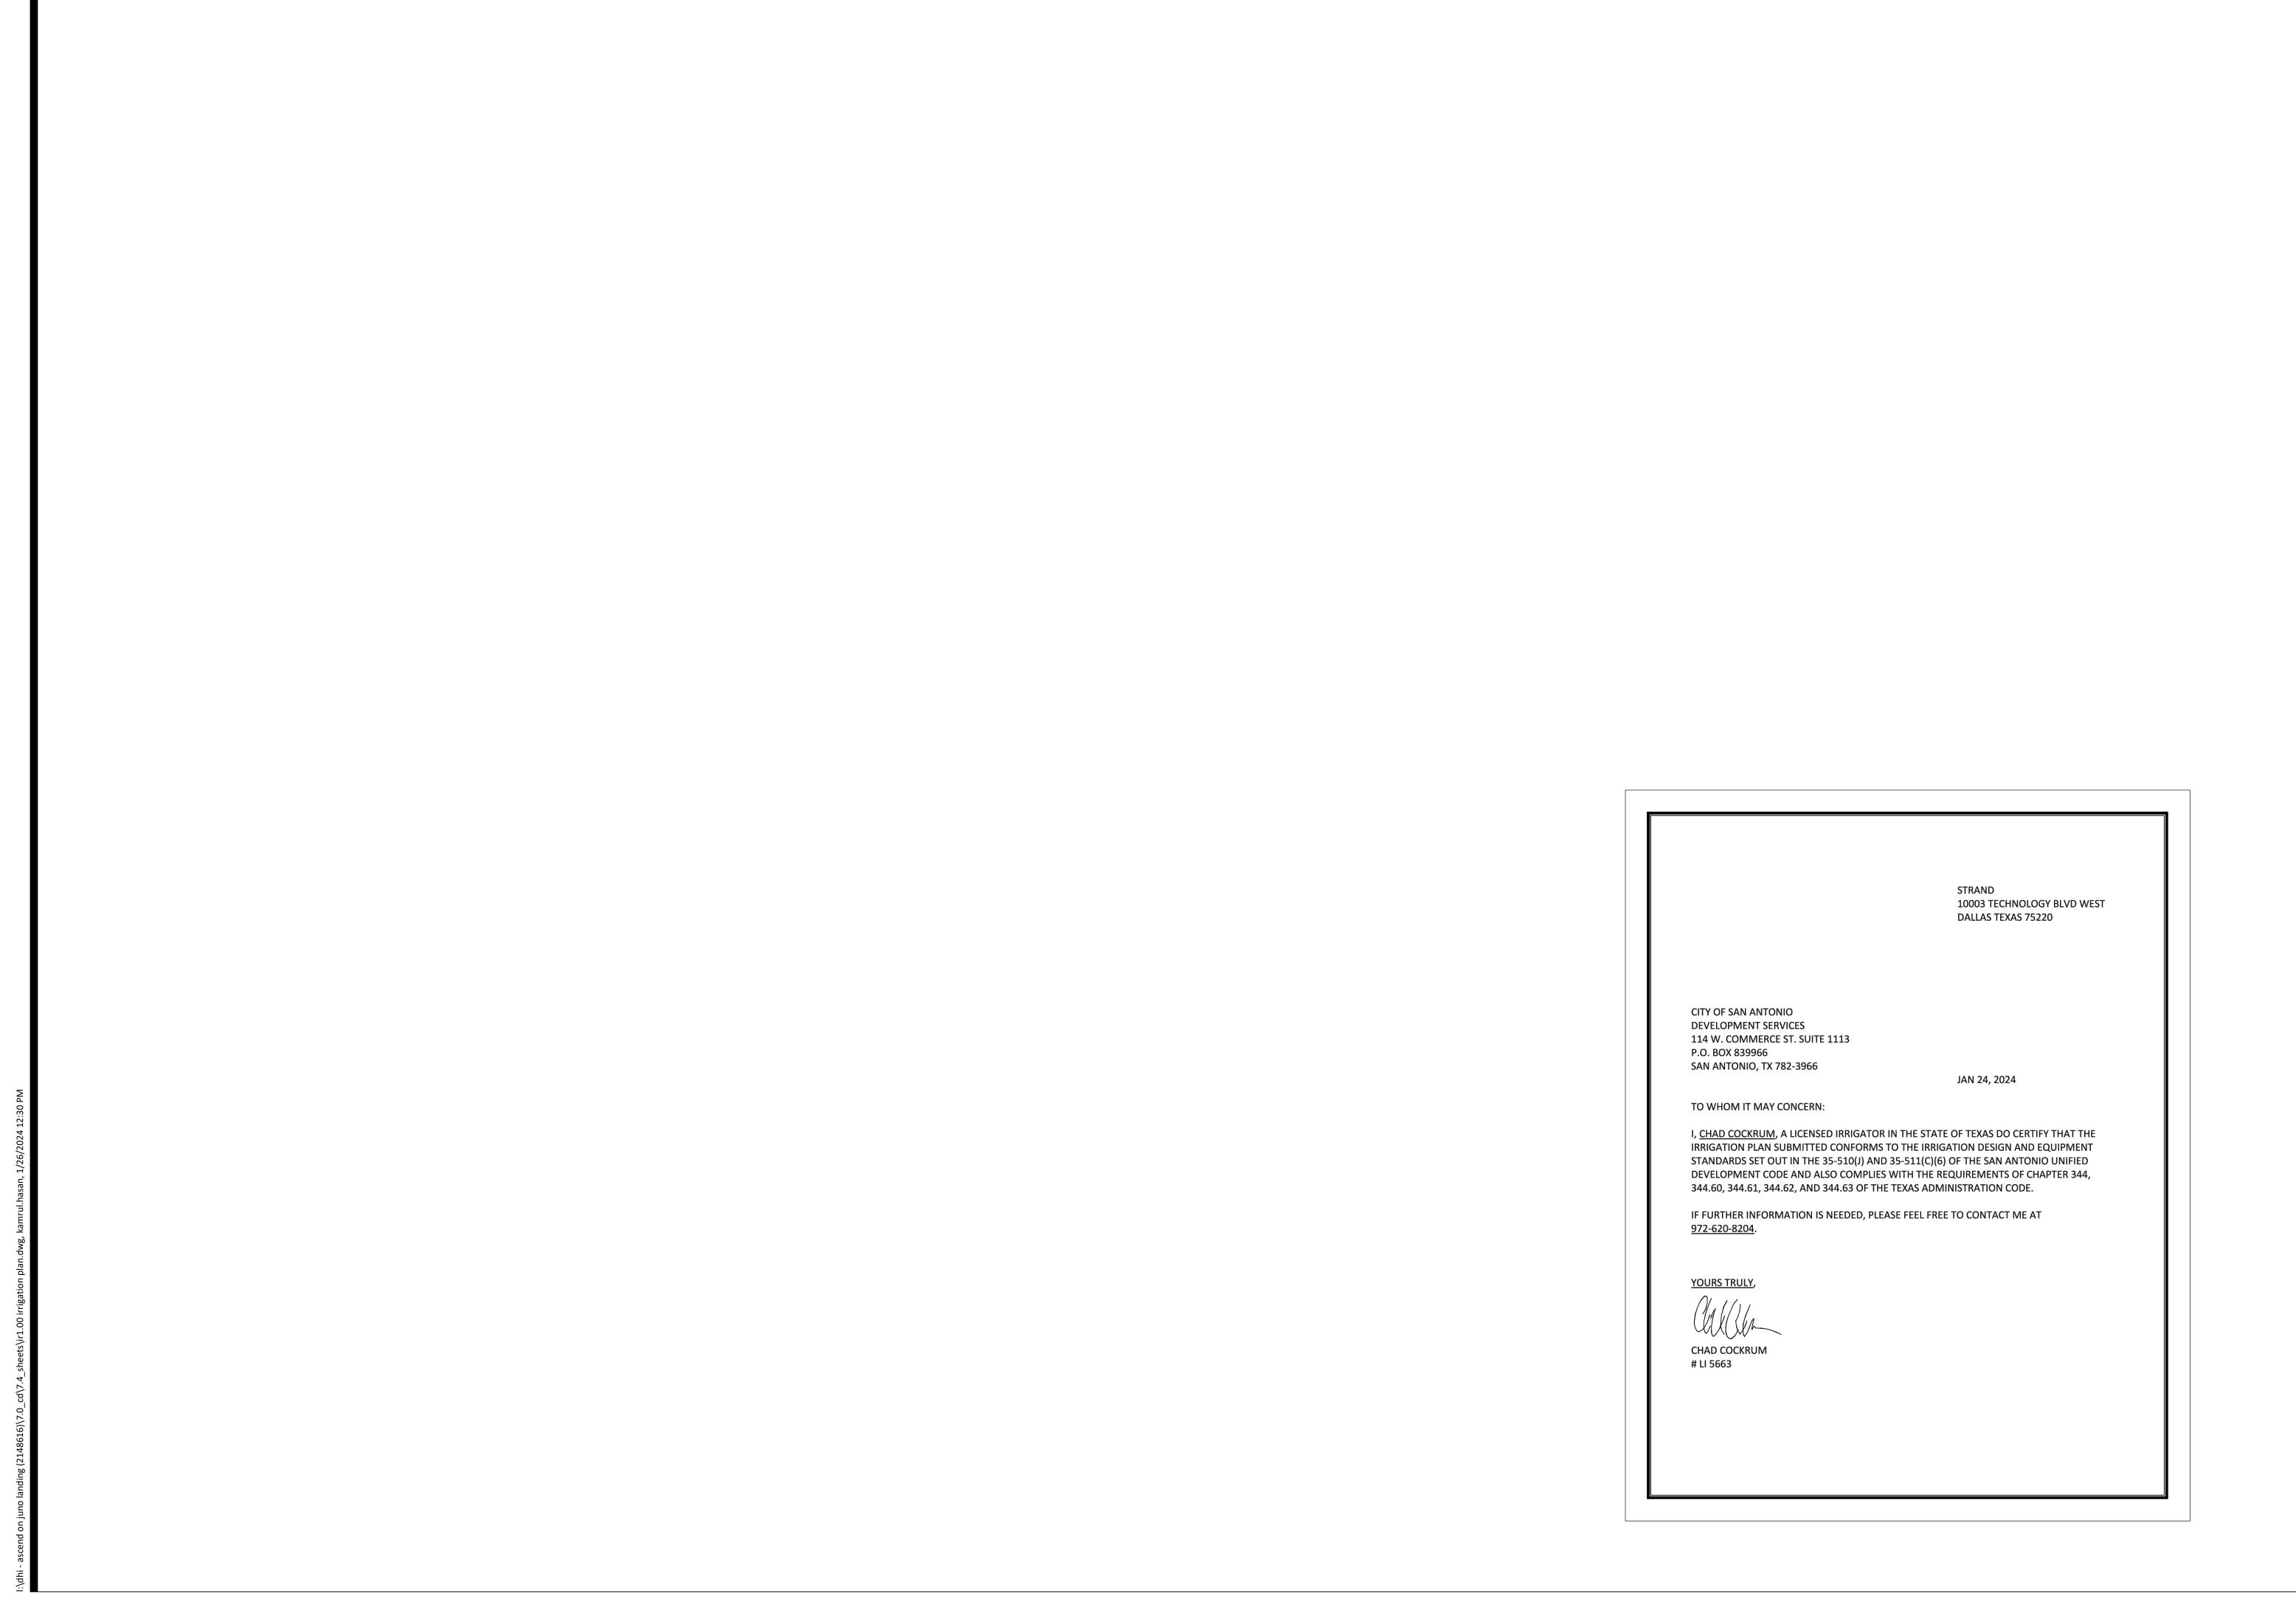


10003 TECHNOLOGY BLVD. WEST DALLAS, TX. 75220 972-620-8204 REGISTRATION NO: F-1629

CLIENT II

CLIENT NAME ADDRESS CITY, STATE, ZIP CODE

ENTS - SOD

3 09/11/2023 (10/06/2023 (12/08/2023 1

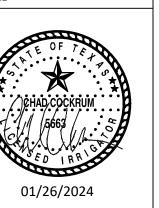

N JUNO LANDING

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SCALE: AS SHOWN

DATE: 1/26/2024

DRWN: STRAND

CHKD: STRAND

SHEET TITLE

IRRIGATION LETTER OF CONFORMITY

SHEET NO.

IR1.11