CIVIL PLANS FOR KITTLE PROPERTY GROUP INC.

CAMINO VALIENTE ROADWAY & CHANNEL PLAN AND PROFILE

WATSON ROAD AND SH 16 SAN ANTONIO, TX 78264

PROJECT TEAM:


OWNER/DEVELOPER

KITTLE PROPERTY GROUP
310 EAST 96TH STREET, SUITE 400
INDIANAPOLIS, INDIANA 46240
PH. (737) 336-2115
CONTACT: COOPER ALLISON, P.E.

CIVIL ENGINEER

KIMLEY-HORN AND ASSOCIATES, INC
1400 WOODLOCH FOREST DR
THE WOODLANDS TX, 77380
PH. (281) 920-6572
CONTACT: MATTHEW MATNEY, P.E.

SURVEY
KIMLEY-HORN AND ASSOCIATES, INC
10101 REUNION PLACE, SUITE 400
SAN ANTONIO, TEXAS 78216
PH. (210) 541-9166
CONTACT: JAY JANISSE

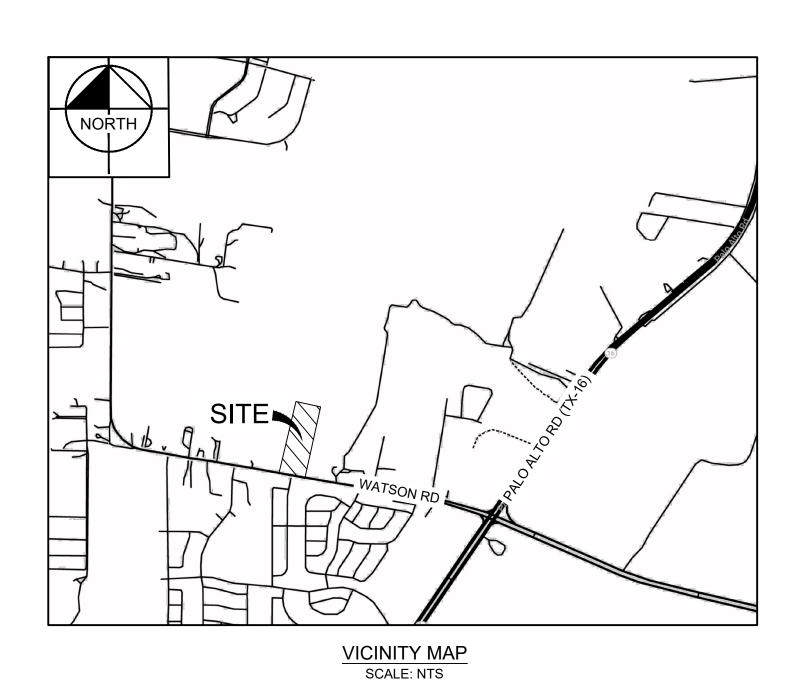

90% CONSTRUCTION DRAWINGS	6/30/202
PERMIT SET	7/18/202

SHEET NO.	SHEET TITLE	REVISION
C0.0	COVER SHEET	
C1.0	GENERAL NOTES	
C2.0	EROSION CONTROL PLAN	
C2.1	EROSION CONTROL DETAILS	
C3.0	CAMINO VALIENTE - PLAN & PROFILE - (STA 1+00 - STA 5+50)	
C3.1	CAMINO VALIENTE - PLAN & PROFILE - (STA 5+50 - END)	
C3.2	STREET DETAILS (1 OF 2)	
C3.3	STREET DETAILS (2 OF 2)	
C4.0	SIGNAGE & STRIPING PLAN	
C4.1	SIGNAGE & STRIPING DETAILS (1 OF 2)	
C4.2	SIGNAGE & STRIPING DETAILS (2 OF 2)	
C5.0	PROPOSED DRAINAGE AREA MAP	
C6.0	CHANNEL PLAN & PROFILE (STA 0+00 - STA 4+50)	
C6.1	CHANNEL PLAN & PROFILE (STA 4+50 - END)	
C6.2	CHANNEL AND STORM CROSS SECTIONS	
C7.0	SANITARY SEWER - PLAN AND PROFILE - (STA 1+00 TO STA 2+93)	
C7.1	SANITARY SEWER - PLAN AND PROFILE - (STA 2+93 TO END)	
C7.2	WATER PLAN (1 OF 2)	
C7.3	WATER PLAN (2 OF 2)	
C8.0	CONSTRUCTION DETAILS (2 OF 2)	
C8.1	CONSTRUCTION DETAILS (2 OF 2)	



LOCATED ON THE EAST SIDE OF SOUTH SYCAMORE STREET APPROX. ±175 NORTH OF THE INTERSECTION OF SOUTH SYCAMORE STREET AND STATE HIGHWAY LOOP NO. 256 ELEVATION: 569.91'




CAUTION!!

EXISTING UNDERGROUND UTILITIES IN THE AREA CONTRACTOR
IS RESPONSIBLE FOR DETERMINING THE HORIZONTAL AND
VERTICAL LOCATION OF ALL UTILITIES PRIOR TO CONSTRUCTION.
CONTRACTOR SHALL BE RESPONSIBLE FOR ANY REPAIRS TO
EXISTING UTILITIES DUE TO DAMAGE INCURRED DURING
CONSTRUCTION. CONTRACTOR SHALL NOTIFY THE ENGINEER OF
ANY DISCREPANCIES ON THE PLANS.

No. REVISIONS D.

© 2025 KIMLEY-HORN AND ASSOCIATES, INC.
10101 REUNION PLACE, SUITE 400, SAN ANTONIO, TX 78
PHONE: 210-541-9166 FAX: 210-541-8699
WWW.KIMLEY-HORN.COM TBPE FIRM NO. 928

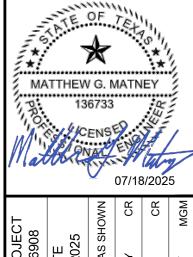

DATE
7/18/2025
SCALE AS SHOWN
DESIGNED BY CR

OVER SHEET

AMINO VALIENTE
PREPARED FOR
TE PROPERTY GROUP, INC.

SHEET NUMBER

28.EXISTING TREE LOCATIONS SHOWN ON THESE PLANS ARE APPROXIMATE. CONTRACTOR SHALL REPORT ANY DISCREPANCIES FOUND

30.TREE PROTECTION MEASURES SHALL BE INSTALLED IN ACCORDANCE WITH THE CITY STANDARD TREE PROTECTION DETAILS AND THE

29.CONTRACTOR SHALL FIELD VERIFY ALL PROTECTED TREE LOCATIONS, INDIVIDUAL PROTECTED TREE CRITICAL ROOT ZONES, AND

PROPOSED SITE GRADING, AND NOTIFY THE CIVIL ENGINEER AND LANDSCAPE ARCHITECT OF ANY CONFLICTS WITH THE TREE

IN THE FIELD THAT AFFECT THE GRADING PLAN TO THE CIVIL ENGINEER.

PRESERVATION PLAN BY THE LANDSCAPE ARCHITECT PRIOR TO COMMENCING THE WORK.

EMPLOYED IN THE STORM WATER POLLUTION PREVENTION PLAN (SWPPP) IF APPLICABLE.

9. CONTRACTOR SHALL PROVIDE ADEQUATE EROSION CONTROL DEVICES NEEDED DUE TO PROJECT PHASING.

APPROVED DETAILS.

7. AS STORM SEWER INLETS ARE INSTALLED ON-SITE, TEMPORARY EROSION CONTROL DEVICES SHALL BE INSTALLED AT EACH INLET PER

8. THE EROSION CONTROL DEVICES SHALL REMAIN IN PLACE UNTIL THE AREA IT PROTECTS HAS BEEN PERMANENTLY STABILIZED.

10. CONTRACTOR SHALL OBSERVE THE EFFECTIVENESS OF THE EROSION CONTROL DEVICES AND MAKE FIELD ADJUSTMENTS AND

MODIFICATIONS AS NEEDED TO PREVENT SEDIMENT FROM LEAVING THE SITE. IF THE EROSION CONTROL DEVICES DO NOT

19. ALL FIRE HYDRANTS, VALVES, TEES, BENDS, WYES, REDUCERS, FITTINGS, AND ENDS SHALL BE MECHANICALLY RESTRAINED AND/OR 20.CONTRACTOR SHALL INSTALL A FULL SEGMENT OF WATER OR WASTEWATER PIPE CENTERED AT ALL UTILITY CROSSINGS SO THAT THE JOINTS ARE GREATER THAN 9-FEET FROM THE CROSSING 21.ALL CROSSINGS AND LOCATIONS WHERE WASTEWATER IS LESS THAN 9-FEET FROM WATER, WASTEWATER CONSTRUCTION AND MATERIALS SHALL COMPLY WITH TOPO CHAPTER 217.53. 22.ALL CROSSING AND LOCATIONS WHERE WATER IS LESS THAN 9-FEET FROM WASTEWATER, WATER CONSTRUCTION AND MATERIALS SHALL COMPLY WITH TCEQ CHAPTER 290.44. 23.ALL WATER AND WASTEWATER SHALL BE TESTED IN ACCORDANCE WITH THE CITY, AWWA, AND TCEQ STANDARDS AND SPECIFICATIONS. AT A MINIMUM, THIS SHALL CONSIST OF THE FOLLOWING: a. ALL WATERLINES SHALL BE HYDROSTATICALLY TESTED AND CHLORINATED BEFORE BEING PLACED INTO SERVICE. CONTRACTOR SHALL COORDINATE WITH THE CITY FOR THEIR REQUIRED PROCEDURES AND SHALL ALSO COMPLY WITH TCEQ REGULATIONS. b. WASTEWATER LINES AND MANHOLES SHALL BE PRESSURE TESTED. CONTRACTOR SHALL COORDINATE WITH THE CITY FOR THEIR REQUIRED PROCEDURES AND SHALL ALSO COMPLY WITH TCEQ REGULATIONS. AFTER COMPLETION OF THESE TESTS, A TELEVISION INSPECTION SHALL BE PERFORMED AND PROVIDED TO THE CITY AND OWNER ON A DVD. 24. CONTRACTOR SHALL INSTALL DETECTABLE WIRING OR MARKING TAPE A MINIMUM OF 12" ABOVE WATER AND WASTEWATER LINES. MARKER DECALS SHALL BE LABELED "CAUTION - WATER LINE", OR "CAUTION - SEWER LINE". DETECTABLE WIRING AND MARKING TAPE SHALL COMPLY WITH CITY STANDARDS. AND SHALL BE INCLUDED IN THE COST OF THE WATER AND WASTEWATER PIPE. 25.DUCTILE IRON PIPE SHALL BE PROTECTED FROM CORROSION BY A LOW-DENSITY POLYETHYLENE LINER WRAP THAT IS AT LEAST A SINGLE LAYER OF 8-MIL. ALL DUCTILE IRON JOINTS SHALL BE BONDED. 26.WATERLINES SHALL BE INSTALLED AT NO LESS THAN THE MINIMUM COVER REQUIRED BY THE CITY. 27.CONTRACTOR SHALL PROVIDE CLEAN-OUTS FOR PRIVATE SANITARY SEWER LINES AT ALL CHANGES IN DIRECTION AND 100-FOOT INTERVALS, OR AS REQUIRED BY THE APPLICABLE PLUMBING CODE. CLEAN-OUTS REQUIRED IN PAVEMENT OR SIDEWALKS SHALL HAVE CAST IRON COVERS FLUSH WITH FINISHED GRADE. 28.CONTRACTOR SHALL PROVIDE BACKWATER VALVES FOR PLUMBING FIXTURES AS REQUIRED BY THE APPLICABLE PLUMBING CODE (E.G FLOOR ELEVATION OF FIXTURE UNIT IS BELOW THE ELEVATION OF THE MANHOLE COVER OF THE NEXT UPSTREAM MANHOLE IN THE PUBLIC SEWER). CONTRACTOR SHALL REVIEW BOTH MEP AND CIVIL PLANS TO CONFIRM WHERE THESE ARE REQUIRED. 29. THE CONTRACTOR IS RESPONSIBLE FOR OBTAINING AND SUBMITTING A TRENCH SAFETY PLAN. PREPARED BY A PROFESSIONAL ENGINEER IN THE STATE OF TEXAS, TO THE CITY PRIOR TO CONSTRUCTION. CONTRACTOR IS RESPONSIBLE FOR MAINTAINING TRENCI SAFETY REQUIREMENTS IN ACCORDANCE WITH CITY, STATE, AND FEDERAL REQUIREMENTS, INCLUDING OSHA FOR ALL TRENCHES. NO OPEN TRENCHES SHALL BE ALLOWED OVERNIGHT WITHOUT PRIOR WRITTEN APPROVAL OF THE CITY. 30.THE CONTRACTOR SHALL KEEP TRENCHES FREE FROM WATER. AS PART OF THE BASE BID FOR THIS PROJECT, CONTRACTOR SHALL ADHERE TO THE PROJECT GEOTECHNICAL REPORT FOR ALL RECOMMENDATIONS FOR BOTH MATERIALS AND PRACTICE OF INSTALLATION GIVEN IN THE PROJECT GEOTECHNICAL REPORT FOR EARTHWORK, SITE SUBGRADE PREPARATION, BUILDING PAD SUBGRADE PREPARATION, PAVING, AND WET/SOFT SOILS CONDITIONS ALONG WITH ANY OTHER SECTIONS PROVIDED IN THE REPORT. TITLE: SUBSURFACE EXPLORATION AND PAVEMENT ANALYSIS - PROPOSED NEW STREETS -SPEEDWAY PLAZA RESIDENTIAL - PHASES I & II INTEGRATED TESTING AND ENGINEERING COMPANY OF SAN ANTONIO, LP.

Ш

SHEET NUMBER

BENCHMARK LIST LOCATED ON THE EAST SIDE OF SOUTH SYCAMORE STREET

ELEVATION: 569.91'

16. THE CONTRACTOR IS RESPONSIBLE TO PROTECT ALL WATER AND WASTEWATER LINES CROSSING THE PROJECT. THE CONTRACTOR

SHALL REPAIR ALL DAMAGED LINES IMMEDIATELY. ALL REPAIRS OF EXISTING WATER MAINS, WATER SERVICES, SEWER MAINS, AND

18. THE ENDS OF ALL EXISTING WATER MAINS THAT ARE CUT. BUT NOT REMOVED. SHALL BE PLUGGED AND ABANDONED IN PLACE. THIS

WORK SHALL BE CONSIDERED AS A SUBSIDIARY COST TO THE PROJECT AND NO ADDITIONAL COMPENSATION SHALL BE ALLOWED.


SANITARY SEWER SERVICES ARE SUBSIDIARY TO THE WORK, AND NO ADDITIONAL COMPENSATION SHALL BE ALLOWED.


17. VALVE ADJUSTMENTS SHALL BE CONSTRUCTED SUCH THAT THE COVERS ARE AT FINISHED SURFACE GRADE OF THE PROPOSED

APPROX. ±175 NORTH OF THE INTERSECTION OF SOUTH

SYCAMORE STREET AND STATE HIGHWAY LOOP NO. 256

EXISTING UNDERGROUND UTILITIES IN THE AREA CONTRACTOR IS RESPONSIBLE FOR DETERMINING THE HORIZONTAL AND VERTICAL LOCATION OF ALL UTILITIES PRIOR TO CONSTRUCTION. CONTRACTOR SHALL BE RESPONSIBLE FOR ANY REPAIRS TO EXISTING UTILITIES DUE TO DAMAGE INCURRED DURING CONSTRUCTION. CONTRACTOR SHALL NOTIFY THE ENGINEER OF ANY DISCREPANCIES ON THE PLANS.

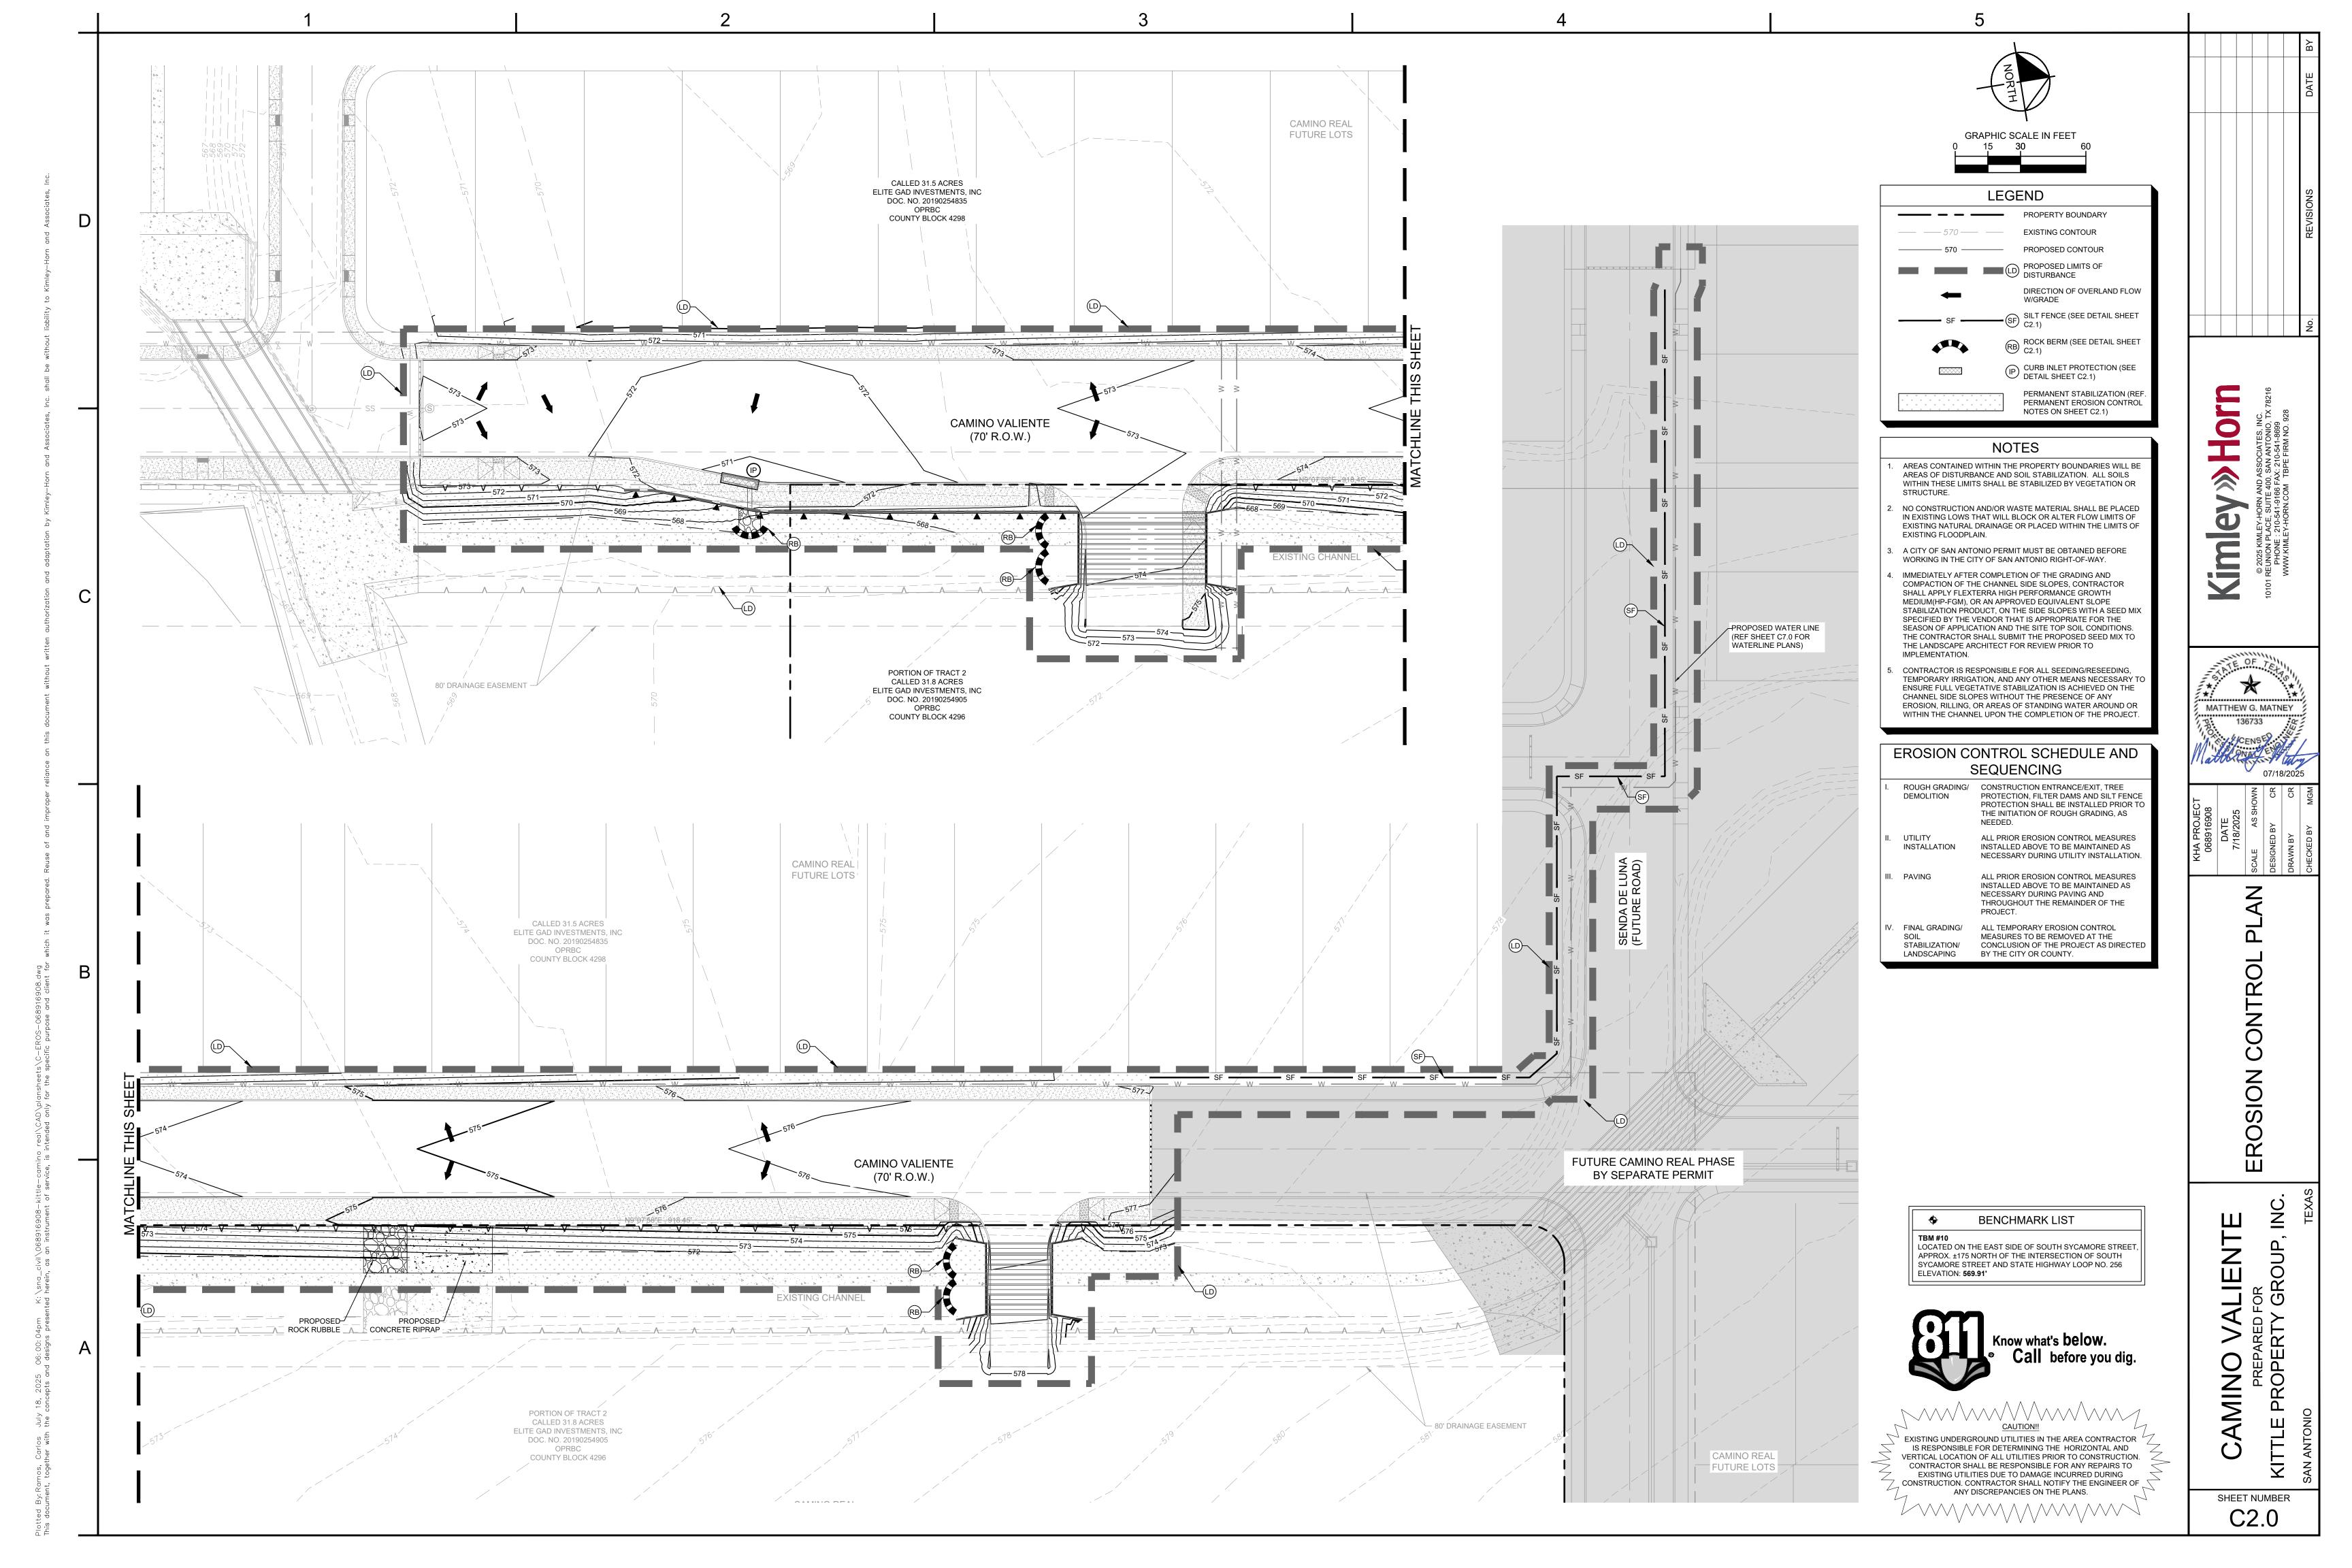

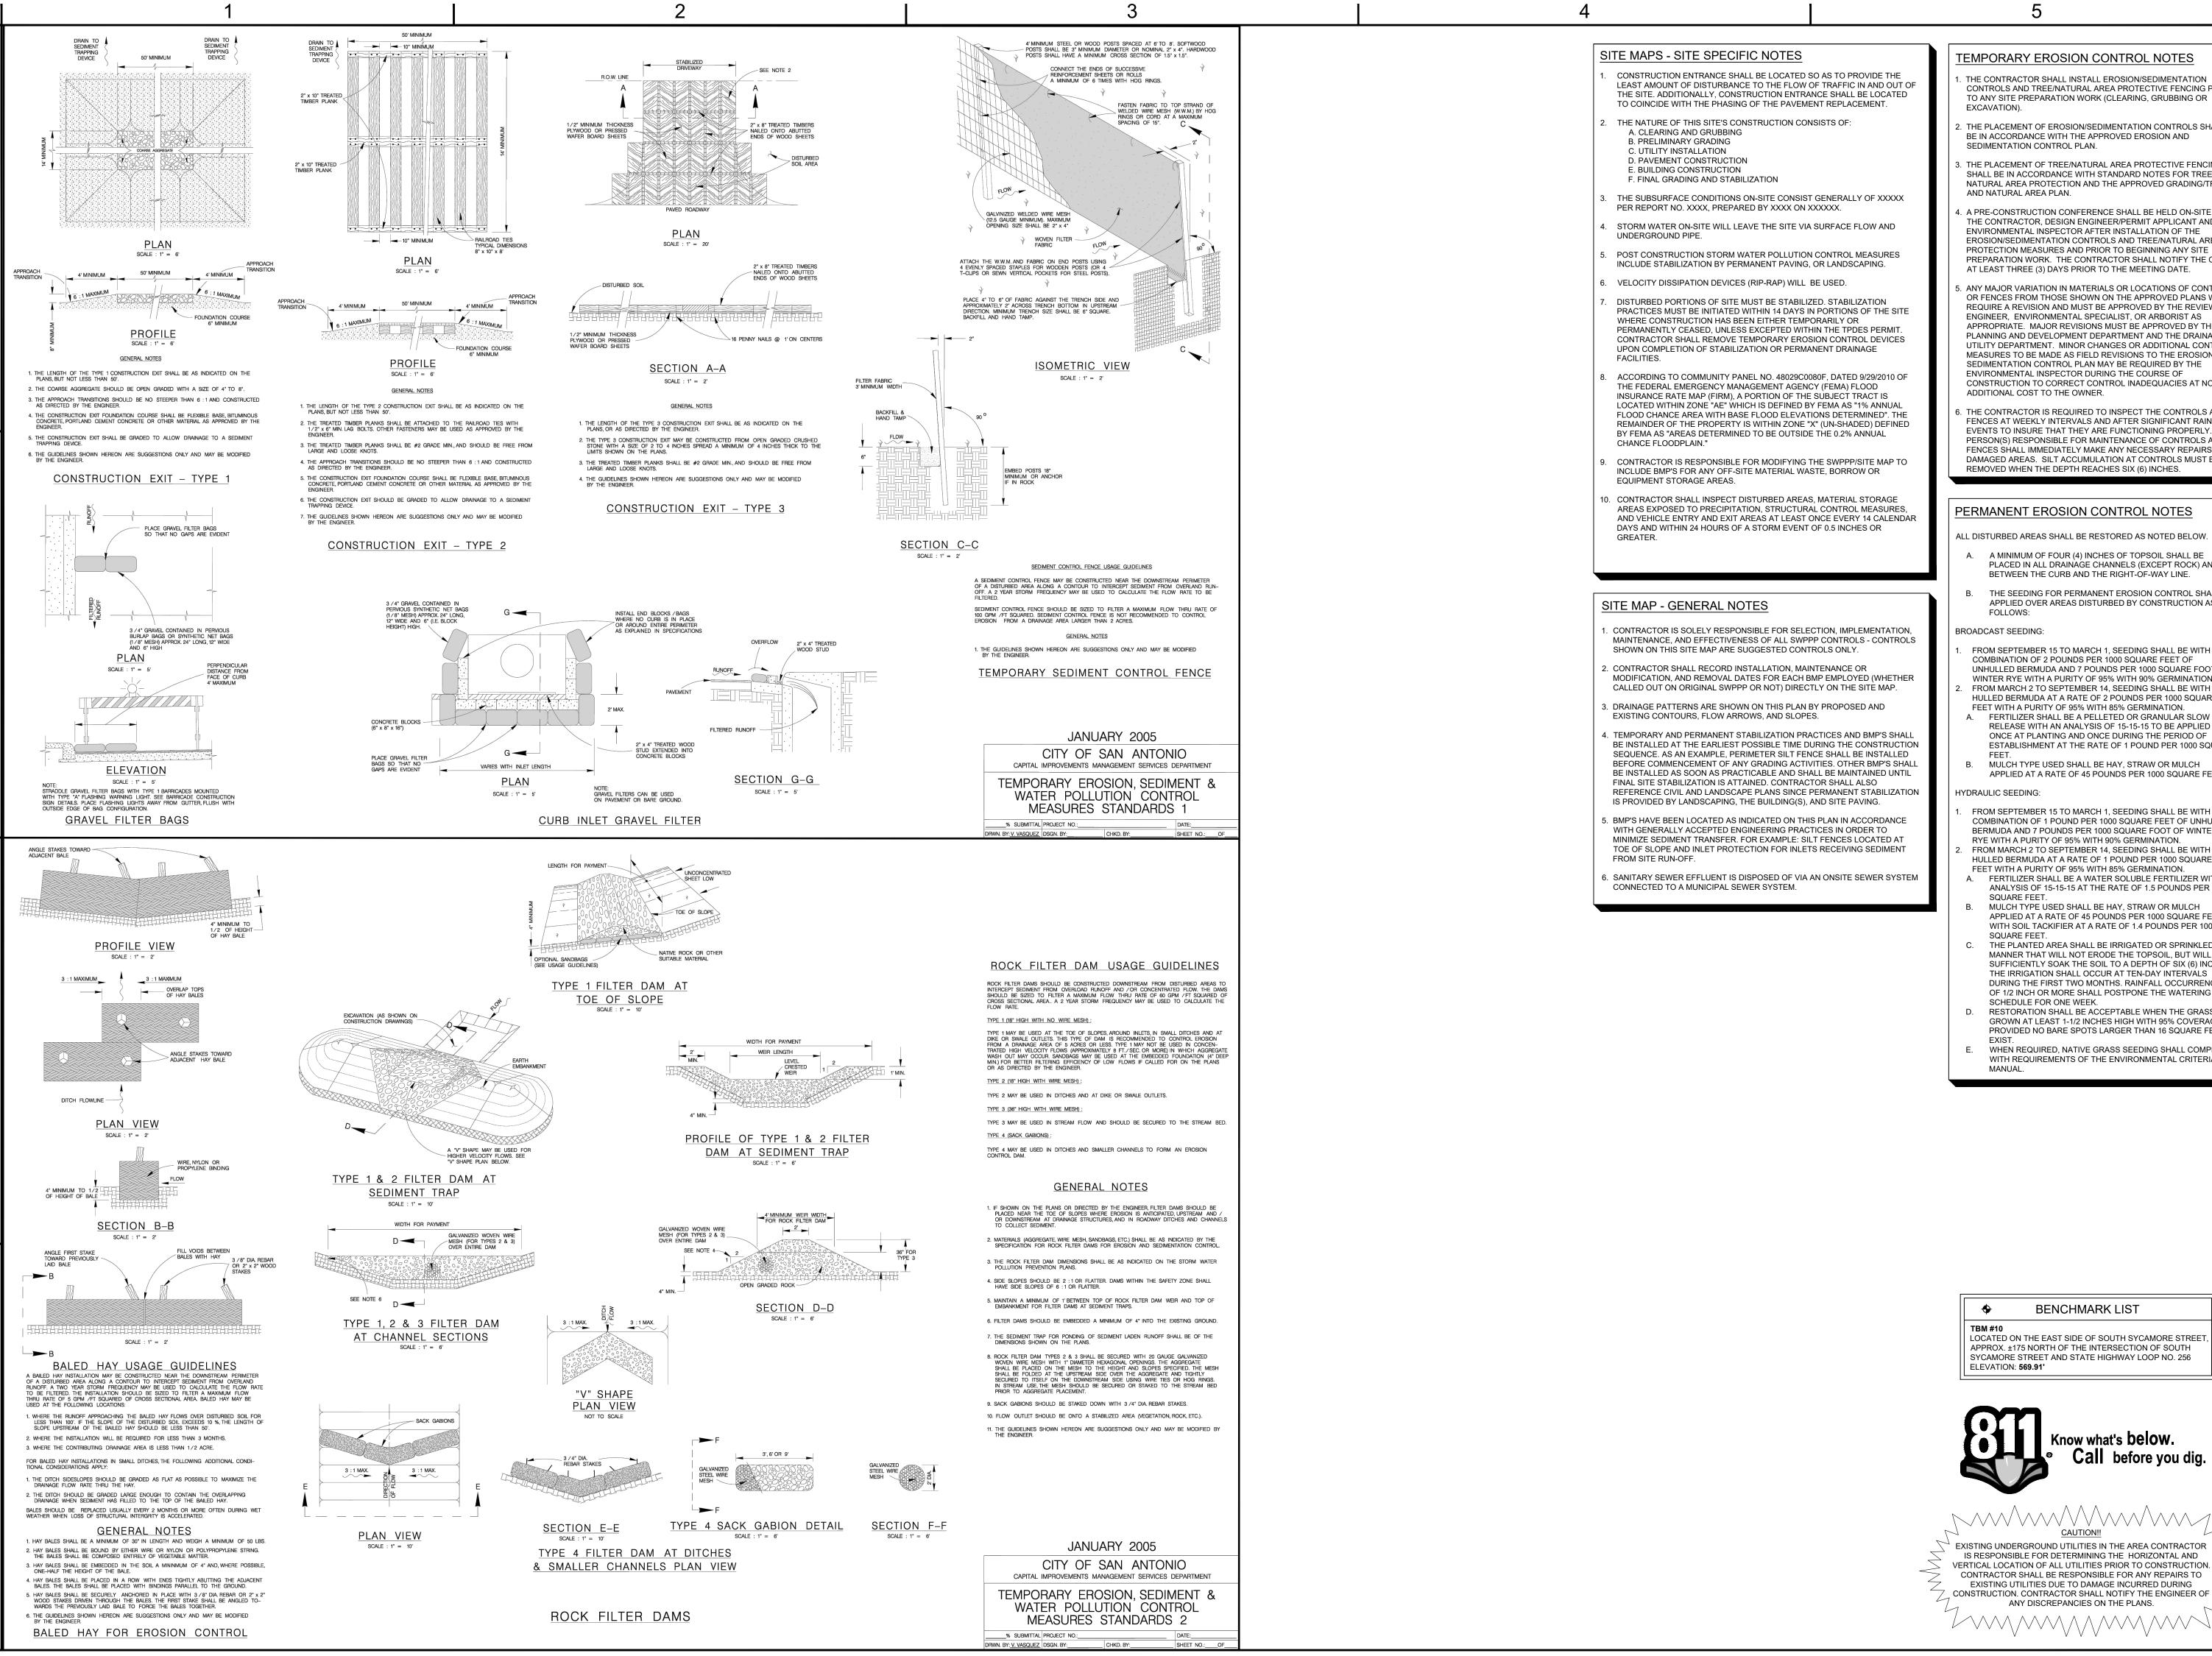

TEMPORARY EROSION CONTROL NOTES

THE CONTRACTOR SHALL INSTALL EROSION/SEDIMENTATION CONTROLS AND TREE/NATURAL AREA PROTECTIVE FENCING PRIOR TO ANY SITE PREPARATION WORK (CLEARING, GRUBBING OR

THE PLACEMENT OF EROSION/SEDIMENTATION CONTROLS SHALL

BE IN ACCORDANCE WITH THE APPROVED EROSION AND

THE PLACEMENT OF TREE/NATURAL AREA PROTECTIVE FENCING SHALL BE IN ACCORDANCE WITH STANDARD NOTES FOR TREE AND NATURAL AREA PROTECTION AND THE APPROVED GRADING/TREE

. A PRE-CONSTRUCTION CONFERENCE SHALL BE HELD ON-SITE WITH THE CONTRACTOR, DESIGN ENGINEER/PERMIT APPLICANT AND ENVIRONMENTAL INSPECTOR AFTER INSTALLATION OF THE EROSION/SEDIMENTATION CONTROLS AND TREE/NATURAL AREA PROTECTION MEASURES AND PRIOR TO BEGINNING ANY SITE PREPARATION WORK. THE CONTRACTOR SHALL NOTIFY THE CITY

ANY MAJOR VARIATION IN MATERIALS OR LOCATIONS OF CONTROLS OR FENCES FROM THOSE SHOWN ON THE APPROVED PLANS WILL REQUIRE A REVISION AND MUST BE APPROVED BY THE REVIEWING ENGINEER, ENVIRONMENTAL SPECIALIST, OR ARBORIST AS APPROPRIATE. MAJOR REVISIONS MUST BE APPROVED BY THE PLANNING AND DEVELOPMENT DEPARTMENT AND THE DRAINAGE UTILITY DEPARTMENT. MINOR CHANGES OR ADDITIONAL CONTROL MEASURES TO BE MADE AS FIELD REVISIONS TO THE EROSION AND SEDIMENTATION CONTROL PLAN MAY BE REQUIRED BY THE ENVIRONMENTAL INSPECTOR DURING THE COURSE OF CONSTRUCTION TO CORRECT CONTROL INADEQUACIES AT NO

THE CONTRACTOR IS REQUIRED TO INSPECT THE CONTROLS AND FENCES AT WEEKLY INTERVALS AND AFTER SIGNIFICANT RAINFALL EVENTS TO INSURE THAT THEY ARE FUNCTIONING PROPERLY. THE PERSON(S) RESPONSIBLE FOR MAINTENANCE OF CONTROLS AND FENCES SHALL IMMEDIATELY MAKE ANY NECESSARY REPAIRS TO DAMAGED AREAS. SILT ACCUMULATION AT CONTROLS MUST BE

0

*

MATTHEW G. MATNEY

PERMANENT EROSION CONTROL NOTES

ALL DISTURBED AREAS SHALL BE RESTORED AS NOTED BELOW.

A. A MINIMUM OF FOUR (4) INCHES OF TOPSOIL SHALL BE

FROM SEPTEMBER 15 TO MARCH 1, SEEDING SHALL BE WITH A COMBINATION OF 2 POUNDS PER 1000 SQUARE FEET OF UNHULLED BERMUDA AND 7 POUNDS PER 1000 SQUARE FOOT OF WINTER RYE WITH A PURITY OF 95% WITH 90% GERMINATION. FROM MARCH 2 TO SEPTEMBER 14, SEEDING SHALL BE WITH HULLED BERMUDA AT A RATE OF 2 POUNDS PER 1000 SQUARE FEET WITH A PURITY OF 95% WITH 85% GERMINATION. A. FERTILIZER SHALL BE A PELLETED OR GRANULAR SLOW

ESTABLISHMENT AT THE RATE OF 1 POUND PER 1000 SQUARE

APPLIED AT A RATE OF 45 POUNDS PER 1000 SQUARE FEET.

FROM SEPTEMBER 15 TO MARCH 1, SEEDING SHALL BE WITH A COMBINATION OF 1 POUND PER 1000 SQUARE FEET OF UNHULLED BERMUDA AND 7 POUNDS PER 1000 SQUARE FOOT OF WINTER RYE WITH A PURITY OF 95% WITH 90% GERMINATION.

HULLED BERMUDA AT A RATE OF 1 POUND PER 1000 SQUARE FEET WITH A PURITY OF 95% WITH 85% GERMINATION. FERTILIZER SHALL BE A WATER SOLUBLE FERTILIZER WITH AN

ANALYSIS OF 15-15-15 AT THE RATE OF 1.5 POUNDS PER 1000 MULCH TYPE USED SHALL BE HAY, STRAW OR MULCH

APPLIED AT A RATE OF 45 POUNDS PER 1000 SQUARE FEET, WITH SOIL TACKIFIER AT A RATE OF 1.4 POUNDS PER 1000

THE PLANTED AREA SHALL BE IRRIGATED OR SPRINKLED IN A MANNER THAT WILL NOT ERODE THE TOPSOIL, BUT WILL SUFFICIENTLY SOAK THE SOIL TO A DEPTH OF SIX (6) INCHES. THE IRRIGATION SHALL OCCUR AT TEN-DAY INTERVALS DURING THE FIRST TWO MONTHS. RAINFALL OCCURRENCES OF 1/2 INCH OR MORE SHALL POSTPONE THE WATERING

WITH REQUIREMENTS OF THE ENVIRONMENTAL CRITERIA

PLACED IN ALL DRAINAGE CHANNELS (EXCEPT ROCK) AND BETWEEN THE CURB AND THE RIGHT-OF-WAY LINE.

THE SEEDING FOR PERMANENT EROSION CONTROL SHALL BE APPLIED OVER AREAS DISTURBED BY CONSTRUCTION AS

MULCH TYPE USED SHALL BE HAY, STRAW OR MULCH

FROM MARCH 2 TO SEPTEMBER 14, SEEDING SHALL BE WITH

D. RESTORATION SHALL BE ACCEPTABLE WHEN THE GRASS HAS

GROWN AT LEAST 1-1/2 INCHES HIGH WITH 95% COVERAGE, PROVIDED NO BARE SPOTS LARGER THAN 16 SQUARE FEET E. WHEN REQUIRED, NATIVE GRASS SEEDING SHALL COMPLY

APPROX. ±175 NORTH OF THE INTERSECTION OF SOUTH SYCAMORE STREET AND STATE HIGHWAY LOOP NO. 256



EXISTING UNDERGROUND UTILITIES IN THE AREA CONTRACTOR IS RESPONSIBLE FOR DETERMINING THE HORIZONTAL AND VERTICAL LOCATION OF ALL UTILITIES PRIOR TO CONSTRUCTION. CONTRACTOR SHALL BE RESPONSIBLE FOR ANY REPAIRS TO EXISTING UTILITIES DUE TO DAMAGE INCURRED DURING CONSTRUCTION. CONTRACTOR SHALL NOTIFY THE ENGINEER OF

SHEET NUMBER


ROUP,

PREPA ROPEI


Ш


Z


Ξ

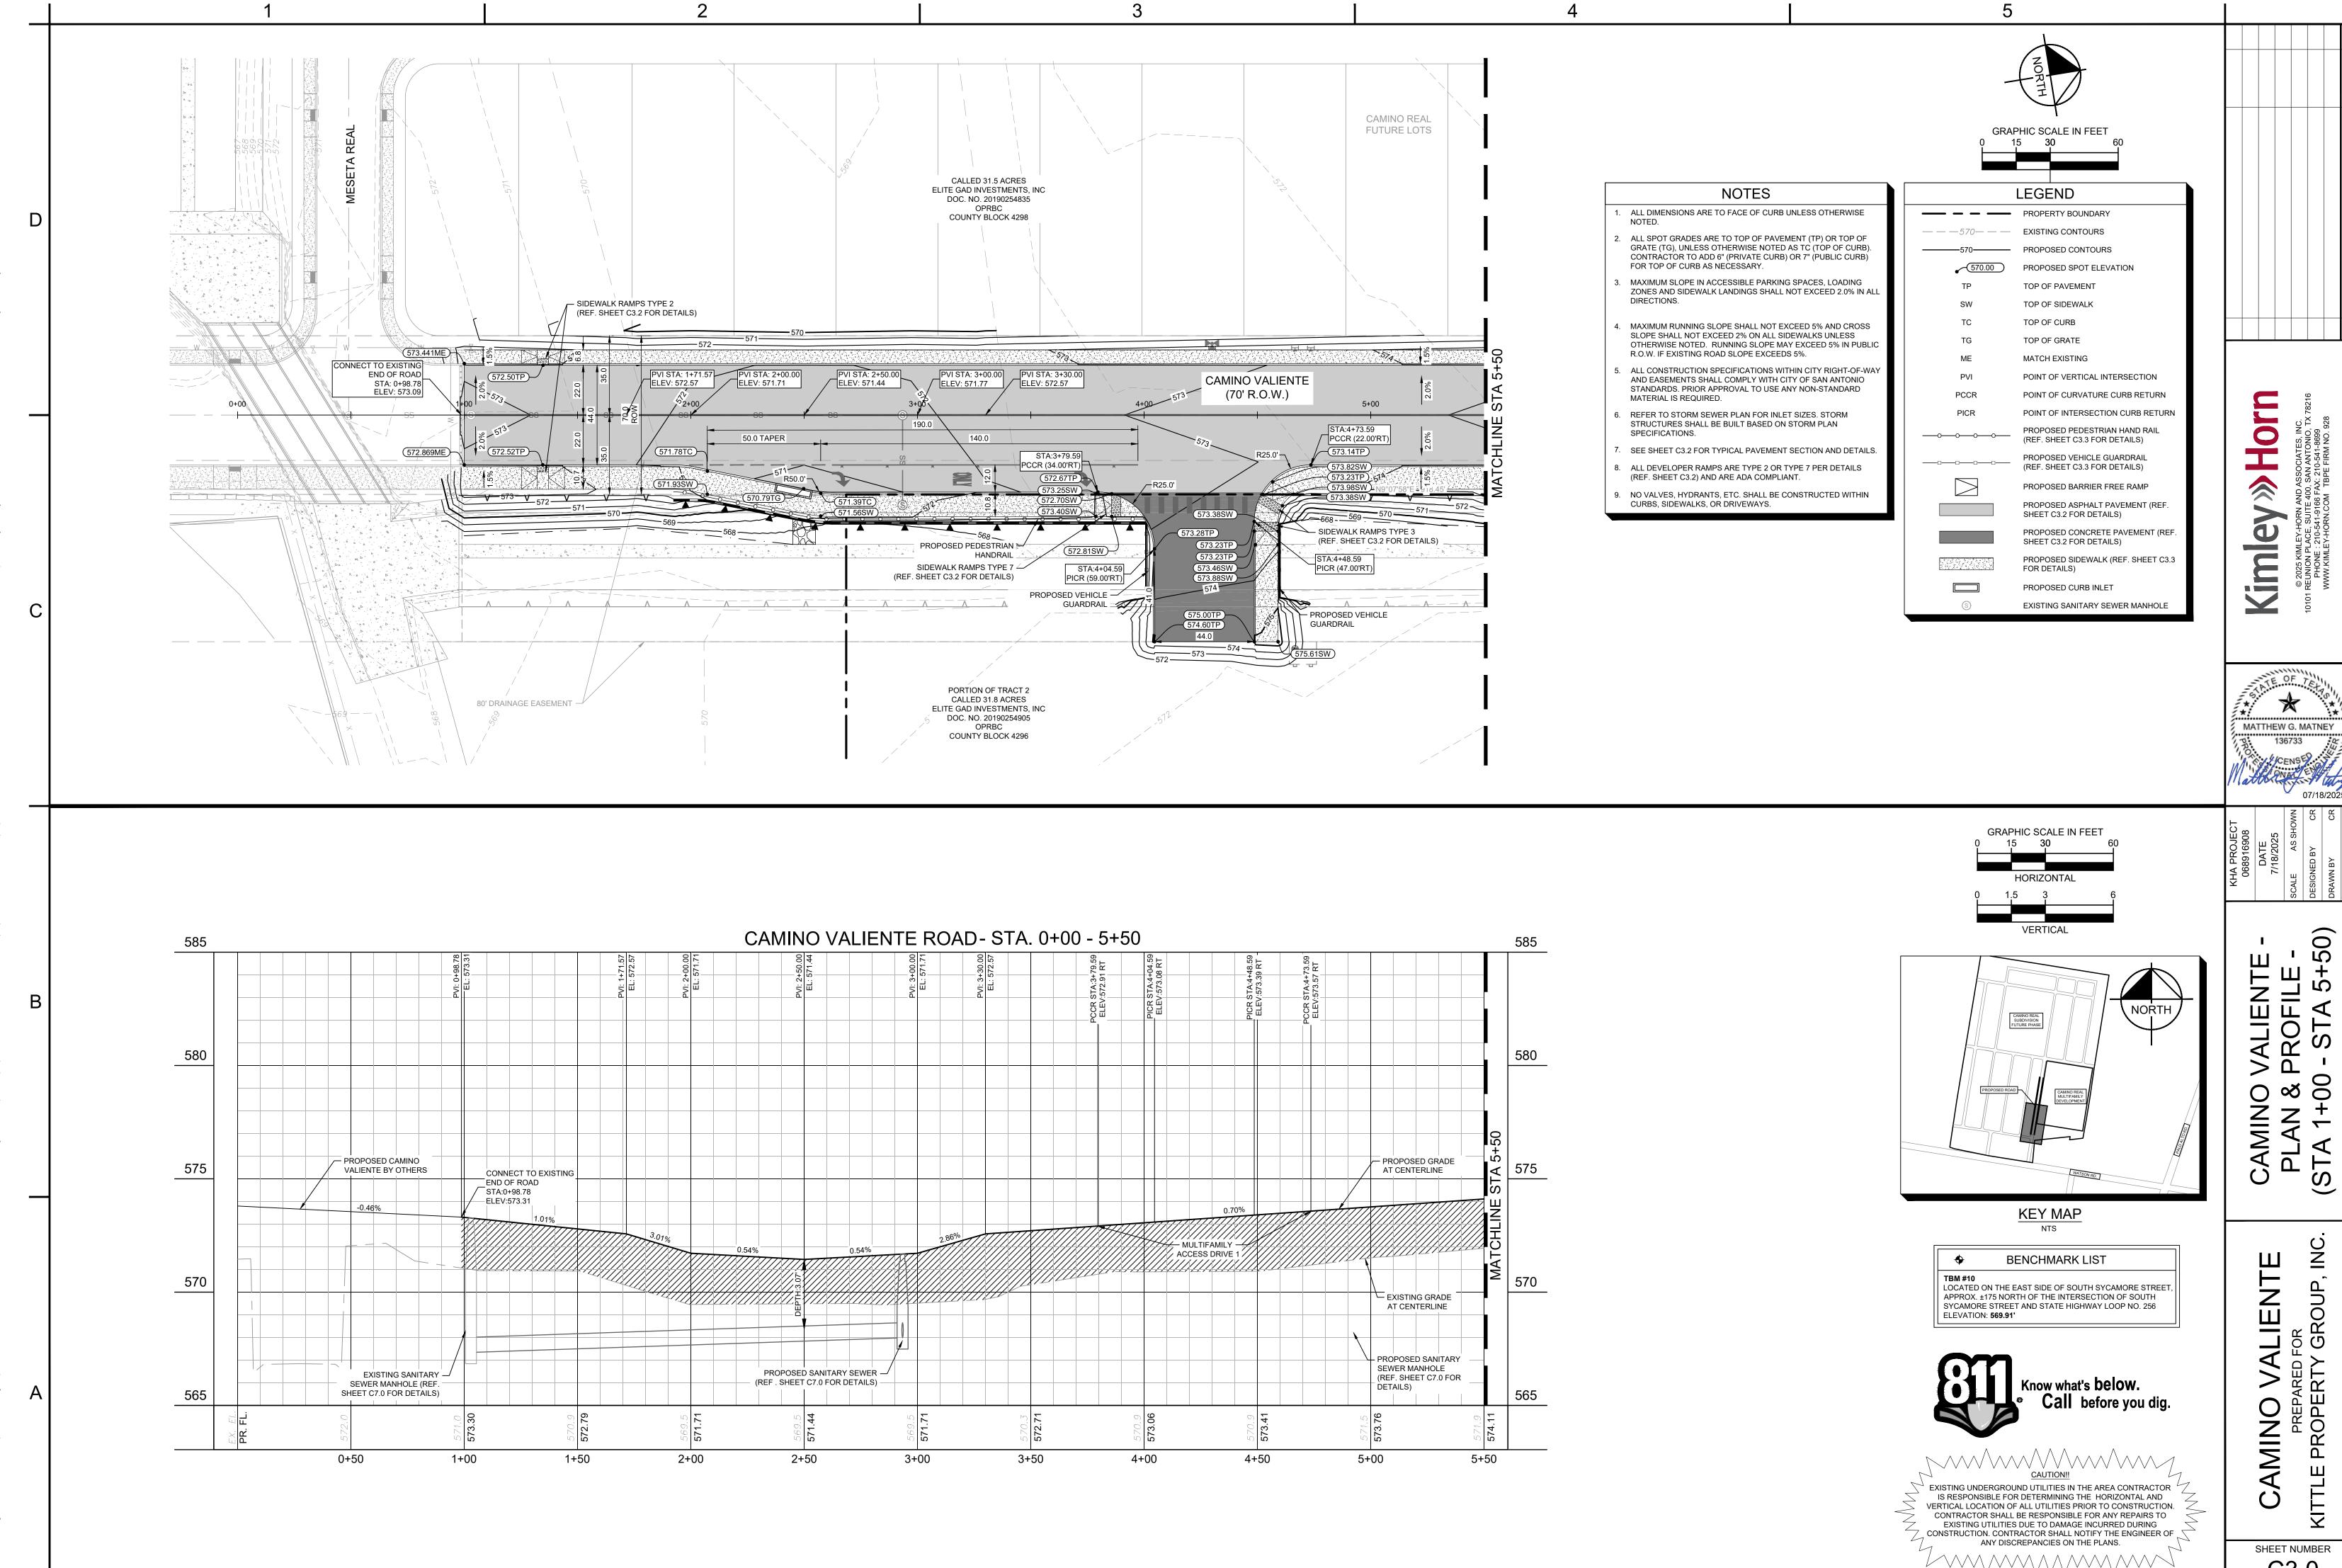



C3.0

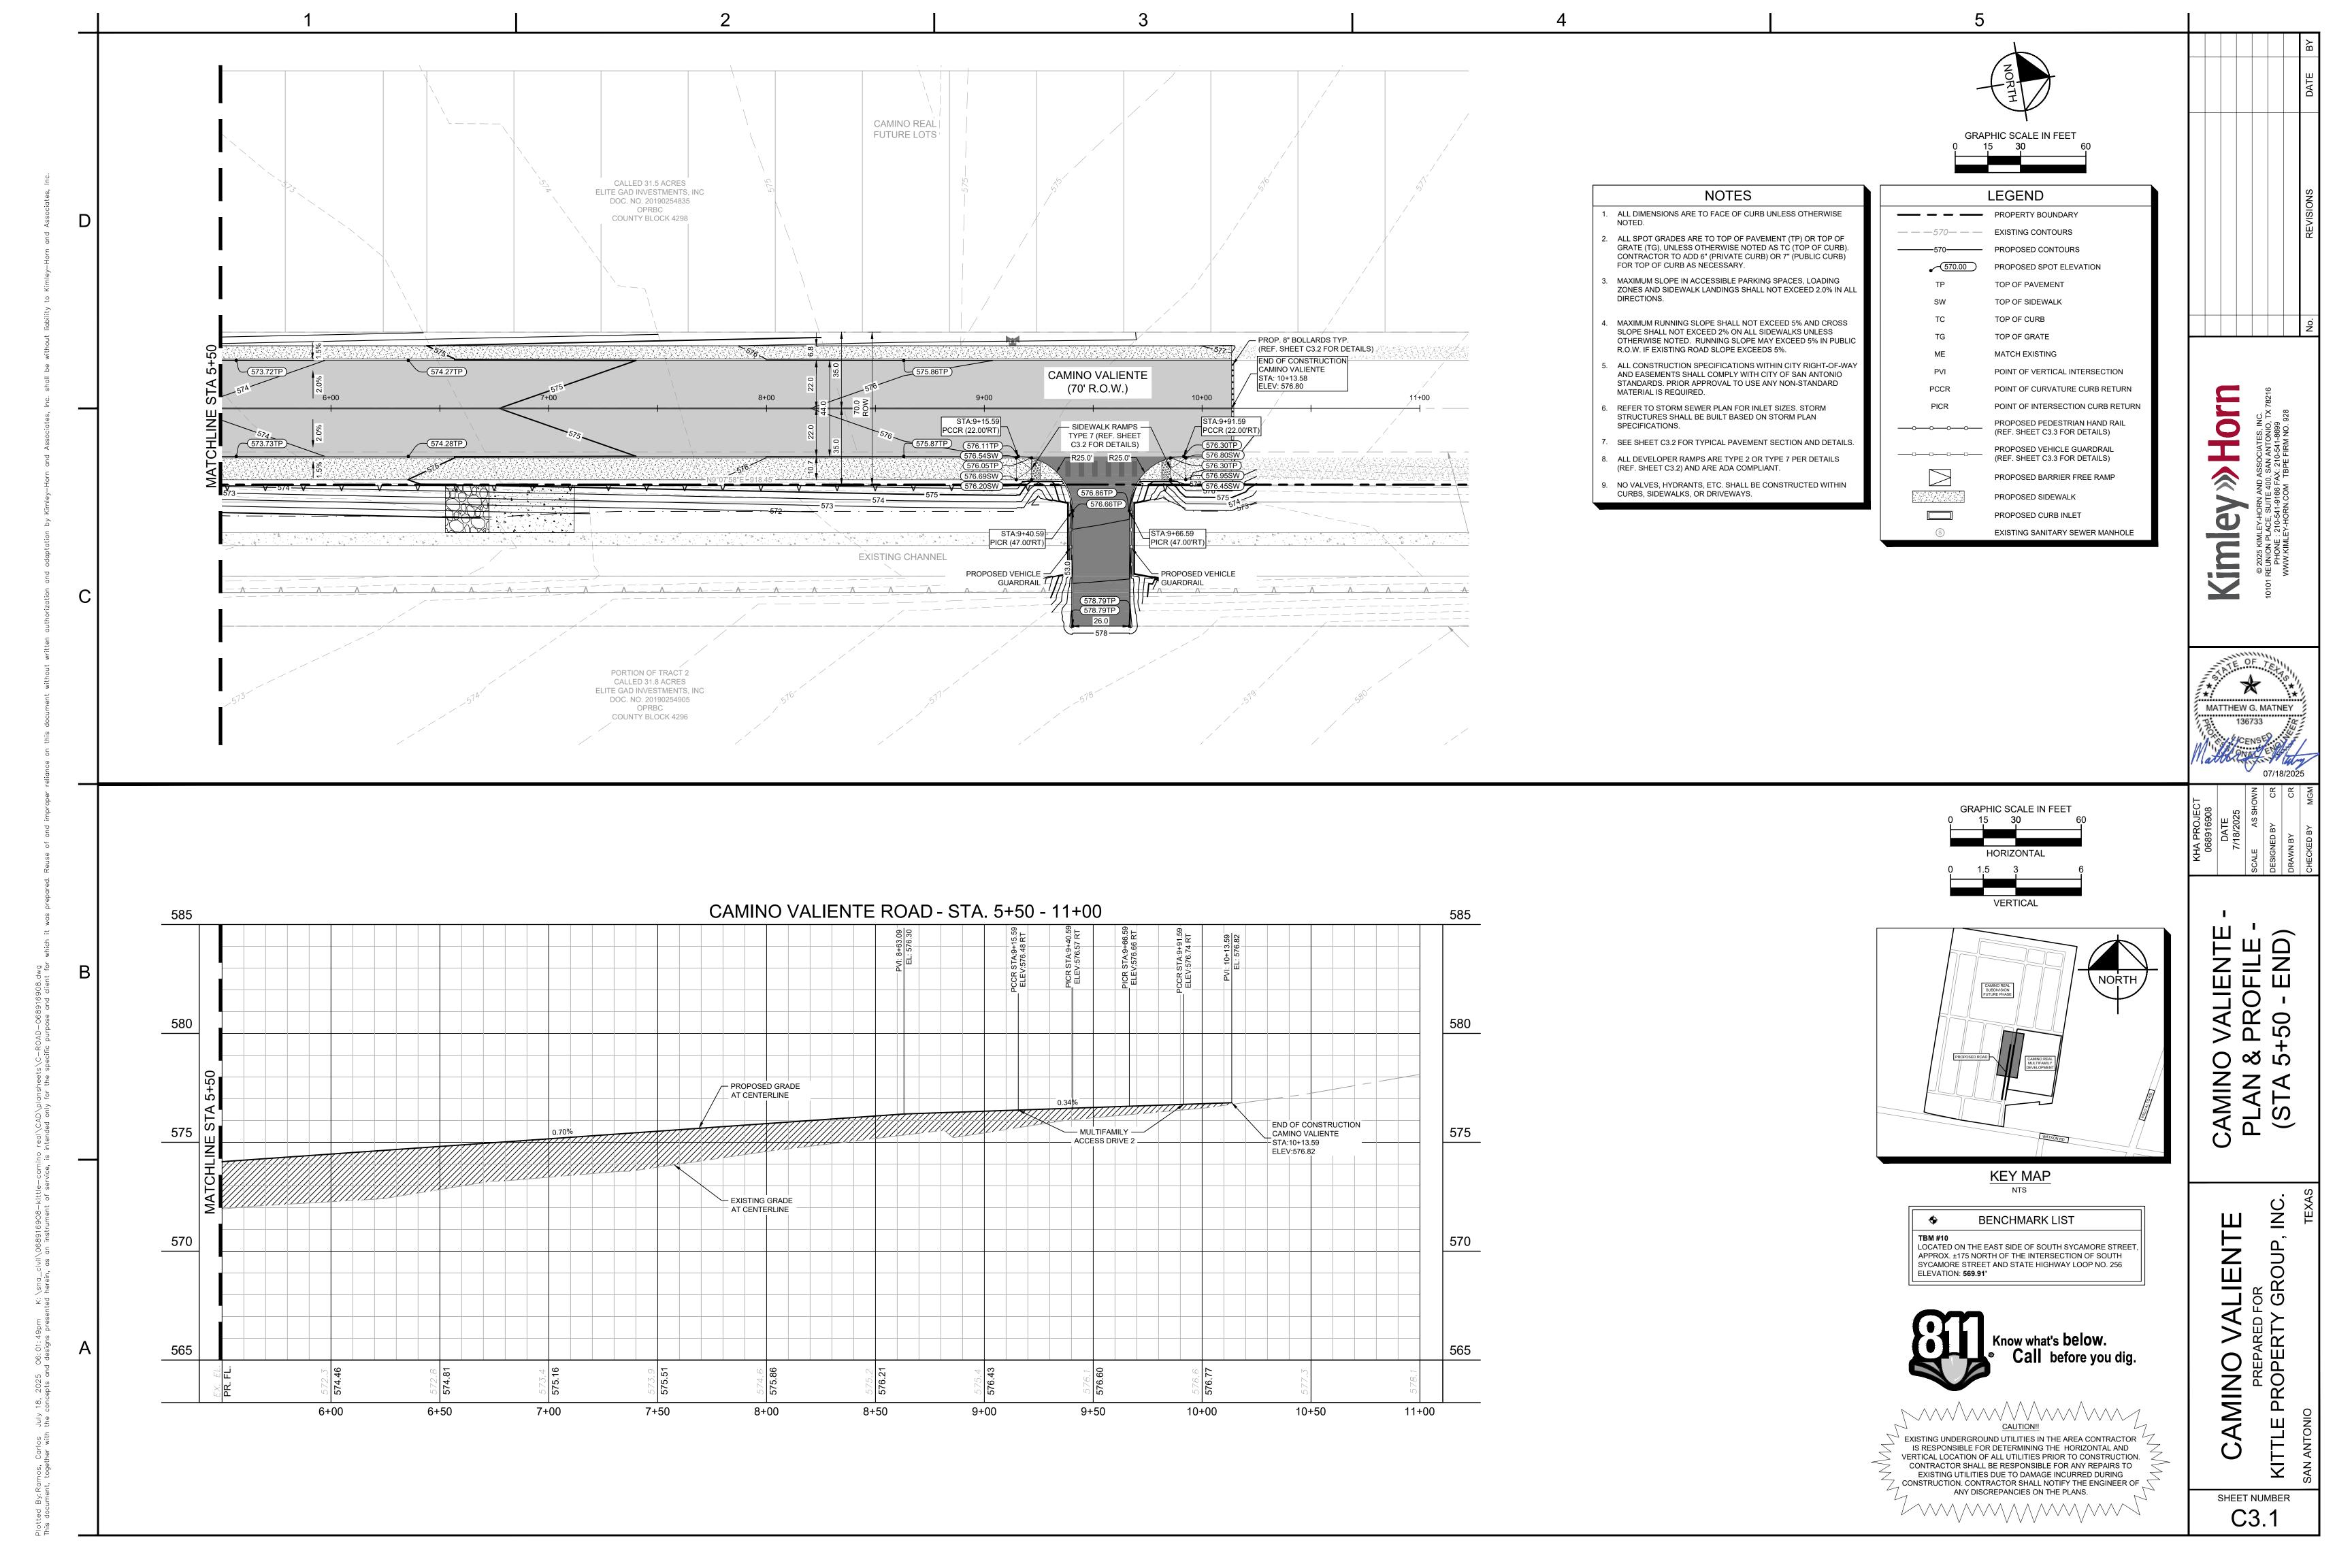


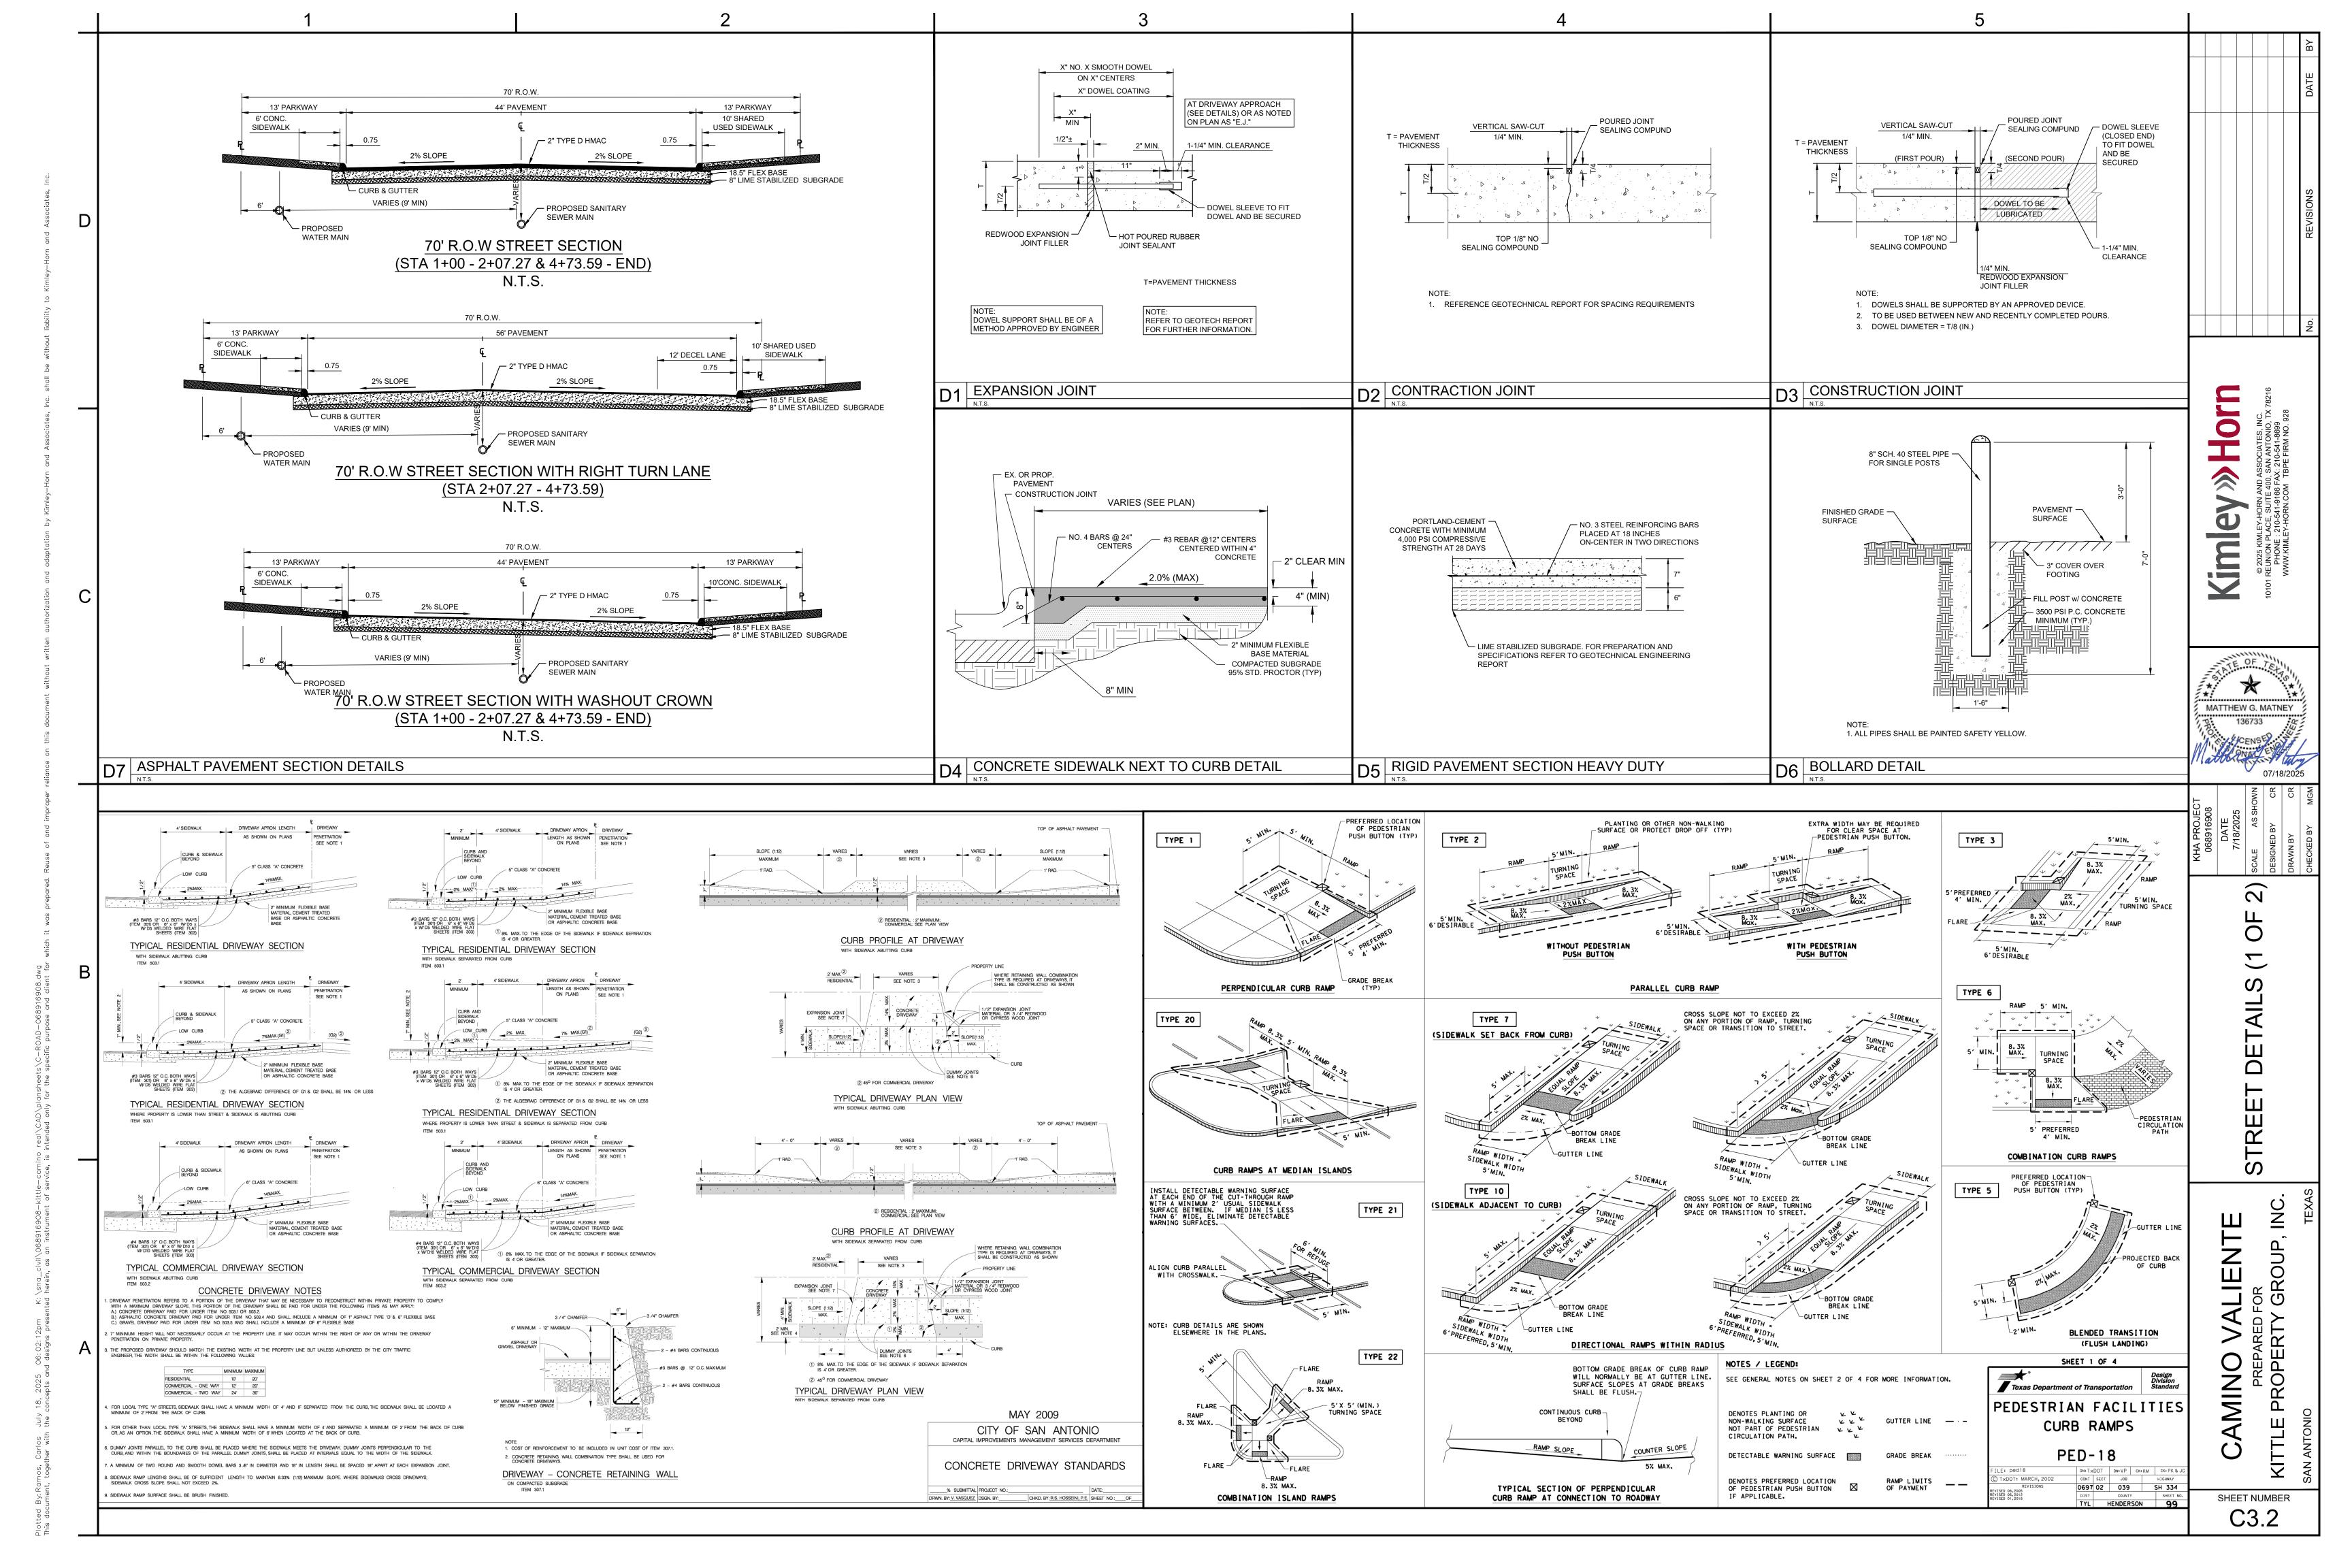


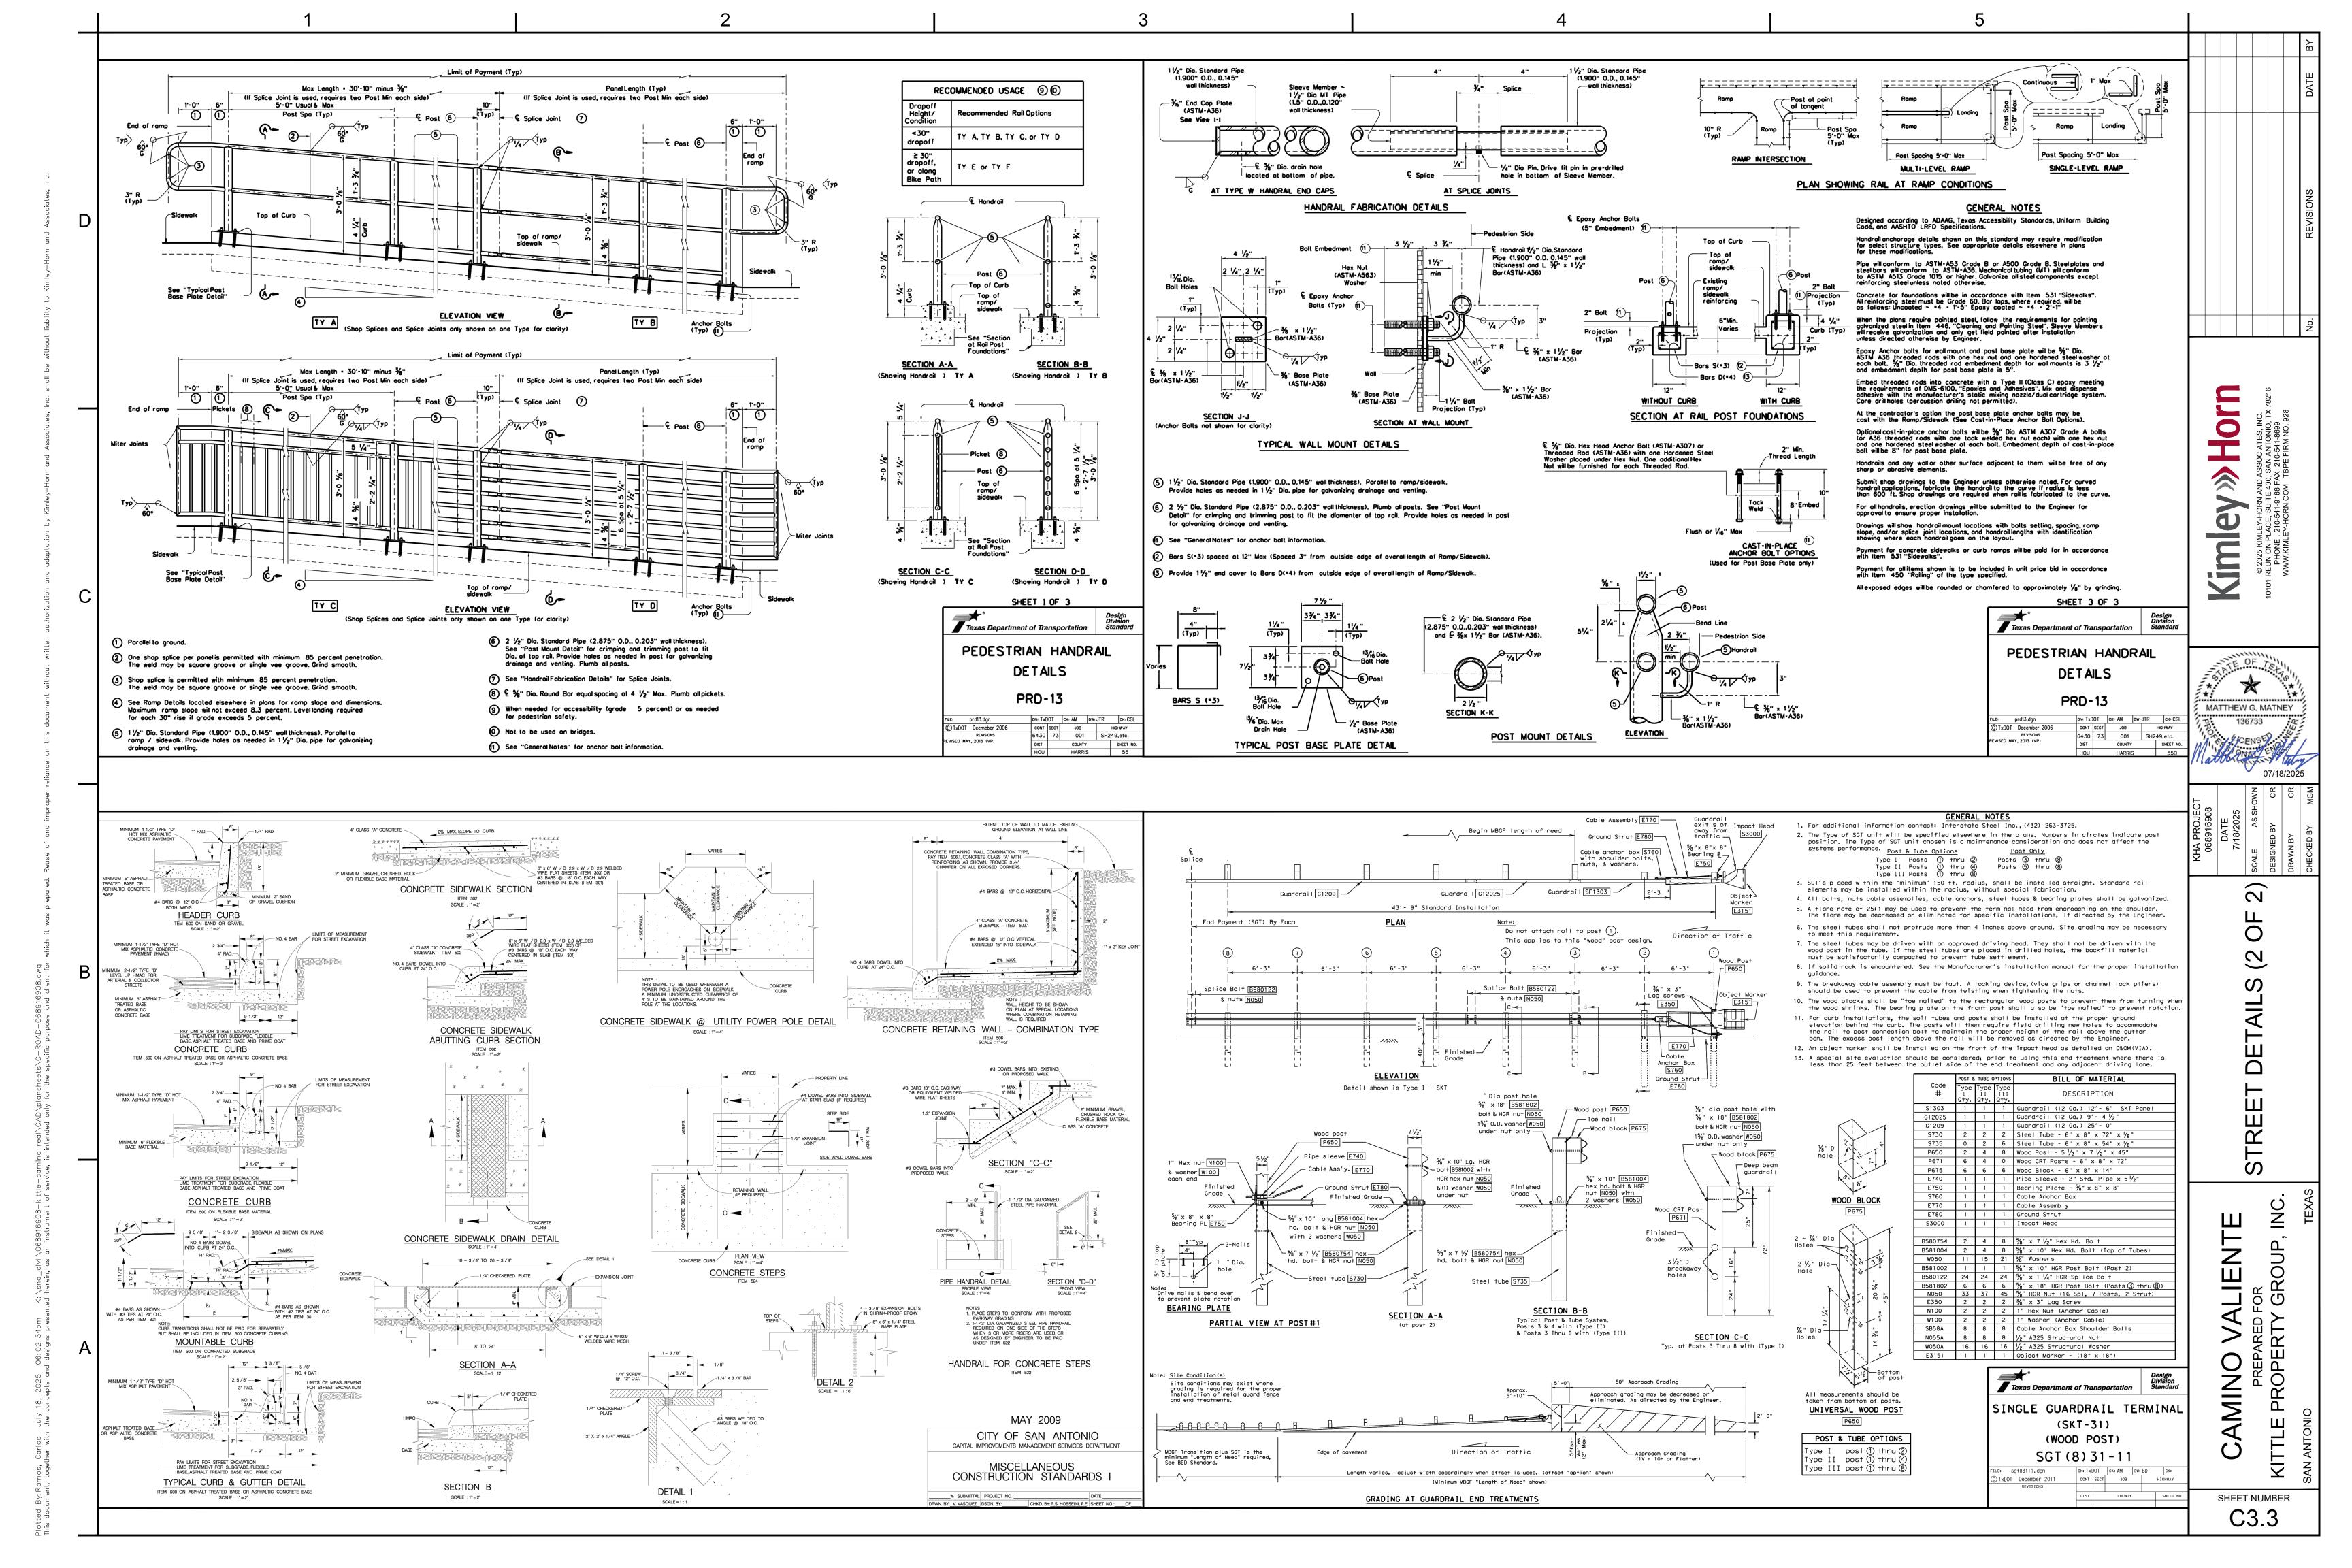

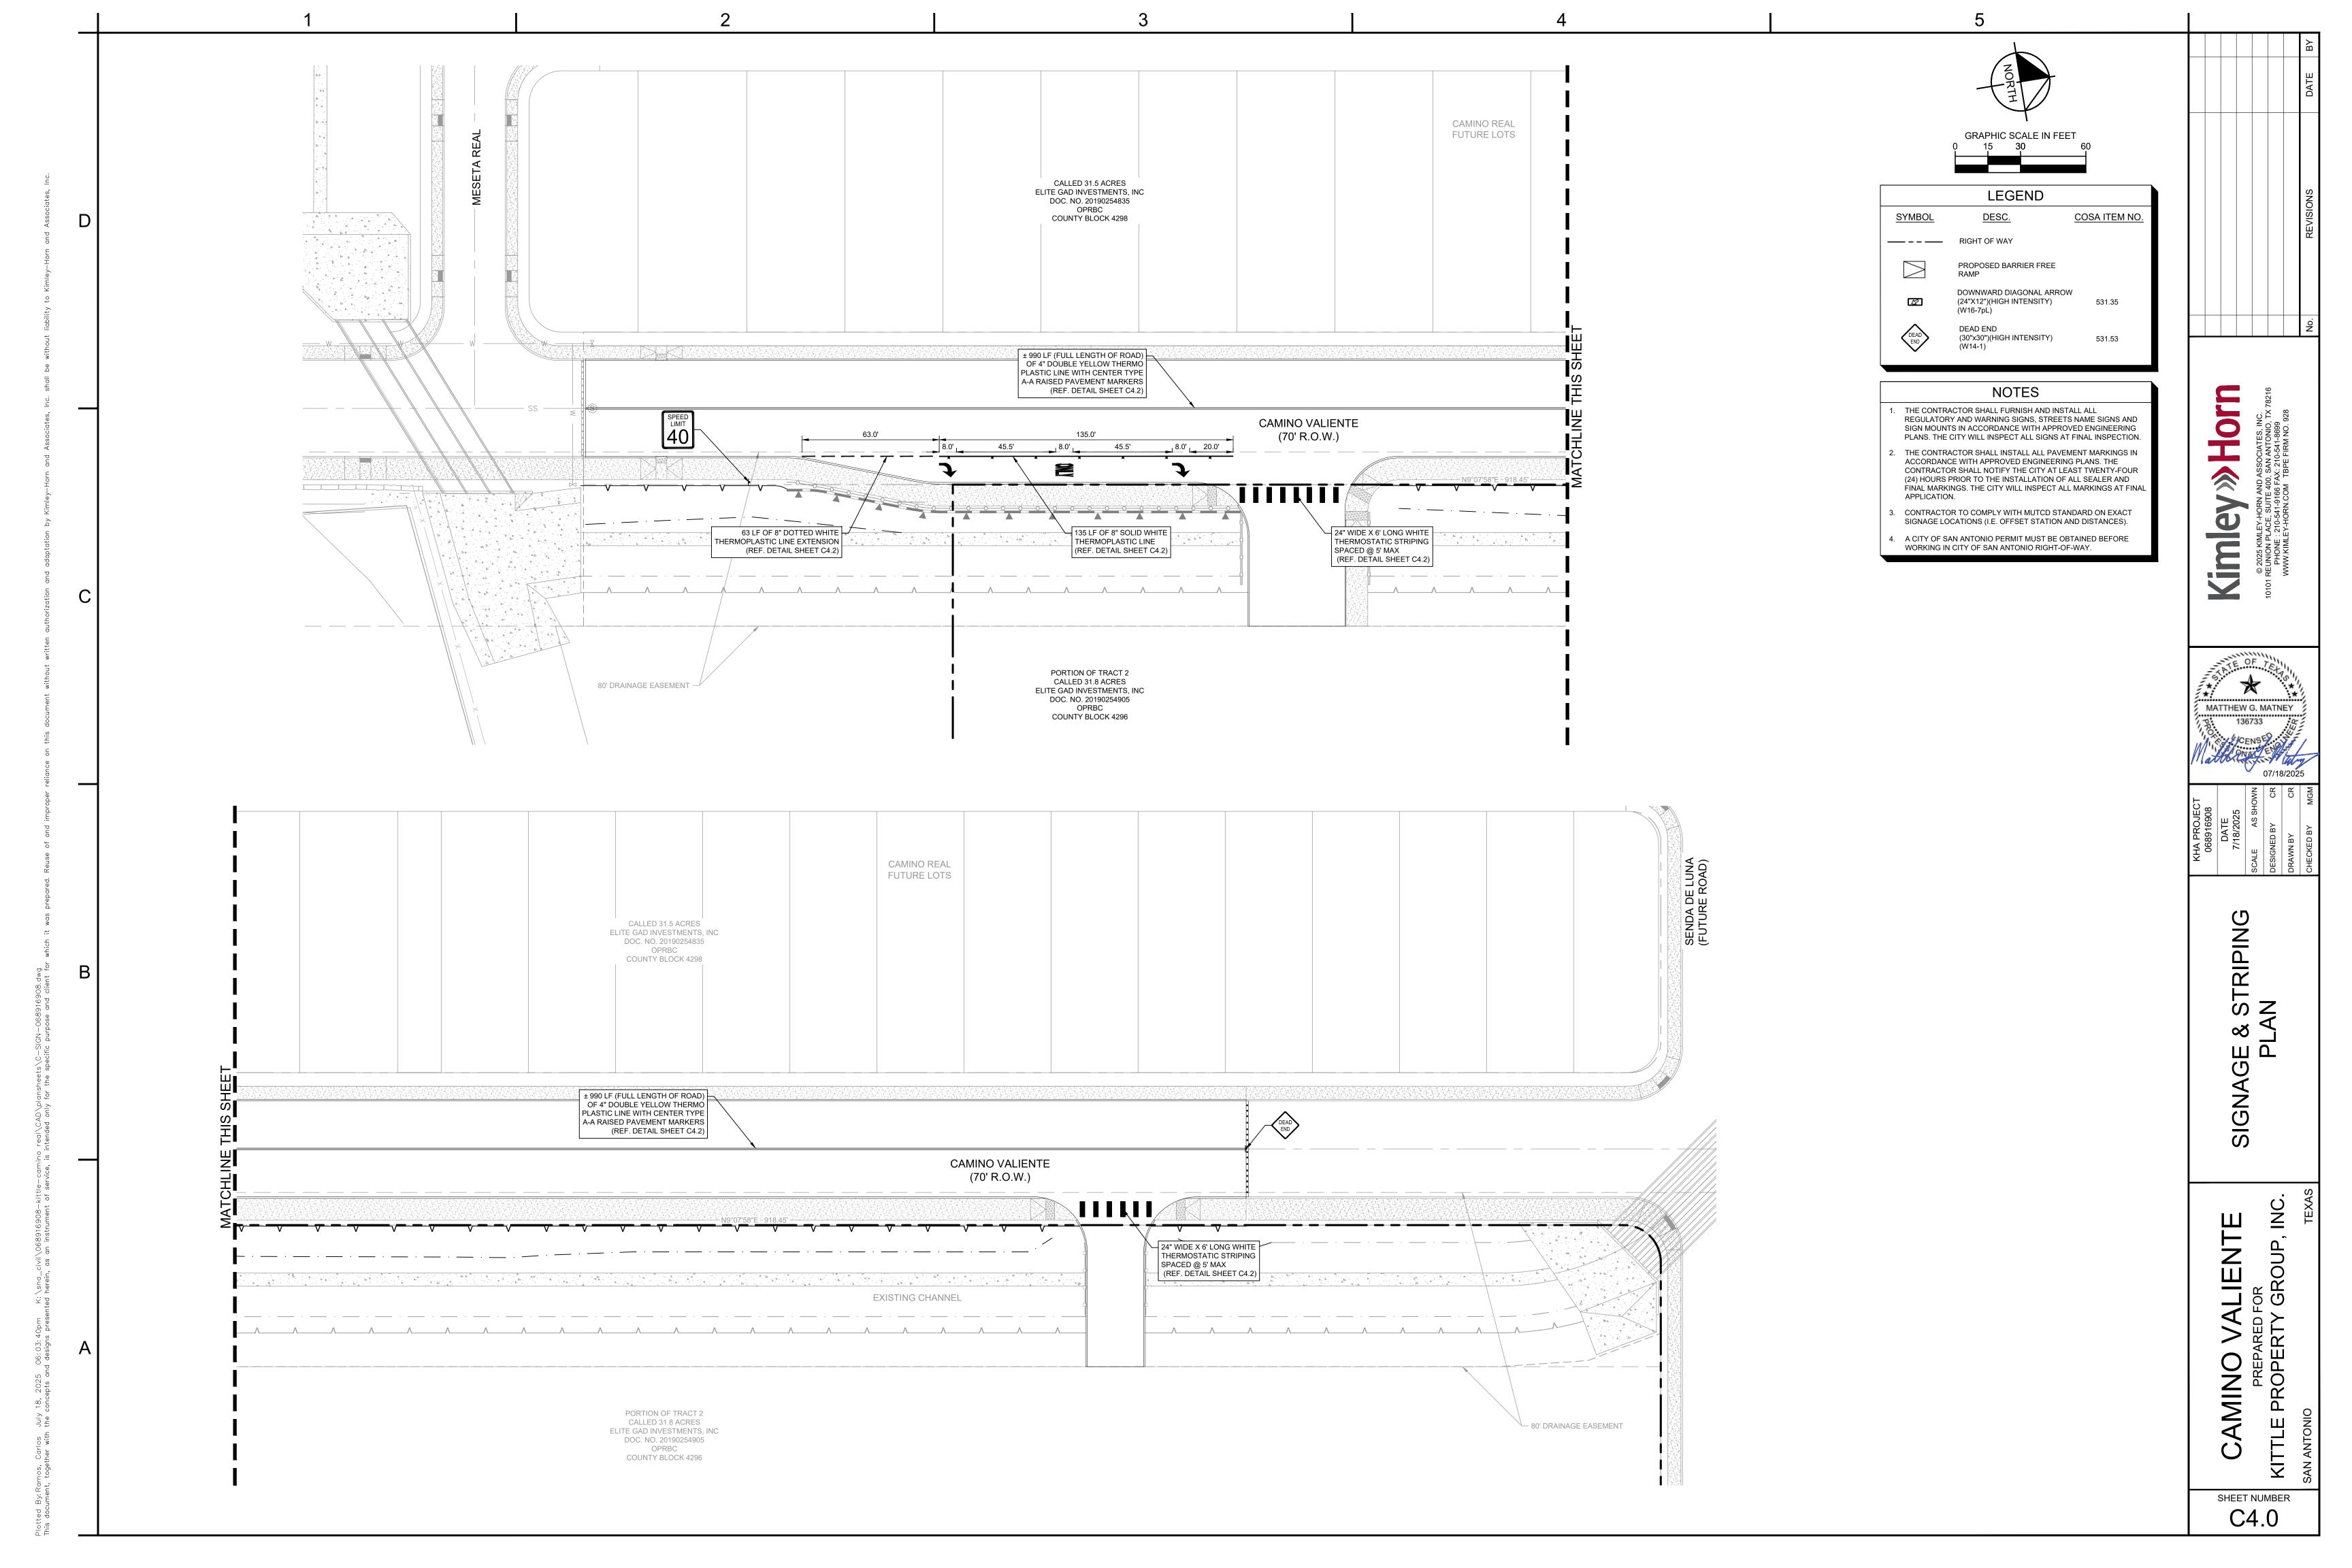


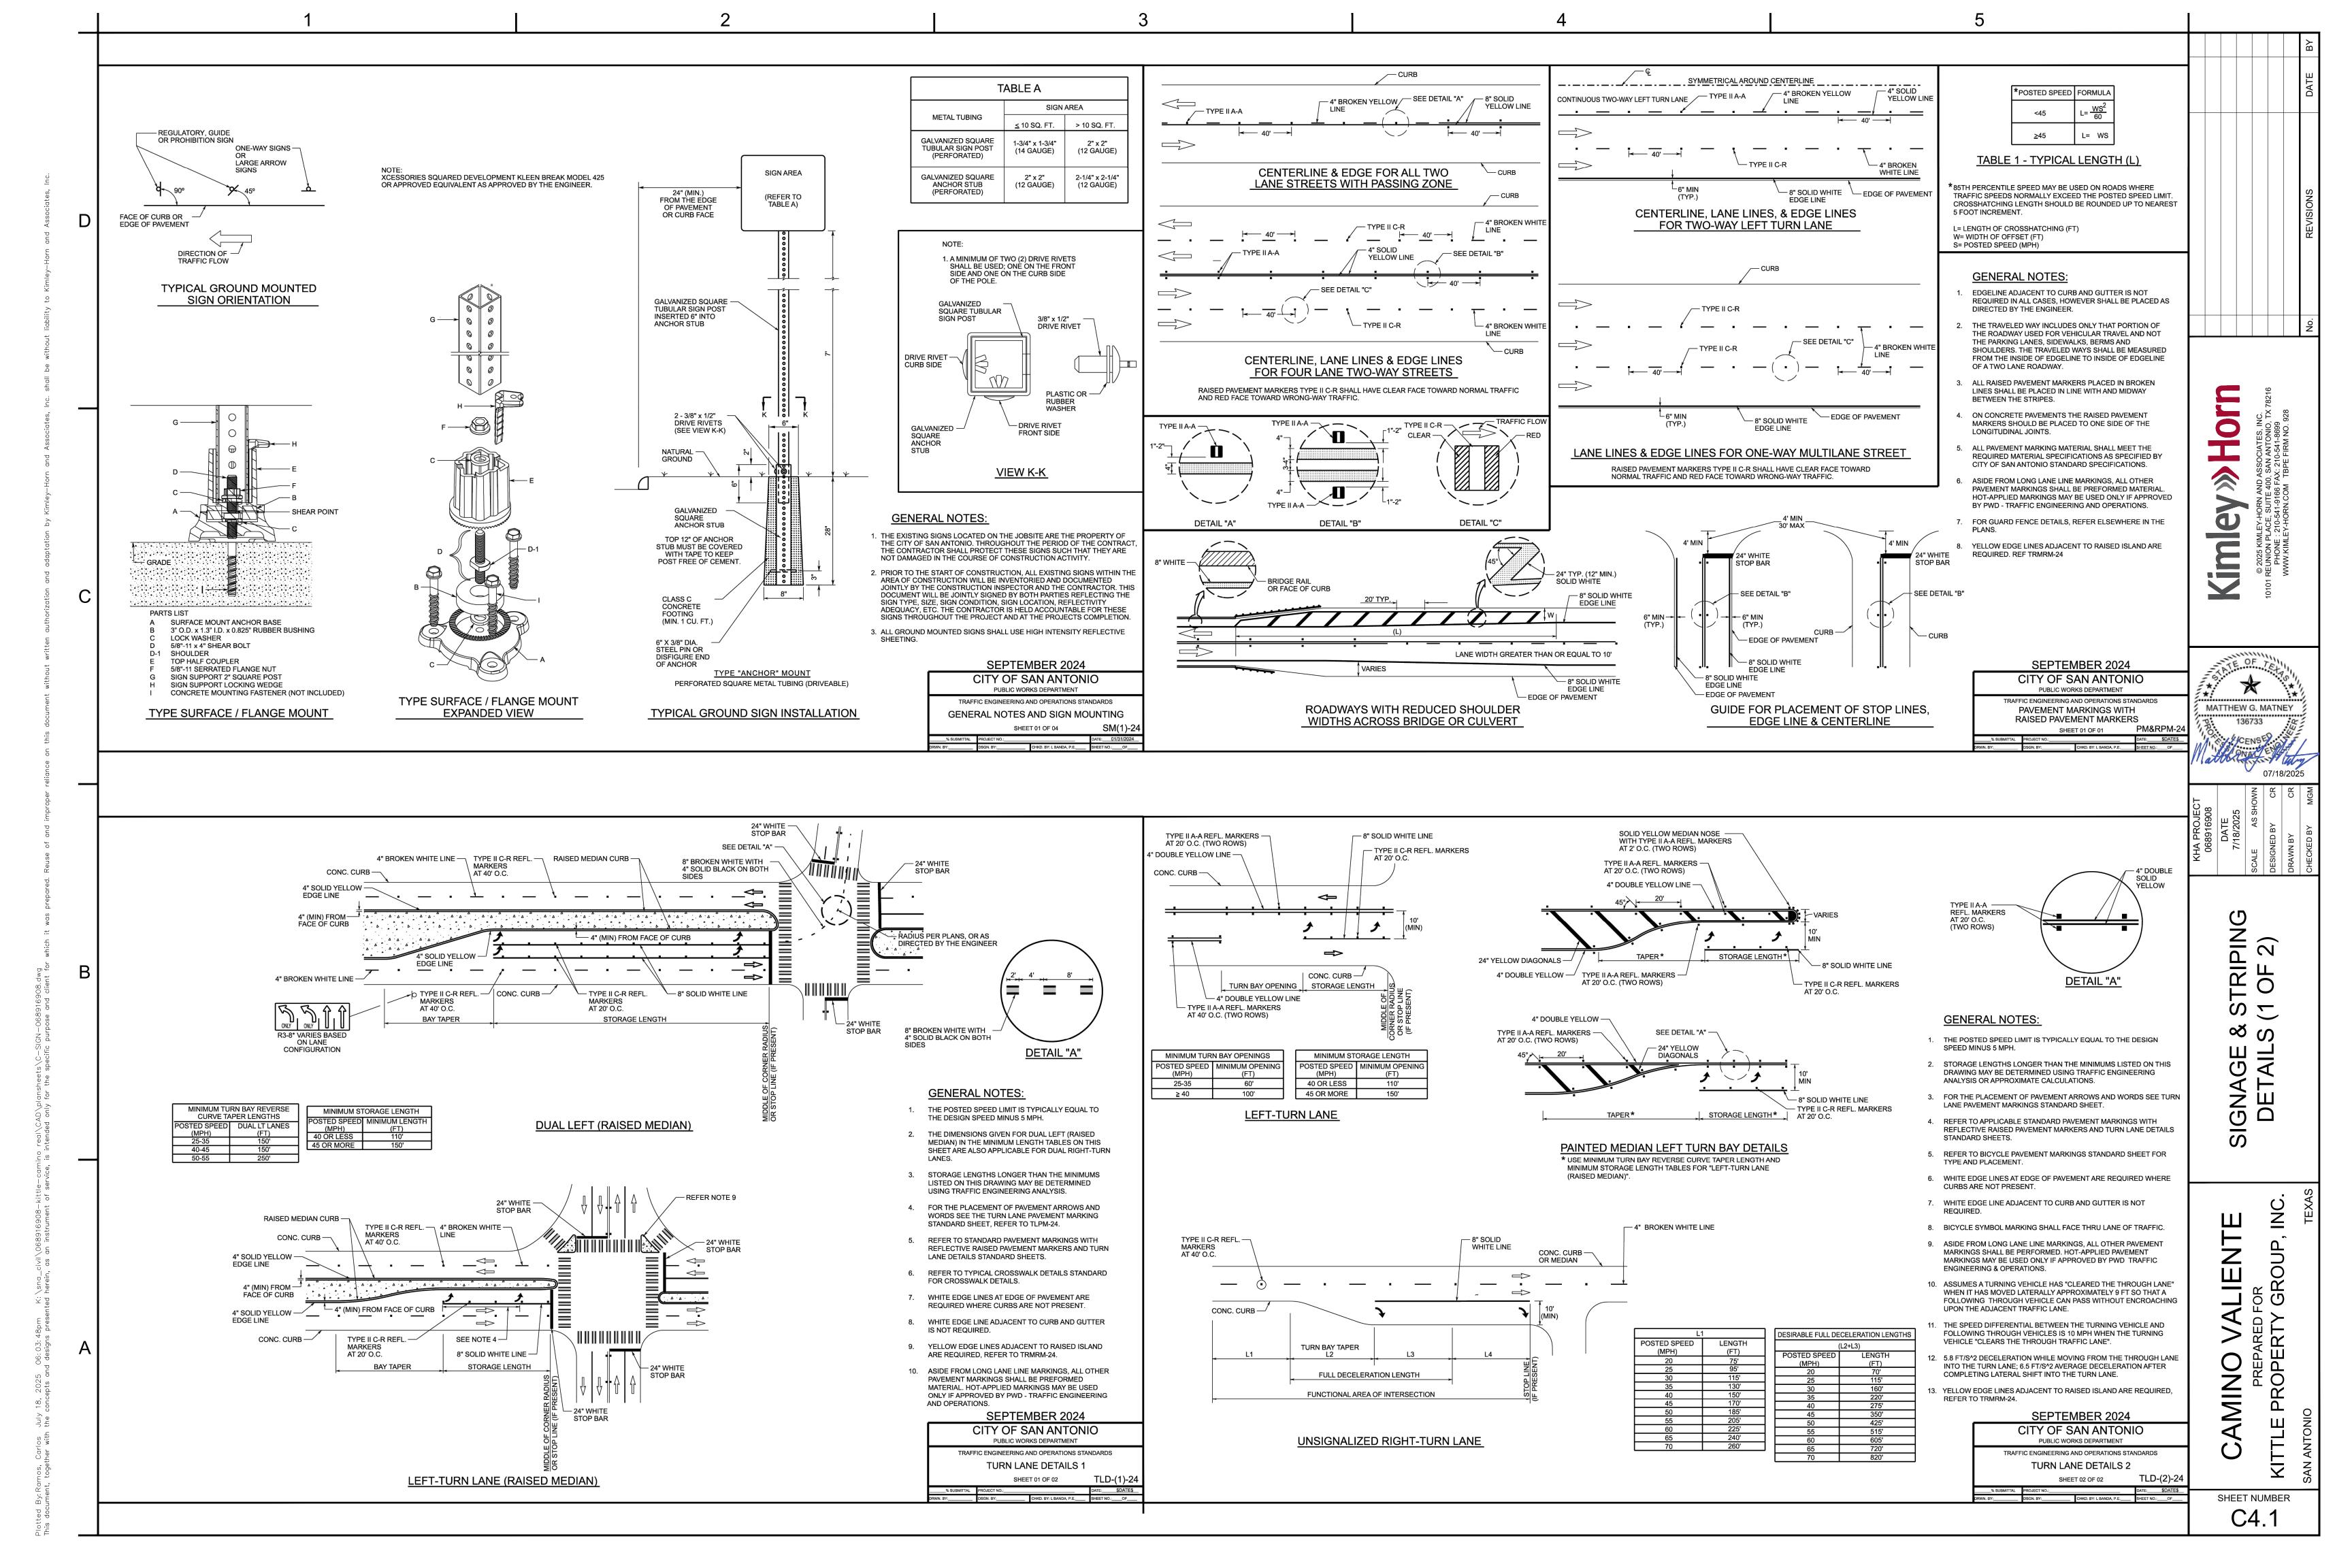

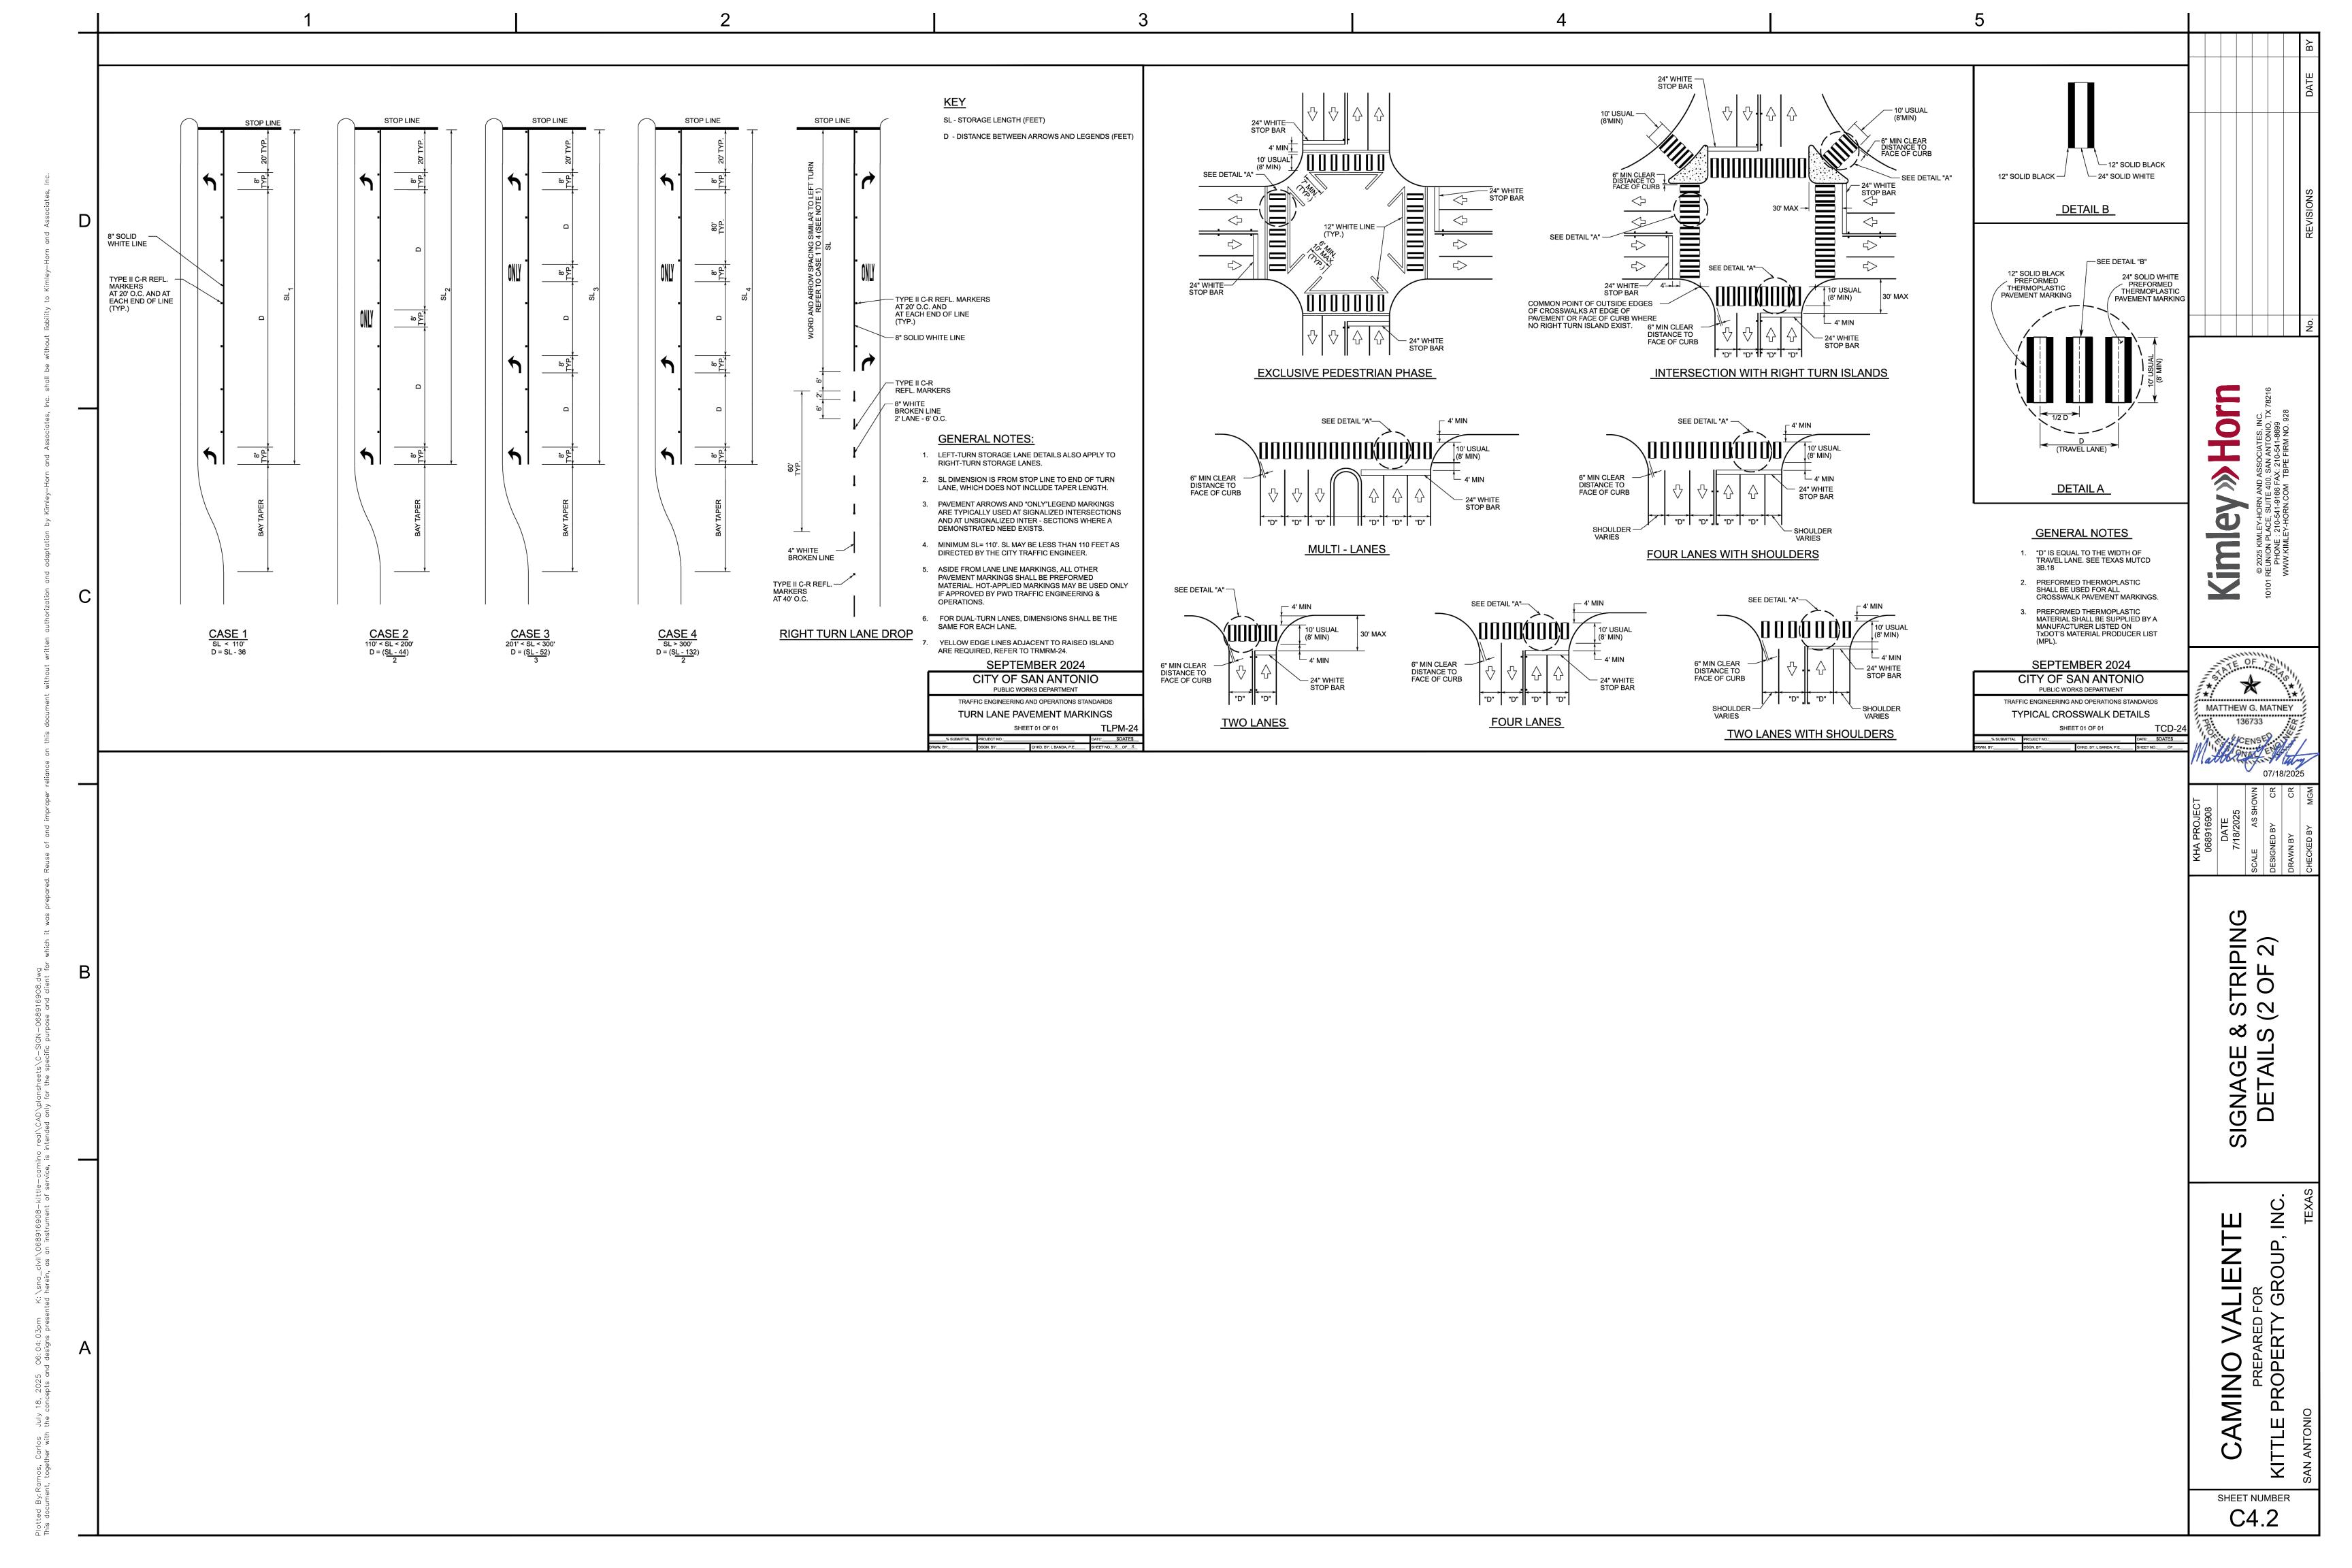


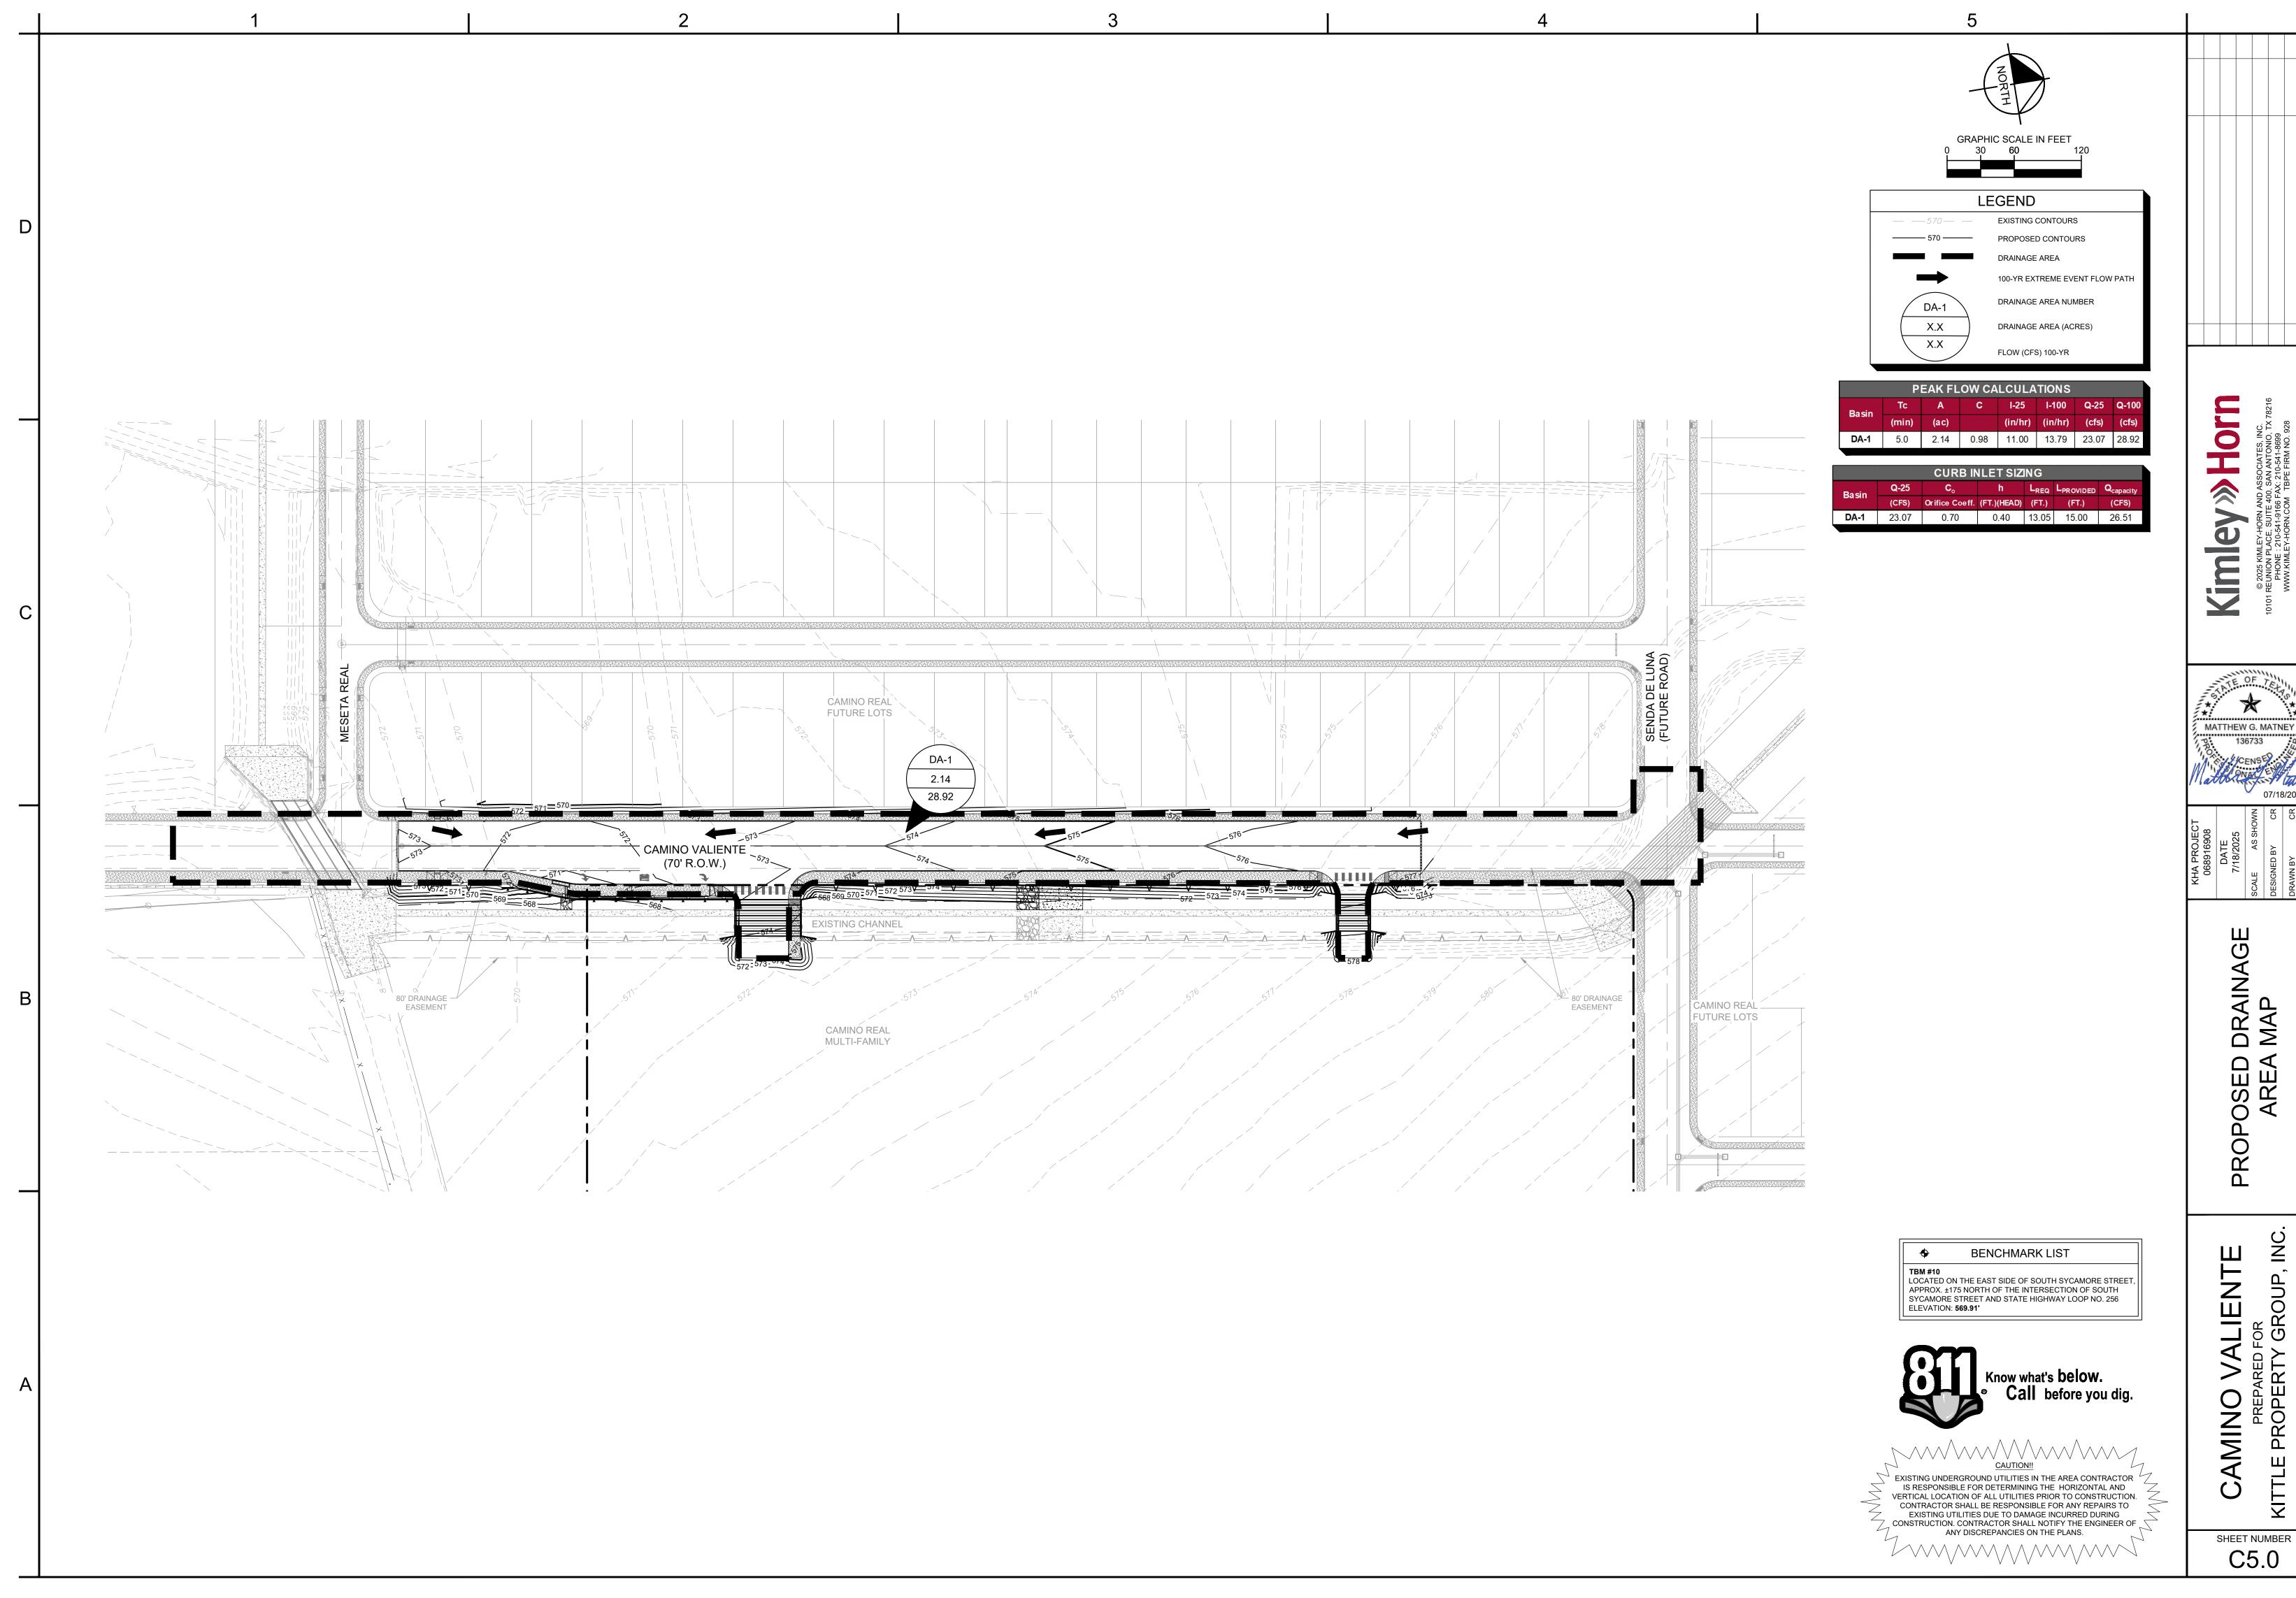

SHEET NUMBER C5.0

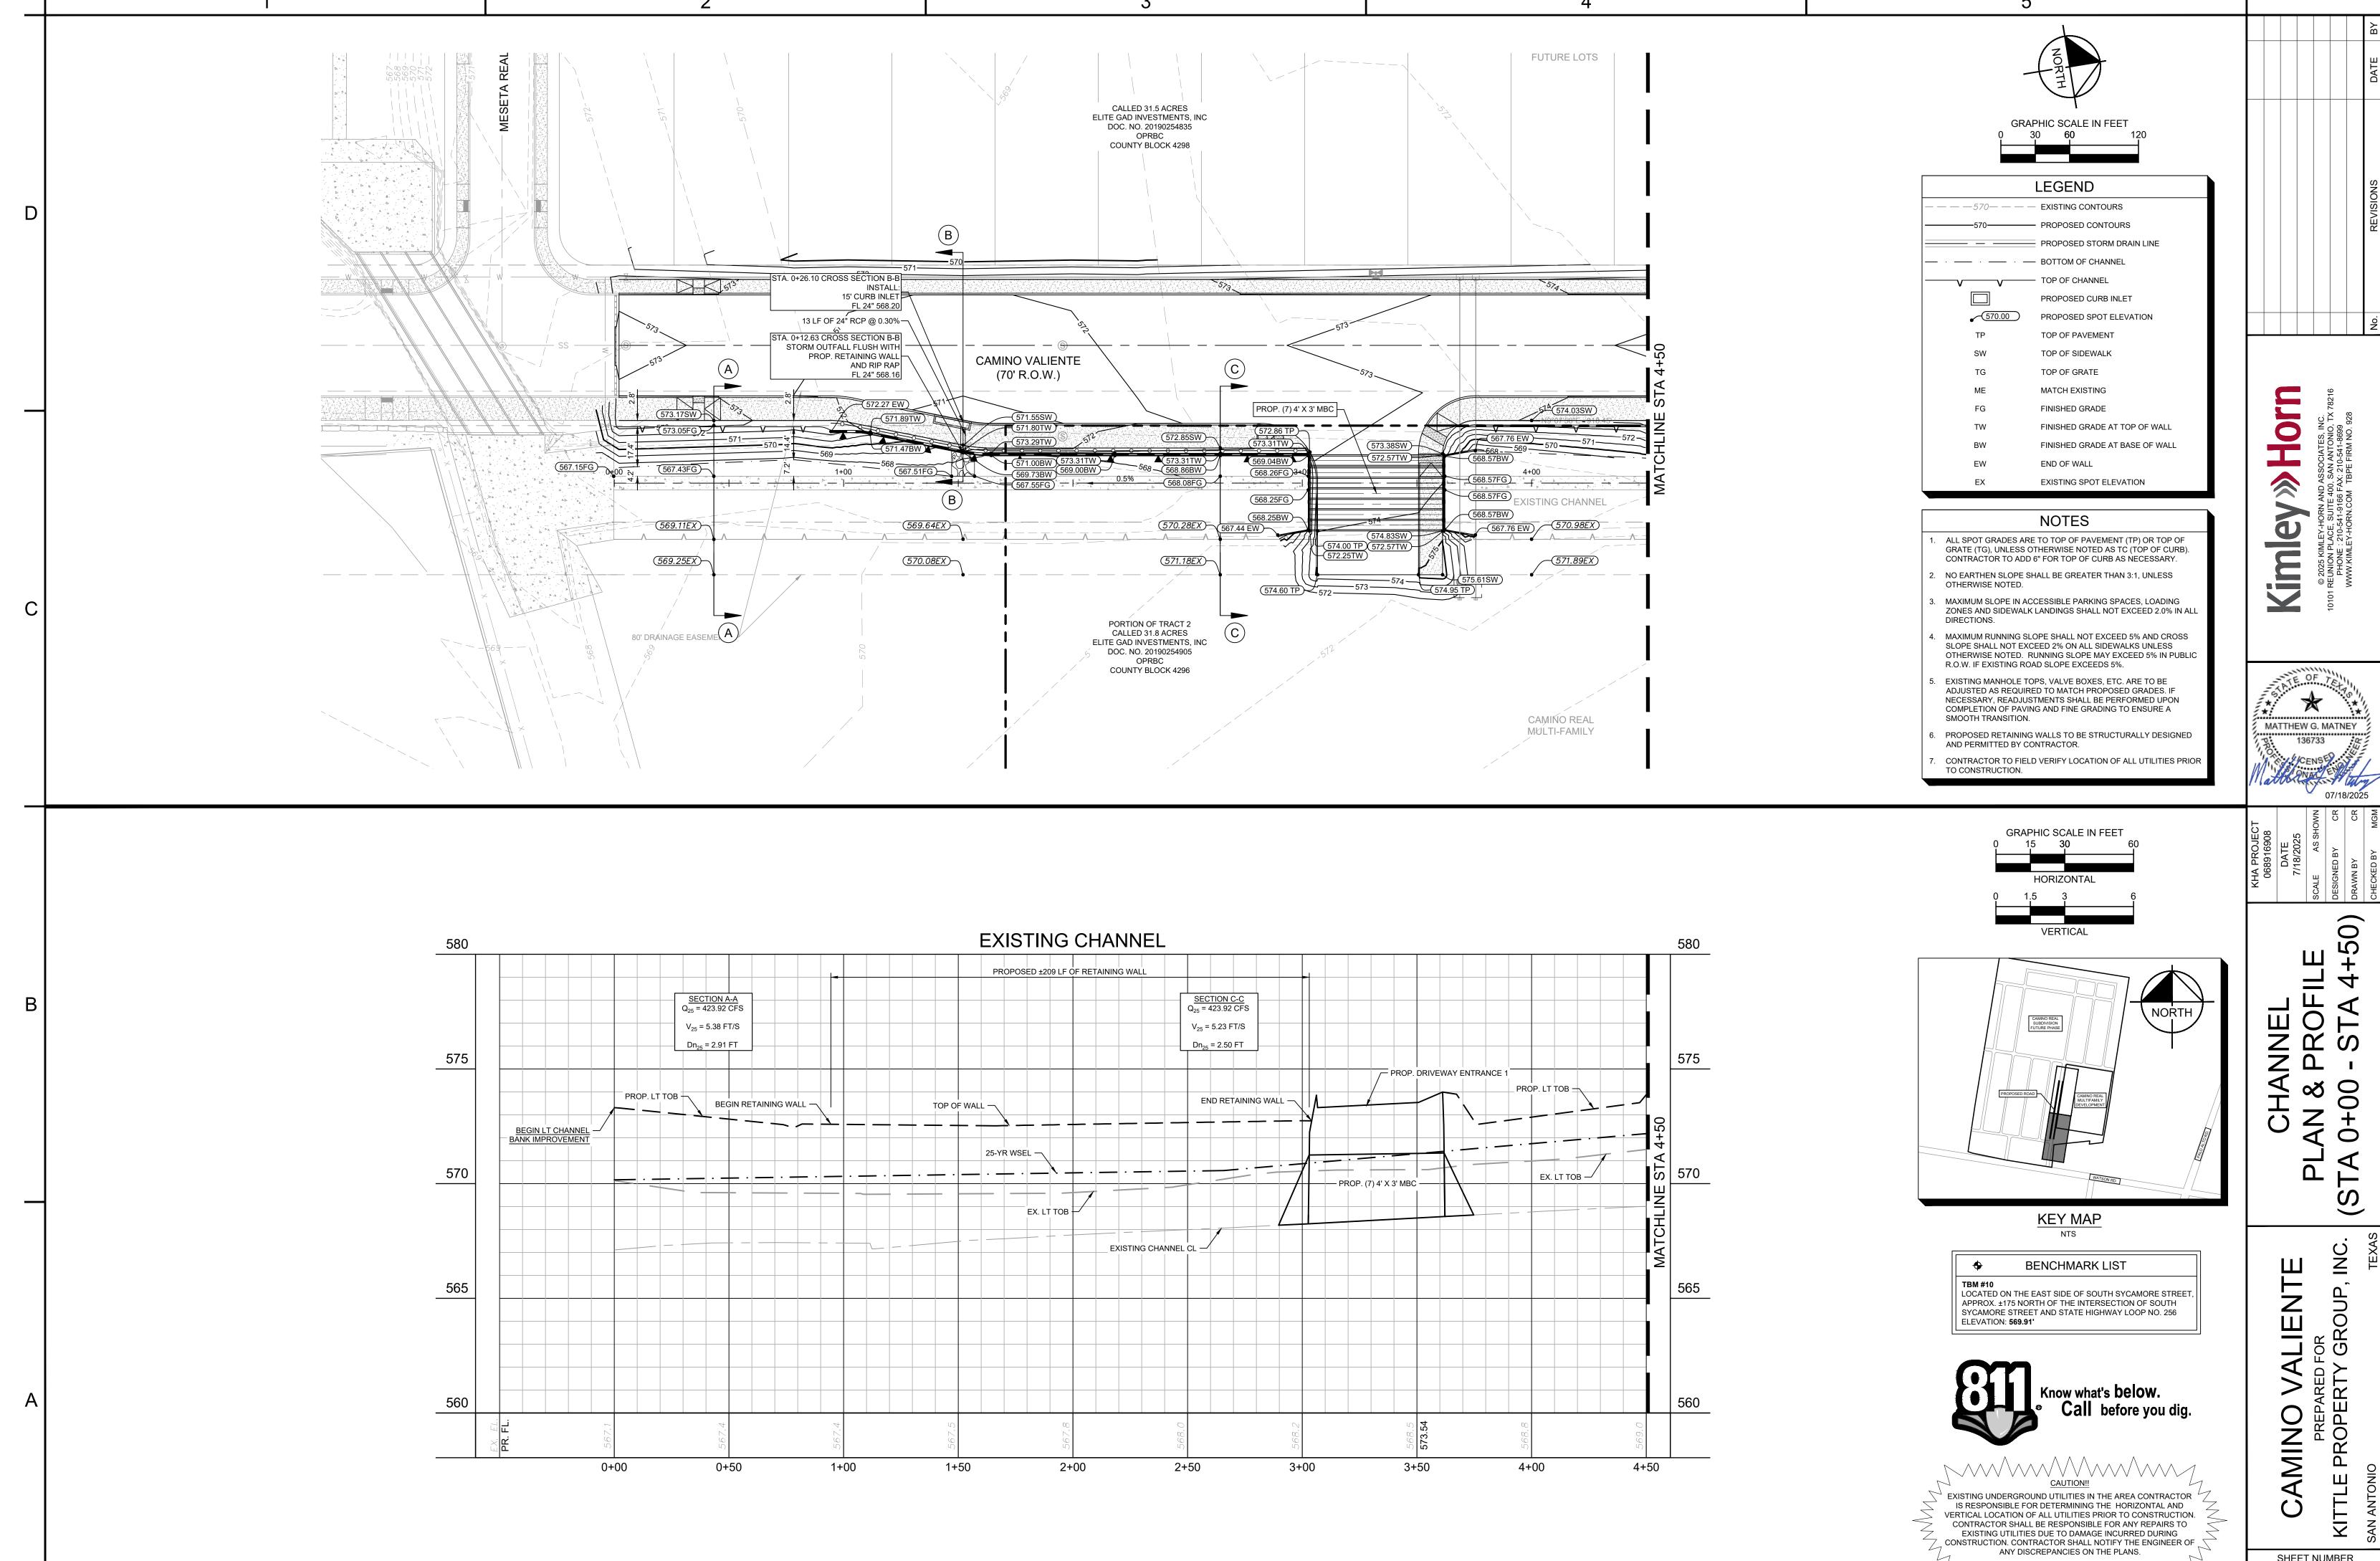

SHEET NUMBER C6.0

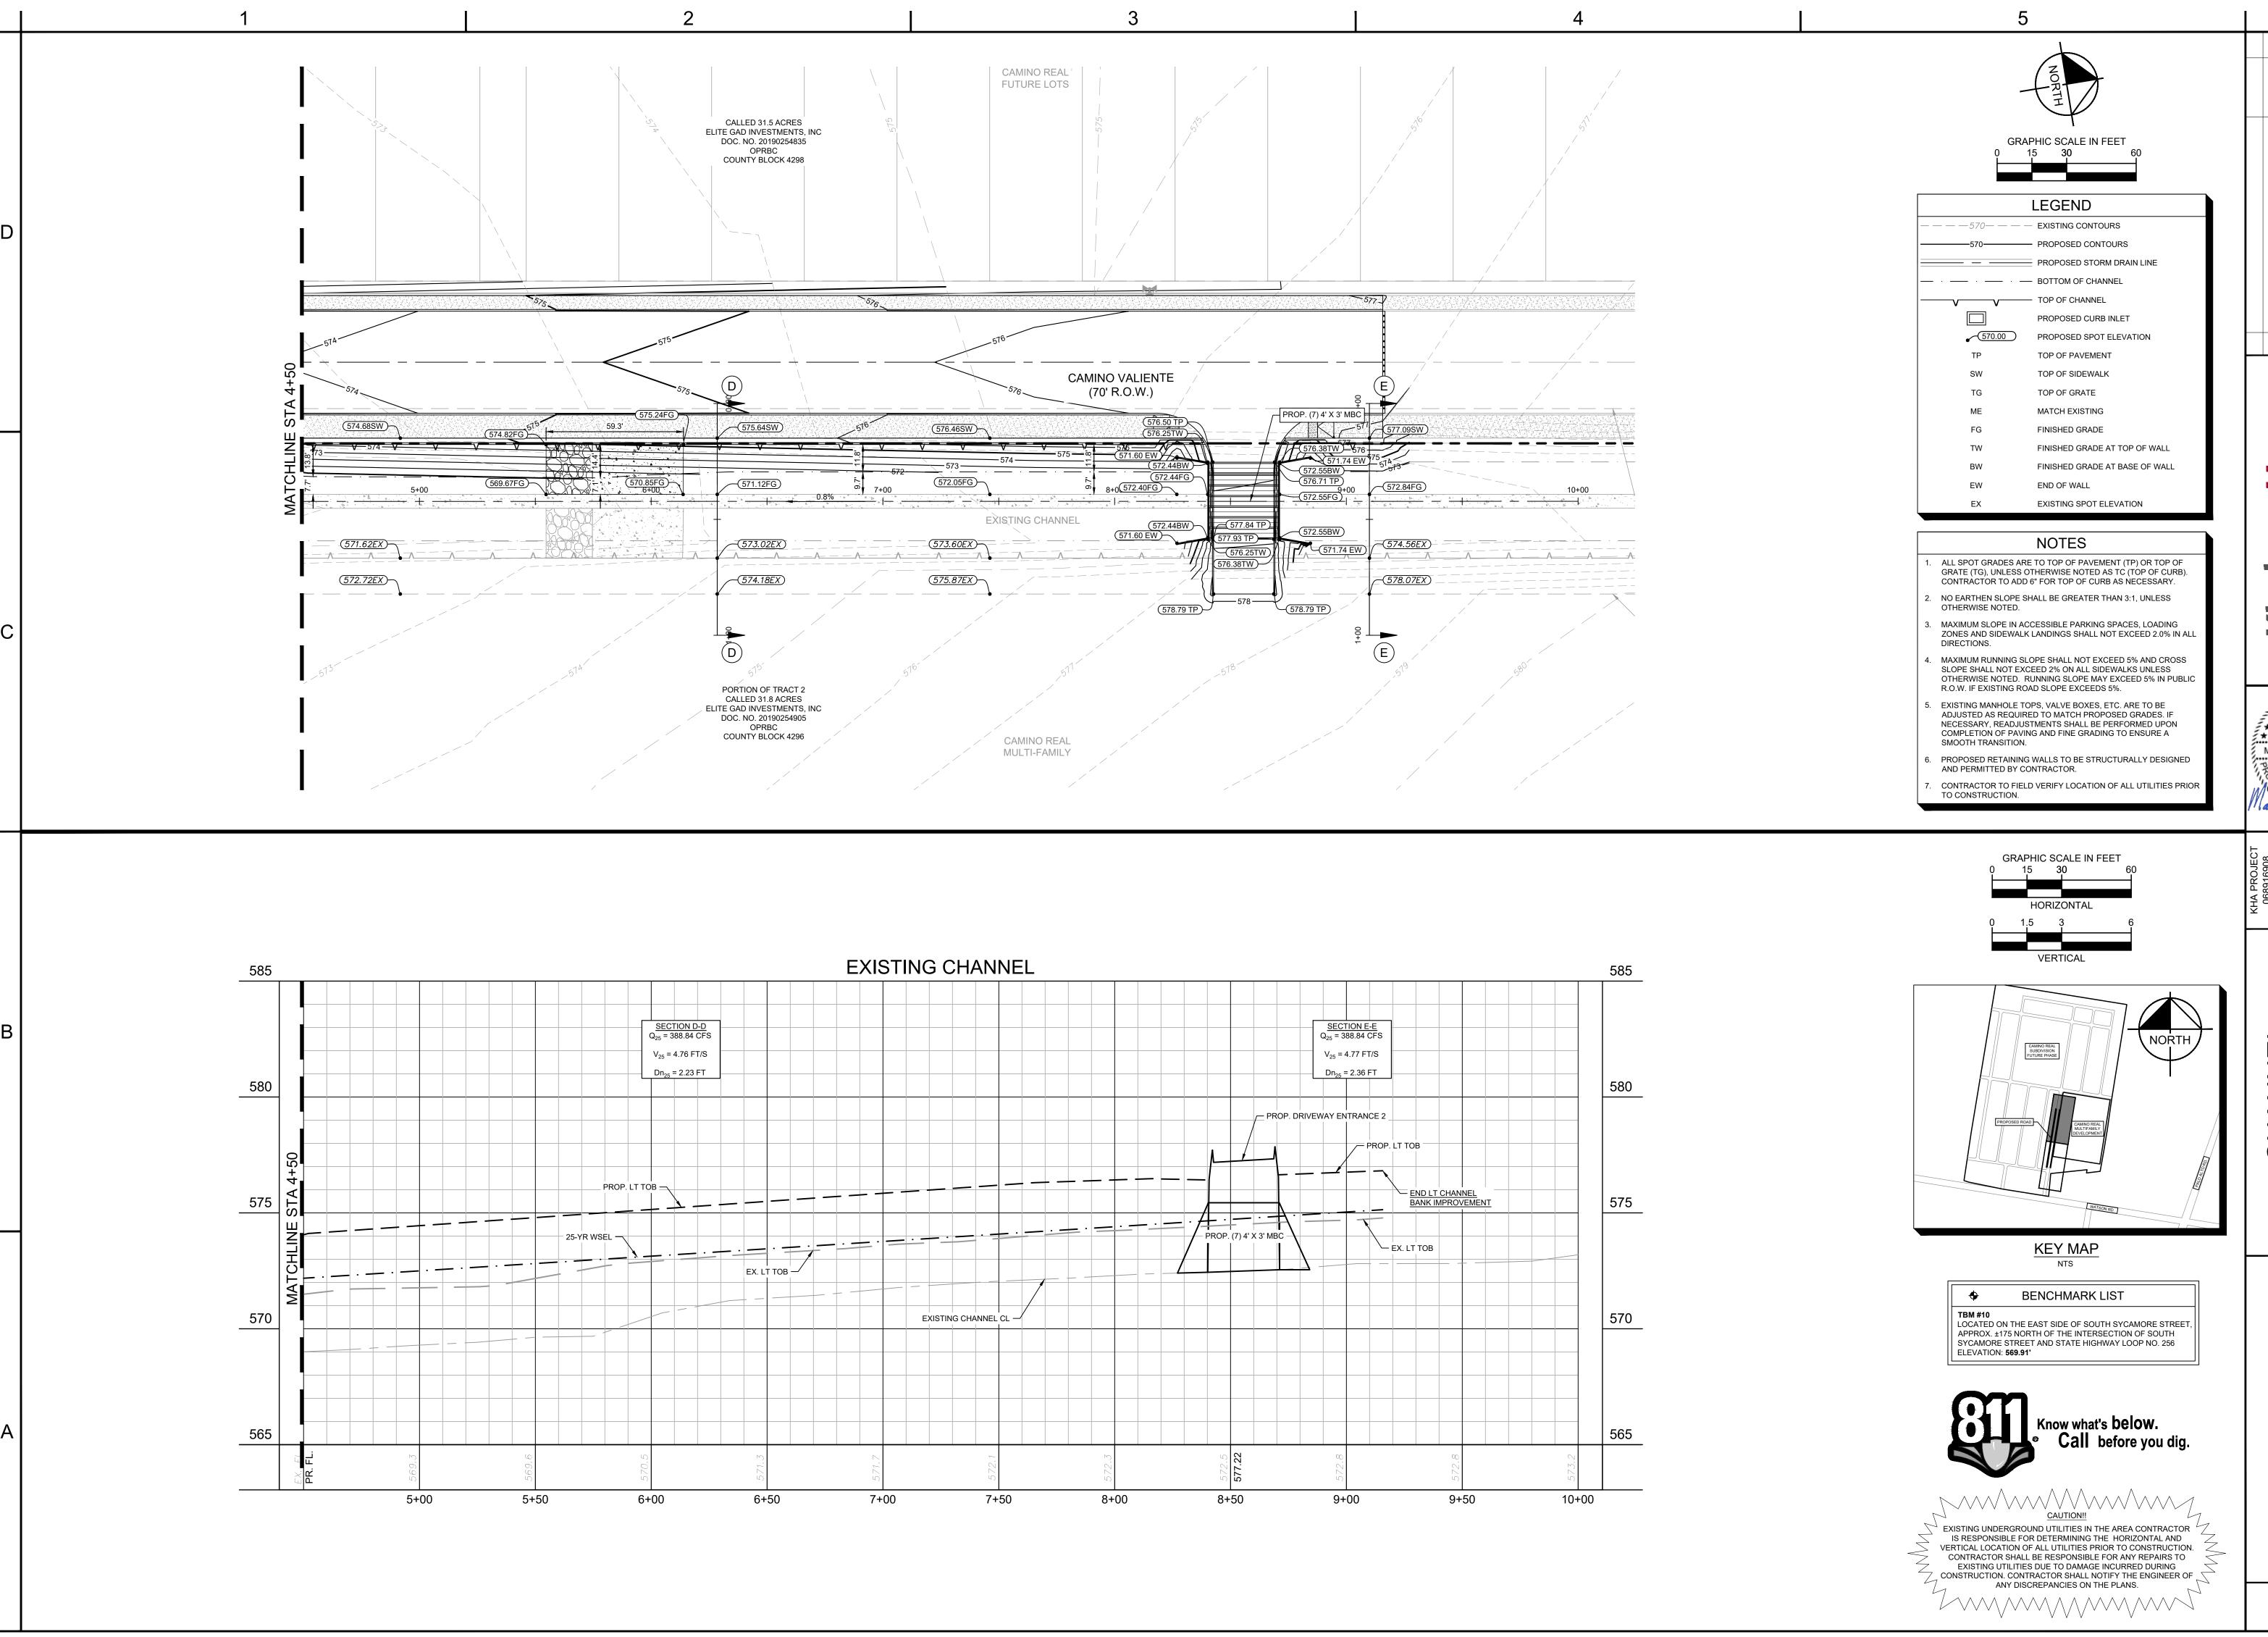

0

MATTHEW G. MATNEY


CHANNEL


MINO VALIENTE

PREPARED FOR

PROPERTY GROUP, INC. **AMINO**

SHEET NUMBER C6.1

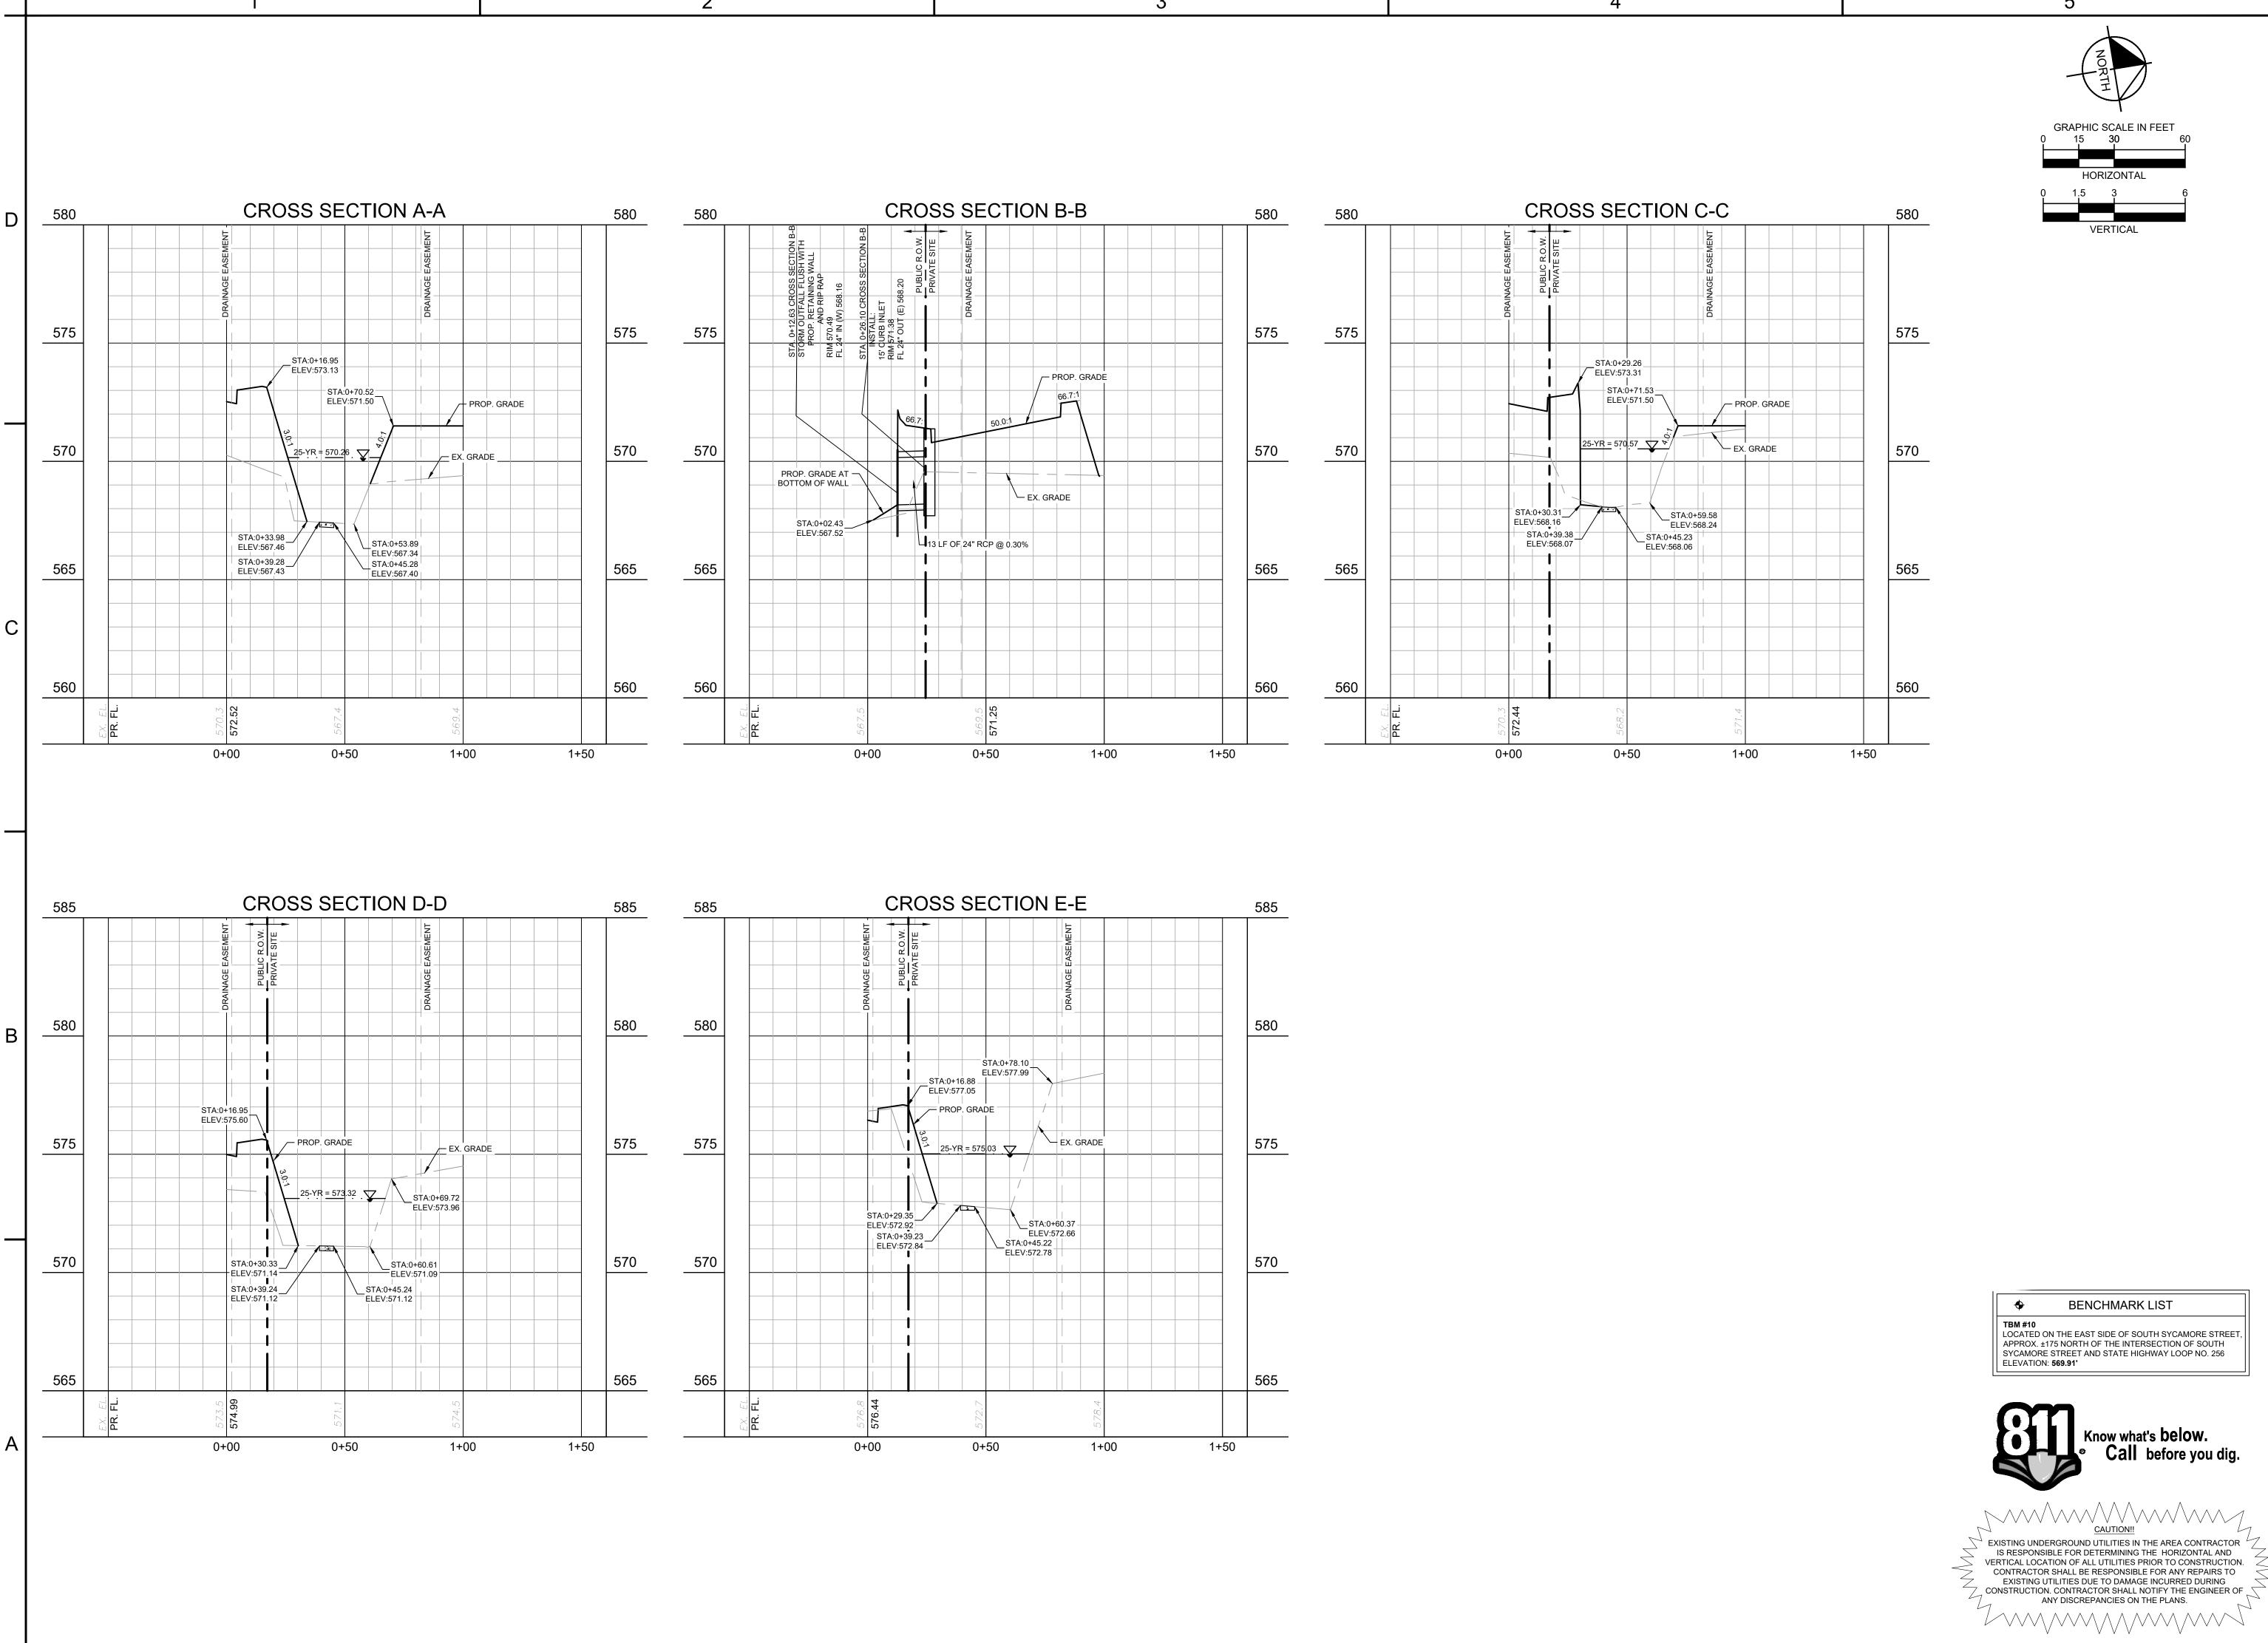

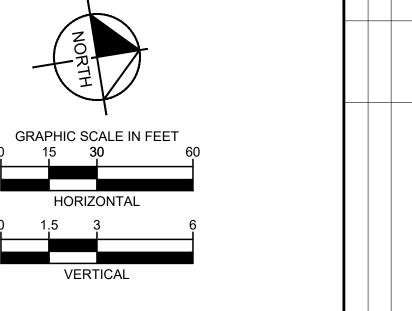

Kimley» Horn

MATTHEW G. MATNEY

AND STORM SECTIONS


CHANNEL CROSS

SAMINO VALIENTE
PREPARED FOR
TLE PROPERTY GROUP, INC.

Know what's below.
Call before you dig.

CAUTION!!

SHEET NUMBER C6.2

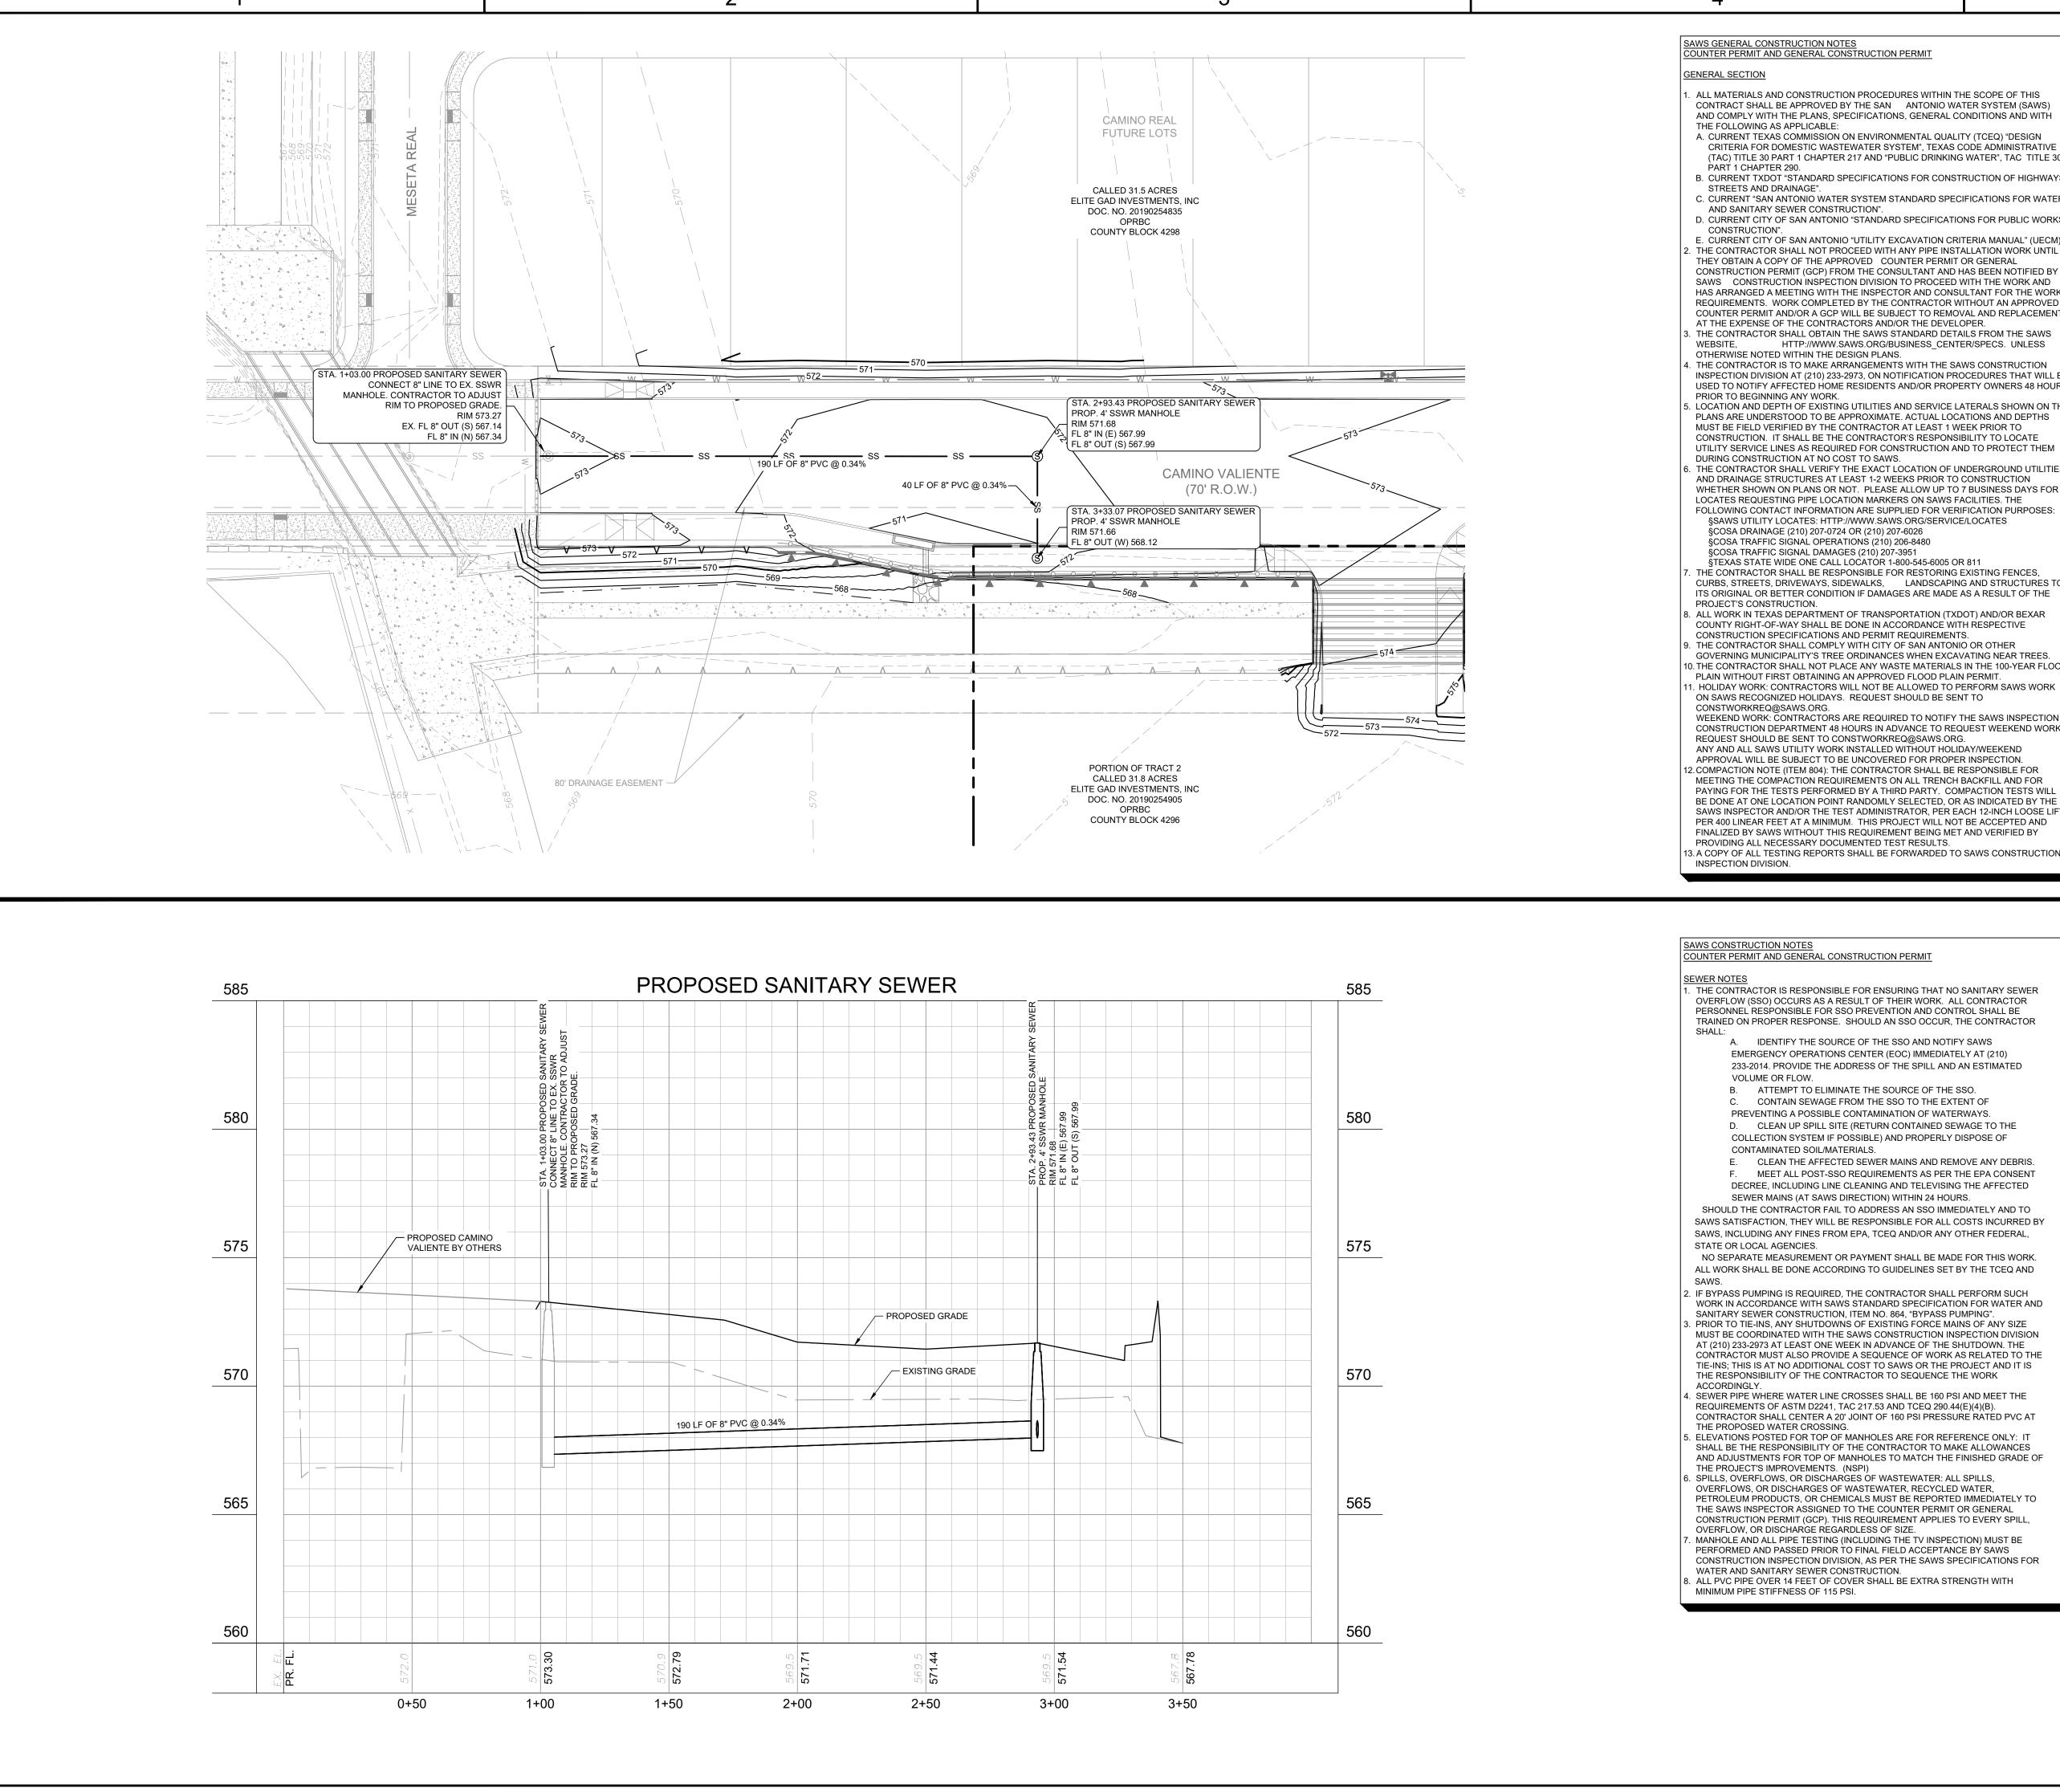

SAWS GENERAL CONSTRUCTION NOTES COUNTER PERMIT AND GENERAL CONSTRUCTION PERMIT

- ALL MATERIALS AND CONSTRUCTION PROCEDURES WITHIN THE SCOPE OF THIS CONTRACT SHALL BE APPROVED BY THE SAN ANTONIO WATER SYSTEM (SAWS) AND COMPLY WITH THE PLANS, SPECIFICATIONS, GENERAL CONDITIONS AND WITH THE FOLLOWING AS APPLICABLE:
- A. CURRENT TEXAS COMMISSION ON ENVIRONMENTAL QUALITY (TCEQ) "DESIGN CRITERIA FOR DOMESTIC WASTEWATER SYSTEM", TEXAS CODE ADMINISTRATIVE (TAC) TITLE 30 PART 1 CHAPTER 217 AND "PUBLIC DRINKING WATER", TAC TITLE 30 PART 1 CHAPTER 290.
- B. CURRENT TXDOT "STANDARD SPECIFICATIONS FOR CONSTRUCTION OF HIGHWAYS STREETS AND DRAINAGE". C. CURRENT "SAN ANTONIO WATER SYSTEM STANDARD SPECIFICATIONS FOR WATER AND SANITARY SEWER CONSTRUCTION".
- D. CURRENT CITY OF SAN ANTONIO "STANDARD SPECIFICATIONS FOR PUBLIC WORKS CONSTRUCTION". E. CURRENT CITY OF SAN ANTONIO "UTILITY EXCAVATION CRITERIA MANUAL" (UECM) THE CONTRACTOR SHALL NOT PROCEED WITH ANY PIPE INSTALLATION WORK UNTIL THEY OBTAIN A COPY OF THE APPROVED COUNTER PERMIT OR GENERAL
- HAS ARRANGED A MEETING WITH THE INSPECTOR AND CONSULTANT FOR THE WORK REQUIREMENTS. WORK COMPLETED BY THE CONTRACTOR WITHOUT AN APPROVED COUNTER PERMIT AND/OR A GCP WILL BE SUBJECT TO REMOVAL AND REPLACEMENT AT THE EXPENSE OF THE CONTRACTORS AND/OR THE DEVELOPER. . THE CONTRACTOR SHALL OBTAIN THE SAWS STANDARD DETAILS FROM THE SAWS
- OTHERWISE NOTED WITHIN THE DESIGN PLANS. THE CONTRACTOR IS TO MAKE ARRANGEMENTS WITH THE SAWS CONSTRUCTION INSPECTION DIVISION AT (210) 233-2973, ON NOTIFICATION PROCEDURES THAT WILL BE USED TO NOTIFY AFFECTED HOME RESIDENTS AND/OR PROPERTY OWNERS 48 HOUR


HTTP://WWW.SAWS.ORG/BUSINESS_CENTER/SPECS. UNLESS


- 5. LOCATION AND DEPTH OF EXISTING UTILITIES AND SERVICE LATERALS SHOWN ON TH PLANS ARE UNDERSTOOD TO BE APPROXIMATE. ACTUAL LOCATIONS AND DEPTHS MUST BE FIELD VERIFIED BY THE CONTRACTOR AT LEAST 1 WEEK PRIOR TO CONSTRUCTION. IT SHALL BE THE CONTRACTOR'S RESPONSIBILITY TO LOCATE UTILITY SERVICE LINES AS REQUIRED FOR CONSTRUCTION AND TO PROTECT THEM
- DURING CONSTRUCTION AT NO COST TO SAWS. THE CONTRACTOR SHALL VERIFY THE EXACT LOCATION OF UNDERGROUND UTILITIE AND DRAINAGE STRUCTURES AT LEAST 1-2 WEEKS PRIOR TO CONSTRUCTION WHETHER SHOWN ON PLANS OR NOT. PLEASE ALLOW UP TO 7 BUSINESS DAYS FOR LOCATES REQUESTING PIPE LOCATION MARKERS ON SAWS FACILITIES. THE FOLLOWING CONTACT INFORMATION ARE SUPPLIED FOR VERIFICATION PURPOSES: §SAWS UTILITY LOCATES: HTTP://WWW.SAWS.ORG/SERVICE/LOCATES
- §COSA DRAINAGE (210) 207-0724 OR (210) 207-6026 §COSA TRAFFIC SIGNAL OPERATIONS (210) 206-8480 §COSA TRAFFIC SIGNAL DAMAGES (210) 207-3951
- §TEXAS STATE WIDE ONE CALL LOCATOR 1-800-545-6005 OR 811 THE CONTRACTOR SHALL BE RESPONSIBLE FOR RESTORING EXISTING FENCES, CURBS, STREETS, DRIVEWAYS, SIDEWALKS, LANDSCAPING AND STRUCTURES TO ITS ORIGINAL OR BETTER CONDITION IF DAMAGES ARE MADE AS A RESULT OF THE
- 3. ALL WORK IN TEXAS DEPARTMENT OF TRANSPORTATION (TXDOT) AND/OR BEXAR COUNTY RIGHT-OF-WAY SHALL BE DONE IN ACCORDANCE WITH RESPECTIVE CONSTRUCTION SPECIFICATIONS AND PERMIT REQUIREMENTS.
- THE CONTRACTOR SHALL COMPLY WITH CITY OF SAN ANTONIO OR OTHER GOVERNING MUNICIPALITY'S TREE ORDINANCES WHEN EXCAVATING NEAR TREES. 0. THE CONTRACTOR SHALL NOT PLACE ANY WASTE MATERIALS IN THE 100-YEAR FLOOI
- PLAIN WITHOUT FIRST OBTAINING AN APPROVED FLOOD PLAIN PERMIT 1. HOLIDAY WORK: CONTRACTORS WILL NOT BE ALLOWED TO PERFORM SAWS WORK ON SAWS RECOGNIZED HOLIDAYS. REQUEST SHOULD BE SENT TO CONSTWORKREQ@SAWS.ORG.
- WEEKEND WORK: CONTRACTORS ARE REQUIRED TO NOTIFY THE SAWS INSPECTION CONSTRUCTION DEPARTMENT 48 HOURS IN ADVANCE TO REQUEST WEEKEND WORK. REQUEST SHOULD BE SENT TO CONSTWORKREQ@SAWS.ORG. ANY AND ALL SAWS UTILITY WORK INSTALLED WITHOUT HOLIDAY/WEEKEND
- APPROVAL WILL BE SUBJECT TO BE UNCOVERED FOR PROPER INSPECTION. 2. COMPACTION NOTE (ITEM 804): THE CONTRACTOR SHALL BE RESPONSIBLE FOR MEETING THE COMPACTION REQUIREMENTS ON ALL TRENCH BACKFILL AND FOR PAYING FOR THE TESTS PERFORMED BY A THIRD PARTY. COMPACTION TESTS WILL BE DONE AT ONE LOCATION POINT RANDOMLY SELECTED, OR AS INDICATED BY THE SAWS INSPECTOR AND/OR THE TEST ADMINISTRATOR, PER EACH 12-INCH LOOSE LIF PER 400 LINEAR FEET AT A MINIMUM. THIS PROJECT WILL NOT BE ACCEPTED AND
- PROVIDING ALL NECESSARY DOCUMENTED TEST RESULTS. 13. A COPY OF ALL TESTING REPORTS SHALL BE FORWARDED TO SAWS CONSTRUCTION


IDENTIFY THE SOURCE OF THE SSO AND NOTIFY SAWS

CONTAIN SEWAGE FROM THE SSO TO THE EXTENT OF

MEET ALL POST-SSO REQUIREMENTS AS PER THE EPA CONSENT

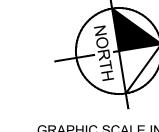

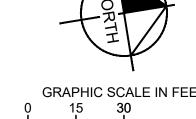

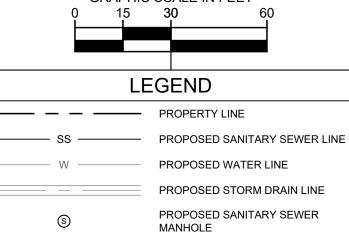


PROPOSED CURB INLET

PROPOSED FIRE HYDRANT

NOTES

- REFER TO SAWS DESIGN GUIDELINES AND STANDARD CONSTRUCTION DETAILS FOR ALL UTILITY STANDARDS.
- CONTRACTOR TO FIELD VERIFY LOCATION OF ALL UTILITIES PRIOR TO CONSTRUCTION. CONTACT ENGINEER IF FIELD CONDITIONS VARY.
- CONTRACTOR SHALL REFER AND ADHERE TO ALL TCEQ DESIGN GUIDELINES (CHAPTER 217 AND 290) FOR ALL UTILITY CROSSING REQUIREMENTS.

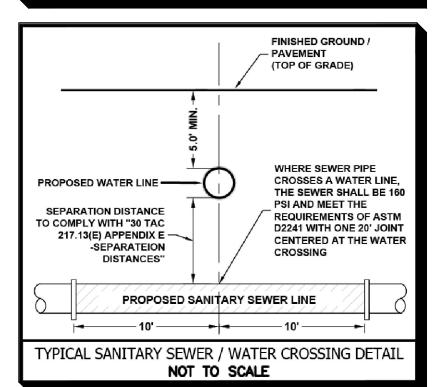

GRAPHIC SCALE IN FEET

0

区



JENTE.

PREPARED FOR PROPERTY (AMIN

SHEET NUMBER

C7.0

ANY DISCREPANCIES ON THE PLANS.


VICINITY MAP SCALE: NTS

BENCHMARK LIST

LOCATED ON THE EAST SIDE OF SOUTH SYCAMORE STREET APPROX. ±175 NORTH OF THE INTERSECTION OF SOUTH SYCAMORE STREET AND STATE HIGHWAY LOOP NO. 256 ELEVATION: **569.91'**



EXISTING UNDERGROUND UTILITIES IN THE AREA CONTRACTOR IS RESPONSIBLE FOR DETERMINING THE HORIZONTAL AND VERTICAL LOCATION OF ALL UTILITIES PRIOR TO CONSTRUCTION. CONTRACTOR SHALL BE RESPONSIBLE FOR ANY REPAIRS TO EXISTING UTILITIES DUE TO DAMAGE INCURRED DURING CONSTRUCTION. CONTRACTOR SHALL NOTIFY THE ENGINEER OF

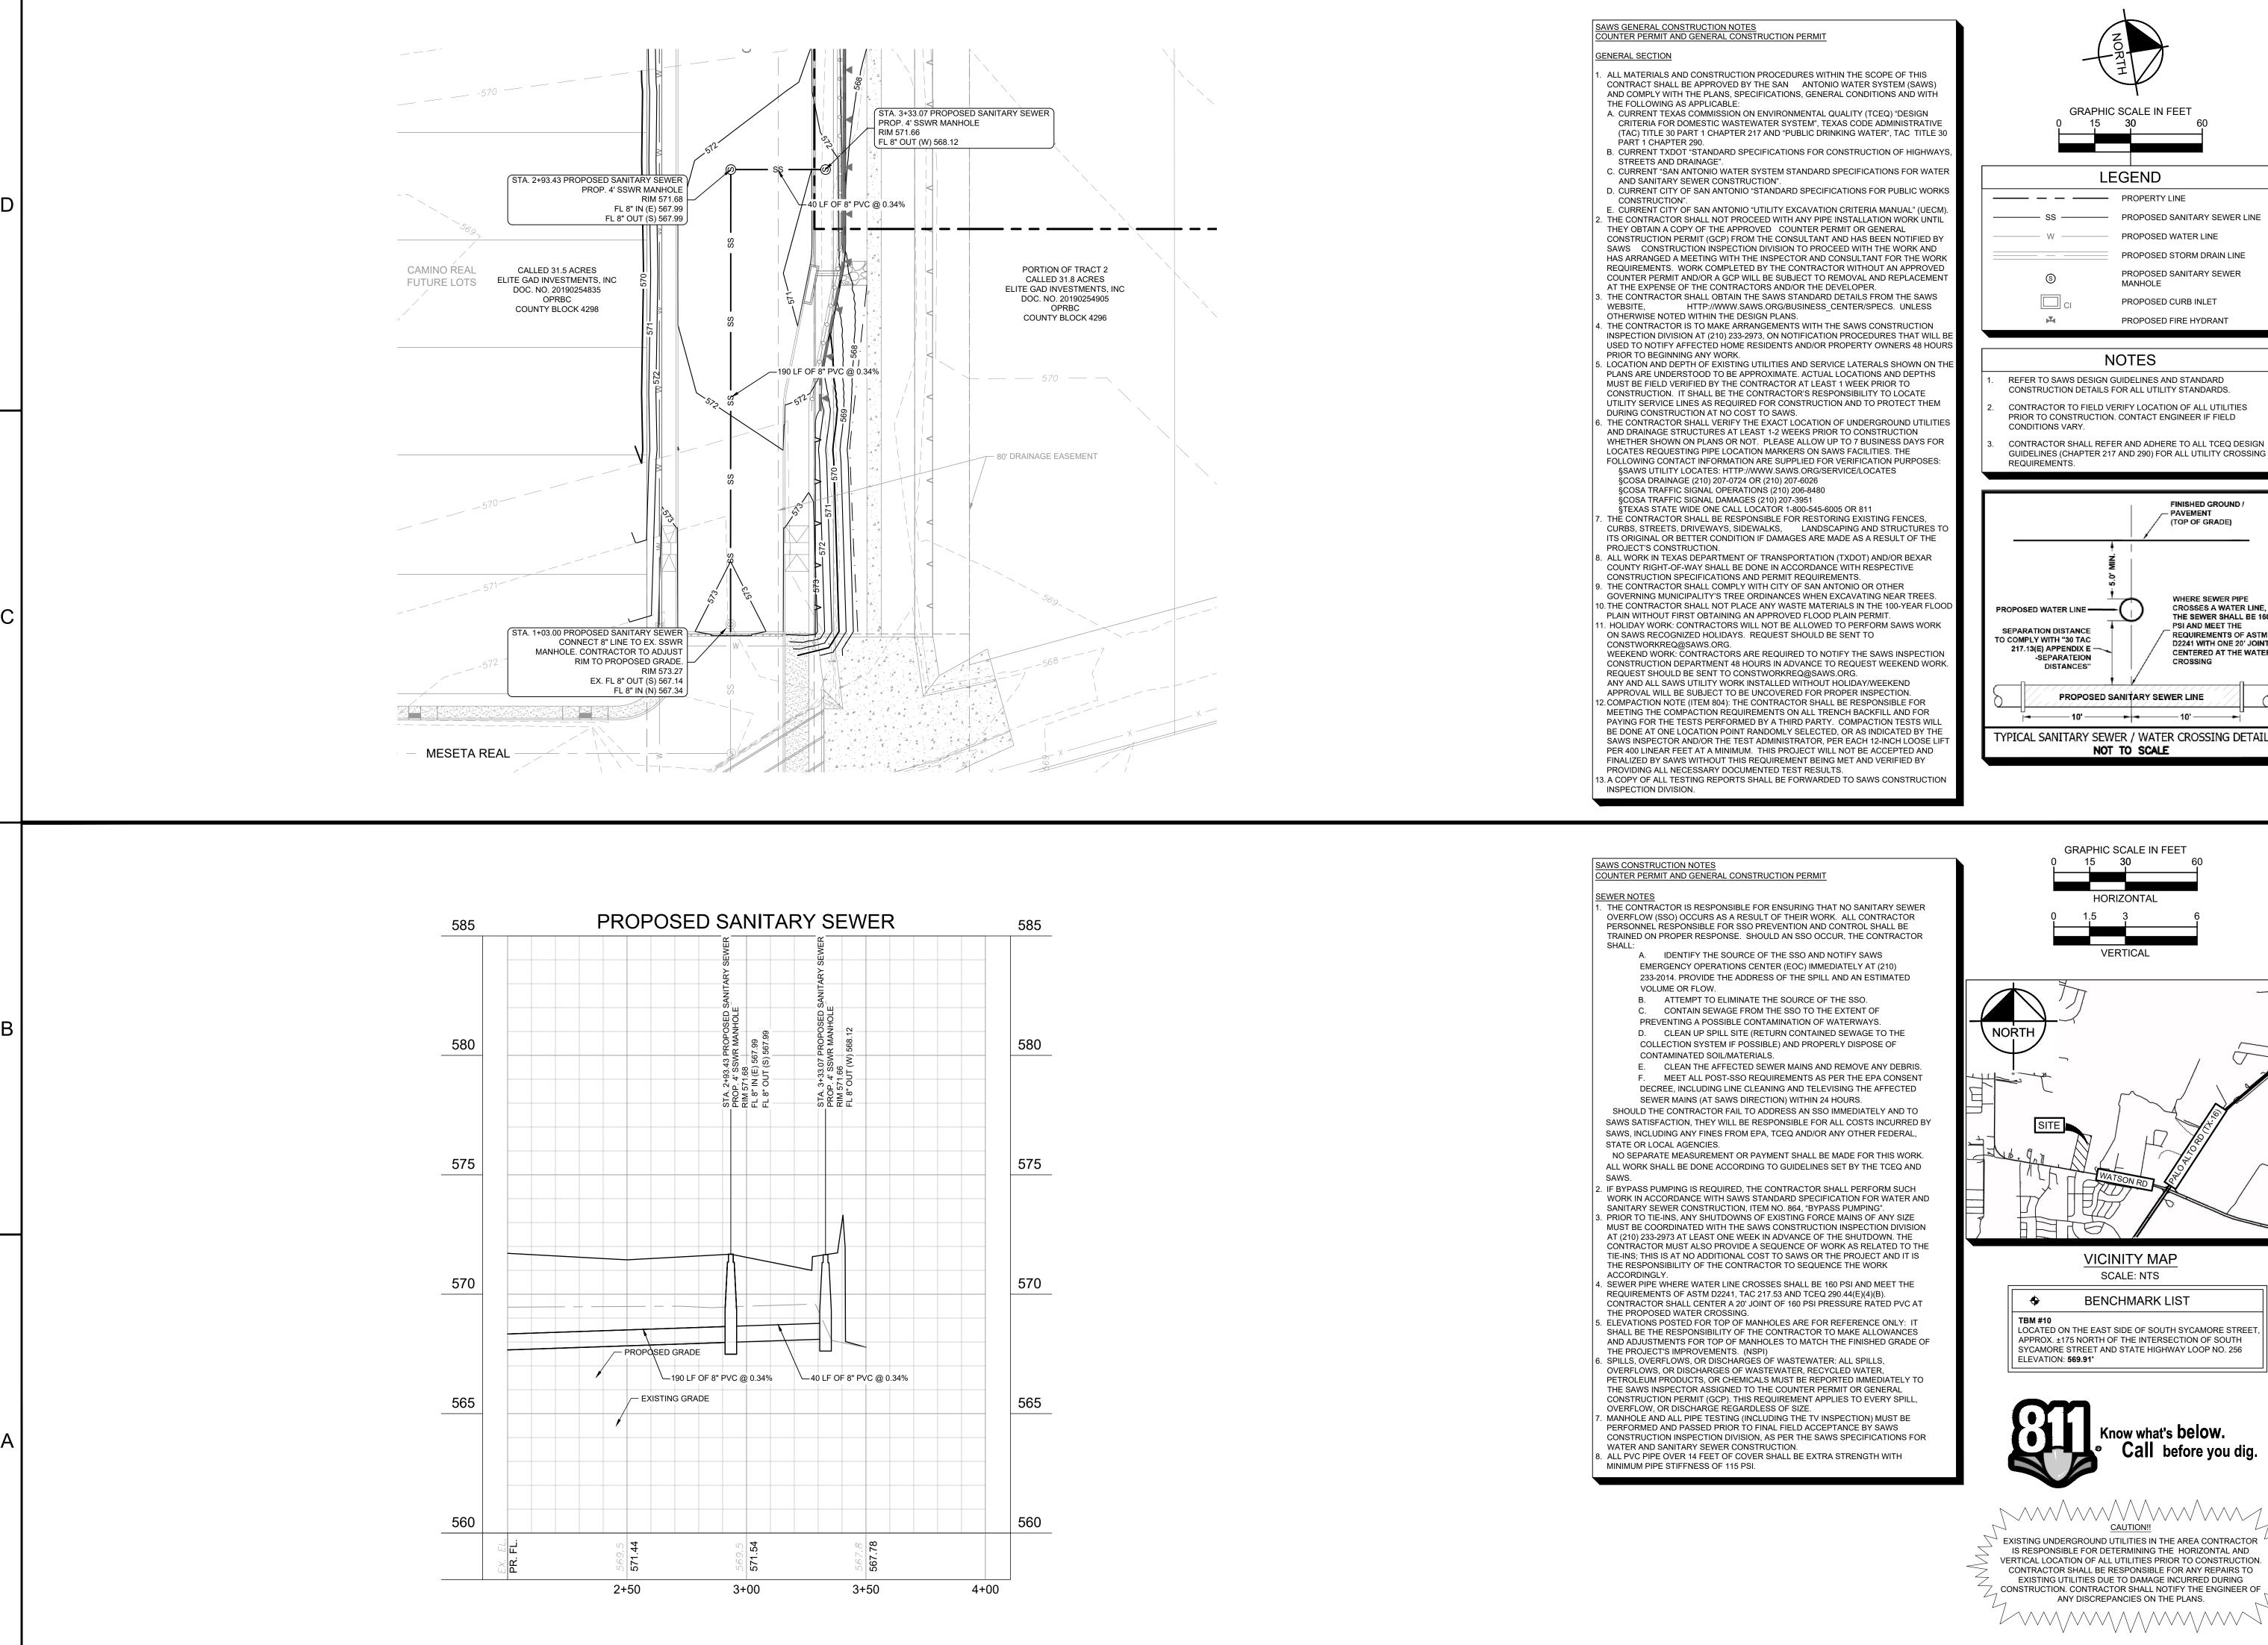




— — — PROPERTY LINE — PROPOSED SANITARY SEWER LINE PROPOSED WATER LINE PROPOSED STORM DRAIN LINE PROPOSED SANITARY SEWER MANHOLE PROPOSED CURB INLET

NOTES

PROPOSED FIRE HYDRANT

REFER TO SAWS DESIGN GUIDELINES AND STANDARD


- CONTRACTOR TO FIELD VERIFY LOCATION OF ALL UTILITIES
- CONTRACTOR SHALL REFER AND ADHERE TO ALL TCEQ DESIGN

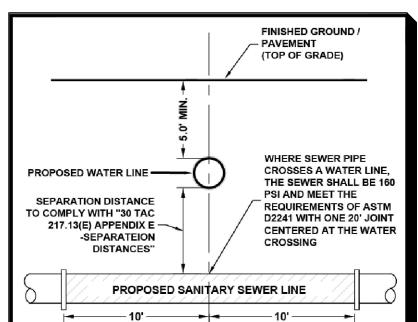

CONSTRUCTION DETAILS FOR ALL UTILITY STANDARDS.

PRIOR TO CONSTRUCTION. CONTACT ENGINEER IF FIELD CONDITIONS VARY.

GUIDELINES (CHAPTER 217 AND 290) FOR ALL UTILITY CROSSING REQUIREMENTS.

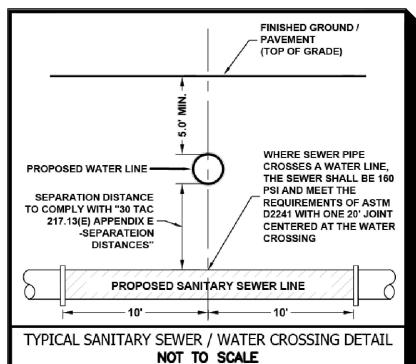

VICINITY MAP

SCALE: NTS

BENCHMARK LIST


0

MATTHEW G. MATNEY


JENTE.

PREPA PROPE AMIN

SHEET NUMBER

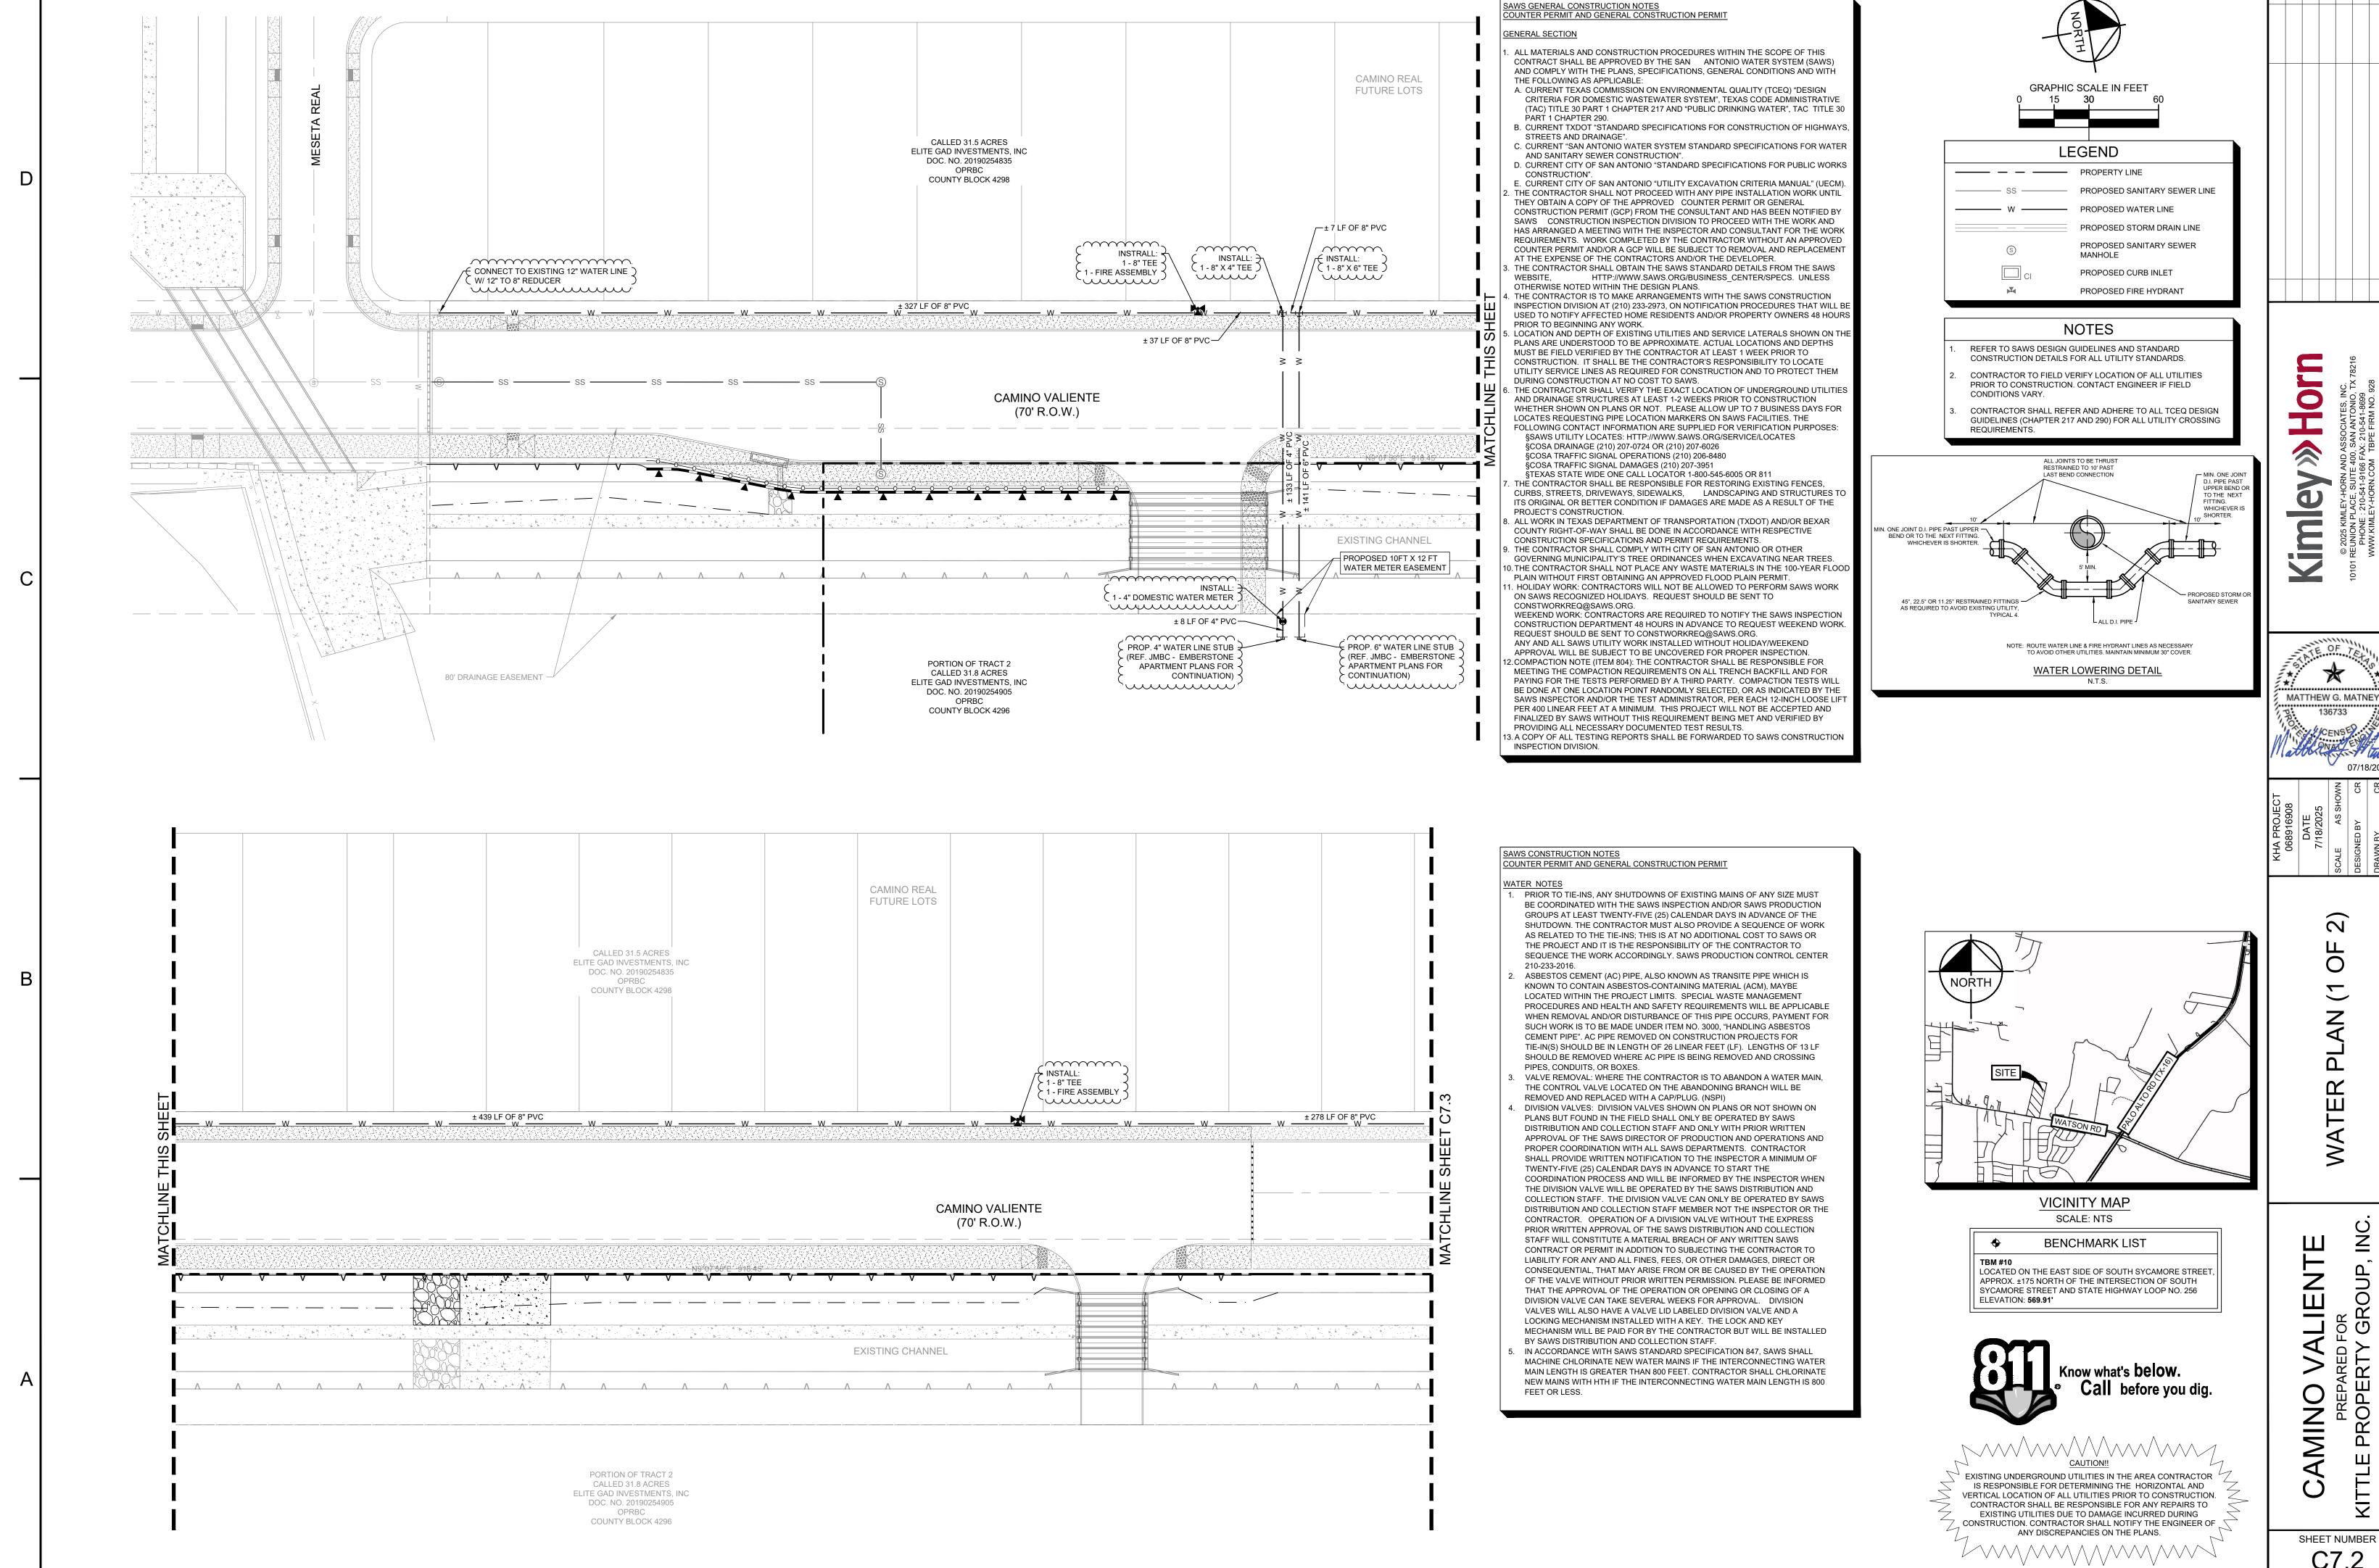

MATTHEW G. MATNEY

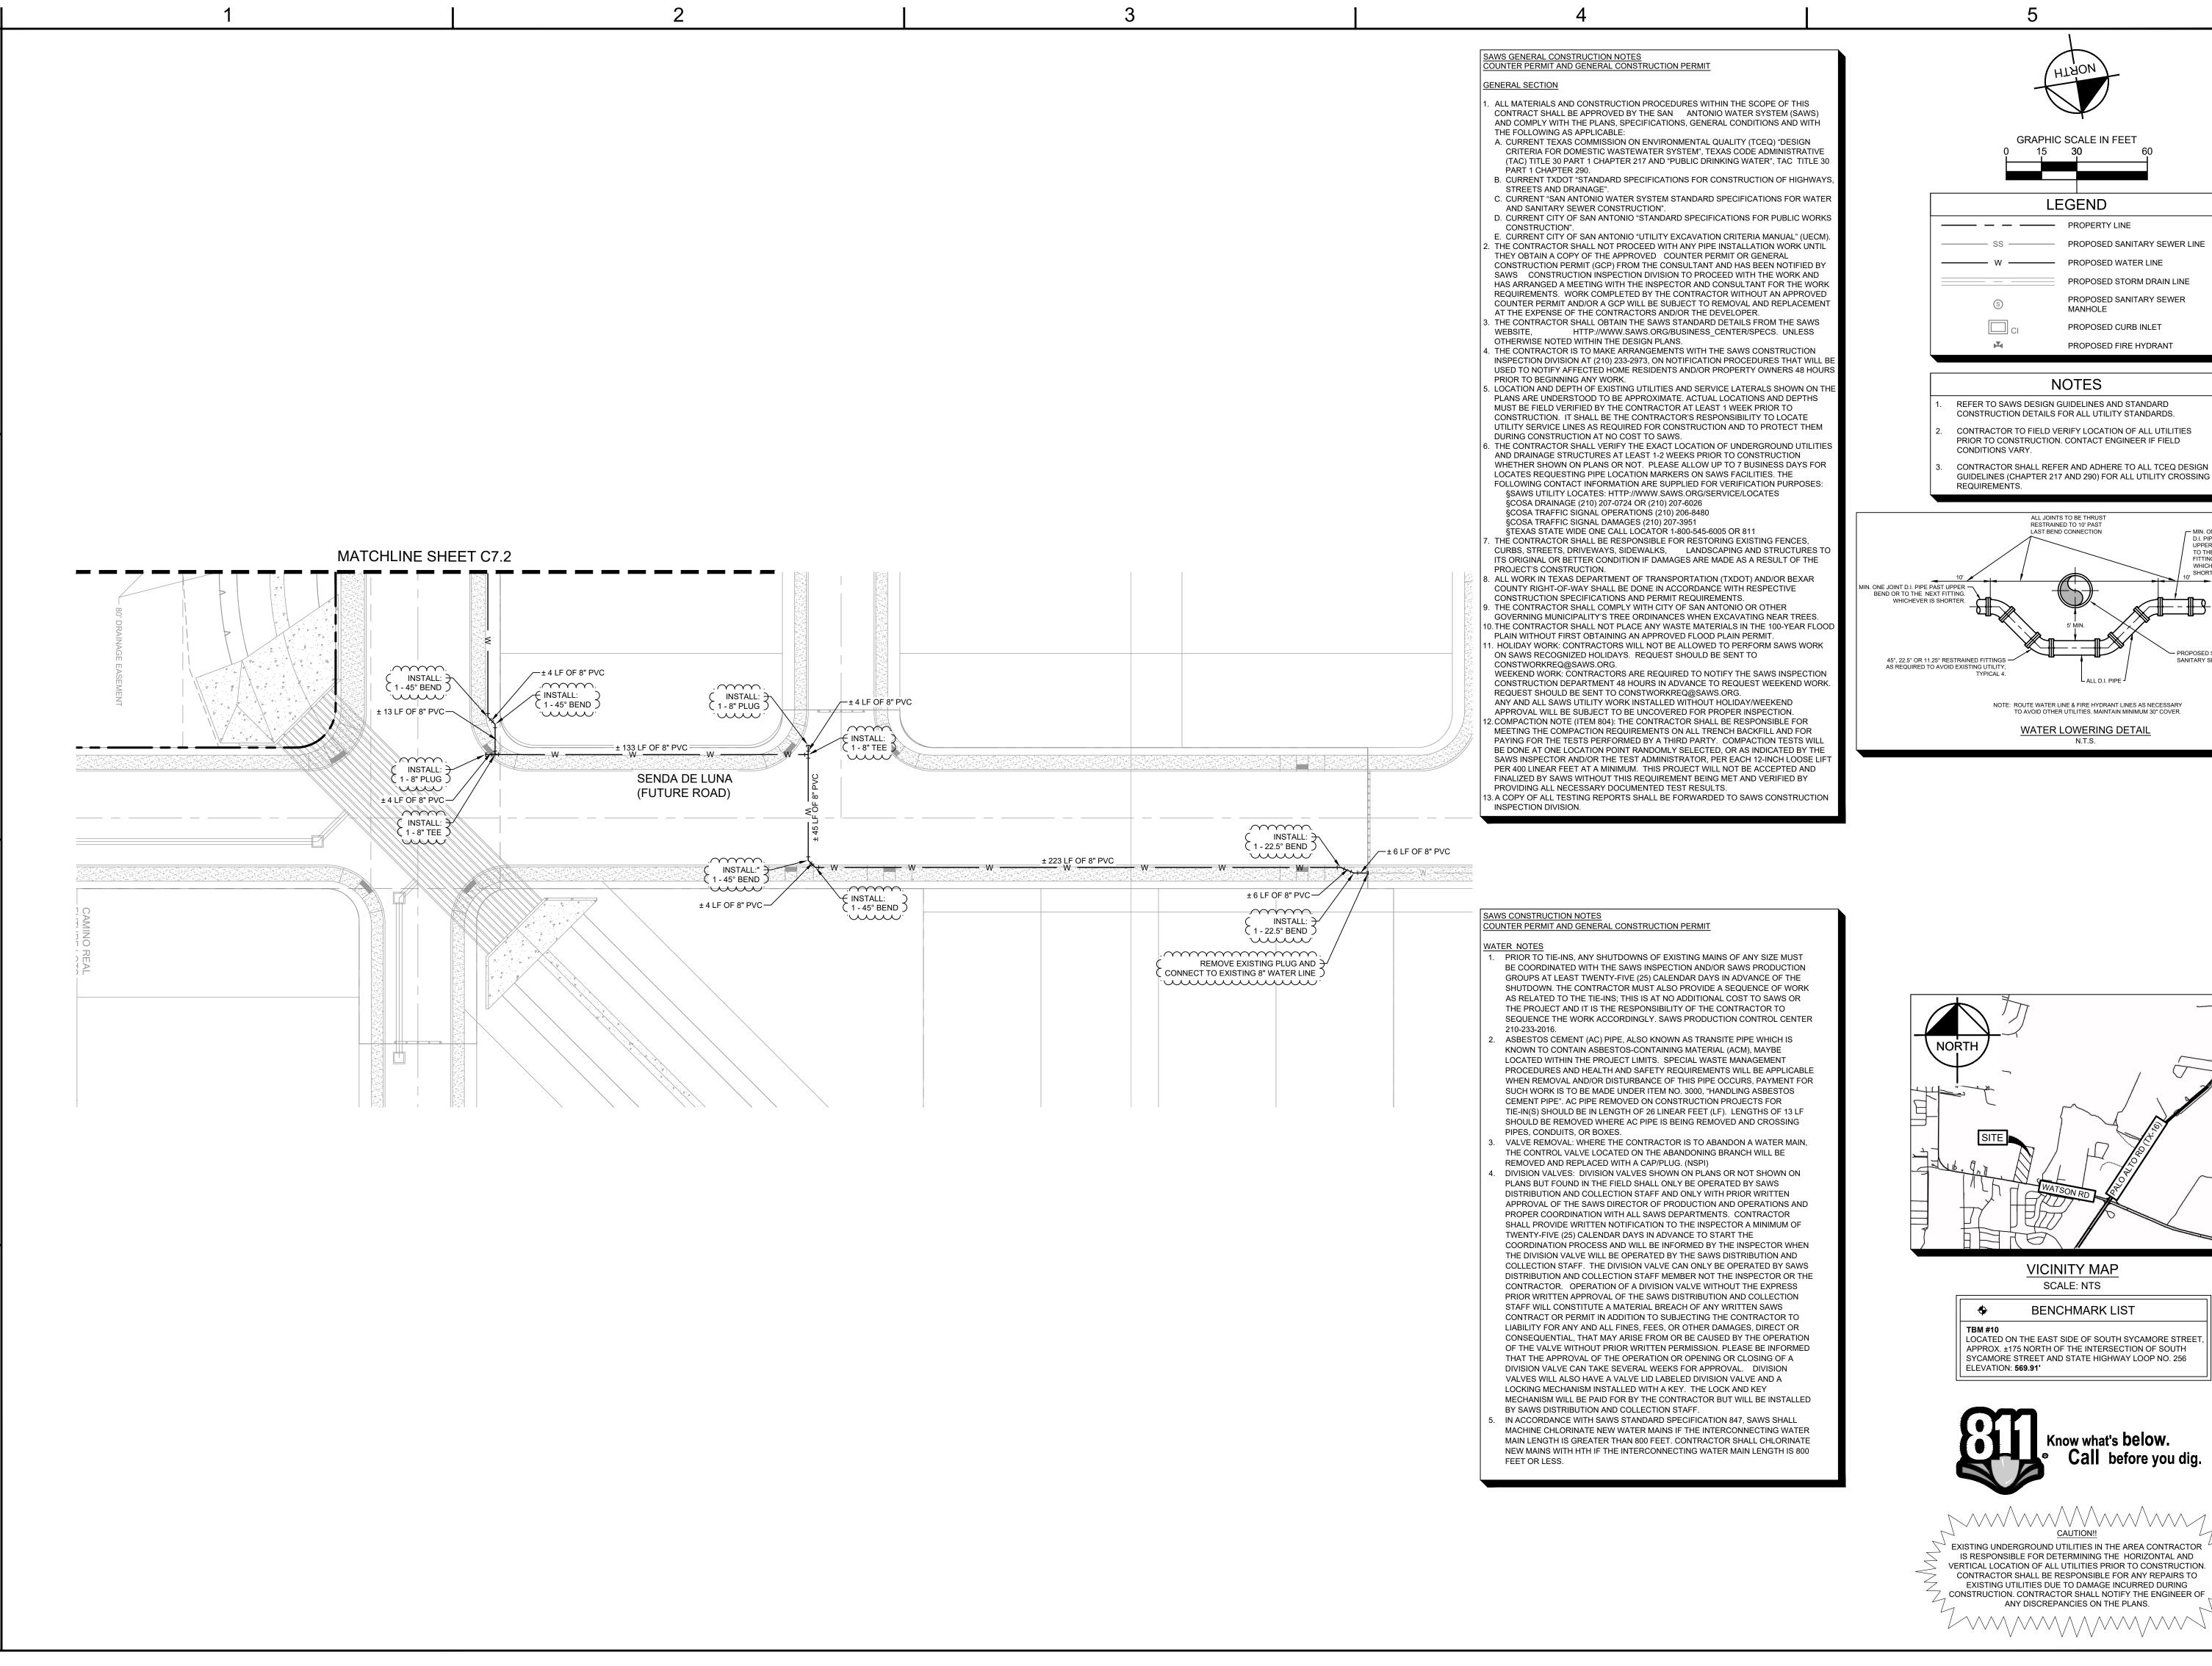



LEGEND PROPERTY LINE


PROPOSED SANITARY SEWER LINE PROPOSED WATER LINE PROPOSED STORM DRAIN LINE PROPOSED SANITARY SEWER MANHOLE PROPOSED CURB INLET

NOTES

PROPOSED FIRE HYDRANT

REFER TO SAWS DESIGN GUIDELINES AND STANDARD CONSTRUCTION DETAILS FOR ALL UTILITY STANDARDS.

- CONTRACTOR TO FIELD VERIFY LOCATION OF ALL UTILITIES PRIOR TO CONSTRUCTION. CONTACT ENGINEER IF FIELD
- CONTRACTOR SHALL REFER AND ADHERE TO ALL TCEQ DESIGN GUIDELINES (CHAPTER 217 AND 290) FOR ALL UTILITY CROSSING REQUIREMENTS.

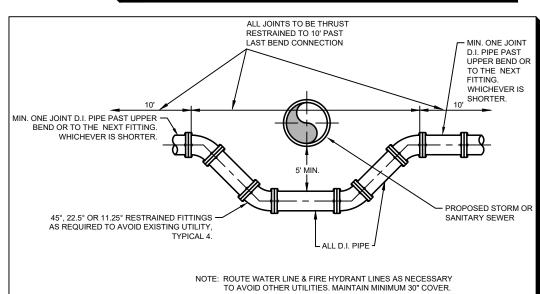


WATER LOWERING DETAIL N.T.S.

VICINITY MAP

SCALE: NTS

BENCHMARK LIST

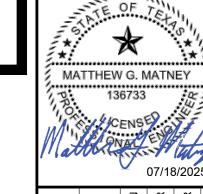

0

2

JENTE. PREPA PROPEI AMIN

SHEET NUMBER

