SUMMARY NOTES:

DEVELOPER/OWNER: ADRIAN TAMES

HYG HOMES 84 NE LOOP 410, SUITE 242

SAN ANTONIO, TX 78216

CONTACT: DAVID BABINEAUX, P.E. EMAIL: DBABINEAUX@BGEINC.COM 7330 SAN PEDRO AVENUE SUITE 202 SAN ANTONIO, TEXAS 78216

PHONE: (210) 469-3285

BGE, INC., TBPE F1046 CONTACT: DION ALBERTSON EMAIL: DALBERTSON@BGEINC.COM 7330 SAN PEDRO AVENUE SUITE 202

SAN ANTONIO, TEXAS 78216 PHONE: (210) 581-3600

FLOODPLAIN INFORMATION

NO PORTION OF THE LOT IN THIS TRACT IS WITHIN THE BOUNDARIES OF THE 100 YEAR FLOODPLAIN OF ANY WATERWAY THAT IS WITHIN THE LIMITS OF THE FEDERAL FLOOD INSURANCE ADMINISTRATION FIRM PANEL.

FEMA PANEL: 48029C0220G EFF. 9/29/2010 TRACT SIZE: 7.36 ACRES

TYPE: SINGLE FAMILY RESIDENTIAL

GENERAL NOTES

ALL CONSTRUCTION SHALL CONFORM TO THE LATEST SAN ANTONIO STANDARD SPECIFICATIONS FOR CONSTRUCTION.

STREETS - CITY OF SAN ANTONIO WATER - SAN ANTONIO WATER SYSTEM - SAWS DRAINAGE - CITY OF SAN ANTONIO

WASTEWATER - SAN ANTONIO WATER SYSTEM - SAWS

CONTACT INFORMATION FOR COORDINATION AND EMERGENCY

CITY OF SAN ANTONIO: (210) 207-1111 ELECTRIC UTILITY: CPS ENERGY (210) 353-4357 WATER UTILITY: SAN ANTONIO WATER SYSTEM-SAWS (210) 704-7297 WASTEWATER UTILITY: SAN ANTONIO WATER SYSTEM-SAWS (210) 704-7297

> **Digitally Approved by COSA DSD Streets and Traffic Plat Review**

Courtesy Street Plan Review:

7.8.2025

By: Abel Barraza AB





CIVIL CONSTRUCTION DRAWINGS:


HERON VALLEY PHASE 1

CITY OF SAN ANTONIO

WATER, SEWER, STREET & DRAINAGE IMPROVEMENTS

JUNE 2025

VICINITY MAP

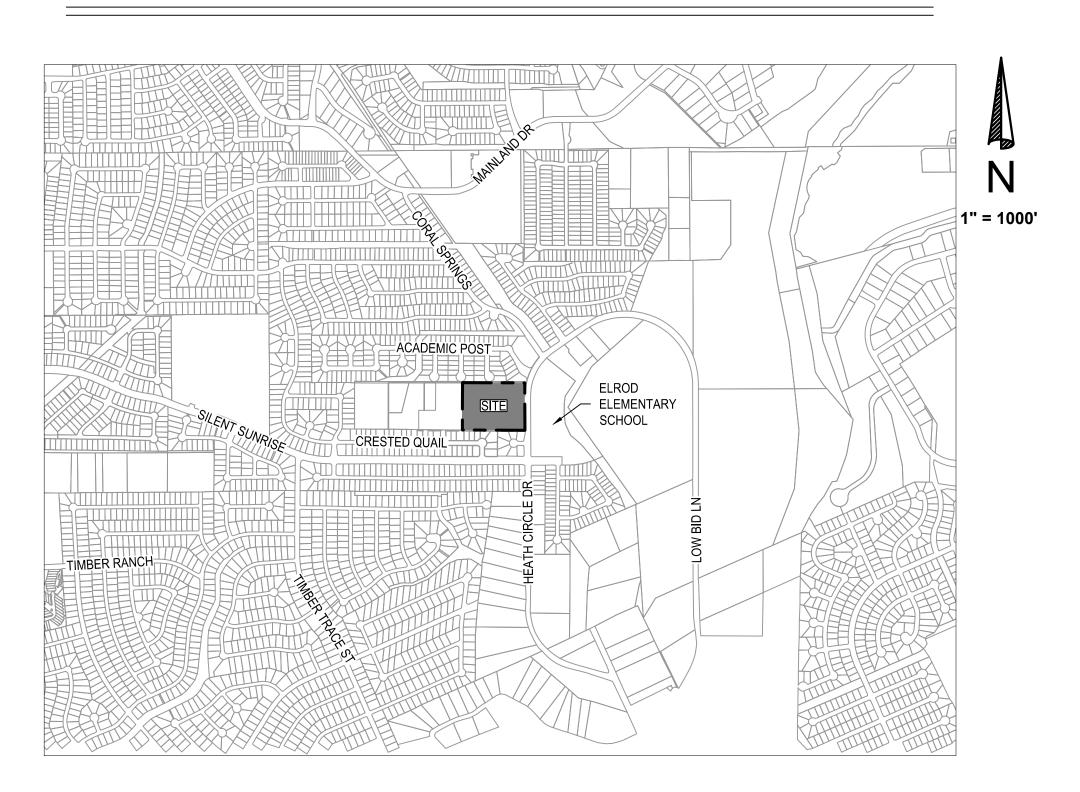

REVISIONS/CORRECTIONS						
SHEET LIST	DESCRIPTION	DATE	REVISE (R) ADD (A) VOID (V) SHEET NO.'S	ACCEPTED BY	APPROVAL DATE	

NOT FOR CONSTRUCTION



7330 San Pedro Ave., Suite 202 San Antonio, TX 78216 Tel: 210-581-3600 ● www.browngay.com

TBPE Registration No. F-1046

DAVID BABINEAUX,P.E. BGE,INC. TBPE NO.F-1046

7330 SAN PEDRO AVENUE SUITE 202

SAN ANTONIO, TEXAS 78216

PHONE: (210) 469 - 3285

SUBMITTED BY

HERON VALLEY PHASE 1

Sheet Number	Sheet Title
C00.00	COVER SHEET
C01.00	CIVIL GENERAL NOTES
C01.10	EXISTING CONDITIONS PLAN
C01.11	DEMOLITION PLAN
C02.00	EROSION & SEDIMENTATION CONTROL PLAN
C02.10	EROSION & SEDIMENTATION CONTROL DETAILS
C02.20	TREE PROTECTION PLAN
C02.21	DETAILED TREE PROTECTION PLAN (SHEET 1 OF 4)
C02.22	DETAILED TREE PROTECTION PLAN (SHEET 2 OF 4)
C02.23	DETAILED TREE PROTECTION PLAN (SHEET 3 OF 4)
C02.24	DETAILED TREE PROTECTION PLAN (SHEET 4 OF 4)
C02.30	TREE PROTECTION TABLES (SHEET 1 OF 2)
C02.31	TREE PROTECTION TABLES (SHEET 2 OF 2)
C02.32	TREE PROTECTION CALCULATIONS
C02.40	TREE PROTECTION PLAN DETAILS
C03.00	OVERALL GRADING PLAN
C03.20	DETENTION POND PLAN
C04.00	UTILITY PLAN
C05.00	OVERALL WASTEWATER PLAN
C05.10	WASTEWATER LINE A PLAN & PROFILE STA 1+00 TO 6+50
C05.11	WASTEWATER LINE A PLAN & PROFILE STA 6+50 TO END
C05.12	WASTEWATER LINE B PLAN & PROFILE
C06.00	WATER DISTRIBUTION PLAN
C06.01	WATER CROSSING DETAIL
C07.00	PARROT VALLEY PLAN AND PROFILE
C07.01	CONDOR VALLEY PLAN AND PROFILE
C07.02	CANARY VALLEY PLAN AND PROFILE
C07.03	FLAMINGO VALLEY PLAN AND PROFILE
C07.04	ROBIN VALLEY PLAN AND PROFILE
C07.10	KNUCKLE DETAILS
C08.00	STORM DRAIN COLLECTION PLAN
C08.10	STORM LINE A PLAN AND PROFILE
C08.11	STORM LINE B PLAN AND PROFILE
C08.20	STREET & DRAINAGE DETAILS (SHEET 1 OF 5)
C08.21	STREET & DRAINAGE DETAILS (SHEET 2 OF 5)
C08.22	STREET & DRAINAGE DETAILS (SHEET 3 OF 5)
C08.23	STREET & DRAINAGE DETAILS (SHEET 4 OF 5)
C08.24	STREET & DRAINAGE DETAILS (SHEET 5 OF 5) SIGNAGE PLAN
C09.00 C09.01	SIGNAGE PLAN SIGNAGE DETAILS (SHEET 1 OF 2)
C09.02	SIGNAGE DETAILS (SHEET 2 OF 2)

SAWS PRESSURE ZONE: 1111


SAWS PRESSURE ZUNE. TITI
DEVELOPER NAME: HYG HOMES
DEVELOPER ADDRESS: 84 NE LOOP 410, SUITE 242
CITY <u>SAN ANTONIO</u> STATE <u>TX</u> ZIP <u>78216</u>
PHONE_(210)-966-2025
SAWS BLOCK MAP #TOTAL EDU'S 42 TOTAL ACREAGE 7.361
TOTAL LINEAR FOOTAGE OF PIPE <u>2,078</u> PLAT NO. <u>24-11800389</u>
NUMBER OF LOTS 40 SAWS JOB NO. 24-1154

MIDDLE COLLECTION AND TREATMENT AREA (MCTA) DEVELOPER NAME: HYG HOMES DEVELOPER ADDRESS: 84 NE LOOP 410, SUITE 242 CITY_SAN ANTONIO STATE TX ZIP 78216 PHONE (210)-966-2025 FAX N/A

SAWS BLOCK MAP # N/A TOTAL EDU'S 40 TOTAL ACREAGE 7.361


TOTAL LINEAR FOOTAGE OF PIPE Private: 1.384 L.F of 8" PVC PLAT NO. 24-11800389


NUMBER OF LOTS 40 SAWS JOB NO. 24-1625

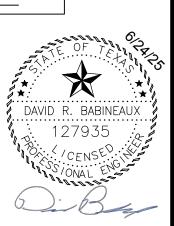

Know what's below. Call before you dig.

THE LOCATION OF EXISTING UNDERGROUND UTILITIES ARE SHOWN IN AN APPROXIMATE WAY ONLY. THE CONTRACTOR SHALL DETERMINE THE EXACT LOCATION OF ALL EXISTING UTILITIES BEFORE COMMENCING WORK. HE AGREES TO BE FULLY RESPONSIBLE FOR ANY AND ALL DAMAGES WHICH MIGHT BE OCCASIONED BY HIS FAILURE TO EXACTLY LOCATE AND PRESERVE ANY AND ALL UNDERGROUND UTILITIES.

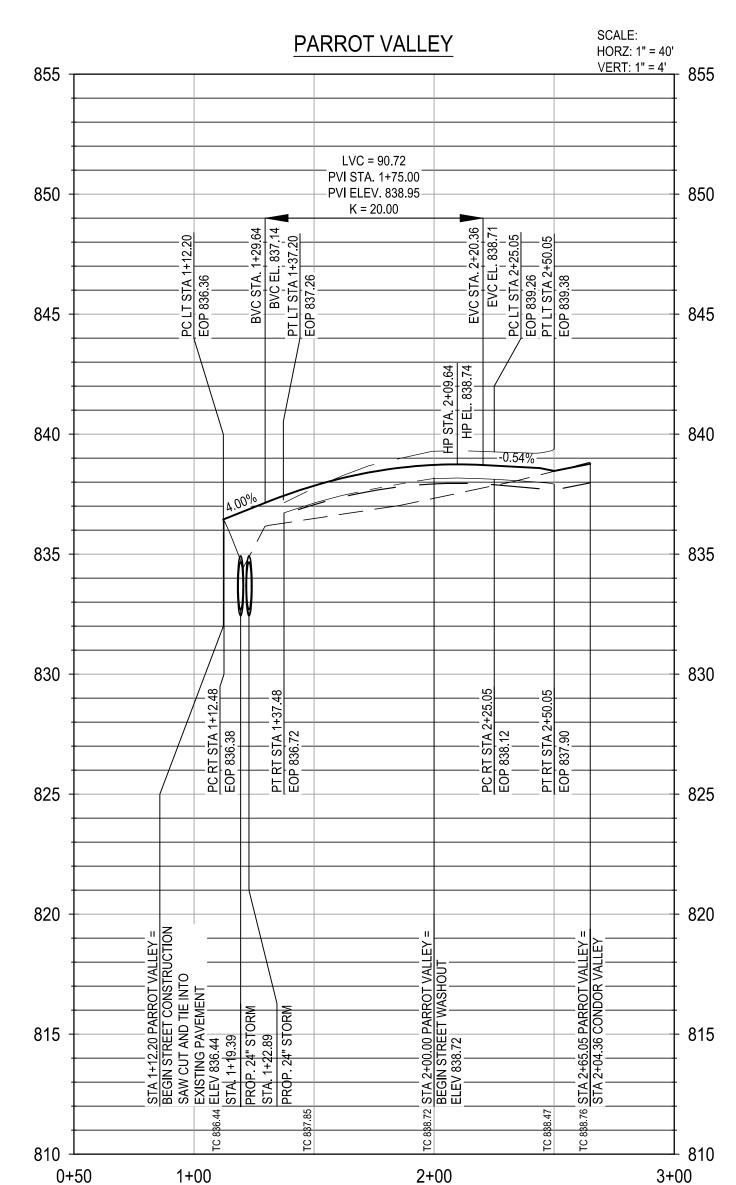

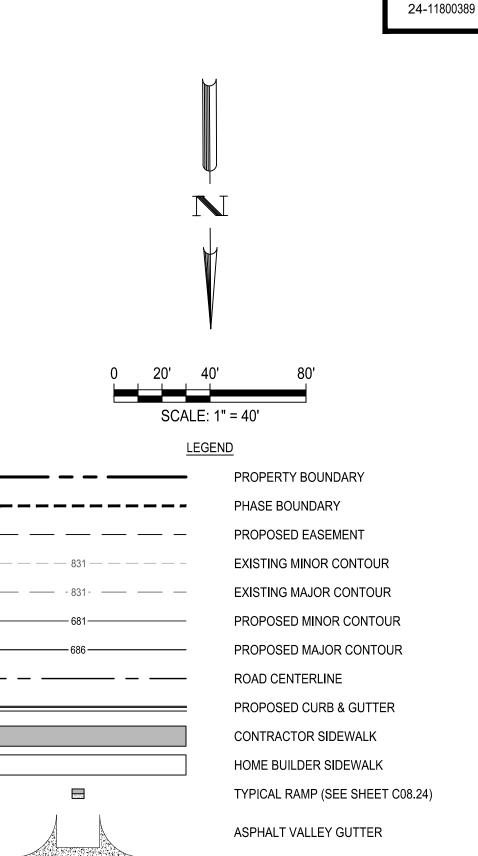

PROFILE LEGEND

PROPOSED FG @ CENTERLINE PROPOSED SUBGRADE PROPOSED BOTTOM OF CURB RIGHT PROPOSED BOTTOM OF CURB LEFT

CONTRACTOR SHALL ENSURE THAT PROPOSED A.D.A. RAMPS AND ACCESSIBLE ROUTES ALONG ROAD CROSSING COMPLY WITH SPECIFICATIONS FOR BOTH RUNNING SLOPE AND CROSS SLOPE.

ENGINEER OF ANY DISCREPANCIES.

◆LP/HP

TRENCH EXCAVATION SAFETY PROTECTION CONTRACTOR AND/OR CONTRACTOR'S INDEPENDENTLY RETAINED EMPLOYEE OR STRUCTURAL DESIGN/GEOTECHNICAL/SAFETY/EQUIPMENT CONSULTANT, IF ANY, SHALL REVIEW THESE PLANS AND ANY AVAILABLE GEOTECHNICAL INFORMATION AND THE ANTICIPATED INSTALLATION SITES WITHIN THE PROJECT WORK AREA IN ORDER TO IMPLEMENT CONTRACTOR'S TRENCH EXCAVATION SAFETY PROTECTION SYSTEMS, PROGRAMS AND/OR PROCEDURES FOR THE PROJECT DESCRIBED IN THE CONTRACT DOCUMENTS. THE CONTRACTOR'S IMPLEMENTATION OF THESE SYSTEMS, PROGRAMS AND/OR PROCEDURES SHALL PROVIDE FOR ADEQUATE TRENCH EXCAVATION SAFETY PROTECTION THAT COMPLY WITH AS A MINIMUM, OSHA STANDARDS FOR TRENCH EXCAVATIONS. SPECIFICALLY, CONTRACTOR AND/OR CONTRACTOR'S INDEPENDENTLY RETAINED EMPLOYEE OR SAFETY CONSULTANT SHALL IMPLEMENT A TRENCH SAFETY PROGRAM IN ACCORDANCE WITH OSHA STANDARDS COVERING THE PRESENCE AND ACTIVITIES OF INDIVIDUALS WORKING IN AND AROUND TRENCH EXCAVATIONS.

NOTES:

PRIVATE STREET DESIGNATION:

AND IS DESIGNATED AS AN

LOT 999, BLOCK 9, IS A PRIVATE STREET

IRREVOCABLE UNDERGROUND AND

SERVICE FACILITIES EASEMENT FOR

WATER, WASTEWATER, AND RECYCLED

AT-GRADE INFRASTRUCTURE AND


GAS, ELECTRIC, STREET LIGHT,

TELEPHONE, CABLE TELEVISION,

DRAINAGE, PEDESTRIAN, PUBLIC

WATER MAINS.

- 1. CONTRACTOR TO SEE DETAIL SHEET FOR TYPICAL ROAD CROSS-SECTIONS. 2. CONTRACTOR SHALL CLEAR AND GRUB THE ENTIRE STREET RIGHT OF WAY WITH THE EXCEPTION OF TREES TO REMAIN AND COORDINATE WITH OWNER AND ENGINEER TO SELECT CLEAR P.U.E. WHERE APPLICABLE FOR DRY UTILITY INSTALLATION.
- 3. CONTRACTOR TO GRADE OR REGRADE ALL AREAS WITHIN ROAD ROW INCLUDING DITCHES FOR POSITIVE DRAINAGE.
- 4. CONTRACTOR SHALL GRADE TO DRAIN AREAS UPSTREAM AND DOWNSTREAM OF ALL PROPOSED CHANNELS.
- 5. CONTRACTOR TO COORDINATE WITH DEVELOPER REGARDING TREE WELLS TO ENSURE TREES TO REMAIN ARE SAVED. CONTRACTOR TO REFERENCE LANDSCAPE PLANS FOR TREE WELL FINISHES.
- 6. CONTRACTOR SHALL HYDROMULCH OR WOODMULCH ALL DISTURBED AREAS, INCLUDING RIGHT-OF-WAY, STEEP SLOPES, DRAINAGE DITCHES WHERE SOIL SUBGRADE IS ENCOUNTERED. CONTRACTOR SHALL BE RESPONSIBLE FOR PROVIDING SUFFICIENT WATERING IN HYDROMULCH AREAS TO ESTABLISH VEGETATION.
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- ALL DIMENSIONS ARE TO FACE OF CURB UNLESS OTHERWISE NOTED. SIDEWALKS ADJACENT TO SINGLE FAMILY LOTS ARE TO BE CONSTRUCTED CONCURRENTLY WITH EACH SINGLE FAMILY HOUSE BY THE HOME BUILDER.

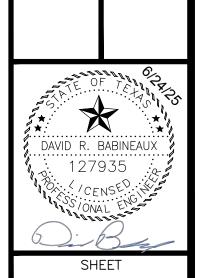

 \triangleleft

DESIGNED BY: JDC

REVIEWED BY: OR

DRAWN BY:

EXISTING GROUND @ CENTERLINE * CONTRACTOR TO FIELD VERIFY AND NOTIFY


LOW POINT/HIGH POINT


PROPOSED CURB INLET


WASHOUT AREA

MANHOLE

PROPOSED STORM LINE WITH

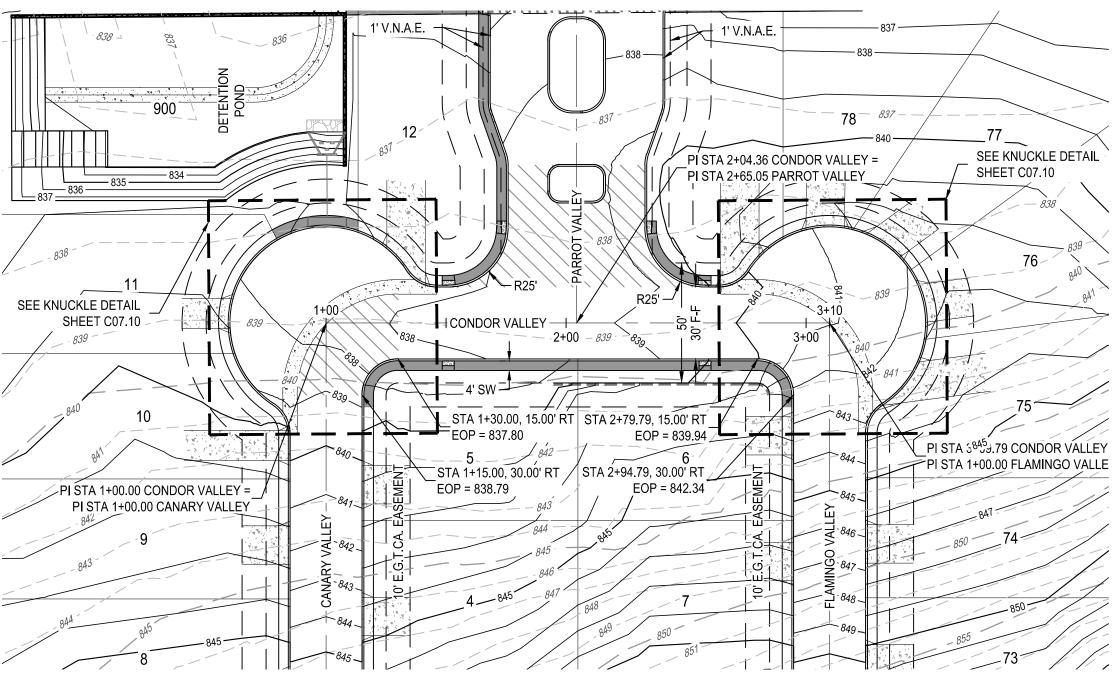

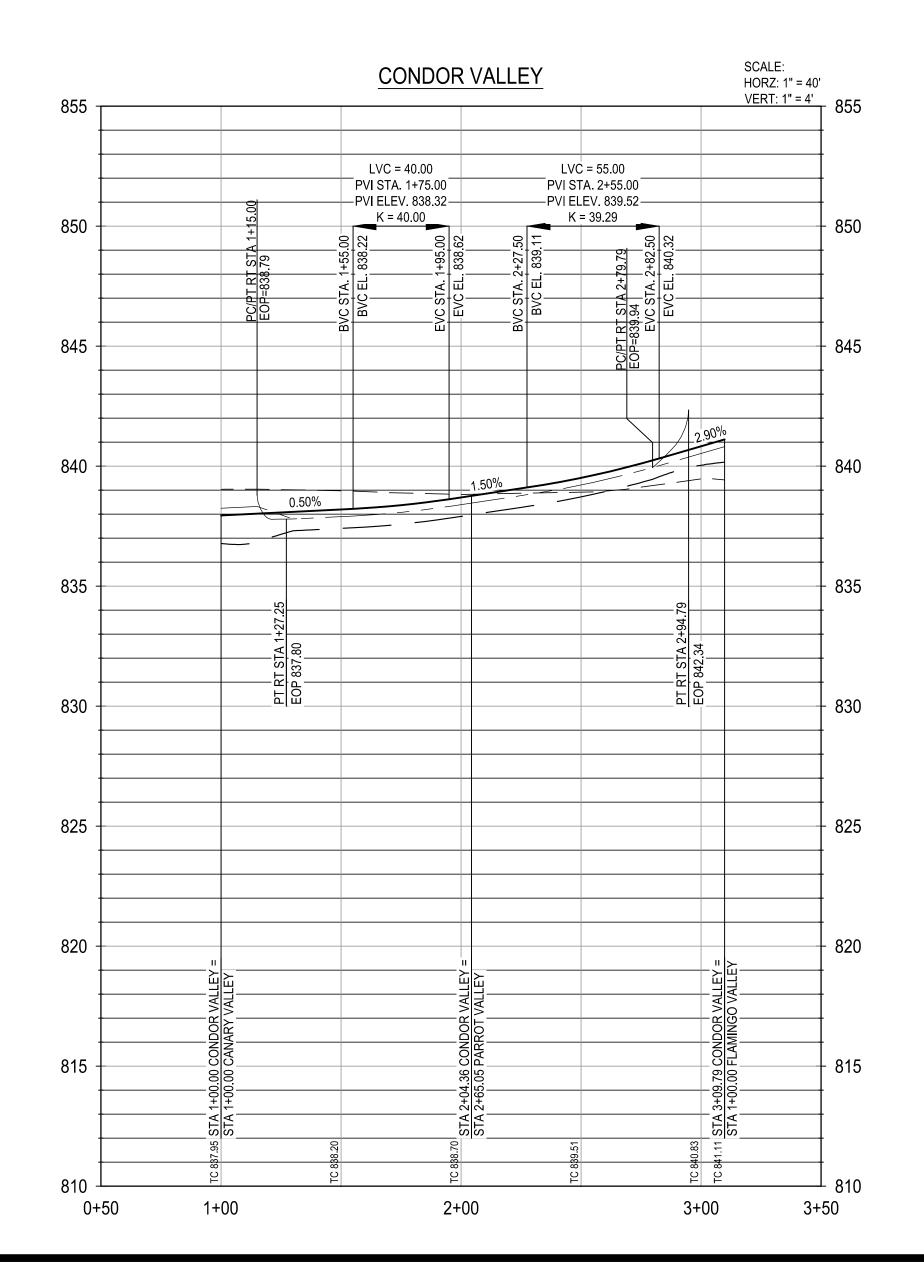

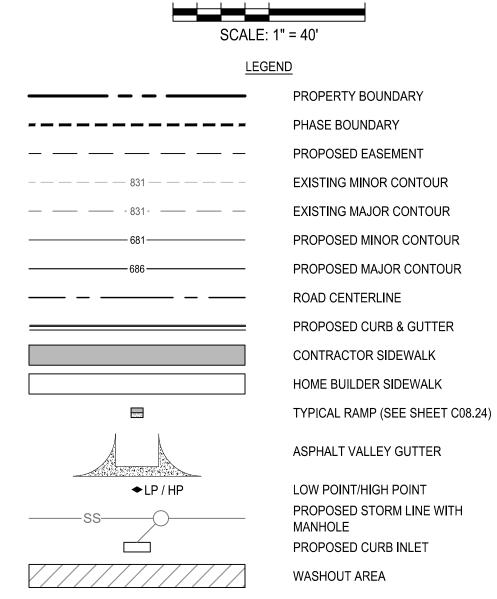

24-11800389

PROFILE LEGEND

 —
 —
 PROPOSED FG @ CENTERLINE

 —
 —
 —
 PROPOSED SUBGRADE

 —
 —
 —
 PROPOSED BOTTOM OF CURB RIGHT

 —
 —
 —
 PROPOSED BOTTOM OF CURB LEFT

 —
 —
 —
 EXISTING GROUND @ CENTERLINE

NOTE:
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* CONTRACTOR TO FIELD VERIFY AND NOTIFY ENGINEER OF ANY DISCREPANCIES.

TRENCH EXCAVATION SAFETY PROTECTION

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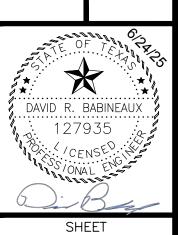
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PGE, III 7330 San Pedro San Pedro San Antonio, 1 7EL: 210-581-3600 ww TEL: 210-581-3600 ww

DESIGNED BY: JDC

REVIEWED BY: OR

DRAWN BY:



PRIVATE STREET DESIGNATION:

LOT 999, BLOCK 9, IS A PRIVATE STREET AND IS DESIGNATED AS AN IRREVOCABLE UNDERGROUND AND AT-GRADE INFRASTRUCTURE AND SERVICE FACILITIES EASEMENT FOR GAS, ELECTRIC, STREET LIGHT, TELEPHONE, CABLE TELEVISION, DRAINAGE, PEDESTRIAN, PUBLIC WATER, WASTEWATER, AND RECYCLED WATER MAINS.

5+00

4+00

825 | 840

-820 | 835 |

3+00

2+00

1+00

0+50

SCALE: 1" = 40' <u>LEGEND</u> PROPERTY BOUNDARY PHASE BOUNDARY PROPOSED EASEMENT EXISTING MINOR CONTOUR EXISTING MAJOR CONTOUR DESIGNED BY: JDC PROPOSED MINOR CONTOUR REVIEWED BY: OR PROPOSED MAJOR CONTOUR DRAWN BY: ROAD CENTERLINE PROPOSED CURB & GUTTER CONTRACTOR SIDEWALK HOME BUILDER SIDEWALK

TYPICAL RAMP (SEE SHEET C08.24)

ASPHALT VALLEY GUTTER

PROPOSED STORM LINE WITH

LOW POINT/HIGH POINT

PROPOSED CURB INLET

WASHOUT AREA

MANHOLE

24-11800389

PROPOSED FG @ CENTERLINE PROPOSED SUBGRADE PROPOSED BOTTOM OF CURB RIGHT PROPOSED BOTTOM OF CURB LEFT EXISTING GROUND @ CENTERLINE

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DRAINAGE, PEDESTRIAN, PUBLIC

WATER MAINS.

AND IS DESIGNATED AS AN

840

6+50


6+00


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0 20' 40' 80'

SCALE: 1" = 40'

LEGEND

PROPERTY BOUNDARY

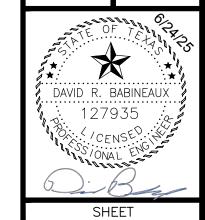PHASE BOUNDARY

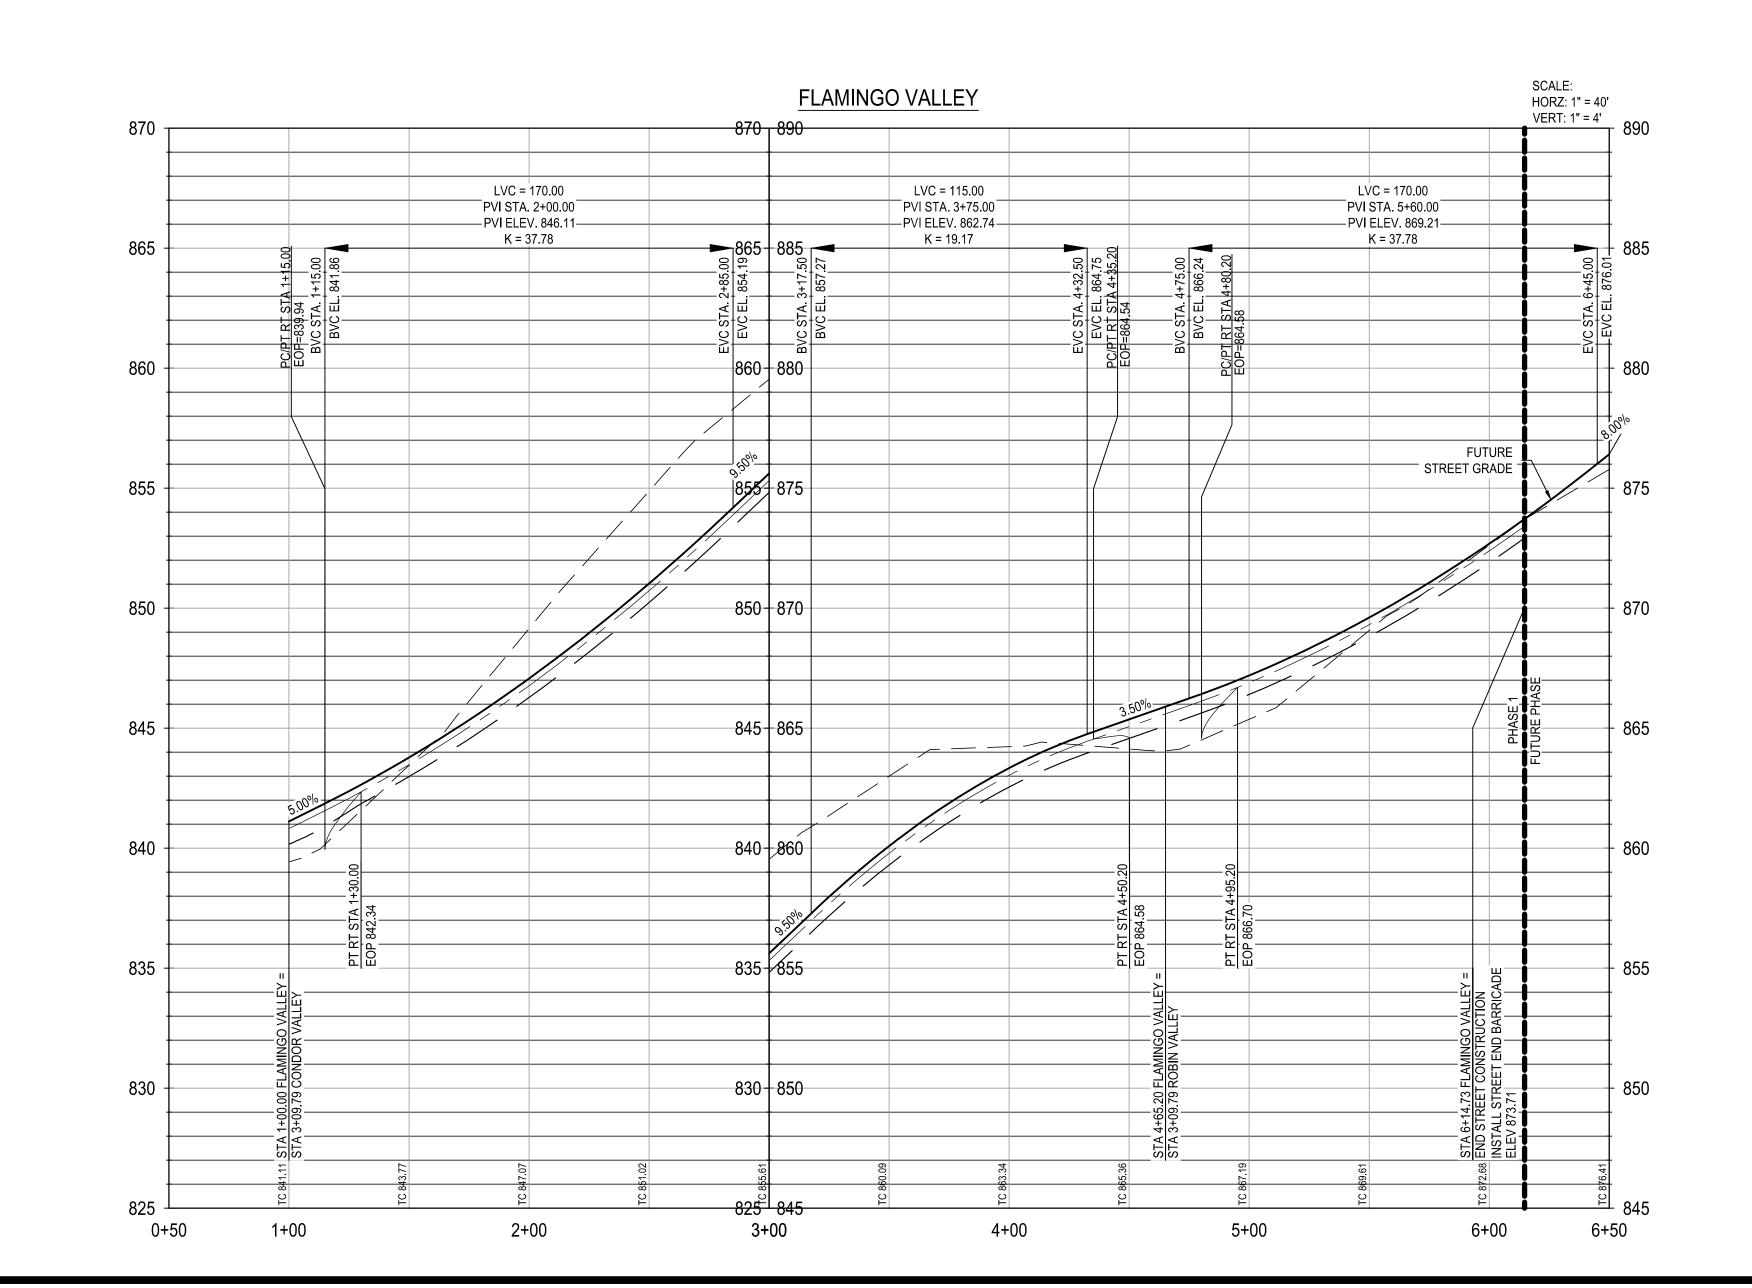PROPOSED EASEMENT

EXISTING MINOR CONTOUR

831 — EXISTING MAJOR CONTOUR

EXISTING MAJOR CONTOUR

PROPOSED MINOR CONTOUR

PROPOSED MAJOR CONTOUR

PROPOSED MAJOR CONTOUR

◆LP/HP

TYPICAL RAMP (SEE SHEET C08.24)

ASPHALT VALLEY GUTTER

HOME BUILDER SIDEWALK

PROPOSED CURB & GUTTER

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ROAD CENTERLINE

24-11800389

LOW POINT/HIGH POINT PROPOSED STORM LINE WITH MANHOLE

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PROFILE LEGEND

PROPOSED FG @ CENTERLINE
PROPOSED SUBGRADE
PROPOSED BOTTOM OF CURB RIGHT
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7330 San Pedro, Suite 20
San Antonio, TX 78216
TEL: 210-581-3600 www.browng

TBPE Registration No. F-10

DESIGNED BY: JDC

REVIEWED BY: OR

DRAWN BY:

ntonio Brojects/19836-00 - Heron Vellev\01 | Unit 1\03 CADD\01 | Shts\C02 03 ELAMINGO VALLEY BLAN AND BROEILE dwg | Jewen Vellev\01 | EV BLAN AND


DAVID R. BABINEAUX


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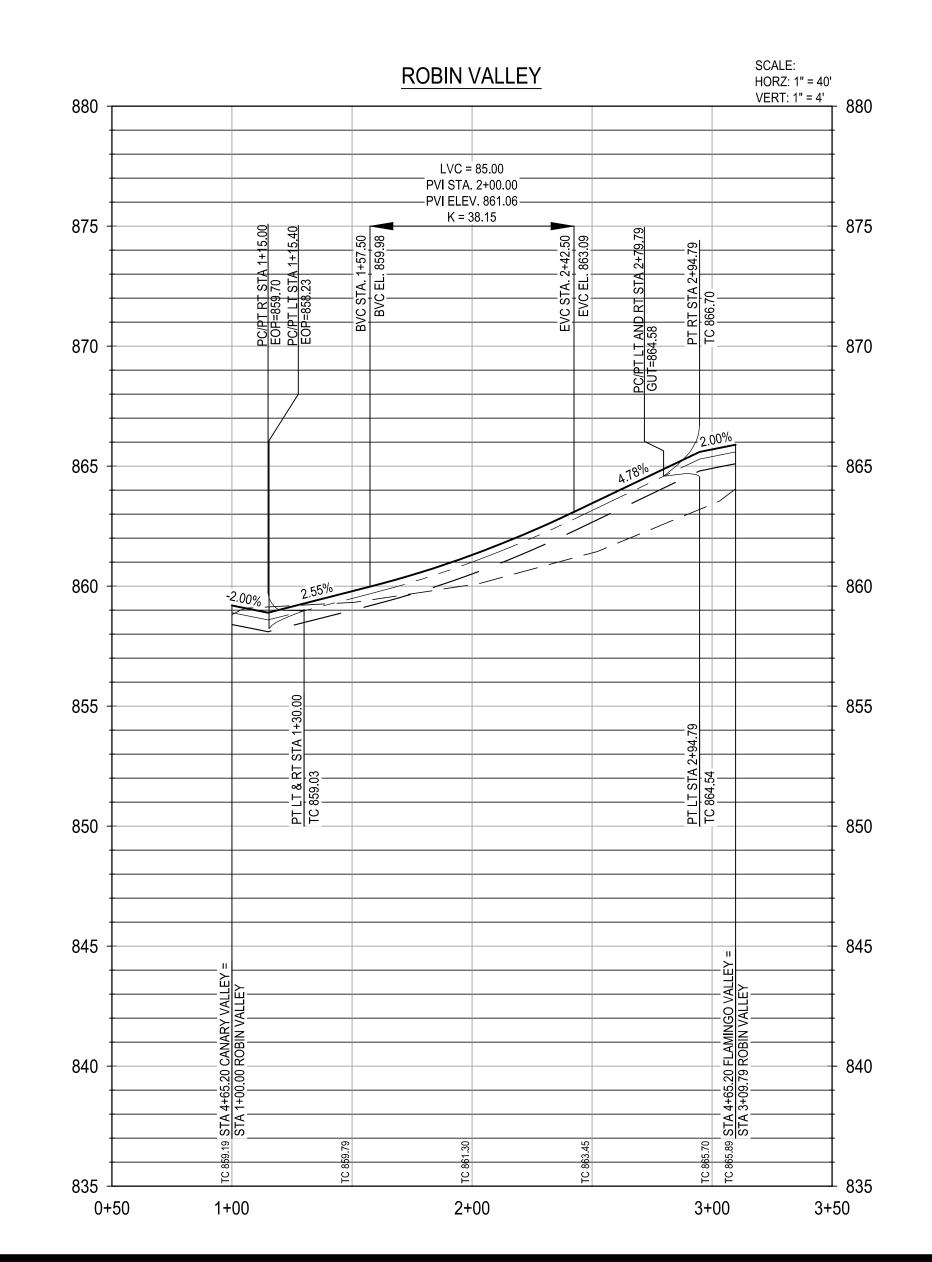
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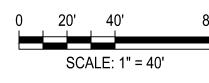
ONAL ENG

SHEET C07.03






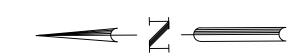

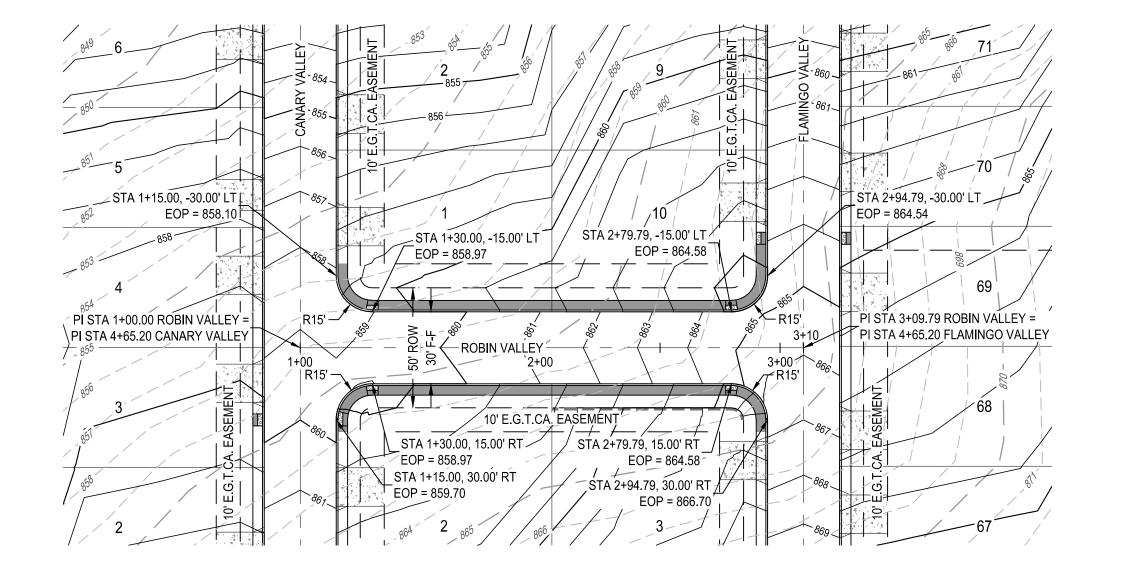


LEGEND

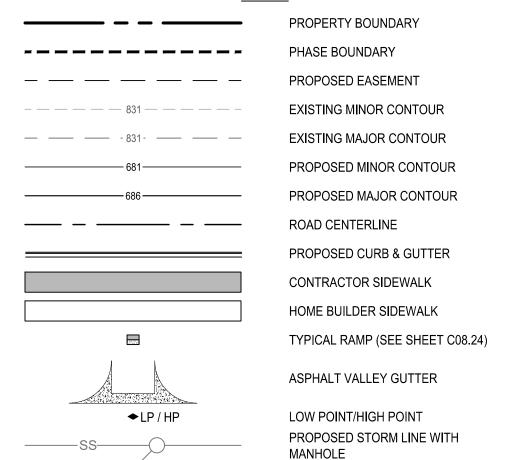

PROFILE LEGEND

PROPOSED CURB INLET

WASHOUT AREA

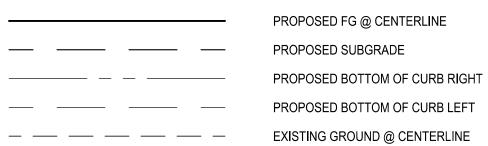

NOTE:
CONTRACTOR SHALL ENSURE THAT PROPOSED A.D.A. RAMPS AND ACCESSIBLE ROUTES ALONG ROAD CROSSING COMPLY WITH SPECIFICATIONS FOR BOTH RUNNING SLOPE AND CROSS SLOPE.

* CONTRACTOR TO FIELD VERIFY AND NOTIFY ENGINEER OF ANY DISCREPANCIES.

TRENCH EXCAVATION SAFETY PROTECTION

CONTRACTOR AND/OR CONTRACTOR'S INDEPENDENTLY RETAINED EMPLOYEE OR STRUCTURAL DESIGN/GEOTECHNICAL/SAFETY/EQUIPMENT CONSULTANT, IF ANY, SHALL REVIEW THESE PLANS AND ANY AVAILABLE GEOTECHNICAL INFORMATION AND THE ANTICIPATED INSTALLATION SITES WITHIN THE PROJECT WORK AREA IN ORDER TO IMPLEMENT CONTRACTOR'S TRENCH EXCAVATION SAFETY PROTECTION SYSTEMS, PROGRAMS AND/OR PROCEDURES FOR THE PROJECT DESCRIBED IN THE CONTRACT DOCUMENTS. THE CONTRACTOR'S IMPLEMENTATION OF THESE SYSTEMS, PROGRAMS AND/OR PROCEDURES SHALL PROVIDE FOR ADEQUATE TRENCH EXCAVATION SAFETY PROTECTION THAT COMPLY WITH AS A MINIMUM, OSHA STANDARDS FOR TRENCH EXCAVATIONS. SPECIFICALLY, CONTRACTOR AND/OR CONTRACTOR'S INDEPENDENTLY RETAINED EMPLOYEE OR SAFETY CONSULTANT SHALL IMPLEMENT A TRENCH SAFETY PROGRAM IN ACCORDANCE WITH OSHA STANDARDS COVERING THE PRESENCE AND ACTIVITIES OF INDIVIDUALS WORKING IN AND AROUND TRENCH EXCAVATIONS.

NOTES

PRIVATE STREET DESIGNATION:

AND IS DESIGNATED AS AN

LOT 999, BLOCK 9, IS A PRIVATE STREET

IRREVOCABLE UNDERGROUND AND

SERVICE FACILITIES EASEMENT FOR

WATER, WASTEWATER, AND RECYCLED

AT-GRADE INFRASTRUCTURE AND

GAS, ELECTRIC, STREET LIGHT,

TELEPHONE, CABLE TELEVISION,

DRAINAGE, PEDESTRIAN, PUBLIC

WATER MAINS.

- CONTRACTOR TO SEE DETAIL SHEET FOR TYPICAL ROAD CROSS-SECTIONS.
 CONTRACTOR SHALL CLEAR AND GRUB THE ENTIRE STREET RIGHT OF WAY WITH THE EXCEPTION OF TREES TO REMAIN AND COORDINATE WITH OWNER AND ENGINEER TO SELECT CLEAR P.U.E. WHERE APPLICABLE FOR DRY UTILITY INSTALLATION.
- 3. CONTRACTOR TO GRADE OR REGRADE ALL AREAS WITHIN ROAD ROW INCLUDING DITCHES FOR POSITIVE DRAINAGE.
- 4. CONTRACTOR SHALL GRADE TO DRAIN AREAS UPSTREAM AND DOWNSTREAM OF ALL PROPOSED CHANNELS.
- 5. CONTRACTOR TO COORDINATE WITH DEVELOPER REGARDING TREE WELLS TO ENSURE TREES TO REMAIN ARE SAVED. CONTRACTOR TO REFERENCE LANDSCAPE PLANS FOR TREE WELL FINISHES.
- 6. CONTRACTOR SHALL HYDROMULCH OR WOODMULCH ALL DISTURBED AREAS, INCLUDING RIGHT-OF-WAY, STEEP SLOPES, DRAINAGE DITCHES WHERE SOIL SUBGRADE IS ENCOUNTERED. CONTRACTOR SHALL BE RESPONSIBLE FOR PROVIDING SUFFICIENT WATERING IN HYDROMULCH AREAS TO ESTABLISH VEGETATION.
- ALL TRAFFIC CONTROL DEVICES AND PAVEMENT MARKINGS SHALL BE IN
 ACCORDANCE WITH THE LATEST EDITION OF THE TEXAS MANUAL ON UNIFORM
 TRAFFIC CONTROL DEVICES. ALL STRIPING TO BE THERMOPLASTIC.
 ALL DIMENSIONS ARE TO FACE OF CURB UNLESS OTHERWISE NOTED.

SIDEWALKS ADJACENT TO SINGLE FAMILY LOTS ARE TO BE CONSTRUCTED CONCURRENTLY WITH EACH SINGLE FAMILY HOUSE BY THE HOME BUILDER.

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DESCRIPTION
DESCRIPTION
DESCRIPTION

AND PROFILE

IN VALLEY PLAN AND

DAVID R. BABINEAUX


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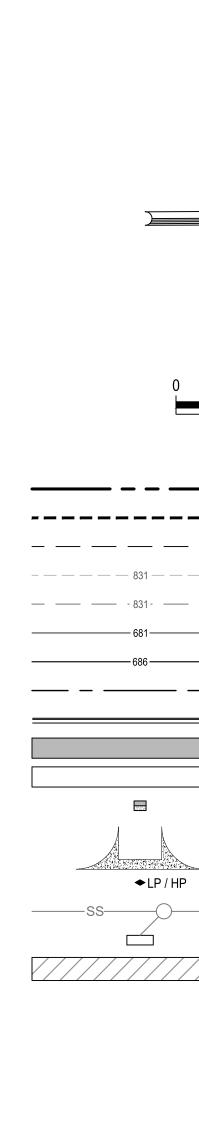
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24-11800389

DESIGNED BY:

REVIEWED BY:

DRAWN BY:

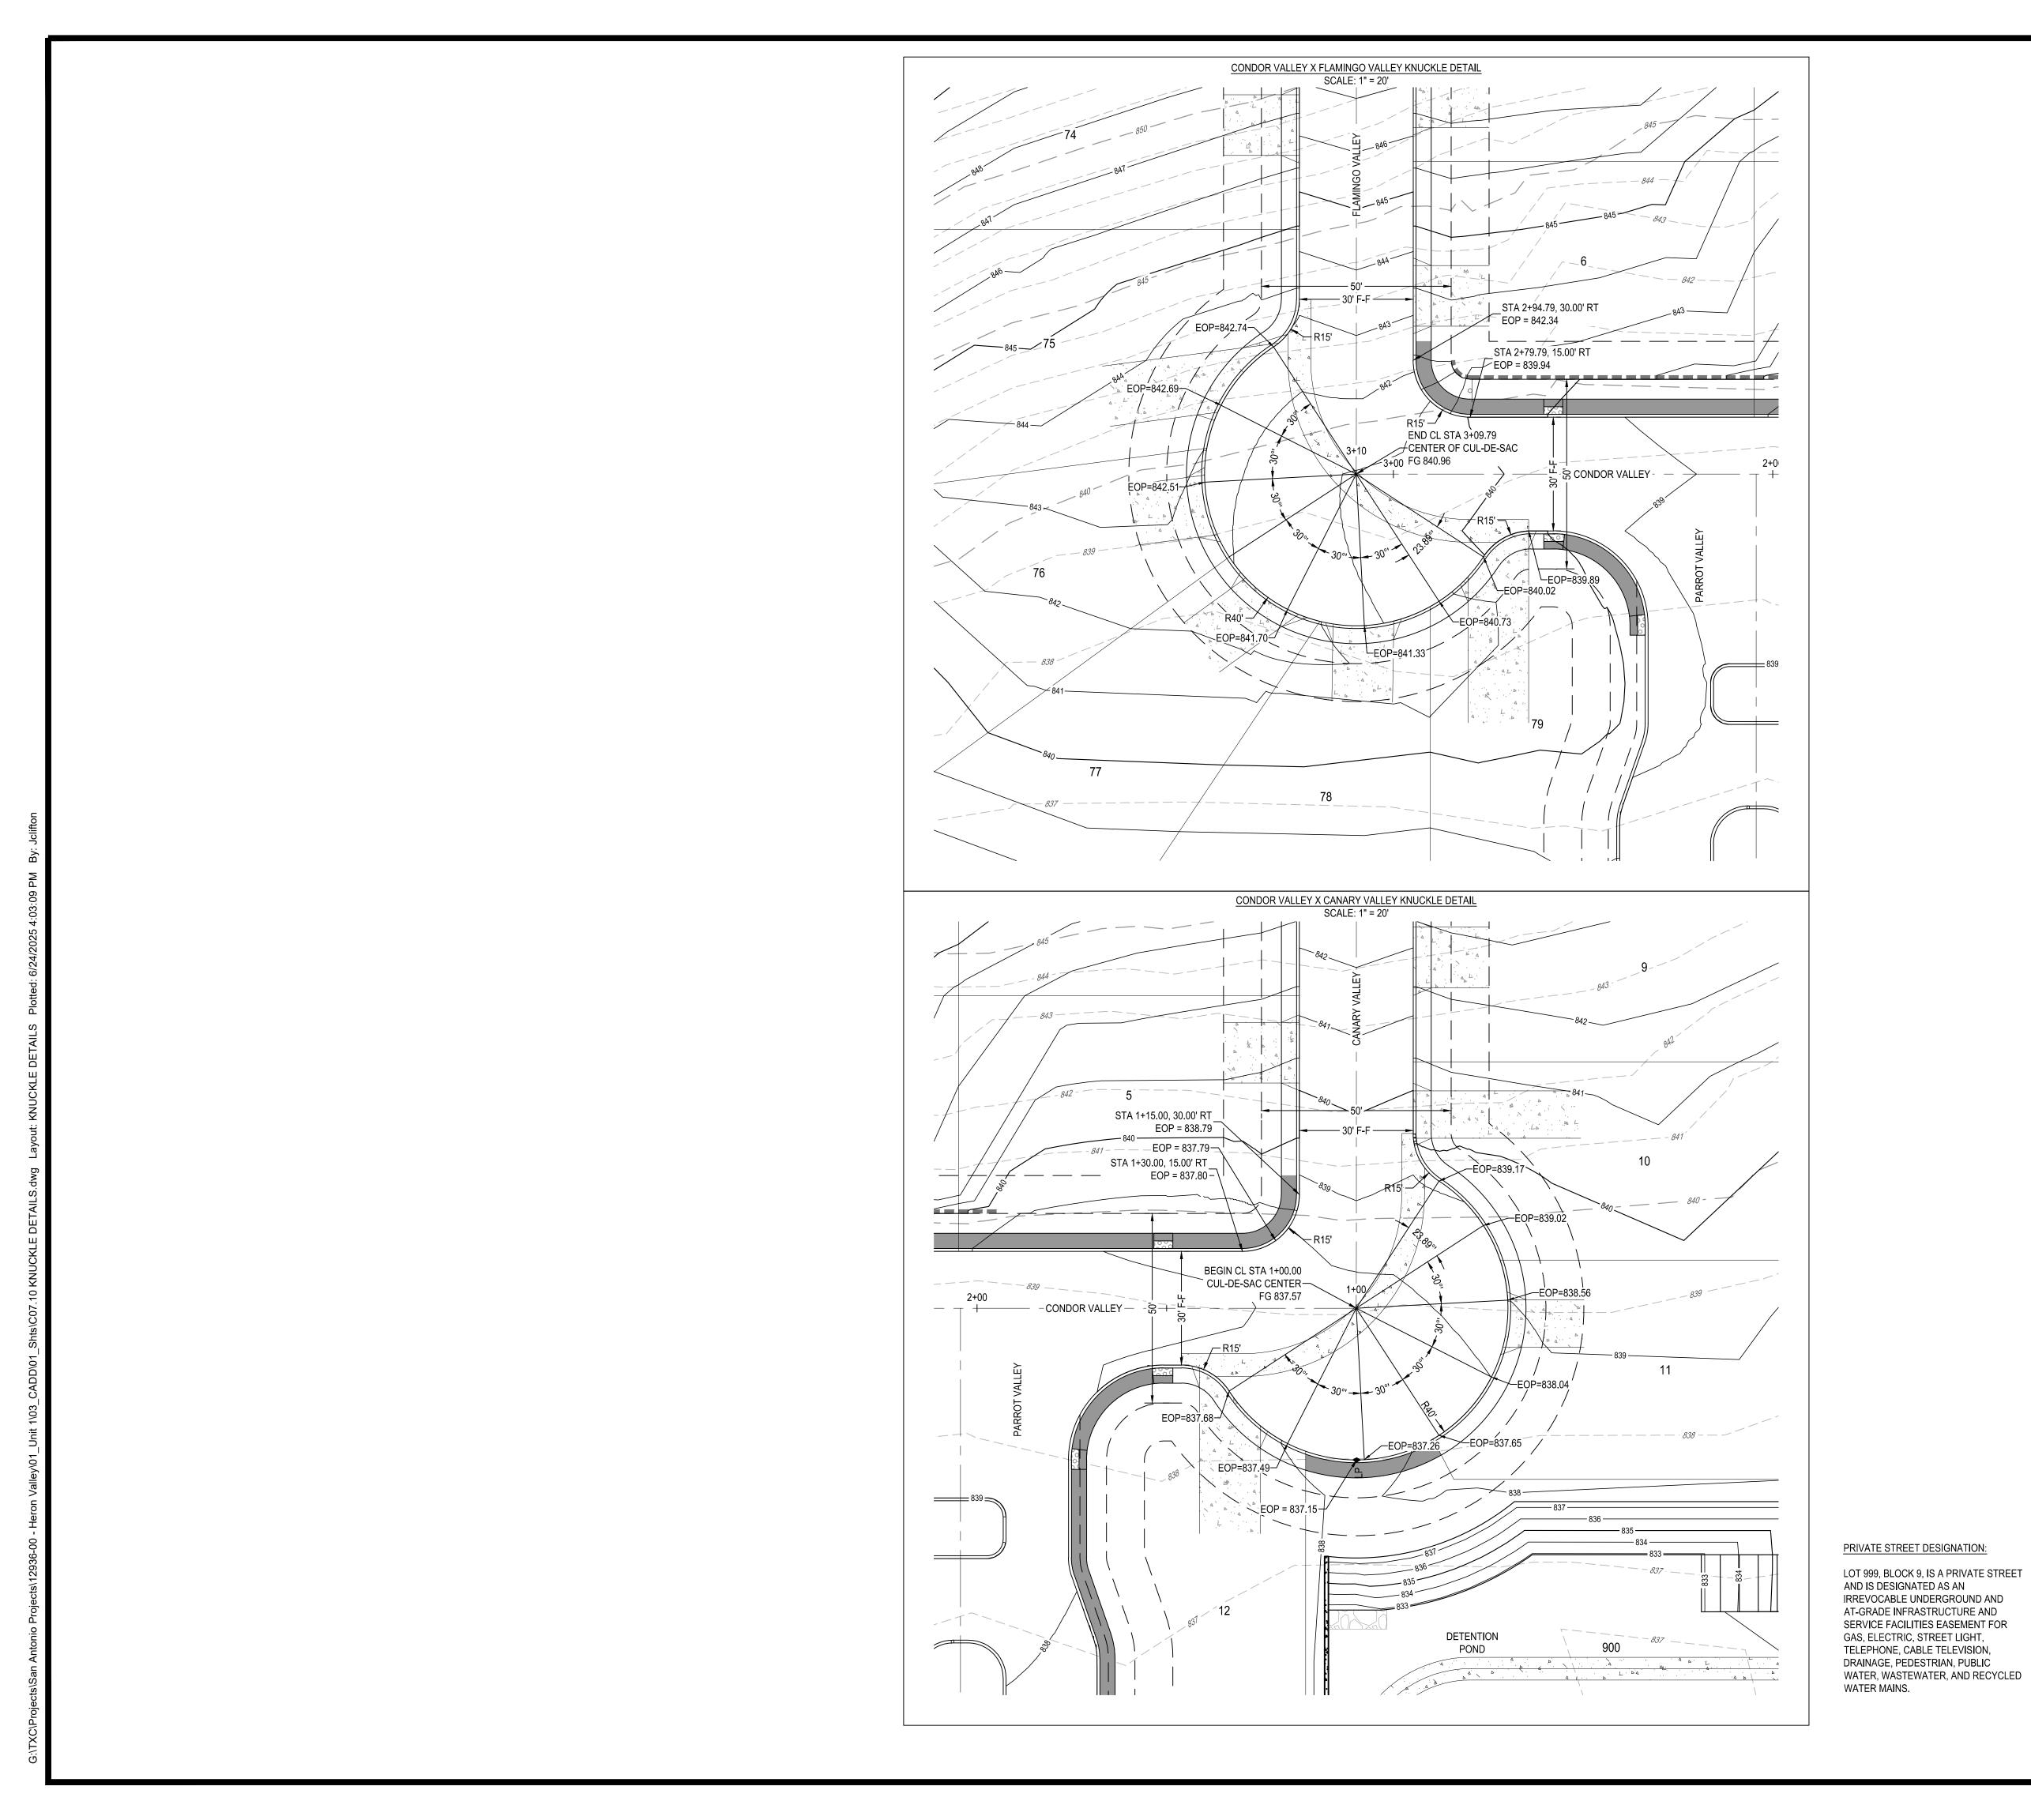

<u>LEGEND</u>

PHASE BOUNDARY

PROPOSED EASEMENT

EXISTING MINOR CONTOUR

EXISTING MAJOR CONTOUR

PROPOSED MINOR CONTOUR

PROPOSED MINOR CONTOUR

PROPOSED MAJOR CONTOUR

ROAD CENTERLINE

PROPOSED CURB & GUTTER

CONTRACTOR SIDEWALK

HOME BUILDER SIDEWALK

HOME BUILDER SIDEWALK

TYPICAL RAMP (SEE SHEET C08.24)

ASPHALT VALLEY GUTTER

LOW POINT/HIGH POINT
PROPOSED STORM LINE WITH
MANHOLE
PROPOSED CURB INLET

PROPERTY BOUNDARY

WASHOUT AREA

CONTRACTOR SHALL ENSURE THAT PROPOSED A.D.A. RAMPS AND ACCESSIBLE ROUTES ALONG ROAD CROSSING COMPLY WITH SPECIFICATIONS FOR BOTH RUNNING SLOPE AND CROSS SLOPE.

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 CONCURRENTLY WITH EACH SINGLE FAMILY HOUSE BY THE HOME BUILDER.

DAVID R. BABINEAUX

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SHEET C07.10

PLAT NUMBEI 24-11800389

DESIGNED BY: ####

REVIEWED BY: #### DRAWN BY:


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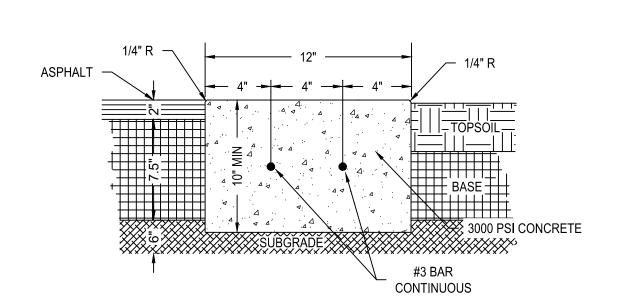
SAW CUT AT HOT MIX ASPHALTIC CONCRETE EXISTING PAVEMENT TACK COAT FLEXIBLE BASE **EXISTING SUBGRADE**

MATCH EXISTING PAVEMENT N.T.S.


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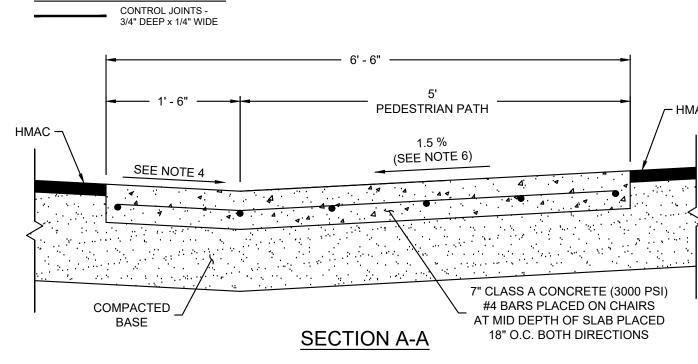
SUBGRADE



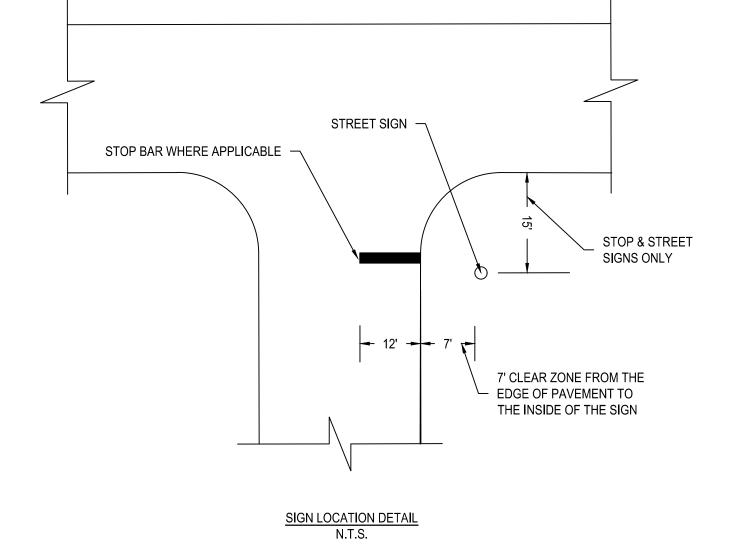

1. REINFORCING STEEL SHALL BE GRADE 60 DEFORMED BARS CONFORMING TO ASTM A 615/A 615M OR ASTM A 706/A 706M. 2. WIRE TIES SHALL BE 16 GAUGE OR HEAVIER BLACK ANNEALED STEEL




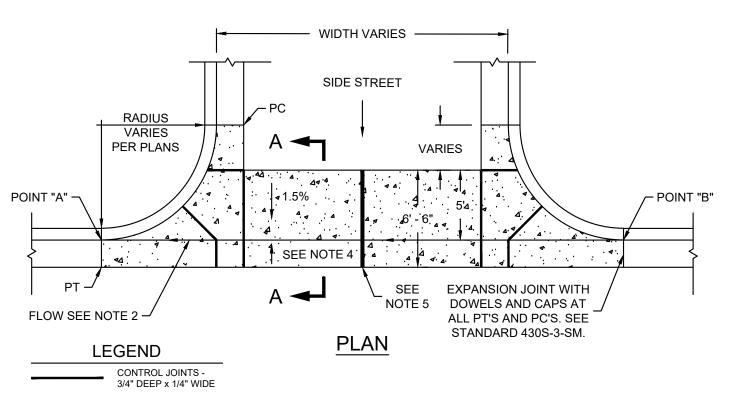

NOTES:

- 1. MONOLITHIC CURB AND GUTTER SHALL BE MEASURED BY PLAN QUANTITY PER SQUARE FEET AND PAID AS
- 2. MINIMUM SLOPE FROM POINT "A" TO POINT "B" SHALL BE 0.50%.
- 3. ALL CONTROL JOINT WILL BE TOOL JOINT OR SAW CUT WITH WALK BEHIND SAW. 4. MATCH CROSS-SLOPE OF ROAD 2% TYPICAL ~ 1.5% MIN. OR 3% MAX.
- 5. INSTALL COLD JOINT IF NEEDED TO MAINTAIN TRAFFIC. SEE DETAIL 420S-3-SM. 6. IF A PEDESTRIAN PATH IS NOT REQUIRED, THE SLOPE MAY ME ADJUSTED TO MATCH THE ROAD OR 6% MAX,

CONCRETE VALLEY GUTTER

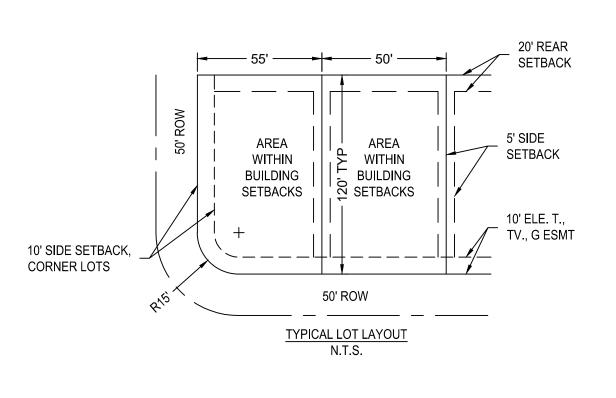


SURFACE COURSE*


VALUES AND RECOMMENDATIONS THAT SHALL BE USED ARE FOUND IN THE ABOVE REFERENCED GEOTECHNICAL INVESTIGATION REPORT. CONTRACTOR SHALL REFERENCE THE RECOMMENDATIONS CONTAINED WITHIN THE GEOTECHNICAL INVESTIGATION REPORTS PREPARED BY:

PROJECT NO. 12-22-0015


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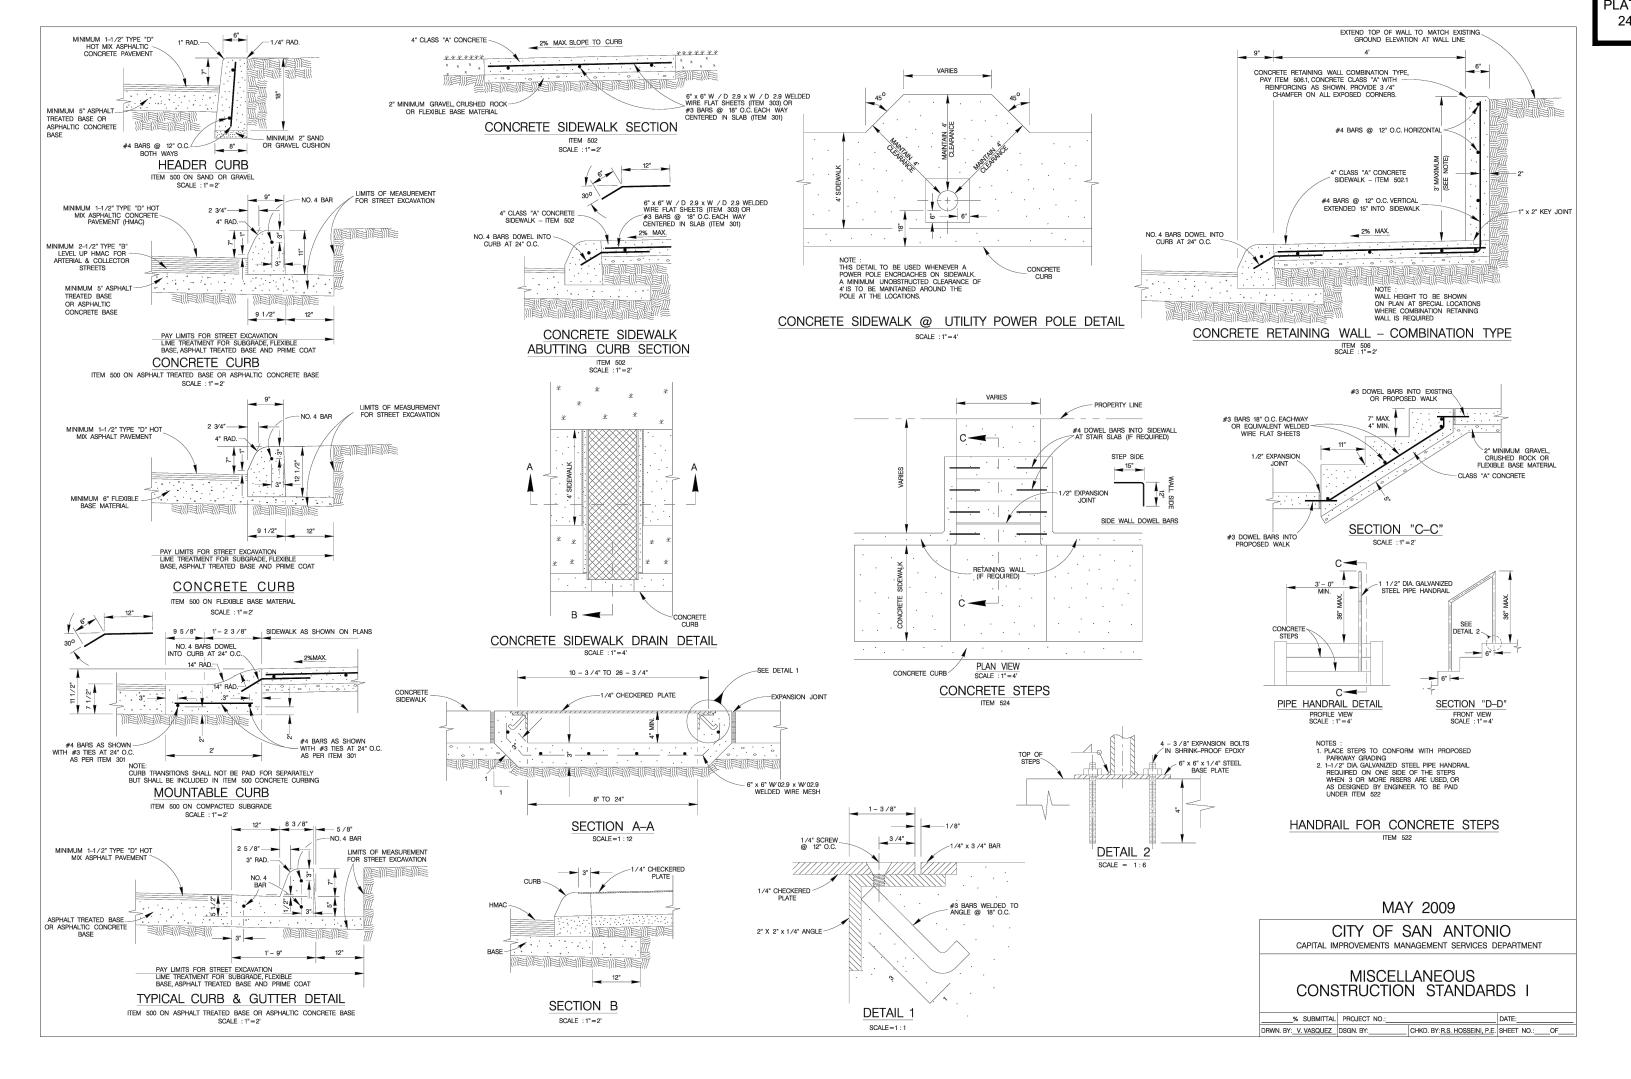
 $\frac{\text{TYPICAL PAVEMENT DETAIL}}{\text{N.T.S.}}$




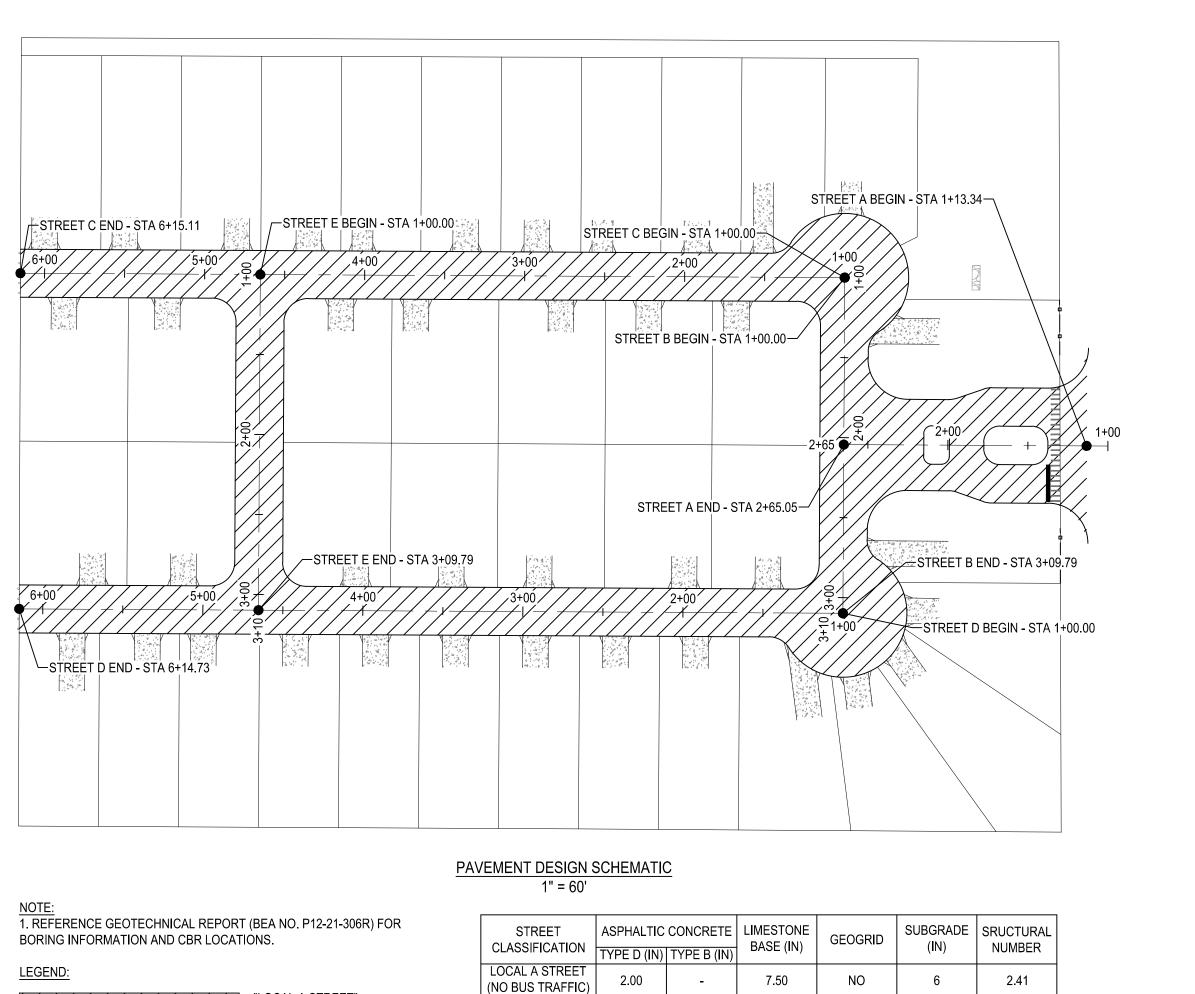

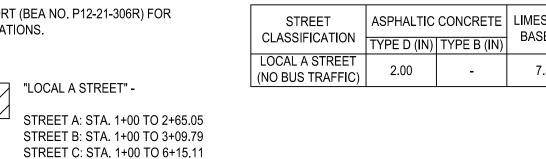
STREET D: STA. 1+00 TO 6+14.73 STREET E: STA. 1+00 TO 3+09.79




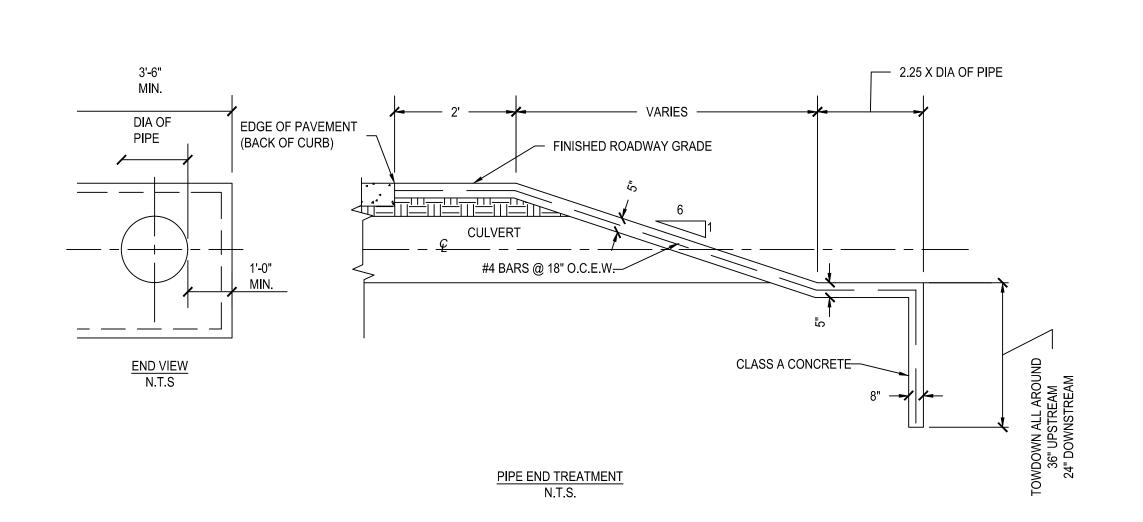


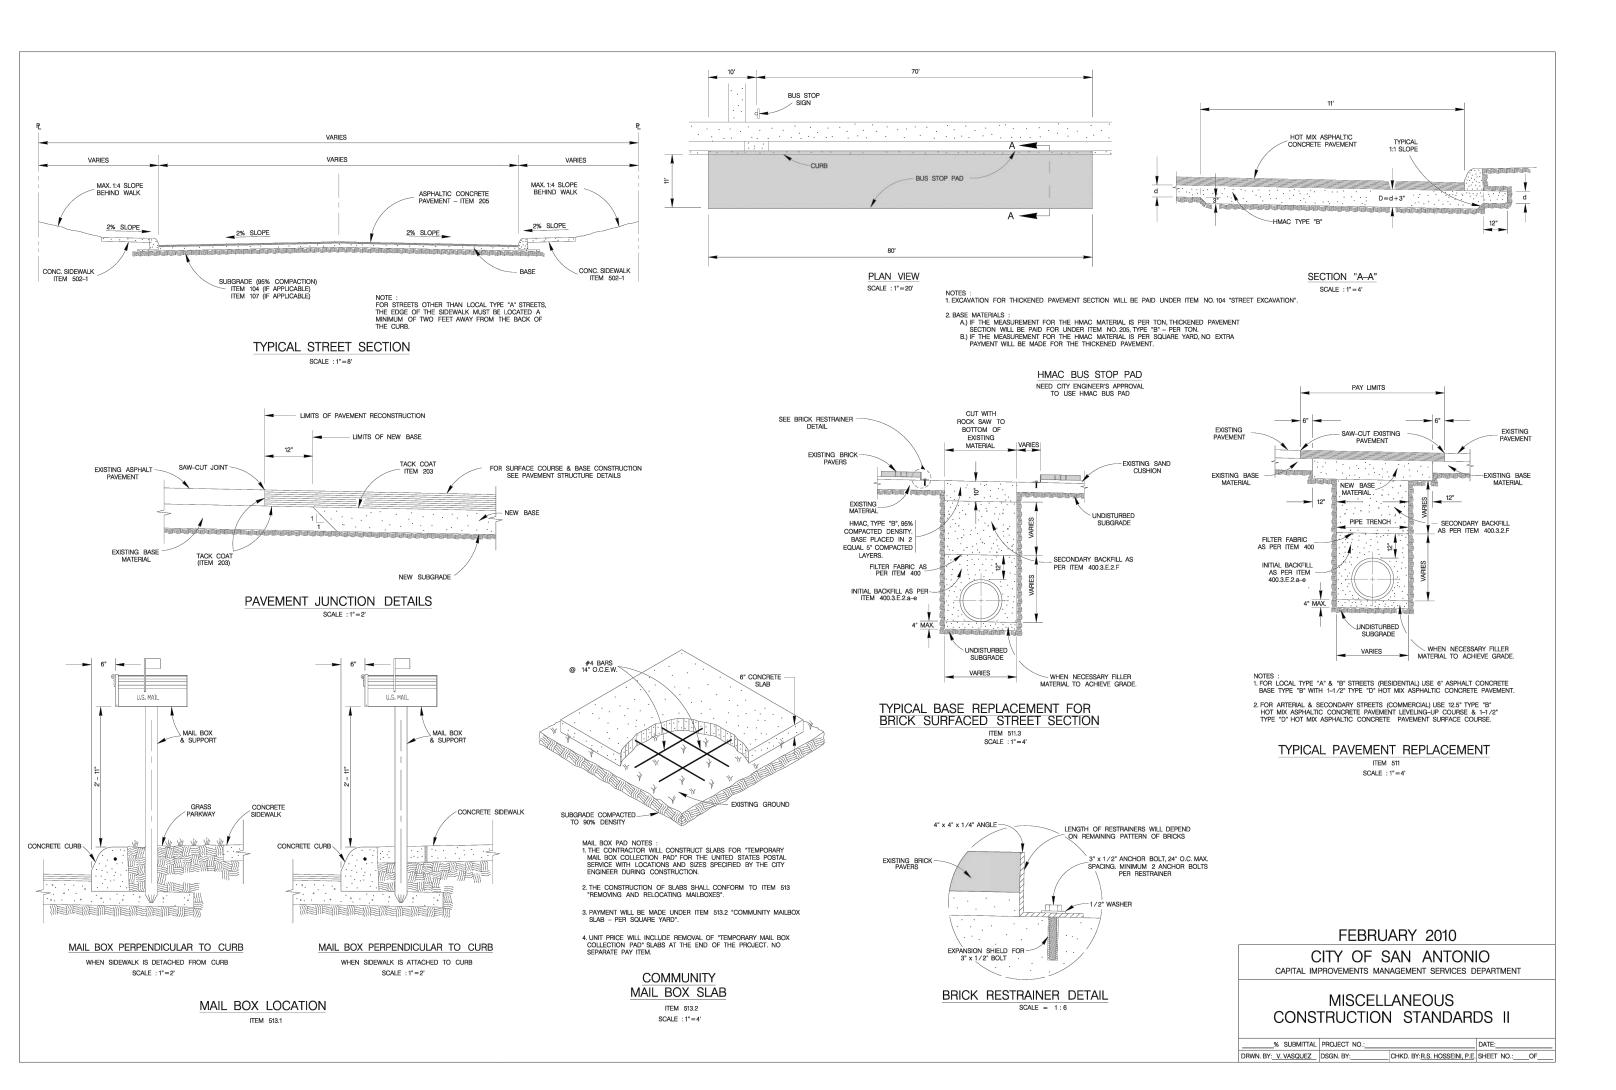

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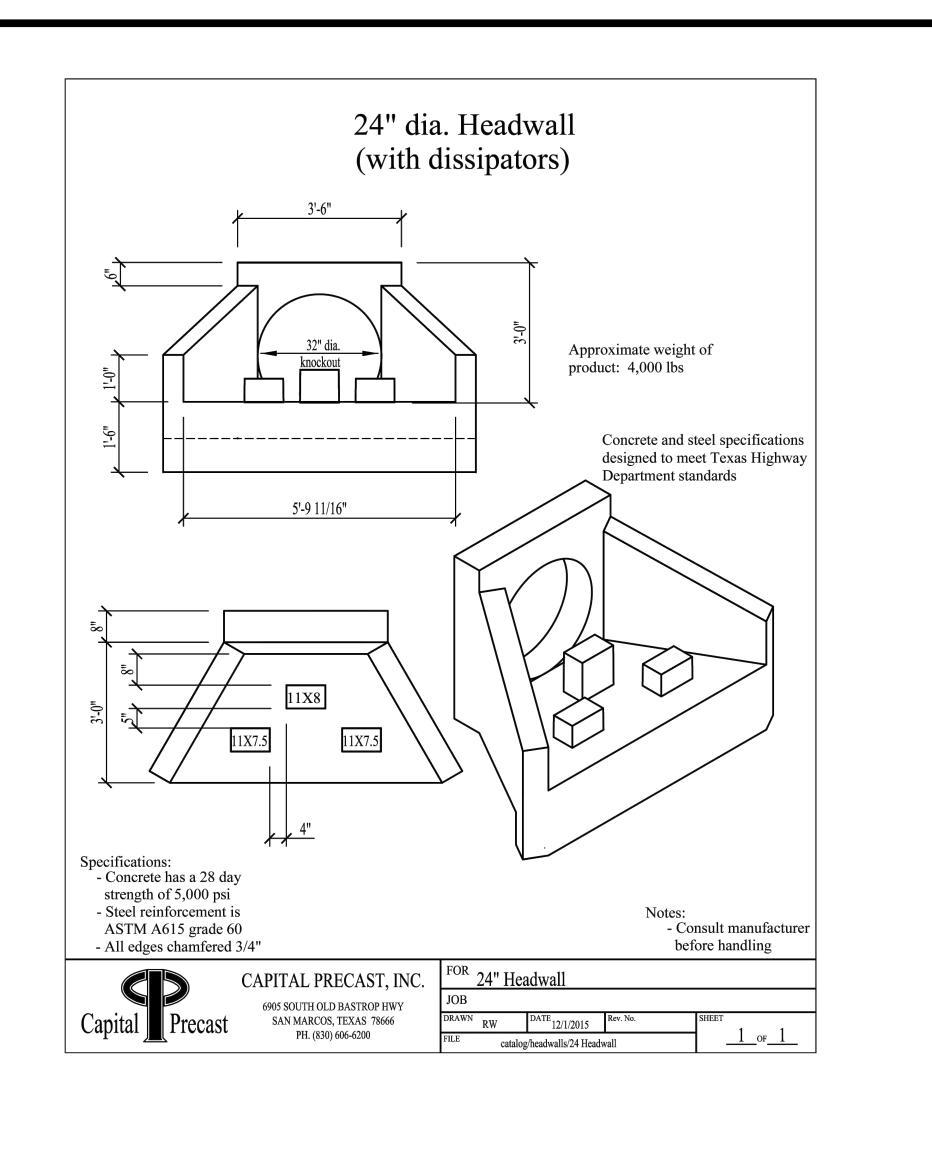


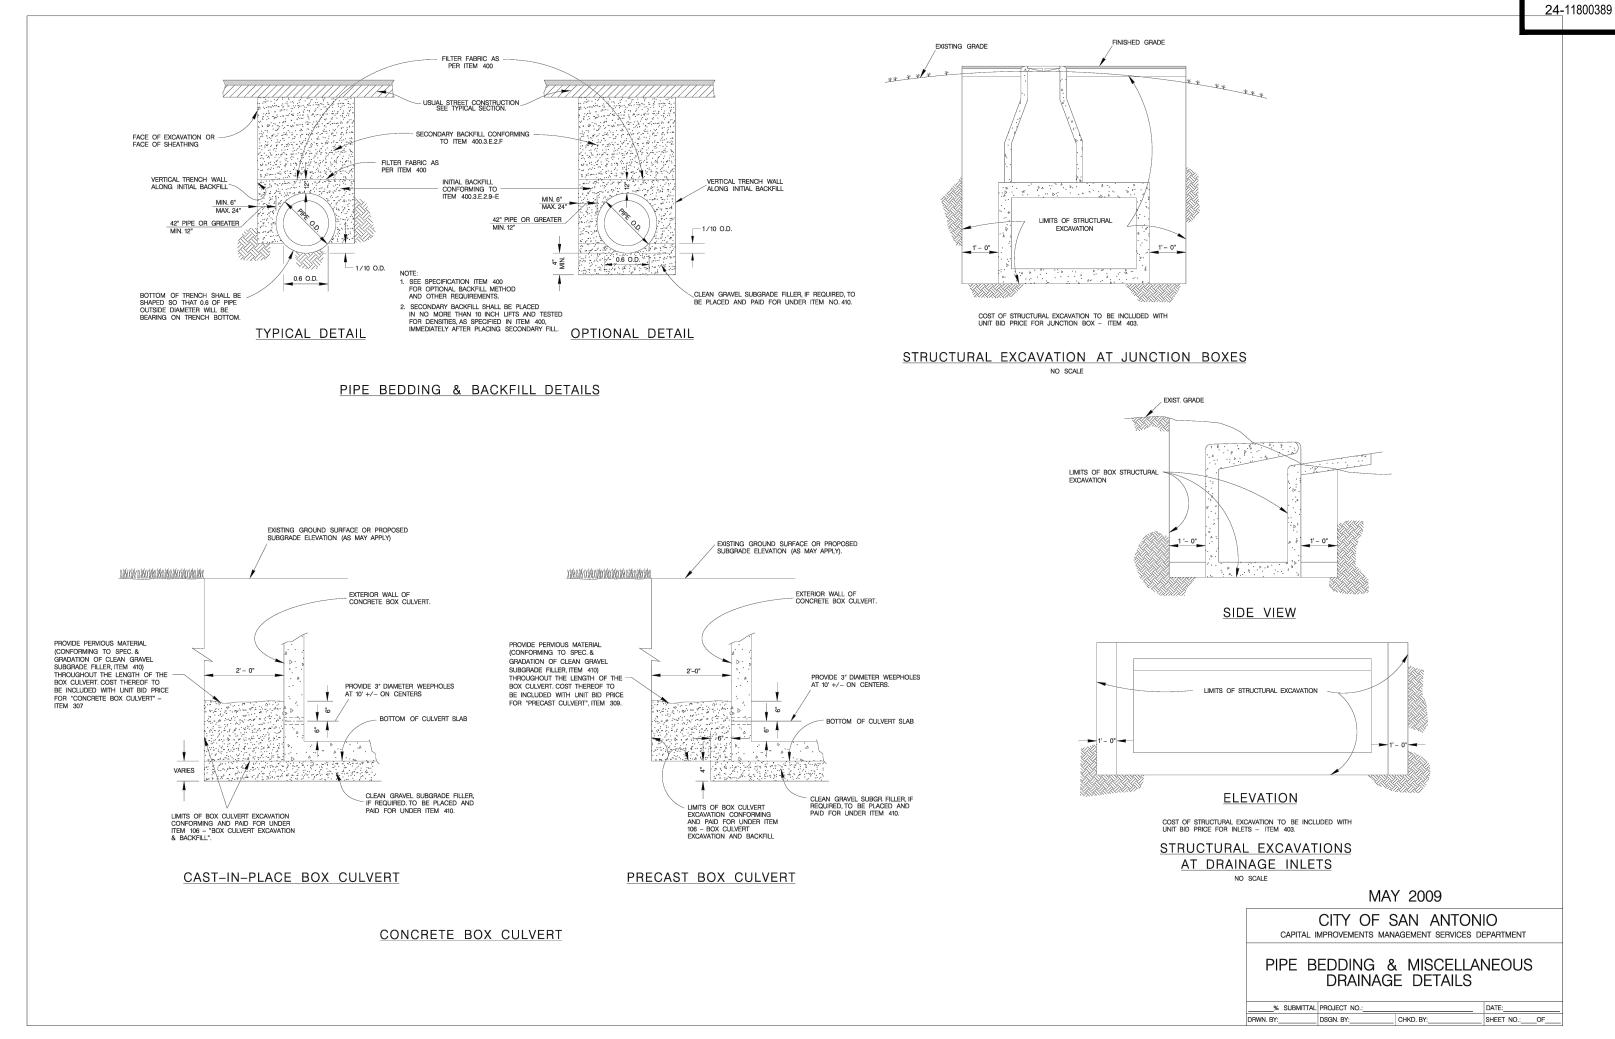
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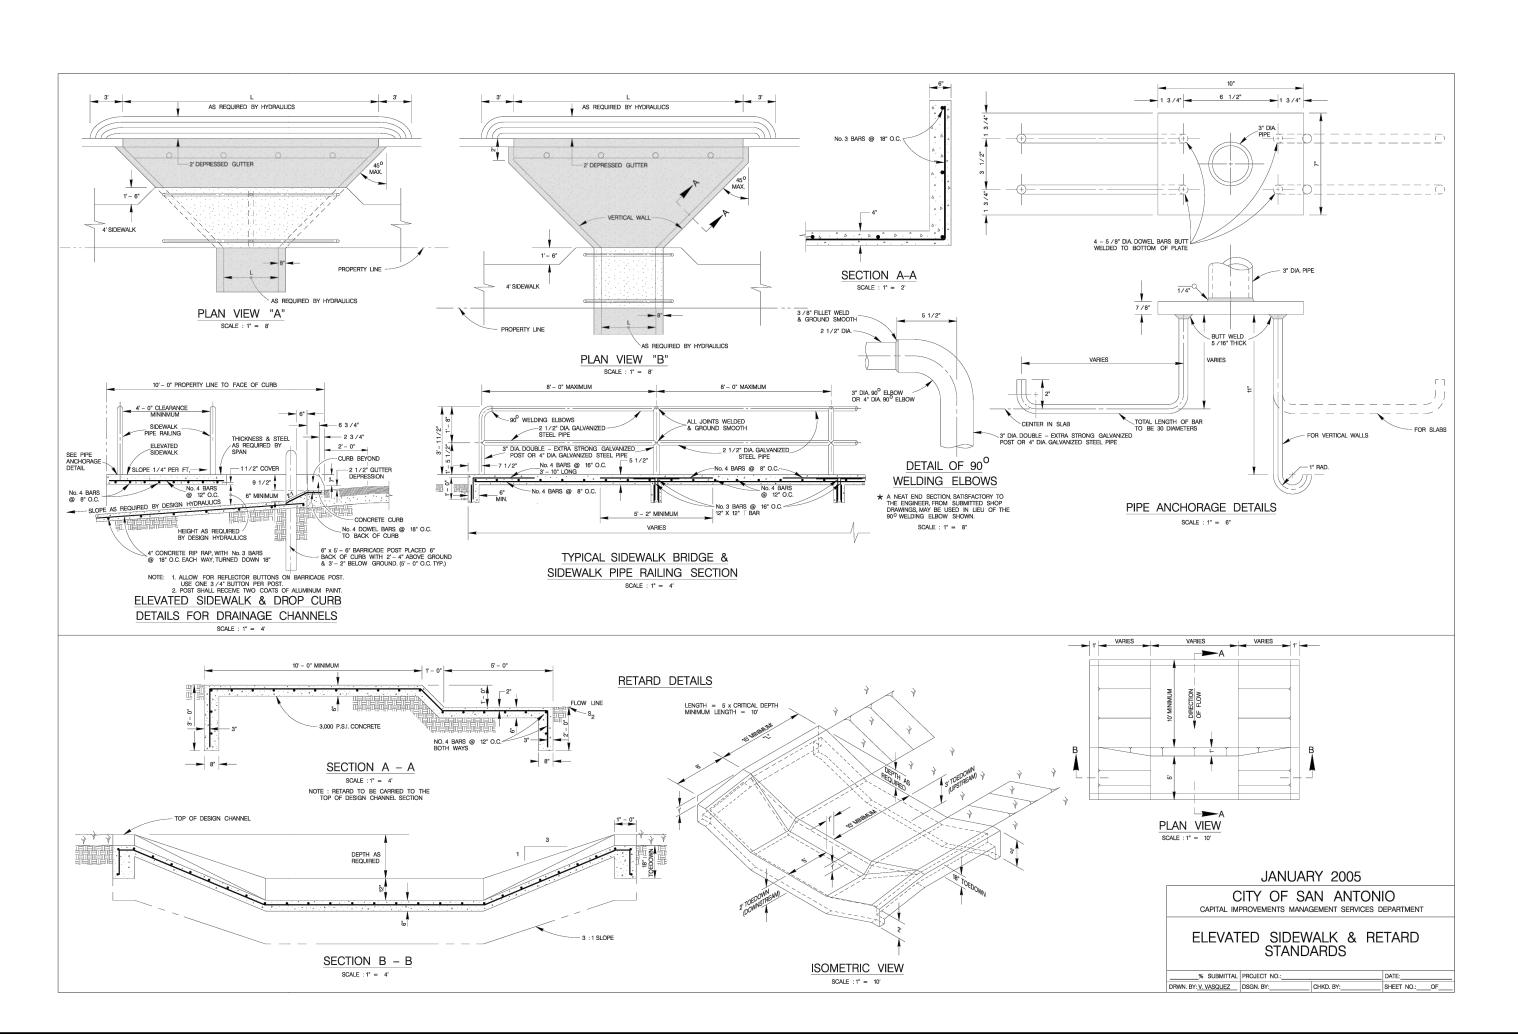
DAVID R. BABINEAUX

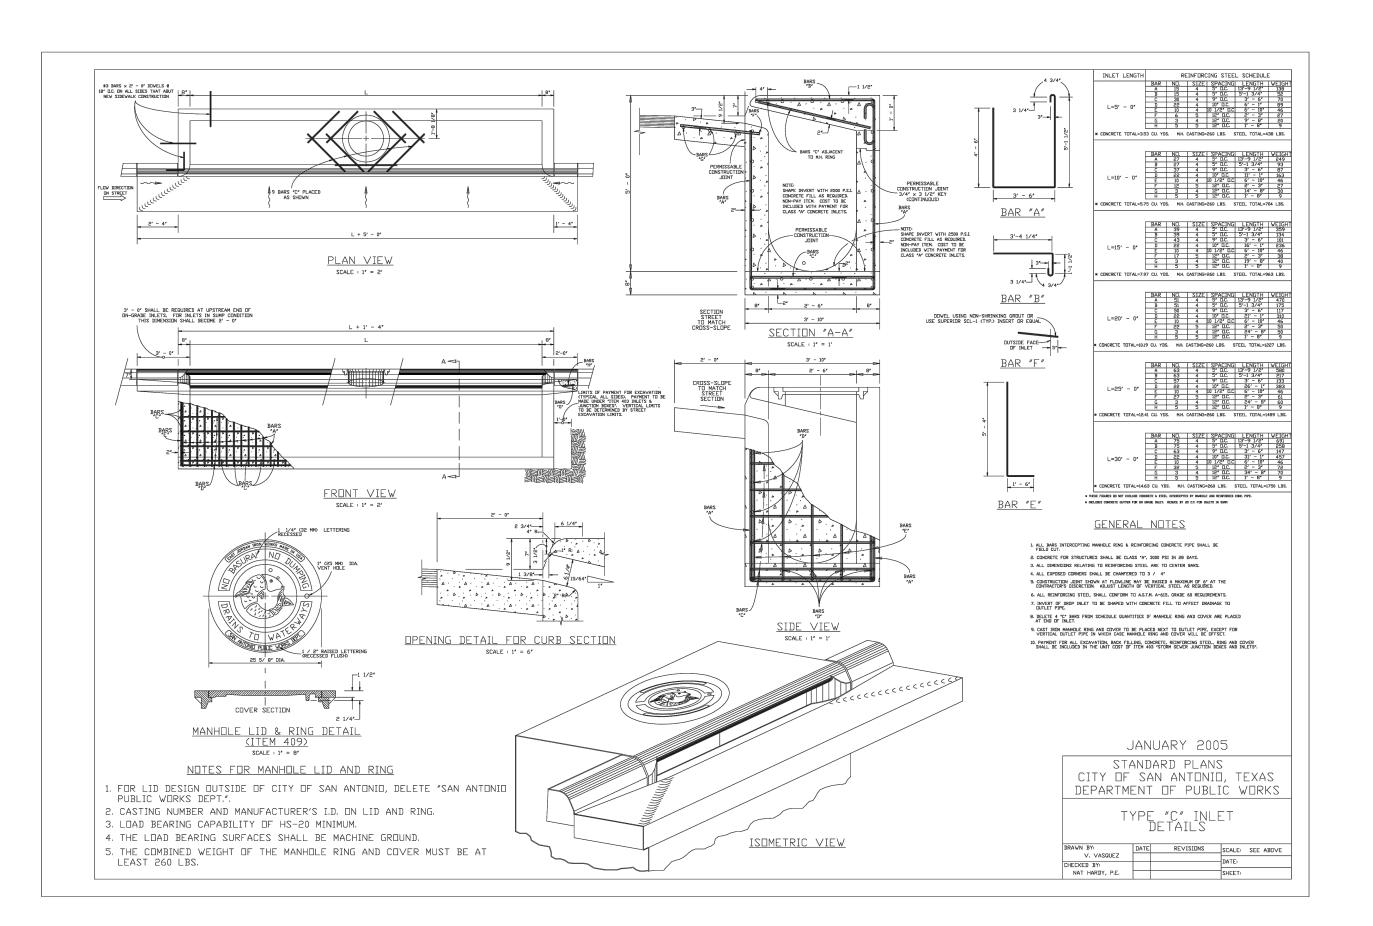
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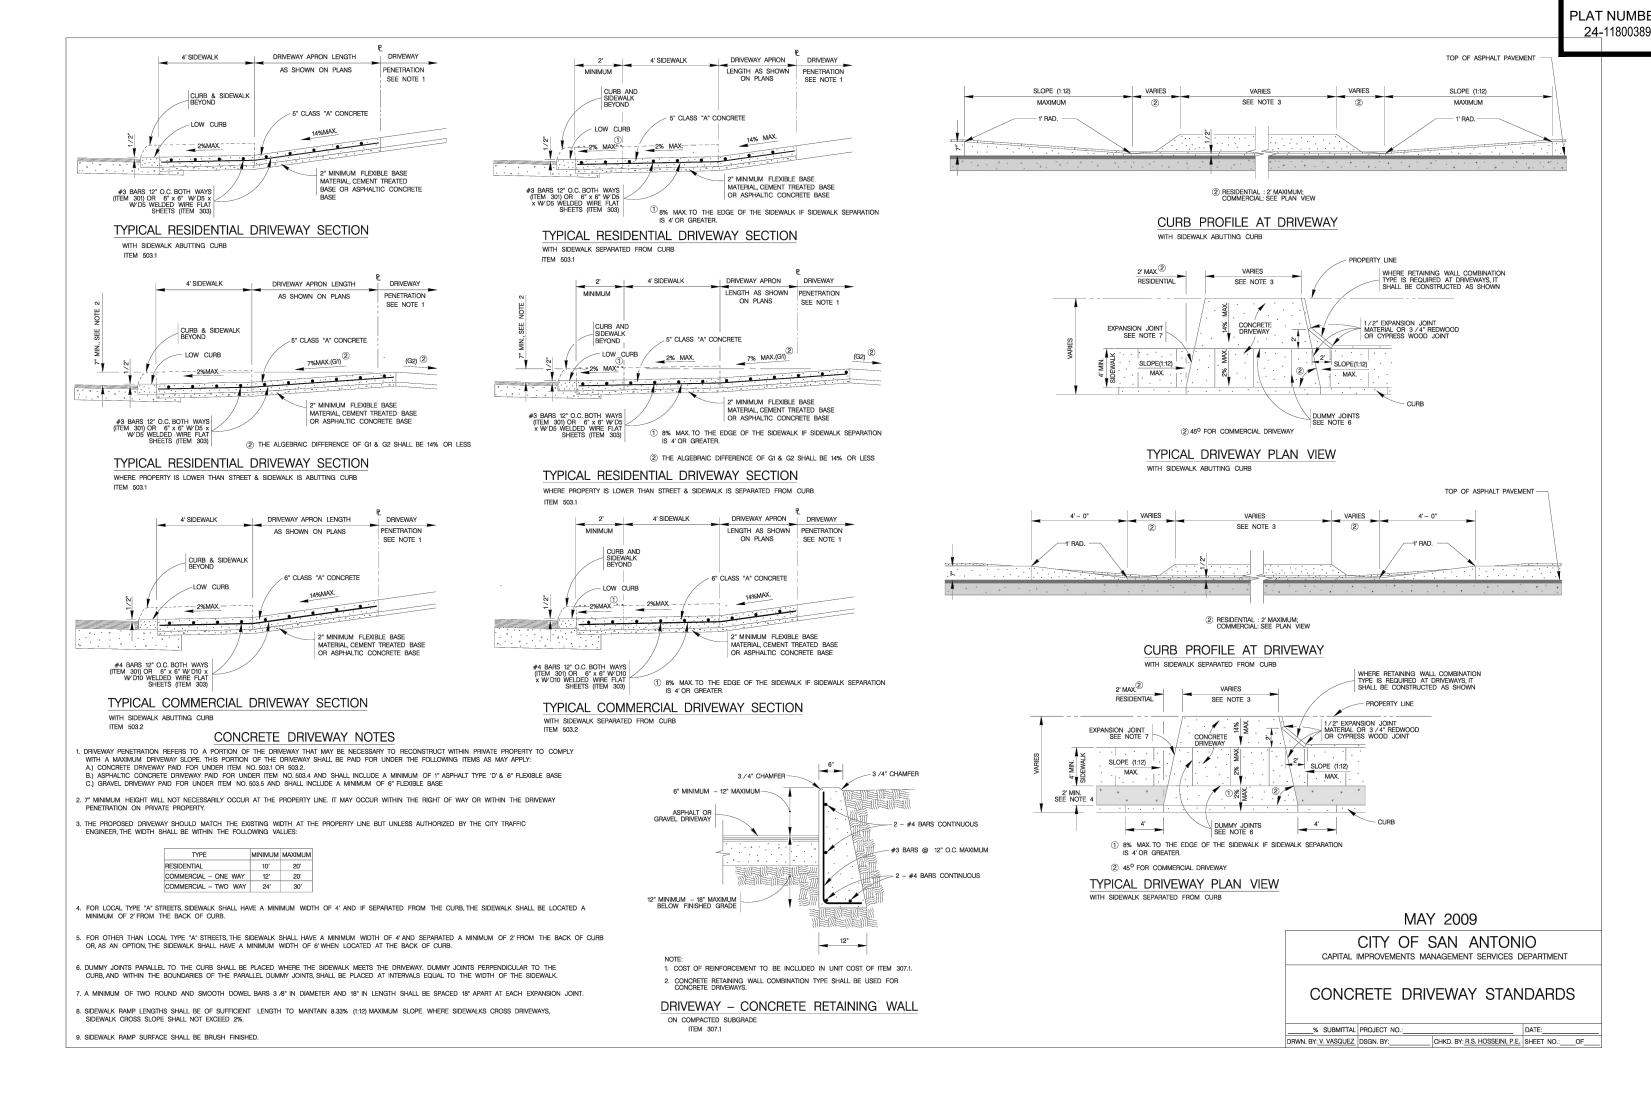
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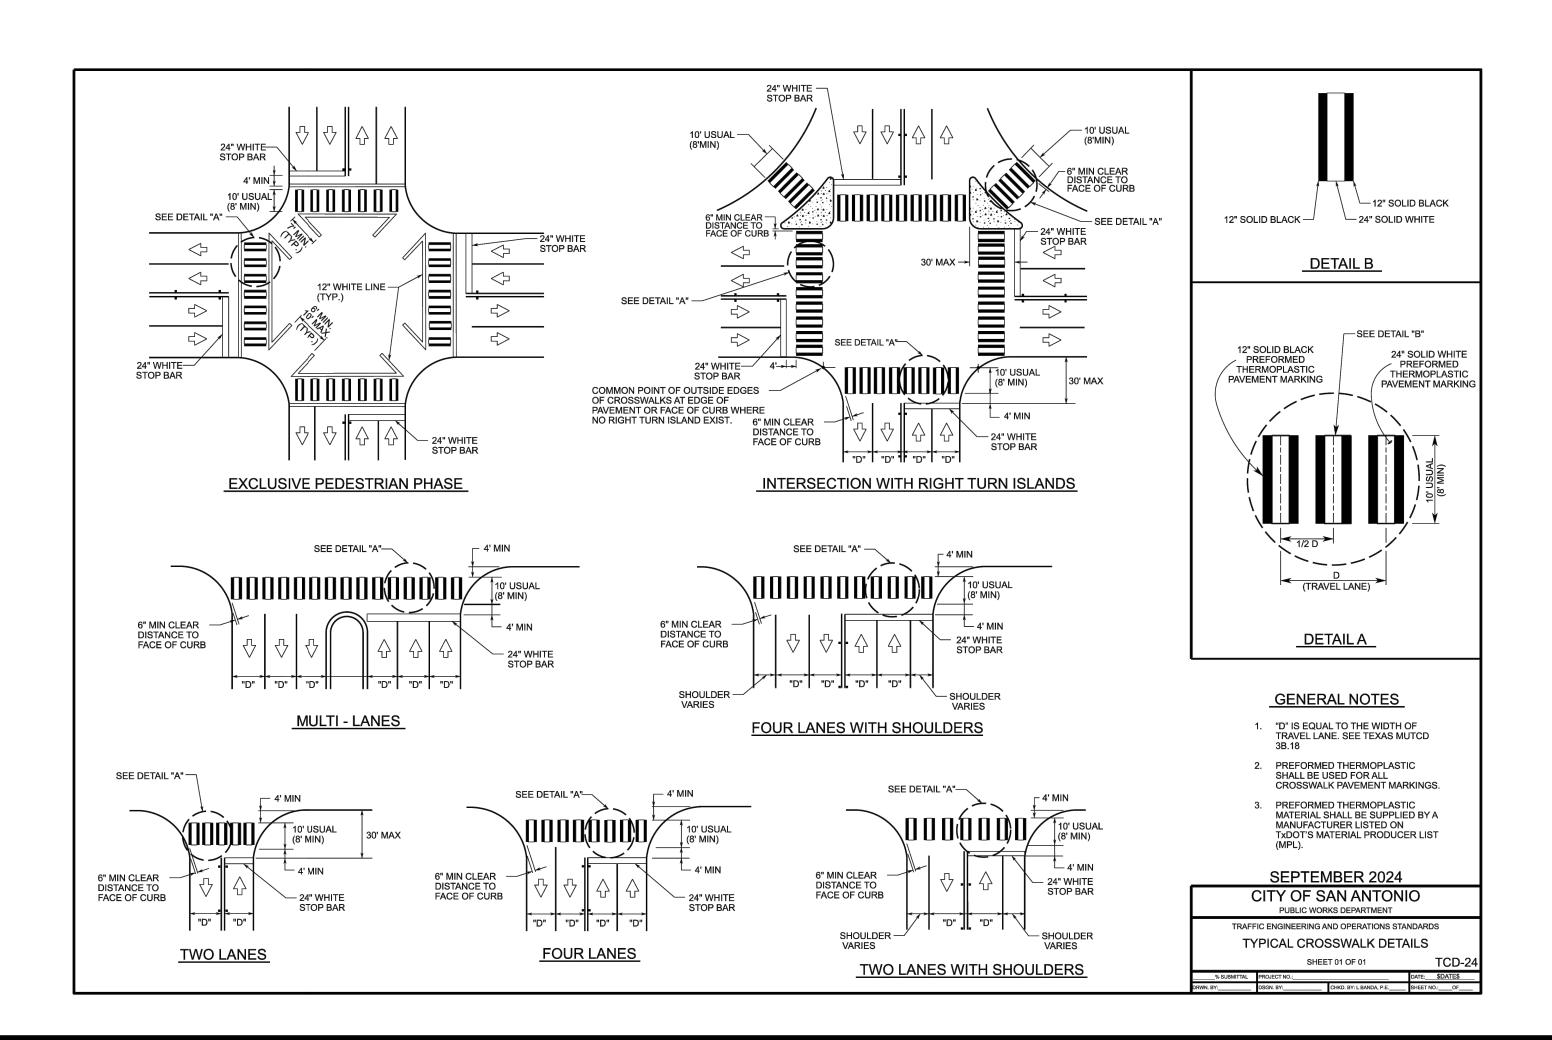


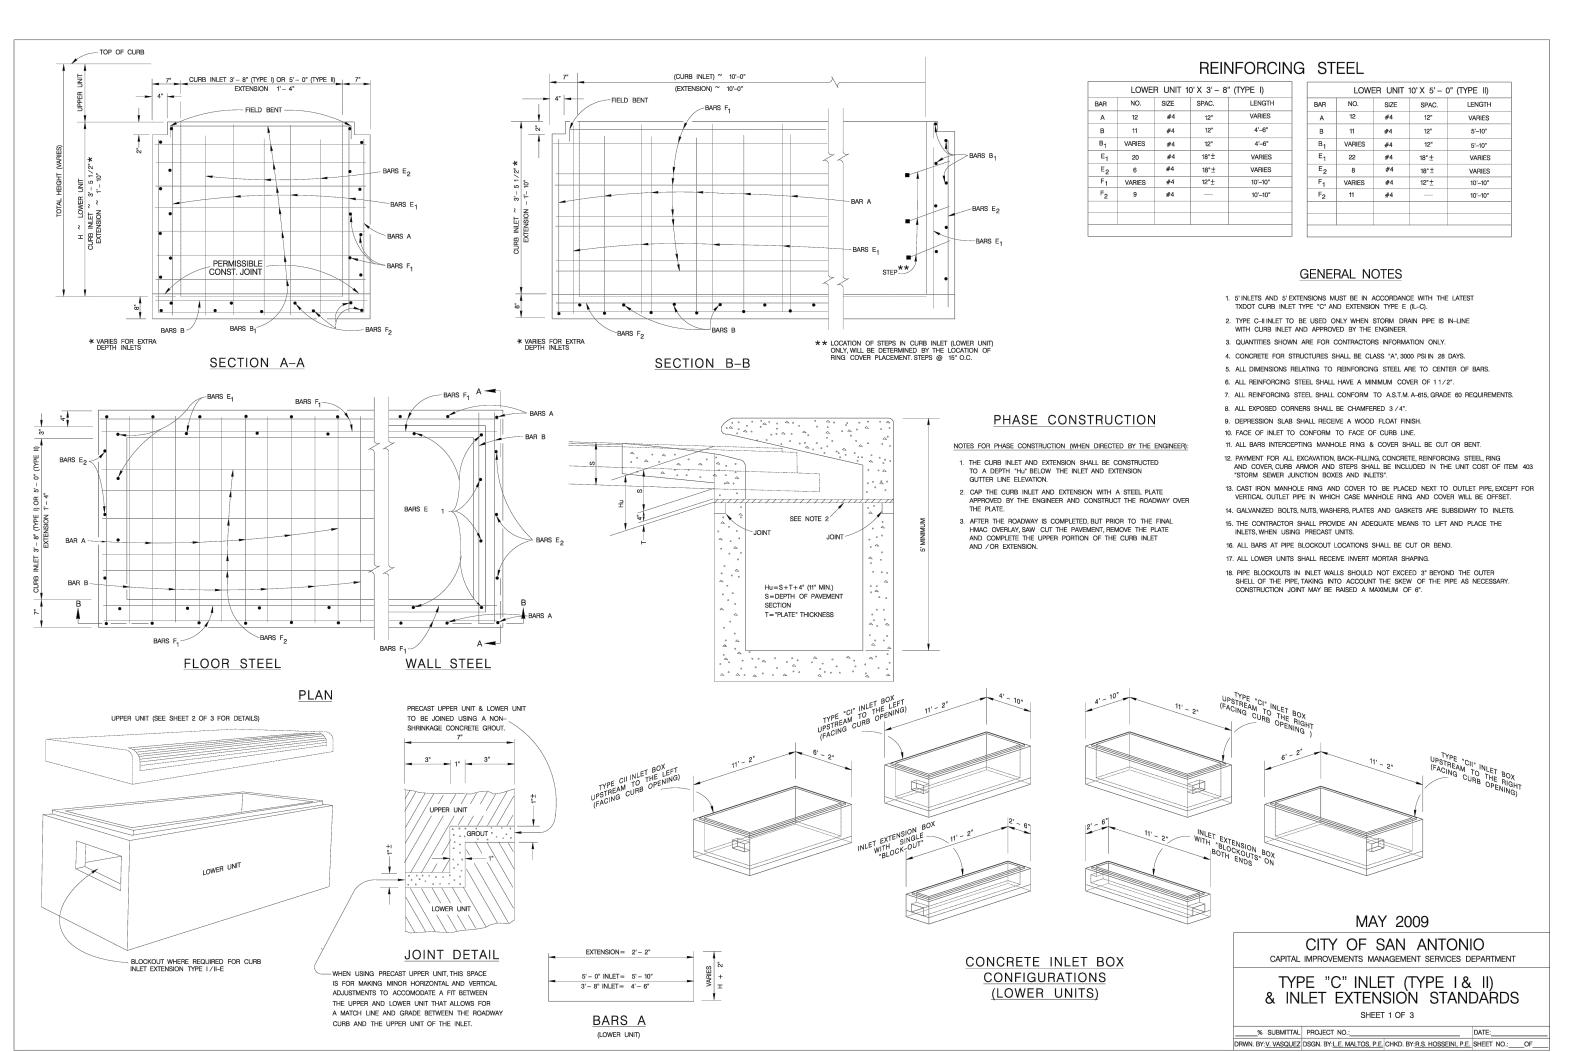






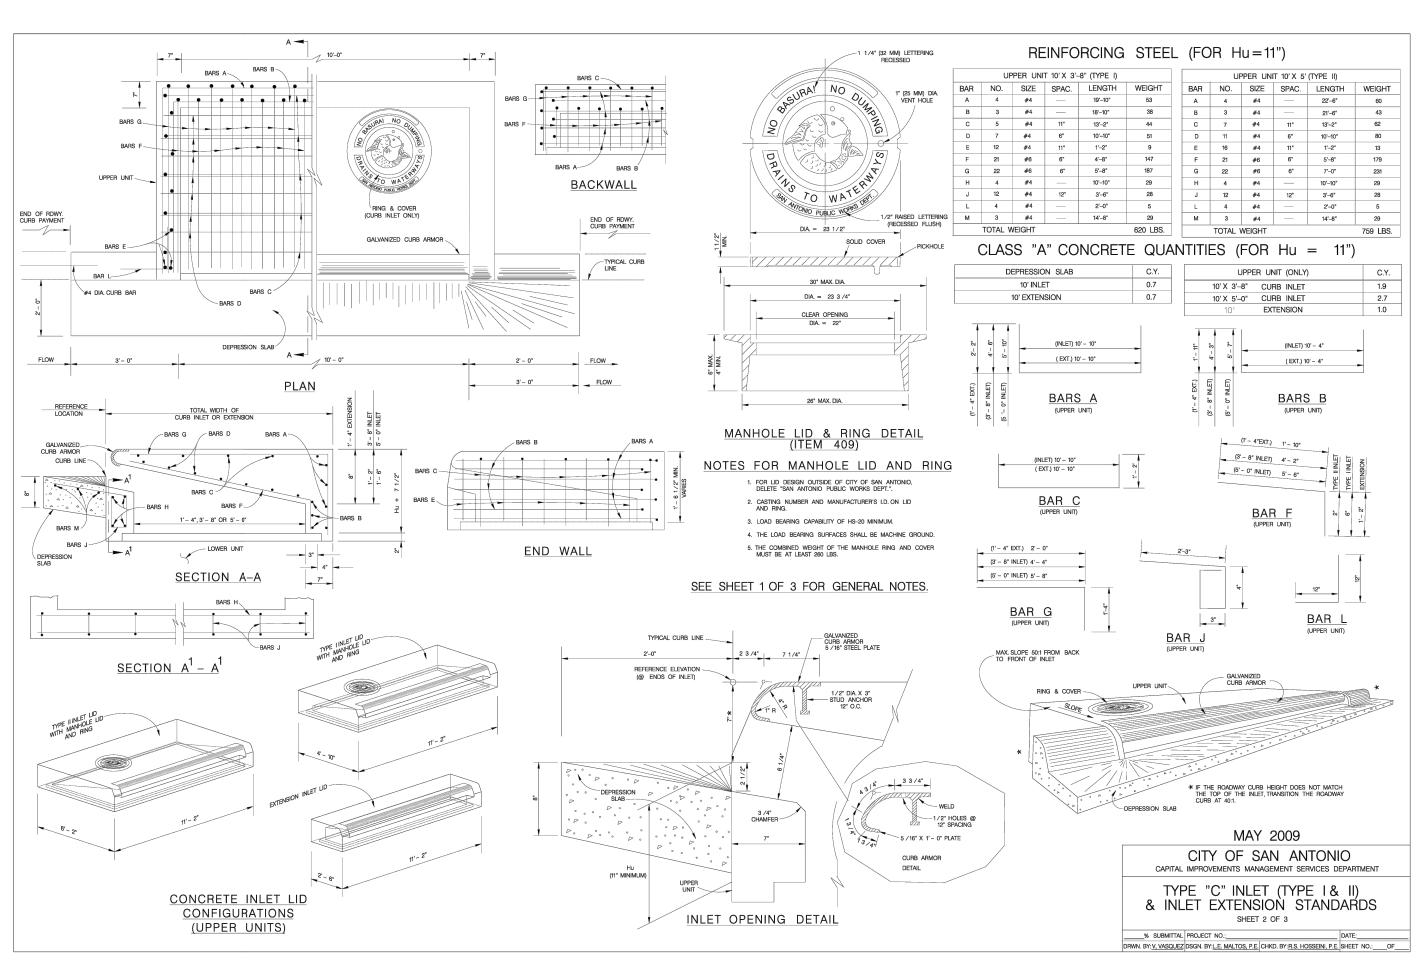

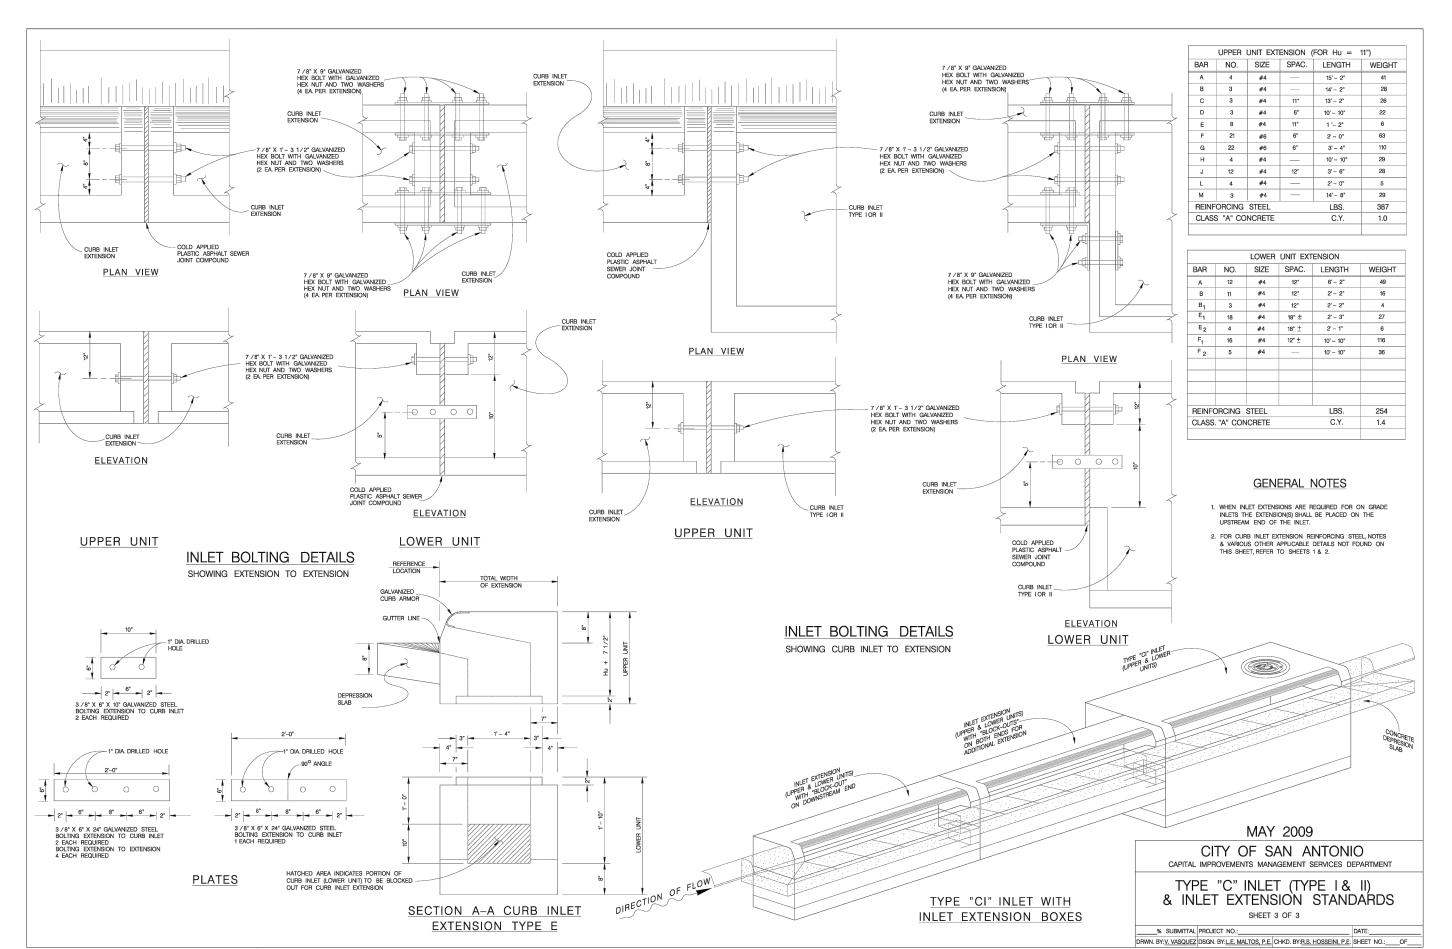

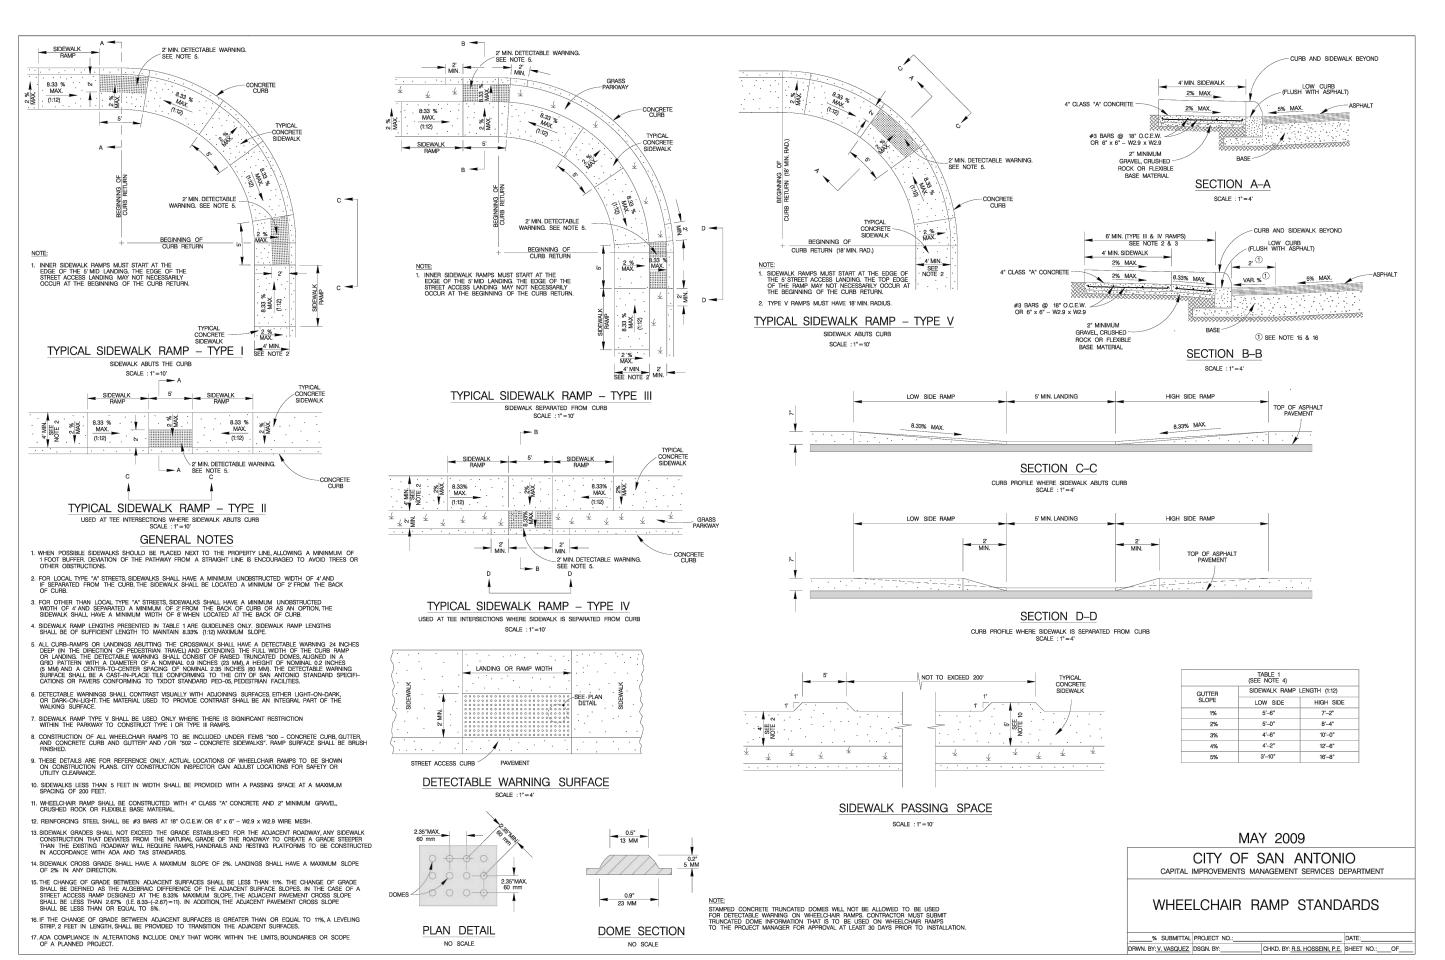



DAVID R. BABINEAUX


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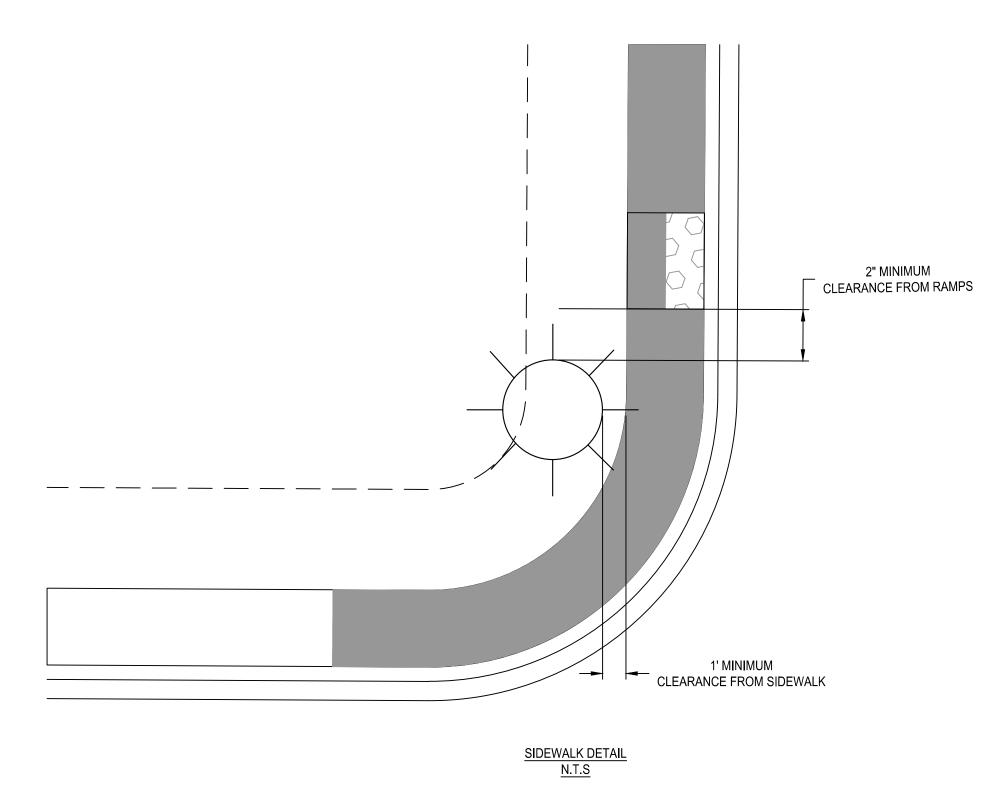
PLAT NUMBEI 24-11800389 DESIGNED BY: REVIEWED BY: OR DRAWN BY: $\overline{}$ \triangleleft \exists

DAVID R. BABINEAUX


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NOTE: LIGHT POST TO BE PLACED CLEAR OF ALL SIDEWALK, RAMPS, AND FIRE HYDRANTS.



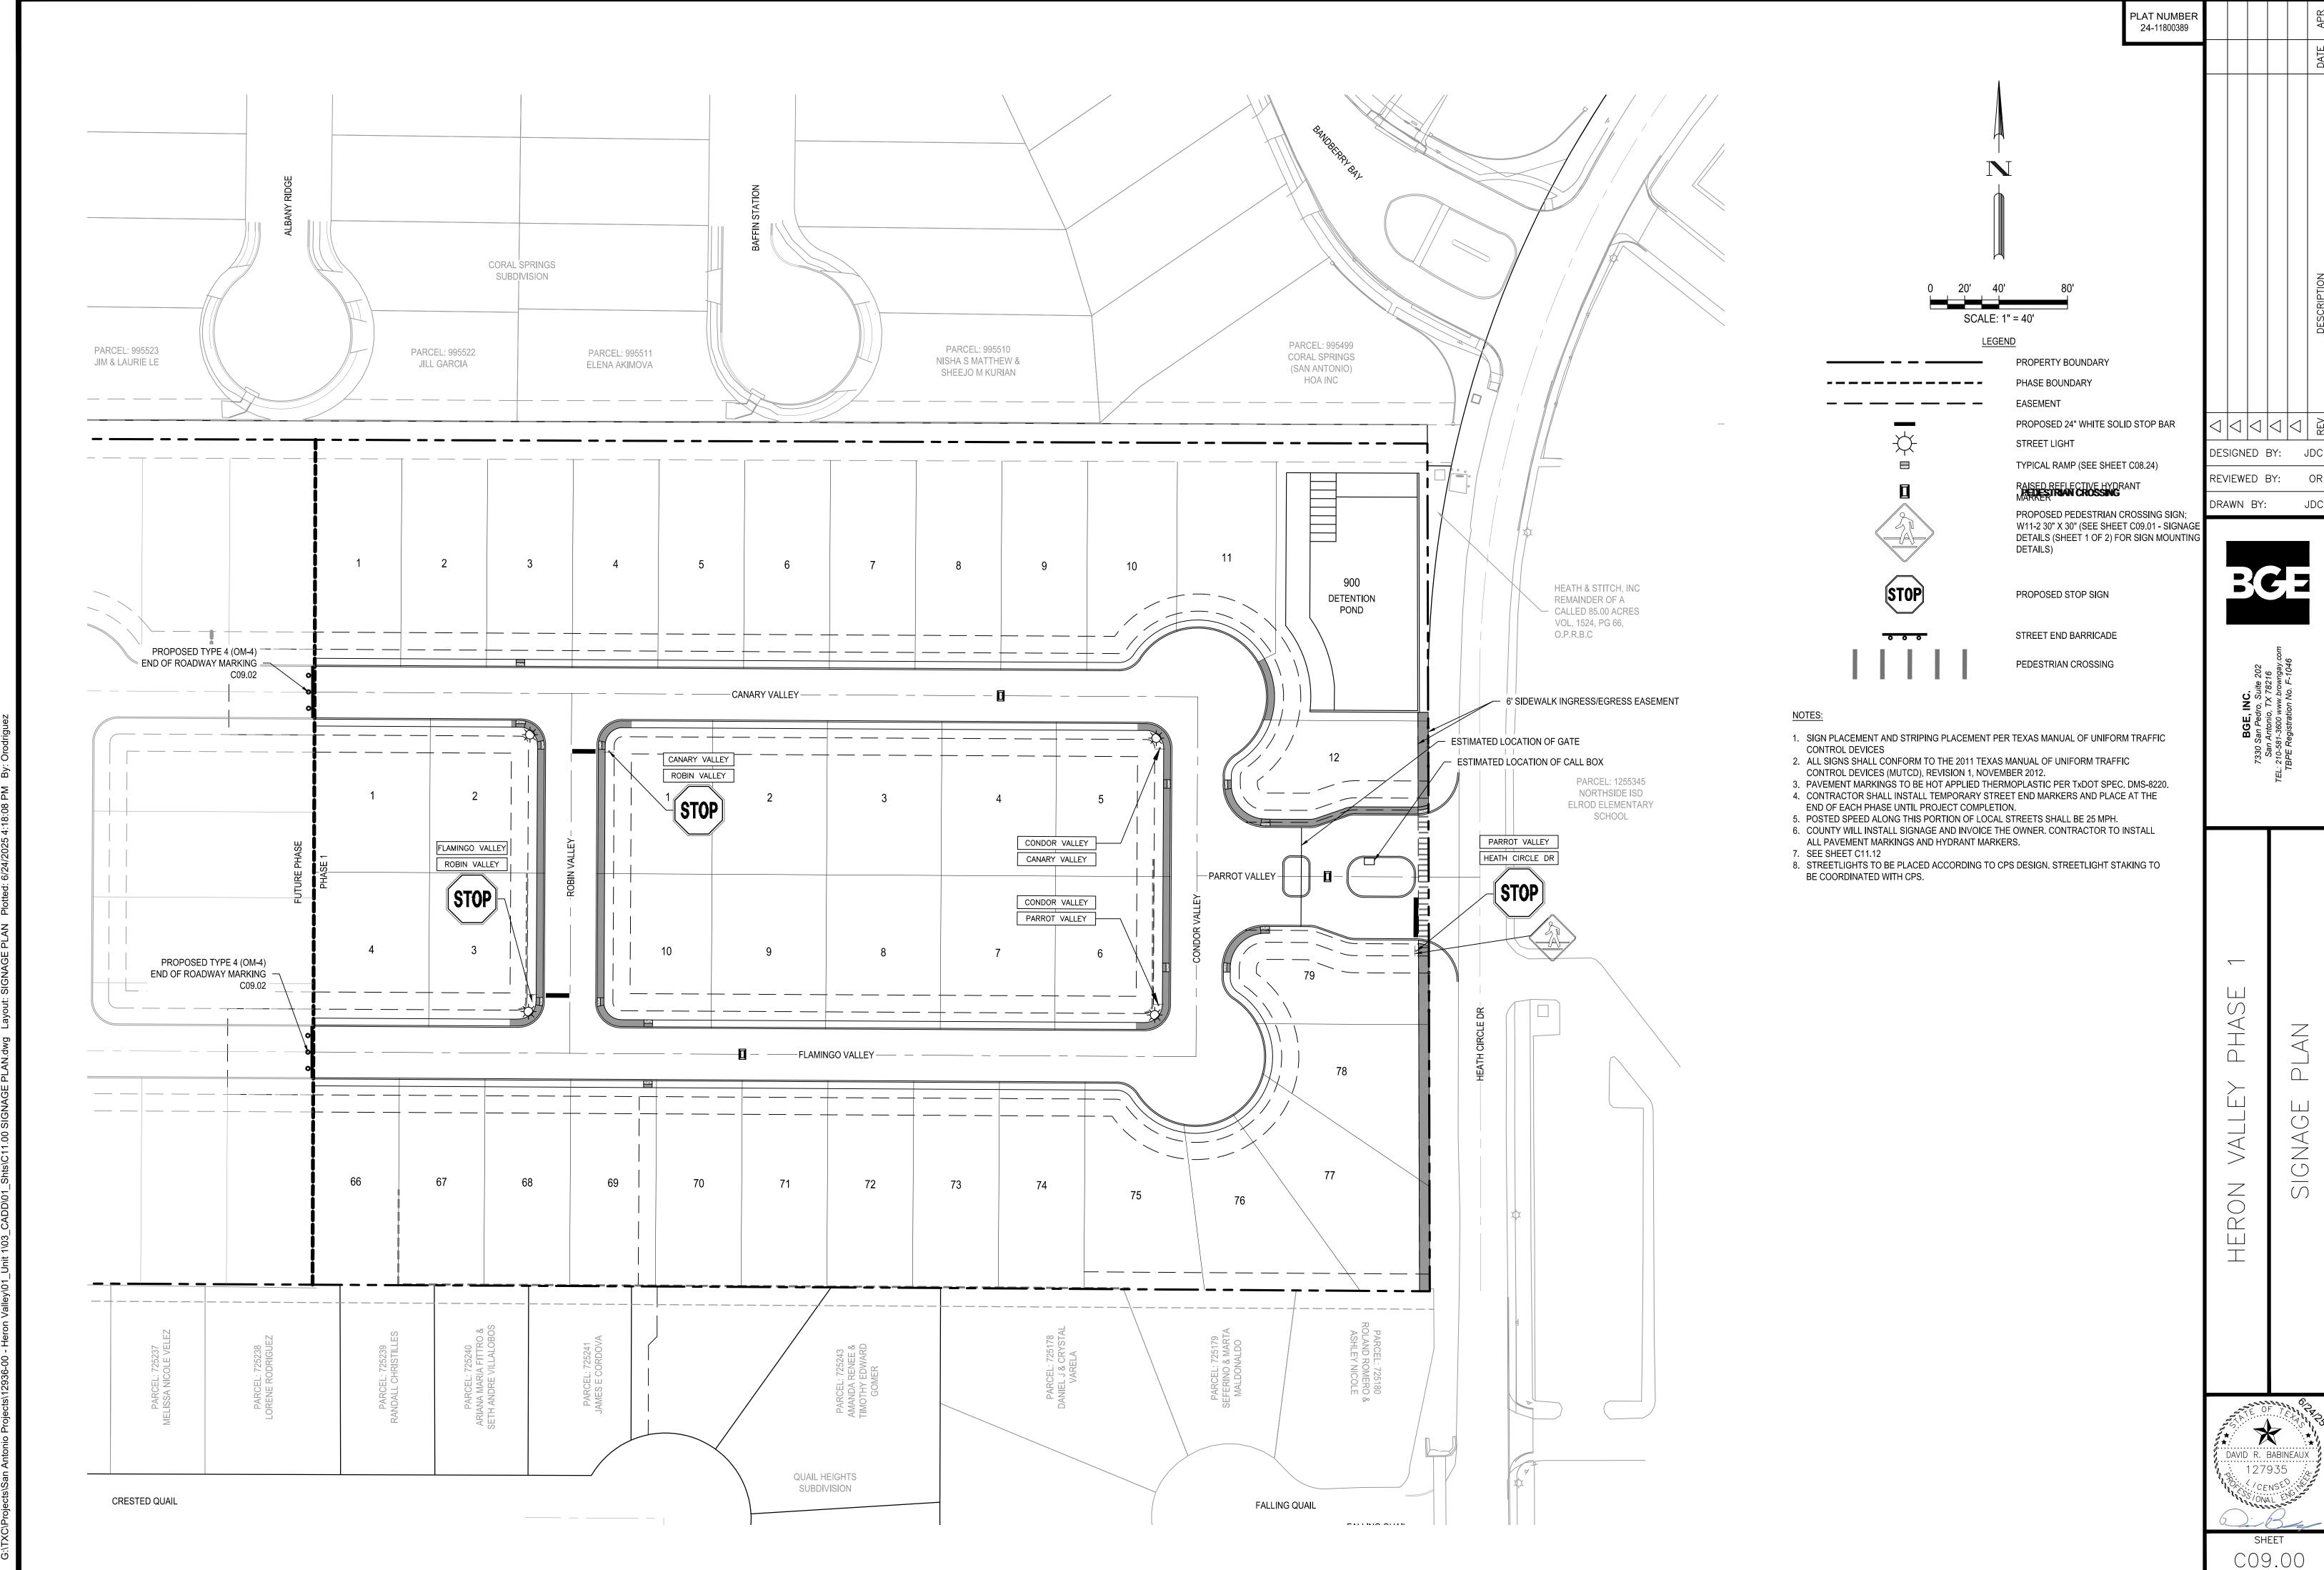

OBJECT MARKER DEFINITION OBJECT MARKER - BID ITEM DESCRIPTIONS Devices used to mark obstructions within or adjacent to the roadway. (See TMUTCD - Chapter 2C, WARNING SIGNS AND OBJECT MARKERS.) XXXXX OM ASSM (OM-XX)(XXXX)XXXXX(XX PAYMENT
INSTL = Installation
REPLC = Replacement
TYPE OF OBJECT MARKER
1, 2, 3, or 4
NUMBER OF REFLECTORS OR DIRECTION
X = 3-Size 2 reflector units (Type 2 only)
Y = 1-Size 3 reflector unit (Type 2 only)
Z = 3-Size 1 or 1-Size 4 reflector unit(s)(Type 2 only)
L = Left Side (Type 3 Object Marker only)
R = Right Side (Type 3 Object Marker only)
C = Center (Type 3 Object Marker only)
TYPE OF POST Type 1 (OM-1) Type 2 (OM-2) Type 3 (OM-3) Type 4 (OM-4) OM-1 OM-2X OM-2Y OM-2Z OM-3L OM-3R OM-3C OM-4 DEVICE C = Center (Type 3 Object Marker only)

TYPE OF POST

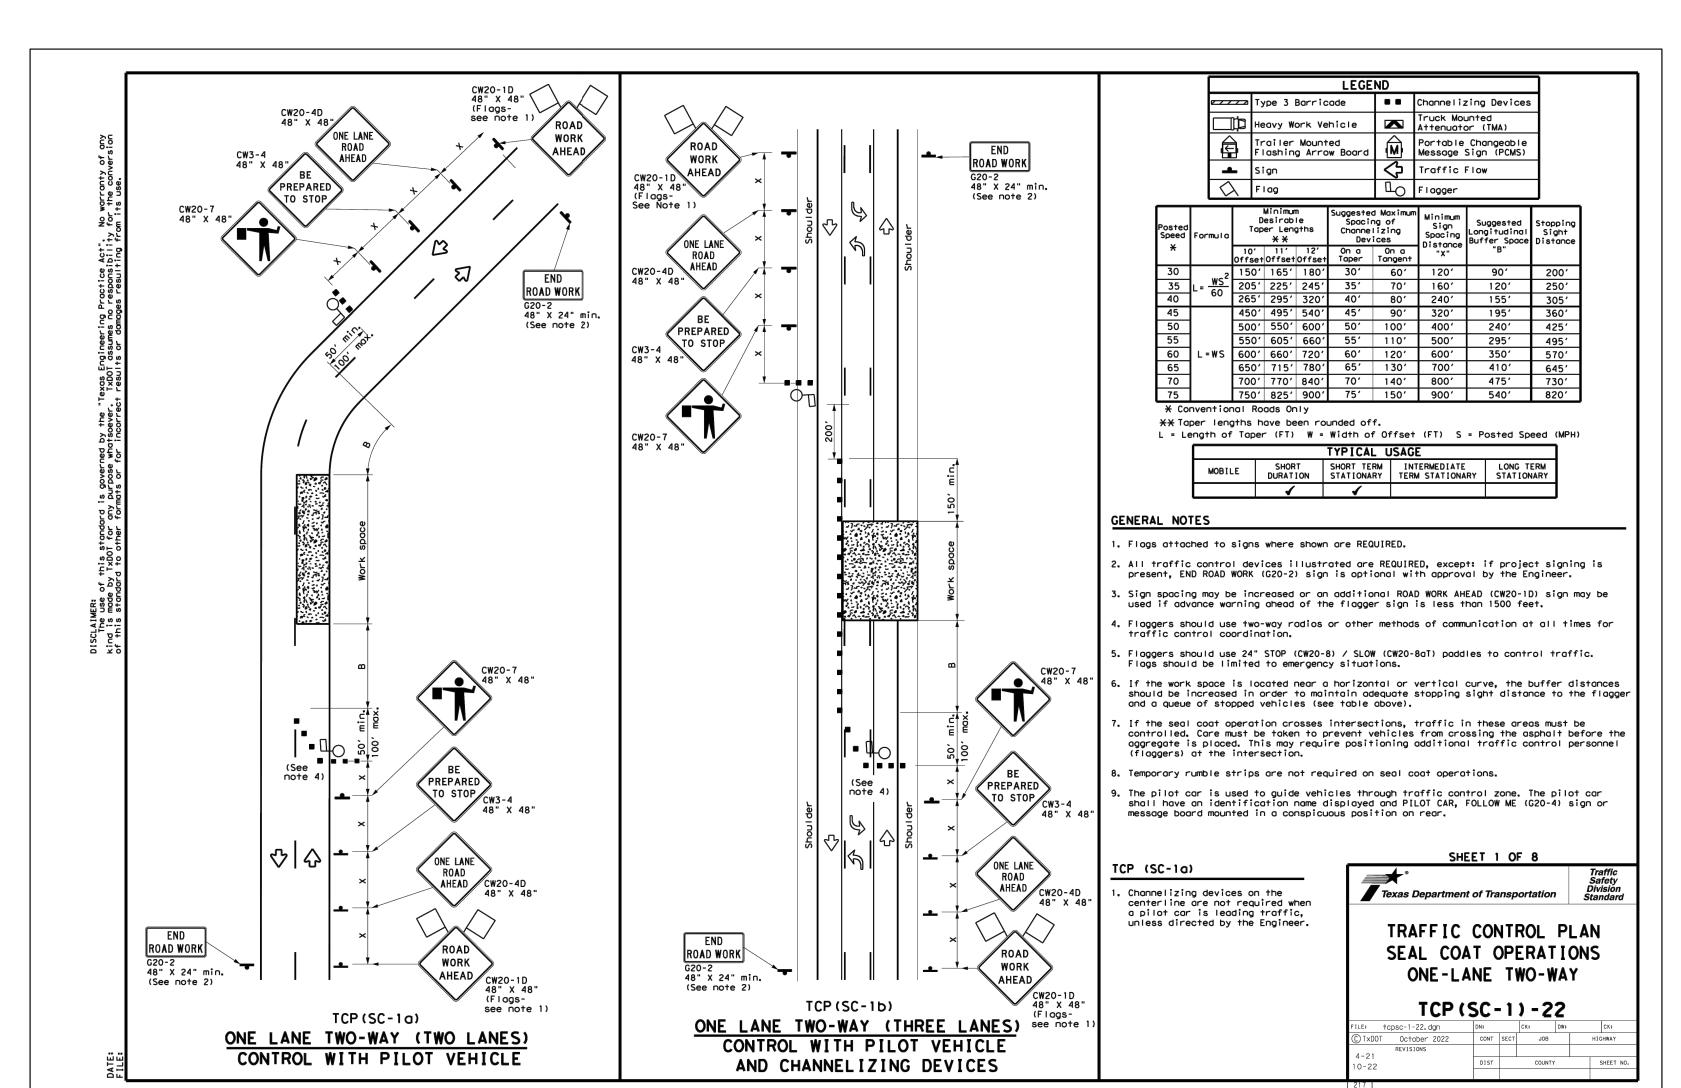WC = Wing Channel Post

WFLX = White Flexible Post

YFLX = Yellow Flexible Post

TWT = Thin Walled Tubing

TYPE OF MOUNT

GND = Ground Embedded (drivable or set in concrete)

SRF = Surface Mount

WAS = Wedge Anchor Steel

WAP = Wedge Anchor Plastic 1-Size 4 reflector unit 3-Size 2 reflector 1-Size 3 reflector or 3-Size 1 reflector units IDENTIFICATION

LL = Low Speed, Low Impact

HH = High Speed, High Impact Alternating Acrylic Black and Retroflective Yellow - Type B_{FL} or C_{FL} sheeting Red - Type B_{FL} or C_{FL} sheeting Yellow - Type B_{rL} or C_{rL} sheeting White and Yellow - Type B or C sheeting SHEETING DIRECTION [if required]

BI = Bi-Directional POST TYPE WC WC WFLX, YFLX TWT, WFLX TWT MOUNT TYPE GNDLL GNDLL, GNDHH, SRFLL, SRFHH WAS, WAP, GNDLL, GNDHH, SRFLL, SRFHH WAS, WAP **GNDLL** WAS, WAP POST TYPE AND SUPPORT FOUNDATION DETAILS REFLECTOR UNIT DIMENSIONS FOR OBJECT MARKERS WEDGE ANCHOR SYSTEMS FLEXIBLE POSTS (YFLX, WFLX) WING CHANNEL (WC) SIZE 4 SIZE 2 SIZE 3 SIZE 1 WAS WAP GNDSRF \odot 0 \circ DEVICE Reflective Reflective 4" ± 光6" 3" ± 1/15" 3" ± 1/45" 1. Size 1 and 4 - Direct applied reflective sheeting for use on flexible post (flx). Post NOTE 2. Size 2 and 3 - For use on wing channel (wc) post only. Use approved metal, plastic, or fiberglass backplate with ¹⁷/₆₄" mounting holes. TYPES 1, 3, AND 4 OBJECT MARKERS TYPICAL OBJECT MARKERS TYPICAL Stub INSTALLATION INSTALLATION Embedded Wing Channel (WC)
 post option may be used for Type
 2 object markers and delineators
 poly See "Flexible Delineator and Object Marker Posts" Material Producer
 List for approved devices. Install per manufacturer's recommendations. 1.12 lbs/ft steel per ASTM A 1011 SS Gr. 50, or ASTM A499. Install per manufacturer's recommendations. 3. Post length may vary to meet field conditions. Pavement surface GENERAL NOTES Texas Department of Transportation Travel Lane Where a restriction prevents consistent placement from the pavement edge, place the affected object markers in line with the innermost edge of the obstruction. When Type 2 object markers are more than 8'-0" from the edge of the pavement, it may not be possible to maintain a height of approximately 4'-0". If this is the case, place the object marker as close to the recommended height as possible. OBJECT MARKER MATERIAL DESCRIPTION 3. Install all object markers in accordance with the manufacturer's recommendation. 2'-0" to 8'-0" or in front of object being marked & INSTALLATION 4. Diagonal stripes on Type 3 object markers shall slope down toward the intended travel lane. 5. Object marker substrates shall be 0.080" aluminum sign blank and conform to ASTM B-209 Alloy 6061-T6 or an approved alternative. D & OM(2)-25 DEPARTMENTAL MATERIAL SPECIFICATIONS

FLEXIBLE DELINEATOR & OBJECT MARKER POSTS
(EMBEDDED & SURFACE MOUNT TYPES)

SIGN FACE MATERIALS

DMS-4400

DMS-8300 See General Notes 1, 2, and 3 SIGN FACE MATERIALS DMS-8300
DELINEATORS, OBJECT MARKERS AND BARRIER REFLECTORS DMS-8600

REVIEWED BY: OR
DRAWN BY: JDC

DESIGNED BY: JDC



BGE, INC.
7330 San Pedro, Suite 202
San Antonio, TX 78216
TEL: 210-581-3600 www.browngay.com
TBPE Registration No. F-1046

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GE DETAILS (SHEET

DAVID R. BABINEAUX

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