


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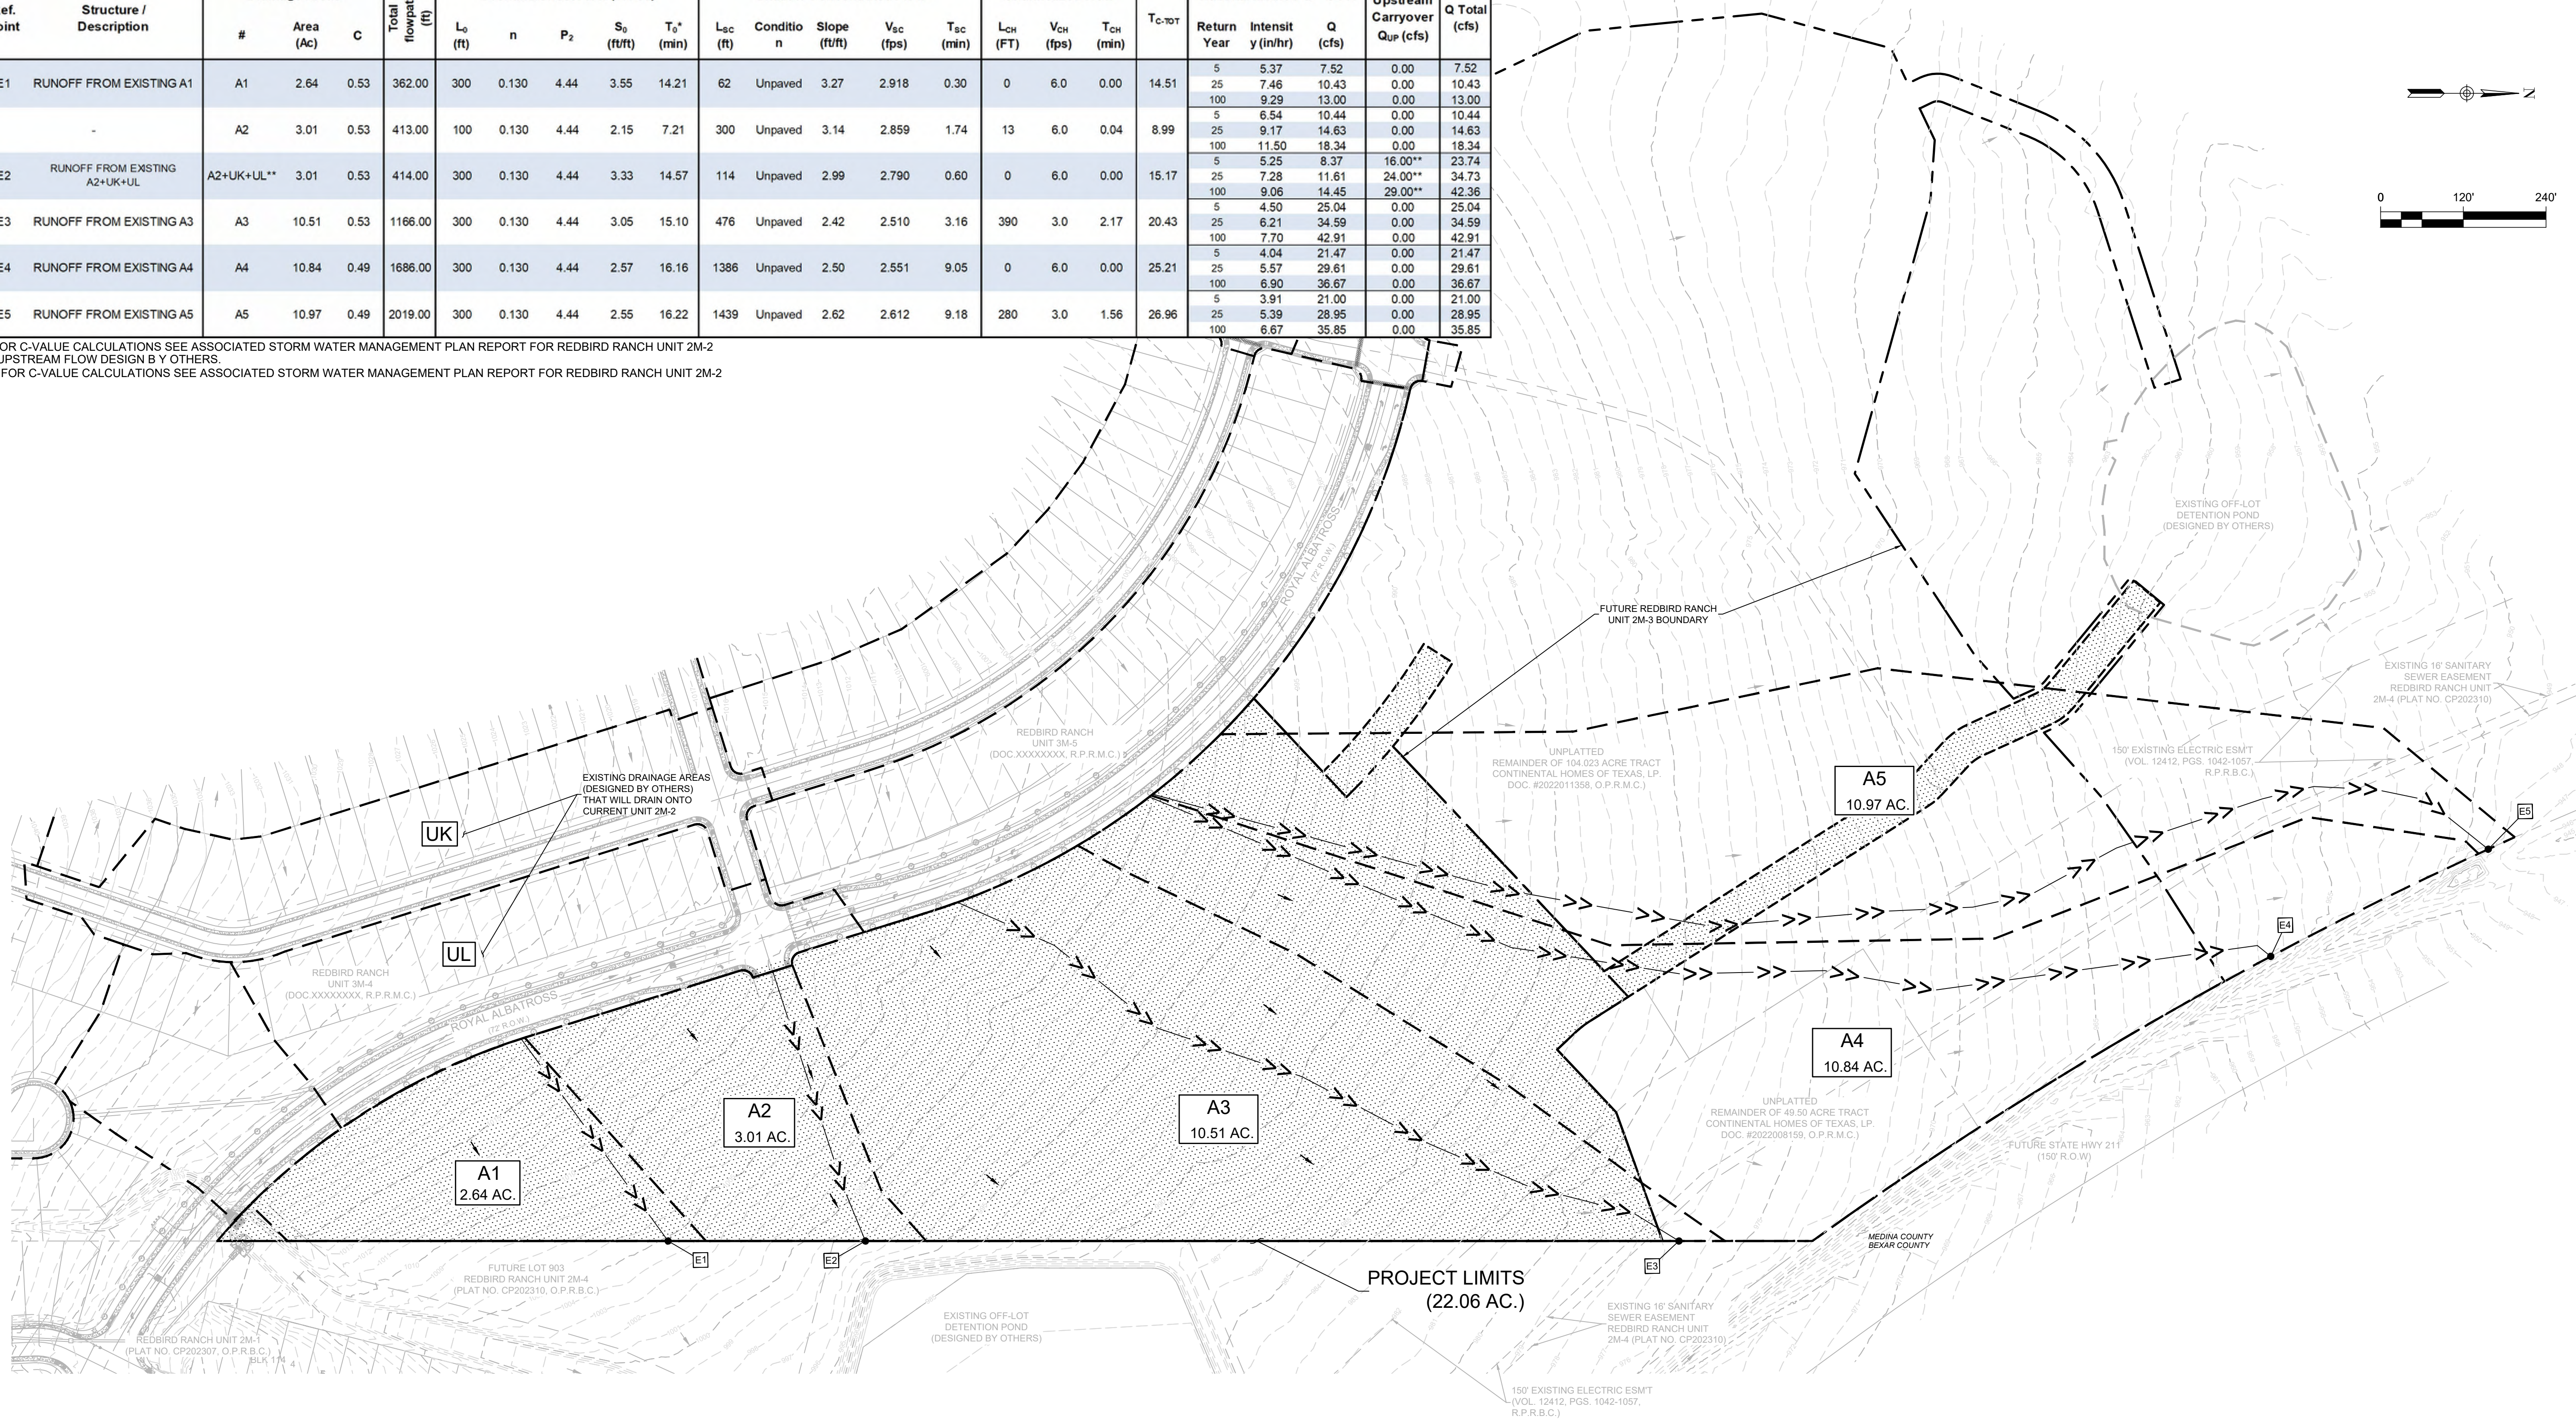


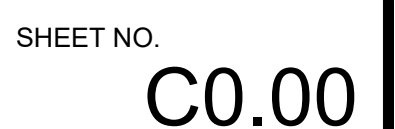





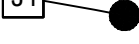
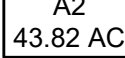



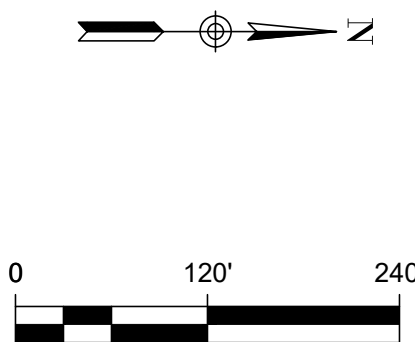


REDBIRD RANCH UNIT 2M-2																									
ATLAS 14 EXISTING FLOW (Q) CALCULATIONS																									
Ref. Point	Structure / Description	Drainage Areas				Total flowpath (ft)	Overland/Sheet Flow (TR-55)					Shallow Concentrated Flow					Channelized Flow			T <sub>C-TOT</sub>	Rational Method Q = C x I x A			Upstream Carryover Q <sub>up</sub> (cfs)	Q Total (cfs)
		#	Area (Ac)	C	L <sub>o</sub> (ft)		n	P <sub>2</sub>	S <sub>0</sub> (ft/ft)	T <sub>0</sub> * (min)	L <sub>sc</sub> (ft)	Condition	Slope (ft/ft)	V <sub>sc</sub> (fps)	T <sub>sc</sub> (min)	L <sub>CH</sub> (FT)	V <sub>CH</sub> (fps)	T <sub>CH</sub> (min)	Return Year		Intensit y (in/hr)	Q (cfs)			
E1	RUNOFF FROM EXISTING A1	A1	2.64	0.53	362.00	300	0.130	4.44	3.55	14.21	62	Unpaved	3.27	2.918	0.30	0	6.0	0.00	14.51	5	5.37	7.52	0.00	7.52	
	-	A2	3.01	0.53	413.00	100	0.130	4.44	2.15	7.21	300	Unpaved	3.14	2.859	1.74	13	6.0	0.04	8.99	25	7.46	10.43	0.00	10.43	
																				100	9.29	13.00	0.00	13.00	
E2	RUNOFF FROM EXISTING A2+UK+UL	A2+UK+UL**	3.01	0.53	414.00	300	0.130	4.44	3.33	14.57	114	Unpaved	2.99	2.790	0.60	0	6.0	0.00	15.17	5	6.54	10.44	0.00	10.44	
																				25	9.17	14.63	0.00	14.63	
																				100	11.50	18.34	0.00	18.34	
E3	RUNOFF FROM EXISTING A3	A3	10.51	0.53	1166.00	300	0.130	4.44	3.05	15.10	476	Unpaved	2.42	2.510	3.16	390	3.0	2.17	20.43	5	5.25	8.37	16.00**	23.74	
																				25	7.28	11.61	24.00**	34.73	
																				100	9.06	14.45	29.00**	42.36	
E4	RUNOFF FROM EXISTING A4	A4	10.84	0.49	1686.00	300	0.130	4.44	2.57	16.16	1386	Unpaved	2.50	2.551	9.05	0	6.0	0.00	25.21	5	4.50	25.04	0.00	25.04	
																				25	6.21	34.59	0.00	34.59	
																				100	7.70	42.91	0.00	42.91	
E5	RUNOFF FROM EXISTING A5	A5	10.97	0.49	2019.00	300	0.130	4.44	2.55	16.22	1439	Unpaved	2.62	2.612	9.18	280	3.0	1.56	26.96	5	4.04	21.47	0.00	21.47	
																				25	5.57	29.61	0.00	29.61	
																				100	6.90	36.67	0.00	36.67	
																				5	3.91	21.00	0.00	21.00	
																				25	5.39	28.95	0.00	28.95	
																					100	6.67	35.85	0.00	35.85

\*\*\* UPSTREAM FLOW DESIGN BY OTHERS.

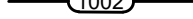


LEGEND (DRAINAGE AREA MAP)	
	PROJECT LIMITS
	EXISTING CONTOUR
	PROPOSED CONTOUR
	FLOW ARROW
	TYPICAL LOT GRADING
	TIME OF CONCENTRATION
	ANALYSIS POINT
	DRAINAGE AREA
	DRAINAGE AREA BOUNDARY








DHI ENGINEERING, LLC  
THIS DOCUMENT HAS BEEN PRODUCED FROM MATERIAL THAT WAS STORED AND/OR TRANSMITTED ELECTRONICALLY AND MAY HAVE BEEN INADVERTENTLY ALTERED. RELY ONLY ON ORIGINAL HARD COPY MATERIALS BEARING THE CONSULTANT'S ORIGINAL SIGNATURE AND SEAL.

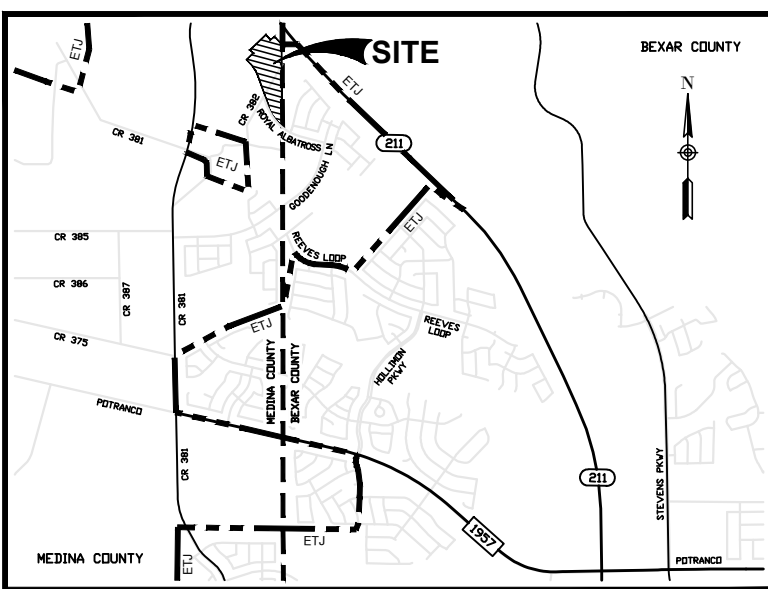

REDBIRD RANCH UNIT 2M-2																										
PROPOSED TIME OF CONCENTRATION - SCS TR-55 Method																										
Ref. Point	Structure / Description	Drainage Areas			Total flowpath (ft)	Overland/Sheet Flow (TR-55)					Shallow Concentrated Flow				Channelized Flow			T <sub>c50%</sub> (min)	Rational Method Q = C-I-A			Upstream Carryover	Capture Structure			
		#	Area (Ac)	C		L <sub>s</sub> (ft)	n	P <sub>2</sub>	S <sub>0</sub> (ft/ft)	T <sub>0</sub> (min)	L <sub>1c</sub> (ft)	Condition	Slope (ft/ft)	V <sub>1c</sub> (fps)	T <sub>1c</sub> (min)	L <sub>CH</sub> (FT)	V <sub>CH</sub> (fps)		T <sub>CH</sub> (min)	Return Year	Intensity (in/hr)		Q (cfs)	Q <sub>up</sub> (cfs)	Q <sub>Total</sub> (cfs)	Q <sub>Intercept</sub> (cfs)
-	-	A1	3.29	0.86	738.00	100	0.240	4.44	5.58	8.04	300	Paved	1.55	2.531	1.9	338	6.0	0.94	10.88	5 6.10 17.25 - 17.25 0.00 17.25	25 8.53 24.12 - 24.12 0.00 24.12	100 10.69 30.20 - 30.20 0.00 30.20	5 6.67 6.67 - 6.67 0.00 6.67	25 10.58 9.32 - 9.32 0.00 9.32	100 13.28 11.69 - 11.69 0.00 11.69	
-	-	A2	0.99	0.89	423.00	160	0.011	4.44	2.50	5	0	0	0	0.000	0.0	263	6.0	0.74	5.74	5 7.57 6.67 - 6.67 0.00 6.67	25 10.58 9.32 - 9.32 0.00 9.32	100 13.28 11.69 - 11.69 0.00 11.69	5 6.67 6.67 - 6.67 0.00 6.67	25 10.58 9.32 - 9.32 0.00 9.32	100 13.28 11.69 - 11.69 0.00 11.69	
J1	20' ON SAG CURB INLET - CARRY OVER FROM A1, A2, UK & UL	A1 + A2	4.28	0.87	1001.00	100	0.240	4.44	5.58	8.04	300	Paved	1.55	2.531	1.9	601	6.0	1.87	11.61	5 6.67 6.67 - 6.67 0.00 6.67	25 10.58 9.32 - 9.32 0.00 9.32	100 13.28 11.69 - 11.69 0.00 11.69	5 6.67 6.67 - 6.67 0.00 6.67	25 10.58 9.32 - 9.32 0.00 9.32	100 13.28 11.69 - 11.69 0.00 11.69	
J1A	20' ON GRADE CURB INLET - CARRY OVER FROM UK & UL	UK + UL	7.95	0.80	945.00	220	0.150	3.96	0.02	16	0	0	0	0.000	0.0	725	6.0	2.00	18.00	5 4.80 31 -15.00* - 15.00* 0.00 15.00	25 10.63 22.12 - 17.00 23.92 23.92 0.00 0.00	100 10.39 38.67 5.43 44.10 44.10 0.00 0.00	5 4.80 31 -15.00* - 15.00* 0.00 15.00	25 10.63 22.12 - 18.00* 22.00* 8.00 4.00 0.00	100 10.39 38.67 5.43 44.10 44.10 0.00 0.00	
-	-	A3	1.83	0.82	456.00	158	0.240	4.44	2.64	15.64	298	Paved	2.15	2.981	1.66	0	6.0	0.00	17.30	5 4.80 31 -15.00* - 15.00* 0.00 15.00	25 10.63 22.12 - 18.00* 22.00* 8.00 4.00 0.00	100 10.39 38.67 5.43 44.10 44.10 0.00 0.00	5 4.80 31 -15.00* - 15.00* 0.00 15.00	25 10.63 22.12 - 18.00* 22.00* 8.00 4.00 0.00	100 10.39 38.67 5.43 44.10 44.10 0.00 0.00	
-	-	A4	0.87	0.79	382.00	101	0.240	4.44	3.71	9.54	281	Unpaved	2.25	2.420	1.8	0	6.0	0.00	11.33	5 4.80 31 -15.00* - 15.00* 0.00 15.00	25 10.63 22.12 - 18.00* 22.00* 8.00 4.00 0.00	100 10.39 38.67 5.43 44.10 44.10 0.00 0.00	5 4.80 31 -15.00* - 15.00* 0.00 15.00	25 10.63 22.12 - 18.00* 22.00* 8.00 4.00 0.00	100 10.39 38.67 5.43 44.10 44.10 0.00 0.00	
J2	ANALYSIS POINT - CARRY OVER FROM A3 + A4	A3 + A4	2.70	0.81	561.00	158	0.240	4.44	2.64	15.64	298	Paved	2.15	2.981	1.66	105	6.0	0.30	17.60	5 4.80 31 -15.00* - 15.00* 0.00 15.00	25 10.63 22.12 - 18.00* 22.00* 8.00 4.00 0.00	100 10.39 38.67 5.43 44.10 44.10 0.00 0.00	5 4.80 31 -15.00* - 15.00* 0.00 15.00	25 10.63 22.12 - 18.00* 22.00* 8.00 4.00 0.00	100 10.39 38.67 5.43 44.10 44.10 0.00 0.00	
-	-	A5	1.81	0.80	391.00	100	0.240	4.44	2.31	11.44	143	Unpaved	2.90	2.748	0.9	148	6.0	0.42	12.72	5 4.80 31 -15.00* - 15.00* 0.00 15.00	25 10.63 22.12 - 18.00* 22.00* 8.00 4.00 0.00	100 10.39 38.67 5.43 44.10 44.10 0.00 0.00	5 4.80 31 -15.00* - 15.00* 0.00 15.00	25 10.63 22.12 - 18.00* 22.00* 8.00 4.00 0.00	100 10.39 38.67 5.43 44.10 44.10 0.00 0.00	
J3	15' ON SAG CURB INLET - CARRY OVER FROM J2 + A5	J2 + A5	4.51	0.81	770.00	158	0.240	4.44	2.00	17.47	298	Paved	2.50	3.214	1.5	314	6.0	0.88	19.89	5 4.80 31 -15.00* - 15.00* 0.00 15.00	25 10.63 22.12 - 18.00* 22.00* 8.00 4.00 0.00	100 10.39 38.67 5.43 44.10 44.10 0.00 0.00	5 4.80 31 -15.00* - 15.00* 0.00 15.00	25 10.63 22.12 - 18.00* 22.00* 8.00 4.00 0.00	100 10.39 38.67 5.43 44.10 44.10 0.00 0.00	
-	-	A6	1.91	0.79	698.00	180	0.240	4.44	2.00	19.39	300	Paved	1.16	2.189	2.3	186	6.0	0.52	22.19	5 4.80 31 -15.00* - 15.00* 0.00 15.00	25 10.63 22.12 - 18.00* 22.00* 8.00 4.00 0.00	100 10.39 38.67 5.43 44.10 44.10 0.00 0.00	5 4.80 31 -15.00* - 15.00* 0.00 15.00	25 10.63 22.12 - 18.00* 22.00* 8.00 4.00 0.00	100 10.39 38.67 5.43 44.10 44.10 0.00 0.00	
-	-	A7	0.64	0.53	411.00	180	0.240	4.44	5.56	12.88	0	Paved	2.50	3.214	0.00	231	6.0	0.65	13.53	5 4.80 31 -15.00* - 15.00* 0.00 15.00	25 10.63 22.12 - 18.00* 22.00* 8.00 4.00 0.00	100 10.39 38.67 5.43 44.10 44.10 0.00 0.00	5 4.80 31 -15.00* - 15.00* 0.00 15.00	25 10.63 22.12 - 18.00* 22.00* 8.00 4.00 0.00	100 10.39 38.67 5.43 44.10 44.10 0.00 0.00	
J4	BEING EARTHEN CHANNEL DRAIN C - CARRY OVER FROM A8	A6 + A7	2.55	0.72	897.00	180	0.240	4.44	2.00	19.39	300	Paved	1.16	2.189	2.28	417	6.0	1.16	22.83	5 4.80 31 -15.00* - 15.00* 0.00 15.00	25 10.63 22.12 - 18.00* 22.00* 8.00 4.00 0.00	100 10.39 38.67 5.43 44.10 44.10 0.00 0.00	5 4.80 31 -15.00* - 15.00* 0.00 15.00	25 10.63 22.12 - 18.00* 22.00* 8.00 4.00 0.00	100 10.39 38.67 5.43 44.10 44.10 0.00 0.00	
-	-	A8	3.82	0.82	1006.00	151	0.240	4.44	2.00	16.85	126	Unpaved	2.00	2.282	0.92	637	6.0	1.77	19.94	5 4.80 31 -15.00* - 15.00* 0.00 15.00	25 10.63 22.12 - 18.00* 22.00* 8.00 4.00 0.00	100 10.39 38.67 5.43 44.10 44.10 0.00 0.00	5 4.80 31 -15.00* - 15.00* 0.00 15.00	25 10.63 22.12 - 18.00* 22.00* 8.00 4.00 0.00	100 10.39 38.67 5.43 44.10 44.10 0.00 0.00	
-	-	A9	2.24	0.81	579.00	157	0.240	4.44	1.89	17.78	300	Paved	2.73	3.359	1.5	122	6.0	0.34	19.60	5 4.80 31 -15.00* - 15.00* 0.00 15.00	25 10.63 22.12 - 18.00* 22.00* 8.00 4.00 0.00	100 10.39 38.67 5.43 44.10 44.10 0.00 0.00	5 4.80 31 -15.00* - 15.00* 0.00 15.00	25 10.63 22.12 - 18.00* 22.00* 8.00 4.00 0.00	100 10.39 38.67 5.43 44.10 44.10 0.00 0.00	
J5	BEING EARTHEN CHANNEL DRAIN D - CARRY OVER FROM A8	A8 + A9	6.06	0.82	1006.00	151	0.240	4.44	2.00	16.85	126	Unpaved	2.00	2.282	0.92	637	6.0	1.77	19.94	5 4.80 31 -15.00* - 15.00* 0.00 15.00	25 10.63 22.12 - 18.00* 22.00* 8.00 4.00 0.00	100 10.39 38.67 5.43 44.10 44.10 0.00 0.00	5 4.80 31 -15.00* - 15.00* 0.00 15.00	25 10.63 22.12 - 18.00* 22.00* 8.00 4.00 0.00	100 10.39 38.67 5.43 44.10 44.10 0.00 0.00	
-	-	A10	7.75	0.47	1039.00	100	0.240	4.44	2.33	11.4	320	Unpaved	3.00	2.795	1.9	619	6.0	1.72	15.02	5 4.80 31 -15.00* - 15.00* 0.00 15.00	25 10.63 22.12 - 18.00* 22.00* 8.00 4.00 0.00	100 10.39 38.67 5.43 44.10 44.10 0.00 0.00	5 4.80 31 -15.00* - 15.00* 0.00 15.00	25 10.63 22.12 - 18.00* 22.00* 8.00 4.00 0.00	100 10.39 38.67 5.43 44.10 44.10 0.00 0.00	
J6	END OF EARTHEN CHANNEL DRAIN D - CARRY OVER FROM J4 & J5	J4 + J5 + A10 + A15	16.36	0.74	1943.00	151	0.240	4.44	2.00	16.85	126	Unpaved	2.00	2.282	0.92	1574	6.0	4.38	22.55	5 4.80 31 -15.00* - 15.00* 0.00 15.00	25 10.63 22.12 - 18.00* 22.00* 8.00 4.00 0.00	100 10.39 38.67 5.43 44.10 44.10 0.00 0.00	5 4.80 31 -15.00* - 15.00* 0.00 15.00	25 10.63 22.12 - 18.00* 22.00* 8.00 4.00 0.00	100 10.39 38.67 5.43 44.10 44.10 0.00 0.00	
-	-	A11	13.81	0.62	1943.00	151	0.240	4.44	2.00	16.85	92	Paved	3.50	3.803	0.40	1574	6.0	4.38	22.15	5 4.80 31 -15.00* - 15.00* 0.00 15.00	25 10.63 22.12 - 18.00* 22.00* 8.00 4.00 0.00	100 10.39 38.67 5.43 44.10 44.10 0.00 0.00	5 4.80 31 -15.00* - 15.00* 0.00 15.00	25 10.63 22.12 - 18.00* 22.00* 8.00 4.00 0.00	100 10.39 38.67 5.43 44.10 44.10 0.00 0.00	
J7	WATERSHED OUTFALL	A11	6.03	0.41	1277.00	100	0.240	4.44	2.60	10.91	320	Unpaved	2.60	2.602	2.05	857	6.0	2.39	15.25	5 4.80 31 -15.00* - 15.00* 0.00 15.00	25 10.63 22.12 - 18.00* 22.00* 8.00 4.00 0.00	100 10.39 38.67 5.43 44.10 44.10 0.00 0.00	5 4.80 31 -15.00* - 15.00* 0.00 15.00	25 10.63 22.12 - 18.00* 22.00* 8.00 4.00 0.00	100 10.39 38.67 5.43 44.10 44.10 0.00 0.00	
-	-	A12	9.82	0.45	915.40	100	0.240	4.44	2.42	11.23	300	Unpaved	2.51	2.556	1.95	515.4	6.0	1.44	14.62	5 4.80 31 -15.00* - 15.00* 0.00 15.00	25 10.63 22.12 - 18.00* 22.00* 8.00 4.00 0.00	100 10.39 38.67 5.43 44.10 44.10 0.00 0.00	5 4.80 31 -15.00* - 15.00* 0.00 15.00	25 10.63 22.12 - 18.00* 22.00* 8.00 4.00 0.00	100 10.39 38.67 5.43 44.10 44.10 0.00 0.00	
-	-	A13	0.89	0.77	162.00	162	0.240	4.44	3.43	14.37	0	Unpaved	1.00	1.613	0.00	0	6.0	0.00	14.37	5 4.80 31 -15.00* - 15.00* 0.00 15.00	25 10.63 22.12 - 18.00* 22.00* 8.00 4.00 0.00	100 10.39 38.67 5.43 44.10 44.10 0.00 0.00	5 4.80 31 -15.00* - 15.00* 0.00 15.00	25 10.63 22.12 - 18.00* 22.00* 8.00 4.00 0.00	100 10.39 38.67 5.43 44.10 44.10 0.00 0.00	
-	-	A14	0.23	0.41	134.00	100	0.240	4.44	4.25	8.97	34	Unpaved	4.25	3.326	0.17	0	6.0	0.00	9.14	5 4.80 31 -15.00* - 15.00* 0.00 15.00	25 10.63 22.12 - 18.00* 22.00* 8.00 4.00 0.00	100 10.39 38.67 5.43 44.10 44.10 0.00 0.00	5 4.80 31 -15.00* - 15.00* 0.00 15.00	25 10.63 22.12 - 18.00* 22.00* 8.00 4.00 0.00	100 10.39 38.67 5.43 44.10 44.10 0.00 0.00	
-	-	A15	4.05	0.41	1328.00	100	0.240	4.44	2.35	11.36	300	Unpaved	2.94	2.766	1.80	928	6.0	2.58	15.74	5 4.80 31 -15.00* - 15.00* 0.00 15.00	25 10.63 22.12 - 18.00* 22.00* 8.00 4.00 0.00	100 10.39 38.67 5.43 44.10 44.10 0.00 0.00	5 4.80 31 -15.00* - 15.00* 0.00 15.00	25 10.63 22.12 - 18.00* 22.00* 8.00 4.00 0.00	100 10.39 38.67 5.43 44.10 44.10 0.00 0.00	

\* FLOWS AND INLET INTERCEPTING CAPACITY BY OTHERS. REFER TO REDBIRD RANCH PHASE 2 UNIT 3M-4, SHEET C1.02 MASTER DRAINAGE PLAN - ULTIMATE CONDITIONS  
\*\* Q TOTAL FLOW FROM EXISTING REDBIRD RANCH PHASE 2 UNIT 3M-4, DIVIDED HALF INTO A1 AND A3  
\*\*\* FOR C-VALUE CALCULATIONS SEE ASSOCIATED STORM WATER MANAGEMENT PLAN REPORT FOR REDBIRD RANCH UNIT 2M-2

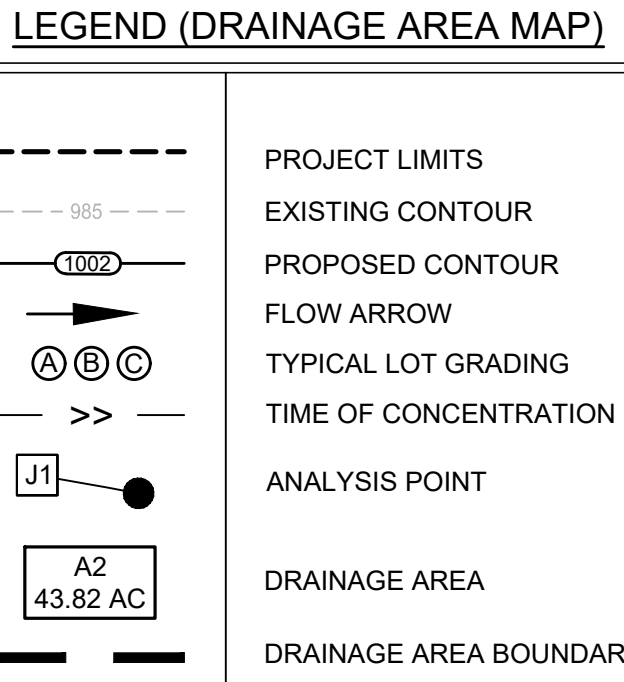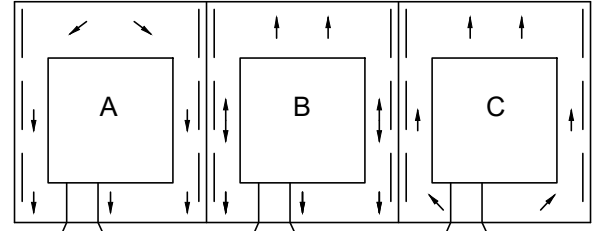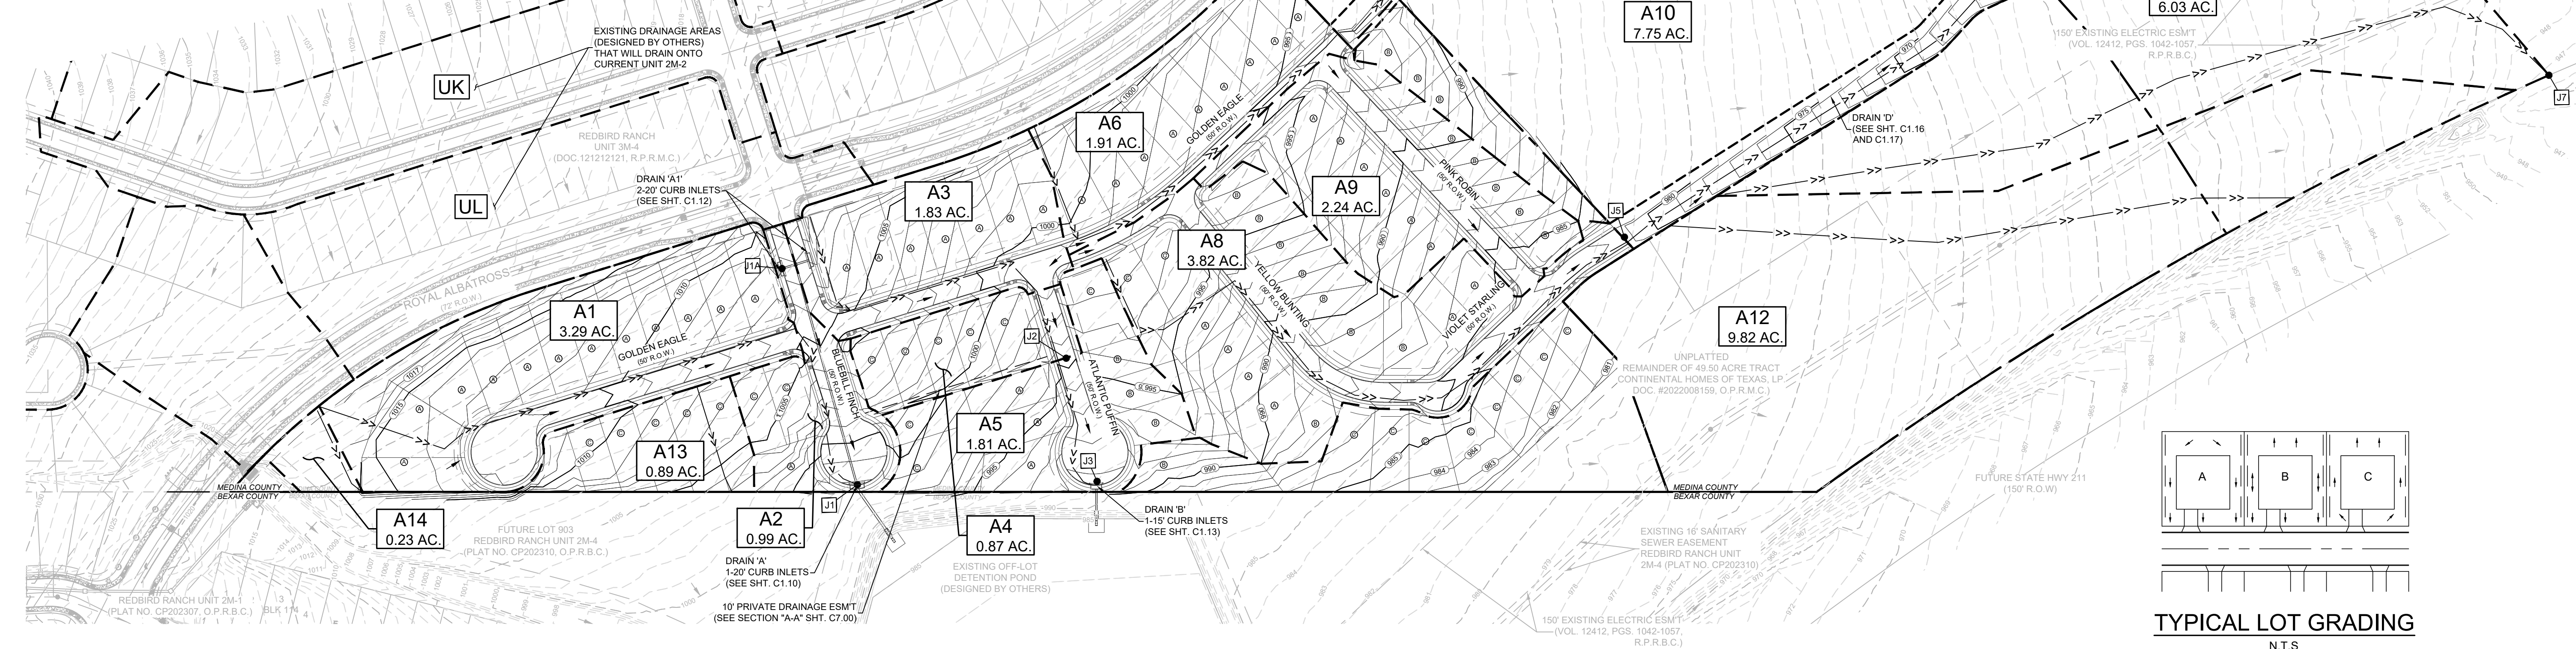

REDBIRD RANCH UNIT 2M-2  
SAN ANTONIO, TX  
PROPOSED DRAINAGE AREA  
MAP

DESIGNED BY: JWS  
DRAWN BY: SQV/JWS  
DATE: 3/20/2024  
JOB NO.: 05000-200  
SHEET NO. C1.01

3/20/2024  
Vance L. Weynand  
Professional Engineer  
No. 99269  
State of Texas

DHI Engineering, LLC.  
4419 LOOP 1604 EAST  
SUITE 100  
SAN ANTONIO, TEXAS 78217  
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TBP REG. NO. F-19561

REV

DESCRIPTION


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DOC # XXXXXXXXXXXXX



DHI ENGINEERING, LLC


THIS DOCUMENT HAS BEEN PRODUCED FROM MATERIAL THAT WAS STORED AND/OR TRANSMITTED ELECTRONICALLY AND MAY HAVE BEEN INADEQUATELY ALTERED. RELY ONLY ON ORIGINAL HARD COPY MATERIALS BEARING THE CONSULTANT'S ORIGINAL SIGNATURE AND SEAL.

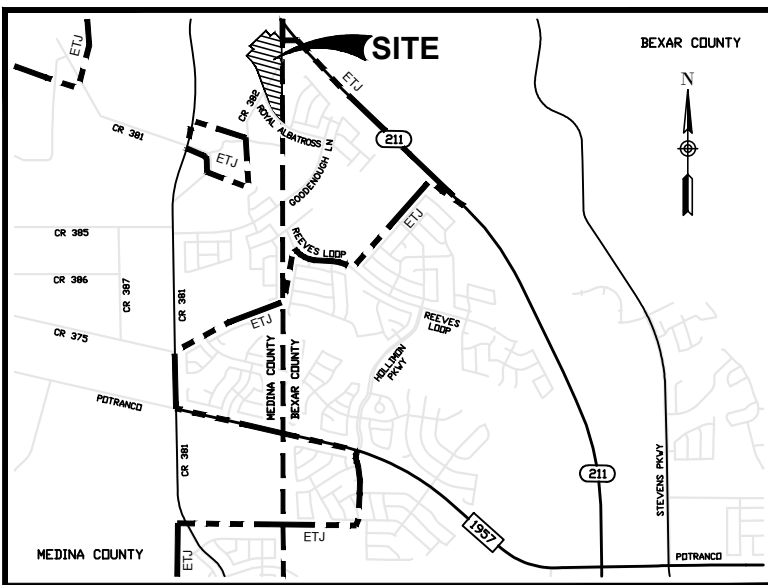

LOCATION MAP  
NOT-TO-SCALE

REDBIRD RANCH UNIT 2M-2 & 2M-3																										
ULTIMATE TIME OF CONCENTRATION - SCS TR-55 Method																										
Ref. Point	Structure / Description	Drainage Areas		Total Length (ft)	Overland/Sheet Flow (TR-55)					Shallow Concentrated Flow					Channelized Flow					T <sub>tot</sub> (min)	Rational Method Q = C-I-A		Upstream Crossover	Capture Structure		
		#	Area (Ac)		C	L <sub>1</sub> (ft)	n	P <sub>2</sub>	S <sub>1</sub> (ft/ft)	T <sub>1</sub> (min)	L <sub>2</sub> (ft)	Condition	Slope (ft/ft)	V <sub>1</sub> (ft/s)	T <sub>2</sub> (min)	L <sub>3</sub> (FT)	V <sub>2</sub> (ft/s)	T <sub>3</sub> (min)	Return Year		Intensity (in/hr)	Q (cfs)		Q Total (cfs)	Q Intercept (cfs)	Q Bypass (cfs)
J1	20' ON SAG CURB INLET - CARRY OVER FROM A1, A2, UK & UL	A1	3.29	0.86	738.00	100	0.240	4.44	5.58	8.04	300	Paved	1.55	2.531	1.9	338	6.0	0.94	10.88	5	6.10	17.3	-	17.27	0.00	17.27
		A2	0.99	0.89	423.00	160	0.011	4.44	2.50	5	0	Paved	0.00	0.000	0.00	263	6.0	0.74	5.74	25	8.53	24.1	-	24.15	0.00	24.15
		A1 + A2 + UK + UL	4.28	0.87	1003.00	100	0.240	4.44	5.60	8.03	640	Paved	1.50	2.490	4.2	263	6.0	0.74	12.97	5	7.57	6.7	-	6.67	0.00	6.67
		A3	1.83	0.82	456.00	158	0.240	4.44	2.64	15.64	298	Paved	2.15	2.981	1.66	0	6.0	0.00	17.30	25	10.58	9.3	-	9.32	0.00	9.32
		A4	0.87	0.79	362.00	101	0.240	4.44	3.71	9.54	261	Unpaved	2.25	2.420	1.7	0	6.0	0.00	11.24	100	12.26	11.7	-	11.69	0.00	11.69
J2	ANALYSIS POINT - CARRY OVER FROM A3 + A4	A3 + A4	2.70	0.81	561.00	158	0.240	4.44	2.00	17.47	298	Paved	2.50	3.214	1.54	105	6.0	0.30	19.31	5	9.67	21.1	1.7	22.79	0.00	22.79
J3	15' ON SAG CURB INLET - CARRY OVER FROM J2 + A5	A5	1.81	0.80	391.00	100	0.240	4.44	2.31	11.44	143	Unpaved	2.90	2.748	0.8	148	6.0	0.42	12.66	25	7.90	29.4	4.0	33.38	0.00	33.38
		J2 + A5	4.51	0.81	770.00	158	0.240	4.44	2.00	17.47	298	Paved	2.50	3.214	1.5	314	6.0	0.88	19.89	25	4.42	12.6	1.7	16.21	0.00	16.21
		A6	4.49	0.80	1288.00	180	0.240	4.44	2.00	19.39	300	Paved	1.16	2.189	2.2	808	6.0	2.25	23.84	25	4.90	7.3	-	7.38	0.00	7.38
		A7	1.73	0.84	653.00	100	0.011	4.44	2.56	5	300	Paved	2.50	3.214	1.55	253	6.0	0.71	7.26	25	10.78	10.2	8.4	23.79	0.00	23.79
		A8	4.82	0.80	876.00	100	0.240	4.44	2.31	11.44	300	Paved	2.49	3.208	1.5	476	6.0	1.33	14.27	5	7.73	8.3	-	8.30	0.00	8.30
J4	ANALYSIS POINT - CARRY OVER FROM A6 + A7	A6 + A7 + A8	11.04	0.81	1819.00	180	0.240	4.44	2.00	19.39	798	Paved	1.75	2.689	4.94	841	6.0	2.34	26.67	25	5.43	10.1	1.7	17.82	0.00	17.82
J5	ANALYSIS POINT - CARRY OVER FROM J4 + A9	A9	1.09	0.81	407.00	135	0.240	4.44	3.54	12.26	272	Paved	0.92	1.950	2.3	0	6.0	0.00	14.56	5	3.93	35.1	0.0	35.13	0.00	35.13
		J4 + A9	12.13	0.81	2097.00	180	0.240	4.44	2.00	19.39	798	Paved	1.75	2.689	4.94	1119	6.0	3.11	27.44	25	6.42	1.0	0.0	48.44	0.00	48.44
		A10	3.82	0.82	914.00	151	0.240	4.44	2.00	16.85	126	Unpaved	2.00	2.282	0.92	637	6.0	1.77	19.94	5	1.61	90.0	0.0	99.98	0.00	99.98
		A11	2.24	0.81	579.00	157	0.240	4.44	1.89	17.78	300	Paved	2.79	3.395	1.47	122	6.0	0.34	19.59	25	5.36	4.7	-	4.73	0.00	4.73
		A10 + A11	6.06	0.82	1006.00	151	0.240	4.44	2.00	16.85	126	Unpaved	2.00	2.282	0.92	637	6.0	1.77	19.94	25	7.45	6.6	0.0	65.05	0.00	65.05
J6	ANALYSIS POINT - CARRY OVER FROM J5	A12	2.48	0.81	810.19	100	0.240	4.44	1.86	12.48	300	Paved	2.69	3.324	1.49	410.19	6.0	1.14	15.11	5	6.58	14.3	0.0	14.25	0.00	14.25
J7	BEGIN OF EARTHEN CHANNEL - CARRY OVER FROM J6	J5 + J6 + A12	20.67	0.81	2097.00	180	0.240	4.44	2.00	19.39	798	Paved	1.75	2.689	4.94	1119	6.0	3.11	27.44	25	3.87	64.8	0.0	64.84	0.00	64.84
J8	END OF EARTHEN CHANNEL - CARRY OVER FROM J7	J7 + A13	22.90	0.79	2919.00	180	0.240	4.44	2.00	19.39	798	Paved	1.75	2.689	4.94	1941	6.0	5.40	29.73	25	5.44	89.4	0.0	89.38	0.00	89.38
J9	BEGIN OF EARTHEN CHANNEL - CARRY OVER FROM A15 & A14	A14	4.29	0.80	906.10	100	0.240	4.44	2.05	12	300	Paved	2.01	2.882	1.73	506.1	6.0	1.41	15.14	25	5.25	7.1	-	7.14	0.00	7.14
		A15	2.37	0.81	732.99	100	0.240	4.44	2.72	10.72	300	Paved	1.96	2.846	1.7	332.99	6.0	0.93	13.35	25	12.32	12.3	-	12.32	0.00	12.32
		A14 + A15	6.66	0.80	733.00	250	0.240	4.44	2.00	20	483	Paved	1.00	2.033	3.96	0	6.0	0.00	23.96	25	3.72	67.3	0.0	67.25	0.00	67.25
		A16	11.23	0.49	673.96	100	0.011	4.44	0.76	5	300	Unpaved	2.35	2.473	2.0	273.96	6.0	0.77	7.77	25	12.32	92.7	0.0	92.70	0.00	92.70
		J9 + A16	17.89	0.61	2104.00	250	0.240	4.44	2.00	20	483	Paved	1.00	2.033	3.96	1371	6.0	3.81	27.77	25	6.26	10.0	0.0	10.00	0.00	10.00
J10	WATERSHED OUTFALL - CARRY OVER FROM J9	A17	10.08	0.52	766.64	100	0.240	4.44	1.29	14.44	300	Unpaved	2.00	2.282	2.1	366.64	6.0	1.02	17.56	25	5.40	3.7	-	3.70	0.00	3.70
J11	WATERSHED OUTFALL - CARRY OVER FROM J10	A18	0.89	0.77	162.00	162	0.240	4.44	3.43	14.37	0	Paved	0.00	0.000	0.00	0	6.0	0.00	14.37	25	7.60	5.1	-	5.14	0.00	5.14
		A19	0.23	0.49	134.00	100	0.240	4.44	4.25	8.97	34	Unpaved	4.25	3.326	0.17	0	6.0	0.00	9.14	25	6.15	0.7	-	0.73	0.00	0.73
		A20	5.74	0.49	1149.29	100	0.240	4.44	1.37	14.1	300	Unpaved	2.60	2.802	1.92	749.29	6.0	2.09	18.11	25	9.12	1.0	-	1.03	0.00	1.03
		A19 + A20	6.07	0.98	1283.29	100	0.240	4.44	1.37	14.1	300	Unpaved	2.60	2.802	1.92	749.29	6.0	2.09	18.11	25	4.86	25.5	-	25.47	0.00	25.47
		A17 + A18	10.97	0.52	928.64	100	0.240	4.44	1.29	14.44	300	Unpaved	2.00	2.282	2.1	366.64	6.0	1.02	17.56	25	6.72	35.2	-	35.24	0.00	35.24

FLOW AND INLET INTERCEPTING CAPACITY BY OTHERS, REFER TO REDBIRD RANCH PHASE 2 UNIT 3M-4, SHEET C1.02 MASTER DRAINAGE PLAN - ULTIMATE CONDITIONS  
\*\*FLOW FROM UK+UL, EXISTING REDBIRD RANCH PHASE 2 UNIT 3M-4, DIVIDED HALF INTO A1 AND REMAINING INTO A3.  
\*\*\*FOR C-VALUE CALCULATIONS SEE ASSOCIATED STORM WATER MANAGEMENT PLAN REPORT FOR REDBIRD RANCH UNIT 2M-2.

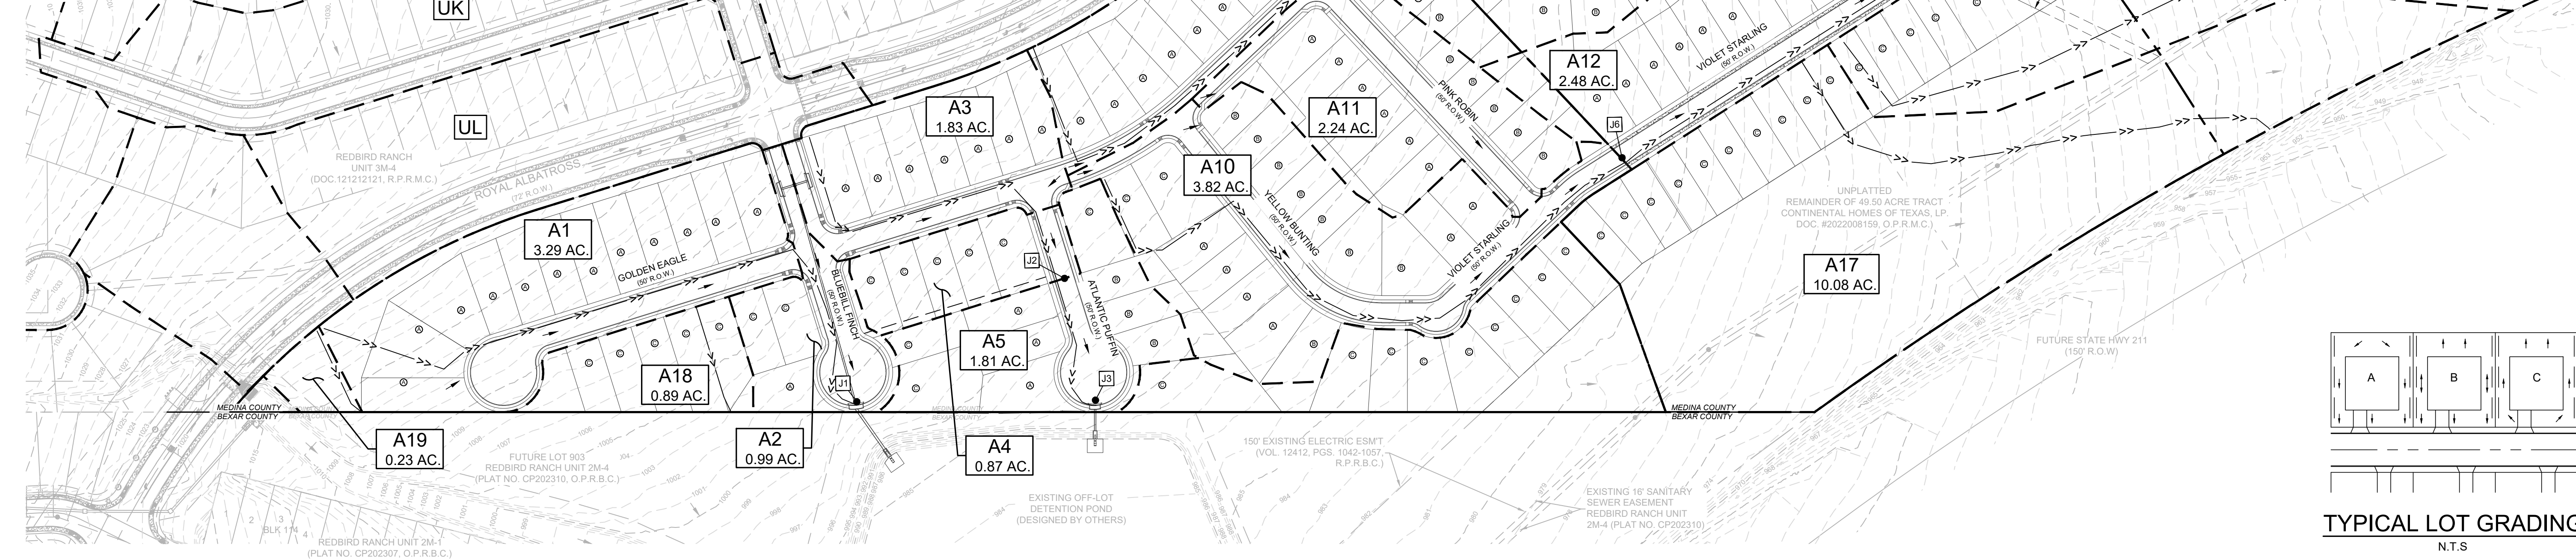

LEGEND (DRAINAGE AREA MAP)

PROJECT LIMITS

EXISTING CONTOUR

PROPOSED CONTOUR

FLOW ARROW



TYPICAL LOT GRADING

TIME OF CONCENTRATION

ANALYSIS POINT

DRAINAGE AREA

DRAINAGE AREA BOUNDARY

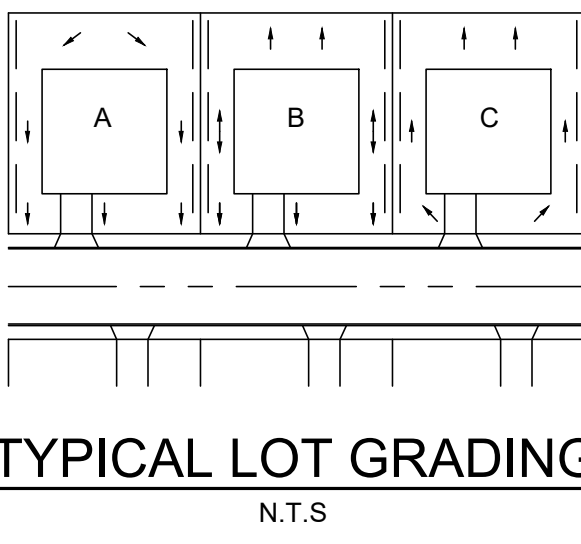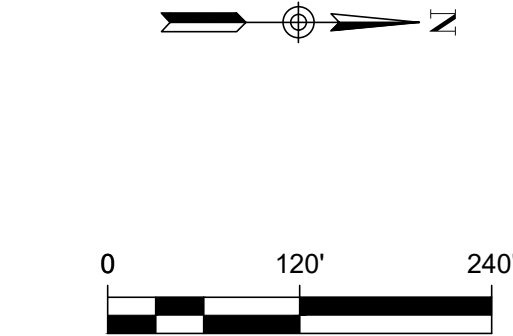

REDBIRD RANCH UNIT 2M-2  
SAN ANTONIO, TX  
ULTIMATE DRAINAGE AREA  
MAP

DESIGNED BY: JWS  
DRAWN BY: SQV/JWS  
DATE: 3/20/2024  
JOB NO.: 05000-200  
SHEET NO.: C1.02

3/20/2024  
VANCE L. WEYLAND  
PROFESSIONAL ENGINEER  
99269  
T.B.P.E. REG. NO. F-19561


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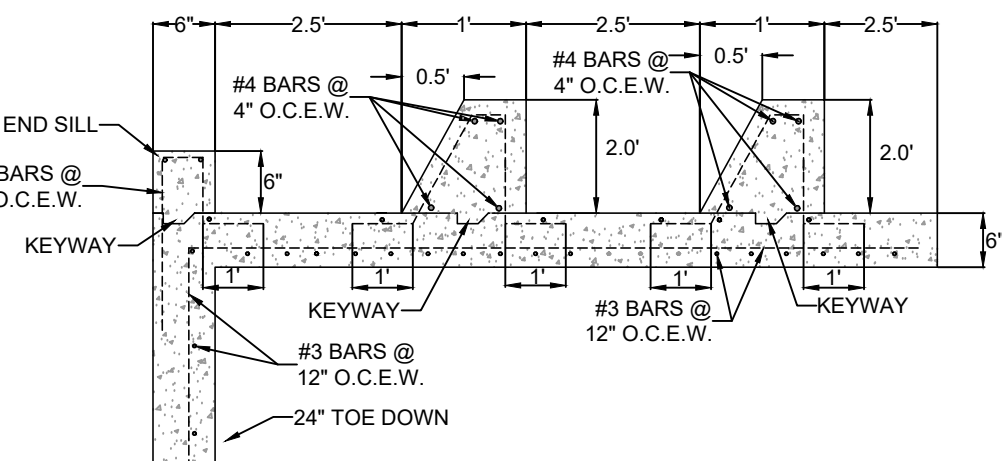
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REDBIRD RANCH UNIT 2M-2  
DOC: # XXXXXXXXXXXXX






DETAIL "A"  
STA. 1+09.96 - STA. 1+41.96  
N.T.S.

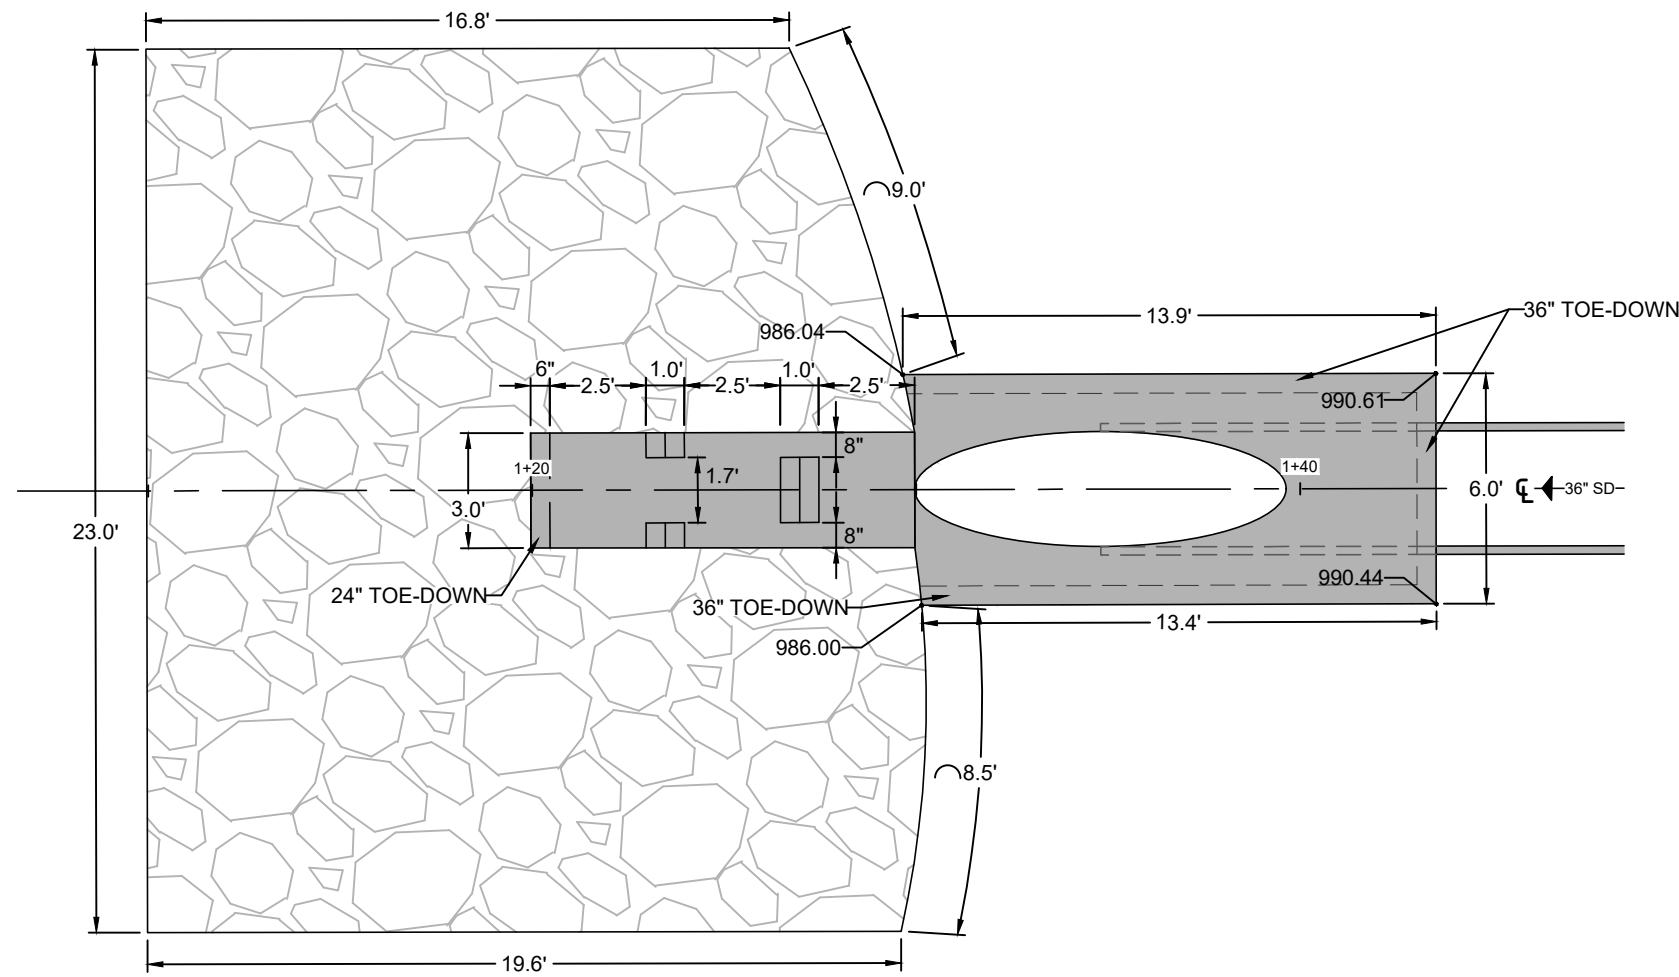

TYPICAL BAFFLE BLOCK DETAIL  
N.T.S.


DRAIN 'A' DISSIPATER CALCULATIONS			
Q (cfs)=	68.90	Wb (Basin Width)	3.00
Froude Number (Fr)=	1.738	Lb (Length of Basin)	8.37
Culvert Span or Bottom Width of Channel (ft)	3	Bw (Width of Baffle Block)	1.5
Culvert Rise or Top of Channel (ft)	3	Space Between Blocks	1.5
Number of Barrels	1	Nb (Number Of Blocks)	1
n	0.013	Height of Blocks	1.98
Slope (ft/ft)	0.018	Distance to Floor Blocks	2.79
Velocity (ft/s)	13.88	Depth of Tail Water above the Stilling Basin Floor	3.27
Y1 (Depth Before Jump)	1.98	Height of Max Tail Water	4.29
Y2 (Sequent Depth Downstream)	3.04	Velocity after Baffle Blocks (fps)	7.02
C	1.07	Height of Sill End	0.20
Y2'	3.27	Thickness of Baffle Blocks	0.396
Z	1.01	C=1.1/(Fr) <sup>2/3</sup> (120)	When 1.7< Fr<5.5
		C=0.85	When 5.5< Fr<11
		C=1.0/(Fr) <sup>2/3</sup> (800)	When 11< Fr<17

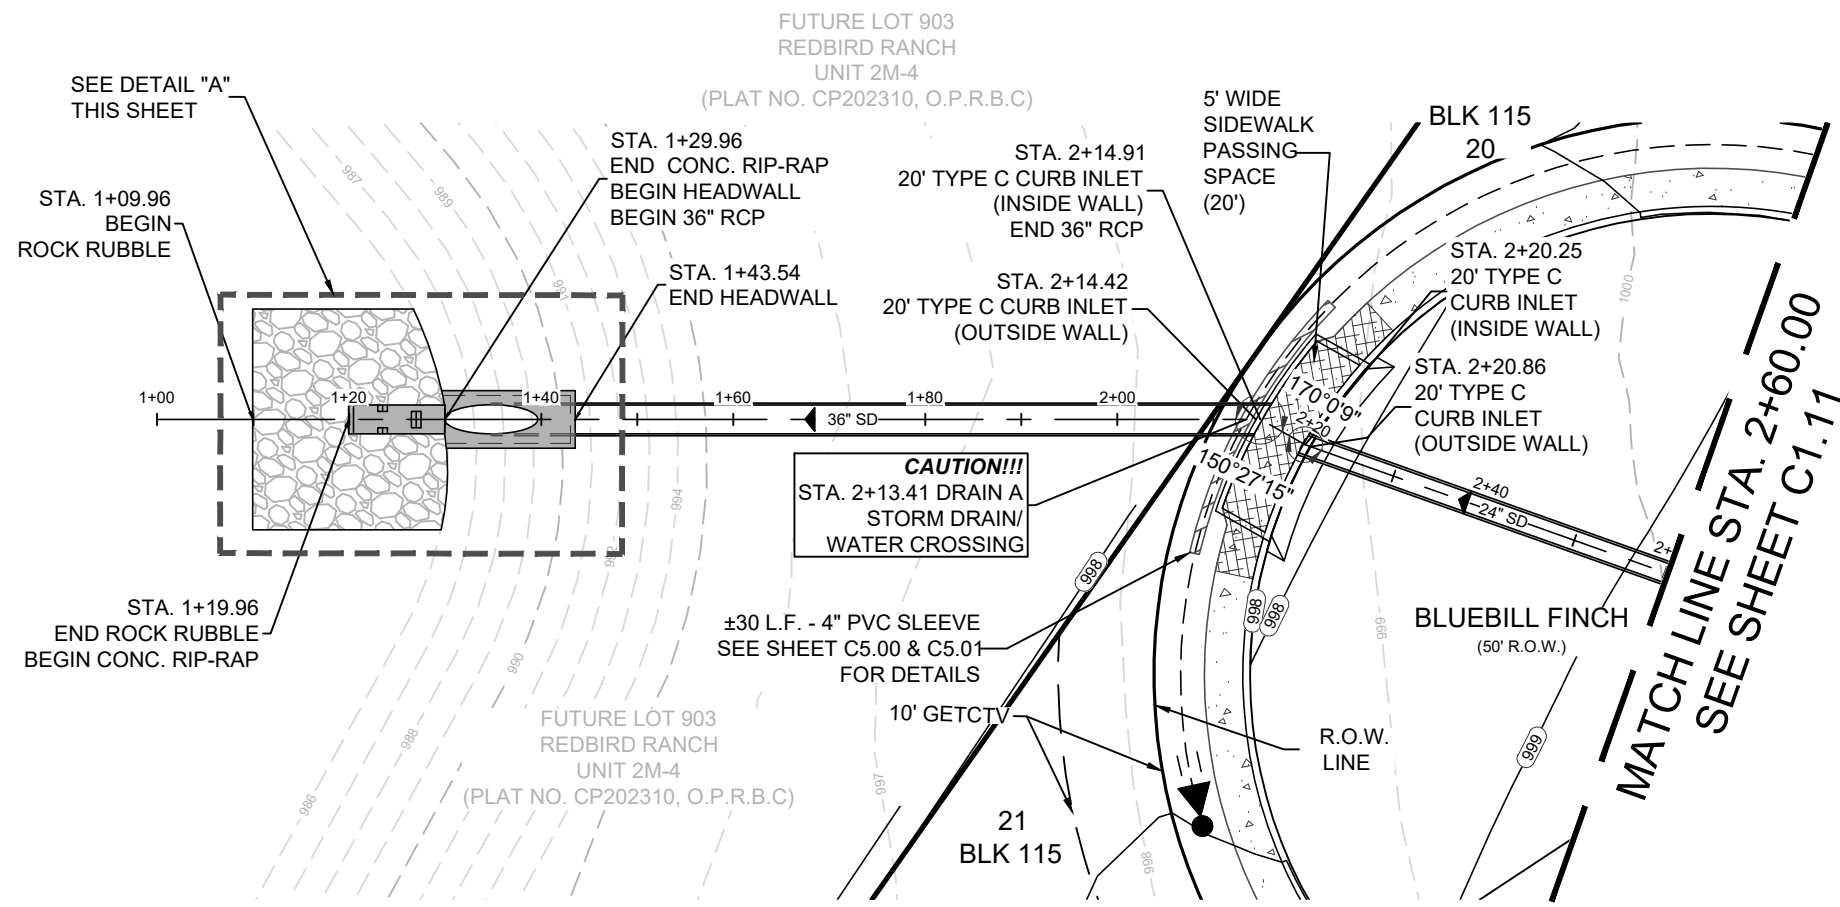

HYDRAULIC CALCULATION	
1-20' CURB INLET	
$L = \frac{Q_{25} (CFS)}{C(h^{3/2})}$	
$L = \frac{34.90}{3.087(0.79^{3/2})}$	
$L = 16.10'$	
*USE INLET WITH A TOTAL MIN. OPENING LENGTH OF 20'	

LEGEND (DRAIN)	
	EXISTING CONTOUR
	PROPOSED CONTOUR
	PROJECT LIMITS
	PROPOSED WATER
	PROPOSED SEWER
	PROPOSED MANHOLE
	FIRE HYDRANTS
	PROPOSED WYE & LATERAL
	SINGLE WATER SERVICE
	DUEL WATER SERVICE
	STREET LIGHTS
	GAS, ELECTRIC, TELEPHONE & CABLE TELEVISION EASEMENT
	DRIVEWAY
	TOP OF CURB
	GUTTER
	FLOWLINE

DRAIN A  
1+00.00 - 2+60.00

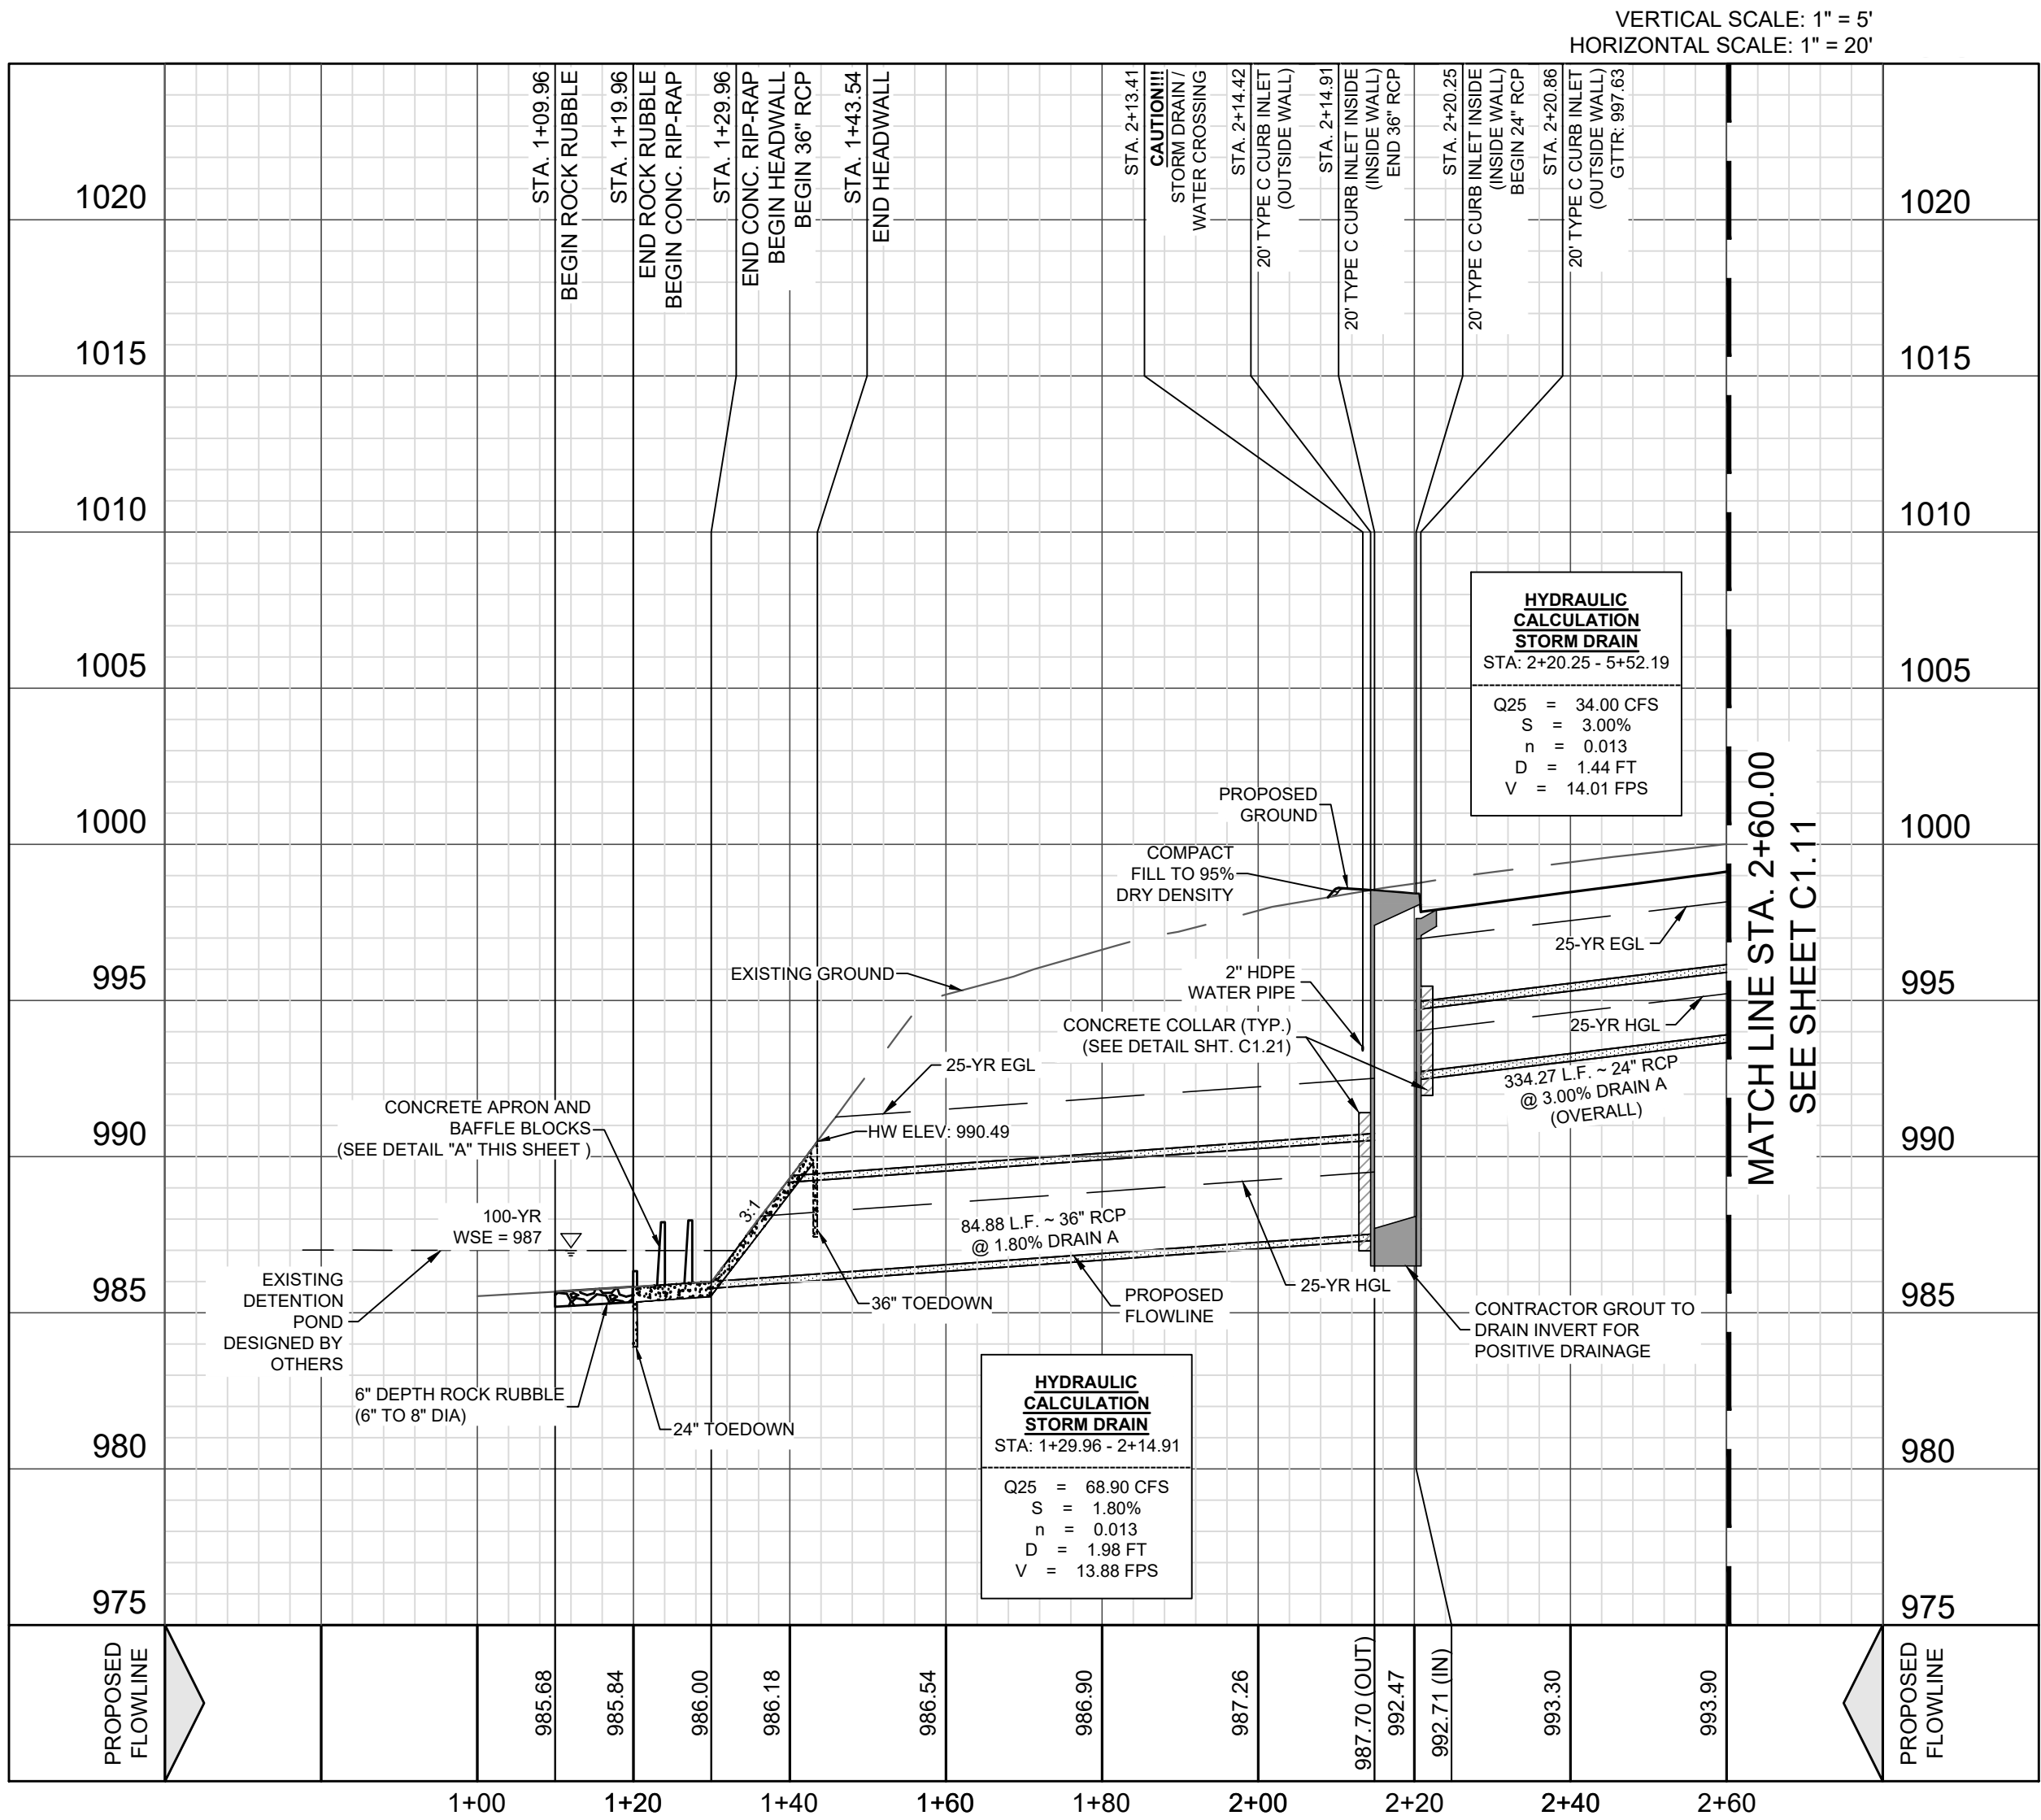

- CPS NOTES:
- A MEDINA COUNTY ROW PERMIT MUST BE OBTAINED BEFORE WORKING IN MEDINA COUNTY ROW. CONTRACTOR SHALL COORDINATE A TRAFFIC CONTROL PLAN FOR ALL WORK WITHIN THE ROW. ADDITIONAL WORKING SIGNS MAY BE RECOMMENDED BY THE ENGINEER ONCE THE ROADWAYS ARE CONSTRUCTED.
  - THE CONTRACTOR WILL BE RESPONSIBLE FOR DETERMINING EXACT LOCATION OF ALL UTILITIES AND DRAINAGE STRUCTURES WHETHER SHOWN ON THE PLANS OR NOT. THE CONTRACTOR SHALL UNCOVER EXISTING UTILITIES PRIOR TO CONSTRUCTION TO VERIFY SIZE, GRADE, AND LOCATION. THE CONTRACTOR SHALL NOTIFY THE ENGINEER IMMEDIATELY OF ANY DEVIATIONS FROM PLANS PRIOR TO BEGINNING CONSTRUCTION. ANY DAMAGE TO EXISTING UTILITIES, WHETHER SHOWN ON THE PLANS OR NOT, SHALL BE THE CONTRACTOR'S RESPONSIBILITY TO REPAIR, AT HIS EXPENSE.
  - ALL CONCRETE FOR TXDOT DRAINAGE STRUCTURES SHALL MEET TXDOT SPECIFICATIONS. ALL OTHER CONCRETE SHALL BE CLASS "A" 3000 PSI CYLINDER STRENGTH IN 28 DAYS.
  - REFERENCE DRAINAGE DETAILS FOR PIPE TRENCH DETAILS, BOX CULVERT, HEADWALL/WINGWALL CONSTRUCTION DETAILS, AND BOX CULVERT BEDDING AND EXCAVATION LIMITS.
  - CONTRACTOR SHALL GROUT ALL CURB INLETS AND JUNCTION BOXES TO PROVIDE FOR POSITIVE DRAINAGE.
  - EARTHEN CHANNELS WILL BE VEGETATED BY SEEDING OR SODDING 85% OF THE CHANNEL SURFACE. MUST HAVE ESTABLISHED VEGETATION BEFORE BEAR COUNTY WILL ACCEPT.
  - CONTRACTOR SHALL MATCH TOP OF CHANNEL TO NATURAL GROUND AND MAINTAIN A MINIMUM CHANNEL DEPTH OF "0" AS SHOWN IN THE PROFILE.

**TRENCH EXCAVATION PROTECTION**

CONTRACTOR AND CONTRACTOR'S INDEPENDENTLY RETAINED EMPLOYEE OR STRUCTURAL DESIGN, GEOTECHNICAL, SAFETY, EQUIPMENT CONSULTANT, IF ANY, SHALL REVIEW THESE PLANS AND ANY AVAILABLE GEOTECHNICAL INFORMATION AND THE ANTICIPATED INSTALLATION SITE WITHIN THE PROJECT'S WORK AREA IN ORDER TO IMPLEMENT CONTRACTOR'S TRENCH EXCAVATION SAFETY PROTECTION SYSTEM. PROGRAMS AND PROCEDURES FOR THE PROJECT DESCRIBED IN THE CONTRACT DOCUMENTS. THE CONTRACTOR'S IMPLEMENTATION OF THESE SYSTEMS, PROGRAMS, AND PROCEDURES SHALL PROVIDE FOR ADEQUATE TRENCH EXCAVATION SAFETY PROTECTION THAT COMPLY WITH AS A MINIMUM, OSHA STANDARDS FOR TRENCH EXCAVATIONS SPECIFICALLY, CONTRACTOR AND CONTRACTOR'S INDEPENDENTLY RETAINED EMPLOYEE OR SAFETY CONSULTANT SHALL IMPLEMENT A TRENCH SAFETY PROGRAM IN ACCORDANCE WITH OSHA STANDARDS GOVERNING THE PRESENCE AND ACTIVITIES OF INDIVIDUALS WORKING IN AND AROUND TRENCH EXCAVATION.

**CAUTION!!!**

CONTRACTOR SHALL BE REQUIRED TO LOCATE ALL PUBLIC OR PRIVATE UTILITIES INCLUDING BUT NOT LIMITING TO: WATER, SEWER, TELEPHONE AND FIBER OPTIC LINES, SITE LIGHTING ELECTRIC, SECONDARY ELECTRIC, PRIMARY ELECTRICAL DUCTBANKS, LANDSCAPE IRRIGATION FACILITIES, AND GAS LINES. ANY UTILITY CONFLICTS THAT ARISE SHOULD BE COMMUNICATED TO THE ENGINEER IMMEDIATELY AND PRIOR TO CONSTRUCTION. THE CONTRACTOR SHALL CONTACT 1-800-DIG-TESS A MINIMUM OF 48 HOURS PRIOR TO THE START OF CONSTRUCTION. ANY DAMAGE TO EXISTING UTILITIES SHALL BE THE SOLE RESPONSIBILITY OF THE CONTRACTOR AND THE REPAIR SHALL BE AT CONTRACTOR'S EXPENSE WHETHER THE UTILITY IS SHOWN ON THESE PLANS OR NOT.

REDBIRD RANCH UNIT 2M-2  
SAN ANTONIO, TX


DESIGNED BY: JWS  
DRAWN BY: SQV/JWS  
DATE: 3/20/2024  
JOB NO.: 05000-200  
SHEET NO.

C1.10


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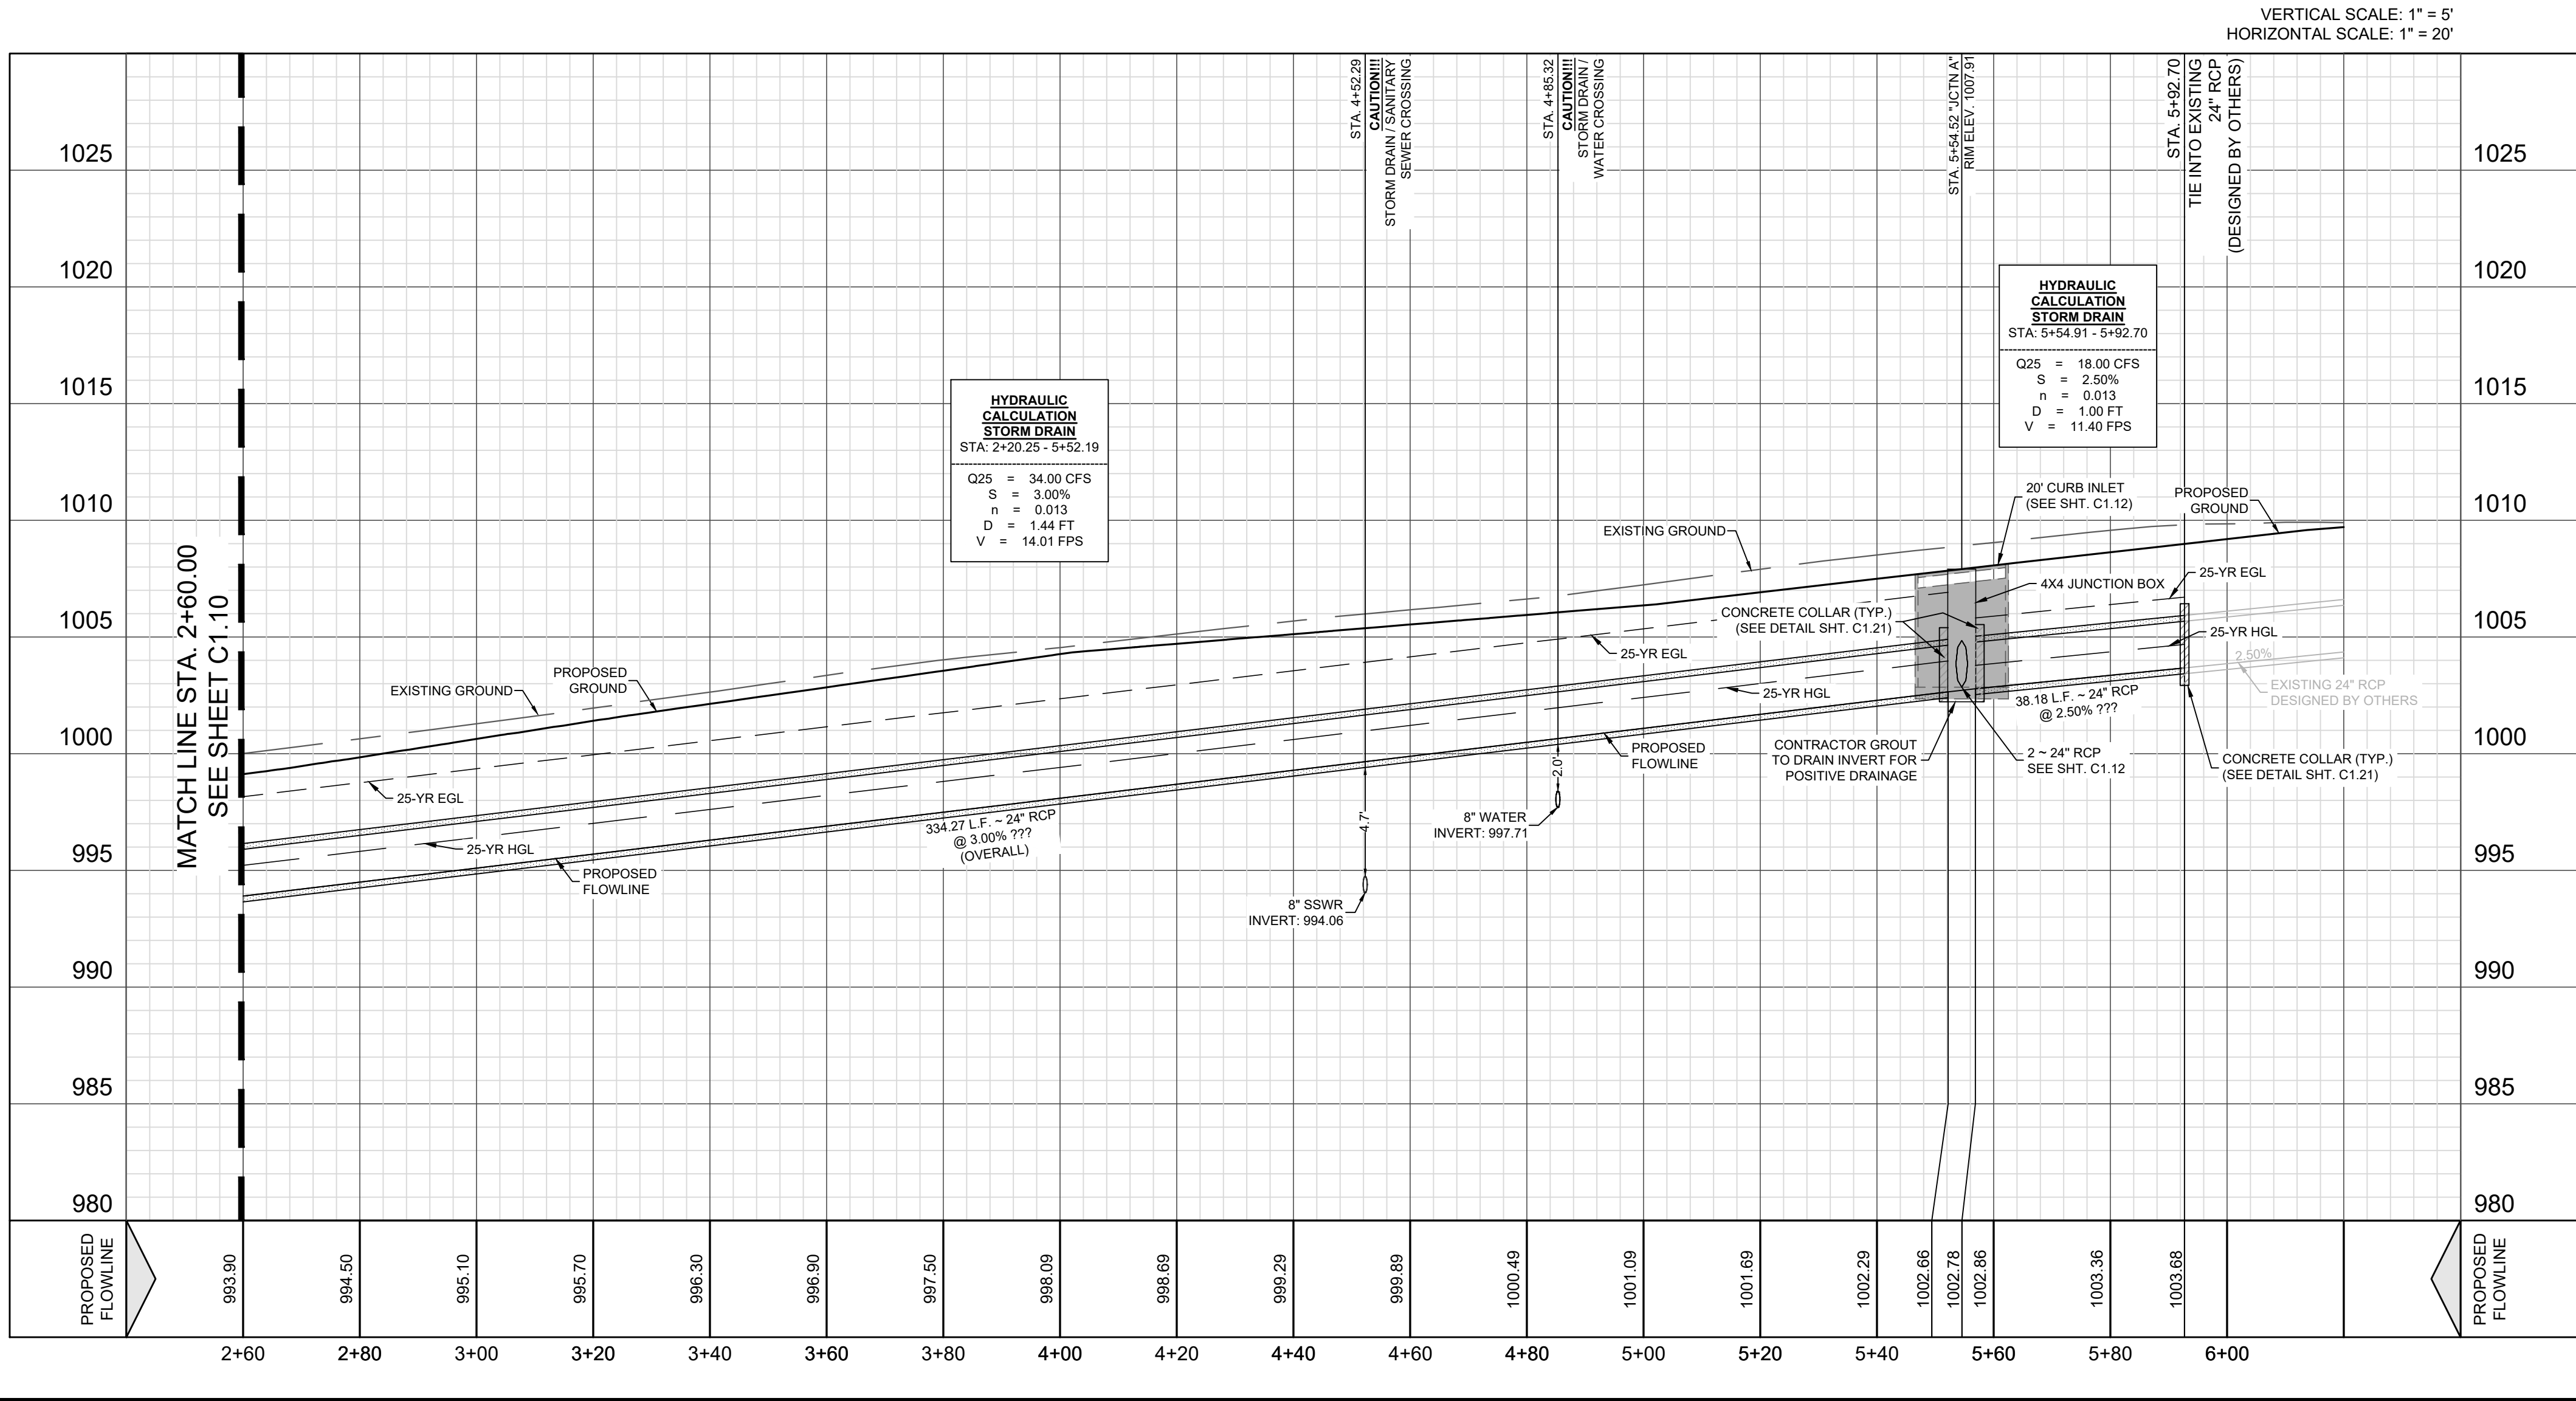
DHI Engineering, LLC.  
4419 ANTONIO LOOP 1604 EAST  
SUITE 100 SAN ANTONIO, TX 78217  
(210) 482-2988 | dhiengineering.com  
TBP REG. NO. F-19561





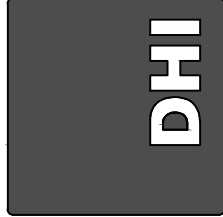

DRAIN A  
2+60.00 - 5+92.70

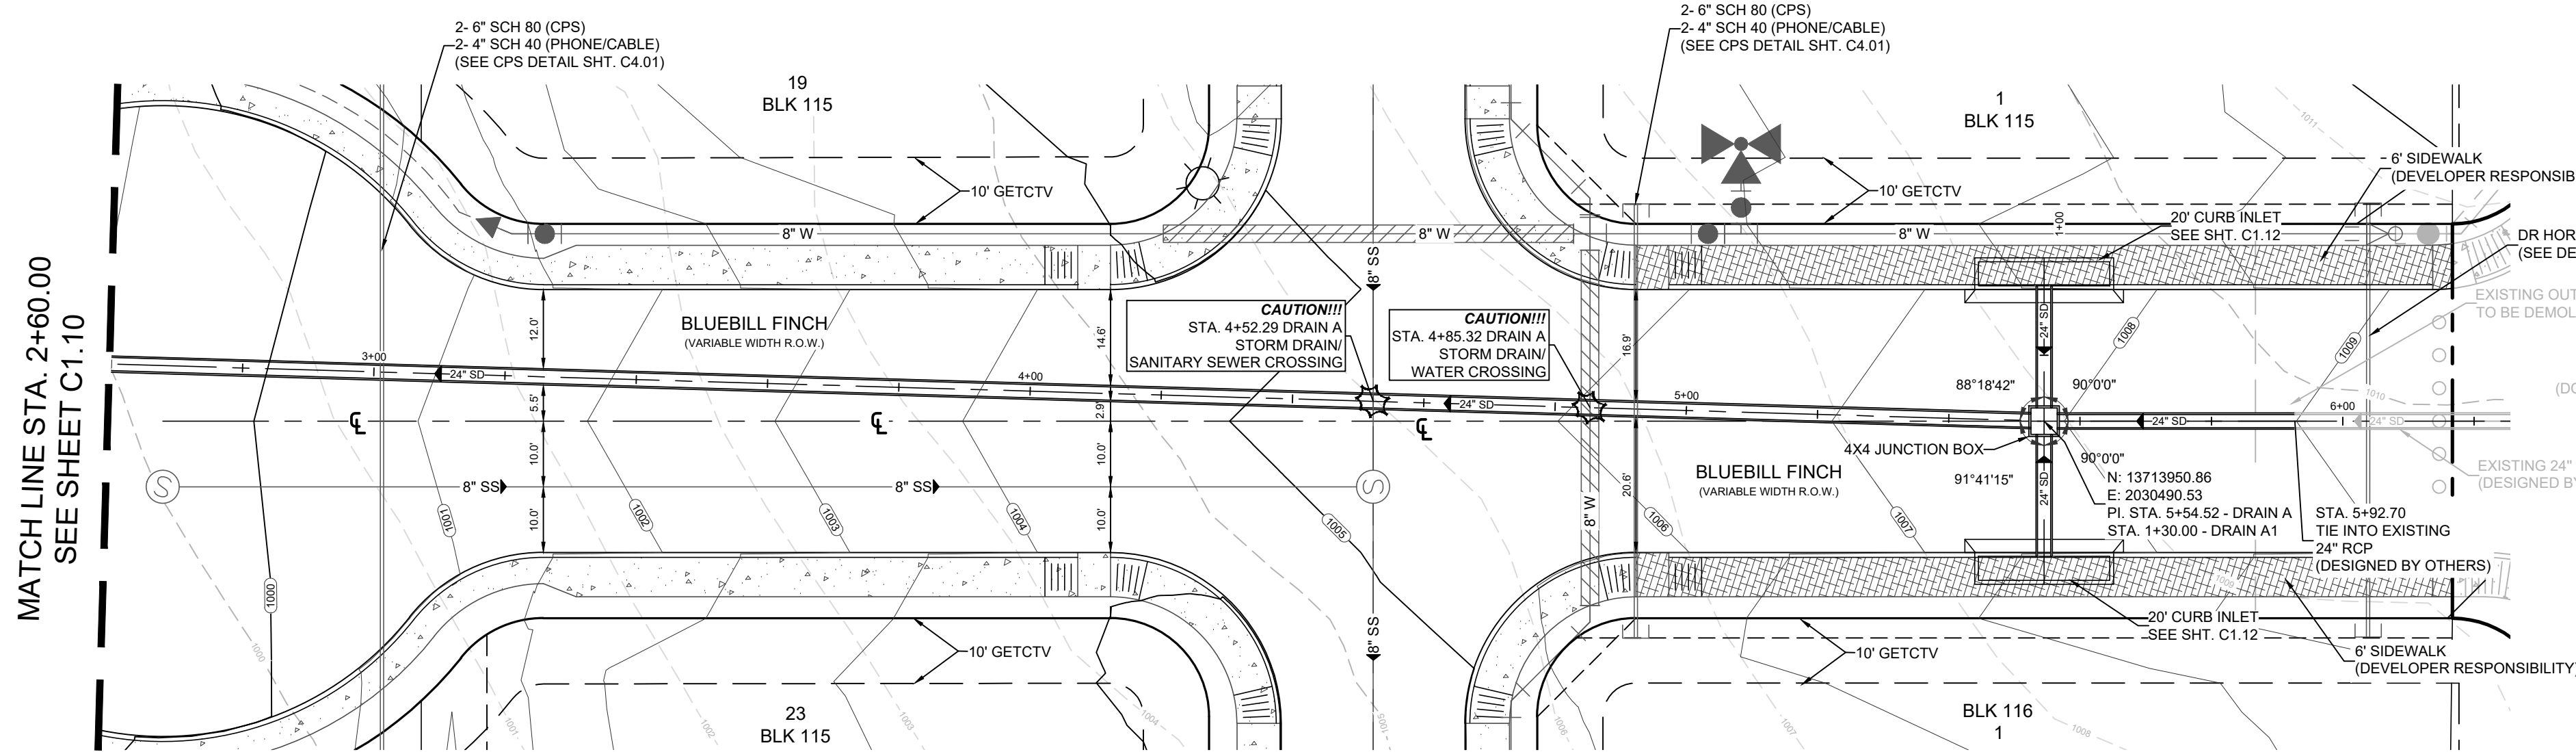

- CPS NOTES:**
1. A MEDINA COUNTY ROW PERMIT MUST BE OBTAINED BEFORE WORKING IN MEDINA COUNTY ROW. CONTRACTOR SHALL COORDINATE A TRAFFIC CONTROL PLAN FOR ALL WORK WITHIN THE ROW. ADDITIONAL WORKING SIGNS MAY BE RECOMMENDED BY THE ENGINEER ONCE THE ROADWAYS ARE CONSTRUCTED.
  2. THE CONTRACTOR WILL BE RESPONSIBLE FOR DETERMINING EXACT LOCATION OF ALL UTILITIES AND DRAINAGE STRUCTURES WHETHER SHOWN ON THE PLANS OR NOT. THE CONTRACTOR SHALL UNCOVER EXISTING UTILITIES PRIOR TO CONSTRUCTION TO VERIFY SIZE, GRADE, AND LOCATION. THE CONTRACTOR SHALL NOTIFY THE ENGINEER IMMEDIATELY OF ANY DEVIATIONS FROM PLANS PRIOR TO BEGINNING CONSTRUCTION. ANY DAMAGE TO EXISTING UTILITIES, WHETHER SHOWN ON THE PLANS OR NOT, SHALL BE THE CONTRACTOR'S RESPONSIBILITY TO REPAIR, AT HIS EXPENSE.
  3. ALL CONCRETE FOR TxDOT DRAINAGE STRUCTURES SHALL MEET TxDOT SPECIFICATIONS. ALL OTHER CONCRETE SHALL BE CLASS "A" 3000 PSI CYLINDER STRENGTH IN 28 DAYS.
  4. REFERENCE DRAINAGE DETAILS FOR PIPE TRENCH DETAILS, BOX CULVERT, HEADWALL, WINGWALL, CONSTRUCTION DETAILS, AND BOX CULVERT BEDDING AND EXCAVATION LIMITS.
  5. CONTRACTOR SHALL GROUT ALL CURB INLETS AND JUNCTION BOXES TO PROVIDE FOR POSITIVE DRAINAGE.
  6. EARTHEN CHANNELS WILL BE VEGETATED BY SEEDING OR SODDING 85% OF THE CHANNEL SURFACE. MUST HAVE ESTABLISHED VEGETATION BEFORE BEAR COUNTY WILL ACCEPT.
  7. CONTRACTOR SHALL MATCH TOP OF CHANNEL TO NATURAL GROUND AND MAINTAIN A MINIMUM CHANNEL DEPTH OF "0" AS SHOWN IN THE PROFILE.

**TRENCH EXCAVATION PROTECTION**

CONTRACTOR AND CONTRACTOR'S INDEPENDENTLY RETAINED EMPLOYEE OR STRUCTURAL DESIGN, GEOTECHNICAL, SAFETY, EQUIPMENT CONSULTANT, IF ANY, SHALL REVIEW THESE PLANS AND ANY AVAILABLE GEOTECHNICAL INFORMATION AND THE ANTICIPATED INSTALLATION SITE WITHIN THE PROJECT'S WORK AREA IN ORDER TO IMPLEMENT CONTRACTOR'S TRENCH EXCAVATION SAFETY PROTECTION SYSTEM. PROGRAMS AND/OR PROCEDURES FOR THE PROJECT DESCRIBED IN THE CONTRACT DOCUMENTS. THE CONTRACTOR'S IMPLEMENTATION OF THESE SYSTEMS, PROGRAMS, AND PROCEDURES SHALL PROVIDE FOR ADEQUATE TRENCH EXCAVATION SAFETY PROTECTION THAT COMPLY WITH AS A MINIMUM, OSHA STANDARDS FOR TRENCH EXCAVATIONS SPECIFICALLY. CONTRACTOR AND CONTRACTOR'S INDEPENDENTLY RETAINED EMPLOYEE OR SAFETY CONSULTANT SHALL IMPLEMENT A TRENCH SAFETY PROGRAM IN ACCORDANCE WITH OSHA STANDARDS GOVERNING THE PRESENCE AND ACTIVITIES OF INDIVIDUALS WORKING IN AND AROUND TRENCH EXCAVATION.

**CAUTION!!!**

CONTRACTOR SHALL BE REQUIRED TO LOCATE ALL PUBLIC OR PRIVATE UTILITIES INCLUDING BUT NOT LIMITING TO: WATER, SEWER, TELEPHONE AND FIBER OPTIC LINES, SITE LIGHTING ELECTRIC, SECONDARY ELECTRIC, PRIMARY ELECTRICAL DUCTBANKS, LANDSCAPE IRRIGATION FACILITIES, AND GAS LINES. ANY UTILITY CONFLICTS THAT ARISE SHOULD BE COMMUNICATED TO THE ENGINEER IMMEDIATELY AND PRIOR TO CONSTRUCTION. THE CONTRACTOR SHALL CONTACT 1-800-DIG-IT-ESS A MINIMUM OF 48 HOURS PRIOR TO THE START OF CONSTRUCTION. ANY DAMAGE TO EXISTING UTILITIES SHALL BE THE SOLE RESPONSIBILITY OF THE CONTRACTOR AND THE REPAIR SHALL BE AT CONTRACTOR'S EXPENSE WHETHER THE UTILITY IS SHOWN ON THESE PLANS OR NOT.

LEGEND (DRAIN)	
	EXISTING CONTOUR
	PROPOSED CONTOUR
	PROJECT LIMITS
	PROPOSED WATER
	PROPOSED SEWER
	PROPOSED MANHOLE
	FIRE HYDRANTS
	PROPOSED WYE & LATERAL
	SINGLE WATER SERVICE
	DUEL WATER SERVICE
	STREET LIGHTS
	GAS, ELECTRIC, TELEPHONE & CABLE TELEVISION EASEMENT
	DRIVEWAY
	TOP OF CURB
	GUTTER
	FLOWLINE

REDBIRD RANCH UNIT 2M-2  
SAN ANTONIO, TX

DESIGNED BY: JWS  
DRAWN BY: SQV/JWS  
DATE: 3/20/2024  
JOB NO.: 05000-200  
SHEET NO. C1.11

3/20/2024


Vance L. Weynand  
DHI Engineering, LLC.  
4419 ANTONIO EAST  
SUITE 100  
SAN ANTONIO, TX 78217  
(210) 482-2988 | dhiengineering.com  
TBP REG. NO. F-195661

REV. DATE. DESCRIPTION

Doc: Mar 20, 2024, 11:52am User: JWS File: \\vhbpc001\user\jws\REDBIRD\PS\Engineering\PROJECT\05000-200\0500 - Design\030 - Sheet\01.11 DRAIN A - STA. 2+60.00 - END.dwg


REDBIRD RANCH UNIT 2M-2 DOC. # XXXXXXXXXX



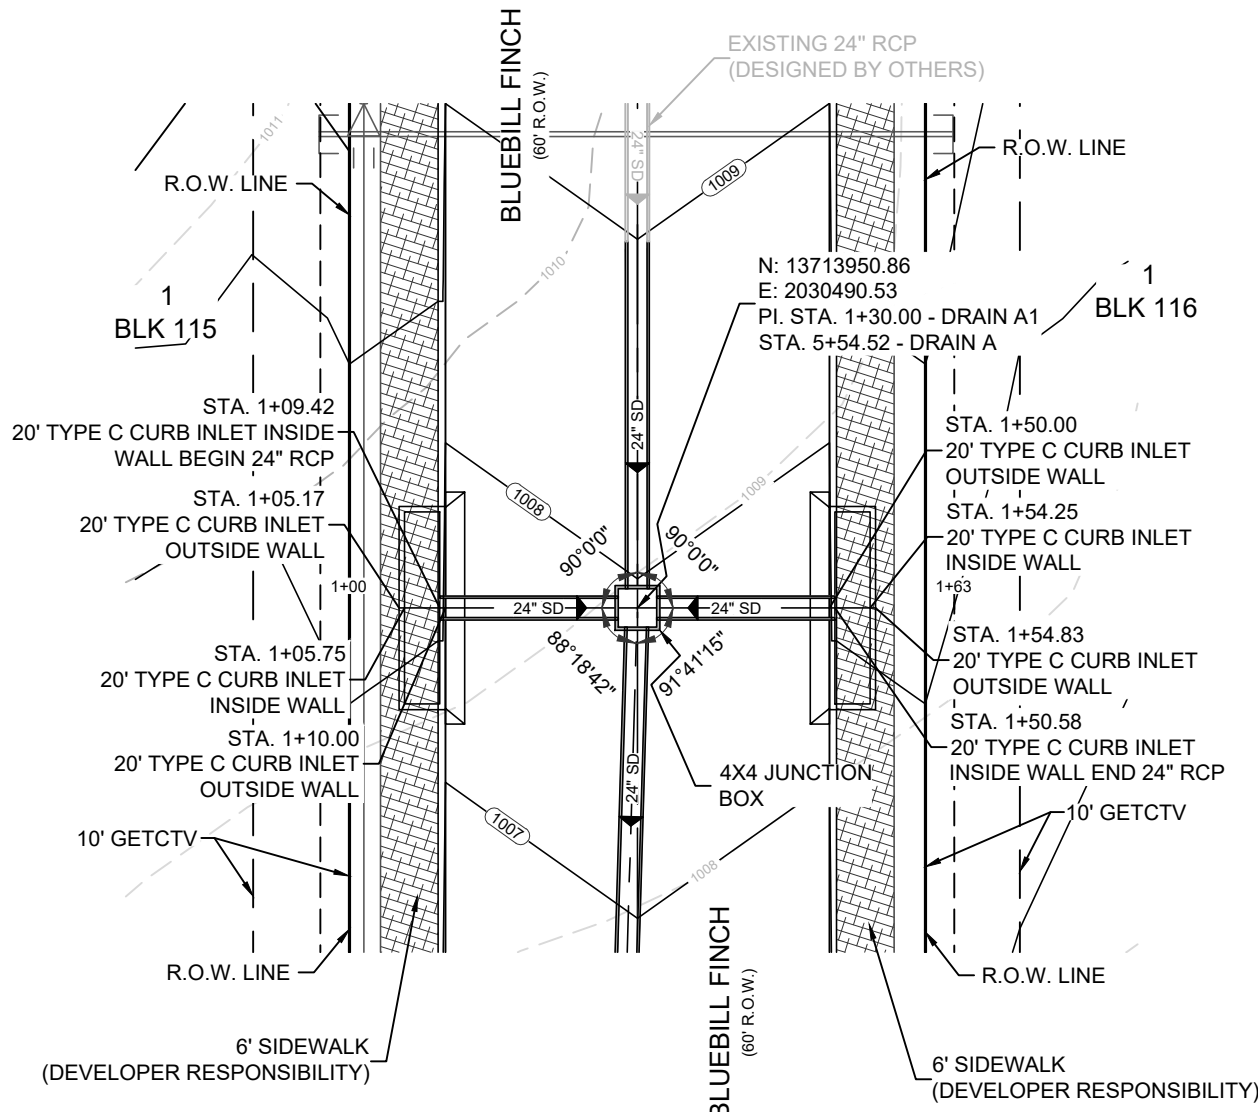

HYDRAULIC CALCULATION	
1-20\"/>	
INLET	
$Q_{20}/2 = 12$ CFS	
$S = 2.83\%$	
$L = 20'$ INLETS	
$Q_{CAPTURED} = 8$ CFS	
$Q_{BYPASSED} = 4$ CFS	

DRAIN A1  
1+00.00 - 1+54.83

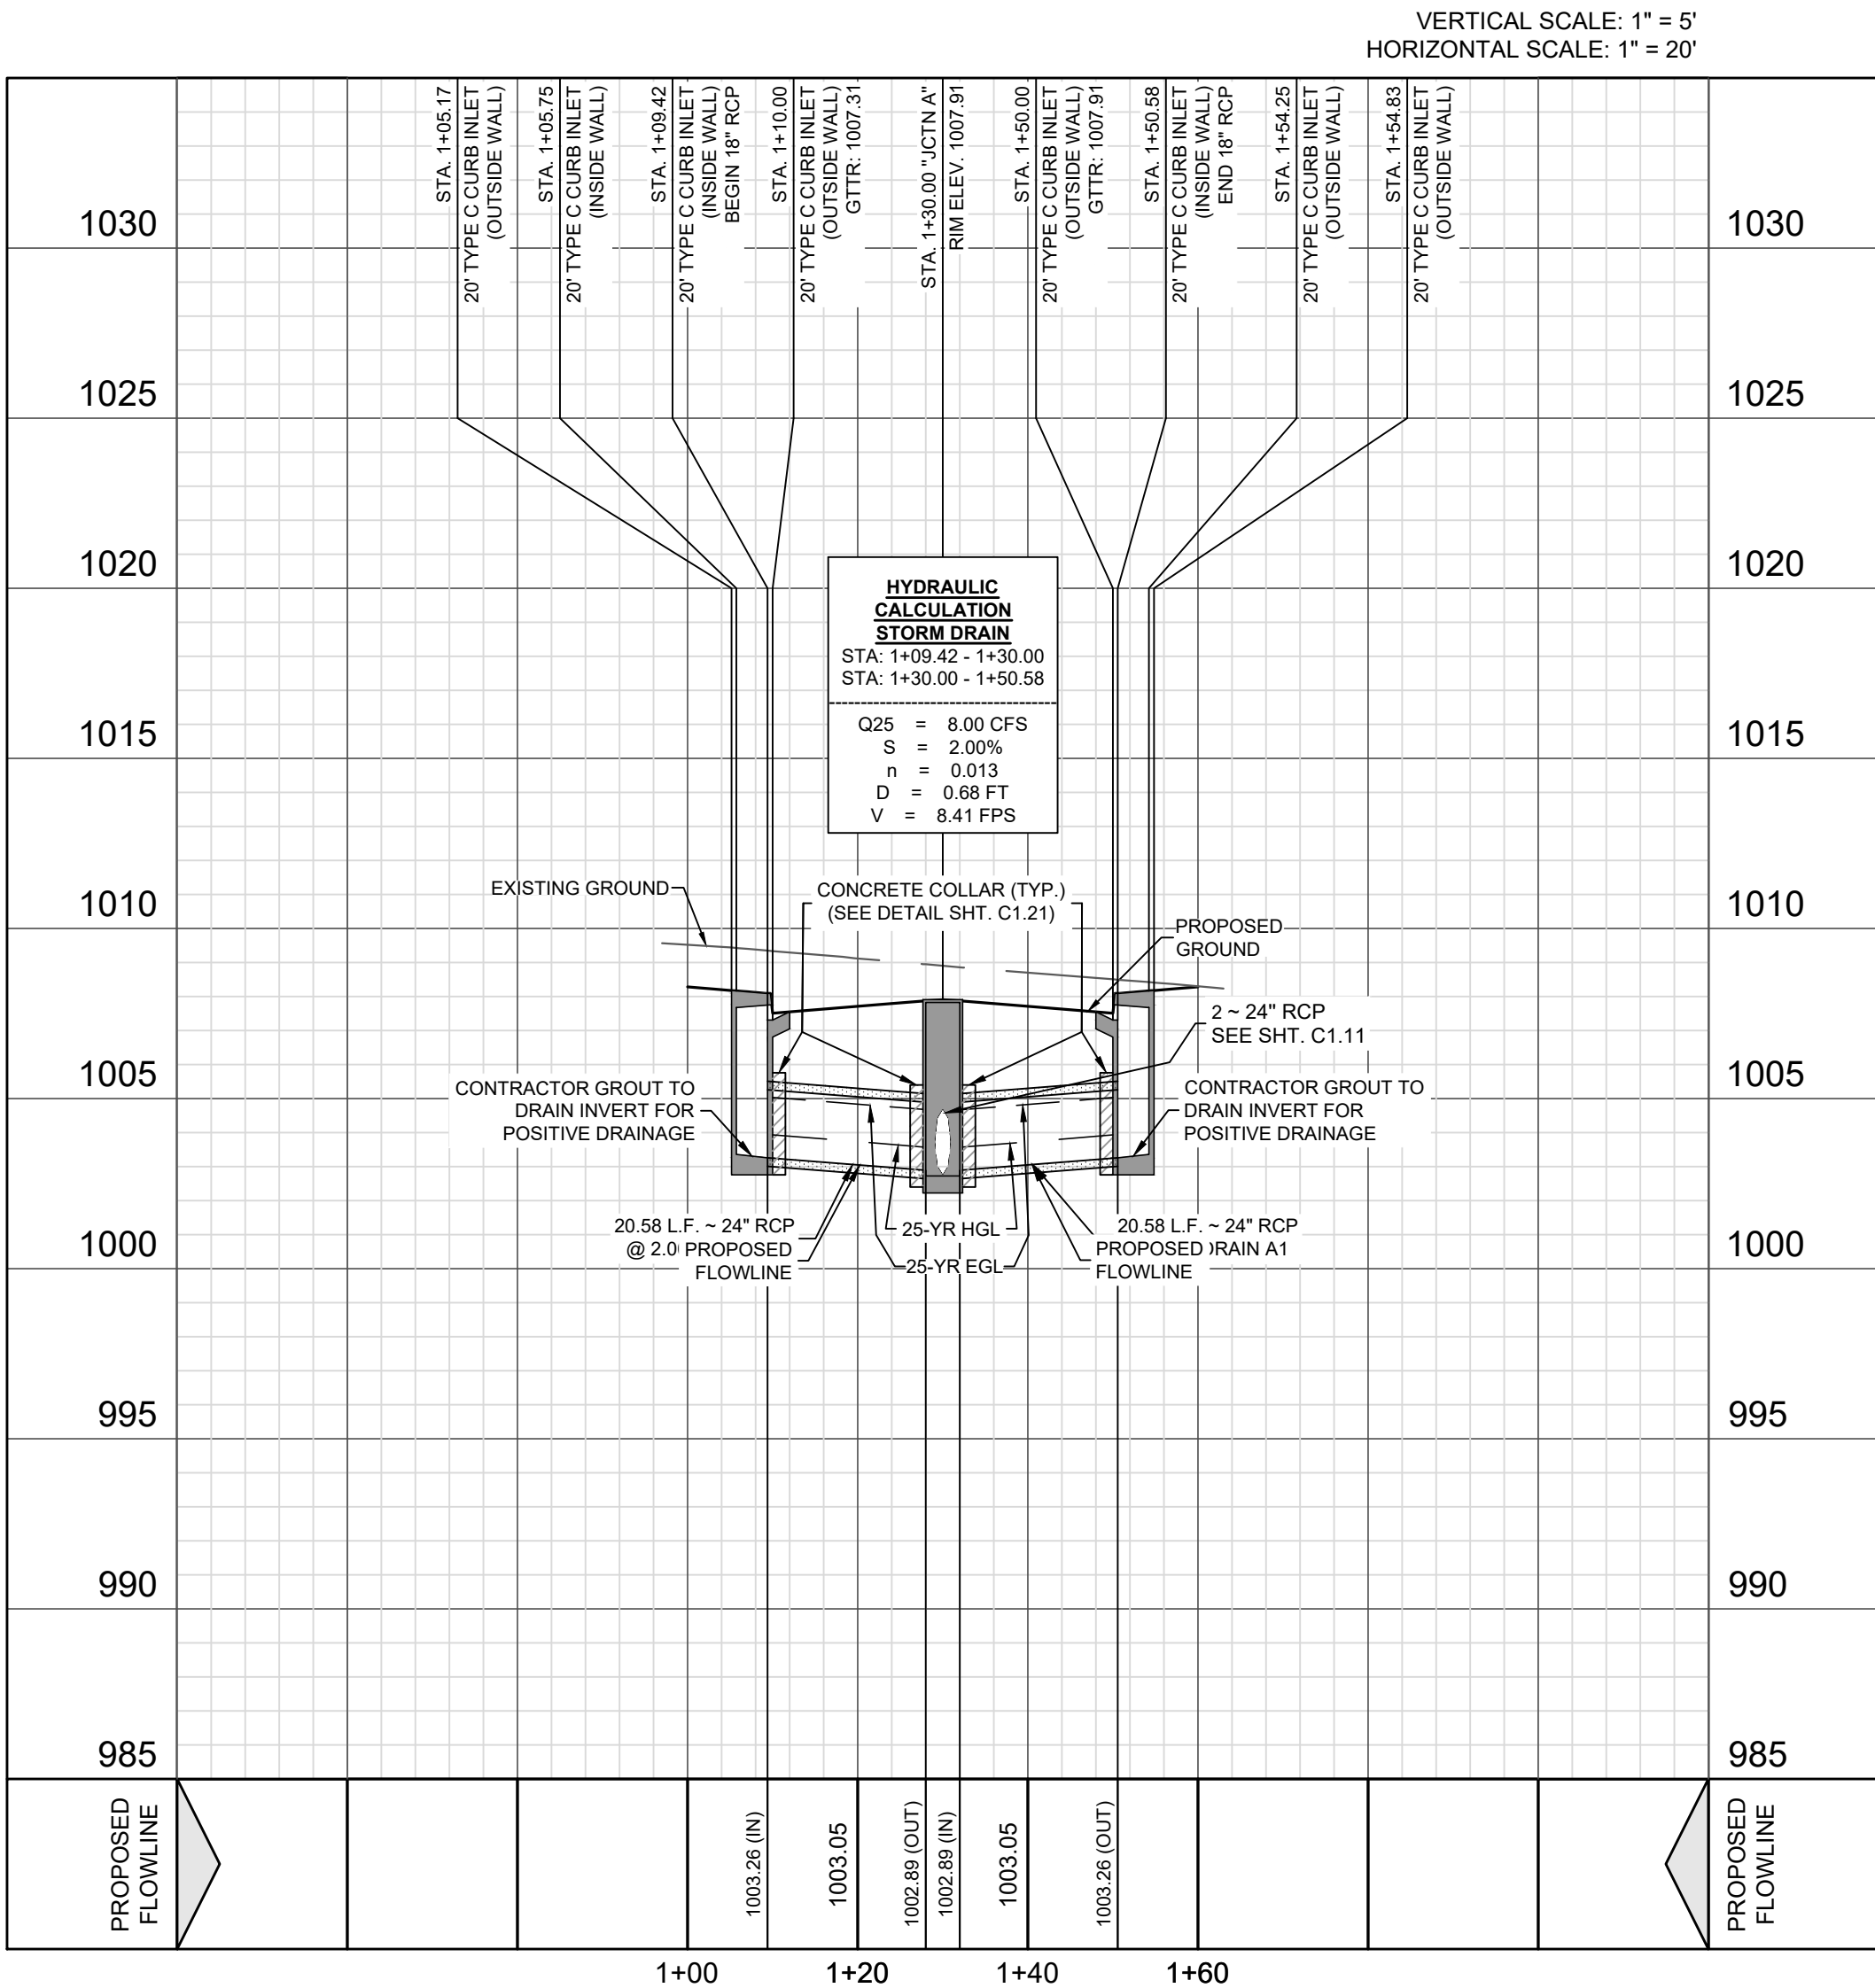

- CPS NOTES:**
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  - ALL CONCRETE FOR TxDOT DRAINAGE STRUCTURES SHALL MEET TxDOT SPECIFICATIONS. ALL OTHER CONCRETE SHALL BE CLASS "A" 3000 PSI CYLINDER STRENGTH IN 28 DAYS.
  - REFERENCE DRAINAGE DETAILS FOR PIPE TRENCH DETAILS, BOX CULVERT, HEADWALL, WINGWALL CONSTRUCTION DETAILS, AND BOX CULVERT BEDDING AND EXCAVATION LIMITS.
  - CONTRACTOR SHALL GROUT ALL CURB INLETS AND JUNCTION BOXES TO PROVIDE FOR POSITIVE DRAINAGE.
  - EARTHEN CHANNELS WILL BE VEGETATED BY SEEDING OR SODDING 85% OF THE CHANNEL SURFACE. MUST HAVE ESTABLISHED VEGETATION BEFORE BEXAR COUNTY WILL ACCEPT.
  - CONTRACTOR SHALL MATCH TOP OF CHANNEL TO NATURAL GROUND AND MAINTAIN A MINIMUM CHANNEL DEPTH OF "0" AS SHOWN IN THE PROFILE.

**TRENCH EXCAVATION PROTECTION**

CONTRACTOR AND CONTRACTOR'S INDEPENDENTLY RETAINED EMPLOYEE OR STRUCTURAL DESIGN, GEO-TECHNICAL, SAFETY, EQUIPMENT CONSULTANT, IF ANY, SHALL REVIEW THESE PLANS AND ANY AVAILABLE GEOTECHNICAL INFORMATION AND THE ANTICIPATED INSTALLATION SITE WITHIN THE PROJECT'S WORK AREA IN ORDER TO IMPLEMENT CONTRACTOR'S TRENCH EXCAVATION SAFETY PROTECTION SYSTEM. PROGRAMS AND/OR PROCEDURES FOR THE PROJECT DESCRIBED IN THE CONTRACT DOCUMENTS. THE CONTRACTOR'S IMPLEMENTATION OF THESE SYSTEMS, PROGRAMS, AND PROCEDURES SHALL PROVIDE FOR ADEQUATE TRENCH EXCAVATION SAFETY PROTECTION THAT COMPLY WITH AS A MINIMUM, OSHA STANDARDS FOR TRENCH EXCAVATIONS SPECIFICALLY. CONTRACTOR AND CONTRACTOR'S INDEPENDENTLY RETAINED EMPLOYEE OR SAFETY CONSULTANT SHALL IMPLEMENT A TRENCH SAFETY PROGRAM IN ACCORDANCE WITH OSHA STANDARDS GOVERNING THE PRESENCE AND ACTIVITIES OF INDIVIDUALS WORKING IN AND AROUND TRENCH EXCAVATION.

**CAUTION!!!**

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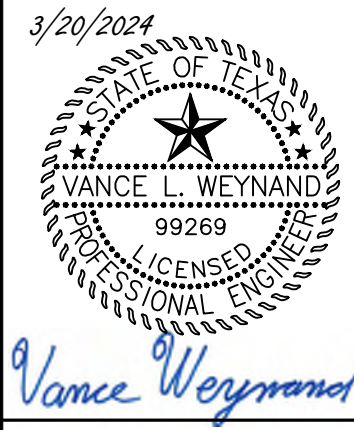
REDBIRD RANCH UNIT 2M-2  
SAN ANTONIO, TX

DRAIN A1 - STA. 1+00.00 TO END


DESIGNED BY: JWS  
DRAWN BY: SQV/JWS  
DATE: 3/20/2024  
JOB NO.: 05000-200  
SHEET NO.

C1.12


REV	DATE	DESCRIPTION




DHI Engineering, LLC.  
4419 ANTONIO EAST  
SUITE 100  
SAN ANTONIO, TX 78217  
(210) 482-2988 | dhiengineering.com  
TBP REG. NO. F-195661

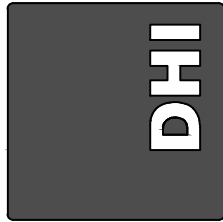



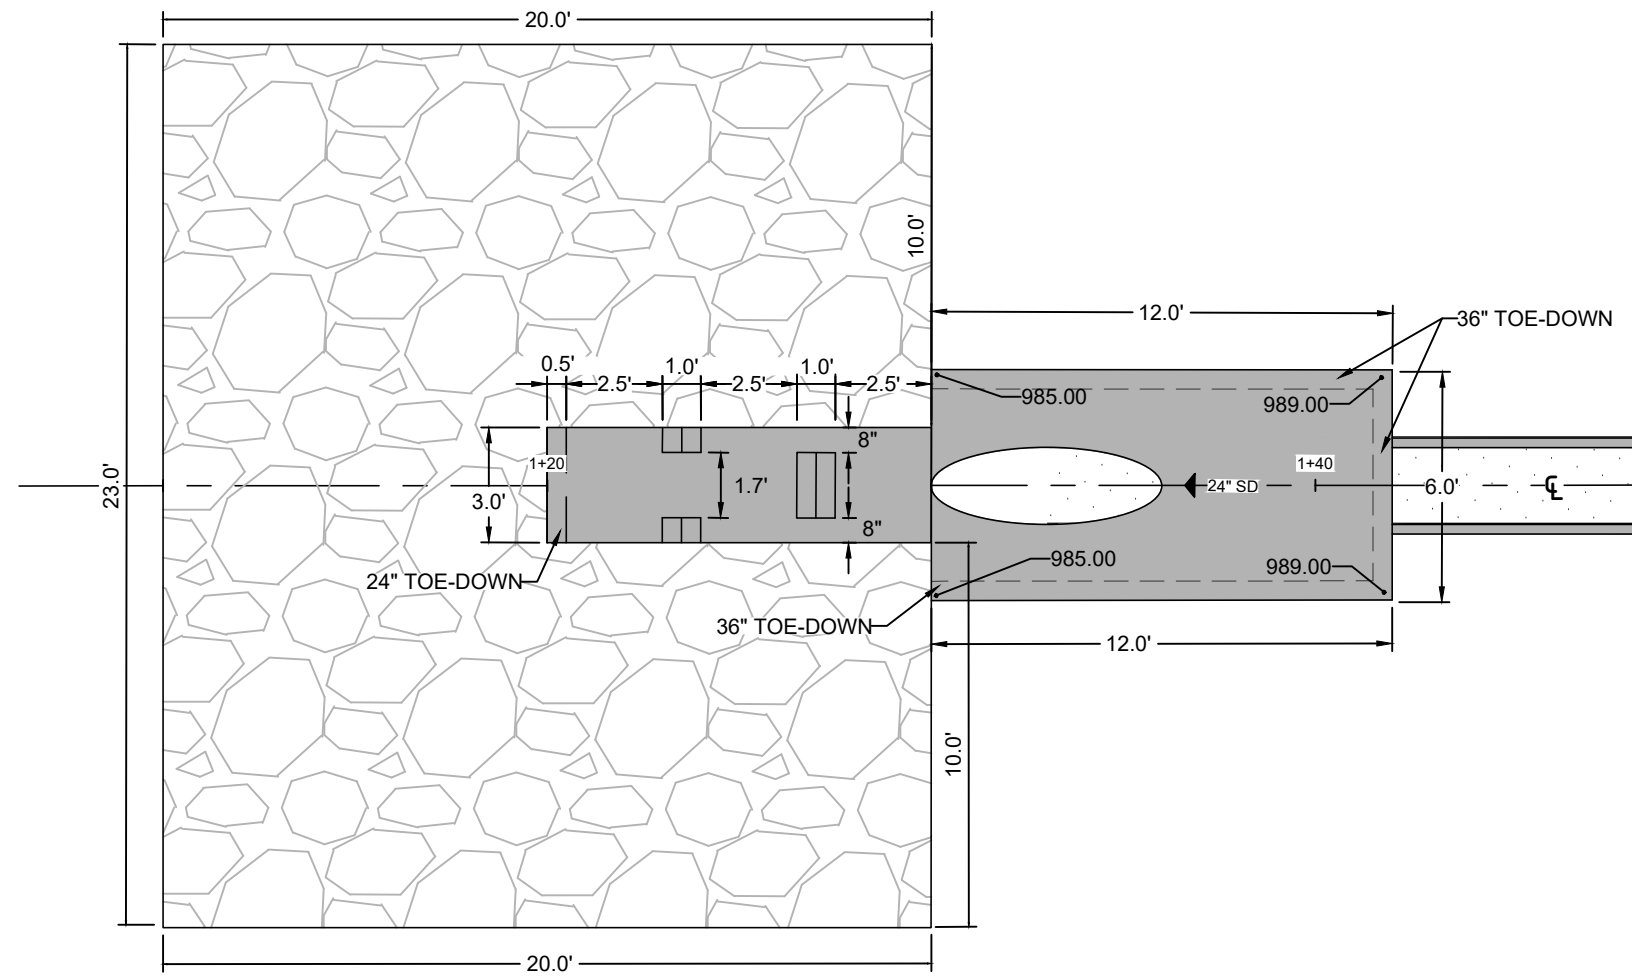


DETAIL "A"  
STA. 1+10.00 - STA. 1+42.00  
N.T.S.

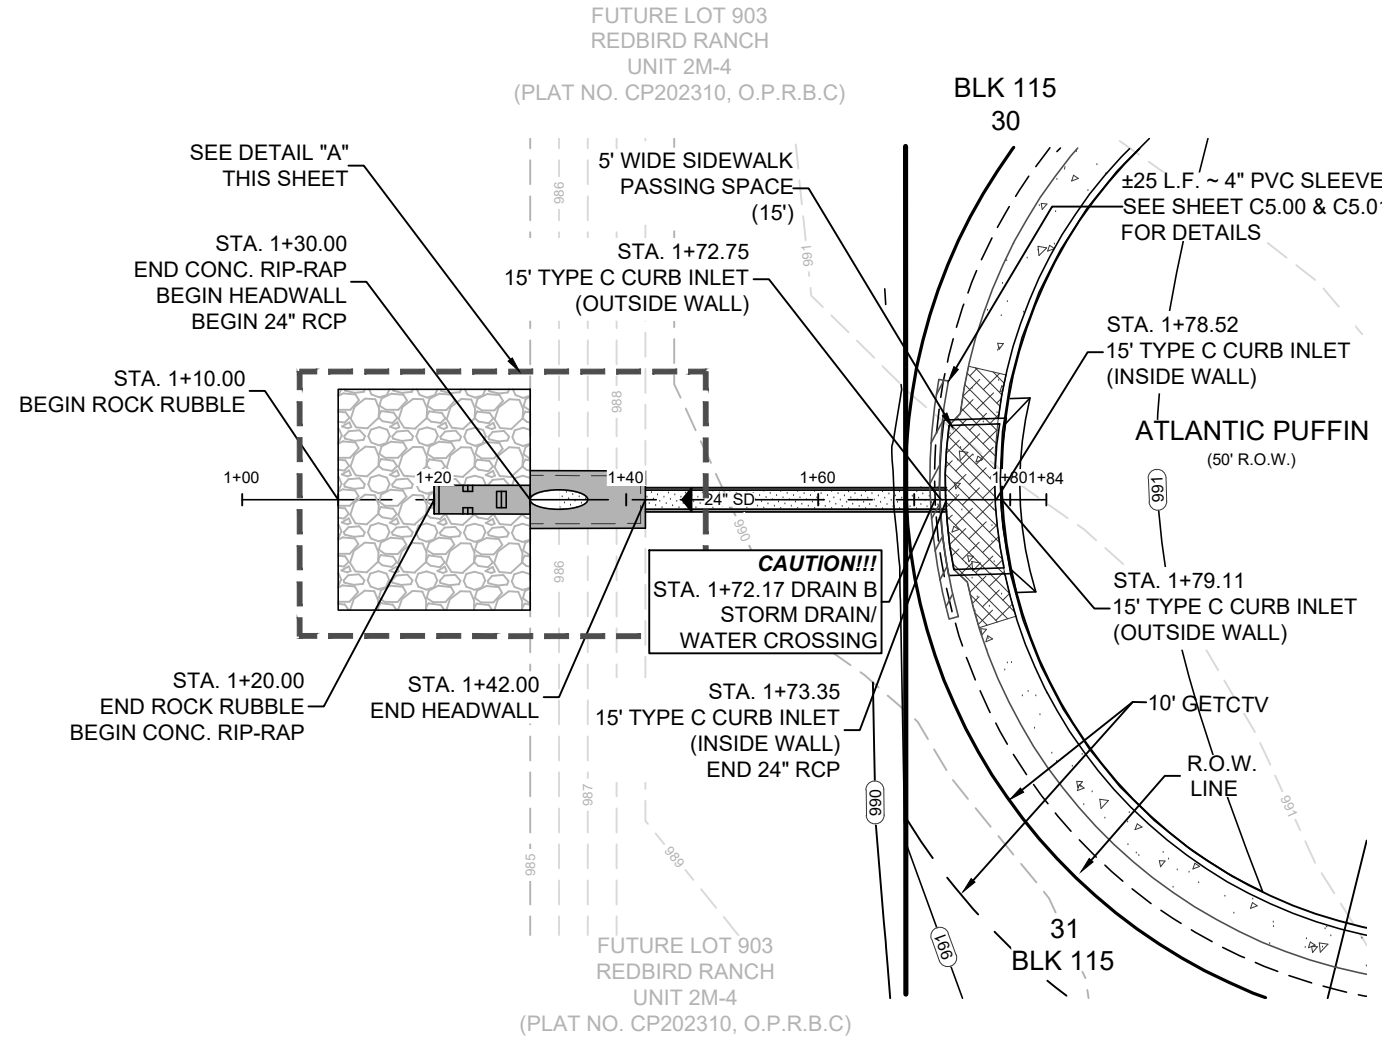


HYDRAULIC CALCULATION	
1-15' CURB INLET	
$L = \frac{Q_{25} \text{ (CFS)}}{C(h^{3/2})}$	
$L = \frac{27.00}{3.087(0.79^{3/2})}$	
$L = 12.46'$	
*USE INLETS WITH A TOTAL LENGTH OF 15' OPENING MIN	

LEGEND (DRAIN)	
	EXISTING CONTOUR
	PROPOSED CONTOUR
	PROJECT LIMITS
	PROPOSED WATER
	PROPOSED SEWER
	PROPOSED MANHOLE
	FIRE HYDRANTS
	PROPOSED WYE & LATERAL
	SINGLE WATER SERVICE
	DUEL WATER SERVICE
	STREET LIGHTS
	GAS, ELECTRIC, TELEPHONE & CABLE TELEVISION EASEMENT
	DRIVEWAY
	TOP OF CURB
	GUTTER
	FLOWLINE

DRAIN B  
1+00.00 - 1+79.11

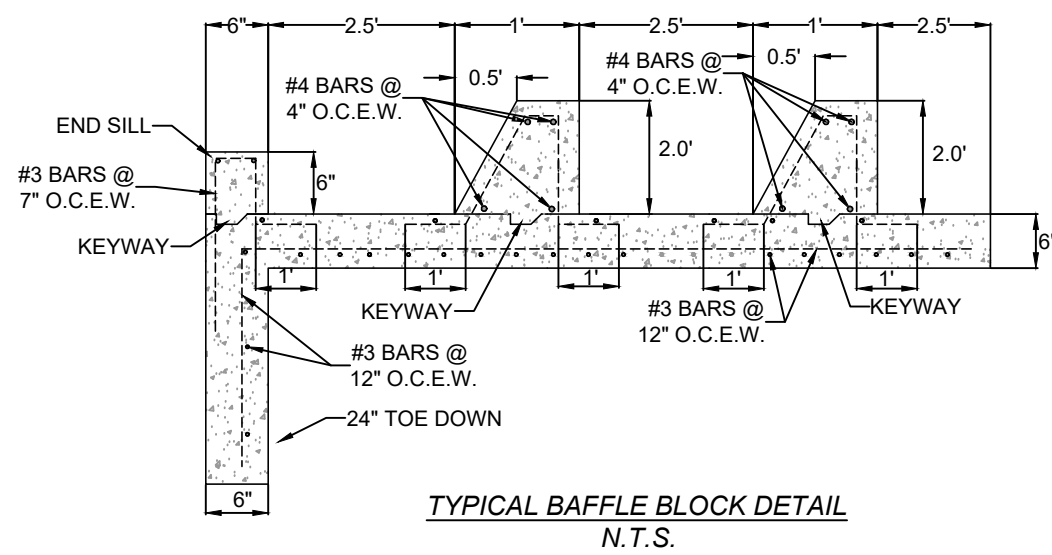

DRAIN 'B' DISSIPATER CALCULATIONS			
Q (cfs)=	27.00	Wb (Basin Width)	3.00
Froud Number (Fr)=	1.396	Lb (Length of Basin)	6.95
Culvert Span or Bottom Width of Channel (ft)	3	Bw (Width of Baffle Block)	1.2
Culvert Rise or Top of Channel (ft)	3	Space Between Blocks	1.2
Number of Barrels	1	Nb (Number Of Blocks)	1
n	0.013	Height of Blocks	1.60
Slope (ft/ft)	0.015	Distance to Floor Blocks	2.32
Velocity (ft/s)	10.02	Depth of Tail Water above the Stilling Basin Floor	2.34
Y1 (Depth Before Jump)	1.6	Height of Max Tail Water	3.06
Y2 (Sequent Depth Downstream)	2.16	Velocity after Baffle Blocks (fps)	3.85
C	1.08	Height of Sill End	0.14
Y2'	2.34	Thickness of Baffle Blocks	0.32
z	0.72	C=1.1-(Fr) <sup>2</sup> /120	When 1.7< Fr<5.5
		C=0.85	When 5.5< Fr<11
		C=1.0-(Fr) <sup>2</sup> /800	When 11< Fr<17

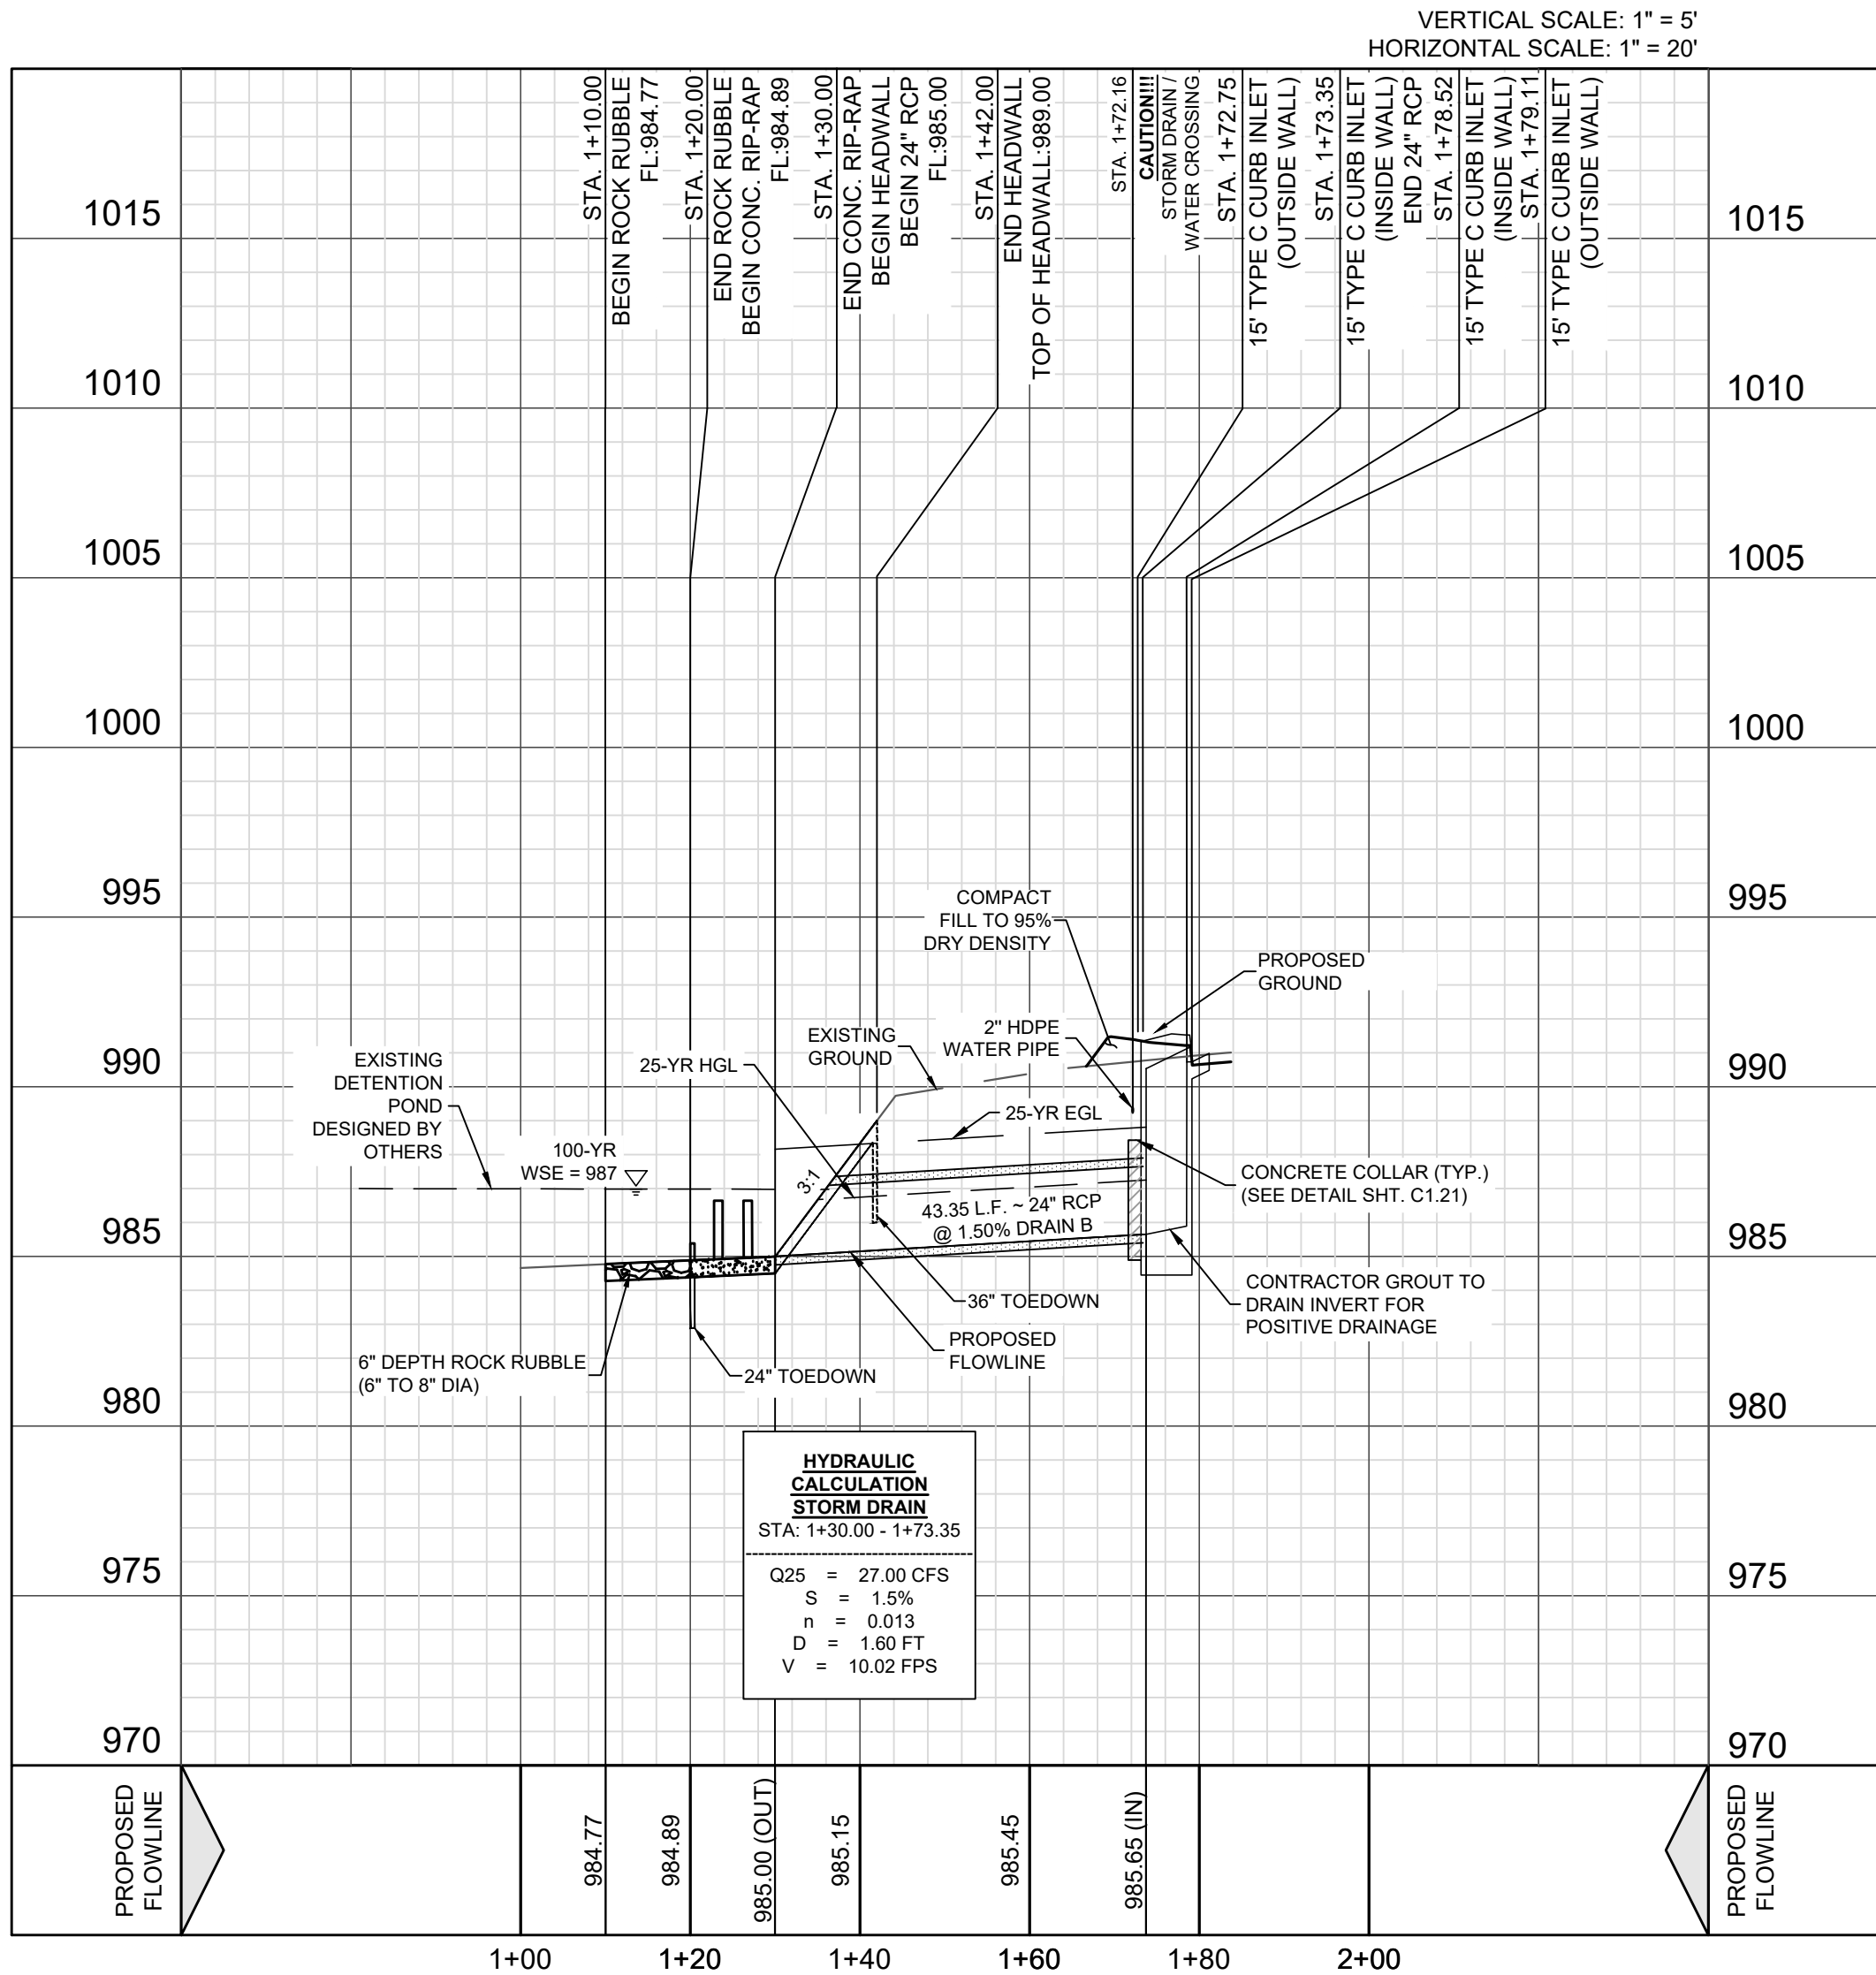

- CPS NOTES:
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  3. ALL CONCRETE FOR TXDOT DRAINAGE STRUCTURES SHALL MEET TXDOT SPECIFICATIONS. ALL OTHER CONCRETE SHALL BE CLASS "A" 3000 PSI CYLINDER STRENGTH IN 28 DAYS.
  4. REFERENCE DRAINAGE DETAILS FOR PIPE TRENCH DETAILS, BOX CULVERT, HEADWALL, WINGWALL, CONSTRUCTION DETAILS, AND BOX CULVERT BEDDING AND EXCAVATION LIMITS.
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REDBIRD RANCH UNIT 2M-2  
SAN ANTONIO, TX

DRAIN B - STA. 1+00.00 - 1+79.11

DESIGNED BY: JWS  
DRAWN BY: SQV/JWS  
DATE: 3/20/2024  
JOB NO.: 05000-200  
SHEET NO.

C1.13


REV	DATE	DESCRIPTION




DHI Engineering, LLC.  
4419 LOOP 1604 EAST  
SUITE 100  
SAN ANTONIO, TEXAS 78217  
(210) 486-2988 | dhiengineering.com  
TBP REG. NO. F-195661





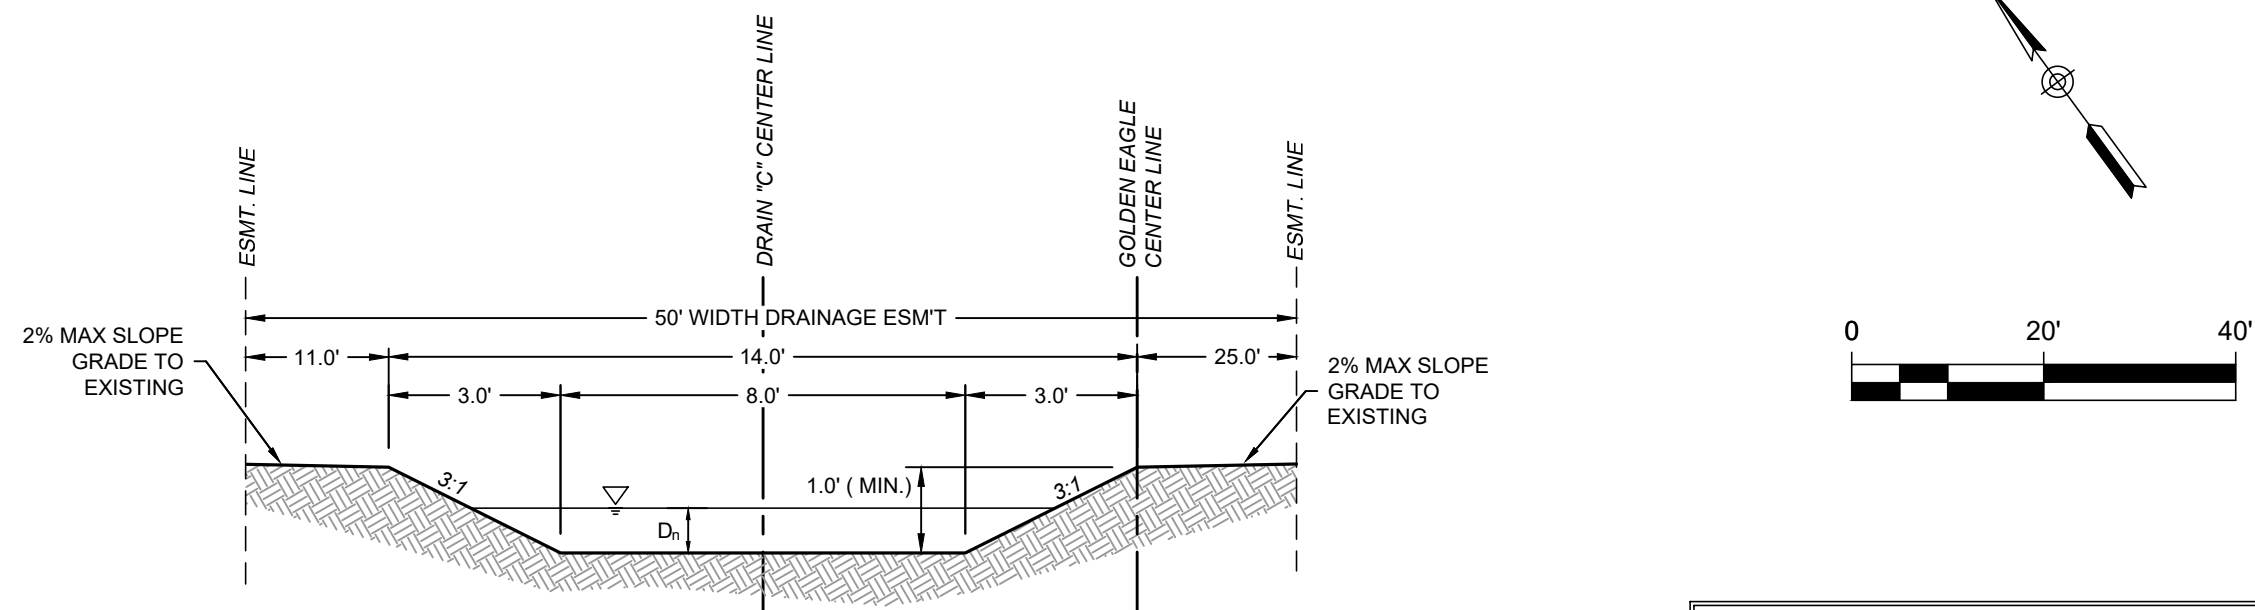

SECTION "A-A"  
STA. 1+88.22 - STA. 3+24.79  
N.T.S.

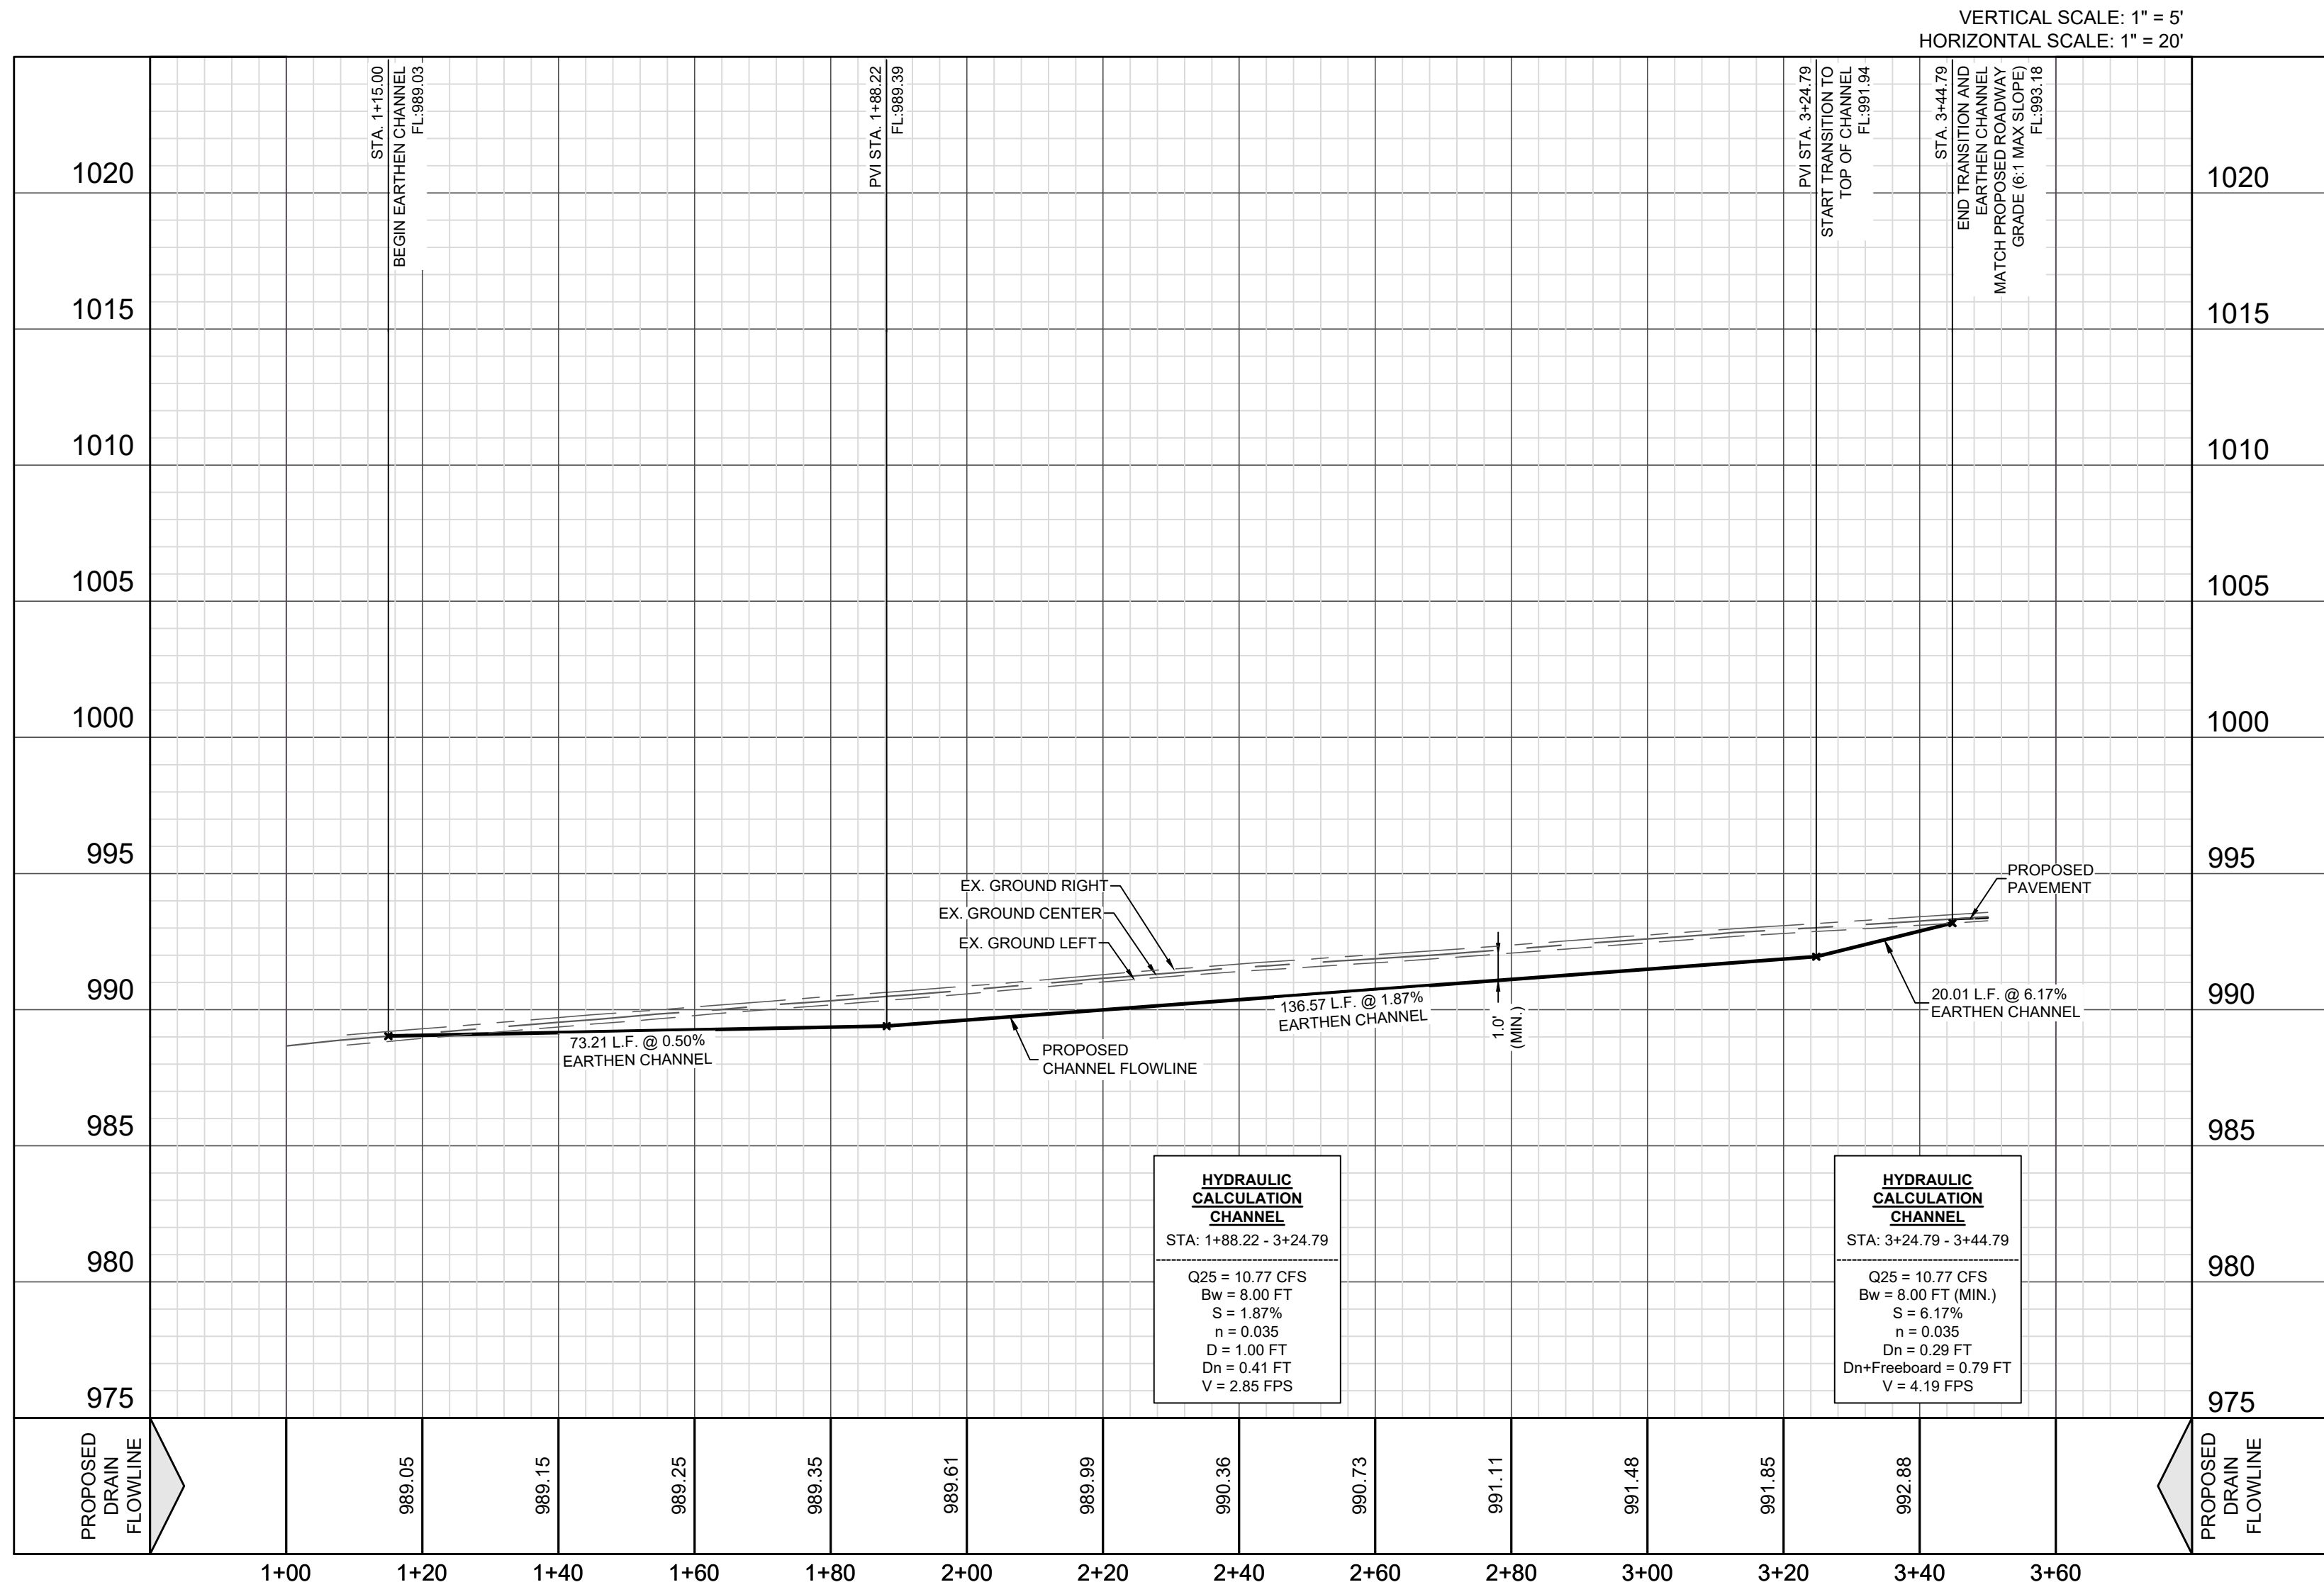

1. A MEDIA CONTROL ROW PERMIT MUST BE OBTAINED BEFORE WORKING IN MEDIA CONTROL ROW. CONTRACTOR SHALL COORDINATE A TRAFFIC CONTROL PLAN FOR ALL WORK WITHIN THE ROW. ADDITIONAL WORKING SIGNS MAY BE RECOMMENDED BY THE ENGINEER ONCE THE ROADWAYS ARE CONSTRUCTED.
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3. ALL CONCRETE FOR TxDOT DRAINAGE STRUCTURES SHALL MEET TxDOT SPECIFICATIONS. ALL OTHER CONCRETE SHALL BE CLASS "A" 3000 PSI CYLINDER STRENGTH IN 28 DAYS.
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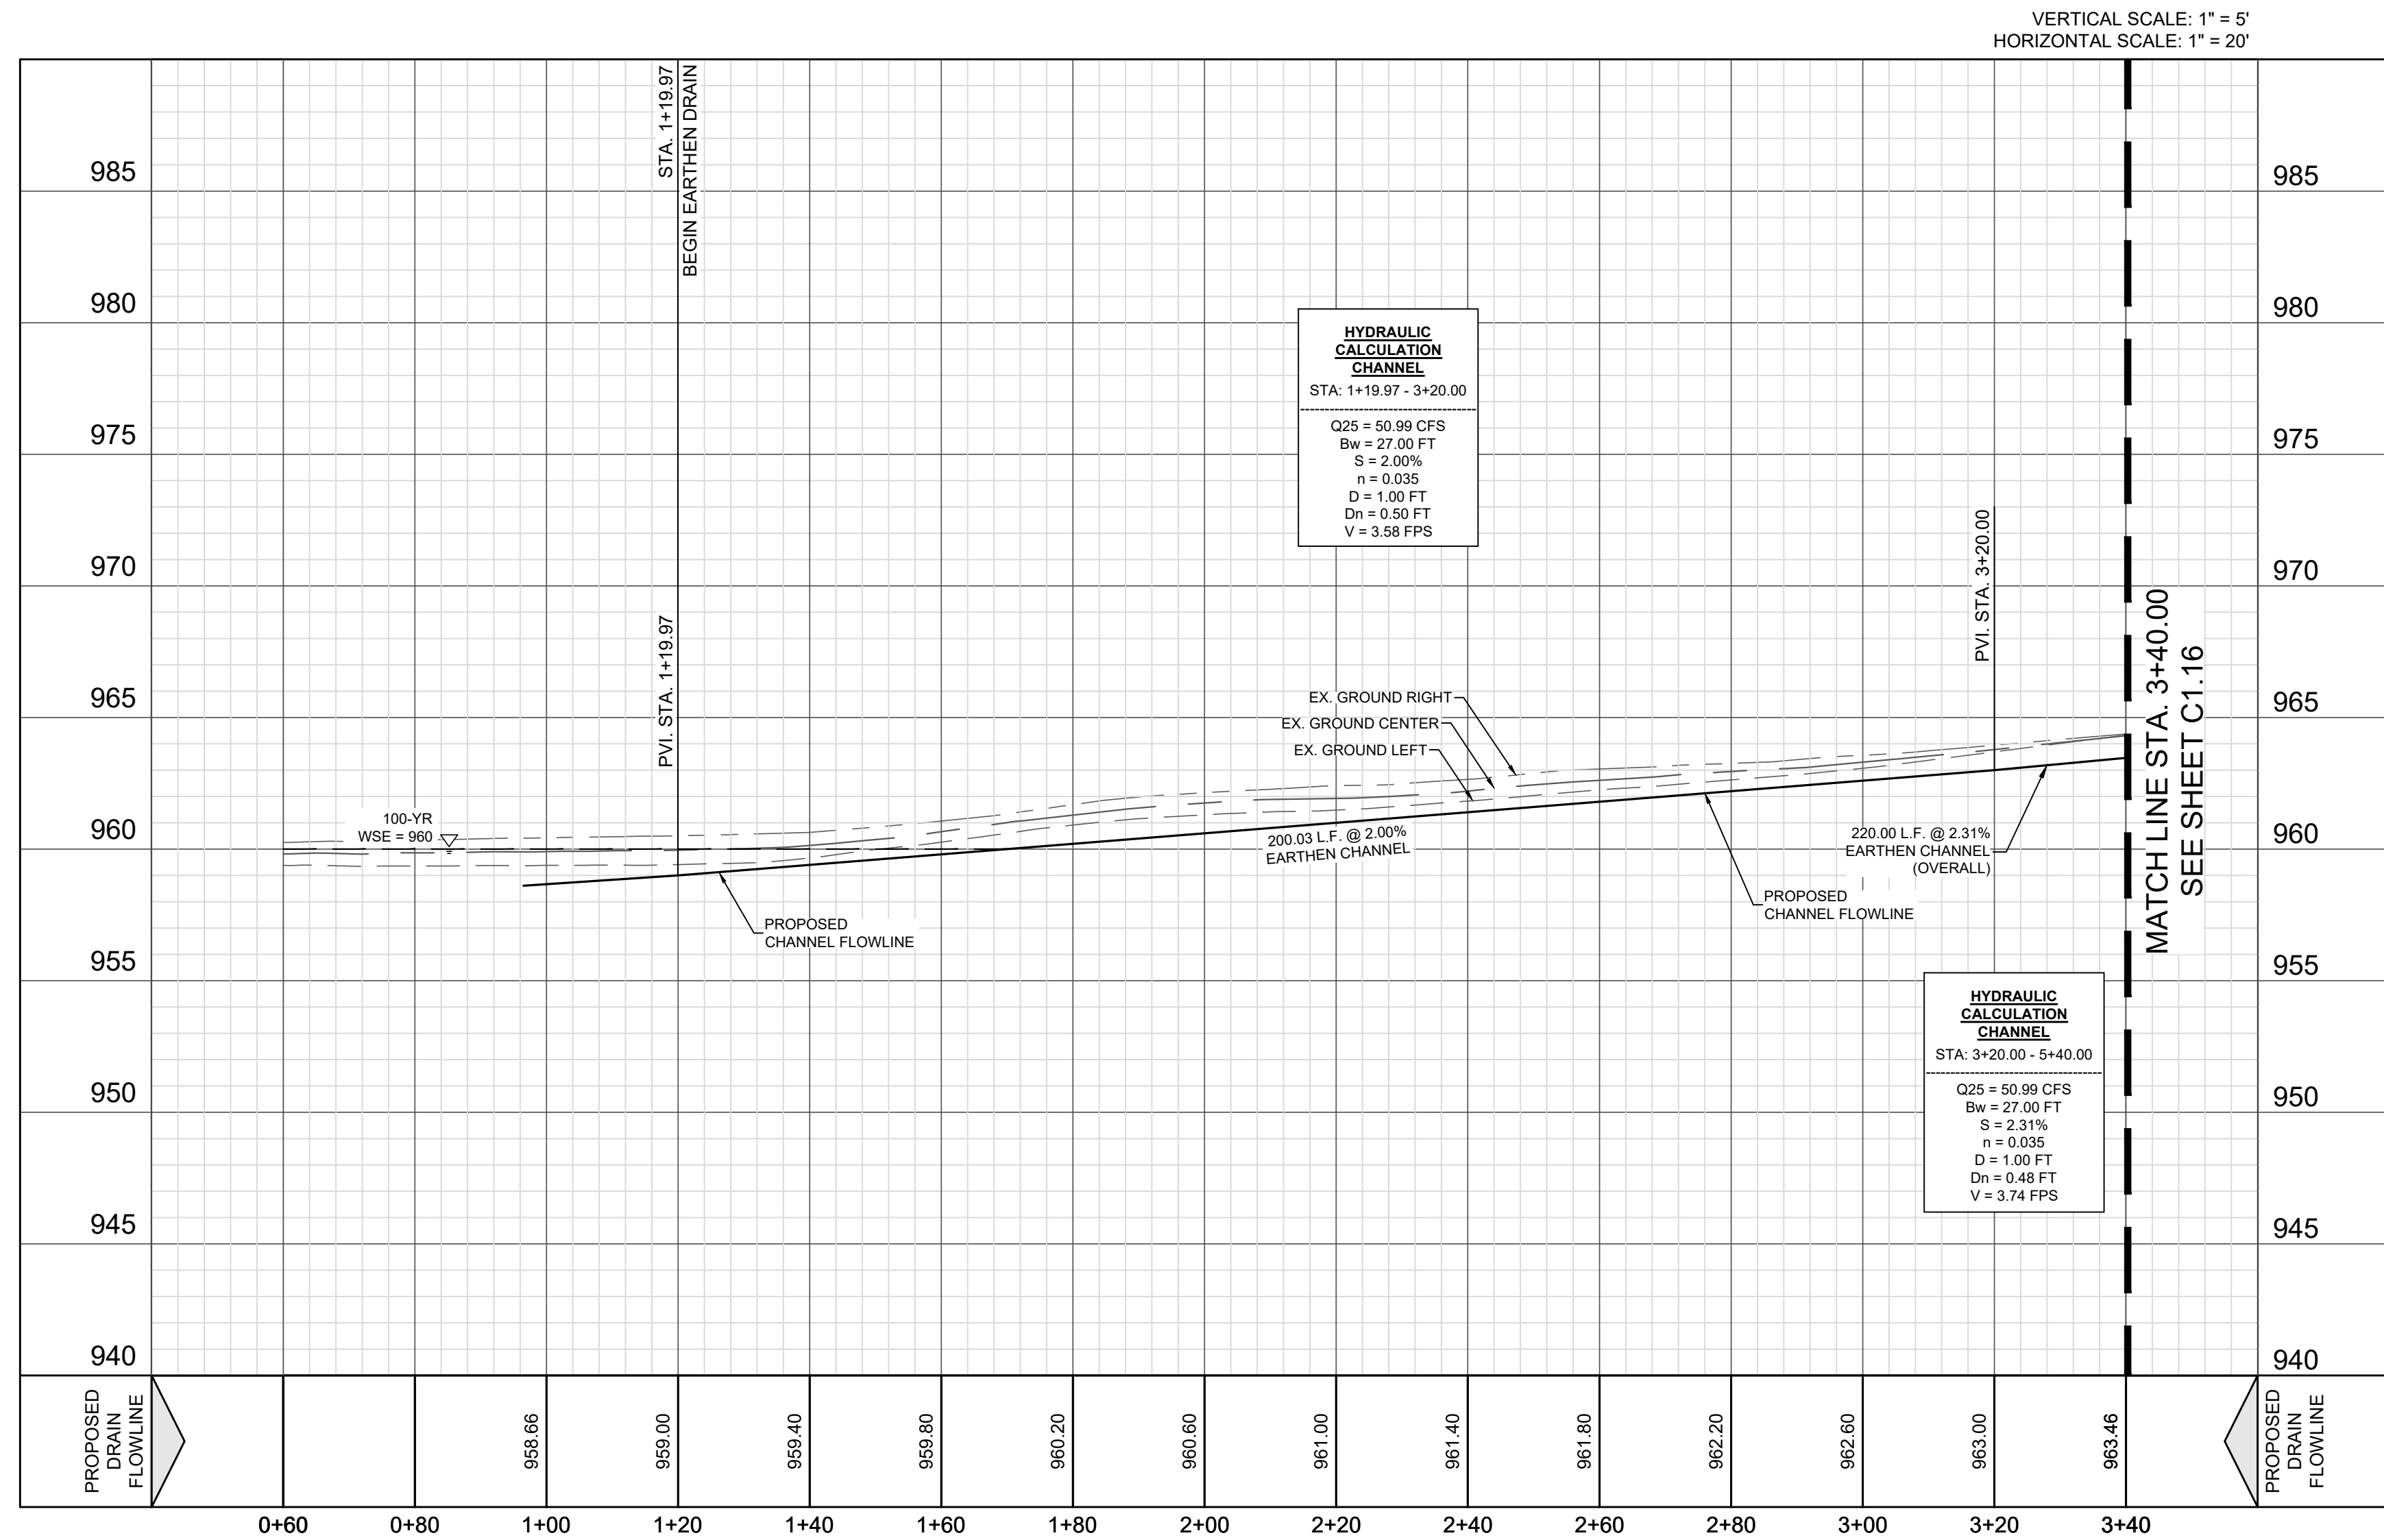
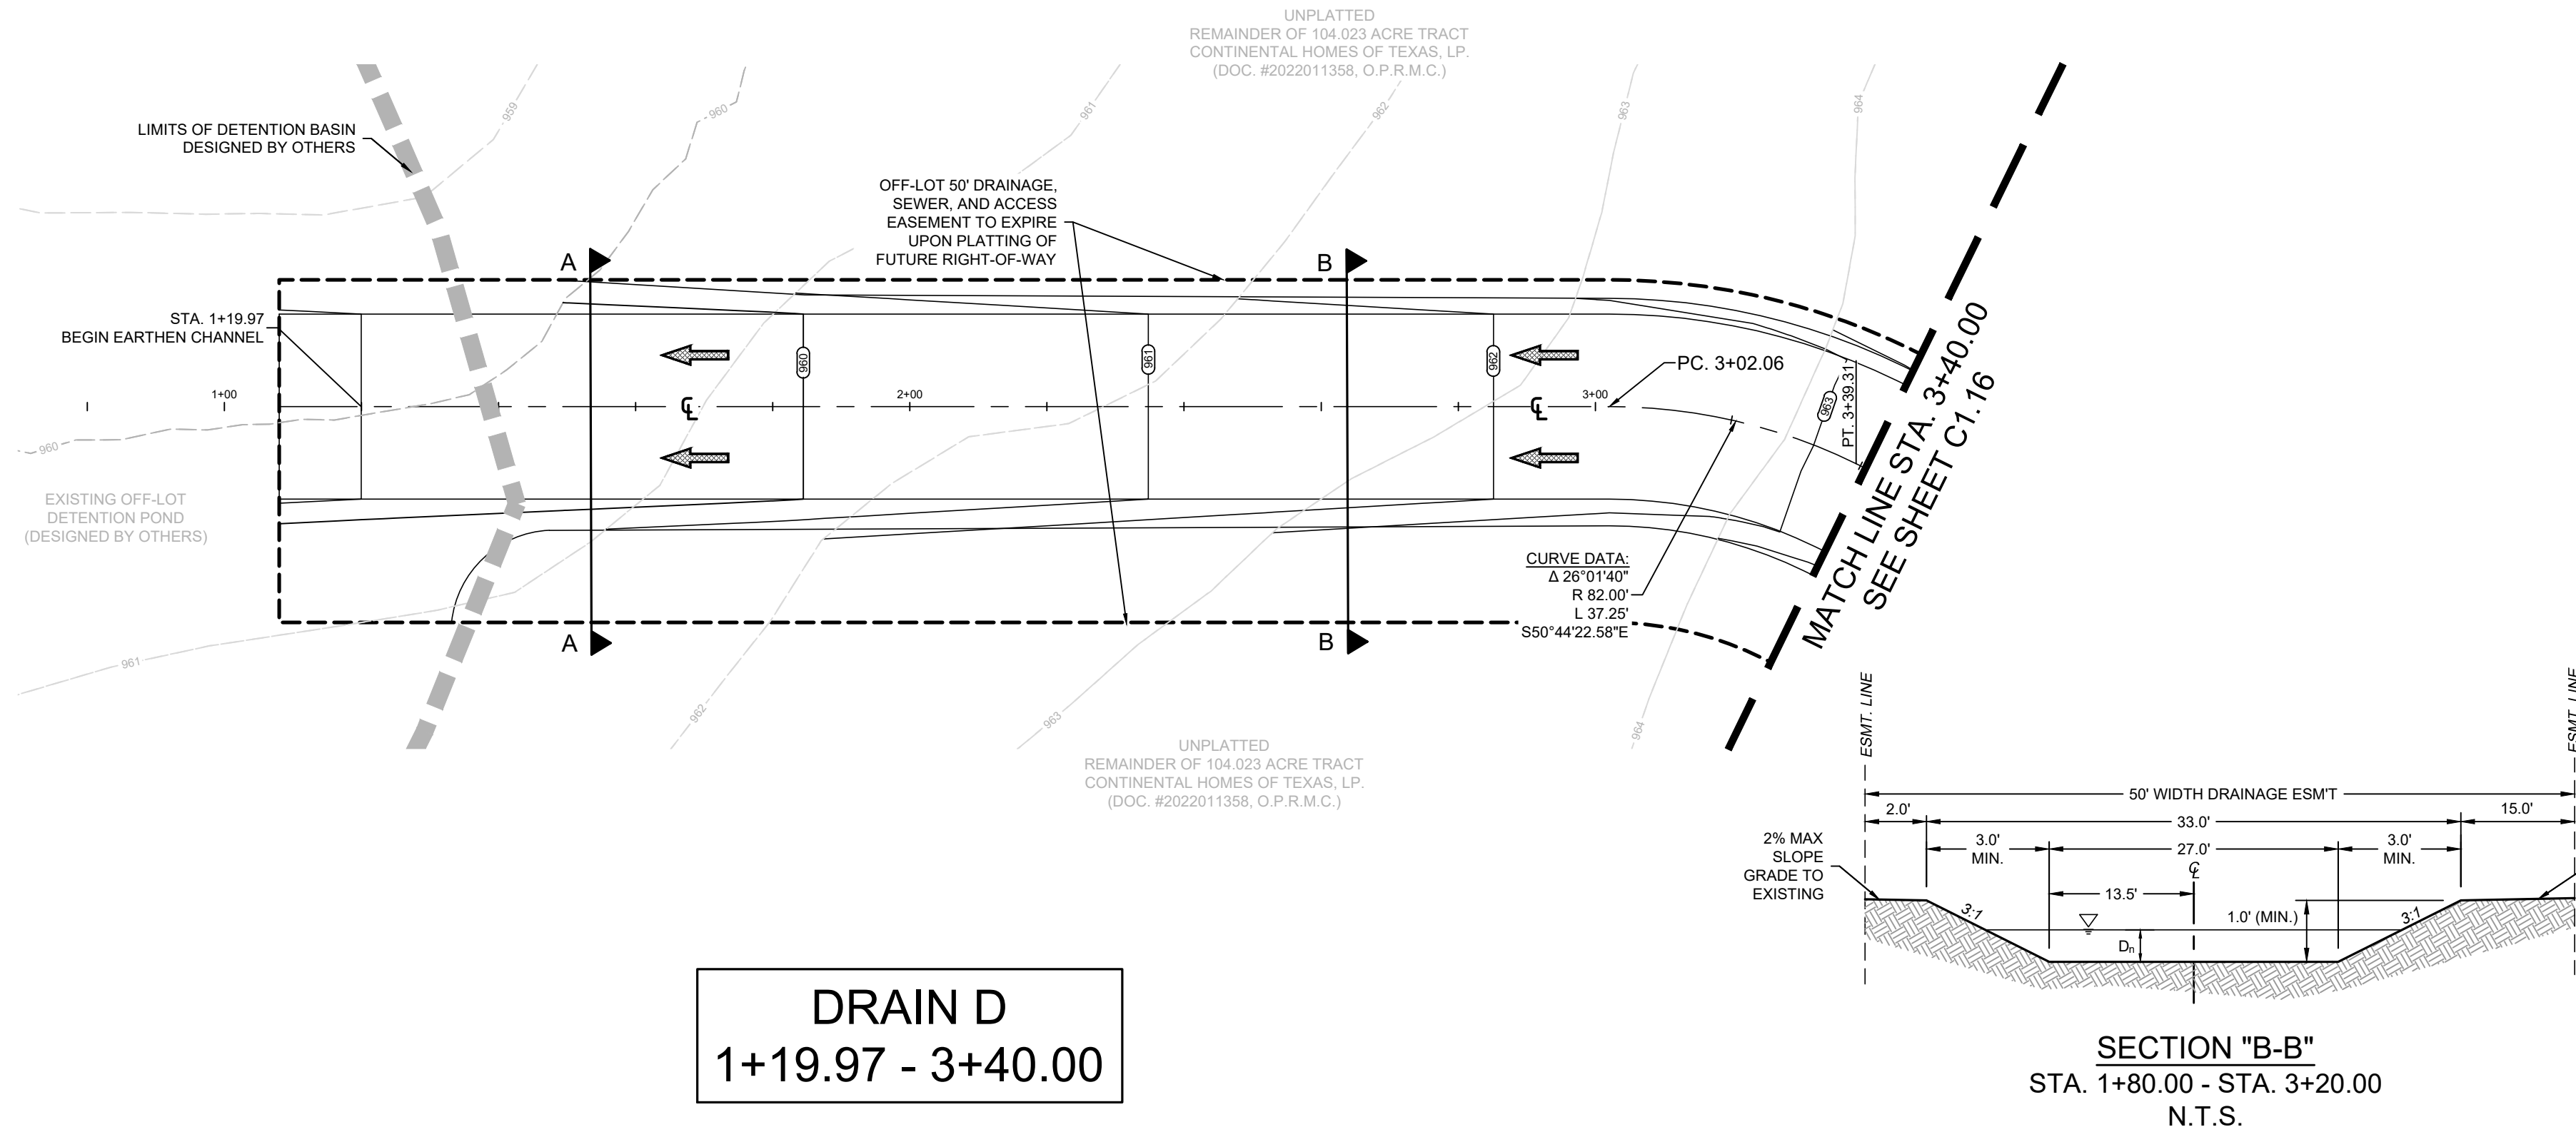
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[illegible]





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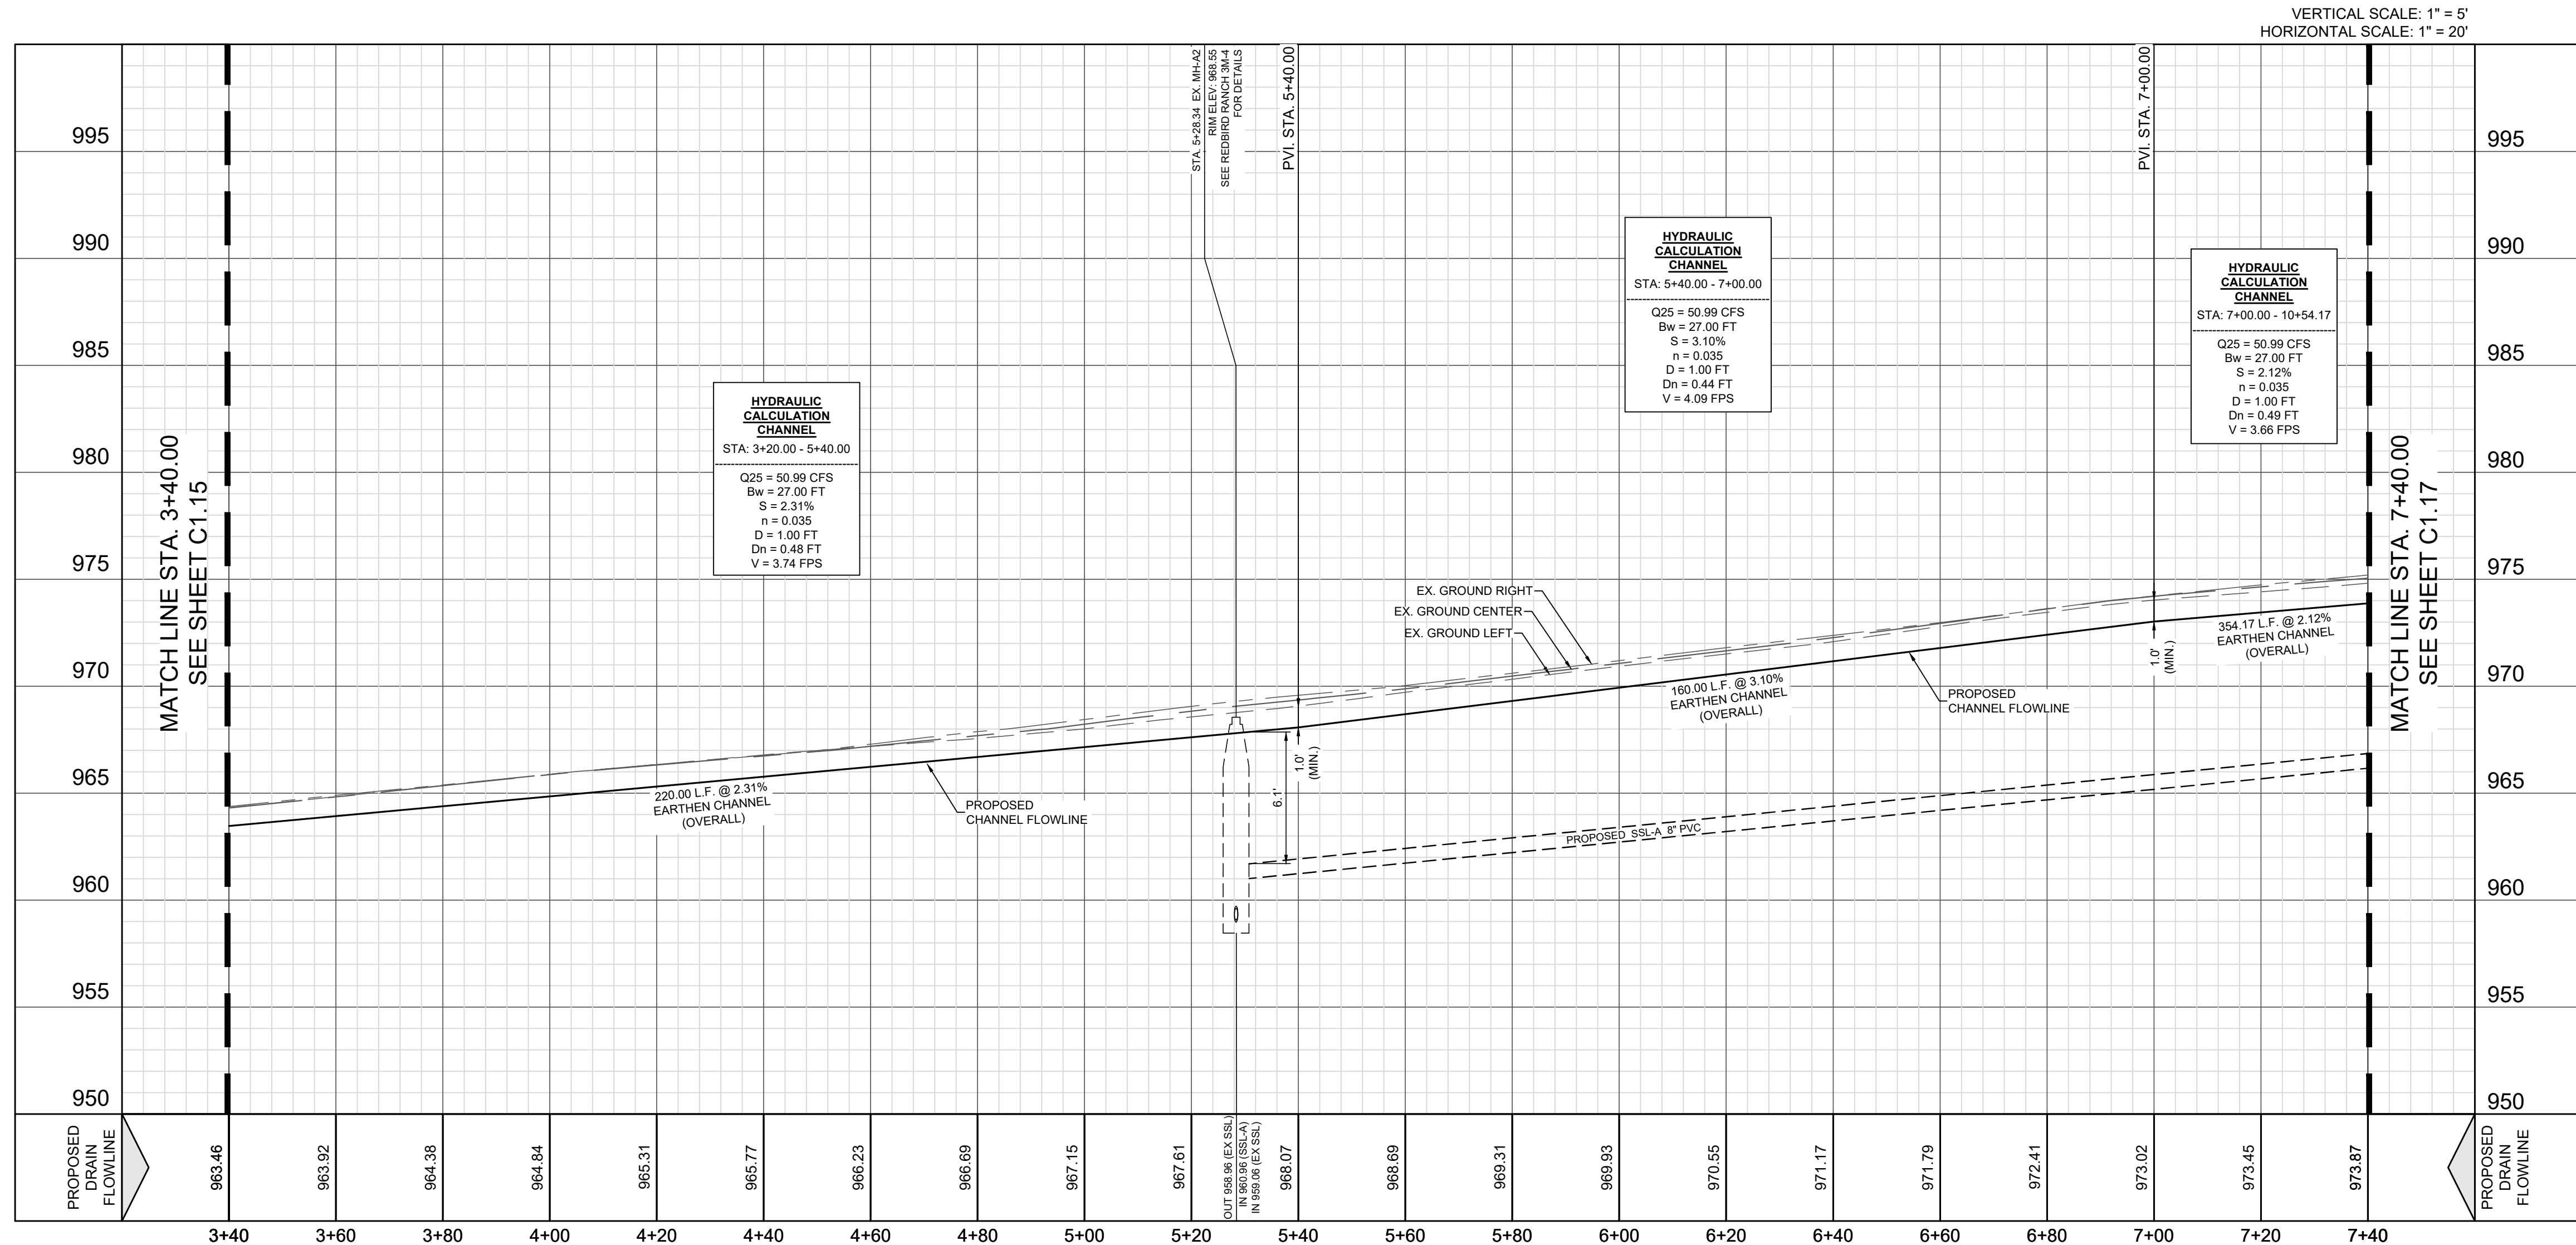
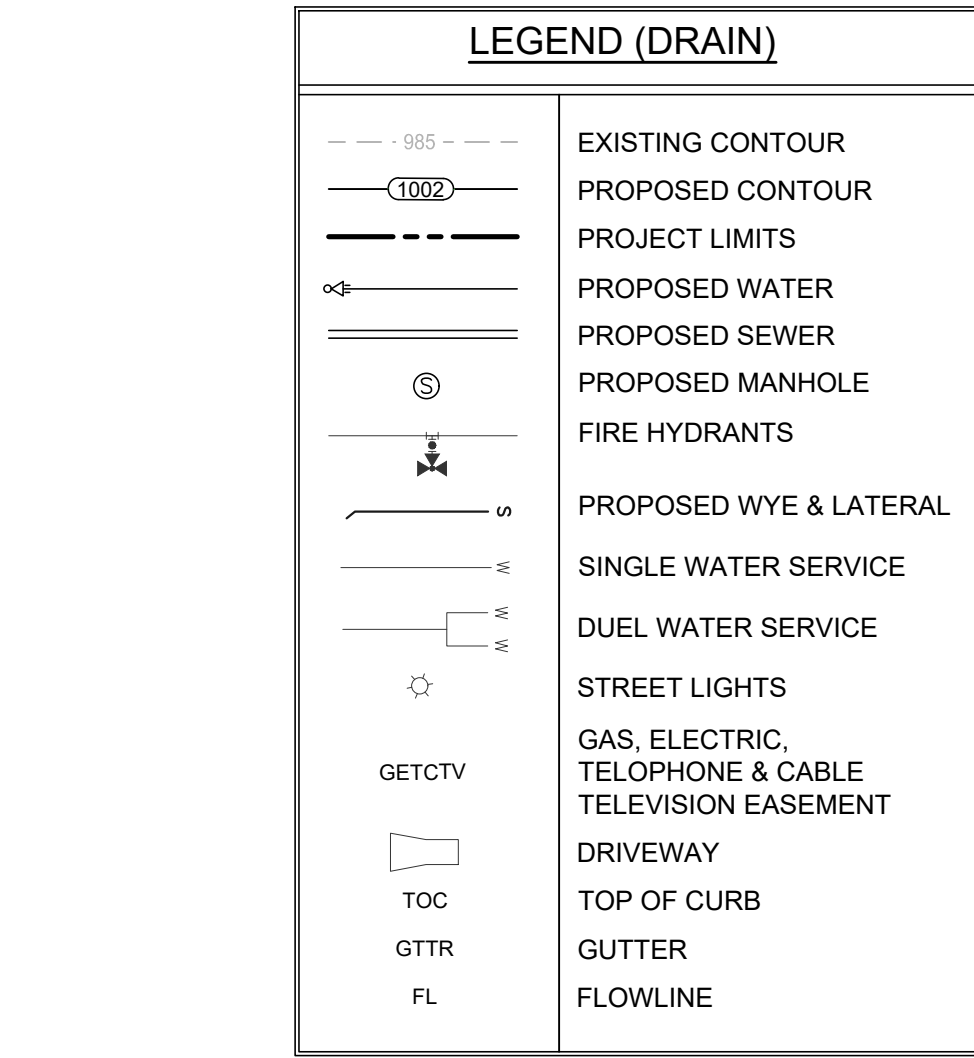
REDBIRD RANCH UNIT 2M-2  
SAN ANTONIO, TX

DRAIN D - STA. 1+00.00 - 3+40.00

DESIGNED BY:	JWS
DRAWN BY:	SQV/JWS
DATE:	3/20/2024
JOB NO.:	05000-200
SHEET NO.	

# C1.15





**CPS NOTES:**

1. A MEDIAN CROWN ROW PERMIT MUST BE OBTAINED BEFORE WORKING IN MEDIAN OR CROWN ROW. CONTRACTOR SHALL COORDINATE A TRAFFIC CONTROL PLAN FOR ALL WORK WITHIN THE ROW. ADDITIONAL WORKING SIGNS MAY BE RECOMMENDED BY THE ENGINEER ONCE THE ROADWAYS ARE CONSTRUCTED.

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4. REFERENCE DRAWING DETAILS FOR PIPE TRENCH DETAILS, BOX CULVERT, HEADWALL, WINGWALL CONSTRUCTION DETAILS, AND BOX CULVERT BEDDING AND EXCAVATION LIMITS.

5. CONTRACTOR SHALL GROUT ALL CUB INLETS AND JUNCTION BOXES TO PROVIDE FOR POSITIVE DRAINAGE.

6. EARTHEN CHANNELS WILL BE VEGETATED BY SEEDING OR SODDING 85% OF THE CHANNEL SURFACE MUST HAVE ESTABLISHED VEGETATION BEFORE BEYAR CROWN WILL ACCEPT.

7. CONTRACTOR SHALL MATCH TOP OF CHANNEL TO NATURAL GROUND AND MAINTAIN A MINIMUM CHANNEL DEPTH OF "0" AS SHOWN IN THE PROFILE.

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CONTRACTOR AND CONTRACTOR'S INDEPENDENTLY RETAINED EMPLOYEE OR STRUCTURAL DESIGN, GEOTECHNICAL, SAFETY, EQUIPMENT CONSULTANT, IF ANY, SHALL REVIEW THESE PLANS AND ANY AVAILABLE GEOTECHNICAL INFORMATION AND THE CONTRACTOR AND INDEPENDENTLY RETAINED EMPLOYEE OR CONSULTANT SHALL IMPLEMENT CONTRACTOR'S TRENCH EXCAVATION SAFETY PROTECTION SYSTEM. PROGRAMS AND/OR PROCEDURES FOR THE PROJECT DESCRIBED IN THE CONTRACT DOCUMENTS SHALL BE THE SAME AS THE CONTRACTOR'S TRENCH EXCAVATION PROGRAMS AND PROCEDURES SHALL PROVIDE FOR ADEQUATE TRENCH EXCAVATION SAFETY PROTECTION THAT COMPLY WITH AS A MINIMUM, OSHA STANDARDS FOR TRENCH OCCUPATIONS SPECIFICALLY. CONTRACTOR'S TRENCH EXCAVATION PROGRAMS, RETAINED EMPLOYEE OR SAFETY CONSULTANT SHALL IMPLEMENT A TRENCH SAFETY PROGRAM TO ACCORDANCE WITH THE TRENCH EXCAVATION SAFETY STANDARDS AND ACTIVITIES OF INDIVIDUALS WORKING IN AND AROUND TRENCH EXCAVATION.

**CAUTION!!!**

CONTRACTOR SHALL BE REQUIRED TO LOCATE ALL PUBLIC OR PRIVATE UTILITIES INCLUDING BUT NOT LIMITING TO: WATER, SEWER, TELEPHONE AND FIBER OPTIC LINES, SITE LIGHTING ELECTRIC, SECONDARY ELECTRIC, PRIMARY ELECTRICAL DUCTBANKS, LANDSCAPE IRRIGATION AND GAS LINES. ANY UTILITY CONFLICTS THAT ARISE SHOULD BE COMMUNICATED TO THE ENGINEER IMMEDIATELY AND PRIOR TO CONSTRUCTION. THE CONTRACTOR SHALL CONTACT 1-800-DIG-TEST A MINIMUM OF 48 HOURS PRIOR TO THE START OF CONSTRUCTION. ANY DAMAGE TO EXISTING UTILITIES SHALL BE THE SOLE RESPONSIBILITY OF THE CONTRACTOR AND THE REPAIR SHALL BE AT CONTRACTOR'S EXPENSE. WHETHER THE UTILITY IS SHOWN ON THESE PLANS OR NOT.




MATCH LINE STA. 7+40.00  
SEE SHEET C1.16

OFF-LOT 50' DRAINAGE,  
SEWER, AND ACCESS  
EASEMENT TO EXPIRE  
UPON PLATTING OF  
FUTURE RIGHT-OF-WAY

UNPLATTED  
REMAINDER OF 104.023 ACRE TRACT  
CONTINENTAL HOMES OF TEXAS, LP,  
(DOC. #2022011358, O.P.R.M.C.)


UNPLATTED  
REMAINDER OF 104.023 ACRE TRACT  
CONTINENTAL HOMES OF TEXAS, LP,  
(DOC. #2022011358, O.P.R.M.C.)

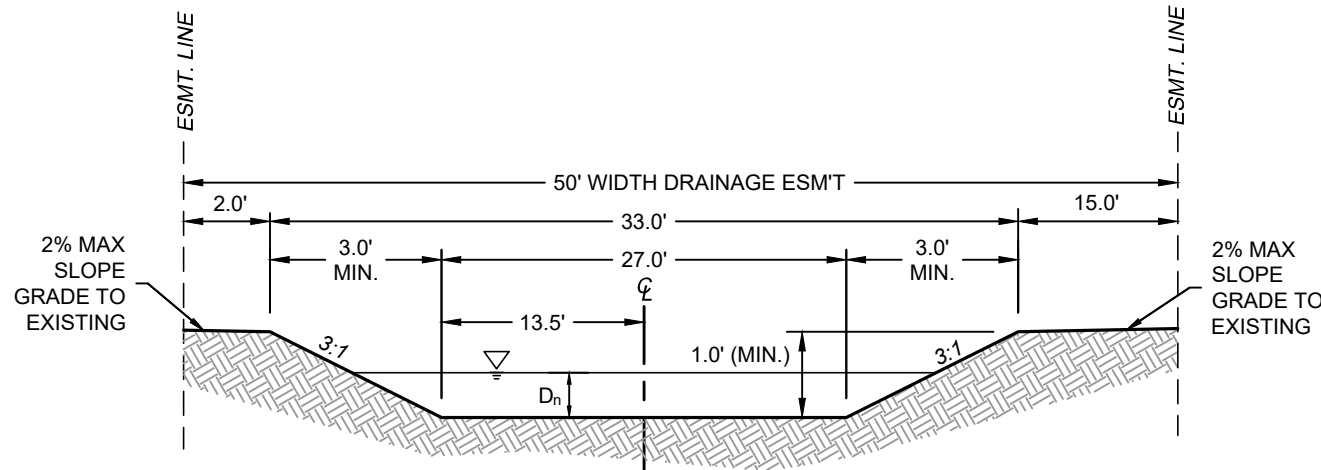

SECTION "E-E"  
STA. 7+00.00 - STA. 10+54.17  
N.T.S.

LEGEND (DRAIN)	
	EXISTING CONTOUR
	PROPOSED CONTOUR
	PROJECT LIMITS
	PROPOSED WATER
	PROPOSED SEWER
	PROPOSED MANHOLE
	FIRE HYDRANTS
	PROPOSED WYE & LATERAL
	SINGLE WATER SERVICE
	DUEL WATER SERVICE
	STREET LIGHTS
	GAS, ELECTRIC, TELEPHONE & CABLE TELEVISION EASEMENT
	DRIVEWAY
	TOP OF CURB
	GUTTER
	FLOWLINE

DRAIN D  
7+40.00 - 10+77.10

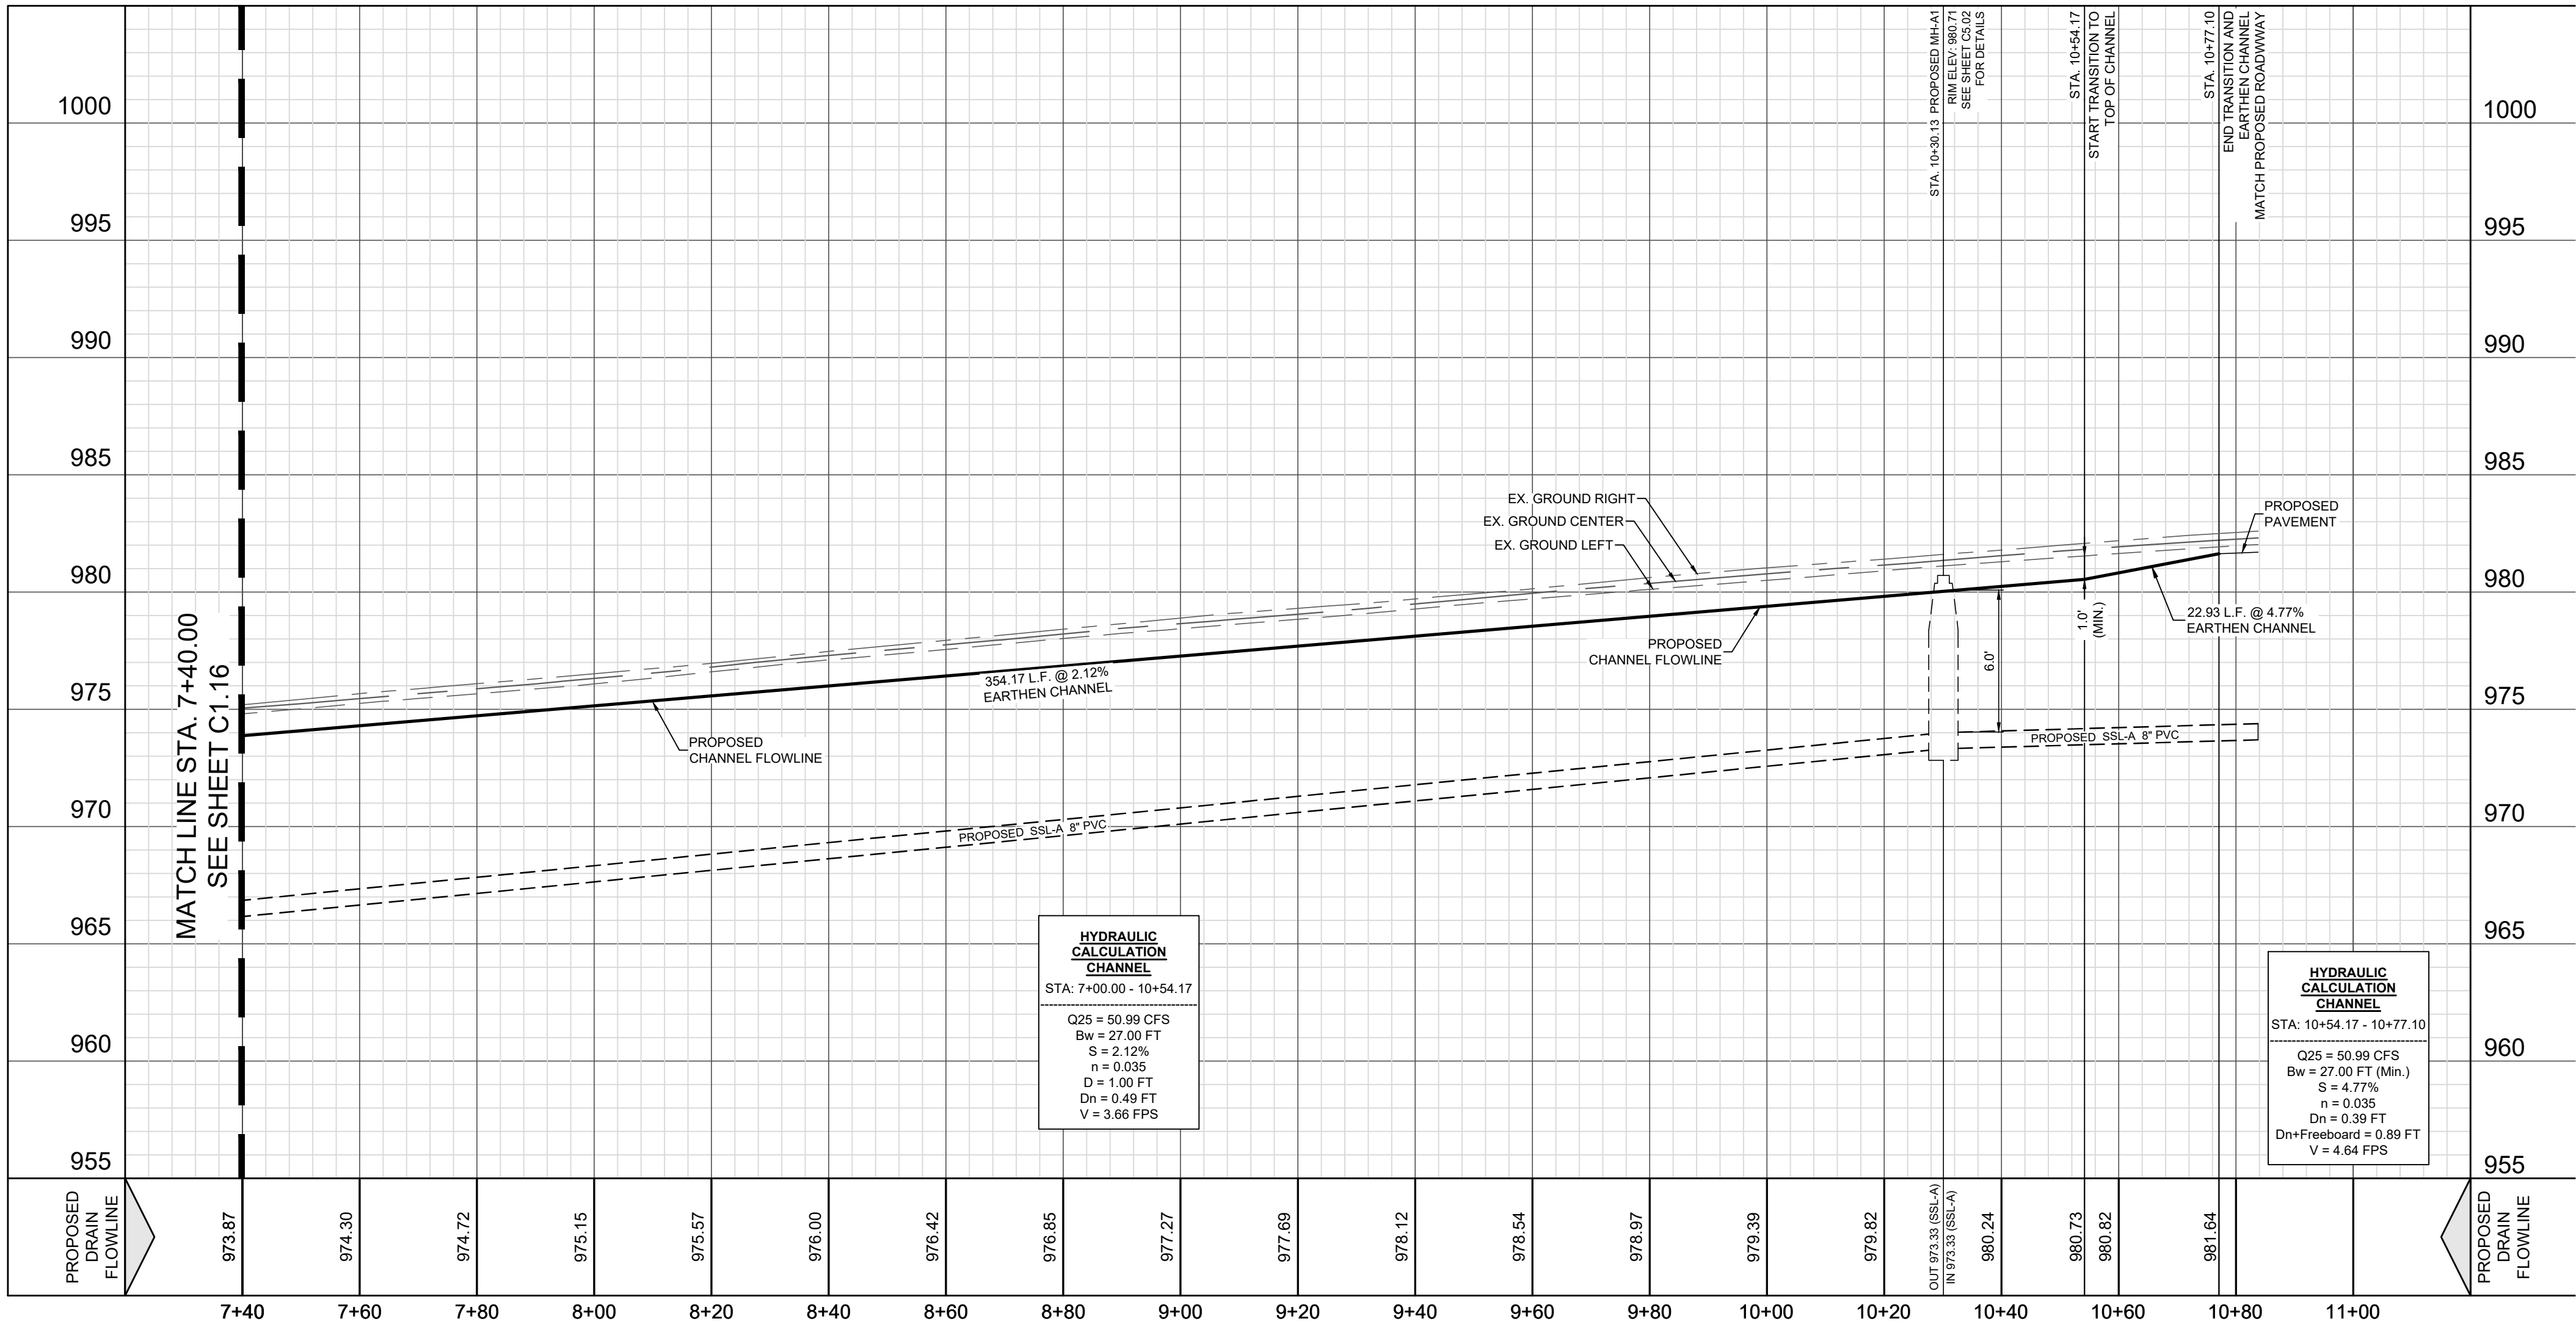

HYDRAULIC  
CALCULATION  
CHANNEL  
STA: 7+00.00 - 10+54.17  
Q25 = 50.99 CFS  
Bw = 27.00 FT  
S = 2.12%  
n = 0.035  
D = 1.00 FT  
Dn = 0.49 FT  
V = 3.66 FPS

HYDRAULIC  
CALCULATION  
CHANNEL  
STA: 10+54.17 - 10+77.10  
Q25 = 50.99 CFS  
Bw = 27.00 FT (Min.)  
S = 4.77%  
n = 0.035  
Dn = 0.39 FT  
Dn+Freeboard = 0.89 FT  
V = 4.64 FPS

- CPS NOTES:
- A MEDINA COUNTY ROW PERMIT MUST BE OBTAINED BEFORE WORKING IN MEDINA COUNTY ROW. CONTRACTOR SHALL COORDINATE A TRAFFIC CONTROL PLAN FOR ALL WORK WITHIN THE ROW. ADDITIONAL WORKING SIGNS MAY BE RECOMMENDED BY THE ENGINEER ONCE THE ROADWAYS ARE CONSTRUCTED.
  - THE CONTRACTOR WILL BE RESPONSIBLE FOR DETERMINING EXACT LOCATION OF ALL UTILITIES AND DRAINAGE STRUCTURES WHETHER SHOWN ON THE PLANS OR NOT. THE CONTRACTOR SHALL UNCOVER EXISTING UTILITIES PRIOR TO CONSTRUCTION TO VERIFY SIZE, GRADE, AND LOCATION. THE CONTRACTOR SHALL NOTIFY THE ENGINEER IMMEDIATELY OF ANY DEVIATIONS FROM PLANS PRIOR TO BEGINNING CONSTRUCTION. ANY DAMAGE TO EXISTING UTILITIES, WHETHER SHOWN ON THE PLANS OR NOT, SHALL BE THE CONTRACTOR'S RESPONSIBILITY TO REPAIR, AT HIS EXPENSE.
  - ALL CONCRETE FOR TxDOT DRAINAGE STRUCTURES SHALL MEET TxDOT SPECIFICATIONS. ALL OTHER CONCRETE SHALL BE CLASS "A" 3000 PSI CYLINDER STRENGTH IN 28 DAYS.
  - REFERENCE DRAINAGE DETAILS FOR PIPE, TRENCH DETAILS, BOX CULVERT, HEADWALL, WINGWALL, CONSTRUCTION DETAILS, AND BOX CULVERT BEDDING AND EXCAVATION LIMITS.
  - CONTRACTOR SHALL GROUT ALL CURB INLETS AND JUNCTION BOXES TO PROVIDE FOR POSITIVE DRAINAGE.
  - EARTHEN CHANNELS WILL BE VEGETATED BY SEEDING OR SODDING 85% OF THE CHANNEL SURFACE. SURFACE MUST HAVE ESTABLISHED VEGETATION BEFORE BEKAR COUNTY WILL ACCEPT.
  - CONTRACTOR SHALL MATCH TOP OF CHANNEL TO NATURAL GROUND AND MAINTAIN A MINIMUM CHANNEL DEPTH OF 10" AS SHOWN IN THE PROFILE.

TRENCH EXCAVATION PROTECTION

CONTRACTOR AND CONTRACTOR'S INDEPENDENTLY RETAINED EMPLOYEE OR STRUCTURAL DESIGN, GEOTECHNICAL, SAFETY, EQUIPMENT CONSULTANT, IF ANY, SHALL REVIEW THESE PLANS AND ANY AVAILABLE GEOTECHNICAL INFORMATION AND THE ANTICIPATED INSTALLATION SITE WITHIN THE PROJECT'S WORK AREA IN ORDER TO IMPLEMENT CONTRACTOR'S TRENCH EXCAVATION SAFETY PROTECTION SYSTEM. PROGRAMS AND/OR PROCEDURES FOR THE PROJECT DESCRIBED IN THE CONTRACT DOCUMENTS, THE CONTRACTOR'S IMPLEMENTATION OF THESE SYSTEMS, PROGRAMS, AND PROCEDURES SHALL PROVIDE FOR ADEQUATE TRENCH EXCAVATION SAFETY PROTECTION THAT COMPLY WITH AS A MINIMUM, OSHA STANDARDS FOR TRENCH EXCAVATIONS SPECIFICALLY, CONTRACTOR AND CONTRACTOR'S INDEPENDENTLY RETAINED EMPLOYEE OR SAFETY CONSULTANT SHALL IMPLEMENT A TRENCH SAFETY PROGRAM IN ACCORDANCE WITH OSHA STANDARDS GOVERNING THE PRESENCE AND ACTIVITIES OF INDIVIDUALS WORKING IN AND AROUND TRENCH EXCAVATION.

CAUTION!!!

CONTRACTOR SHALL BE REQUIRED TO LOCATE ALL PUBLIC OR PRIVATE UTILITIES INCLUDING BUT NOT LIMITING TO: WATER, SEWER, TELEPHONE AND FIBER OPTIC LINES, SITE LIGHTING ELECTRIC, SECONDARY ELECTRIC, PRIMARY ELECTRICAL DUCTBANKS, LANDSCAPE IRRIGATION FACILITIES, AND GAS LINES. ANY UTILITY CONFLICTS THAT ARISE SHOULD BE COMMUNICATED TO THE ENGINEER IMMEDIATELY AND PRIOR TO CONSTRUCTION. THE CONTRACTOR SHALL CONTACT 1-800-DIG-TESS A MINIMUM OF 48 HOURS PRIOR TO THE START OF CONSTRUCTION. ANY DAMAGE TO EXISTING UTILITIES SHALL BE THE SOLE RESPONSIBILITY OF THE CONTRACTOR AND THE REPAIR SHALL BE AT CONTRACTOR'S EXPENSE WHETHER THE UTILITY IS SHOWN ON THESE PLANS OR NOT.

REDBIRD RANCH UNIT 2M-2  
SAN ANTONIO, TX

DRAIN D - STA. 7+40.00 -  
10+77.10

DESIGNED BY: JWS  
DRAWN BY: SQV/JWS  
DATE: 3/20/2024  
JOB NO.: 05000-200  
SHEET NO.

C1.17

3/20/2024

REV. DATE DESCRIPTION

DHI Engineering, LLC.  
4419 LOOP 1604 EAST  
SUITE 100  
SAN ANTONIO, TEXAS 78217  
(210) 486-2988 | dhiengineering.com  
TBP REG. NO. F-195661




Vance Weyand








TYPICAL DETAIL FOR C.M.P. AND S.R.C.M.P.

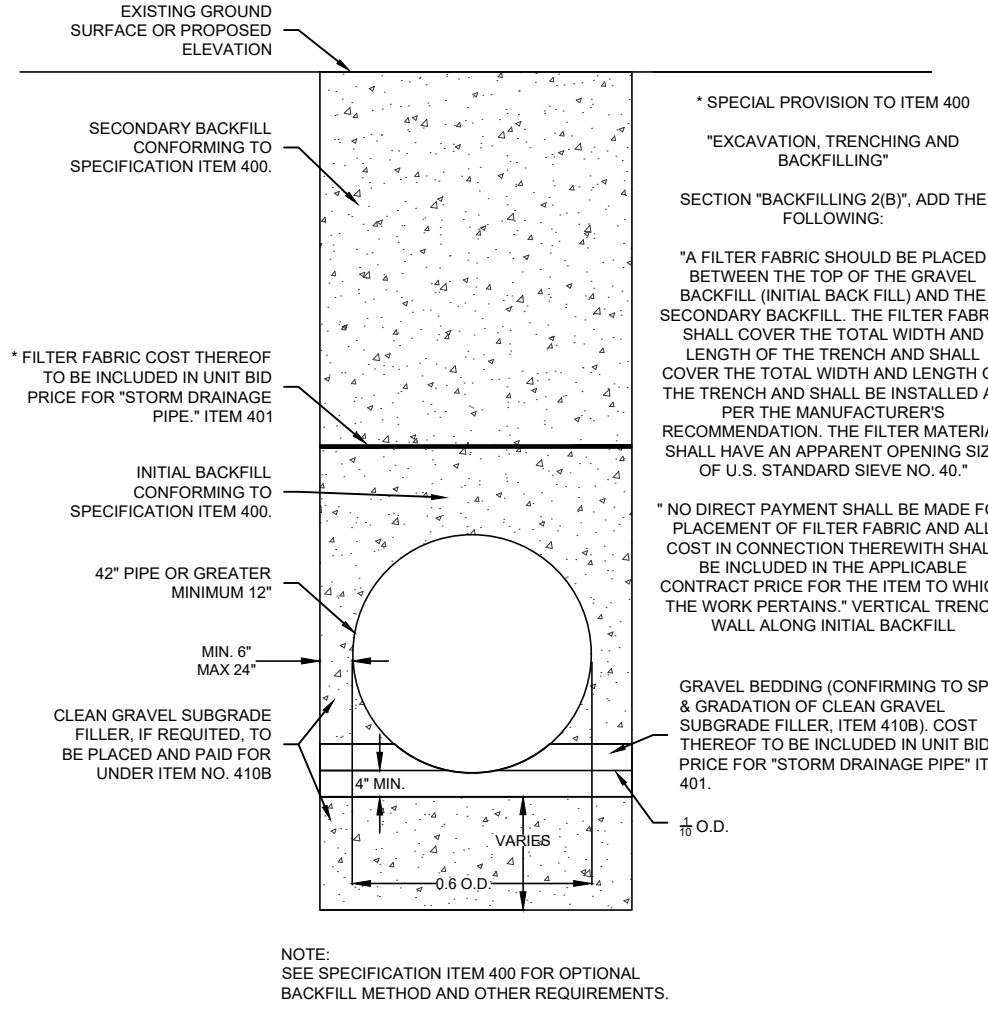


TYPICAL DETAIL

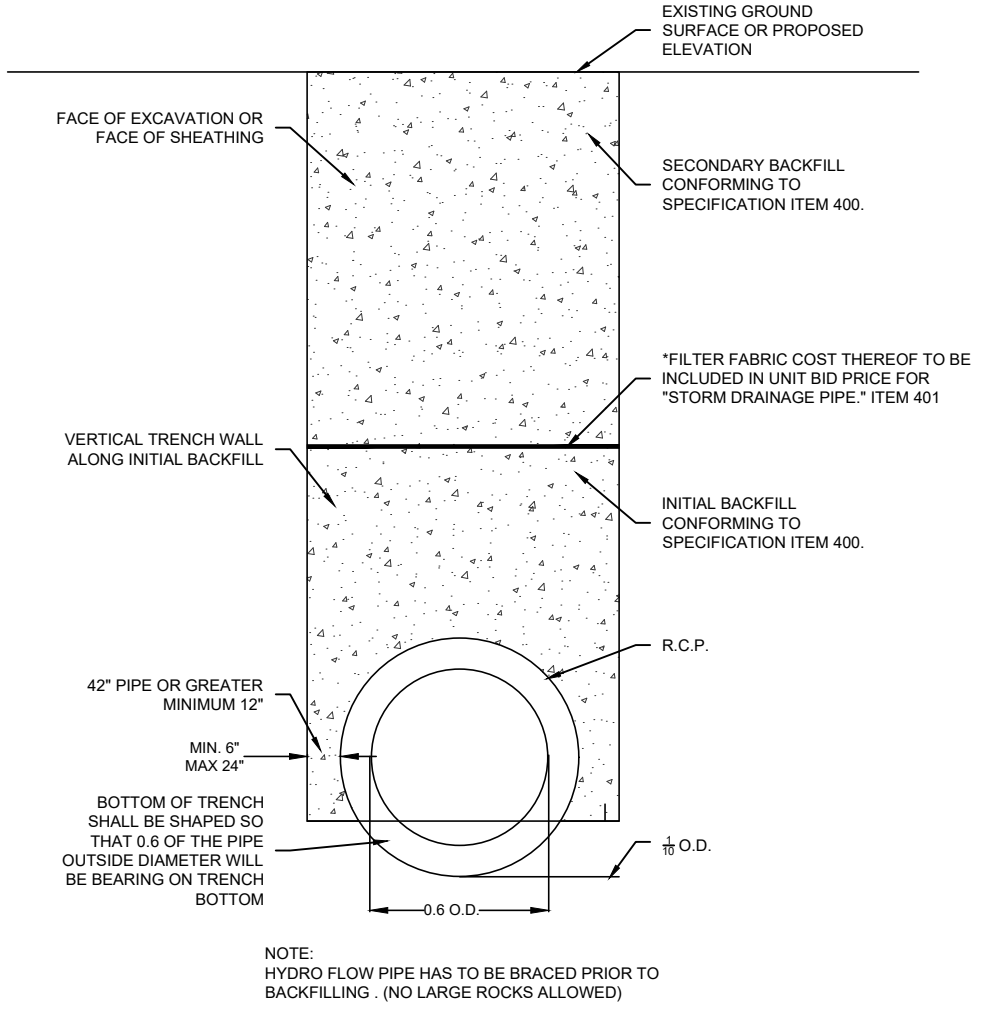


PIPE BEDDING AND BACKFILL DETAILS

NOT TO SCALE

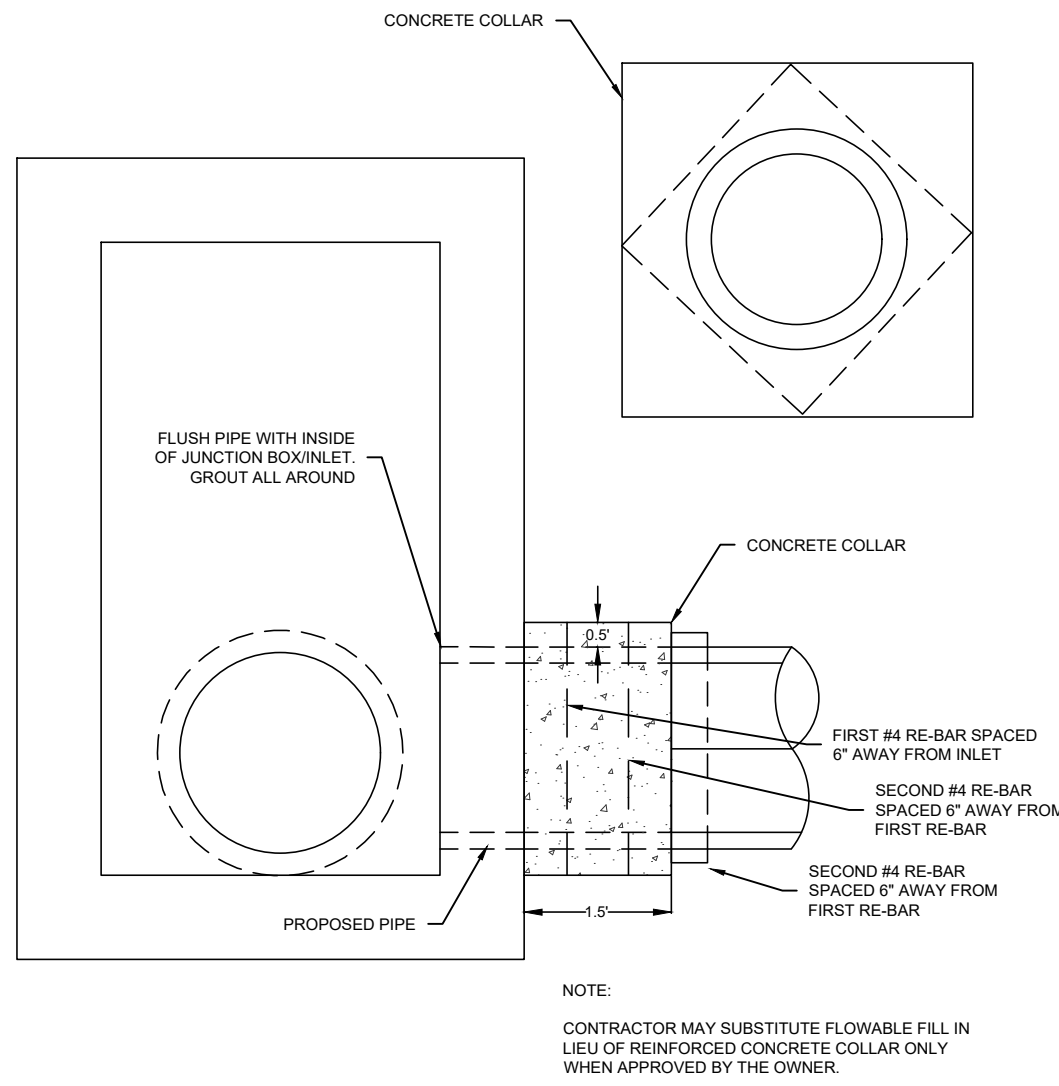

CONCRETE COLLAR DETAIL

NOT TO SCALE



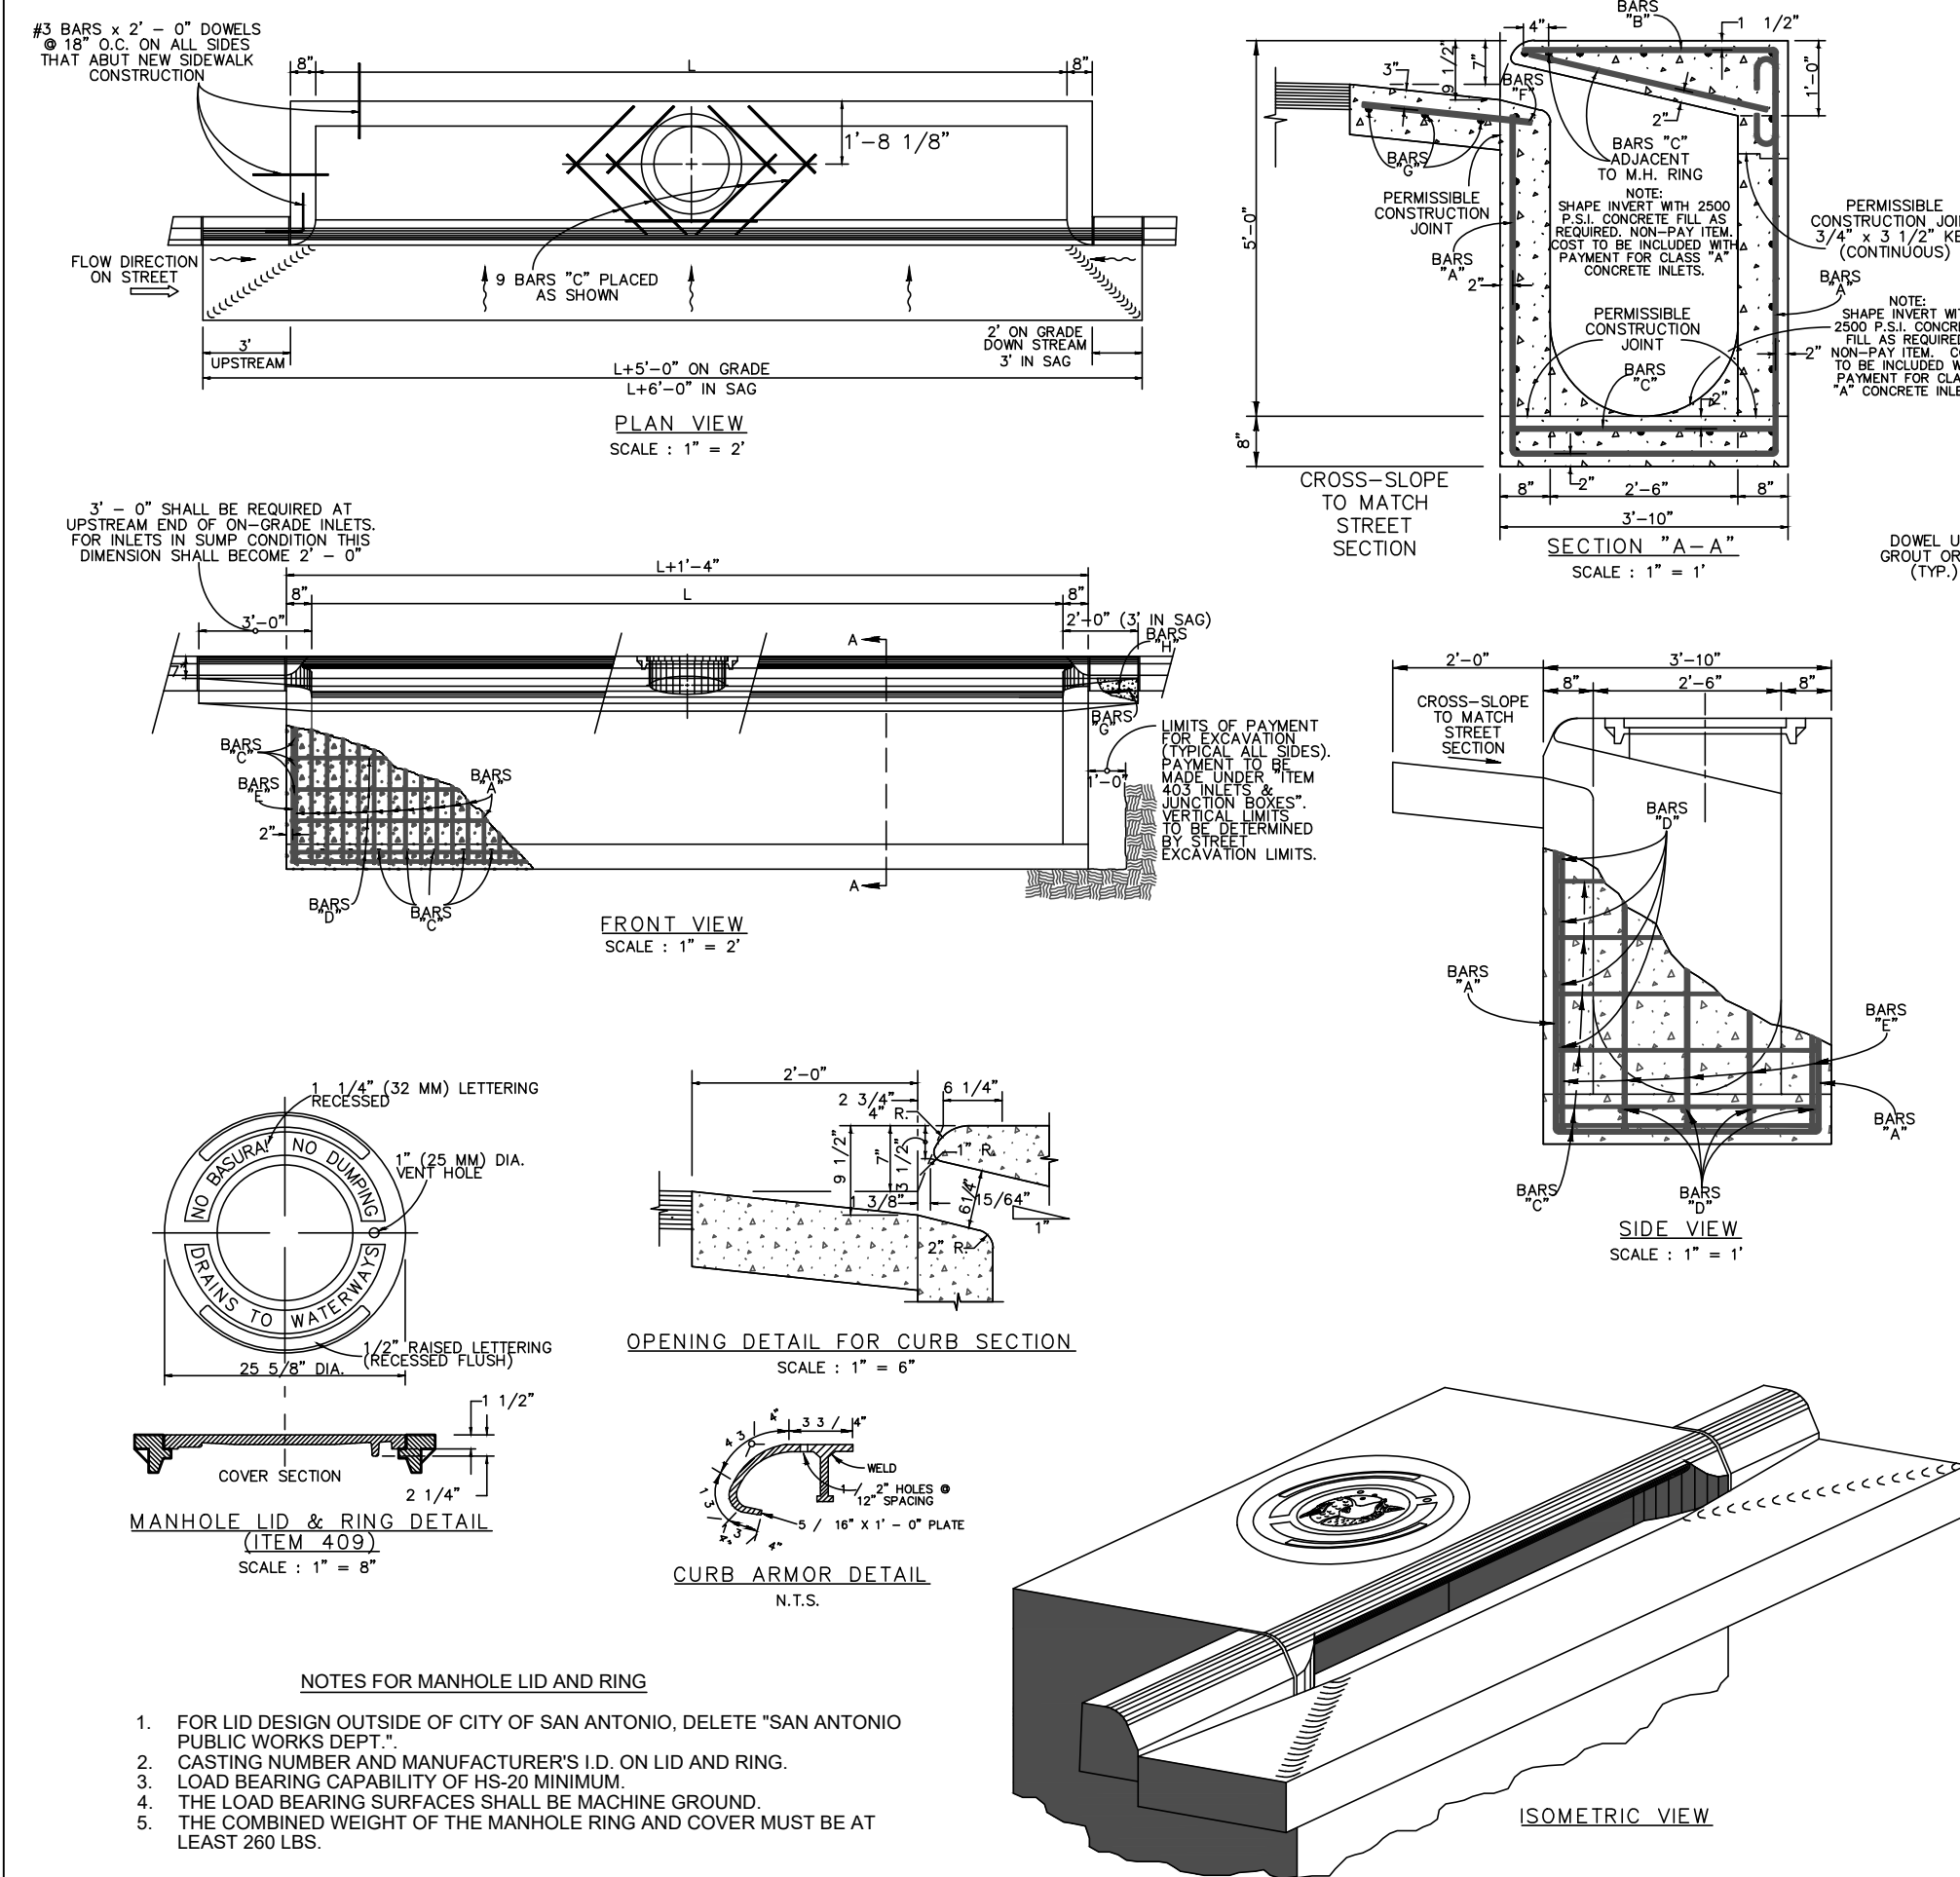


TYPE "C" INLET STANDARDS



STREET NOTES:

1. A MEDINA COUNTY PERMIT MUST BE OBTAINED BEFORE WORKING IN MEDINA COUNTY ROW. CONTRACTOR SHALL COORDINATE A TRAFFIC CONTROL PLAN FOR ALL WORK WITHIN THE ROW. ADDITIONAL WARNING SIGNS MAY BE RECOMMENDED BY THE ENGINEER ONCE THE ROADWAYS ARE CONSTRUCTED.
2. CONTRACTOR SHALL MATCH EXISTING PAVEMENT AT TIE-IN. IF EXISTING PAVEMENT ELEVATION DIFFERS SIGNIFICANTLY, CONTRACTOR SHALL NOTIFY THE ENGINEER PRIOR TO CONTINUING WORK.
3. SIDEWALKS SHALL BE CONSTRUCTED A MINIMUM OF 3 FT. FROM THE BACK OF CURB FOR ALL LOCATIONS WHERE THE SIDEWALK IS SHOWN OFFSET. REFER TO STREET DETAIL SHEET FOR SIDEWALK AND RAMP DETAILS.
4. NO PERMANENT STRUCTURES HIGHER THAN 3 FT., AND LOWER THAN 8 FT. ABOVE THE PAVEMENT INCLUDING STRUCTURES, WALLS, FENCES, AND VEGETATION, SHALL BE CONSTRUCTED OR ALLOWED WITHIN THE CLEAR VISION EASEMENT. CONTRACTOR SHALL GRADE AREAS WITHIN CLEAR VISION EASEMENTS SUCH THAT THE ELEVATION WITHIN THE CLEAR VISION EASEMENT IS NOT HIGHER THAN 3 FT. ABOVE THE ADJACENT TOP OF PAVEMENT.
5. DRIVEWAYS SHOWN ON THIS PLAN ARE FOR THE SOLE PURPOSE OF INDICATION A POTENTIAL CONFLICT WITH CURB RAMP, DRAINAGE INFRASTRUCTURE, OR OTHER CONFLICT. DRIVEWAY LOCATION IS SUBJECT TO CHANGE BASED ON HOME SELECTION AND FINAL LOT DESIGN.
6. CHANGES IN THE SIDEWALK LOCATION FOR A MAXIMUM LINEAR DISTANCE OF TWO HUNDRED (200) FEET ARE PERMITTED TO BE APPROVED BY THE FIELD INSPECTOR WITHOUT AMENDING THE STREET PLAN OR UTILITY LAYOUT PER LOC SECTION 35-506 (Q)(6).
7. ALL RAMPS AND ANY PROPOSED SIDEWALKS THAT DO NOT FRONT PROPOSED RESIDENTIAL LOTS ARE REQUIRED TO BE CONSTRUCTED WITH STREET CONSTRUCTION.

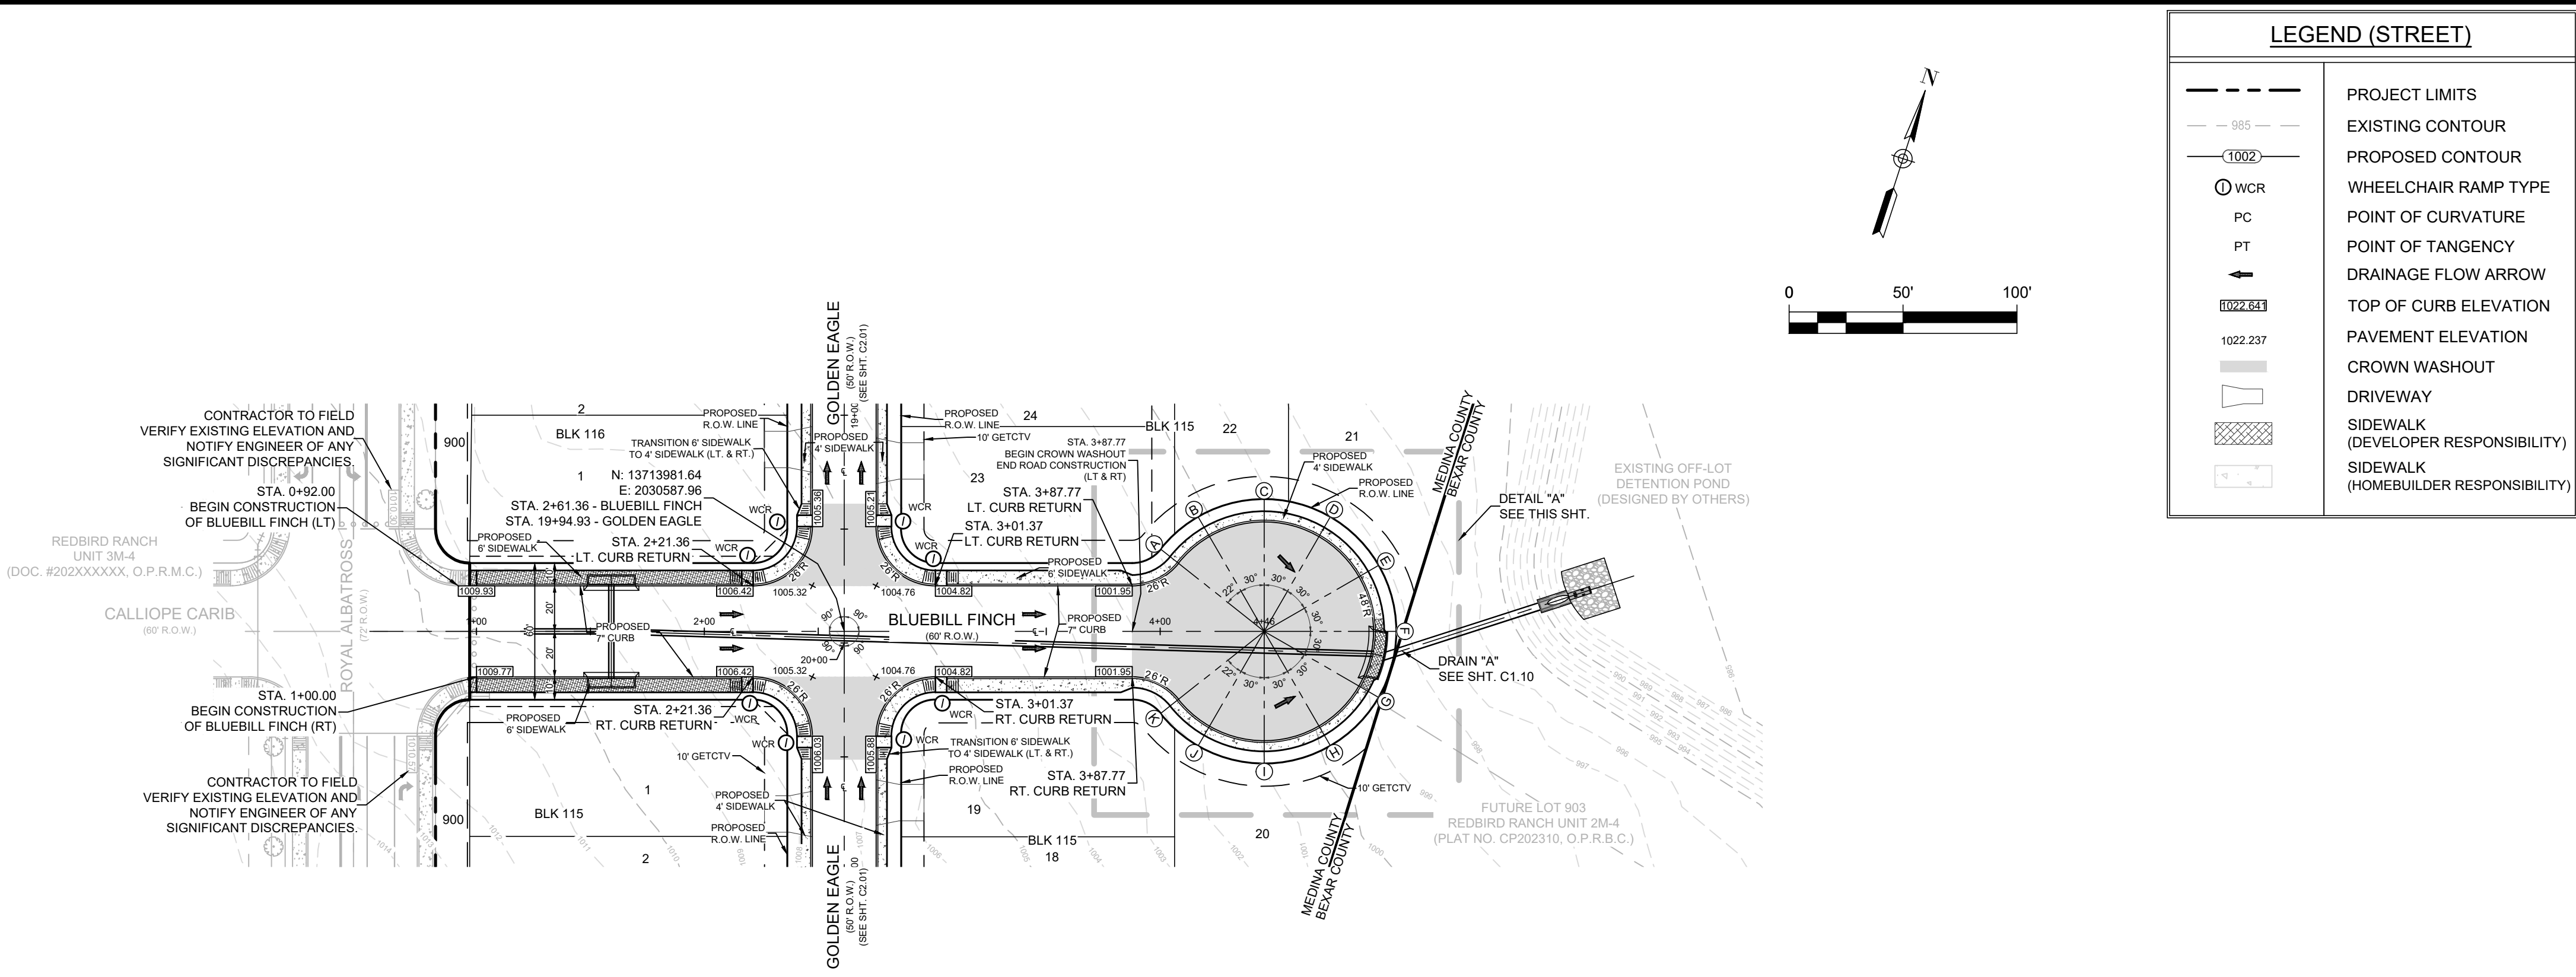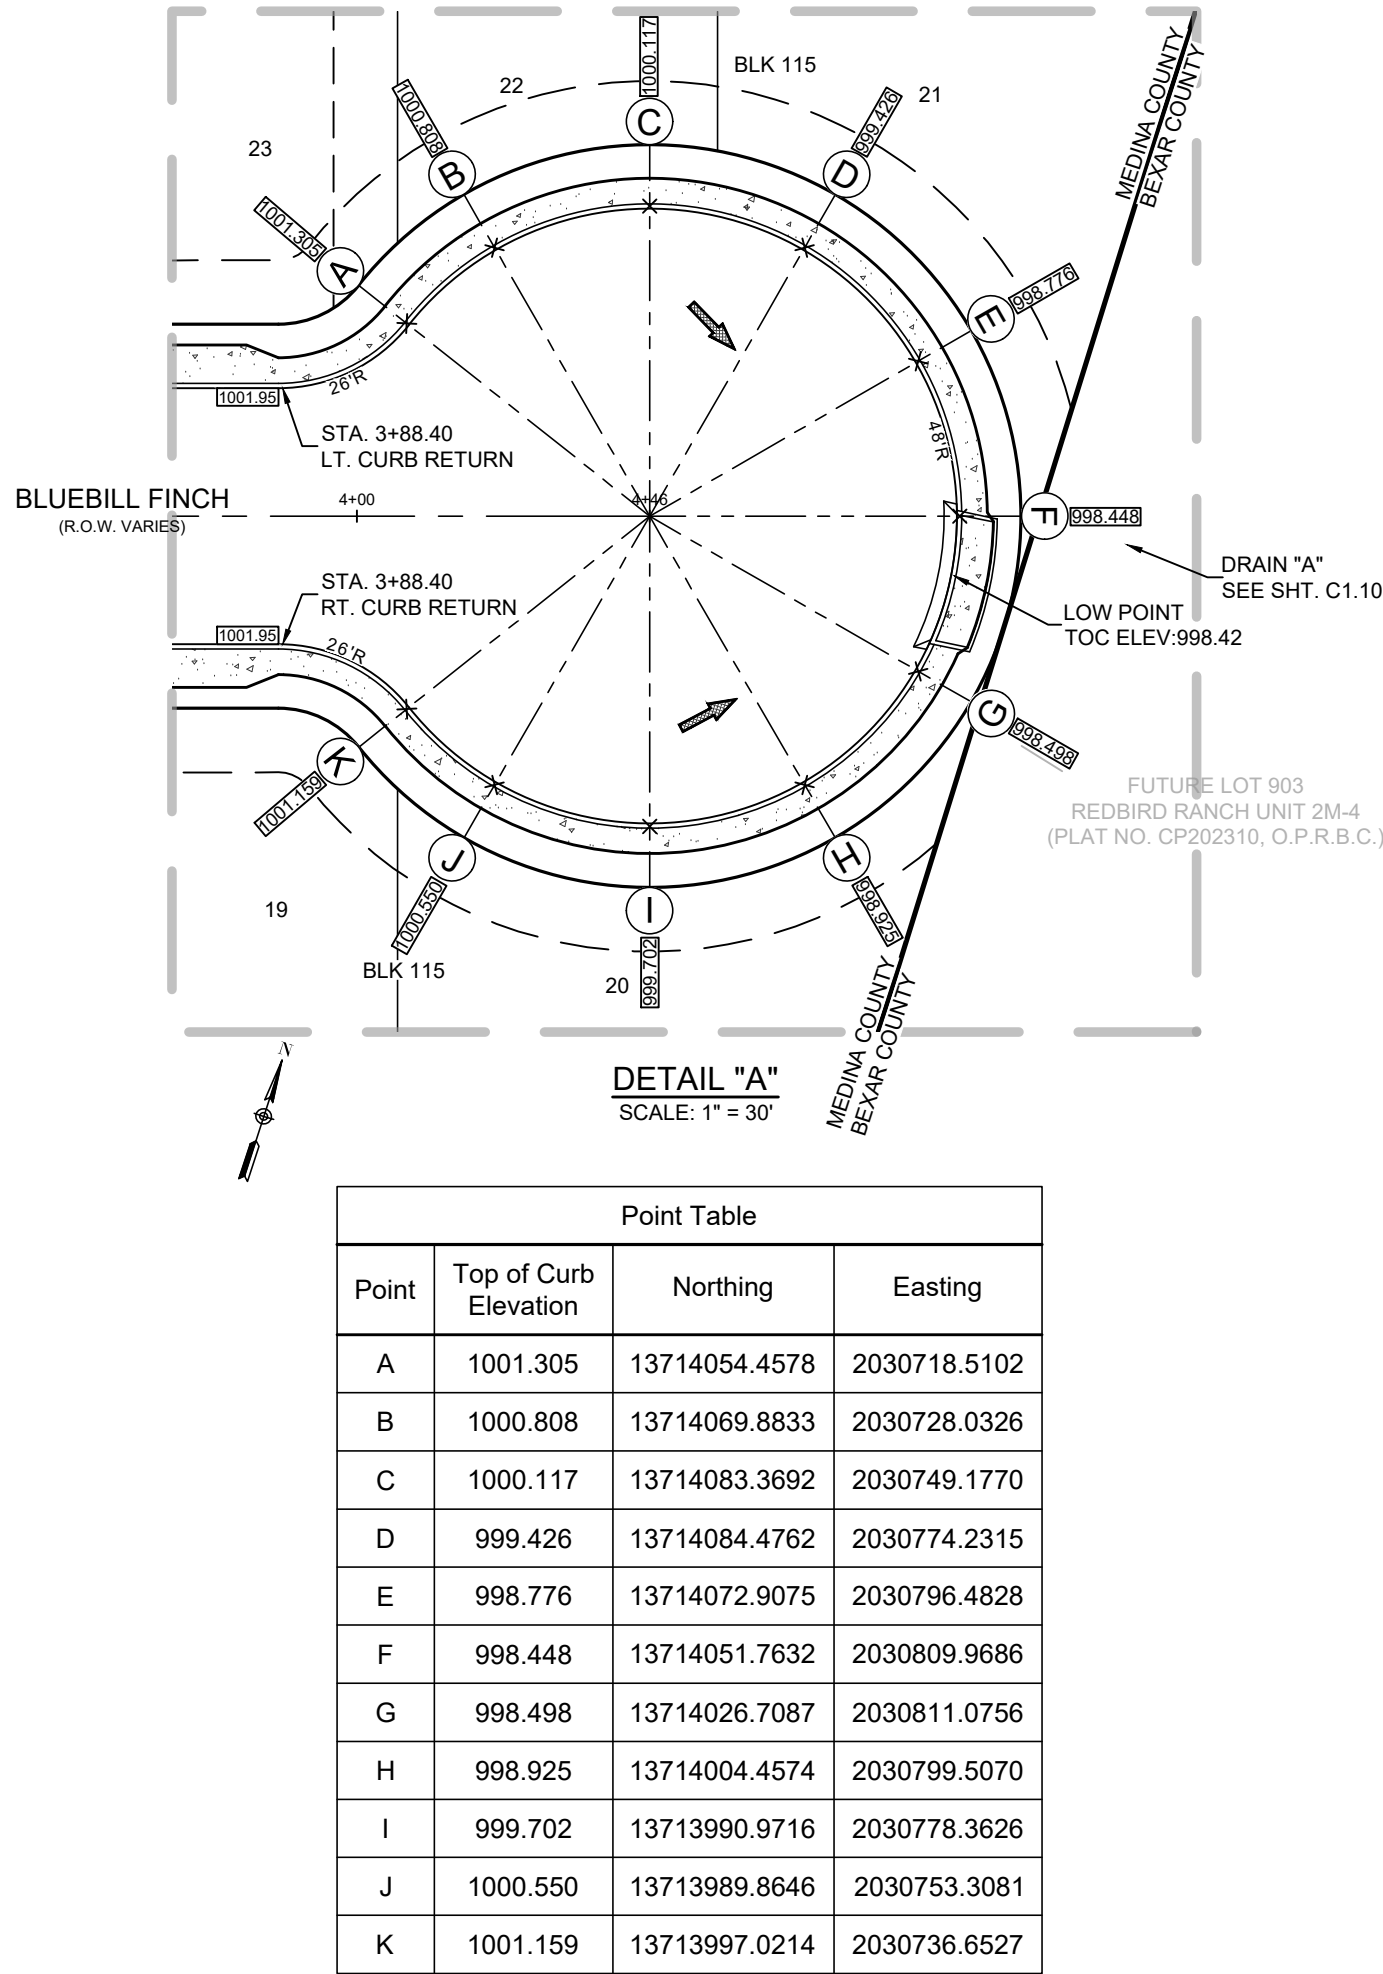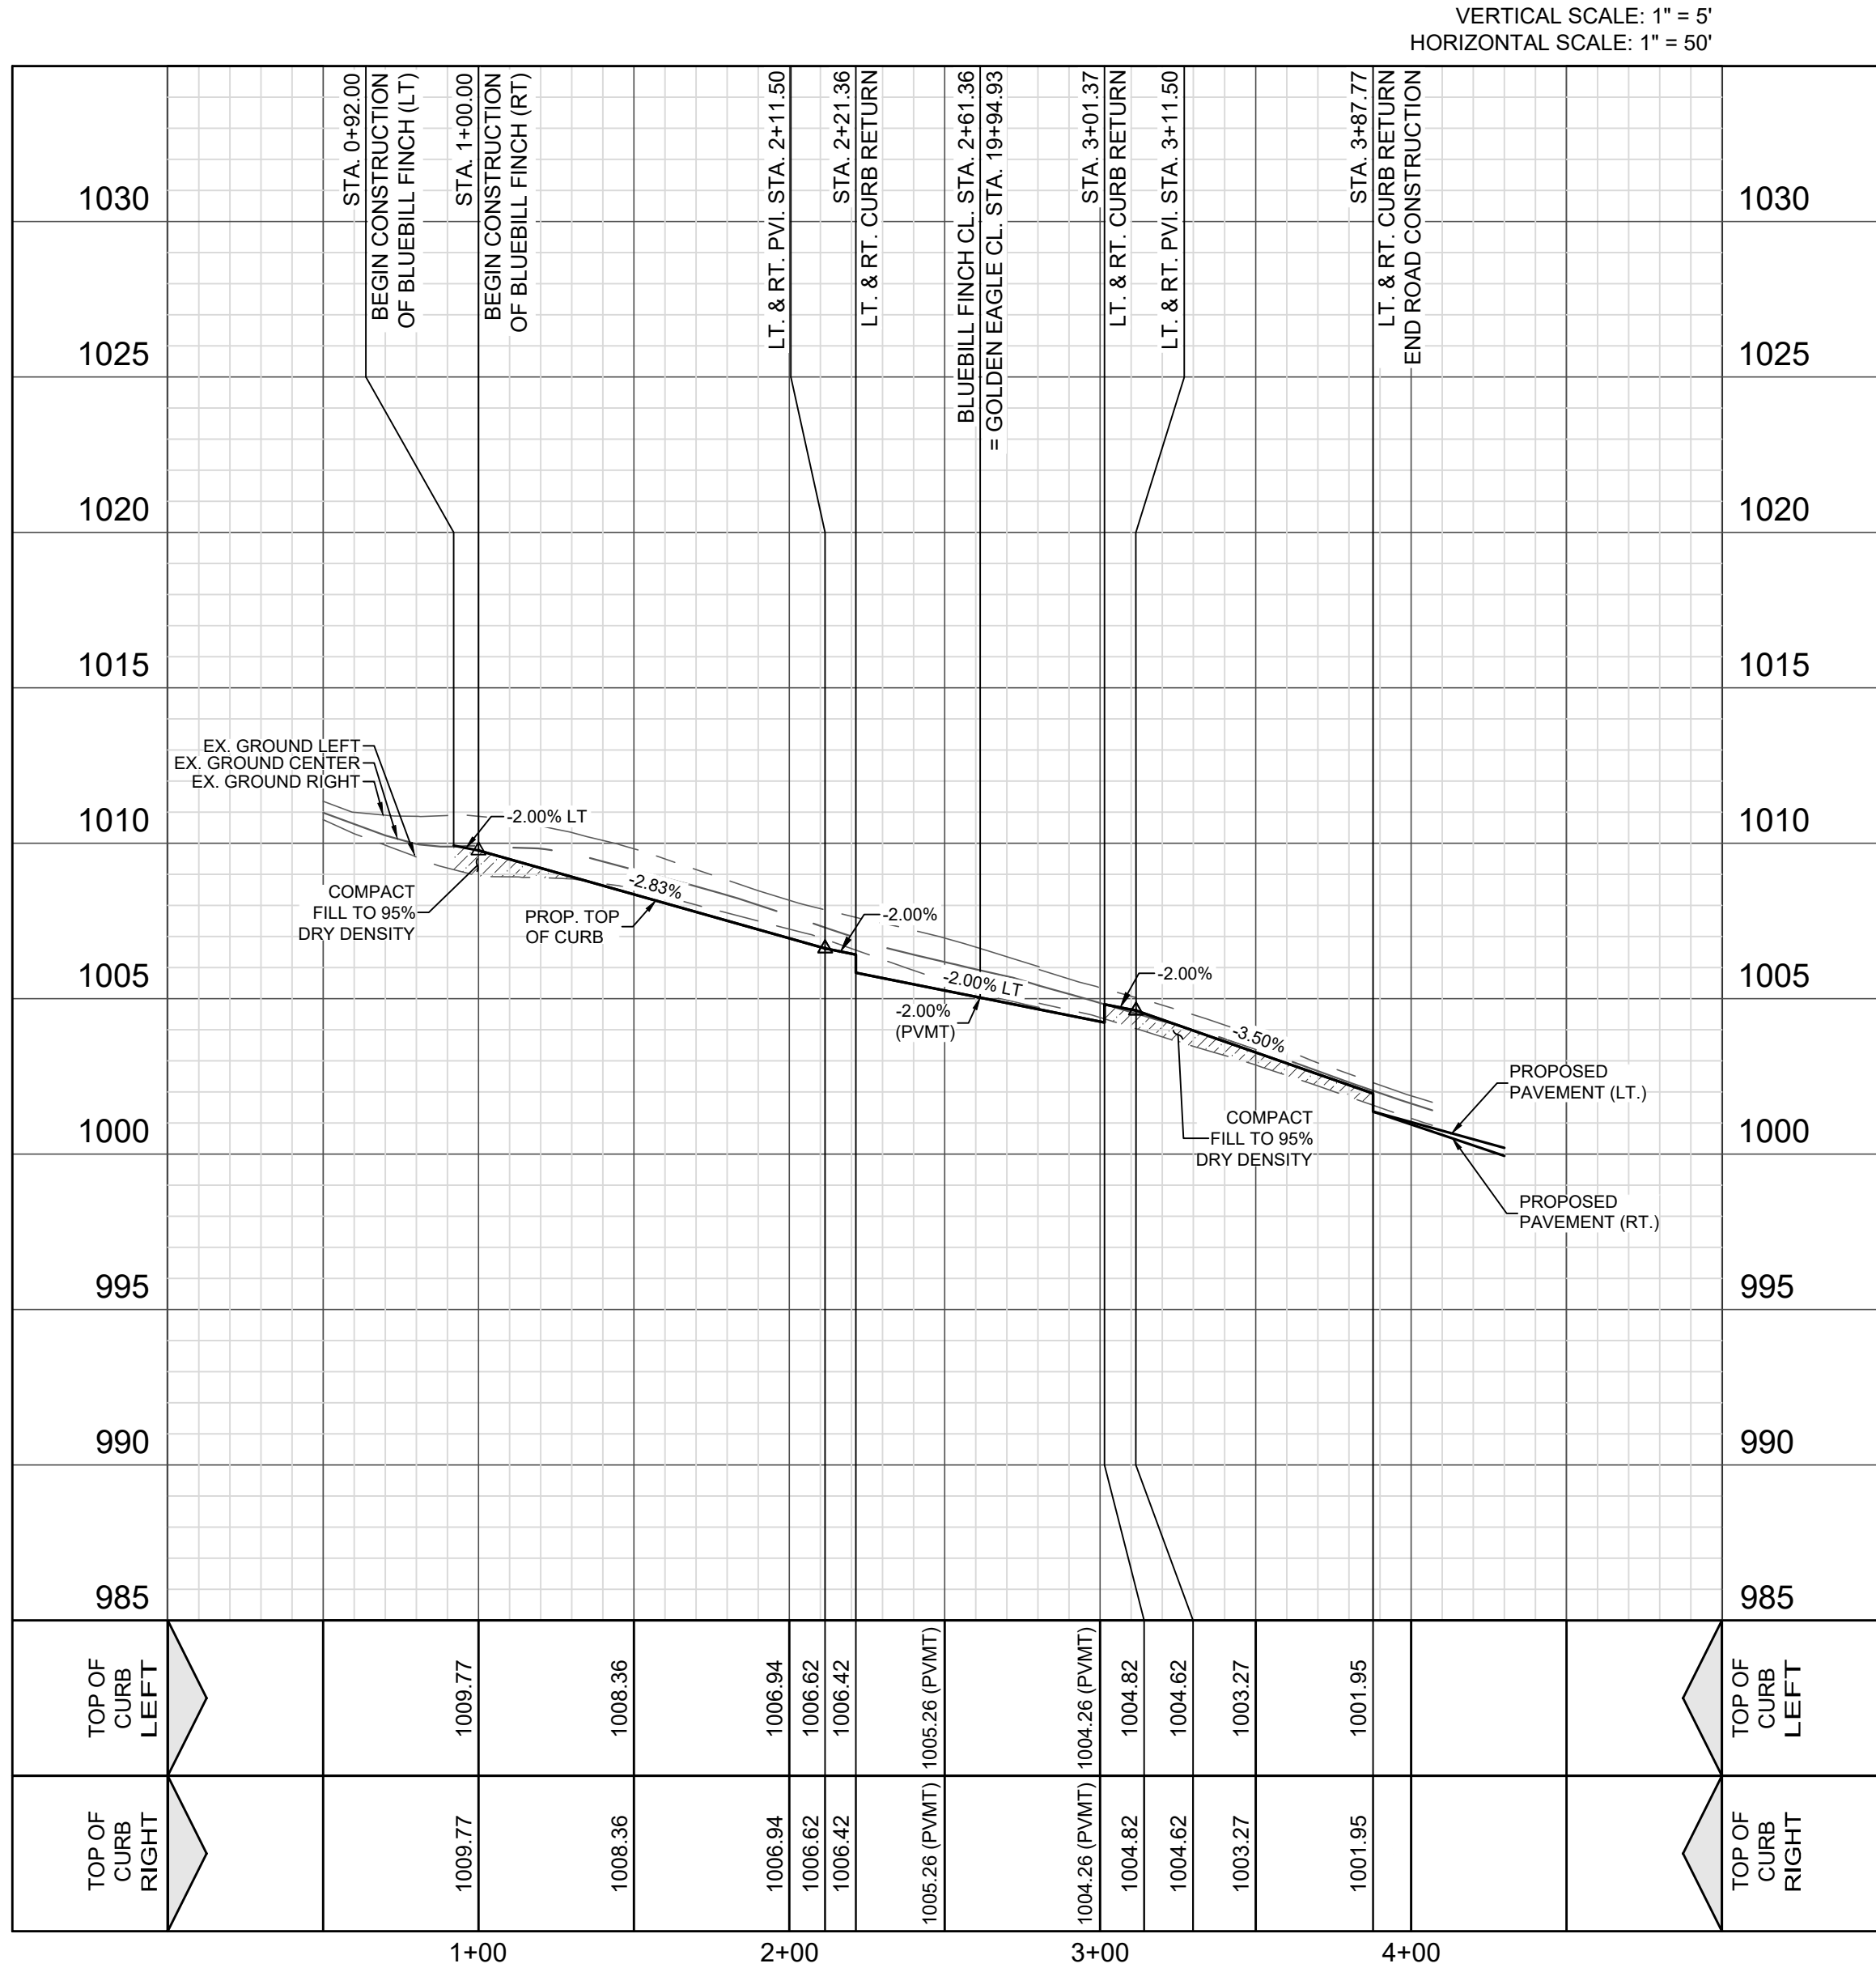

BLUEBILL FINCH  
STA. 1+00.00 TO 3+87.77

REDBIRD RANCH UNIT 2M-2  
SAN ANTONIO, TX  
BLUEBILL FINCH - STA. 1+00.00 -  
3+87.77

DESIGNED BY: JWS  
DRAWN BY: SQV/JWS  
DATE: 3/20/2024  
JOB NO.: 05000-200  
SHEET NO.

C2.00

DHI Engineering, LLC.  
4419 LOOP 1604 EAST  
SUITE 100  
SAN ANTONIO, TEXAS 78257  
(210) 482-2988 | dhiengineering.com  
TBP REG. NO. F-195661

DHI


3/20/2024

STATE OF TEXAS  
VANCE L. WEYLAND  
99269  
PROFESSIONAL ENGINEER  
CIVIL  
Vance Weyland

REV	DATE	DESCRIPTION




DHI ENGINEERING, LLC. THIS DOCUMENT HAS BEEN PRODUCED FROM MATERIAL THAT WAS STORED AND/OR TRANSMITTED ELECTRONICALLY AND MAY HAVE BEEN INADVERTENTLY ALTERED. RELY ONLY ON ORIGINAL HARD COPY MATERIALS BEARING THE CONSULTANT'S ORIGINAL SIGNATURE AND SEAL.

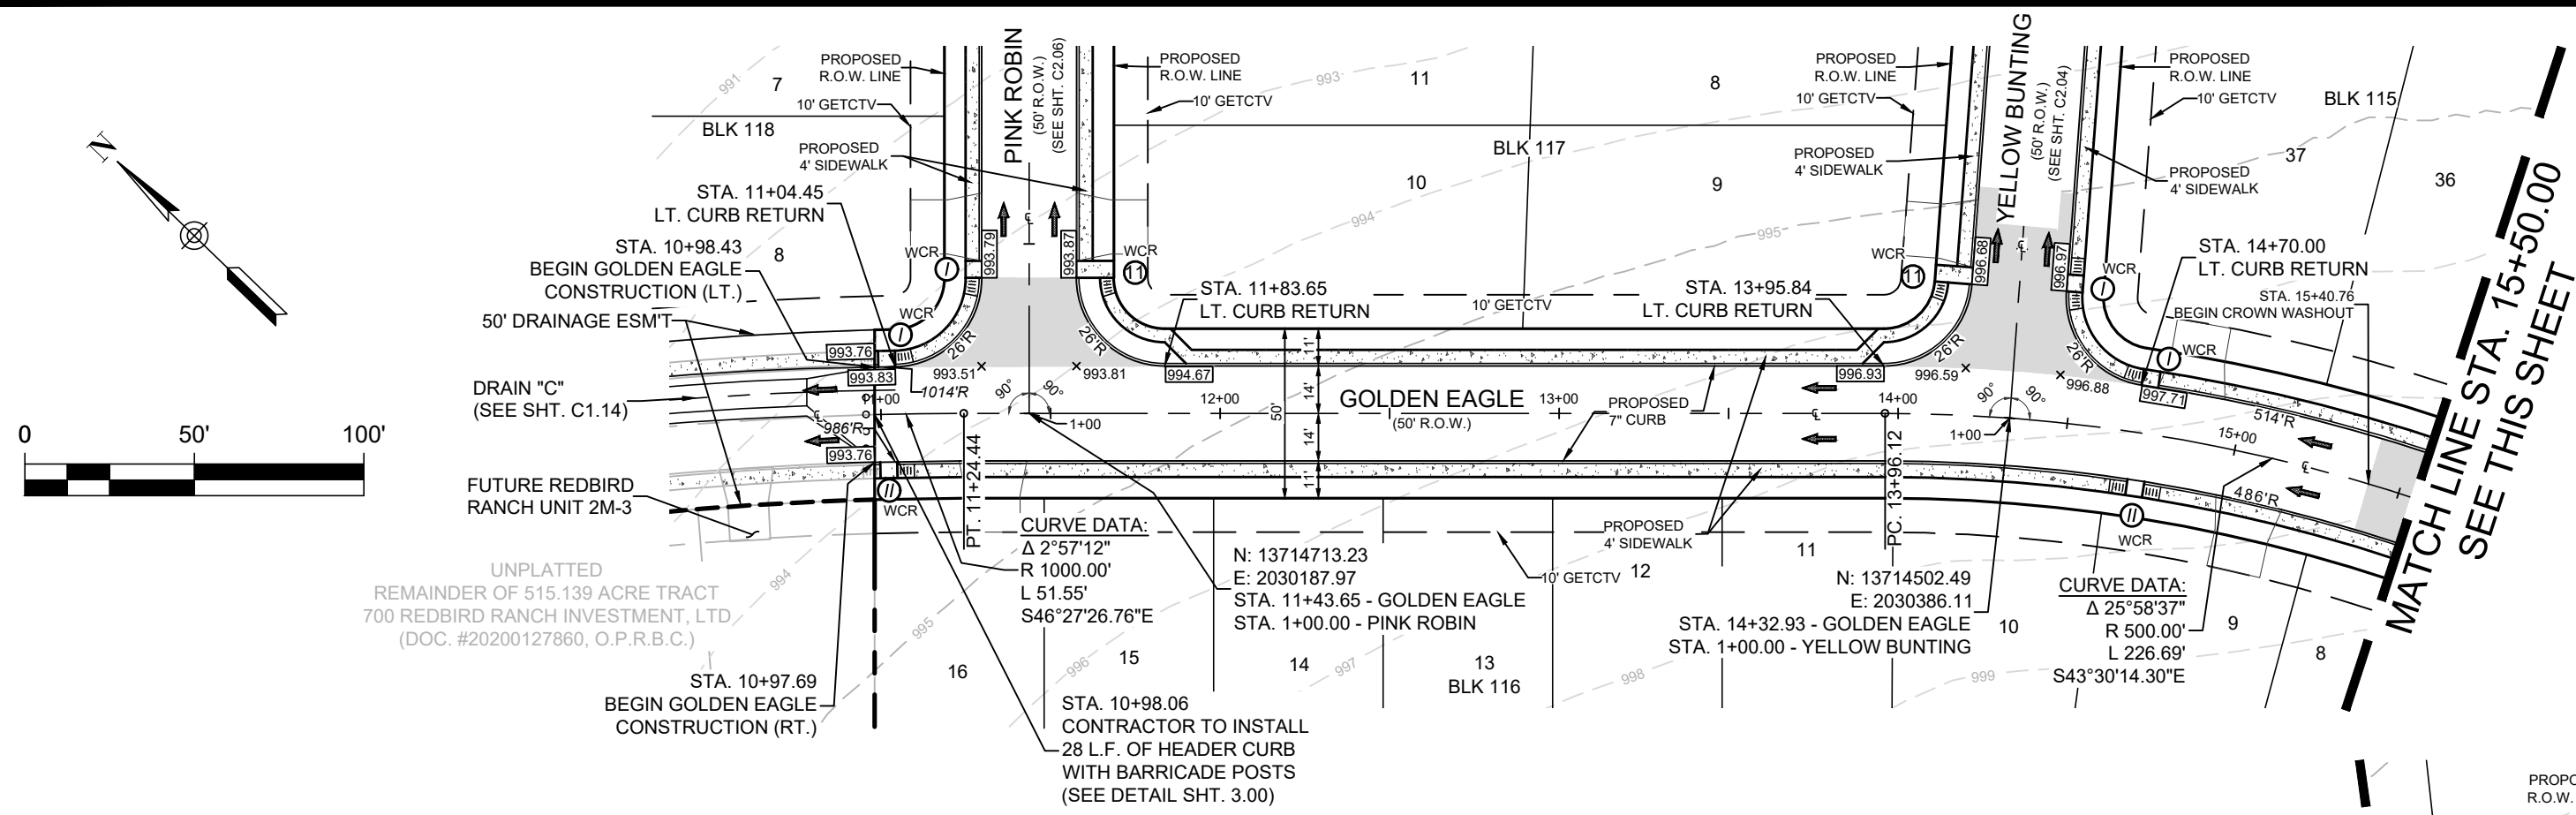



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- CONTRACTOR SHALL MATCH EXISTING PAVEMENT AT THE RT. IF EXISTING PAVEMENT ELEVATION DIFFERS SIGNIFICANTLY, CONTRACTOR SHALL NOTIFY THE ENGINEER PRIOR TO CONTINUING WORK.
- SIDEWALKS SHALL BE CONSTRUCTED A MINIMUM OF 3 FT. FROM THE BACK OF CURB FOR ALL LOCATIONS WHERE THE SIDEWALK IS SHOWN OFFSET. REFER TO STREET DETAIL SHEET FOR SIDEWALK AND RAMP DETAILS.
- NO PERMANENT STRUCTURES HIGHER THAN 3 FT. AND LOWER THAN 8 FT. ABOVE THE PAVEMENT INCLUDING STRUCTURES, WALLS, FENCES, AND VEGETATION, SHALL BE CONSTRUCTED OR ALLOWED WITHIN THE CLEAR VISION EASEMENT. CONTRACTOR SHALL GRADE AREAS WITHIN CLEAR VISION EASEMENTS SUCH THAT THE ELEVATION WITHIN THE CLEAR VISION EASEMENT IS NOT HIGHER THAN 3 FT. ABOVE THE ADJACENT TOP OF PAVEMENT.
- DRIVEWAYS SHOWN ON THIS PLAN ARE FOR THE SOLE PURPOSE OF INDICATION A POTENTIAL CONFLICT WITH CURB RAMP, DRAINAGE INFRASTRUCTURE, OR OTHER CONFLICT. DRIVEWAY LOCATION IS SUBJECT TO CHANGE BASED ON HOME SELECTION AND FINAL LOT DESIGN.
- CHANGES IN THE SIDEWALK LOCATION FOR A MAXIMUM LINEAR DISTANCE OF TWO HUNDRED (200) FEET ARE PERMITTED TO BE APPROVED BY THE FIELD INSPECTOR WITHOUT AMENDING THE STREET PLAN OR UTILITY LAYOUT PER UDC SECTION 30-099 (02B).
- ALL RAMP AND ANY PROPOSED SIDEWALKS THAT DO NOT FRONT PROPOSED RESIDENTIAL LOTS ARE REQUIRED TO BE CONSTRUCTED WITH STREET CONSTRUCTION.

**GOLDEN EAGLE  
STA. 10+97.69 TO 21+00.00**

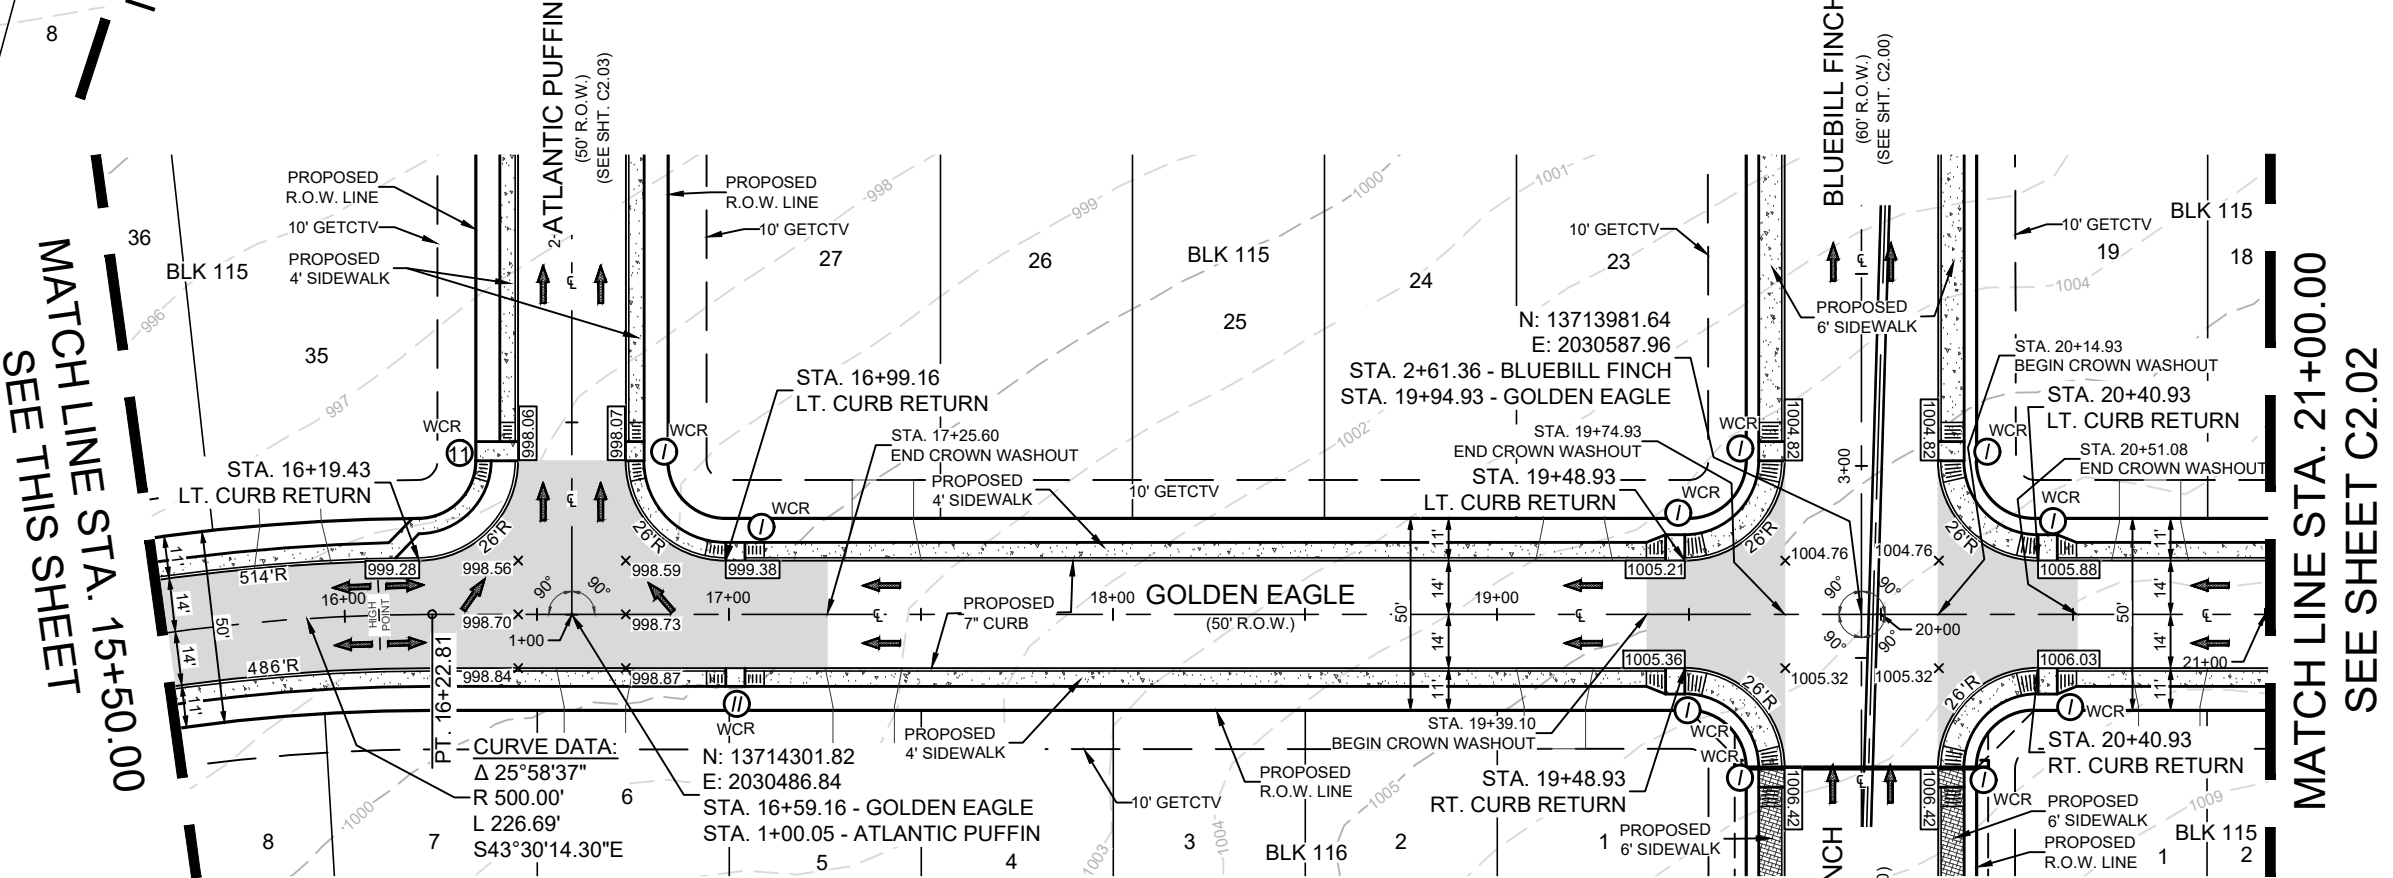

LEGEND (STREET)	
	PROJECT LIMITS
	EXISTING CONTOUR
	PROPOSED CONTOUR
	WHEELCHAIR RAMP TYPE
	POINT OF CURVATURE
	POINT OF TANGENCY
	DRAINAGE FLOW ARROW
	TOP OF CURB ELEVATION
	PAVEMENT ELEVATION
	CROWN WASHOUT
	DRIVEWAY
	SIDEWALK (DEVELOPER RESPONSIBILITY)
	SIDEWALK (HOMEBUILDER RESPONSIBILITY)

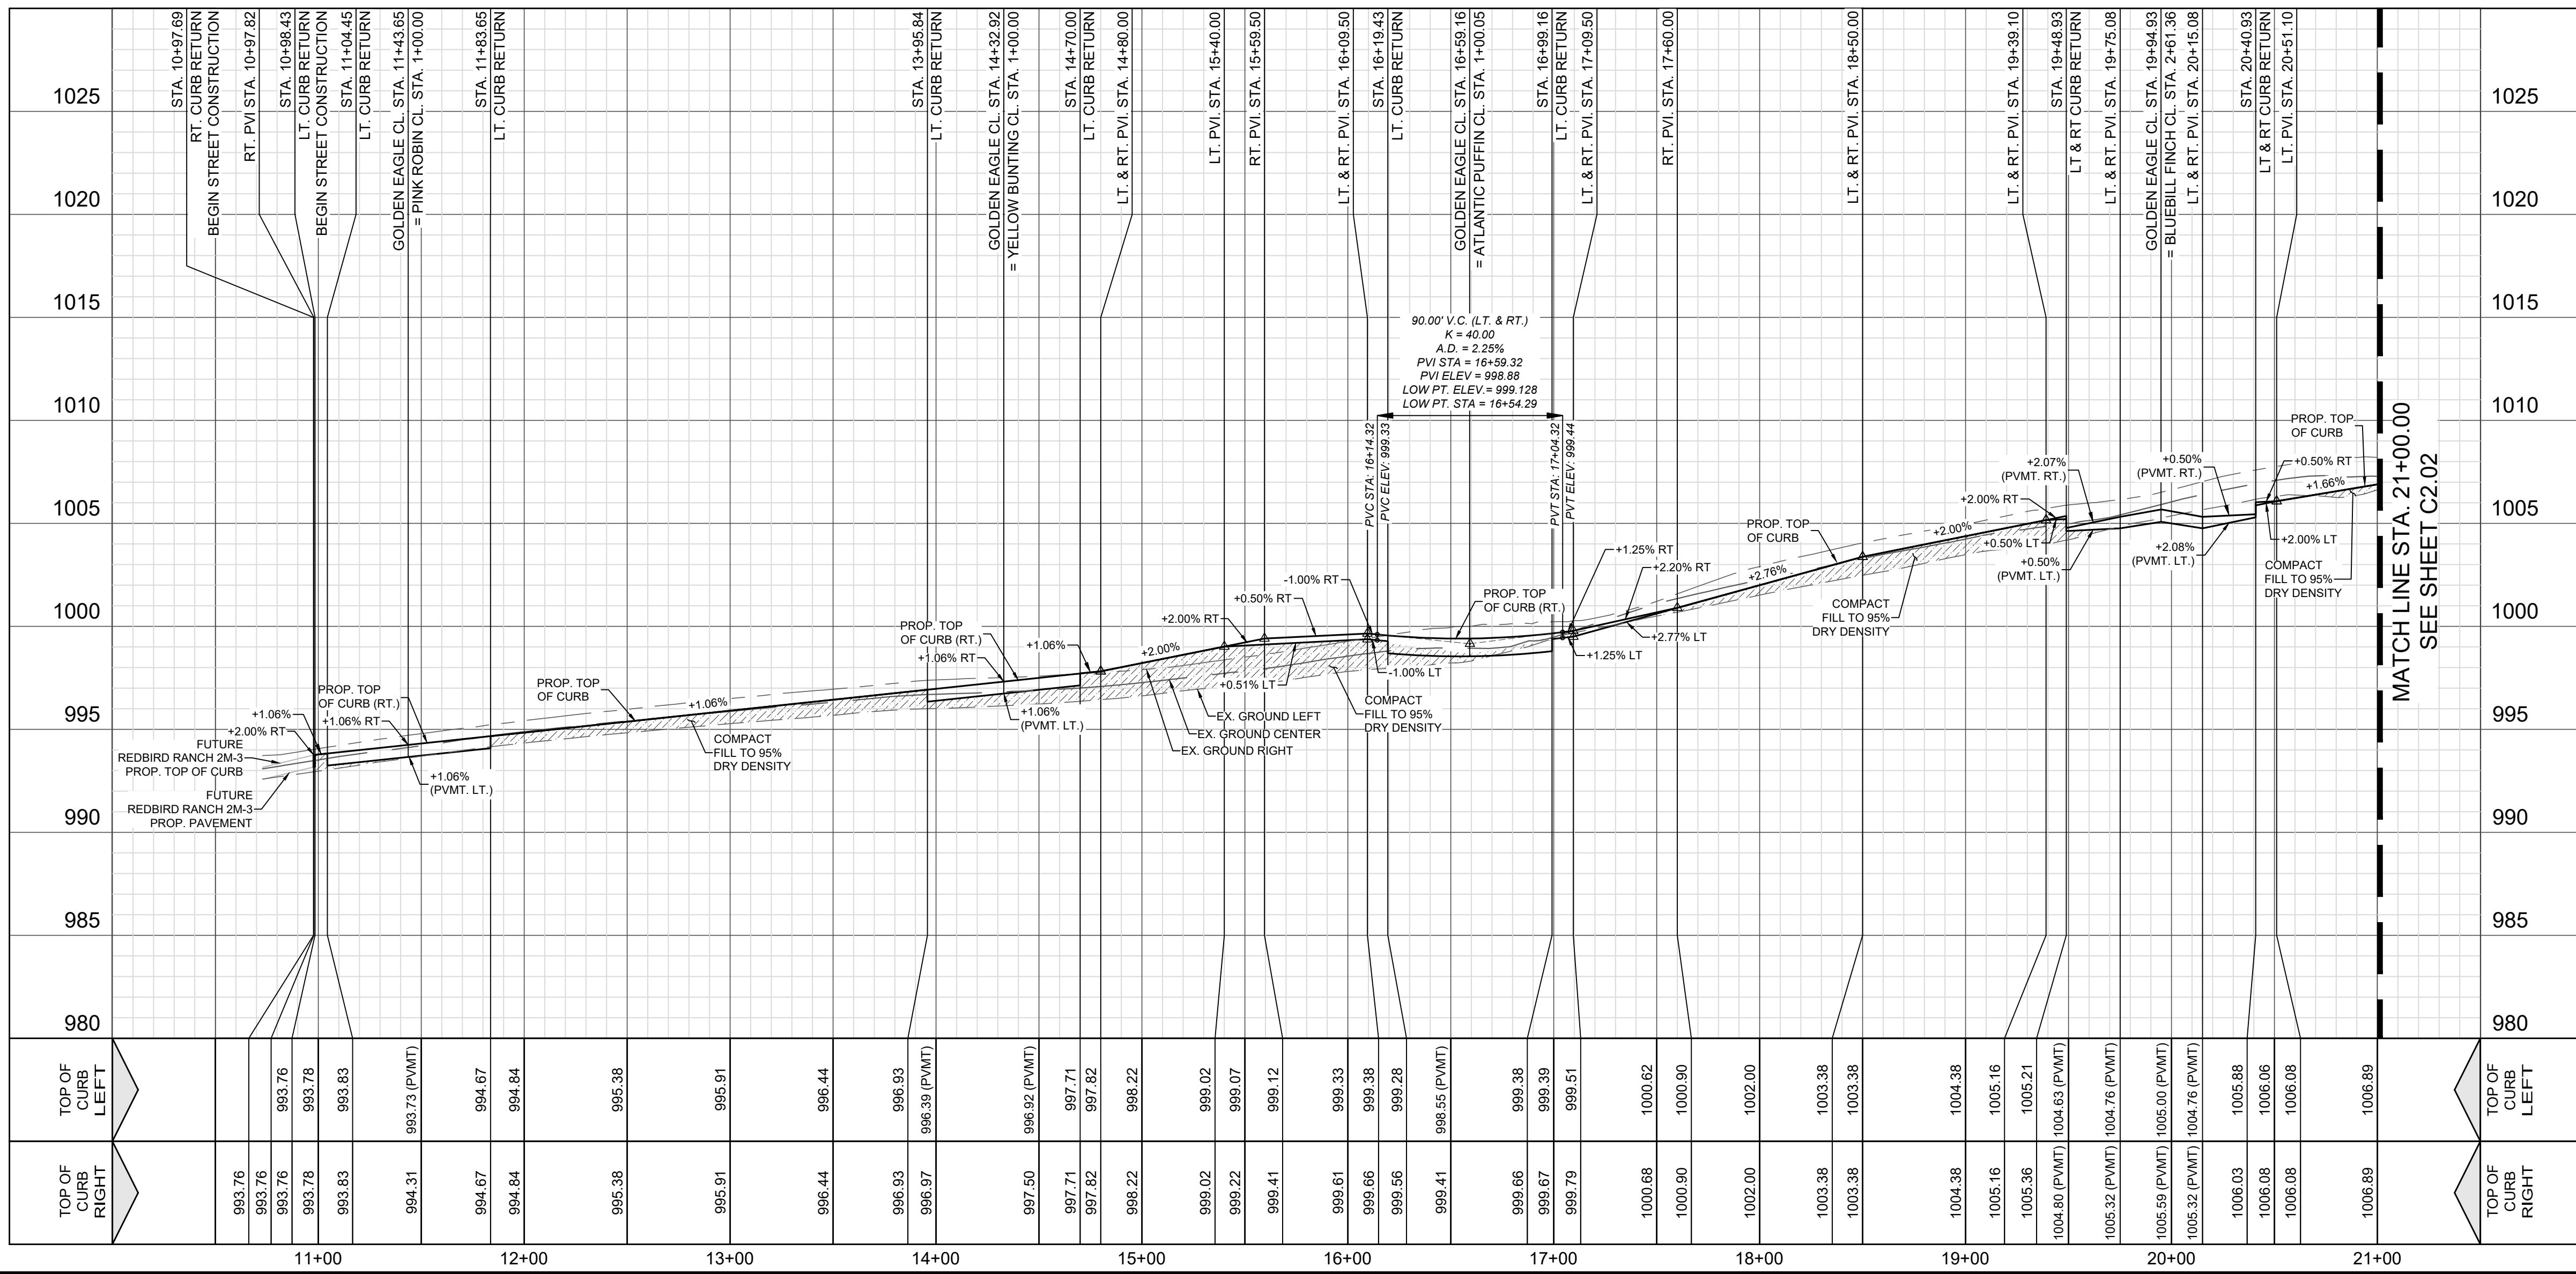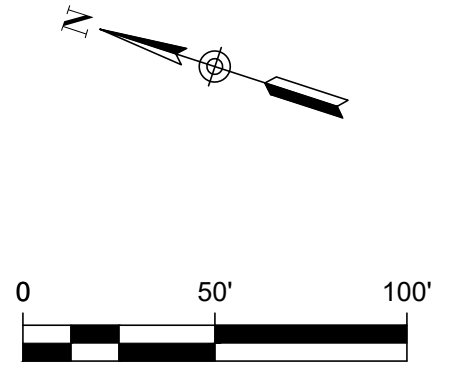

**REDBIRD RANCH UNIT 2M-2  
SAN ANTONIO, TX  
GOLDEN EAGLE - STA. 10+97.69 - 21+00.00**

DESIGNED BY: JWS  
DRAWN BY: SQV/JWS  
DATE: 3/20/2024  
JOB NO.: 05000-200  
SHEET NO. **C2.01**

3/20/2024  
Vance L. Weyand  
Professional Engineer  
No. 99269  
State of Texas



**DHI Engineering, LLC.**  
4419 LOOP 1604 EAST  
SUITE 100  
SAN ANTONIO, TX 78217  
(210) 482-2988 | dhiengineering.com  
TBP REG. NO. F-19561

**DHI**



STREET NOTES:



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7. ALL RAMPS AND ANY PROPOSED SIDEWALKS THAT DO NOT FRONT PROPOSED RESIDENTIAL LOTS ARE REQUIRED TO BE CONSTRUCTED WITH STREET CONSTRUCTION.

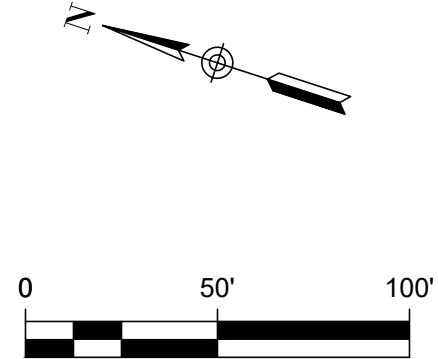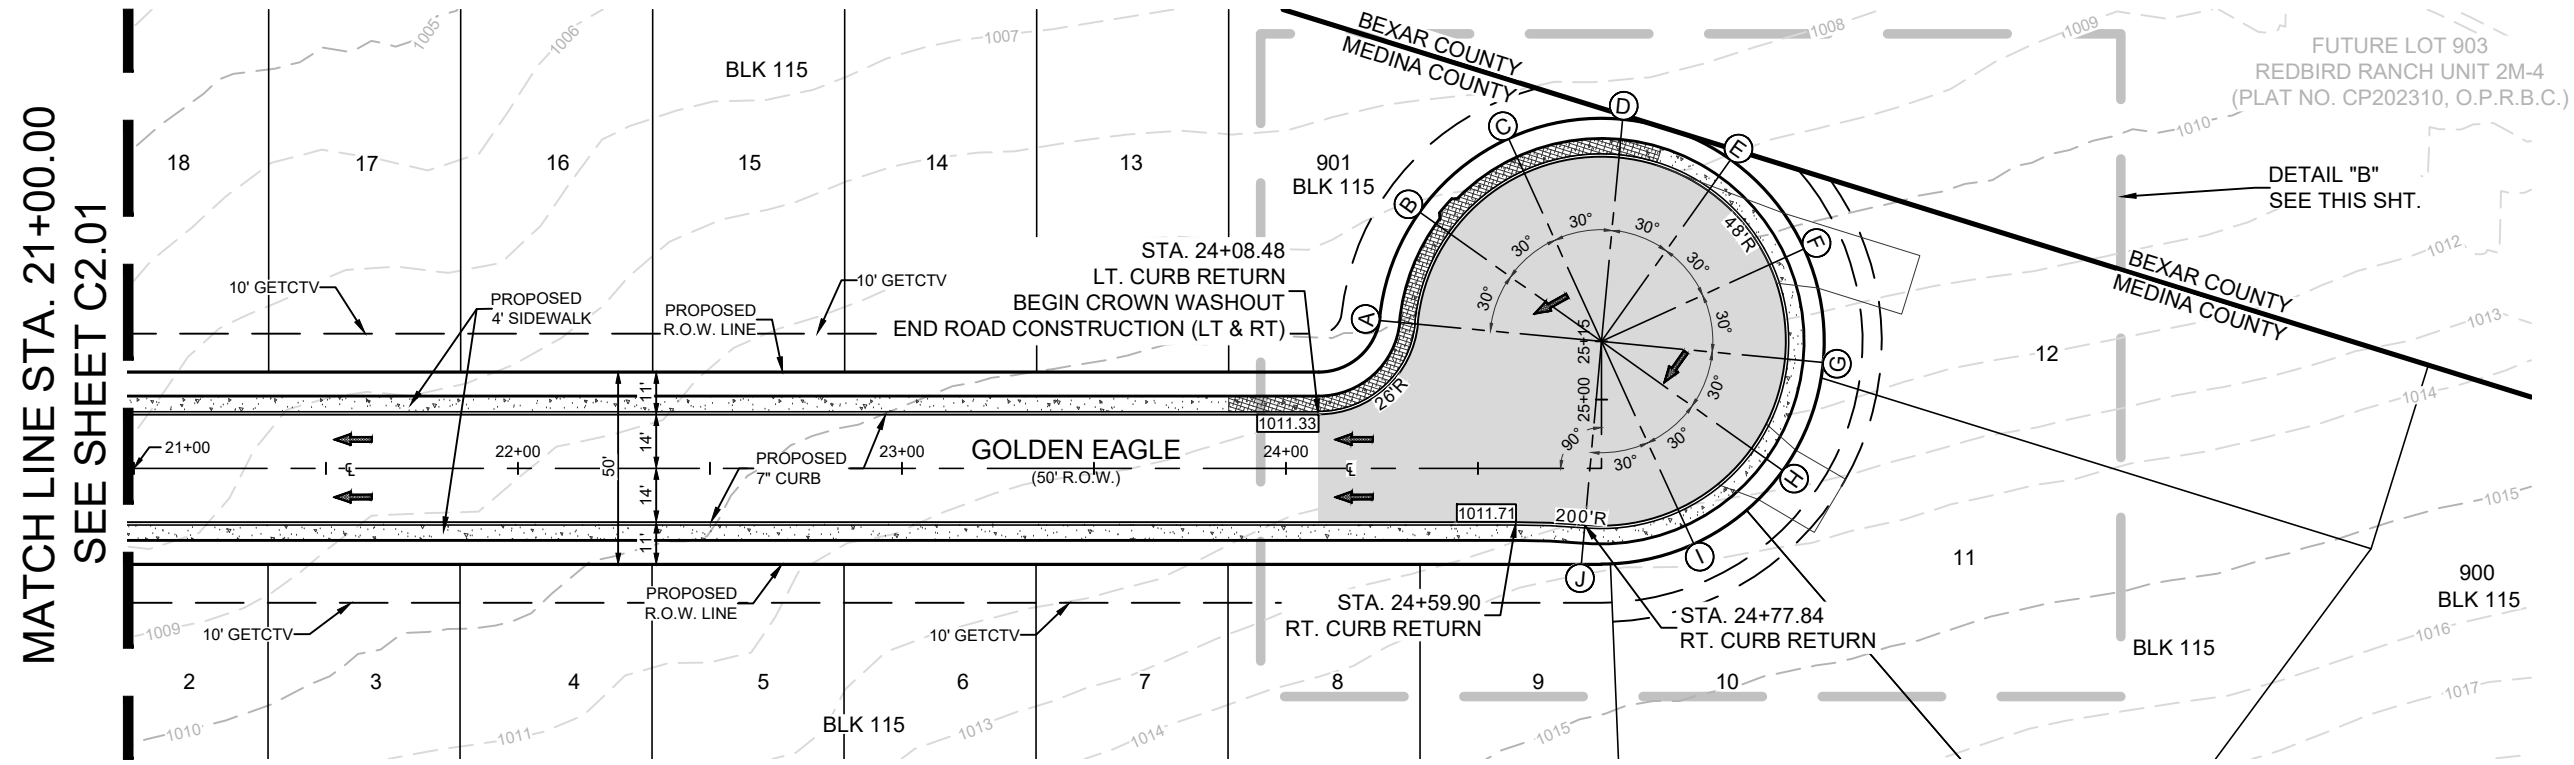

LEGEND (STREET)	
	PROJECT LIMITS
	EXISTING CONTOUR
	PROPOSED CONTOUR
	WHEELCHAIR RAMP TYPE
	POINT OF CURVATURE
	POINT OF TANGENCY
	DRAINAGE FLOW ARROW
	TOP OF CURB ELEVATION
	PAVEMENT ELEVATION
	CROWN WASHOUT
	DRIVEWAY
	SIDEWALK (DEVELOPER RESPONSIBILITY)
	SIDEWALK (HOMEBUILDER RESPONSIBILITY)

GOLDEN EAGLE  
STA. 21+00.00 TO 24+08.48

VERTICAL SCALE: 1" = 5'  
HORIZONTAL SCALE: 1" = 50'

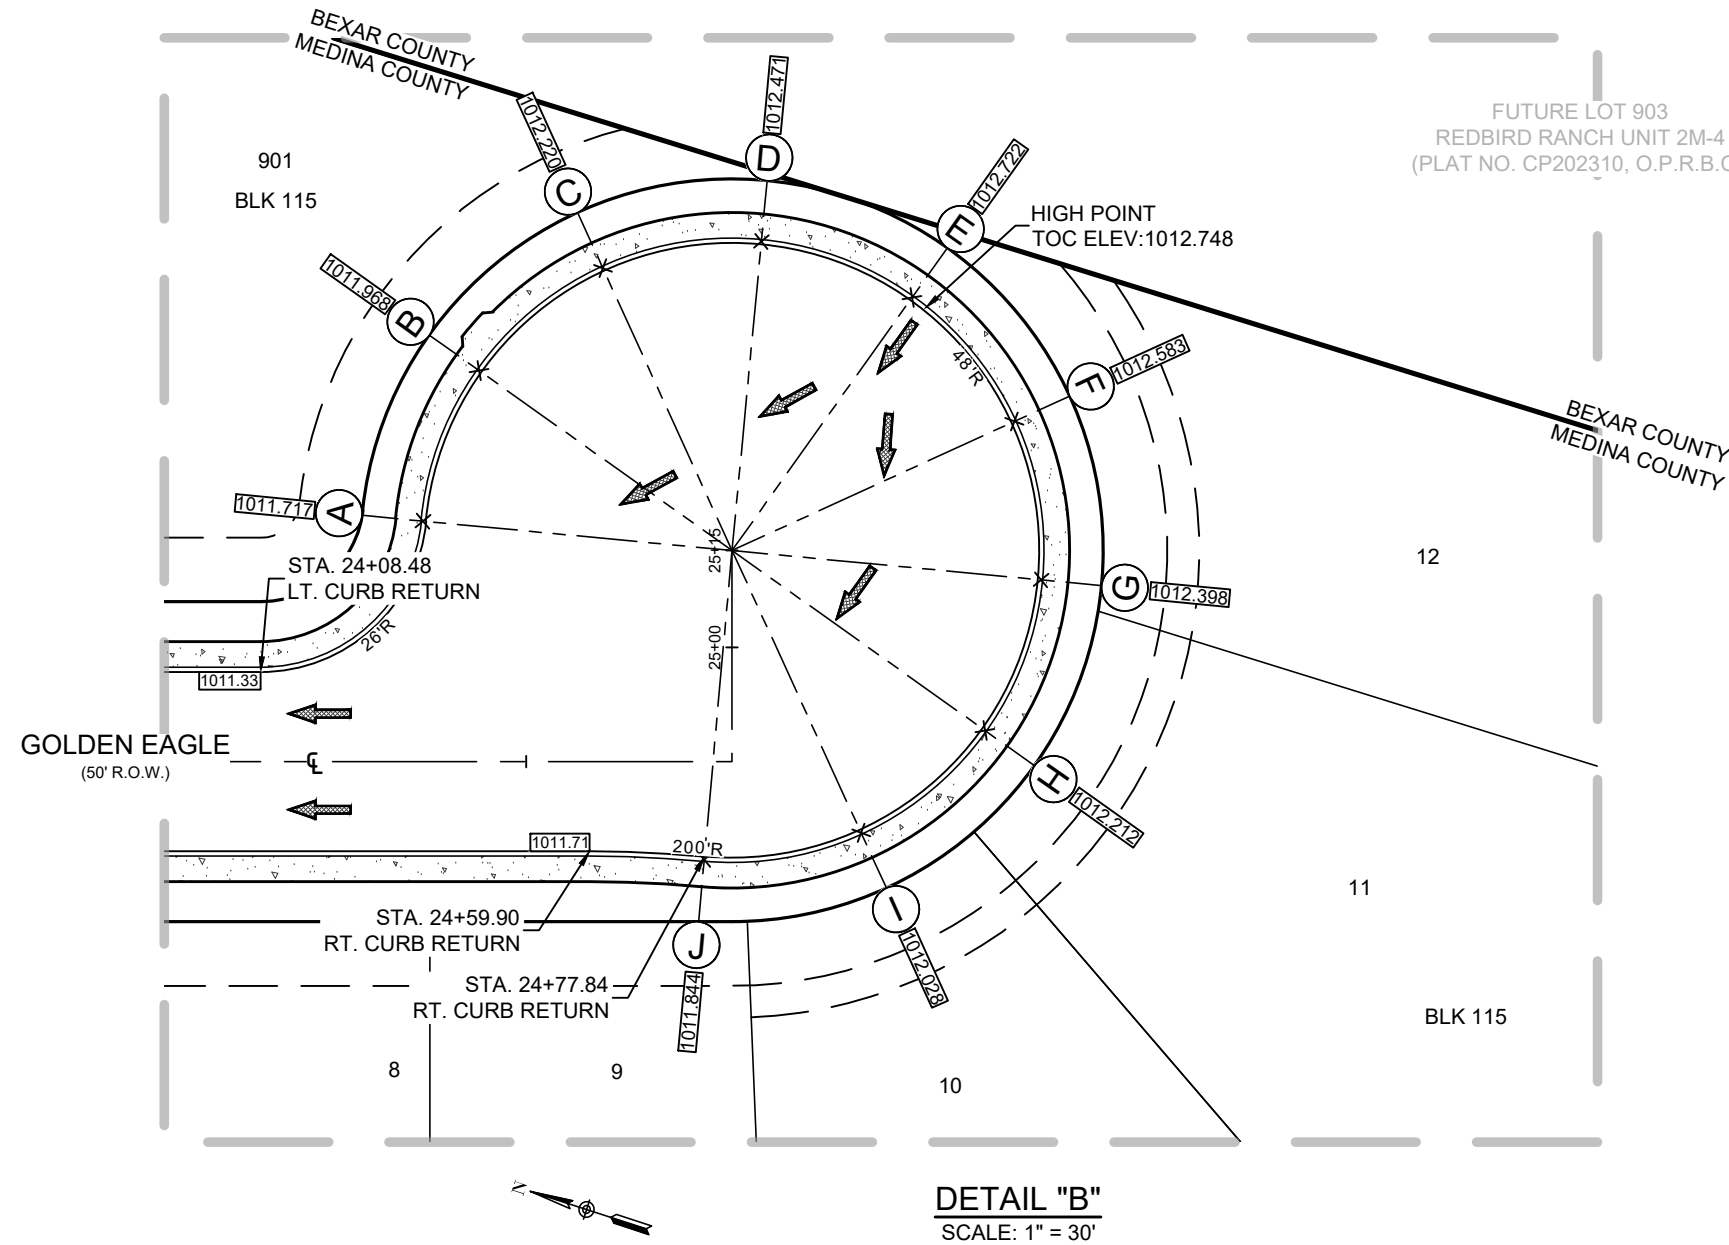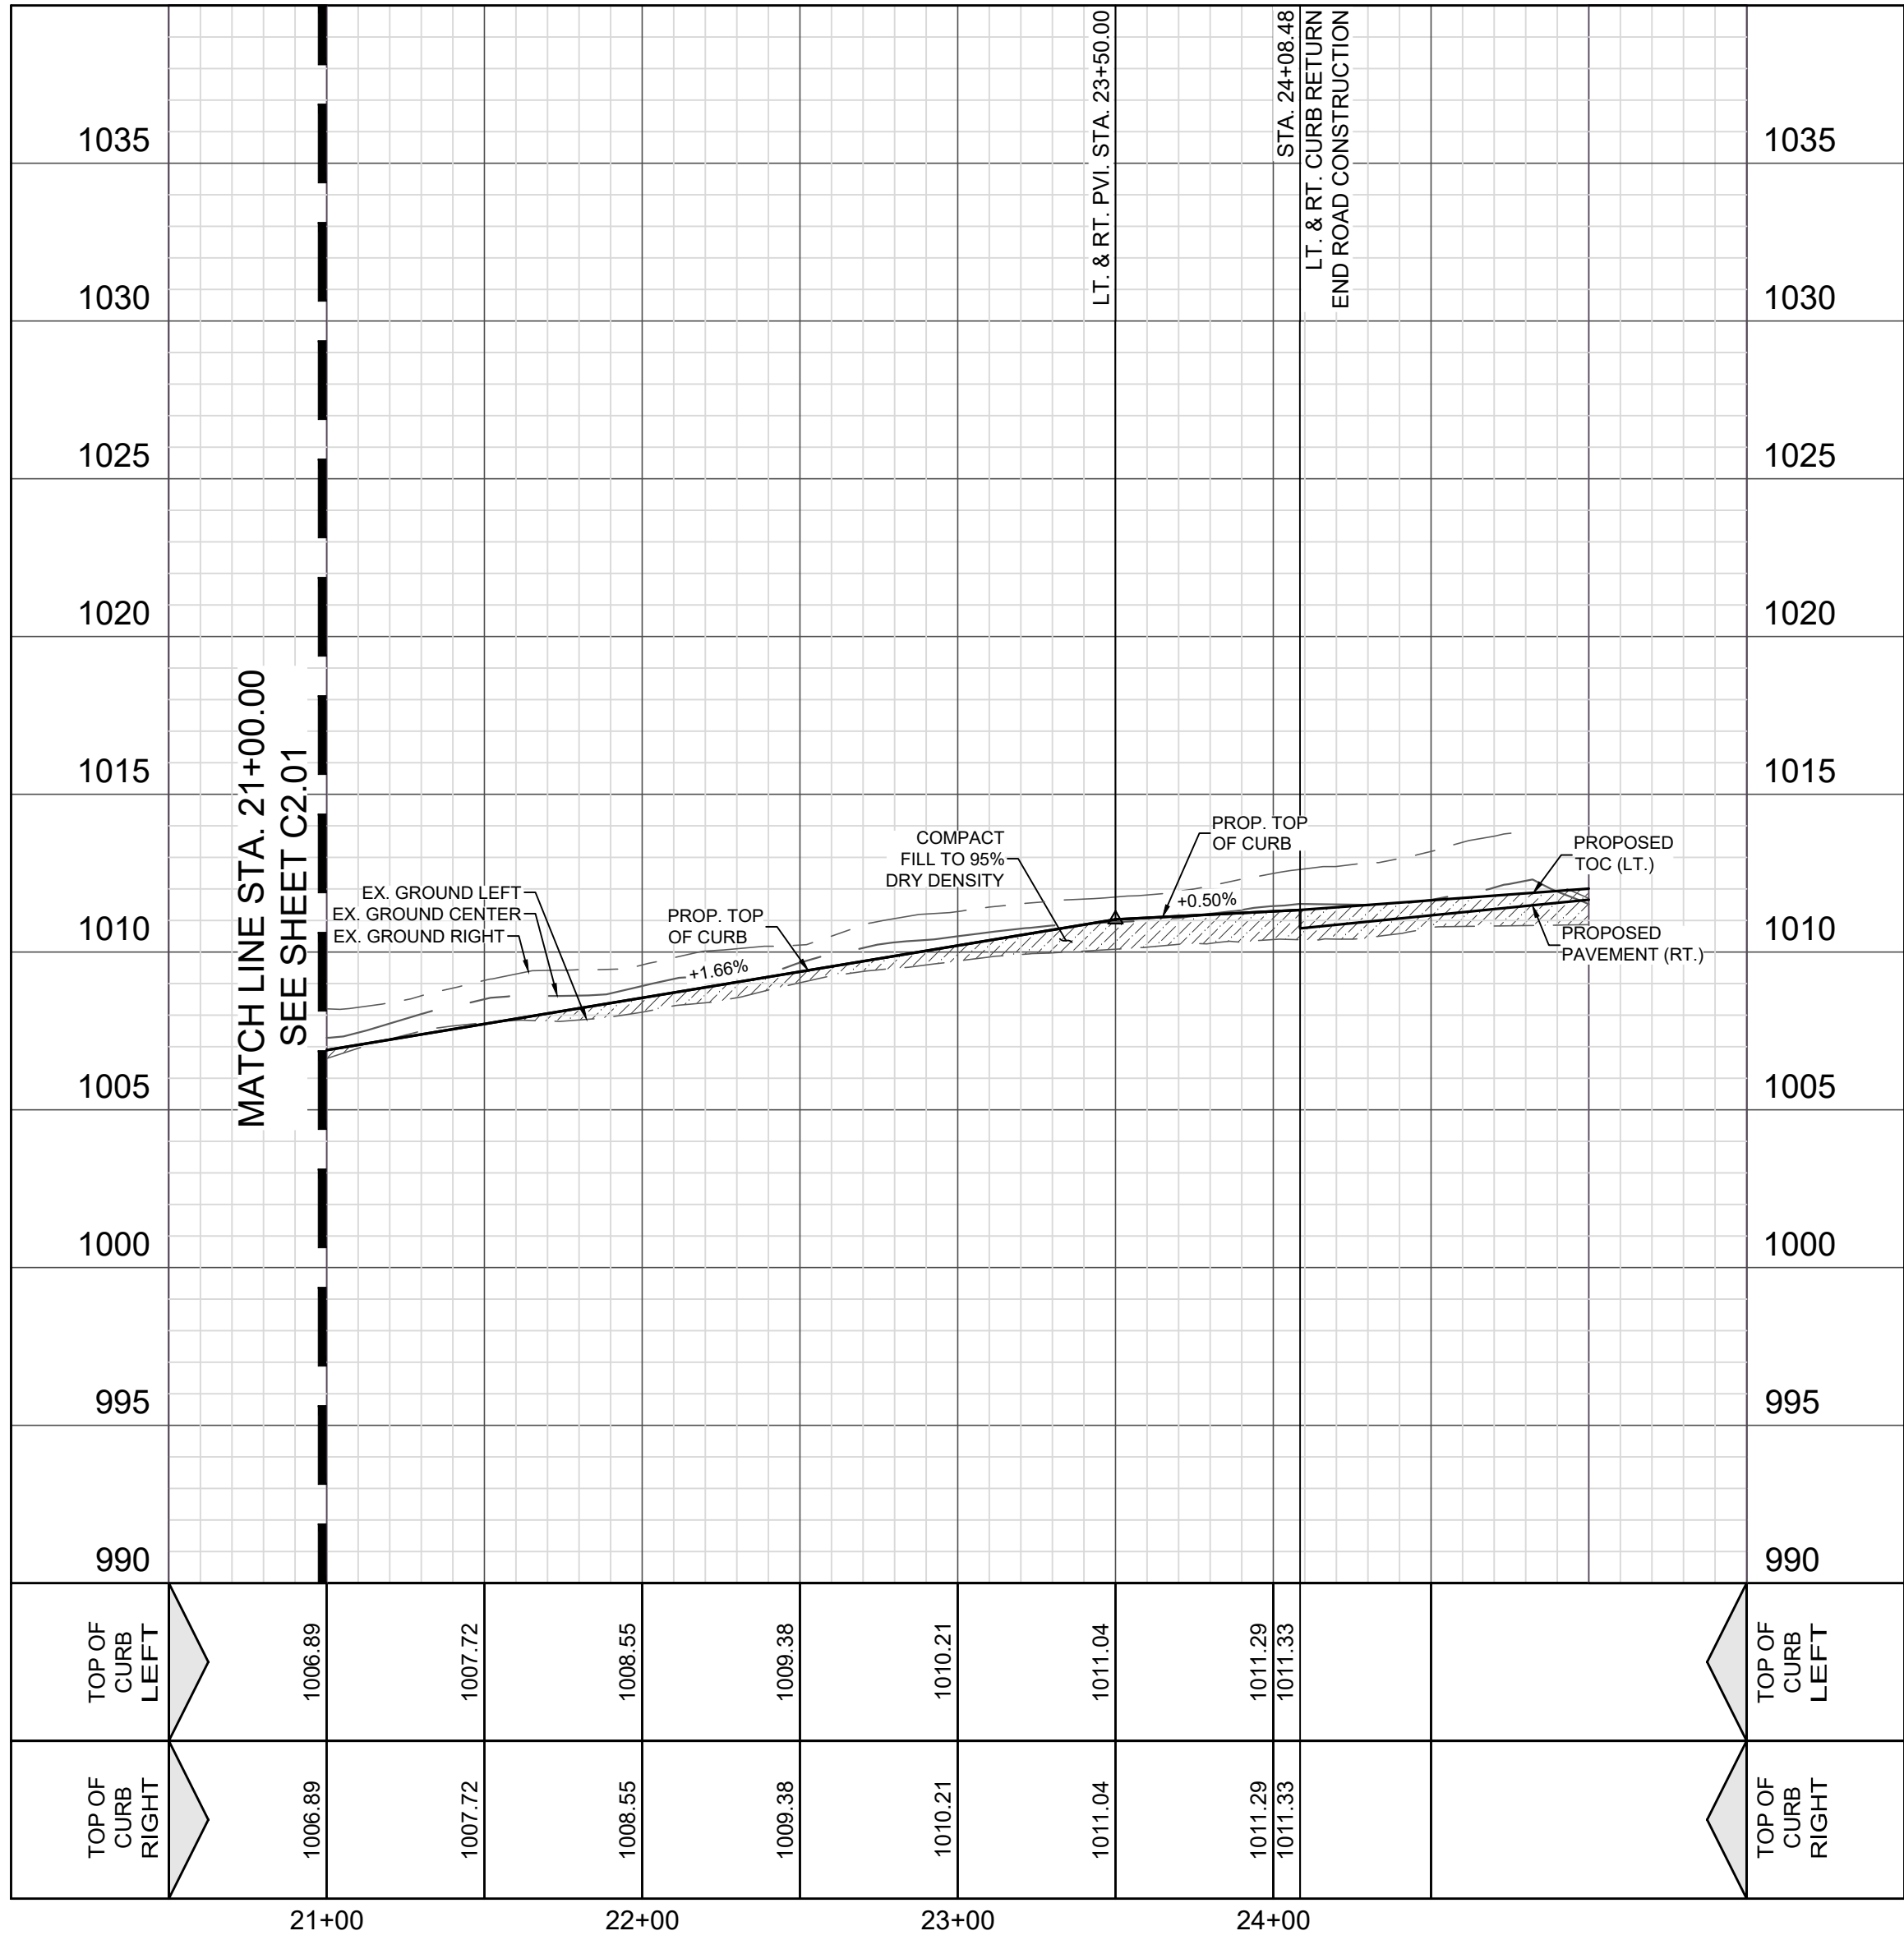

Point Table			
Point	Top of Curb Elevation	Northing	Easting
A	1011.717	13713574.3933	2030755.9945
B	1011.968	13713573.1228	2030781.0647
C	1012.220	13713559.4874	2030802.1410
D	1012.471	13713537.1407	2030813.5759
E	1012.722	13713512.0704	2030812.3054
F	1012.583	13713490.9941	2030798.6700
G	1012.398	13713479.5593	2030776.3232
H	1012.212	13713480.8297	2030751.2530
I	1012.028	13713494.4652	2030730.1767

REDBIRD RANCH UNIT 2M-2  
SAN ANTONIO, TX  
GOLDEN EAGLE - STA. 21+00.00 - 24+08.48

DESIGNED BY: JWS  
DRAWN BY: SQV/JWS  
DATE: 3/20/2024  
JOB NO.: 05000-200  
SHEET NO.


C2.02

DHI Engineering, LLC.  
4419 LOOP 1604 EAST  
SUITE 100  
SAN ANTONIO, TX 78247  
(210) 482-2988 | dhiengineering.com  
TBP REG. NO. F-195661

DHI

3/20/2024  
Vance L. Weyand  
Professional Engineer  
No. 99269  
State of Texas





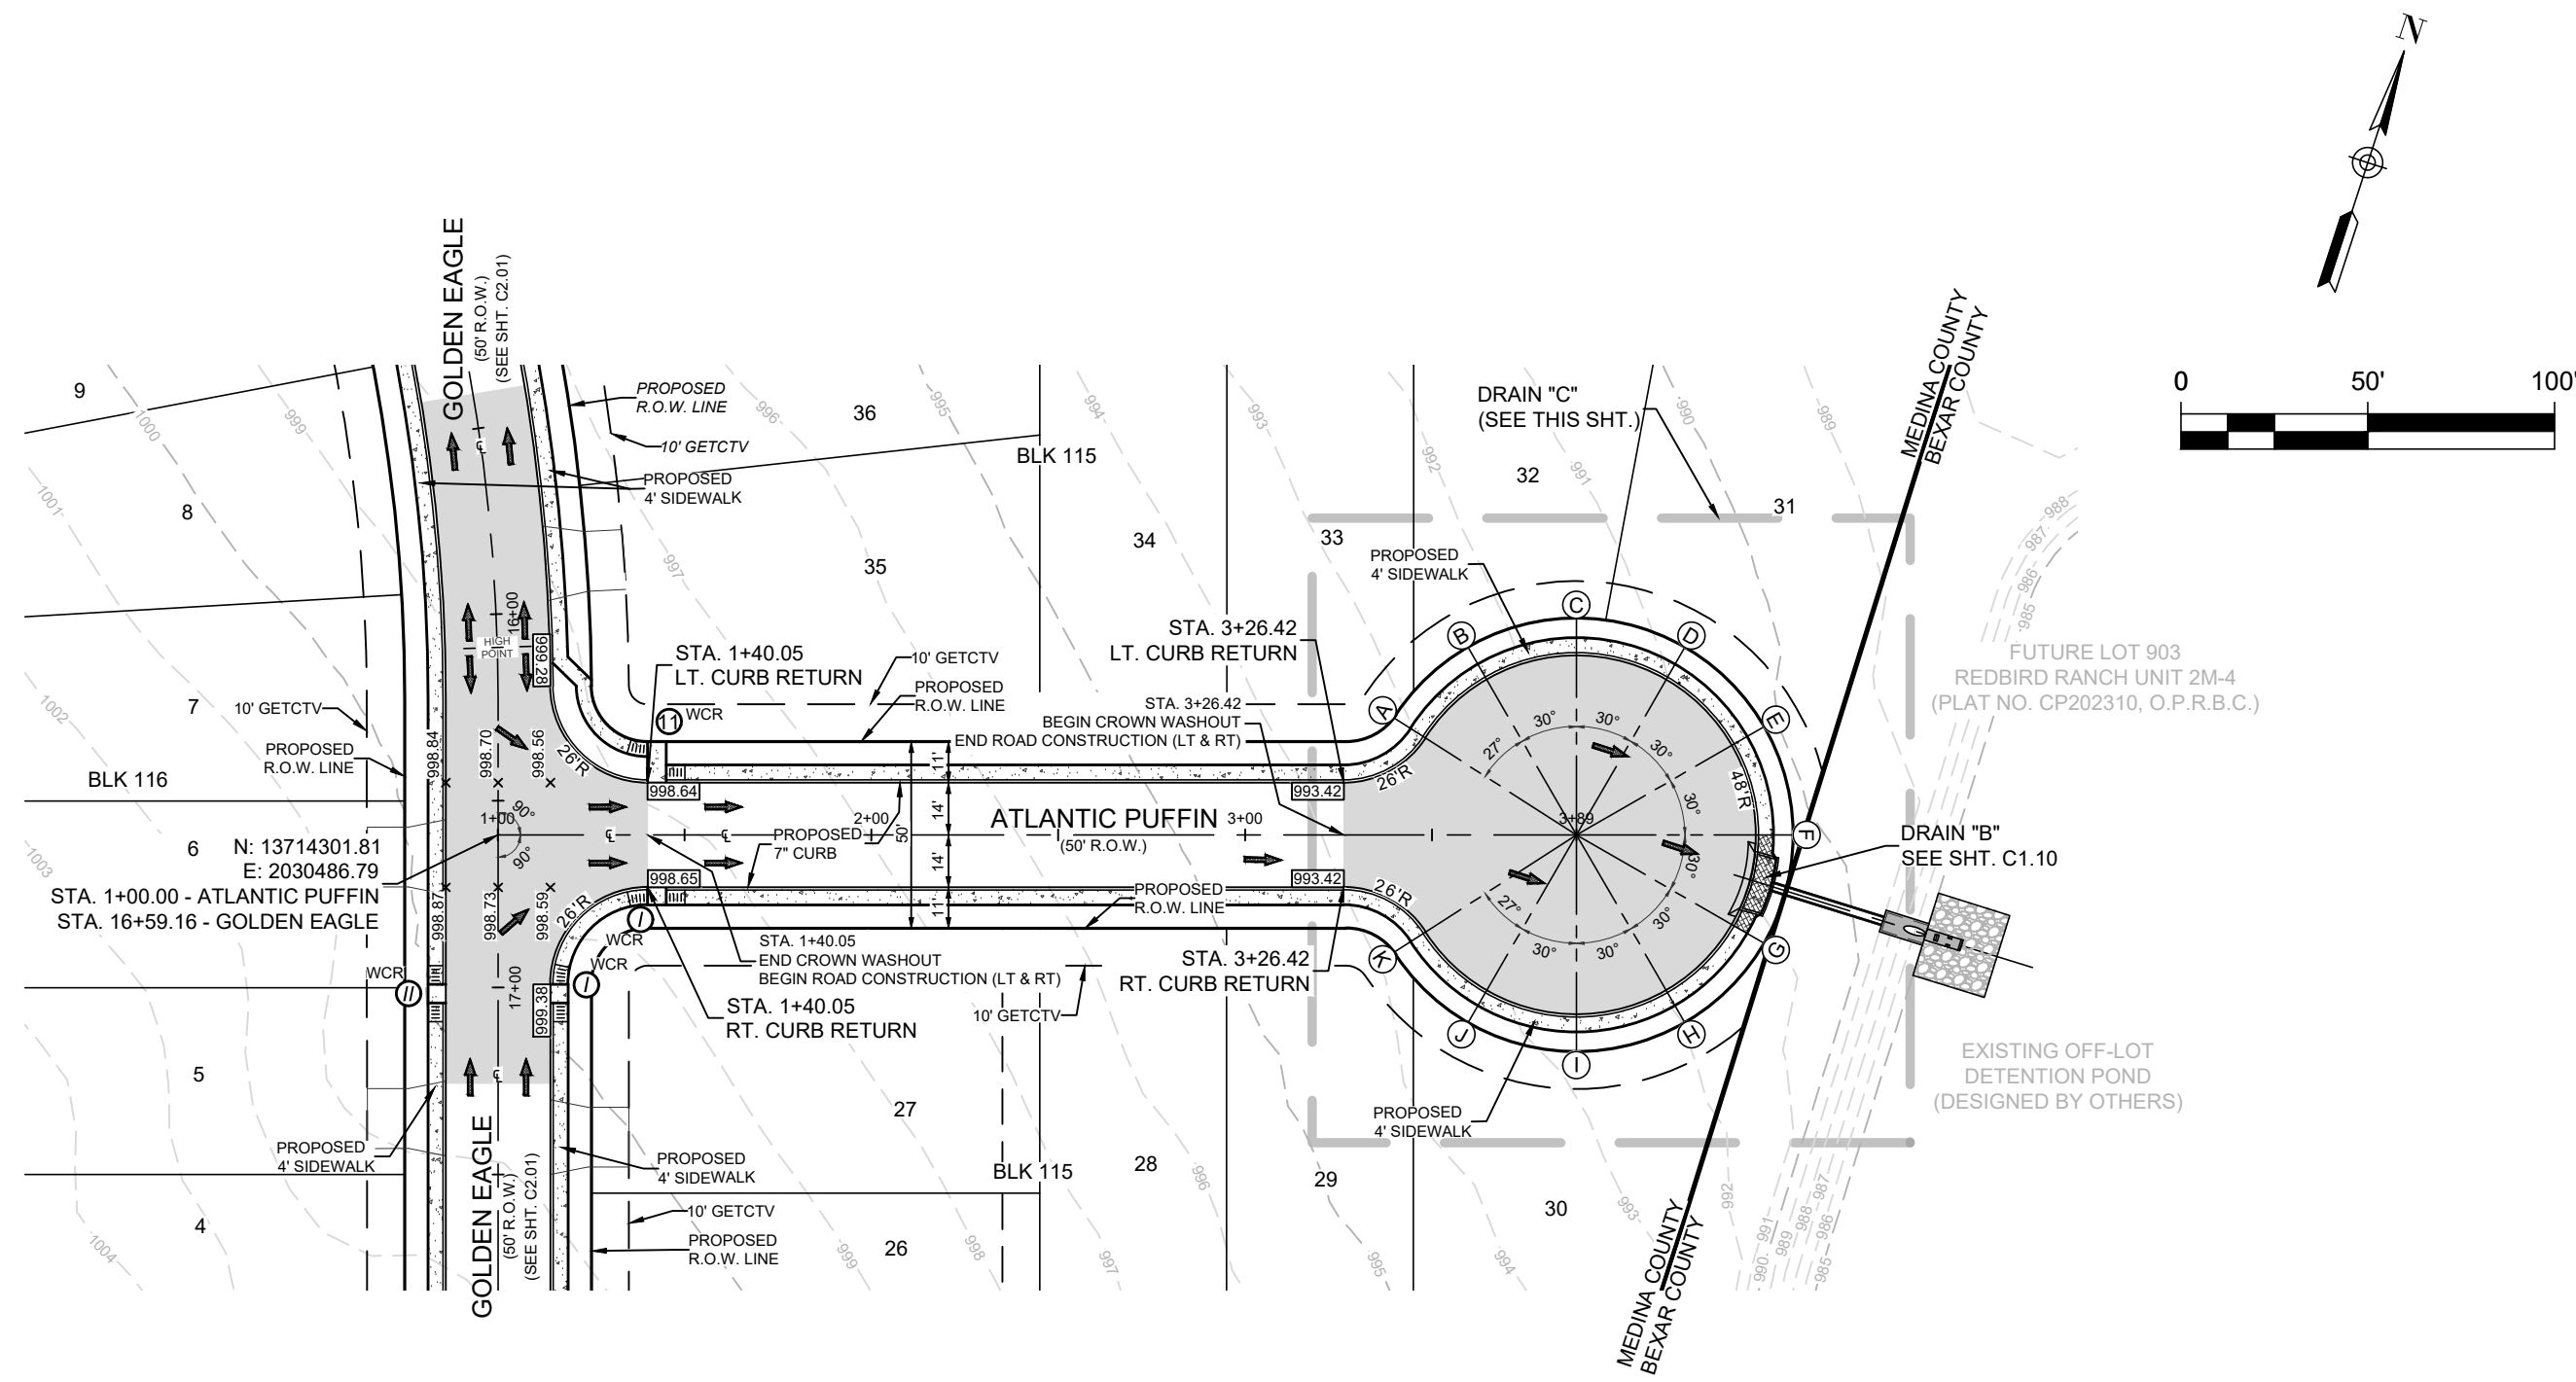





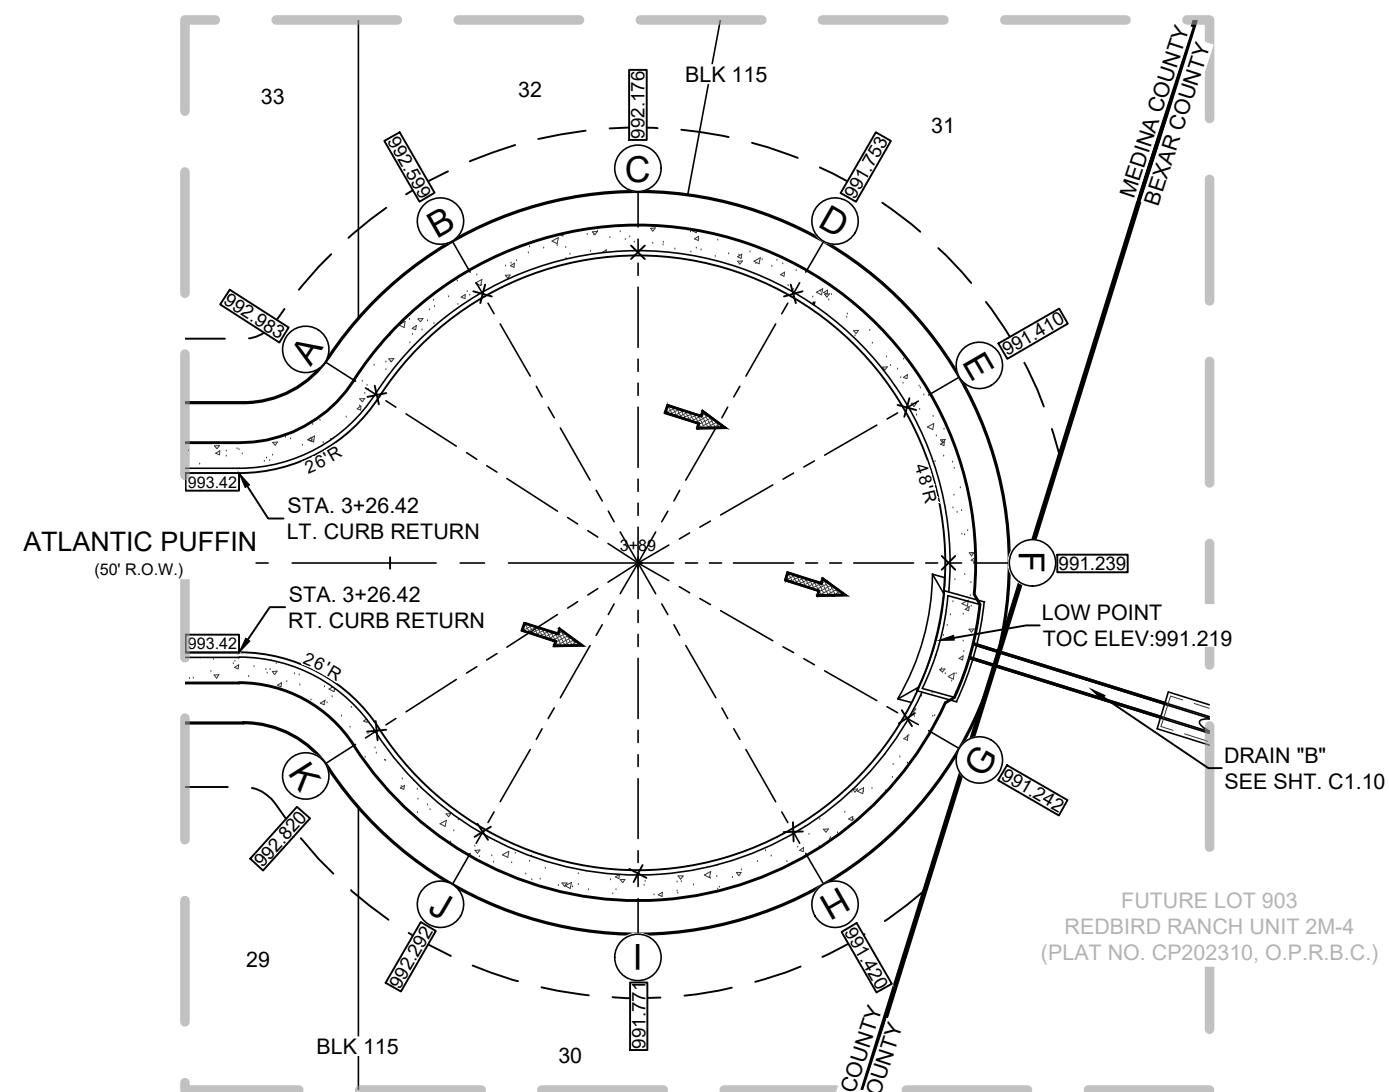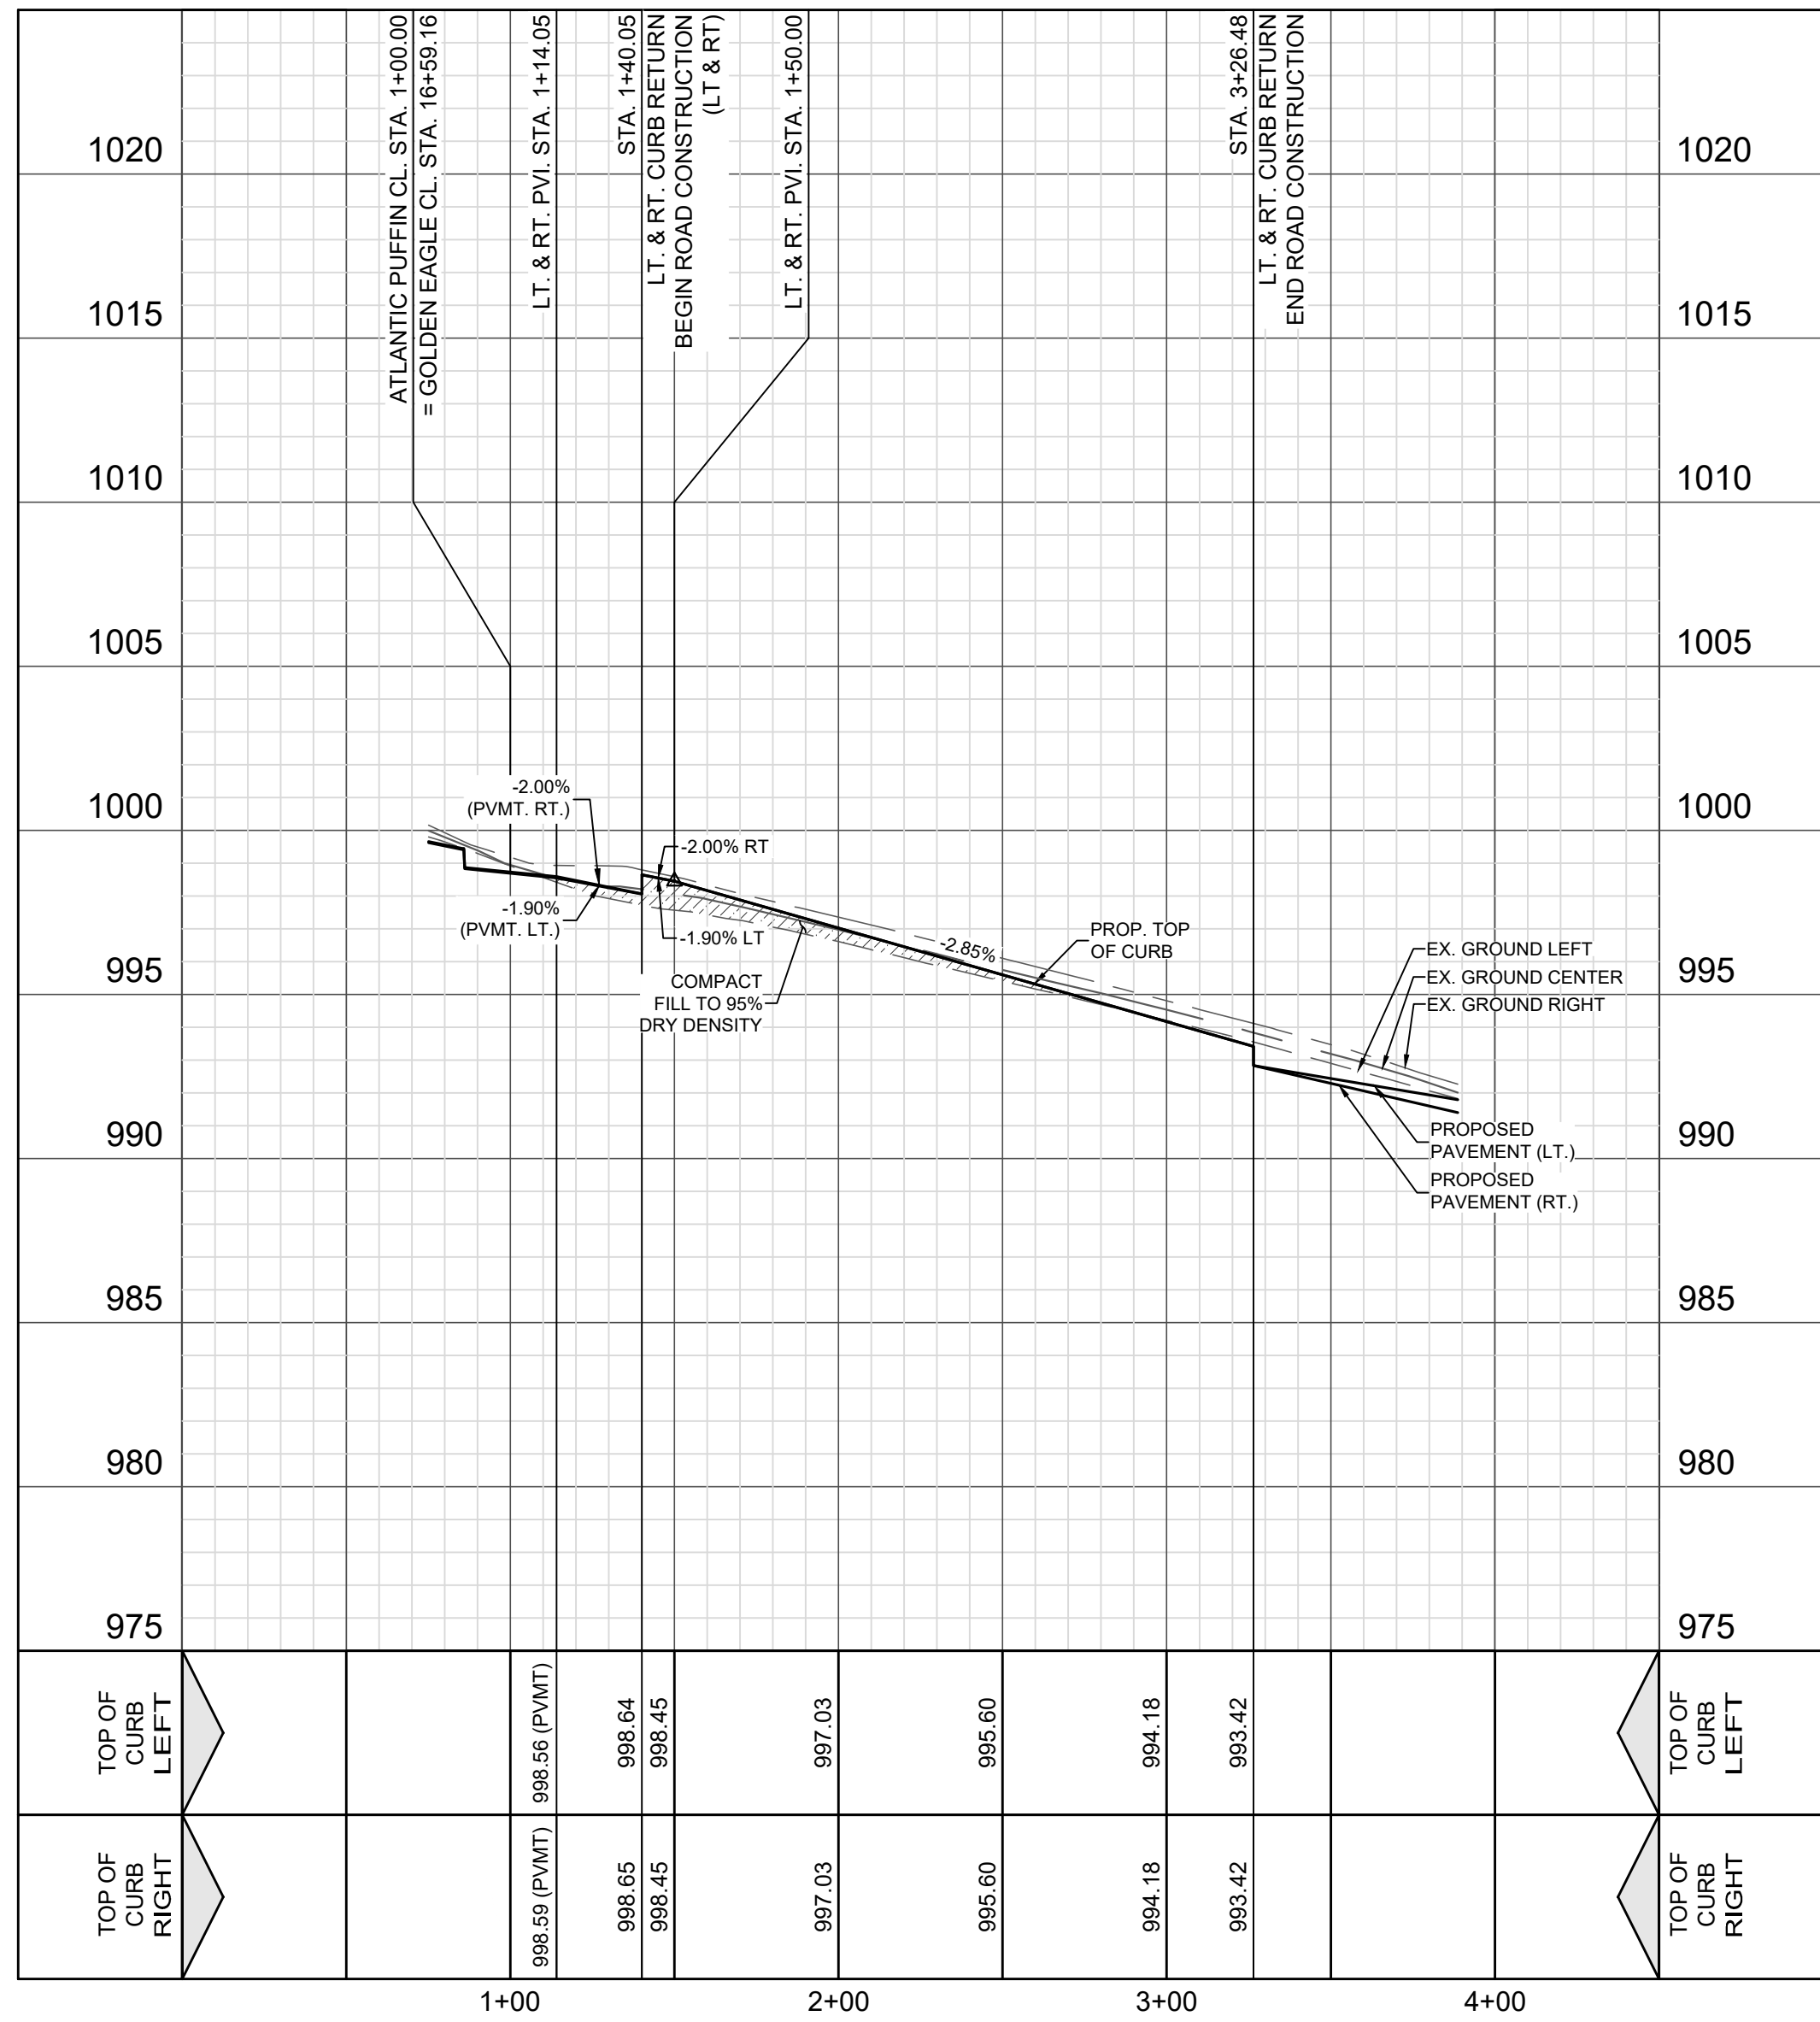


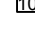
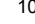

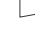


ATLANTIC PUFFIN  
STA. 1+00.00 TO 3+26.48

VERTICAL SCALE: 1" = 5'  
HORIZONTAL SCALE: 1" = 50'

- STREET NOTES:**
- 1. A MEDIANA COUNTY PERMIT MUST BE OBTAINED BEFORE WORKING IN MEDINA COUNTY ROADWAY. CONTRACTOR SHALL COORDINATE A TRAFFIC CONTROL PLAN FOR ALL WORKS IN THE ROADWAY. THE ROADWAY SHALL BE KEPT OPEN TO TRAFFIC AS RECOMMENDED BY THE ENGINEER ONCE THE ROADWAYS ARE CONSTRUCTED.
  - 2. CONTRACTOR SHALL MATCH EXISTING PAVEMENT AT THE IN-IF EXISTING PAVEMENT IS NOT FOUND, THE CONTRACTOR SHALL CONSTRUCT PAVEMENT TO MATCH THE ENGINEER PROPOSED TO CONTINUING WORK.
  - 3. SIDEWALKS SHALL BE CONSTRUCTED A MINIMUM OF 3' FT. FROM THE BACK OF CURB FOR ALL LOCATIONS WHERE THE SIDEWALK IS SHOWN OFF-SHORE. REFER TO SURVEY FOR THE STREET FOR SIDEWALK AND RAMPING SIDEWALKS.
  - 4. NO PERMANENT STRUCTURES HIGHER THAN 8' FT. AND LOWER THAN 8' FT. ABOVE THE PAVEMENT INCLUDING STRUCTURES, WALLS, FENCES, AND VEGETATION SHALL BE CONSTRUCTED OR ALLOWED WITHIN THE CLEAR VISION EASEMENT. THE CLEAR VISION EASEMENT SHALL BE GREATER THAN 10' FT. FROM THE BACK OF CURB, WHICH THE ELEVATION WITHIN THE CLEAR VISION EASEMENT IS NOT HIGHER THAN 3' FT. ABOVE THE PAVEMENT.
  - 5. DRIVEWAYS SHOWN ON THIS PLAN ARE FOR THE SOLE PURPOSE OF INDICATION. A POTENTIAL CONFLICT WITH CURB RAMP, DRAINAGE INFRASTRUCTURE, OR EXISTING UTILITIES MAY BE ENCOUNTERED. THE CONTRACTOR SHALL BE SUBJECT TO CHANGE BASED ON HOME SELECTION AND FINAL LOT DESIGN.
  - 6. CHANGES IN THE SIDEWALK LOCATION FOR A MAXIMUM LINEAL DISTANCE OF TWO HUNDRED (200) FEET ARE PERMITTED TO BE APPROVED BY THE FIELD ENGINEER. ANY CHANGES TO THE SIDEWALK LOCATION SHALL BE SUBJECT TO HOME SELECTION AND FINAL LOT DESIGN.
  - 7. ALL RAMPS AND ANY PROPOSED SIDEWALKS THAT DO NOT FORM PROPOSED DRIVEWAYS ARE REQUIRED TO BE CONSTRUCTED WITH STREET CONSTRUCTION.



Point Table			
Point	Top of Curb Elevation	Northing	Easting
A	992.984	13714401.4741	2030715.3029
B	992.599	13714421.5193	2030726.3381
C	992.176	13714435.0230	2030747.5126
D	991.753	13714436.1302	2030772.6021
E	991.410	13714424.5443	2030794.8838
F	991.239	13714403.3698	2030808.3875
G	991.243	13714378.2803	2030809.4947
H	991.420	13714355.9986	2030797.9088
I	991.772	13714342.4949	2030776.7343
J	992.293	13714341.3877	2030751.6448
K	992.821	13714351.4590	2030731.0985

LEGEND (STREET)	
	PROJECT LIMITS
	EXISTING CONTOUR
	PROPOSED CONTOUR
	WHEELCHAIR RAMP TYPE
	POINT OF CURVATURE
	POINT OF TANGENCY
	DRAINAGE FLOW ARROW
	TOP OF CURB ELEVATION
	PAVEMENT ELEVATION
	CROWN WASHOUT
	DRIVEWAY
	SIDEWALK (DEVELOPER RESPONSIBILITY)
	SIDEWALK (HOMEBUILDER RESPONSIBILITY)

**DHI**


**DHI Engineering, LLC.**  
5419 N. LOOP 1604 EAST  
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(210) 496-2668 | [dhiengineering.com](http://dhiengineering.com)  
TBPB REG. NO. F-193661

**REDBIRD RANCH UNIT 2M-2**  
SAN ANTONIO, TX  
ATLANTIC PUFFIN - STA. 1+00.00 - 3+26.48

DESIGNED BY:	JWS
DRAWN BY:	SQV/JWS
DATE:	3/20/2024
JOB NO.:	05000-200
SHEET NO.	

## C2.03



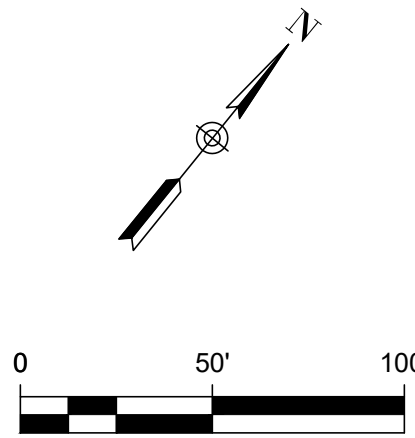

VERTICAL SCALE: 1" = 5'  
HORIZONTAL SCALE: 1" = 50'

100.00' V.C. (LT. & RT.)  
K = 53.58  
A.D. = 1.87%  
PVI STA = 3+50.00  
PVI ELEV = 989.71  
LOW PT. ELEV. = 988.893  
LOW PT. STA = 4+00.00

A MEDINA COUNTY PERMIT MUST BE OBTAINED BEFORE WORKING IN MEDINA COUNTY. CONTRACTOR SHALL BE RESPONSIBLE FOR OBTAINING ALL NECESSARY PERMITS. NO WORK SHALL BE ALLOWED WITHIN THE ROW. ADDITIONAL WARNING SIGNS MAY BE RECOMMENDED BY THE ENGINEER ONCE THE ROADWAYS ARE CONSTRUCTED.

2. CONTRACTOR SHALL MATCH EXISTING PAVEMENT AT THEM IF EXISTING PAVEMENT ELEVATION DIFFERS SIGNIFICANTLY. CONTRACTOR SHALL NOTIFY THE ENGINEER OF ANY DISCREPANCIES TO CORRECT.

3. SIDEWALKS SHALL BE CONSTRUCTED A MINIMUM OF 3 FT. FROM THE BACK OF CURB FOR ALL LOCATIONS WHERE THE SIDEWALK IS SHOWN OFF-SHEET. REFER TO STREET DETAIL SHEET FOR SIDEWALK AND RAMP DETAILS.

4. NO PERMANENT STRUCTURES HIGHER THAN 8 FT. - AND LOWER THAN 8 FT. ABOVE GRADE ARE ALLOWED. TREES, BUSHES AND VEGETATION SHALL BE PROTECTED. SHALL BE CONSTRUCTED OR ALLOWED WITHIN THE CLEAR EASEMENT AREA. CONTRACTOR SHALL GRADE AREAS WITHIN CLEAR EASEMENT SIDEWAYS SUCH THAT THERE IS NO OBSTRUCTION WITHIN THE CLEAR EASEMENT IS NOT HIGHER THAN 4 FT. ABOVE THE ADJACENT TOP OF PAVEMENT.

5. DRIVEWAYS SHOWN ON THIS PLAN ARE FOR THE SOLE PURPOSE OF INDICATING A POTENTIAL CONFLICT WITH CURB RAMP, DRAINAGE INFRASTRUCTURE, OR OTHER DRIVEWAY. CONTRACTOR SHALL BE SUBJECT TO CHANGE BASED ON HOME SELECTION AND FINAL LOT DESIGN.

6. CHANGES IN THE SIDEWALK LOCATION FOR A SUBSTANTIAL LINEAL DISTANCE OF TWO HUNDRED (200) FEET ARE PERMITTED TO BE APPROVED BY THE FIELD DISTRICT ENGINEER. ANY CHANGES TO THE STREET PLAN OR UTILITY LAYOUT PER FIELD DISTRICT ENGINEER WILL BE REQUIRED.


7. ALL RAMP AND ANY PROPOSED SIDEWALKS THAT DO NOT FRONT PROPOSED RESIDENTIAL LOTS ARE REQUIRED TO BE CONSTRUCTED WITH STREET

[illegible]


REDBIRD RANCH UNIT 2M-2  
SAN ANTONIO, TX  
YELLOW BUNTING - STA. 1+00.00 - 5+98.01



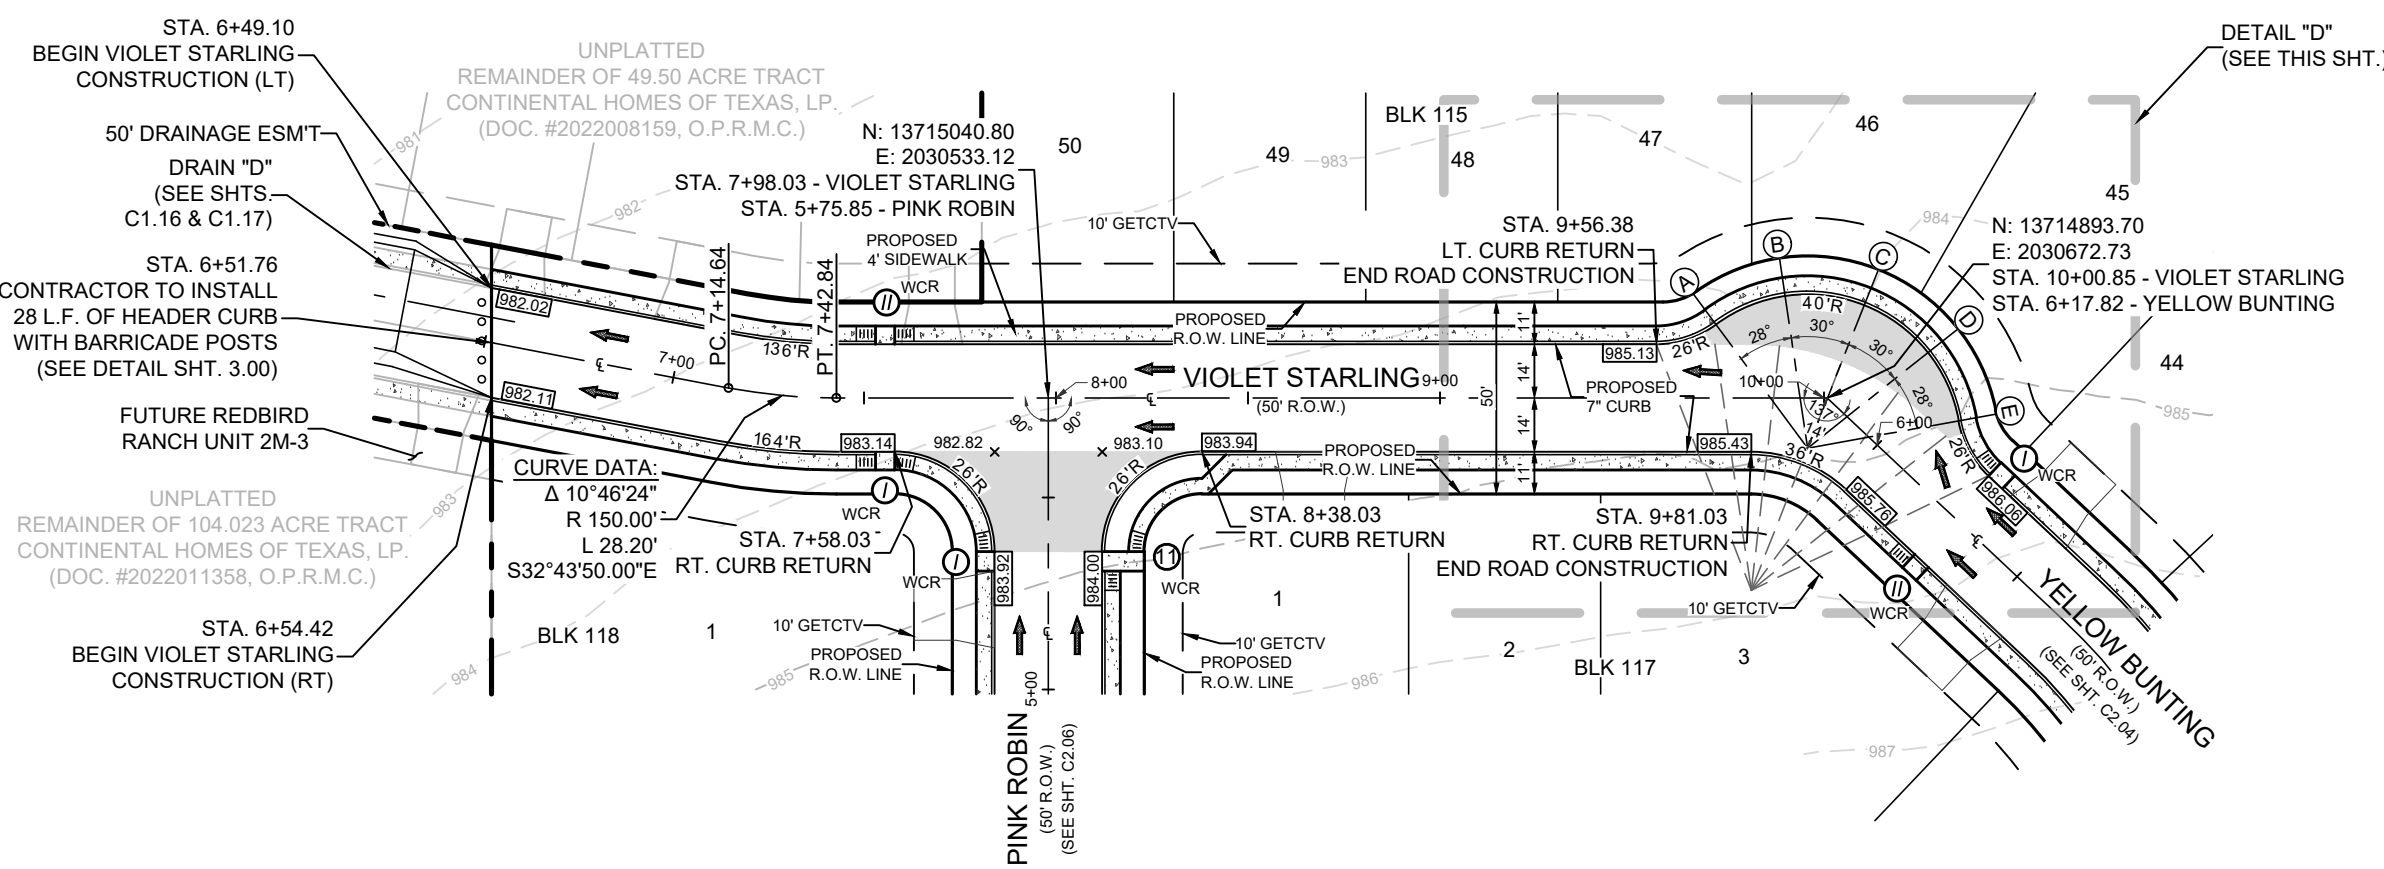




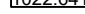
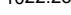


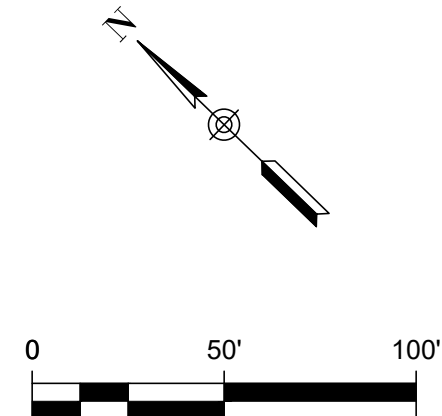

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DRAWN BY:	SQV/JW
DATE:	3/20/202
JOB NO.:	05000-20
SHEET NO.	C2.04




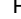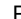


VIOLET STARLING  
STA. 6+51.76 TO 9+81.03



LEGEND (STREET)	
	PROJECT LIMITS
	EXISTING CONTOUR
	PROPOSED CONTOUR
	WHEELCHAIR RAMP TYPE
	POINT OF CURVATURE
	POINT OF TANGENCY
	DRAINAGE FLOW ARROW
	TOP OF CURB ELEVATION
	PAVEMENT ELEVATION
	CROWN WASHOUT
	DRIVEWAY
	SIDEWALK (DEVELOPER RESPONSIBILITY)
	SIDEWALK (HOMEBUILDER RESPONSIBILITY)

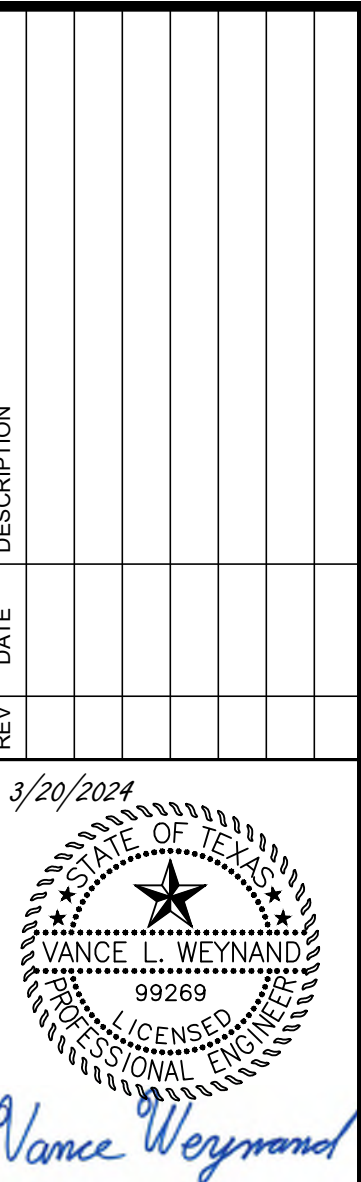

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TBPE REG. NO. F-19561

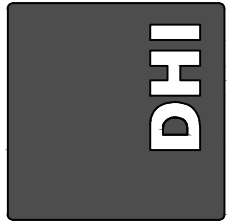



REDBIRD RANCH UNIT 2M-2  
SAN ANTONIO, TX  
VIOLET STARLING - STA. 6+51.76 - 9+81.03

DESIGNED BY:	JWS
DRAWN BY:	SQV/JWS
DATE:	3/20/2024
JOB NO.:	05000-200
SHEET NO.	

## C2.05


**STREET NOTES:**

1. A MEDIAN COUNTY PERMIT MUST BE OBTAINED BEFORE WORKING IN MEDIAN COUNTY ROW. CONTRACTOR SHALL COORDINATE A TRAFFIC CONTROL PLAN FOR ALL WORK IN MEDIAN COUNTY ROW. ALL WARNING SIGNS MAY BE RECOMMENDED BY THE ENGINEER ONCE THE ROADWAYS ARE CONSTRUCTED.
2. CONTRACTOR SHALL MATCH EXISTING PAVEMENT AT THE-IF EXISTING PAVEMENT ELEVATION DIFFERS SIGNIFICANTLY, CONTRACTOR SHALL NOTIFY THE ENGINEER PRIOR TO CONTINUING WORK.
3. SIDEWALKS SHALL BE CONSTRUCTED A MINIMUM OF 3 FT. FROM THE BACK OF CURB FOR ALL LOCATIONS WHERE THE SIDEWALK IS SHOWN OFFSET. REFER TO STREET DETAIL SHEET FOR SIDEWALK AND RAMP DETAILS.
4. NO PERMANENT STRUCTURES HIGHER THAN 3 FT. AND LOWER THAN 8 FT. ABOVE GRADE SHALL BE CONSTRUCTED OR ALLOWED. TREES AND VEGETATION SHALL BE CONSTRUCTED OR ALLOWED WITHIN THE CLEAR VISION EASEMENTS. CONTRACTOR SHALL GRADE AREAS WITHIN CLEAR VISION EASEMENTS SUCH THAT THE VISION AREA WITHIN CLEAR VISION IS NOT HIGHER THAN 3 FT. ABOVE THE ADJACENT TOP OF PAVEMENT.
5. DRIVEWAYS SHOWN ON THIS PLAN ARE FOR THE SOLE PURPOSE OF INDICATION A DRIVEWAY SHALL BE CONSTRUCTED TO THE PROPERTY LINE AND TO THE OTHER THY CULK. DRIVEWAY LOCATION IS SUBJECT TO CHANGE BASED ON HOME SELECTION AND FINAL LOT DESIGN.
6. CHANGES IN THE SIDEWALK LOCATION FOR A MAXIMUM LINEAR DISTANCE OF 10 FEET SHALL BE REQUIRED FOR THE FIELD INSPECTOR TO MEET THE FIELD INSPECTOR WITHIN THE EXISTING STREET PLAN OR UTILITY LAYOUT PER LIDAR SECTION 35-506 (C)(6).
7. ALL RAMPS AND ANY PROPOSED SIDEWALKS THAT DO NOT FORM PROPOSED DRIVEWAYS ARE REQUIRED TO BE CONSTRUCTED WITH STREET CONSTRUCTION.

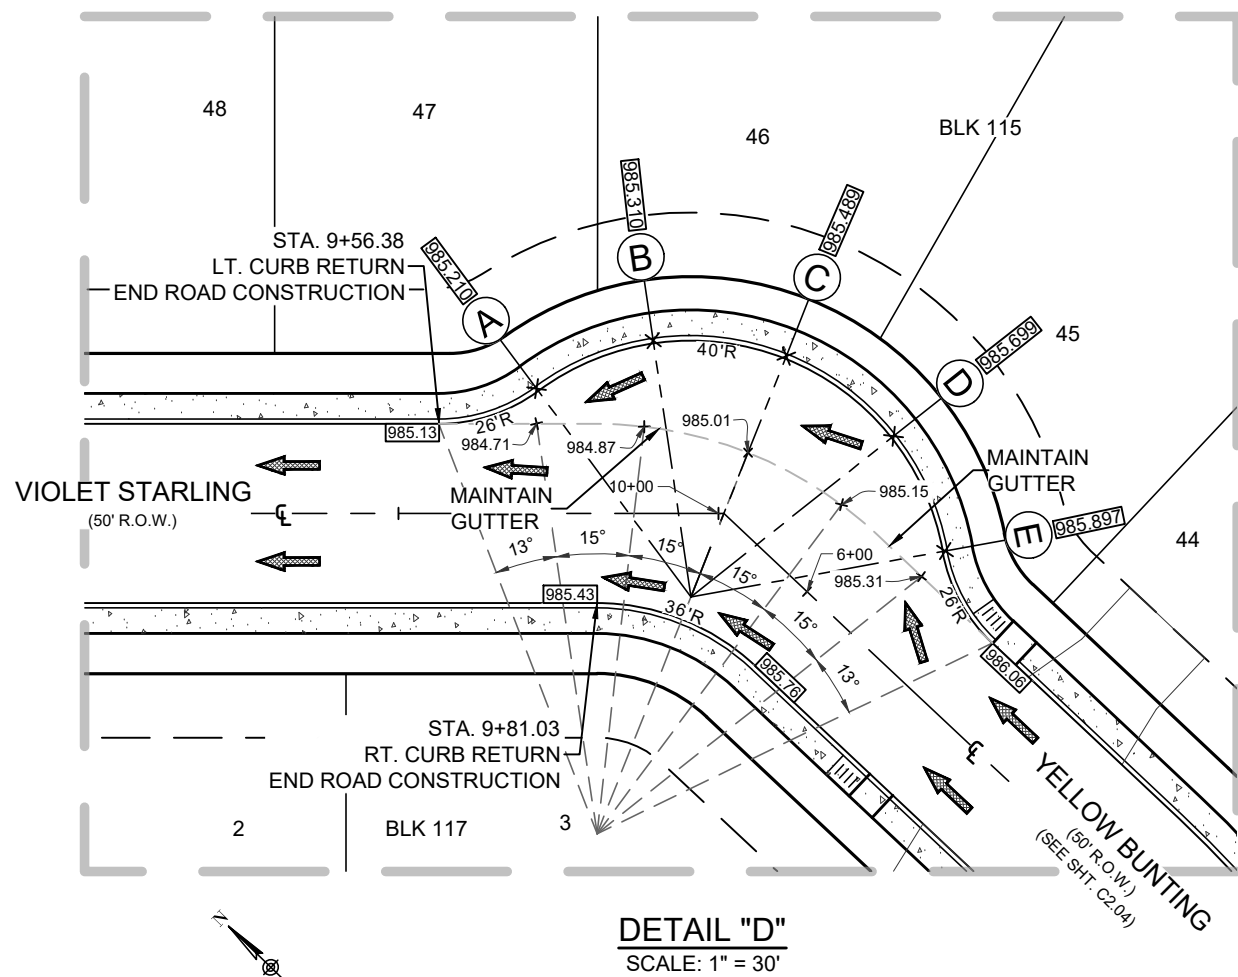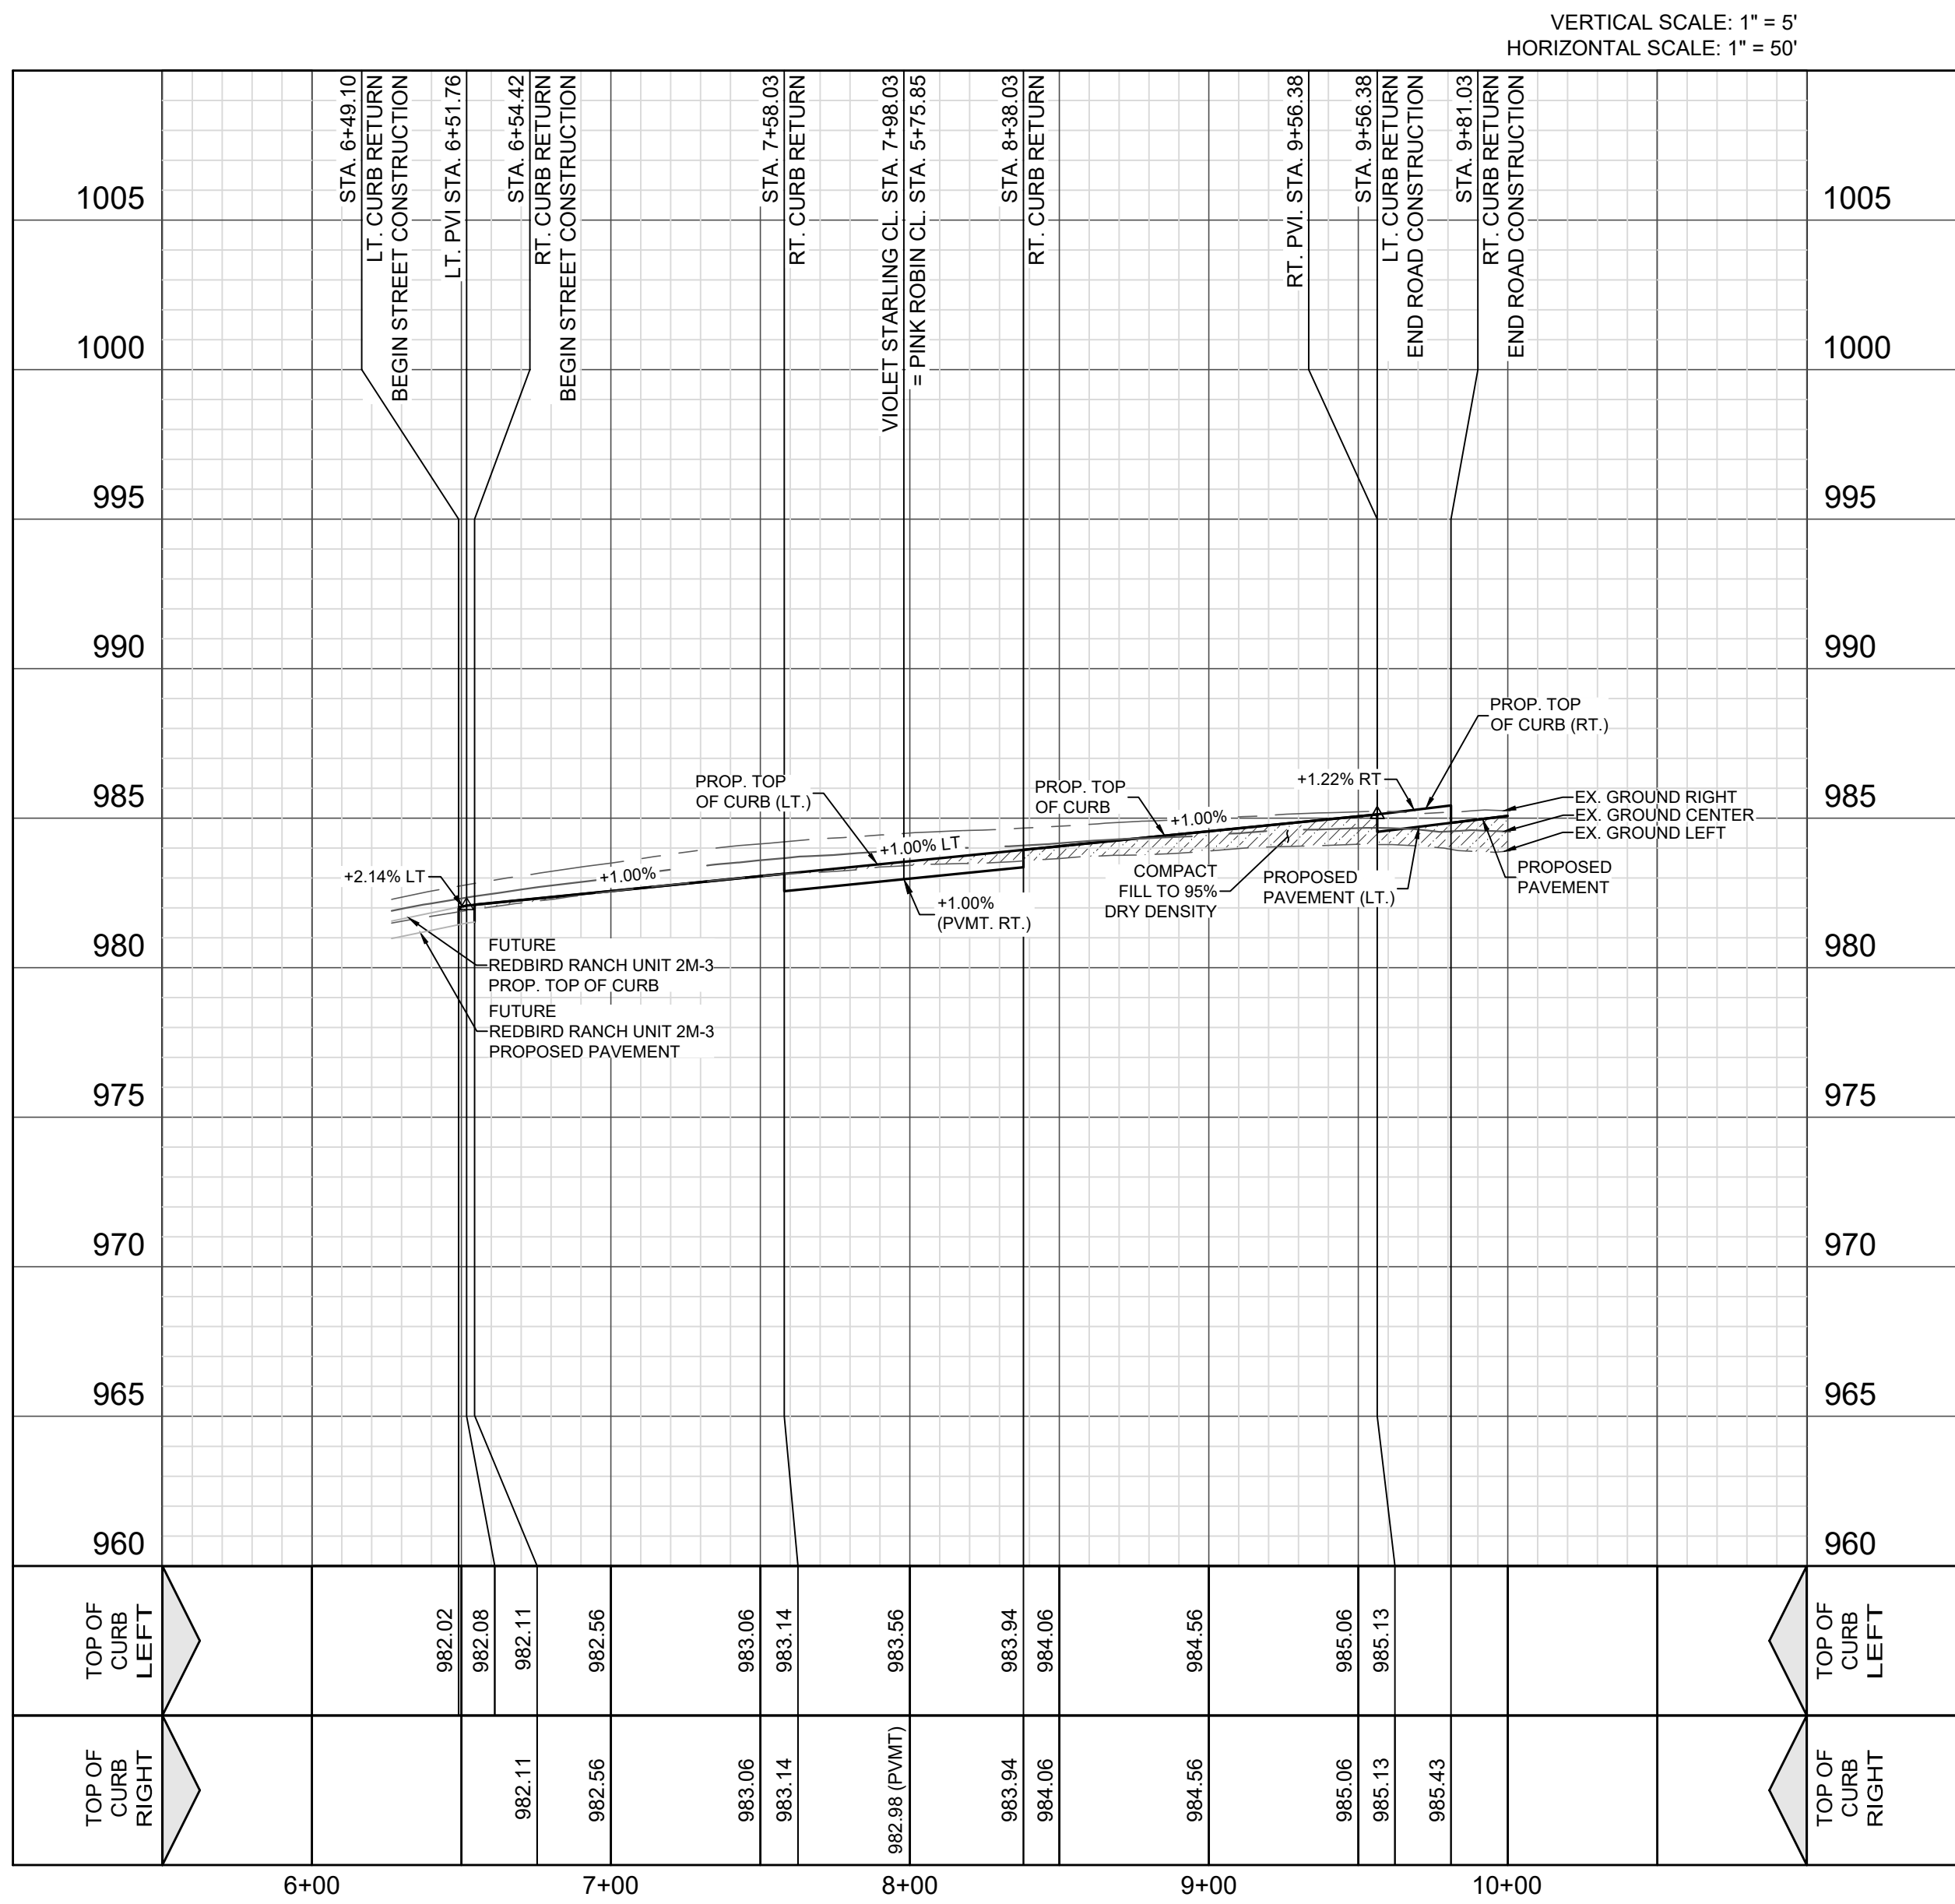

Point Table			
Point	Top of Curb Elevation	Northing	Easting
A	985.210	13714928.3572	2030666.7315
B	985.310	13714920.3178	2030684.7212
C	985.489	13714903.5506	2030697.2623
D	985.699	13714882.7784	2030699.7273
E	985.897	13714864.5968	2030692.2684




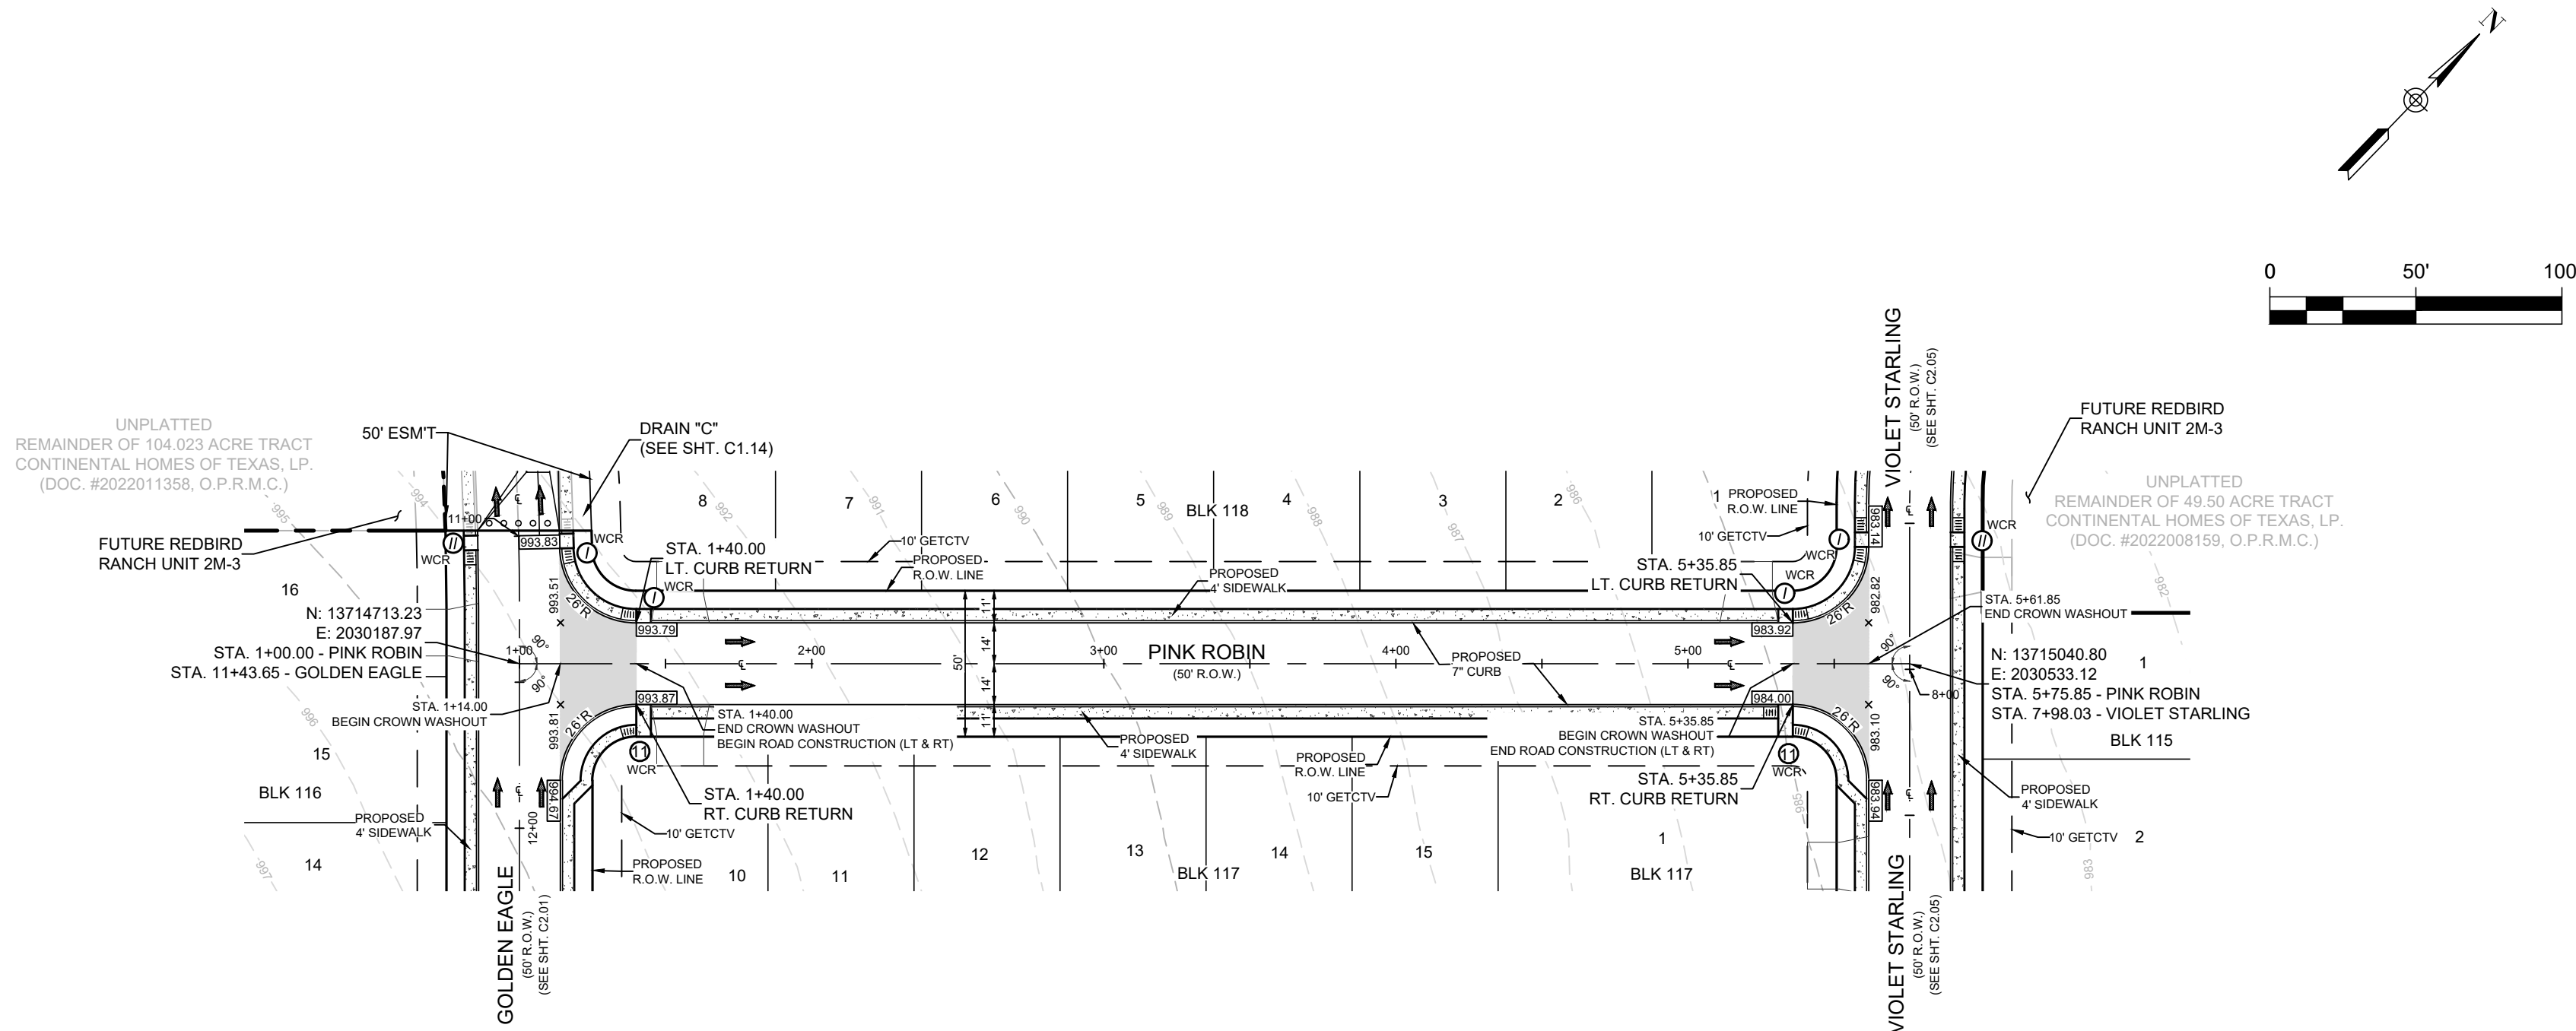

PINK ROBIN  
STA. 1+00.00 TO 5+75.85

STREET NOTES:

1. A MEDINA COUNTY PERMIT MUST BE OBTAINED BEFORE WORKING IN MEDINA COUNTY ROW. CONTRACTOR SHALL COORDINATE A TRAFFIC CONTROL PLAN FOR ALL WORK WITHIN THE ROW. ADDITIONAL WARNING SIGNS MAY BE RECOMMENDED BY THE ENGINEER ONCE THE ROADWAYS ARE CONSTRUCTED.
2. CONTRACTOR SHALL MATCH EXISTING PAVEMENT AT TIE-IN. IF EXISTING PAVEMENT ELEVATION DIFFERS SIGNIFICANTLY, CONTRACTOR SHALL NOTIFY THE ENGINEER PRIOR TO CONTINUING WORK.
3. SIDEWALKS SHALL BE CONSTRUCTED A MINIMUM OF 3 FT. FROM THE BACK OF CURB FOR ALL LOCATIONS WHERE THE SIDEWALK IS SHOWN OFFSET. REFER TO STREET DETAIL SHEET FOR SIDEWALK AND RAMP DETAILS.
4. NO PERMANENT STRUCTURES HIGHER THAN 3 FT. AND LOWER THAN 8 FT. ABOVE THE PAVEMENT INCLUDING STRUCTURES, WALLS, FENCES, AND VEGETATION, SHALL BE CONSTRUCTED OR ALLOWED WITHIN THE CLEAR VISION EASEMENT. CONTRACTOR SHALL GRADE AREAS WITHIN CLEAR VISION EASEMENTS SUCH THAT THE ELEVATION WITHIN THE CLEAR VISION EASEMENT IS NOT HIGHER THAN 3 FT. ABOVE THE ADJACENT TOP OF PAVEMENT.
5. DRIVEWAYS SHOWN ON THIS PLAN ARE FOR THE SOLE PURPOSE OF INDICATION A POTENTIAL CONFLICT WITH CURB RAMP, DRAINAGE INFRASTRUCTURE, OR OTHER CONFLICT. DRIVEWAY LOCATION IS SUBJECT TO CHANGE BASED ON HOME SELECTION AND FINAL LOT DESIGN.
6. CHANGES IN THE SIDEWALK LOCATION FOR A MAXIMUM LINEAR DISTANCE OF TWO HUNDRED (200) FEET ARE PERMITTED TO BE APPROVED BY THE FIELD INSPECTOR WITHOUT AMENDING THE STREET PLAN OR UTILITY LAYOUT PER UDC SECTION 36-508 (Q)(8).
7. ALL RAMP AND ANY PROPOSED SIDEWALKS THAT DO NOT FRONT PROPOSED RESIDENTIAL LOTS ARE REQUIRED TO BE CONSTRUCTED WITH STREET CONSTRUCTION.

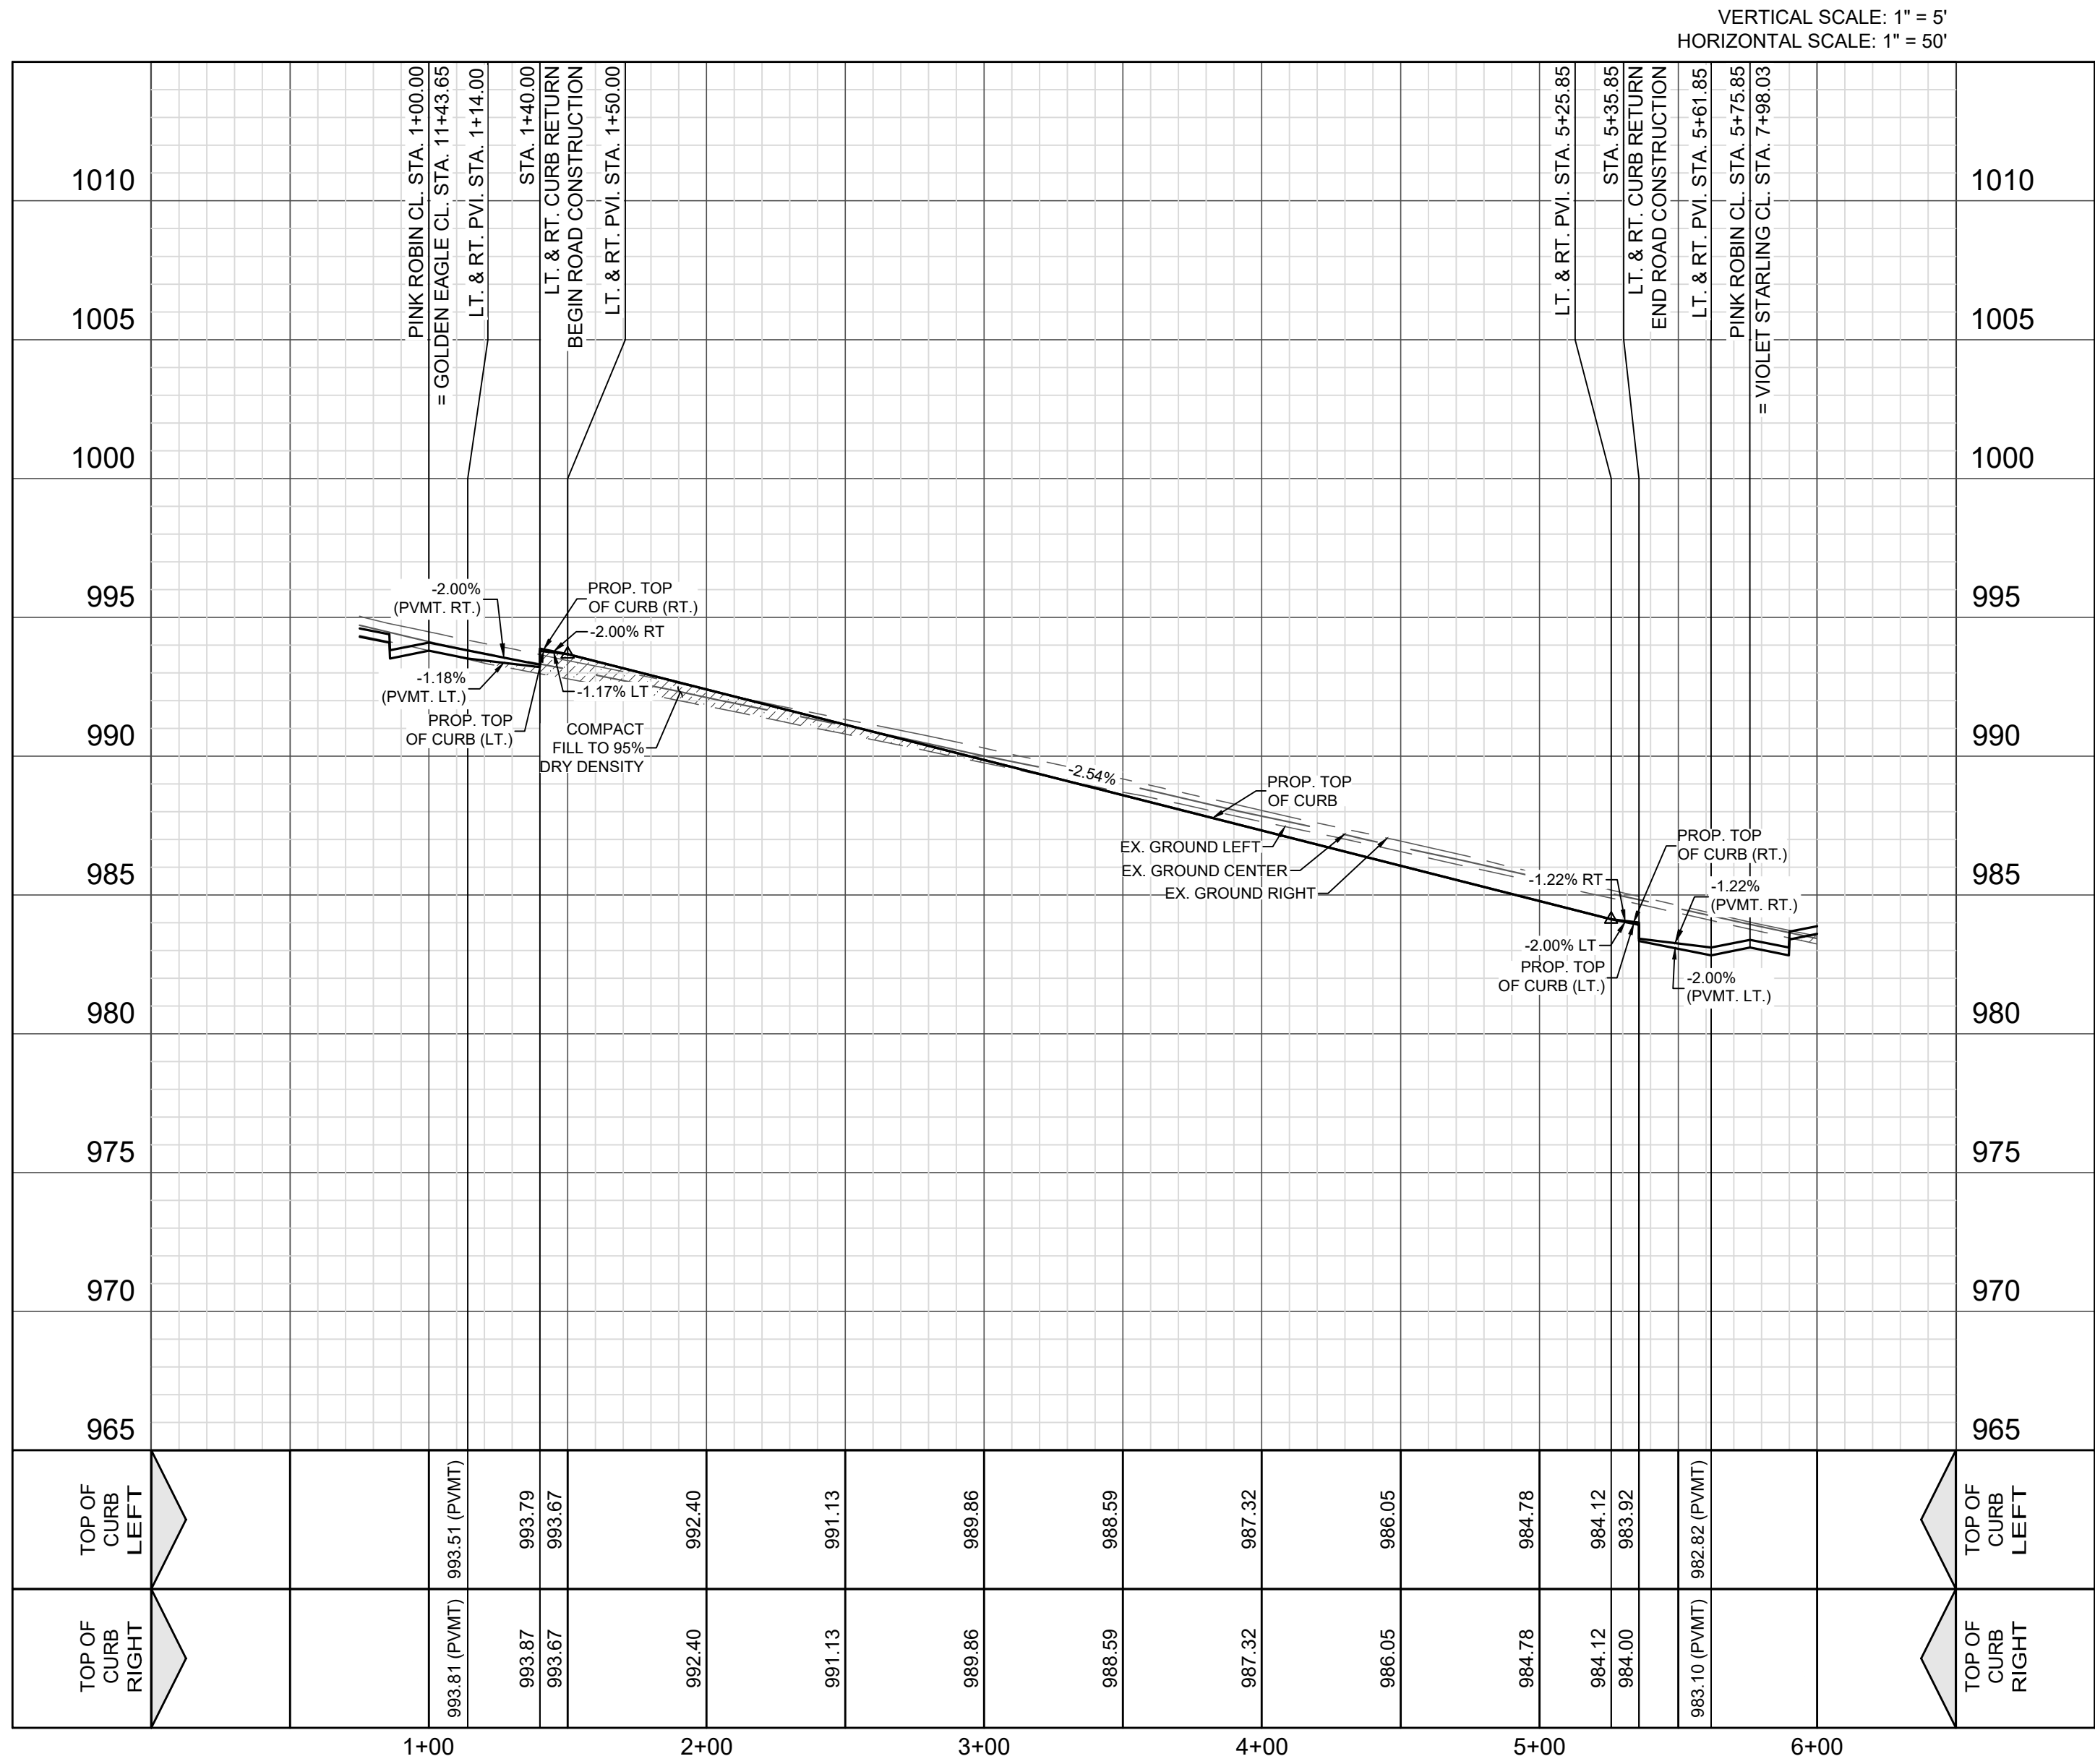

REDBIRD RANCH UNIT 2M-2  
SAN ANTONIO, TX  
PINK ROBIN - STA. 1+00.00 - 5+75.85

DESIGNED BY: JWS  
DRAWN BY: SQV/JWS  
DATE: 3/20/2024  
JOB NO.: 05000-200  
SHEET NO.


C2.06

LEGEND (STREET)	
	PROJECT LIMITS
	EXISTING CONTOUR
	PROPOSED CONTOUR
	WHEELCHAIR RAMP TYPE
	POINT OF CURVATURE
	POINT OF TANGENCY
	DRAINAGE FLOW ARROW
	TOP OF CURB ELEVATION
	PAVEMENT ELEVATION
	CROWN WASHOUT
	DRIVEWAY
	SIDEWALK (DEVELOPER RESPONSIBILITY)
	SIDEWALK (HOMEBUILDER RESPONSIBILITY)


REV	DATE	DESCRIPTION



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SUITE 100  
SAN ANTONIO, TEXAS 78217  
(210) 482-2988 | dhiengineering.com  
TBPE REG. NO. F-195661

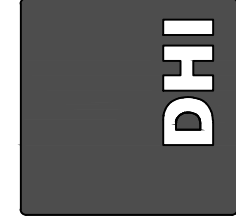



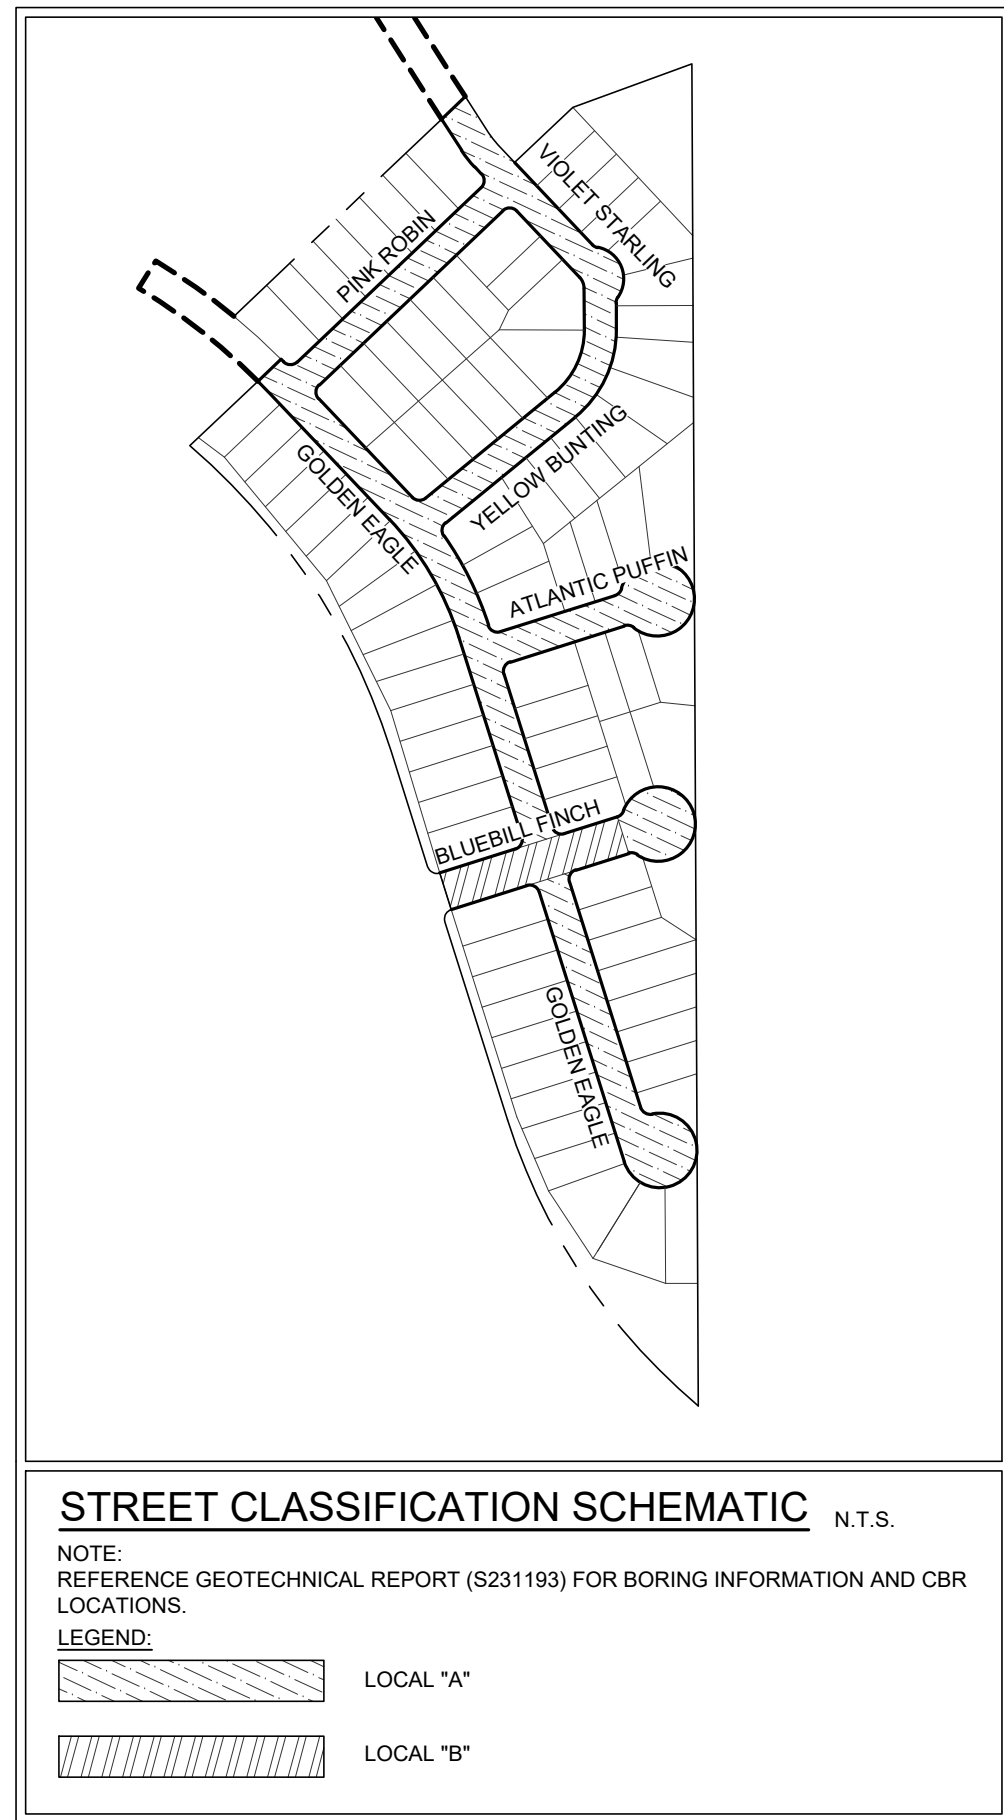

PAVEMENT SECTION DESIGN								
STREET NAME	STATION	TYPE "C" HMAC	TYPE "D" HMAC	FLEXIBLE/ AGGREGATE BASE	STABILIZED LIME SUBGRADE	GEOGRID (TENSAR TRIAX TXS)	CBR	STRUCTURAL NUMBER
BLUEBILL FINCH (LOCAL "B")	0+92.00 TO 3+87.77	2"	2"	16"	8"	NO	2.5	4.64
GOLDEN EAGLE (LOCAL "A")	10+97.69 TO 24+08.48	--	2"	10"	6"	NO	2.5	2.76
ATLANTIC PUFFIN (LOCAL "A")	1+14.00 TO 3+26.48	--	2"	10"	6"	NO	2.5	2.76
YELLOW BUNTING (LOCAL "A")	1+14.00 TO 5+98.01	--	2"	10"	6"	NO	2.5	2.76
VIOLET STARLING (LOCAL "A")	6+49.10 TO 9+81.03	--	2"	10"	6"	NO	2.5	2.76
PINK ROBIN (LOCAL "A")	1+14.00 TO 5+75.85	--	2"	10"	6"	NO	2.5	2.76
CONTRACTOR SHALL REFERENCE GEOTECH STUDY/REPORT BY INTEC, DATED 09/13/2023, PROJECT NO. S231193.								

**GENERAL NOTES:**

1. CONTRACTOR SHALL REFERENCE THE PROJECT PAVEMENT DESIGN REPORT **NO.5231193** PREPARED BY **INTEC** DATED **09/13/2023**.
2. CONTRACTOR SHALL RETAIN A GEOTECHNICAL ENGINEER TO VERIFY THE SUB GRADE CONDITION PRIOR TO PLACING ANY BASE MATERIAL. GEOTECHNICAL ENGINEER SHALL DETERMINE THE SUB GRADE CONDITION AND IF LIME STABILIZATION IS REQUIRED.
3. GEOTECHNICAL ENGINEER SHOULD VERIFY THE STREET SUBGRADE AT THE TIME OF CONSTRUCTION PRIOR TO PLACEMENT OF AGGREGATE BASE.
4. THE FLEXIBLE BASE COURSE SHOULD BE CRUSHED LIMESTONE CONFORMING TO TxDOT STANDARD SPECIFICATIONS, ITEM 247, TYPE A, GRADES 1 OR 2.
5. THE MOISTURE CONTENT OF THE FILL SHOULD BE MAINTAINED WITHIN THE RANGE OF OPTIMUM WATER CONTENT TO 2 PERCENTAGE POINTS ABOVE THE OPTIMUM WATER CONTENT UNTIL PERMANENTLY COVERED.
6. IN THE EVENT THAT THE CLAY FILL USED IS DIFFERENT THAN THE EXISTING SUBGRADE, THE RECOMMENDATIONS IN THE GEOTECHNICAL REPORT COULD BE INVALIDATED AND THE DESIGN ENGINEER MUST BE CONSULTED TO DETERMINE IF ADDITIONAL CBR TESTING AND THICKER PAVEMENT SECTIONS ARE REQUIRED.
7. WHERE PAVEMENT SUBGRADE IS LOCATED WITHIN 2 FT. OF THE EXISTING GROUND SURFACE (STRATUM 1 SURFACE) MOISTURE CONDITIONED SUBGRADE WILL BE REQUIRED. GEOTECHNICAL ENGINEER SHOULD VERIFY THE STREET SUBGRADE AT THE TIME OF CONSTRUCTION PRIOR TO PLACEMENT OF AGGREGATE BASE TO DETERMINE WHERE THE MOISTURE CONDITIONED SUBGRADE IS NEEDED. REFERENCE GEOTECHNICAL ENGINEERING REPORT FOR MORE INFORMATION.
8. THE CONTRACTOR IS RESPONSIBLE FOR COORDINATING ALL MATERIAL TESTING WITH THE PROJECT GEOTECHNICAL ENGINEER. TESTING SHALL BE PAID FOR BY THE OWNER.

**SUBGRADE NOTES:**

1. THE SUBGRADE PLASTICITY INDEX VALUE IS EXPECTED TO BE LESS THAN OR EQUAL TO 20 OR GREATER THAN 20.
2. IF THE SUBGRADE PLASTICITY INDEX VALUES ARE LESS THAN OR EQUAL TO 20, AS PER CITY OF SAN ANTONIO OR BEXAR COUNTY REQUIREMENTS, SUBGRADE STABILIZATION IS NOT NEEDED.
3. IF THE FINAL STREET SUBGRADE PLASTICITY INDEX VALUES ARE GREATER THAN 20, THEN THE SUBGRADE SHOULD BE LIME STABILIZED.
4. LIME STABILIZED TO A DEPTH OF 6 OR 8 INCHES AS NOTED ABOVE BASED ON AN APPLICATION RATE OF 7% OF THE DRY WEIGHT (INITIAL RECOMMENDATIONS) OF THE SOIL TO BE STABILIZED. THE LIME APPLICATION RATE WILL BE PRESENTED AFTER THE FIELD TESTS ARE COMPLETED.
5. THE SUBGRADE SOILS SHOULD BE TESTED FOR SOIL SULFATE CONTENT PRIOR TO STABILIZATION. IF THE SOIL SULFATE CONTENT IS HIGHER THAN 3000 PPM PER PAVEMENT DESIGN REPORT NO. 5231193, AN ALTERNATIVE PROCEDURE WILL BE NEEDED.
6. LIME APPLICATION RATE OF 32 LBS. PER SQUARE YARD FOR 8 INCH DEPTH OF STABILIZATION IS RECOMMENDED.
7. LIME APPLICATION RATE OF 43 LBS. PER SQUARE YARD FOR 8 INCH DEPTH OF STABILIZATION IS RECOMMENDED.
8. THE SUBGRADE SHOULD BE PROOF ROLLED TO IDENTIFY SOFT AREAS BEFORE STABILIZATION.
9. IF FILL IS USED TO RAISE THE GRADE, APPROVED FILL MATERIAL UNDERNEATH THE PAVEMENT SHOULD BE USED. THE FILL SHOULD BE FREE OF DELETERIOUS MATERIAL. THE GRAVEL SIZE SHOULD NOT EXCEED 3 INCHES IN SIZE, WITH A MINIMUM CBR VALUE OF 2.5, AND A MAXIMUM PLASTICITY INDEX VALUE OF 60. LIME APPLICATION RATES SHOULD BE RE-EVALUATED AND SULFATE CONTENT TESTED FOR THE FILL MATERIAL. THE MATERIAL SHOULD BE PLACED AS PER APPLICABLE CITY OR COUNTY GUIDELINES






LIME NOTES:

FOR LIME STABILIZATION CONSTRUCTION VERIFICATION THE FOLLOWING SHALL BE CONDUCTED ON THE FIELD:

1. AFTER INITIAL MIXING THE SOIL-LIME MIXTURE SHALL MELLOW FOR A PERIOD OF TWO TO THREE DAYS. MAINTAIN MOISTURE DURING MELLOWING.
2. AFTER MELLOWING AND FINAL MIXING, THE PULVERIZATION SHALL BE CHECKED USING THE FOLLOWING CRITERIA (REMOVE NON-SLAKING AGGREGATES RETAINED ON THE ¾ INCH SIEVE FROM THE SAMPLE)
 





* MINIMUM PASSING 1 ¾" SIEVE	100
* MINIMUM PASSING ¾" SIEVE	85
* MINIMUM PASSING NO. 4 SIEVE	60
3. SAMPLE SOIL-LIME MIXTURE FOR DETERMINATION OF MAXIMUM DRY DENSITY (MDD). IN THE LABORATORY, MOLD SPECIMENS TO 95% OF MDD AT OPTIMUM MOISTURE CONTENT AND VERIFY UCS TO BE AT LEAST 160 PSI IN ACCORDANCE WITH PROCEDURE OUTLINED IN THE CRACKING TENSILE STRENGTH DEVELOPMENT DESIGN CRITERIA GUIDE FOR MIXTURE DESIGN.

6. LIME APPLICATION RATE OF 32 LBS. PER SQUARE YARD FOR 8 INCH DEPTH OF STABILIZATION IS RECOMMENDED.
7. LIME APPLICATION RATE OF 43 LBS. PER SQUARE YARD FOR 8 INCH DEPTH OF STABILIZATION IS RECOMMENDED.
8. THE SUBGRADE SHOULD BE PROOF ROLLED TO IDENTIFY SOFT AREAS BEFORE STABILIZATION.
9. IF FILL IS USED TO RAISE THE GRADE, APPROVED FILL MATERIAL UNDERNEATH THE PAVEMENT SHOULD BE USED. THE FILL SHOULD BE FREE OF DELETERIOUS MATERIAL. THE GRAVEL SIZE SHOULD NOT EXCEED 3 INCHES IN SIZE, WITH A MINIMUM CBR VALUE OF 2.5, AND A MAXIMUM PLASTICITY INDEX VALUE OF 60. LIME APPLICATION RATES SHOULD BE RE-EVALUATED AND SULFATE CONTENT TESTED FOR THE FILL MATERIAL. THE MATERIAL SHOULD BE PLACED AS PER APPLICABLE CITY OR COUNTY GUIDELINES
4. COMPACT AND CHECK FIELD DENSITY (MIN. OF 85% OF MDD REQUIRED).
5. CURE FOR AN ADDITIONAL 2 TO 5 DAYS (TOTAL MELOWING AND CURING TIME SHOULD TOTAL AT LEAST 5 DAYS).
6. VERIFY DEPTH OF LIME STABILIZED LAYER TO DEPTH AS NOTED ON PLAN TO WITHIN +/- 1.0 INCH.
7. LIME APPLICATION RATE OF 43 LBS. PER SQUARE YARD FOR 8 INCH DEPTH OF STABILIZATION IS RECOMMENDED.
8. THE SUBGRADE SHOULD BE PROOF ROLLED TO IDENTIFY SOFT AREAS BEFORE STABILIZATION.

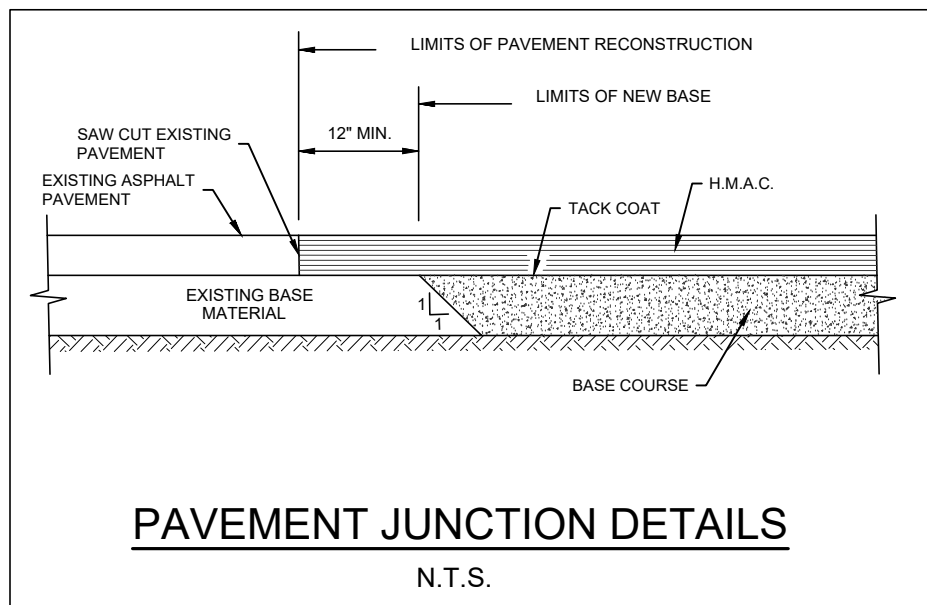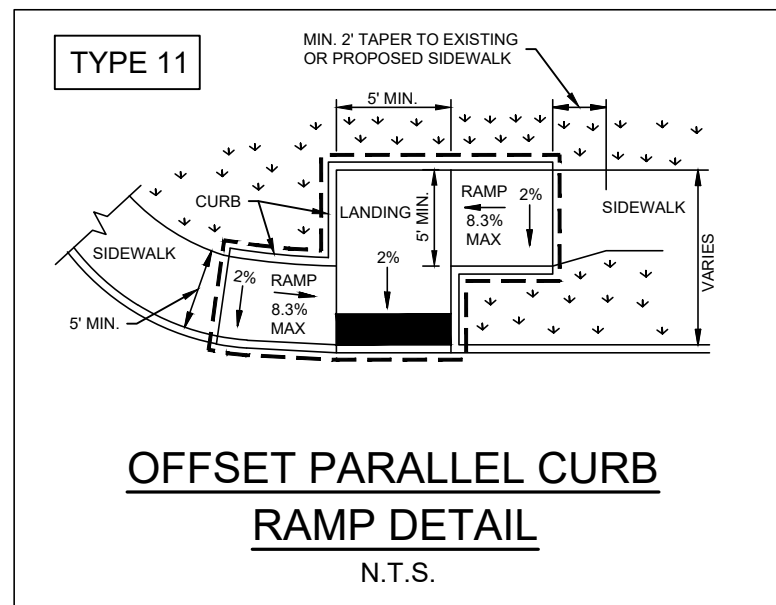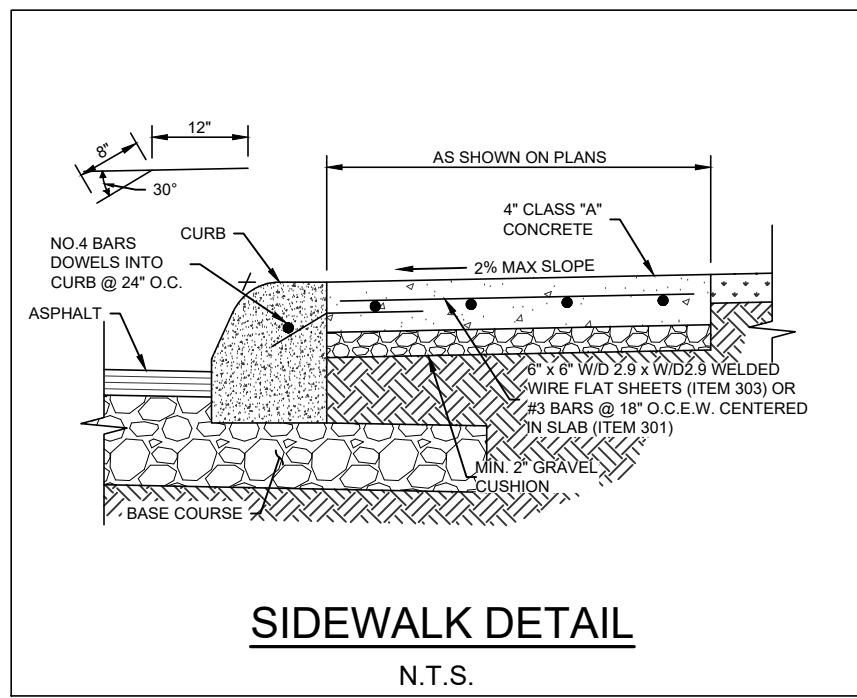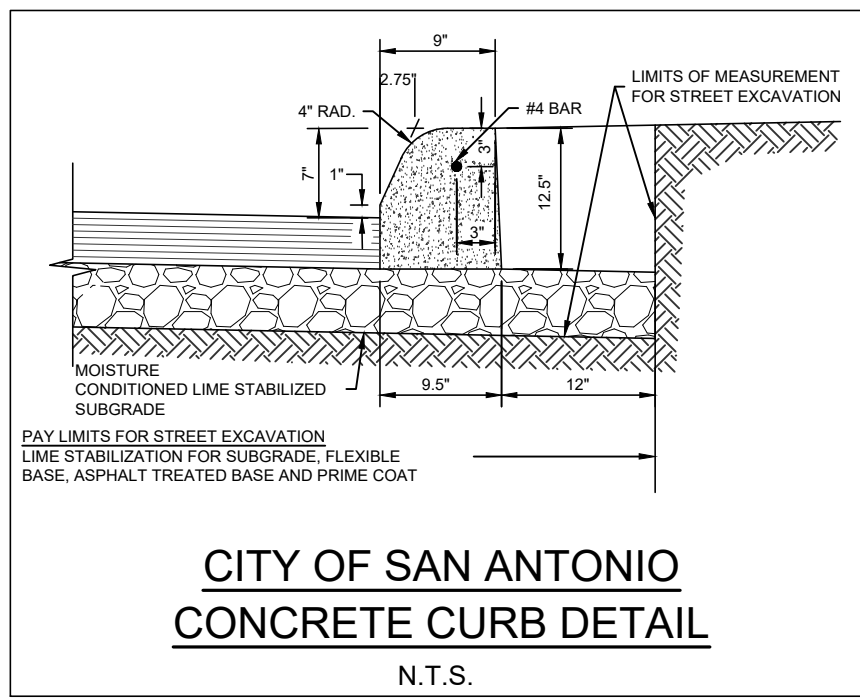
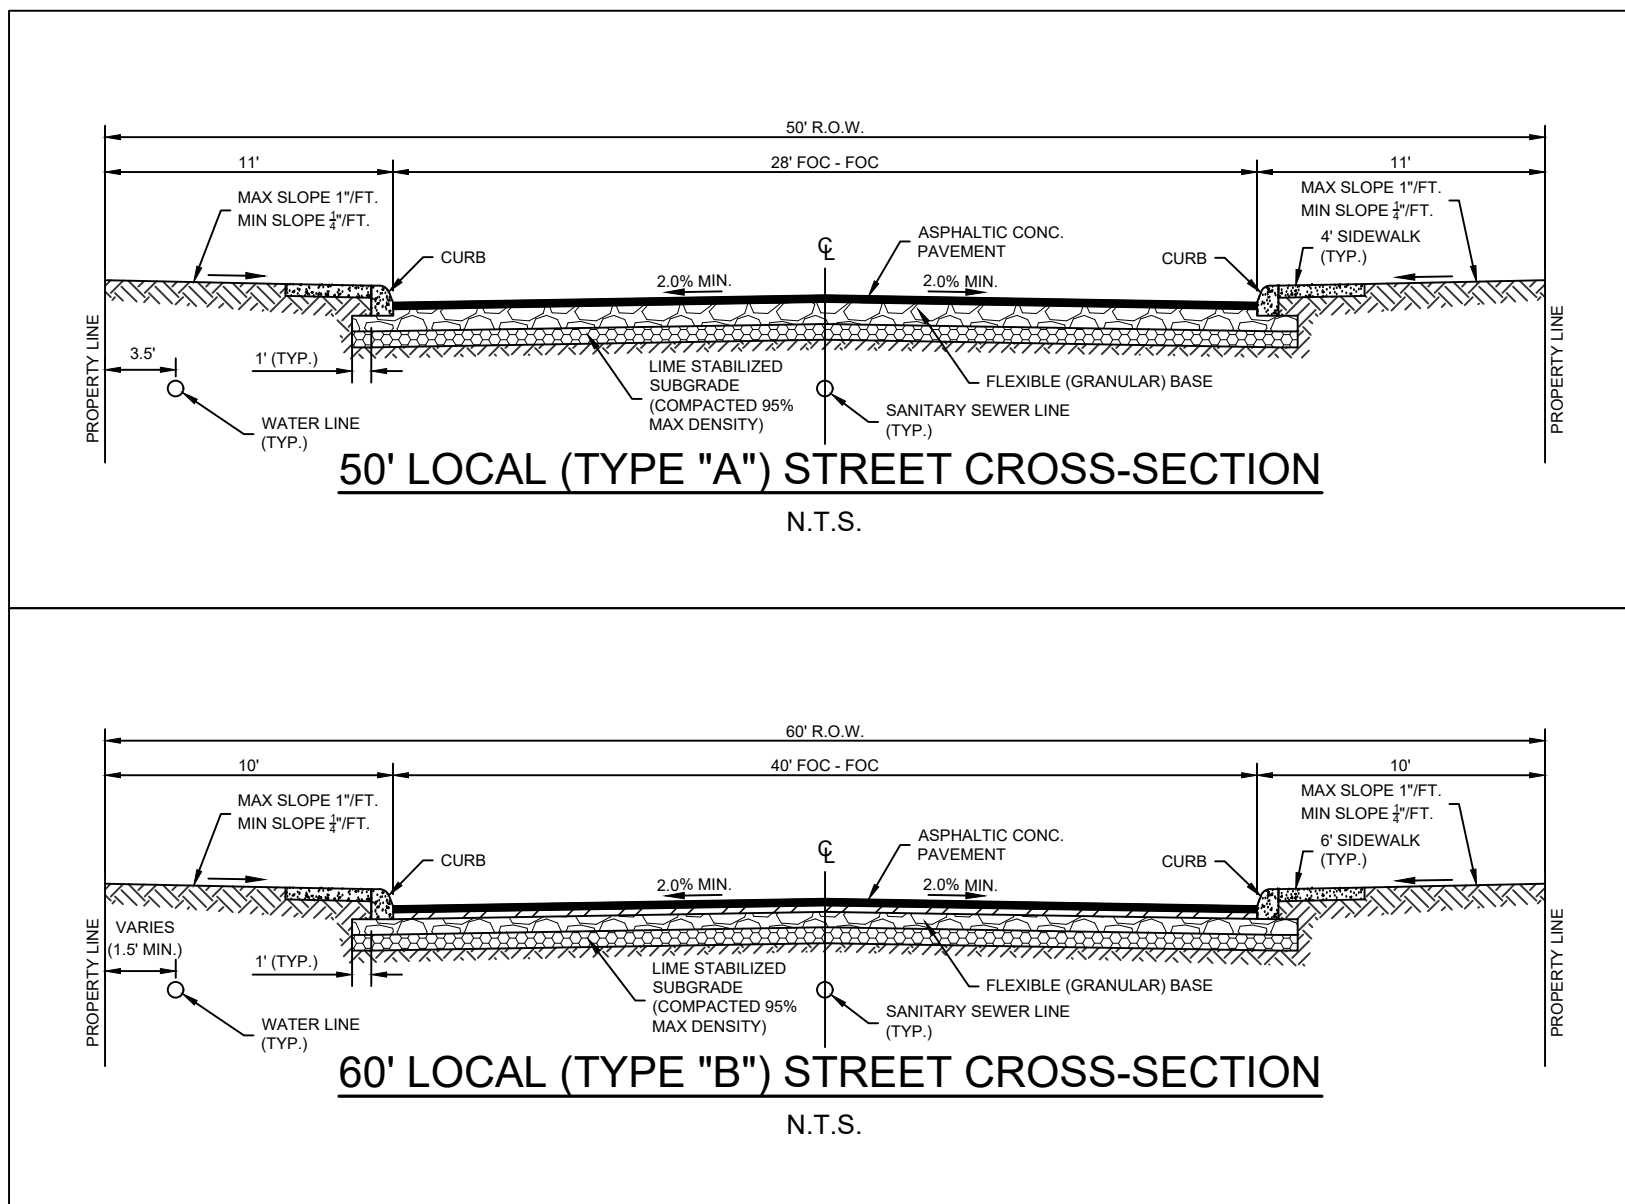







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

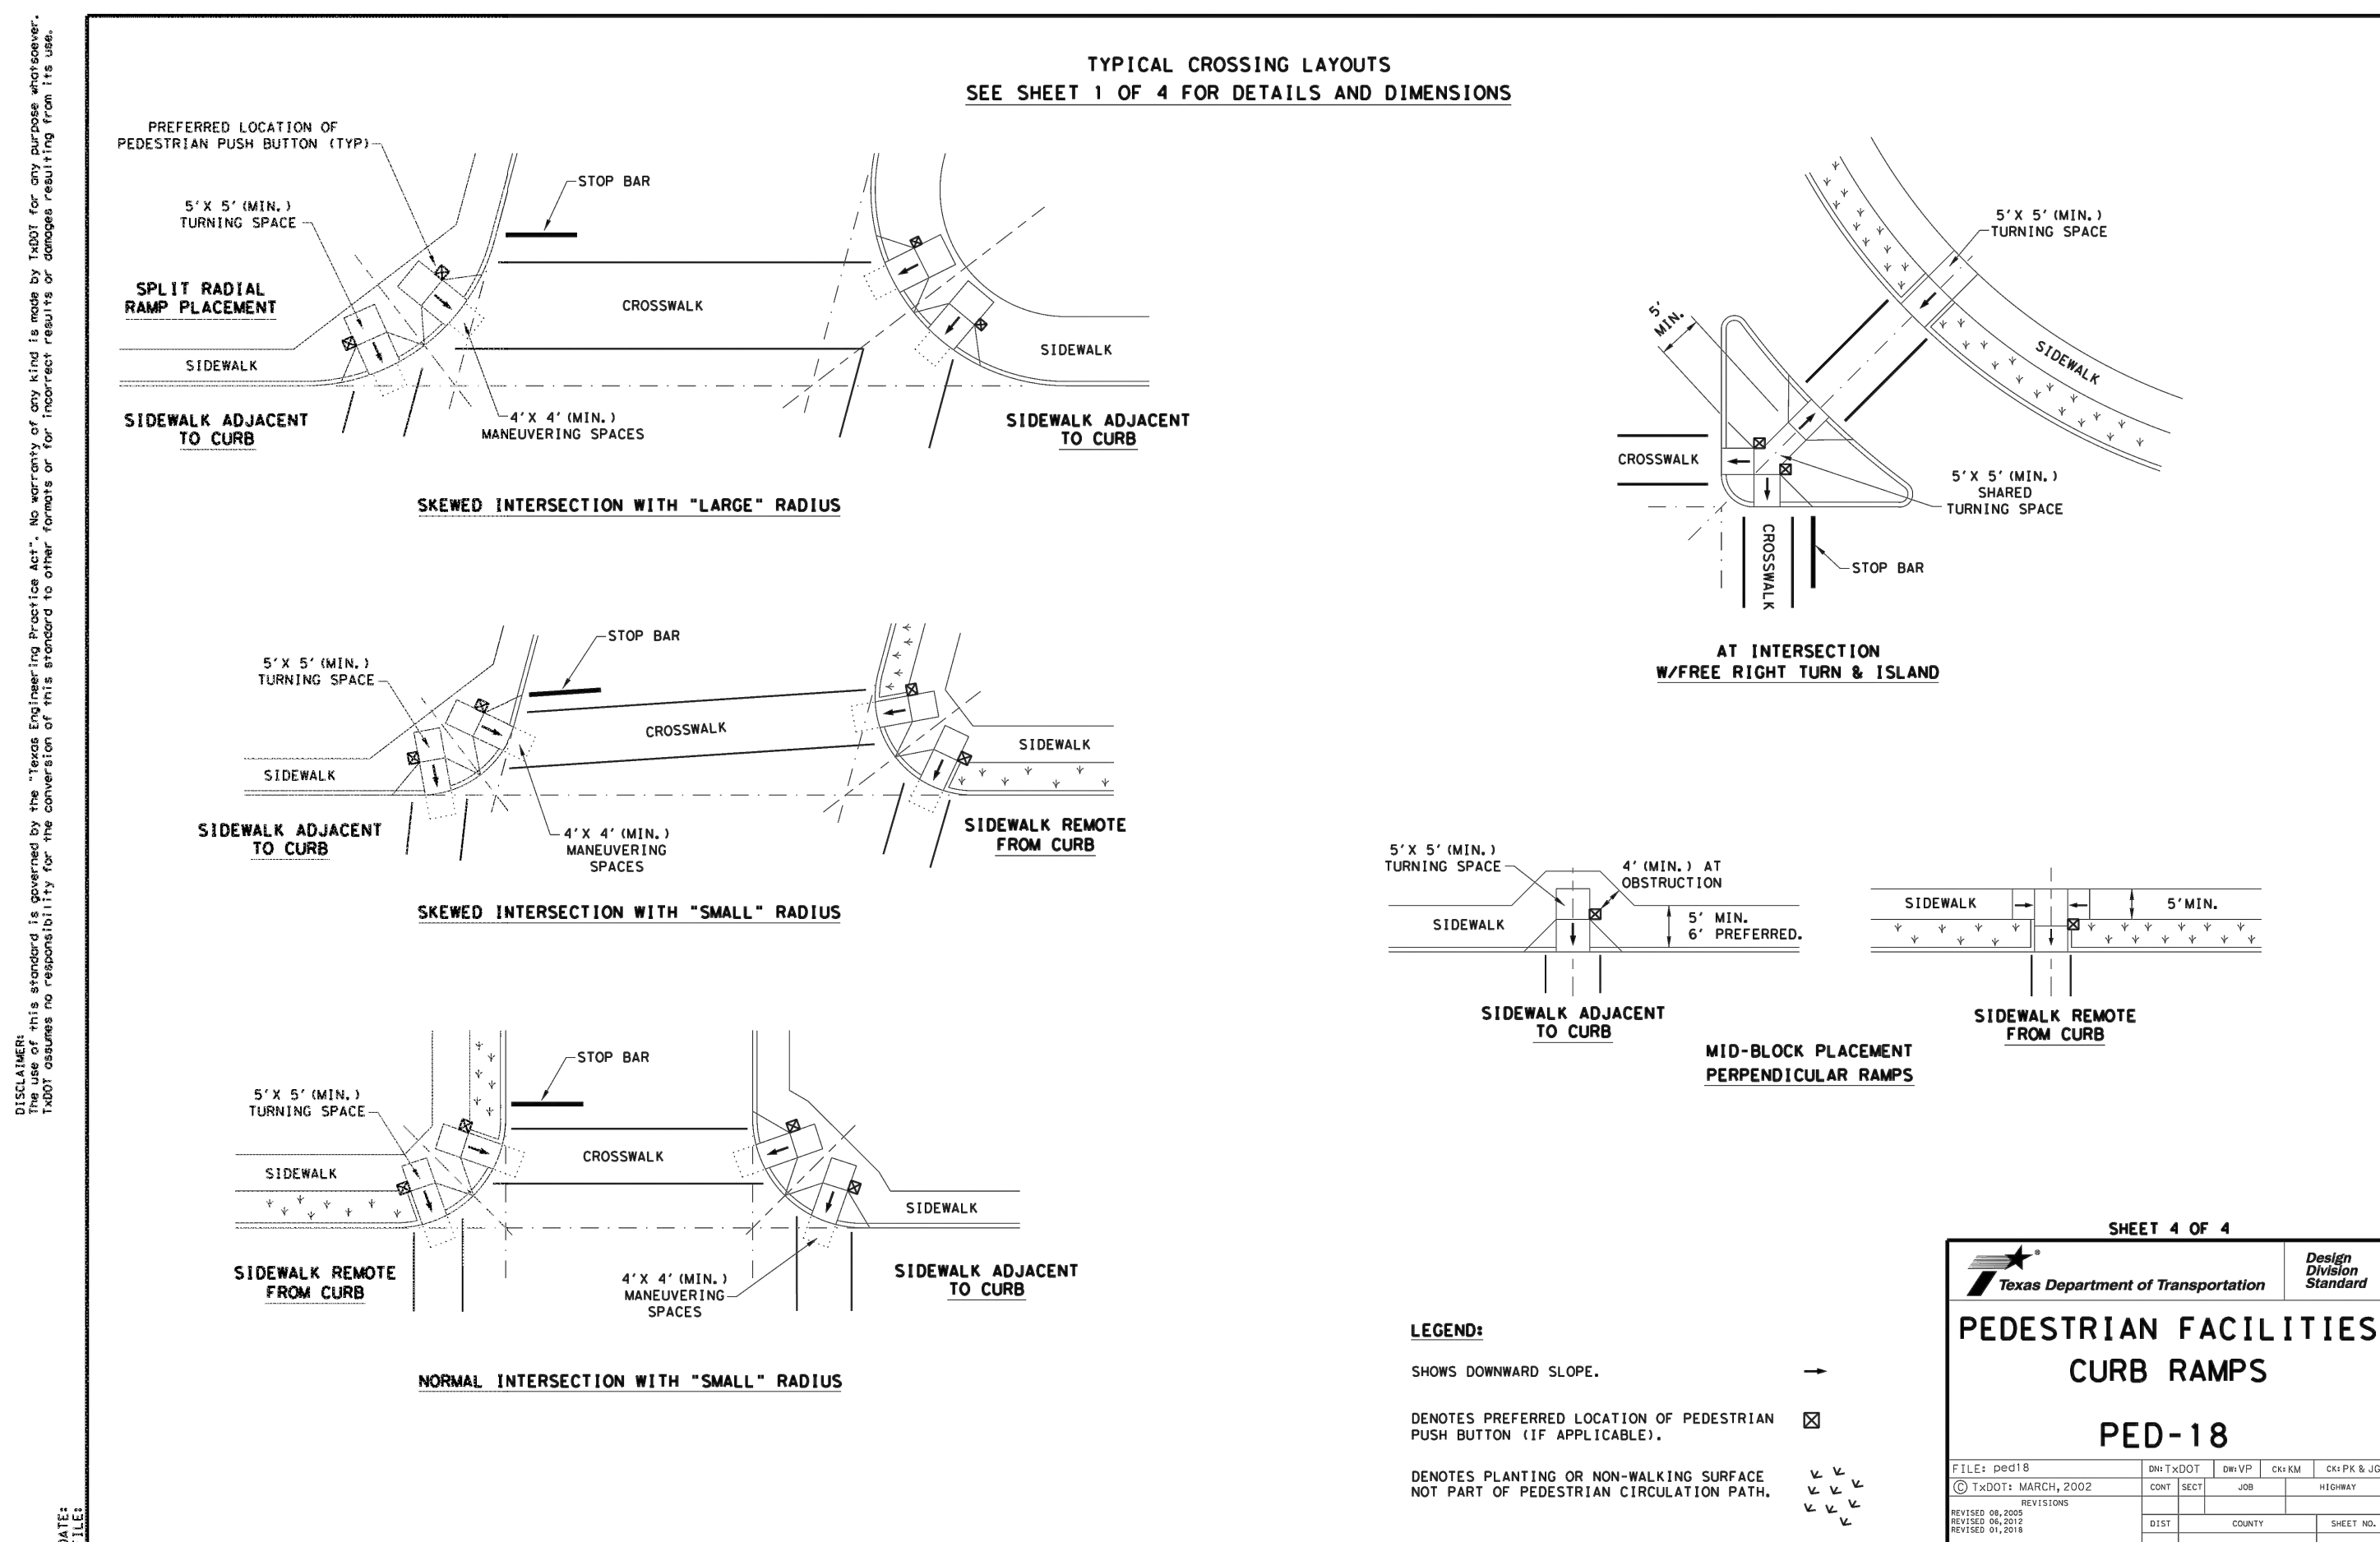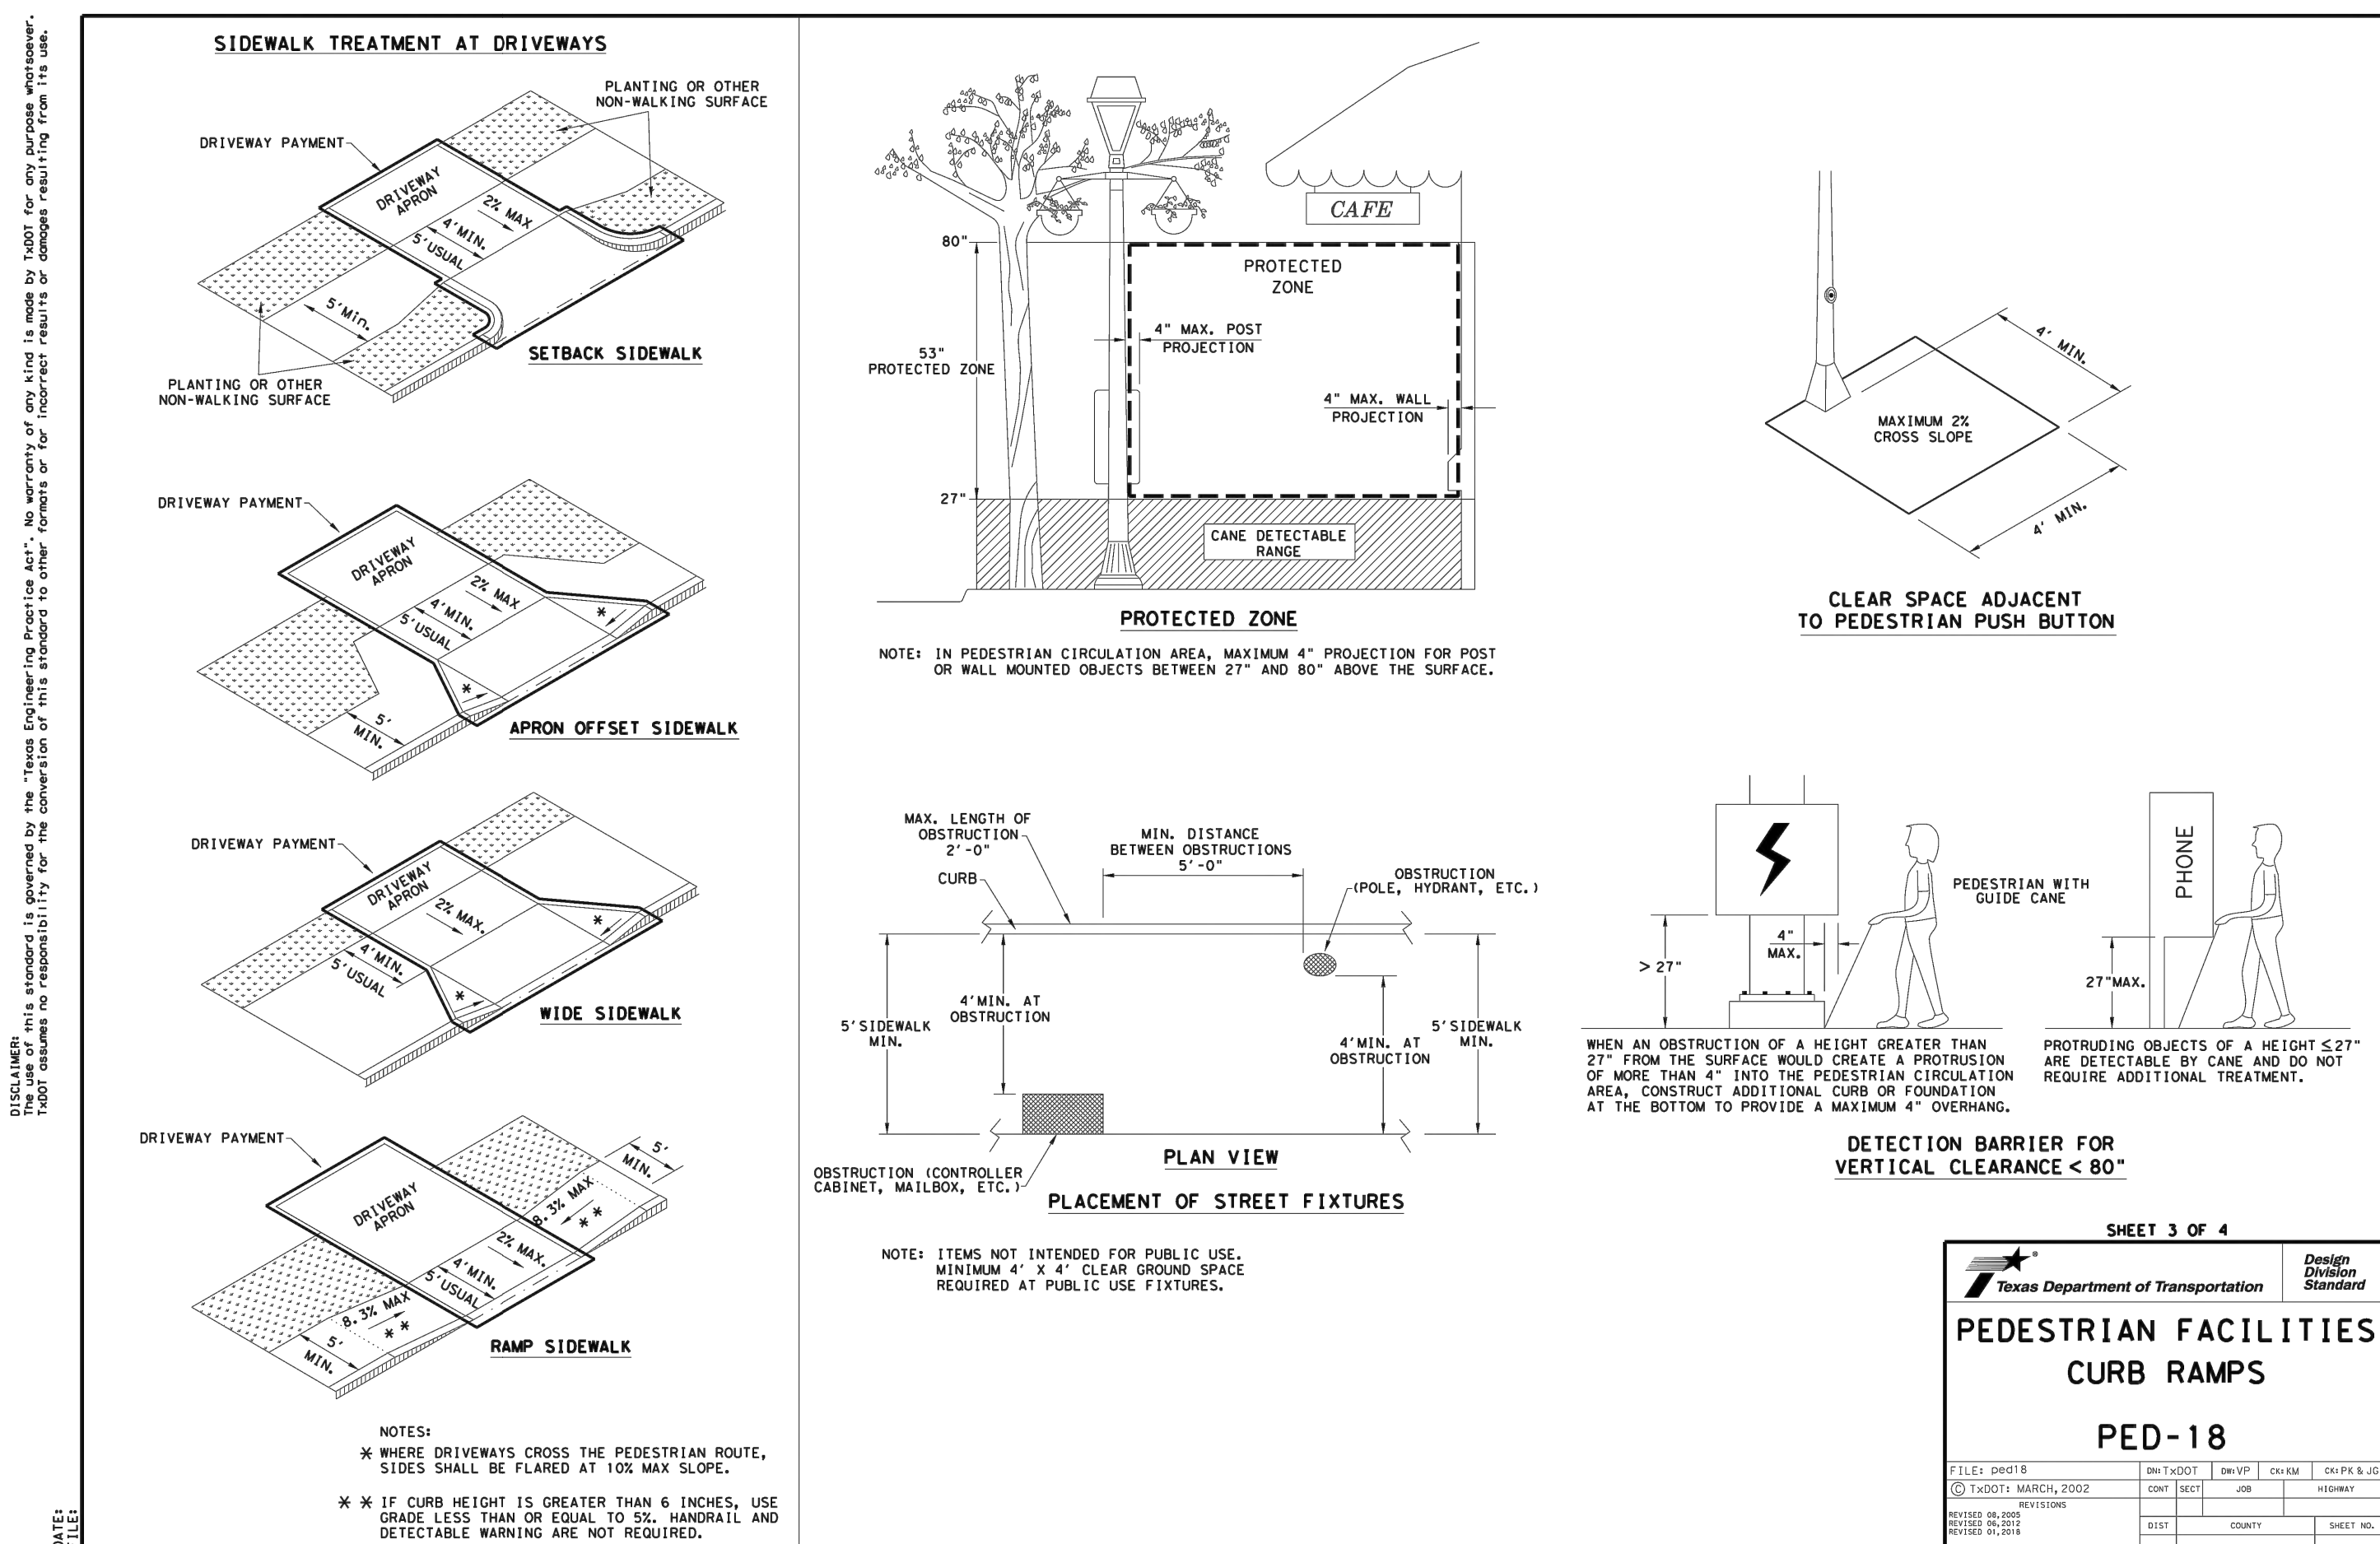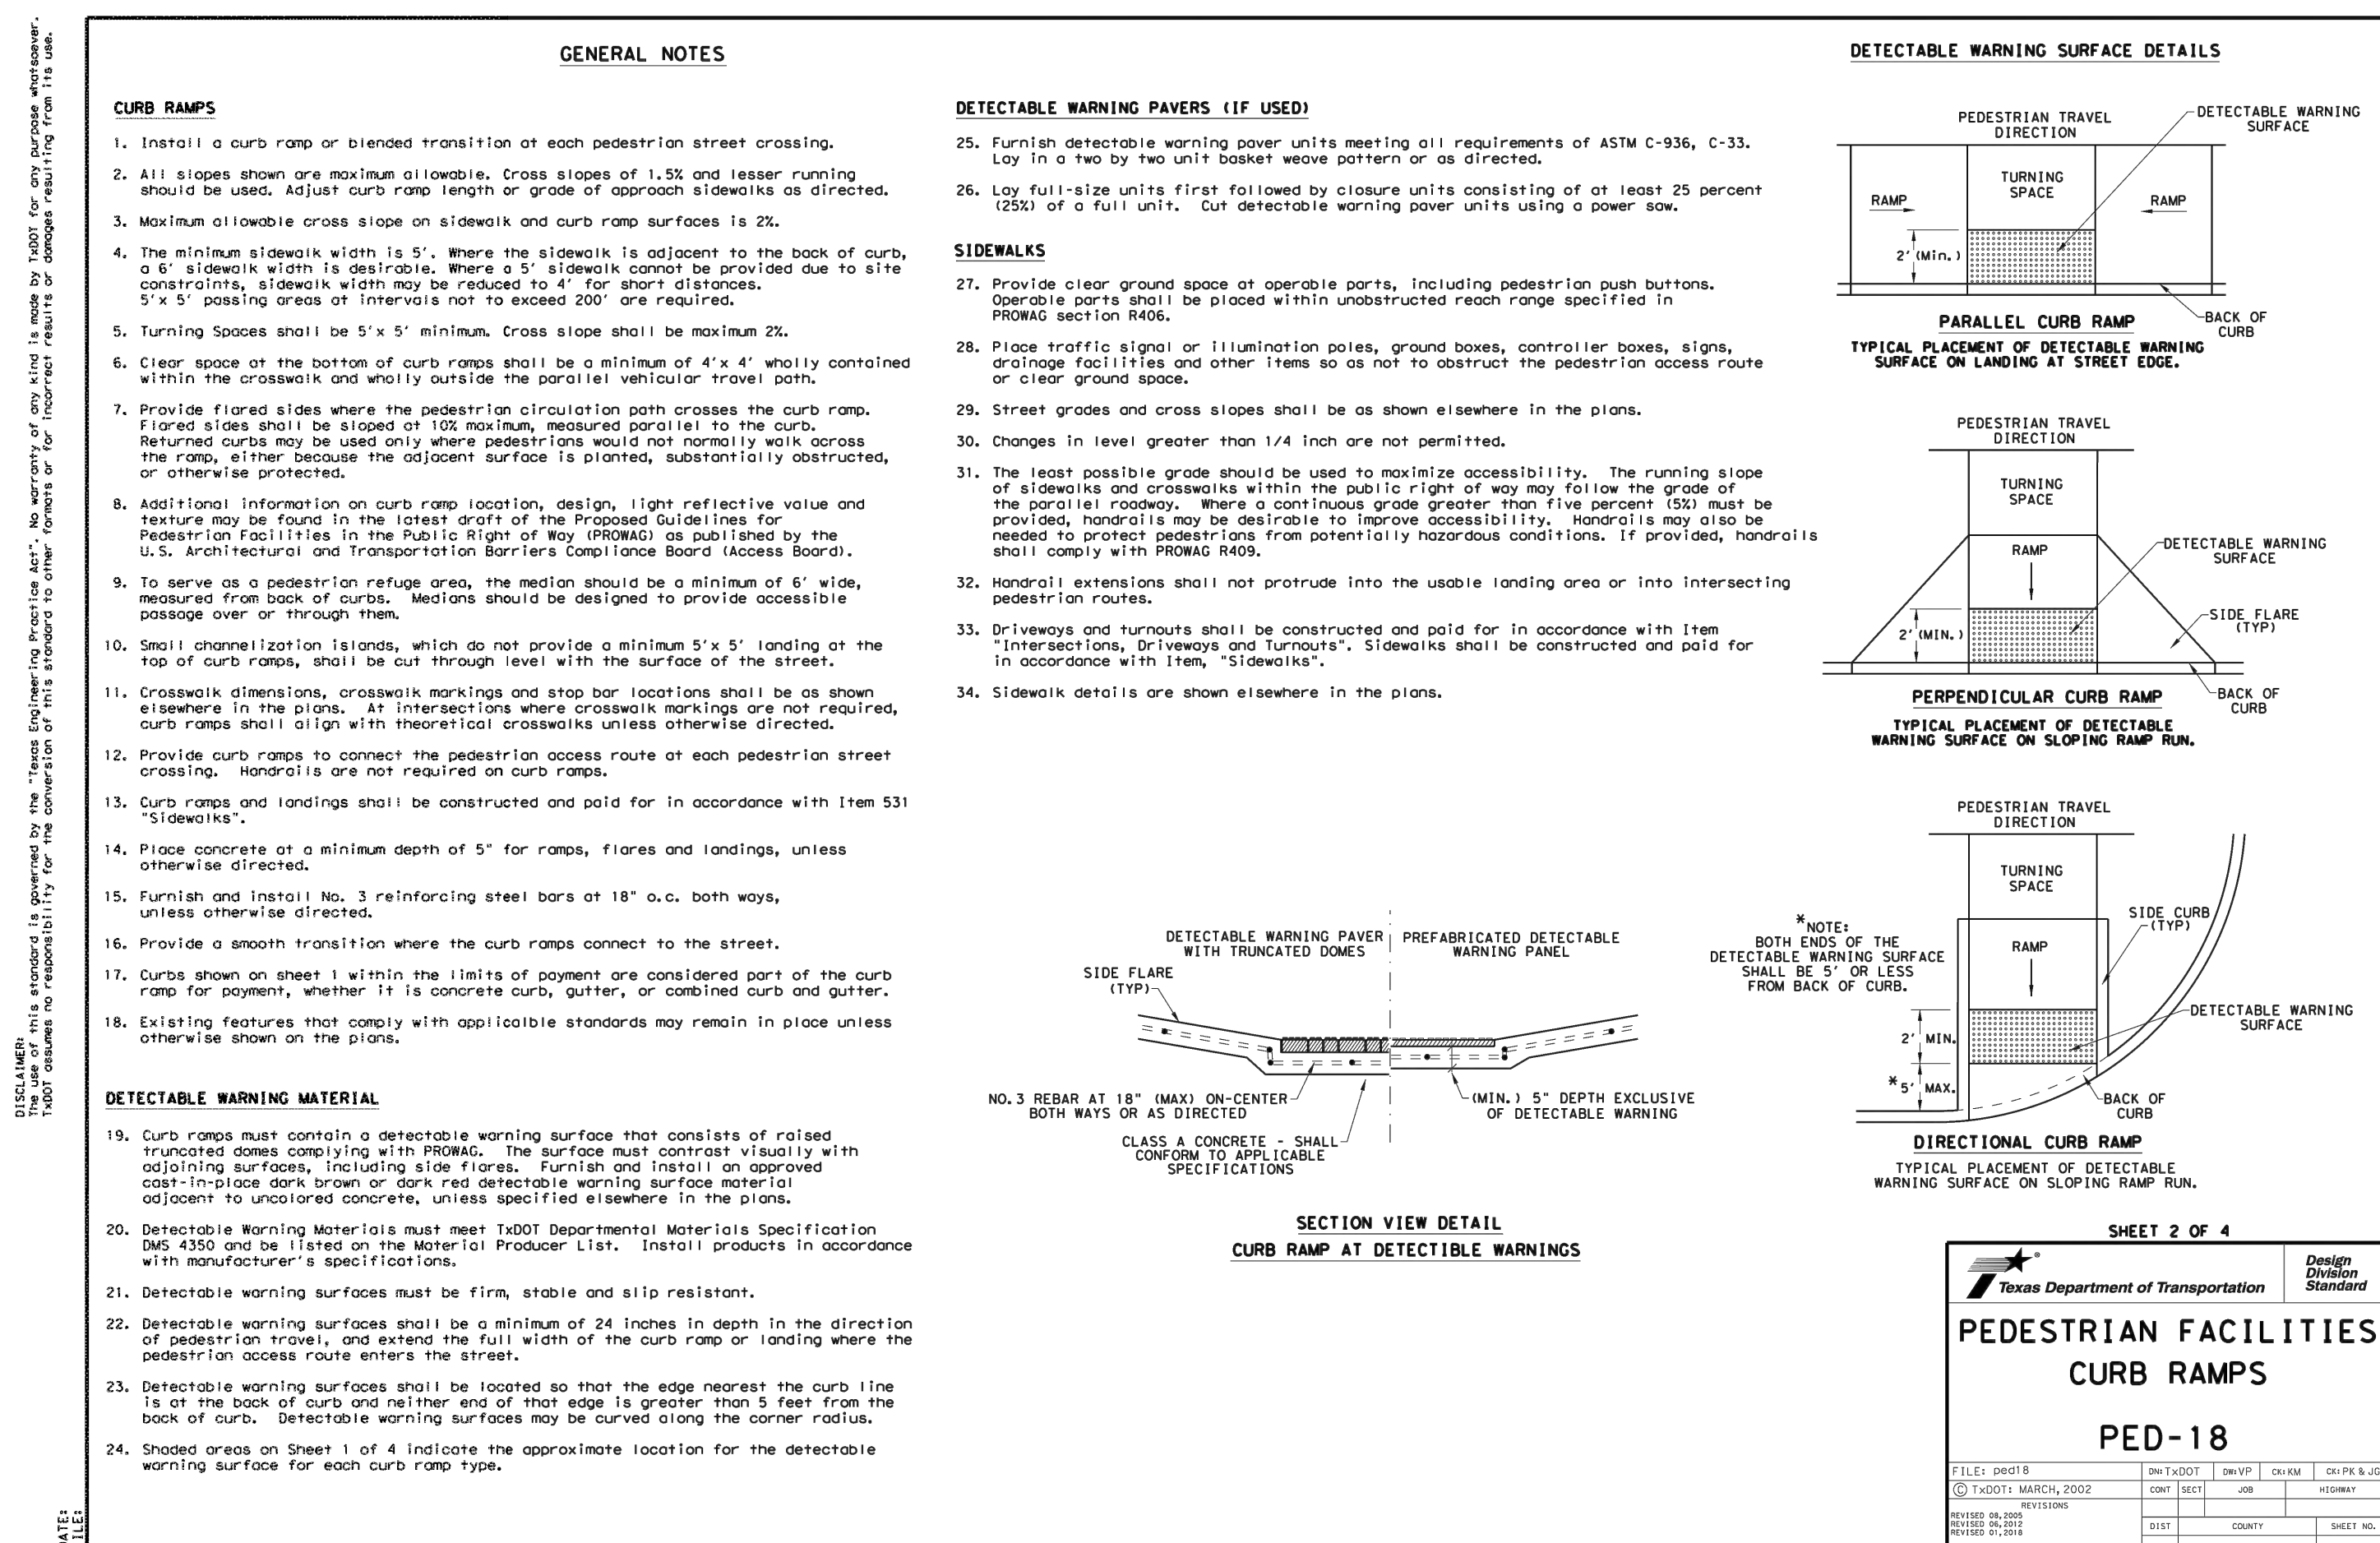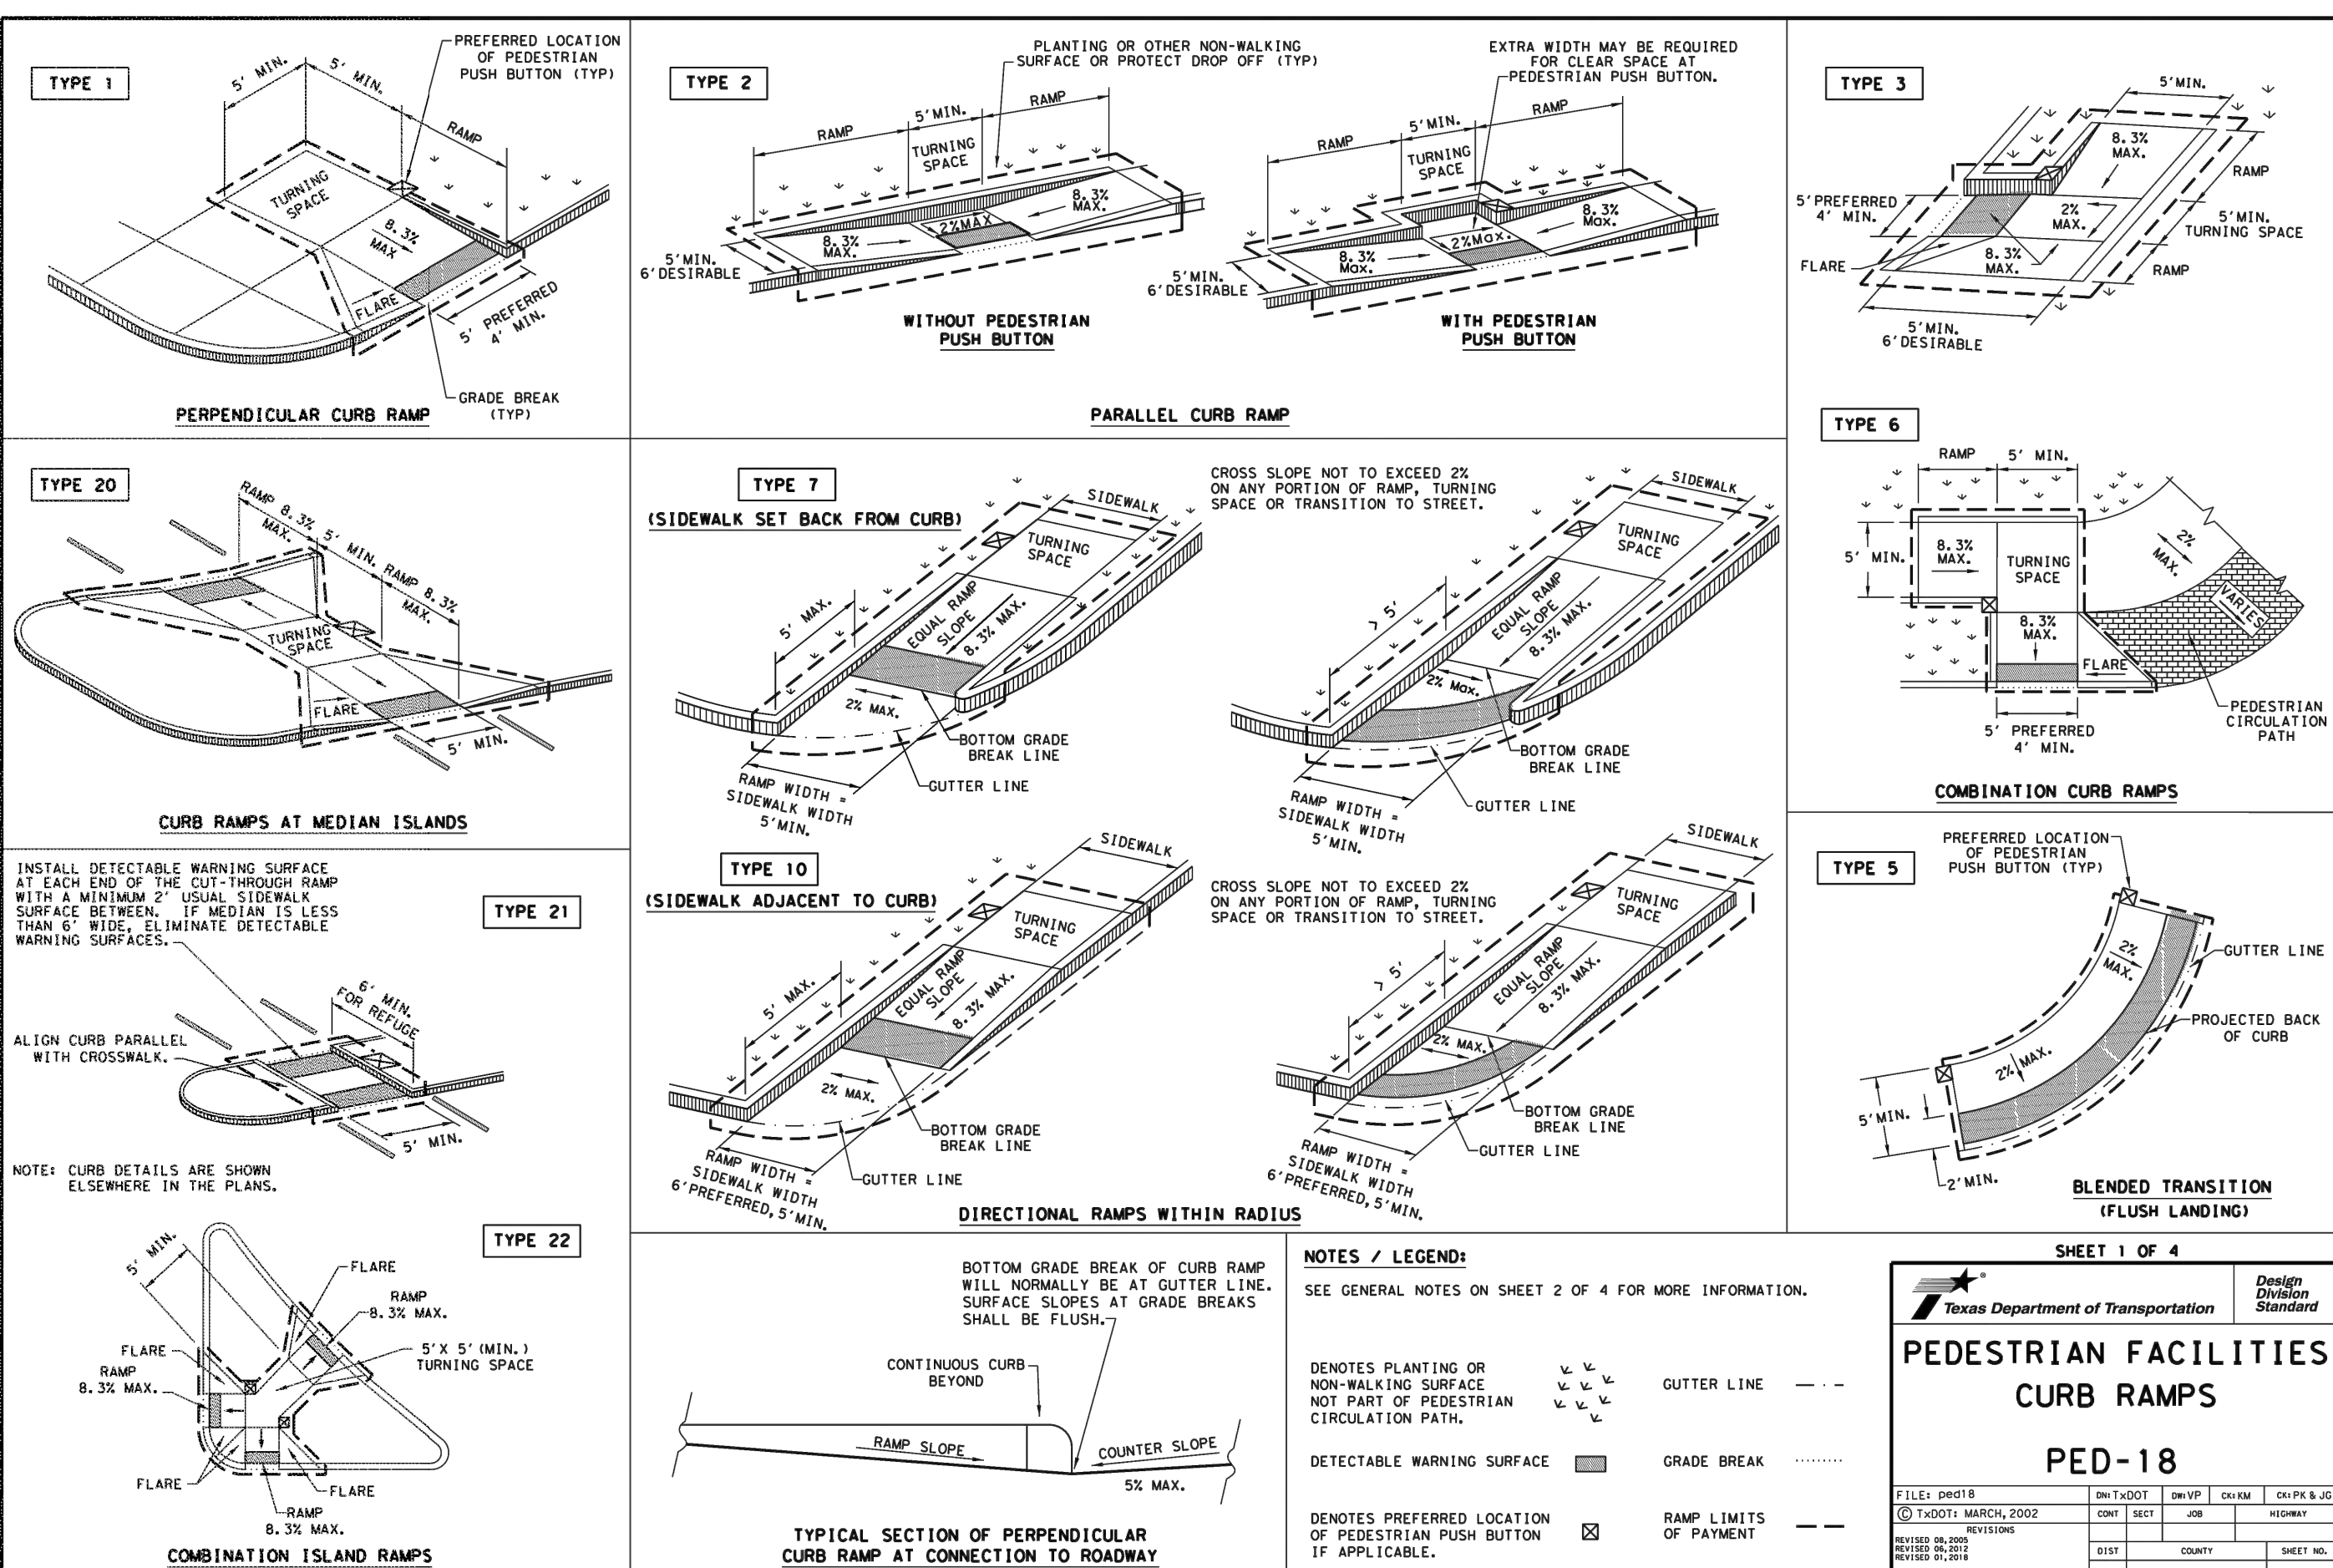



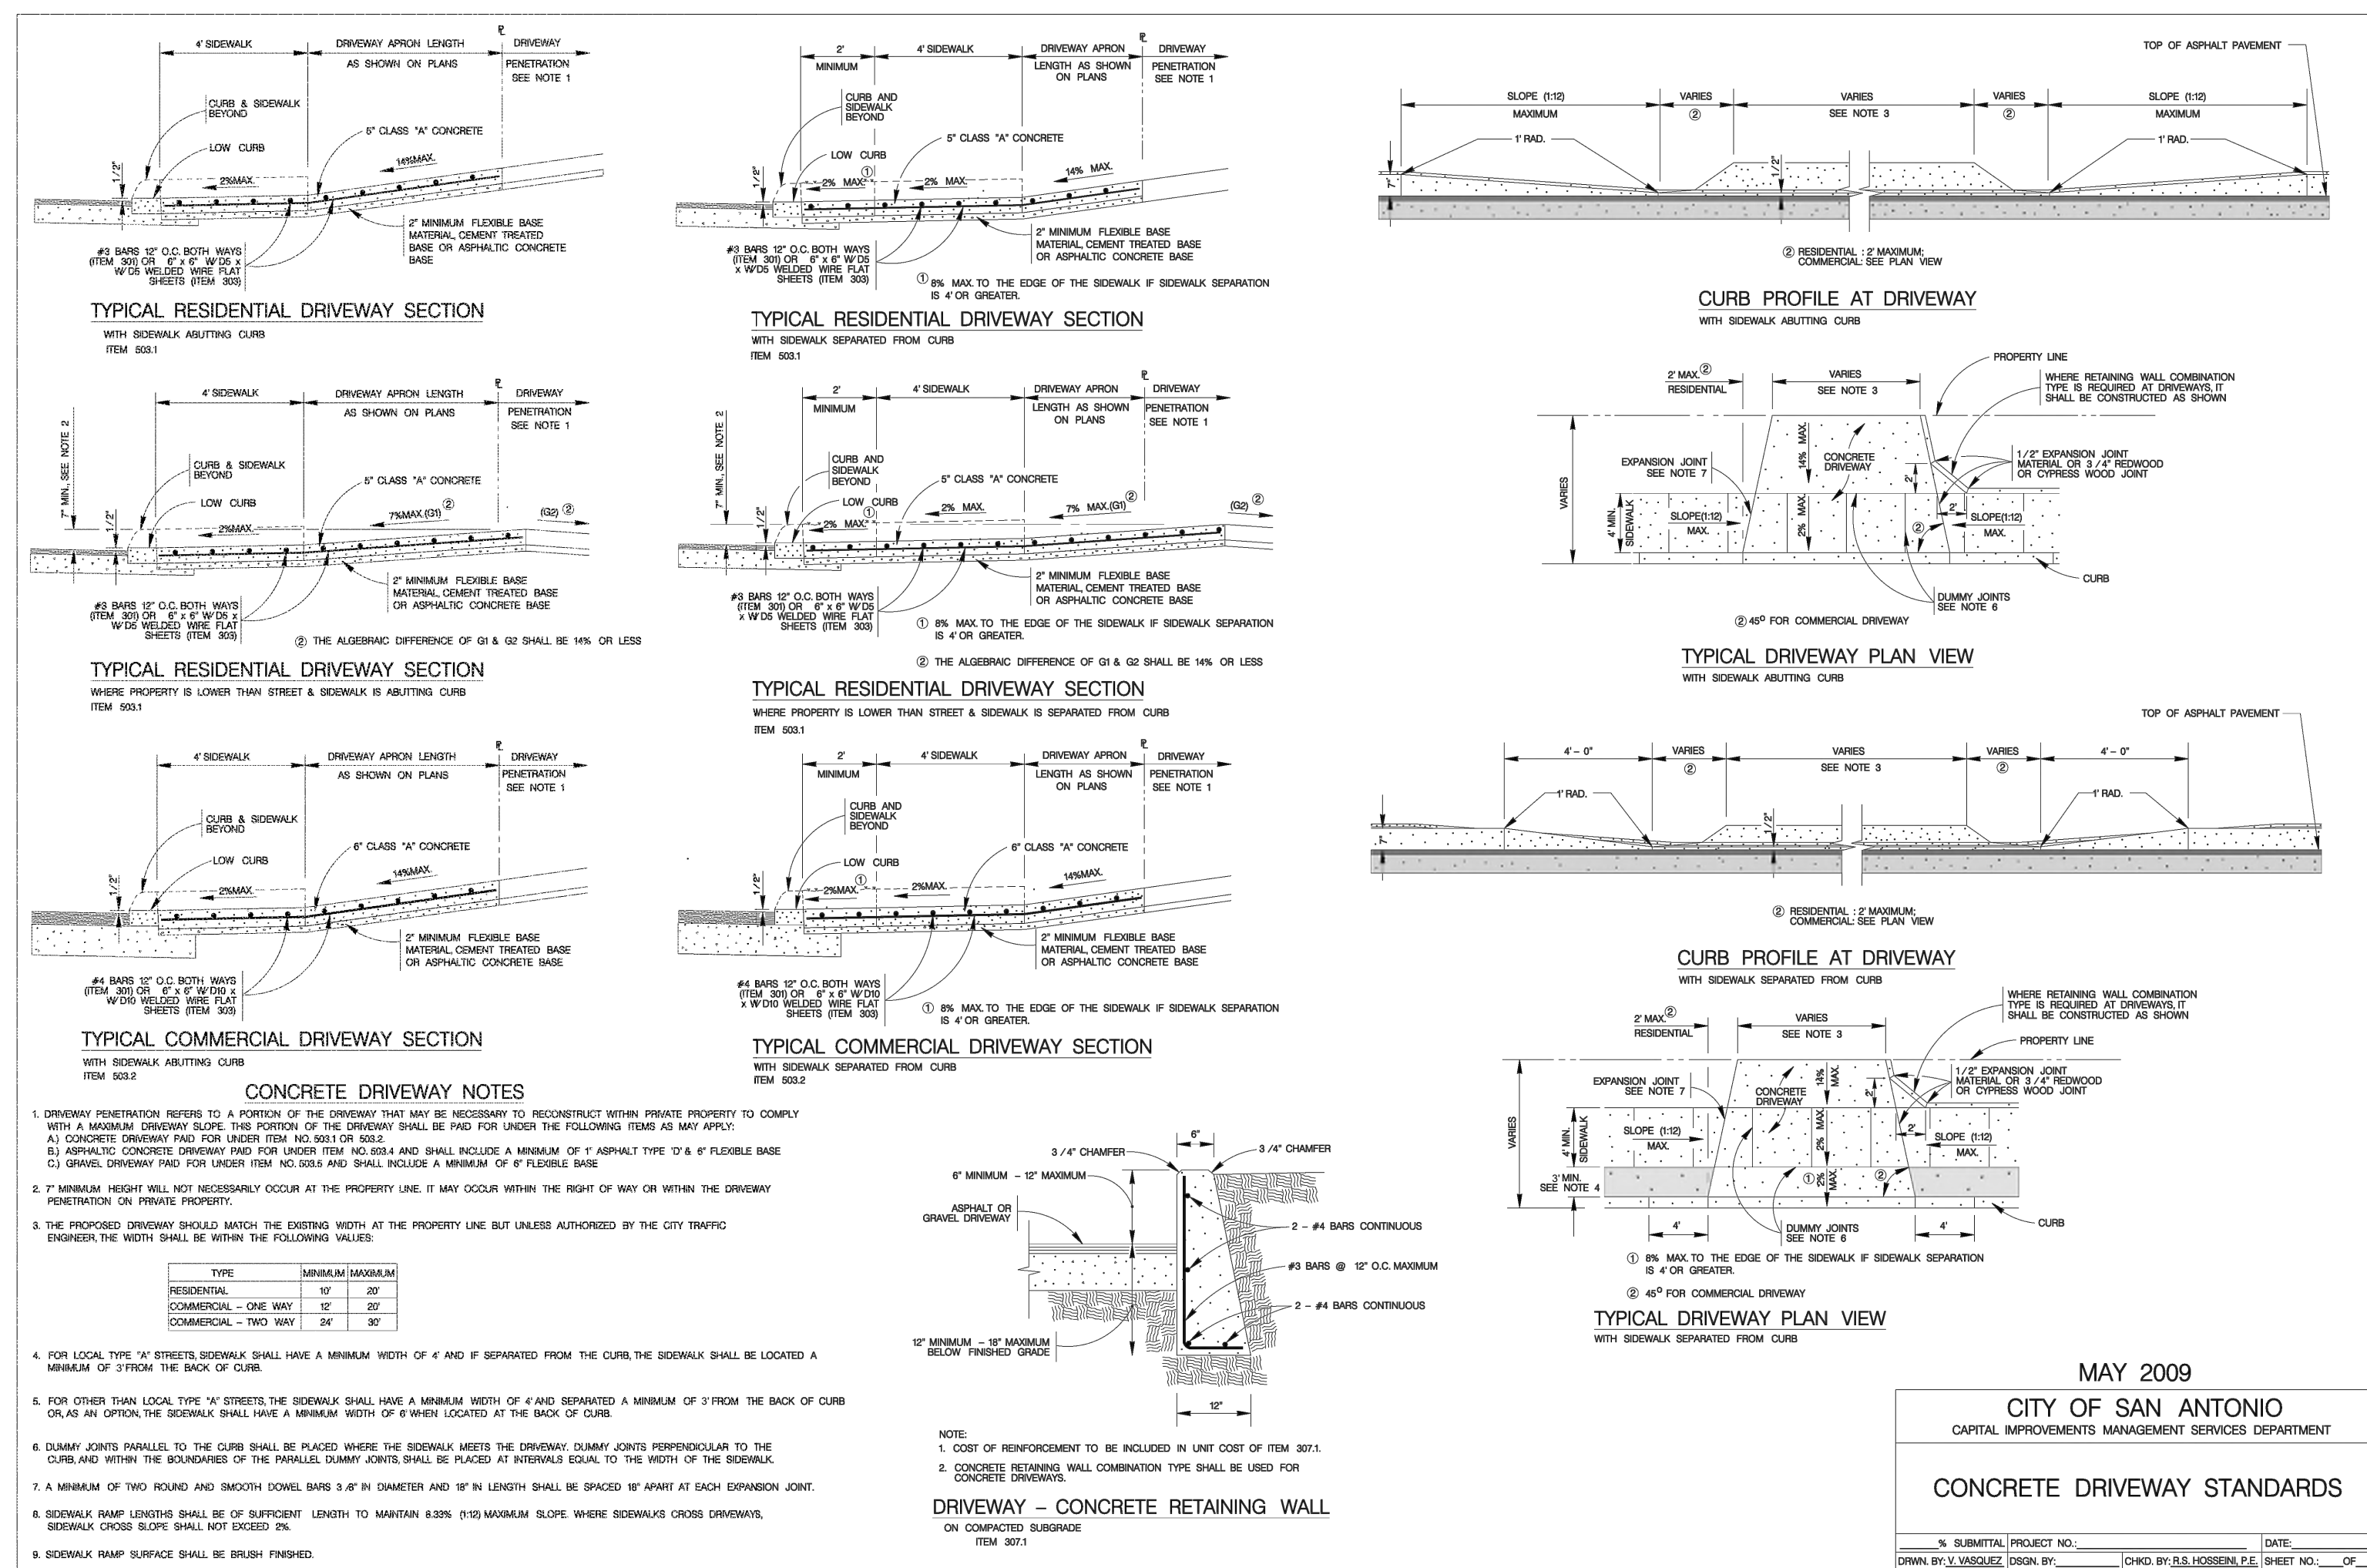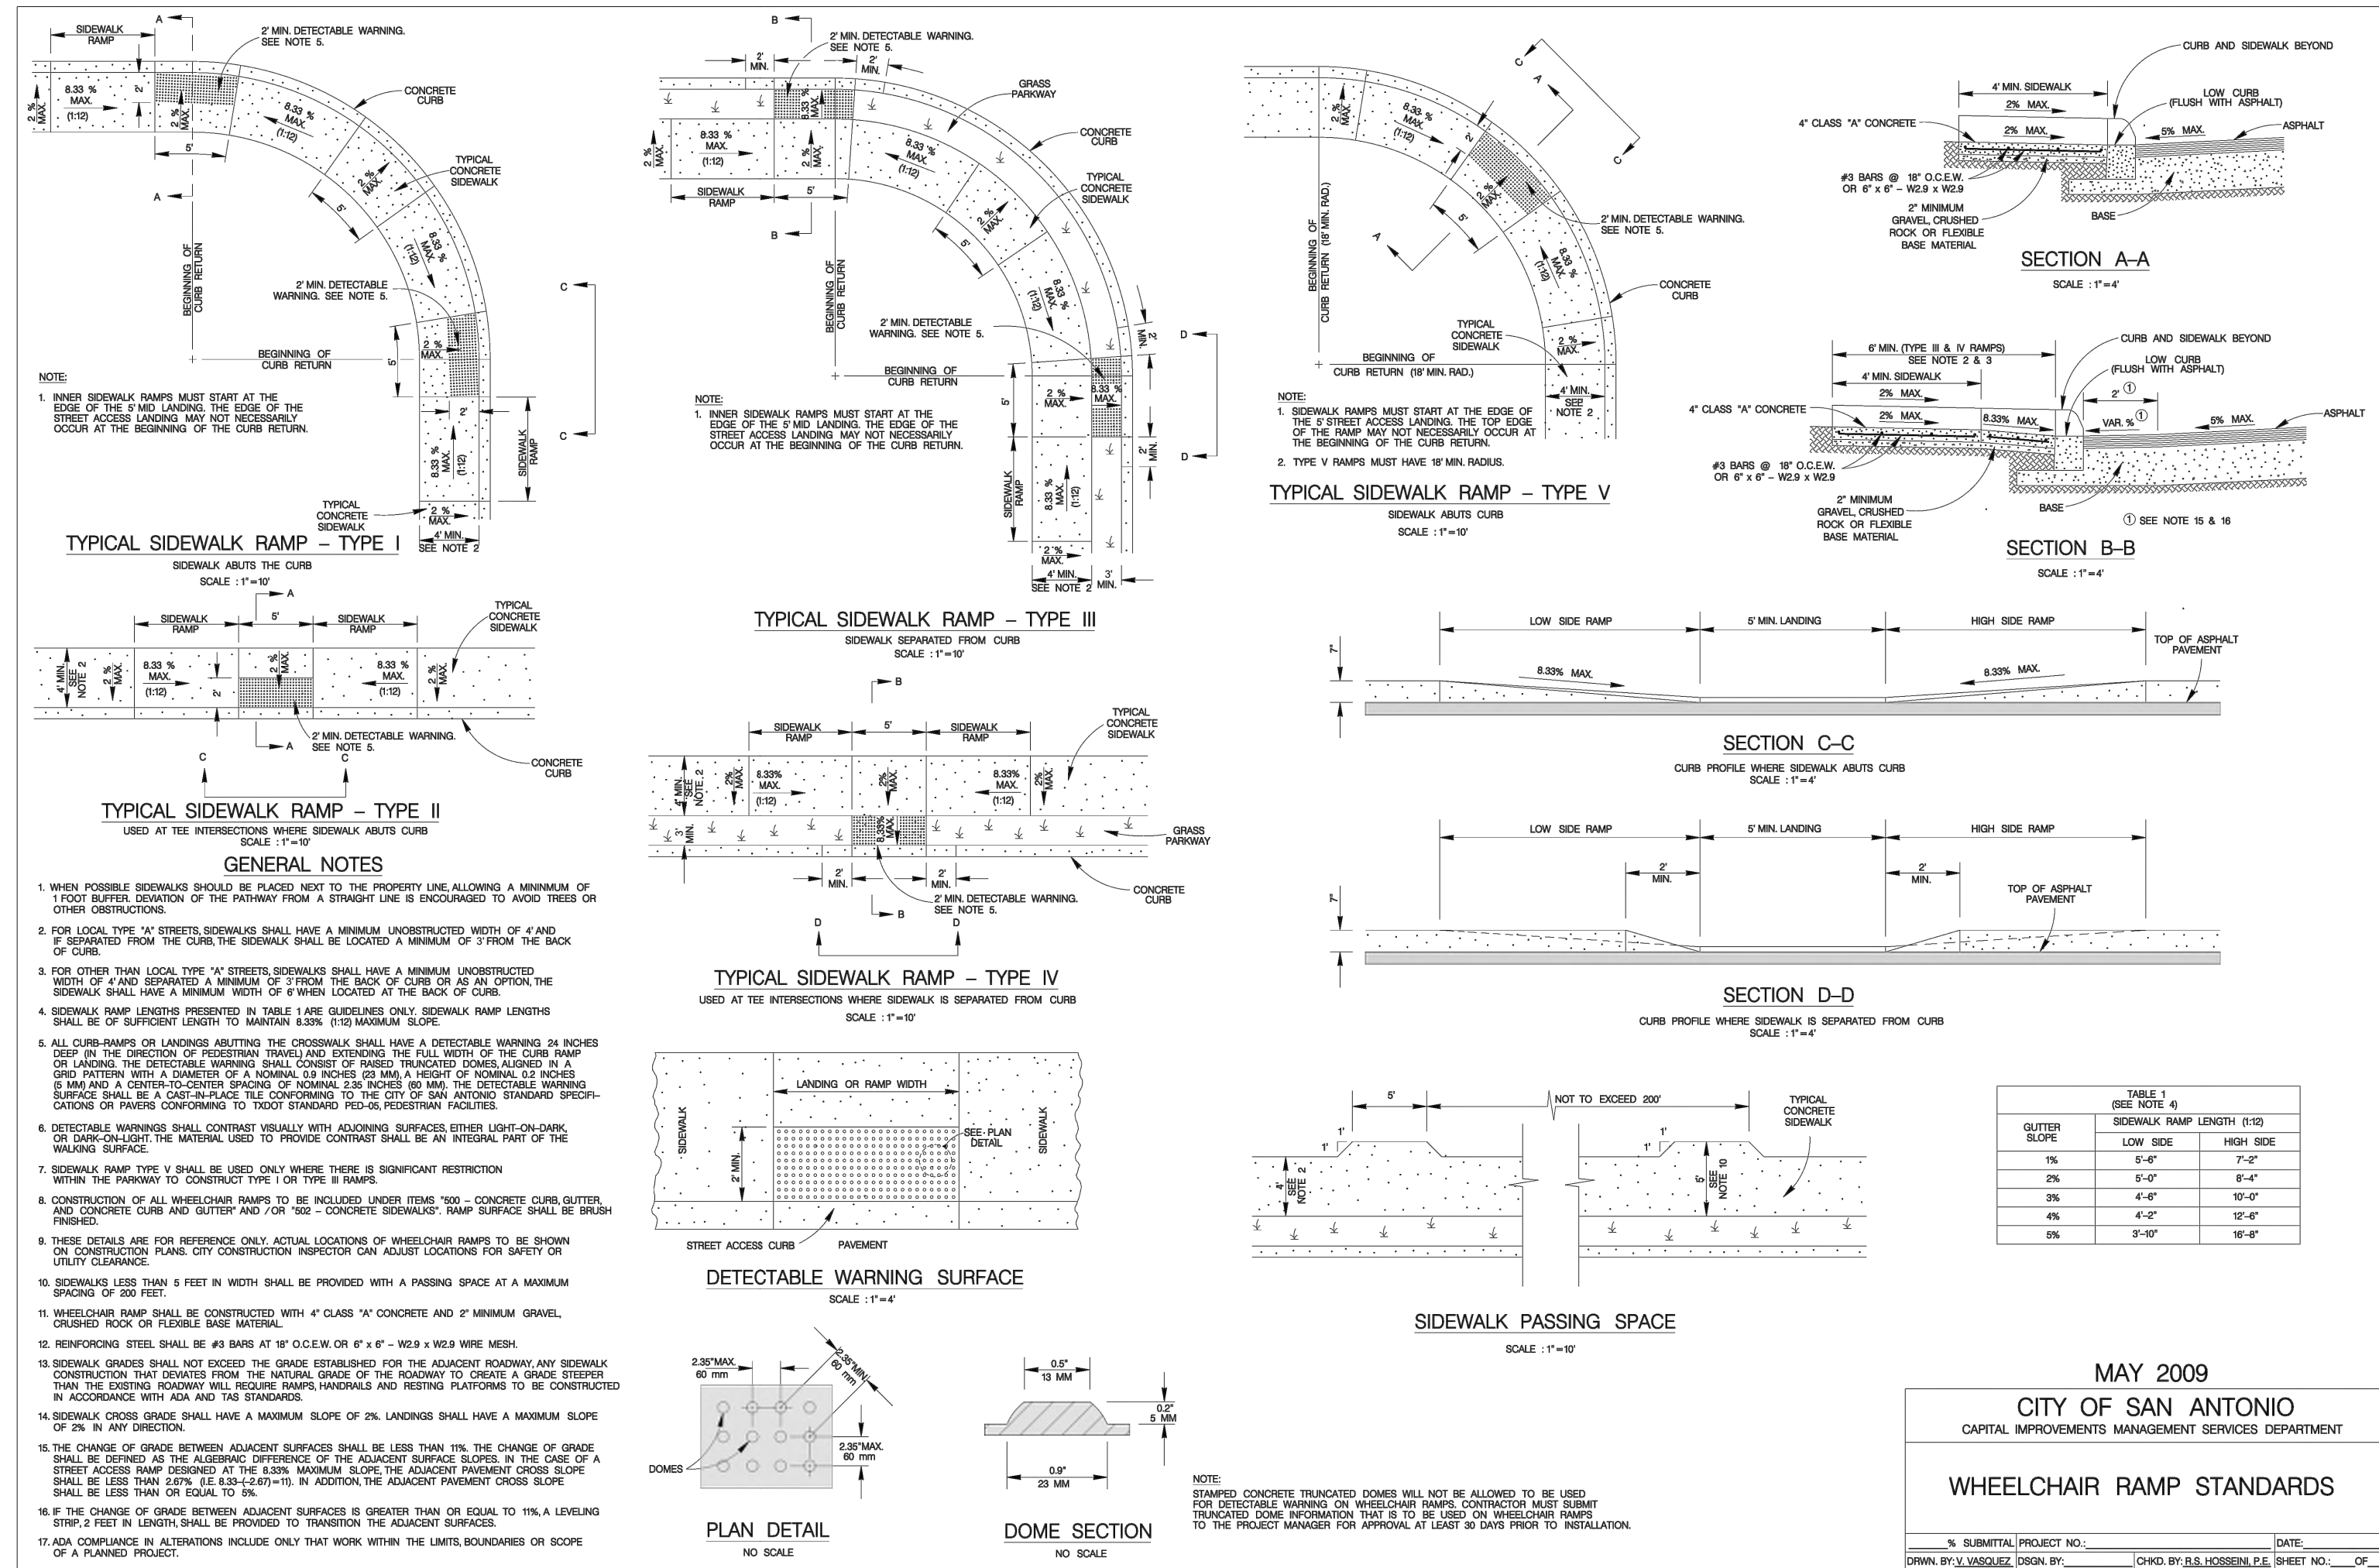




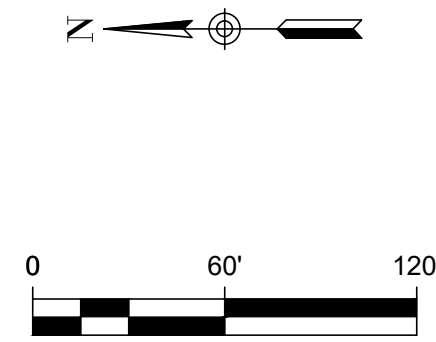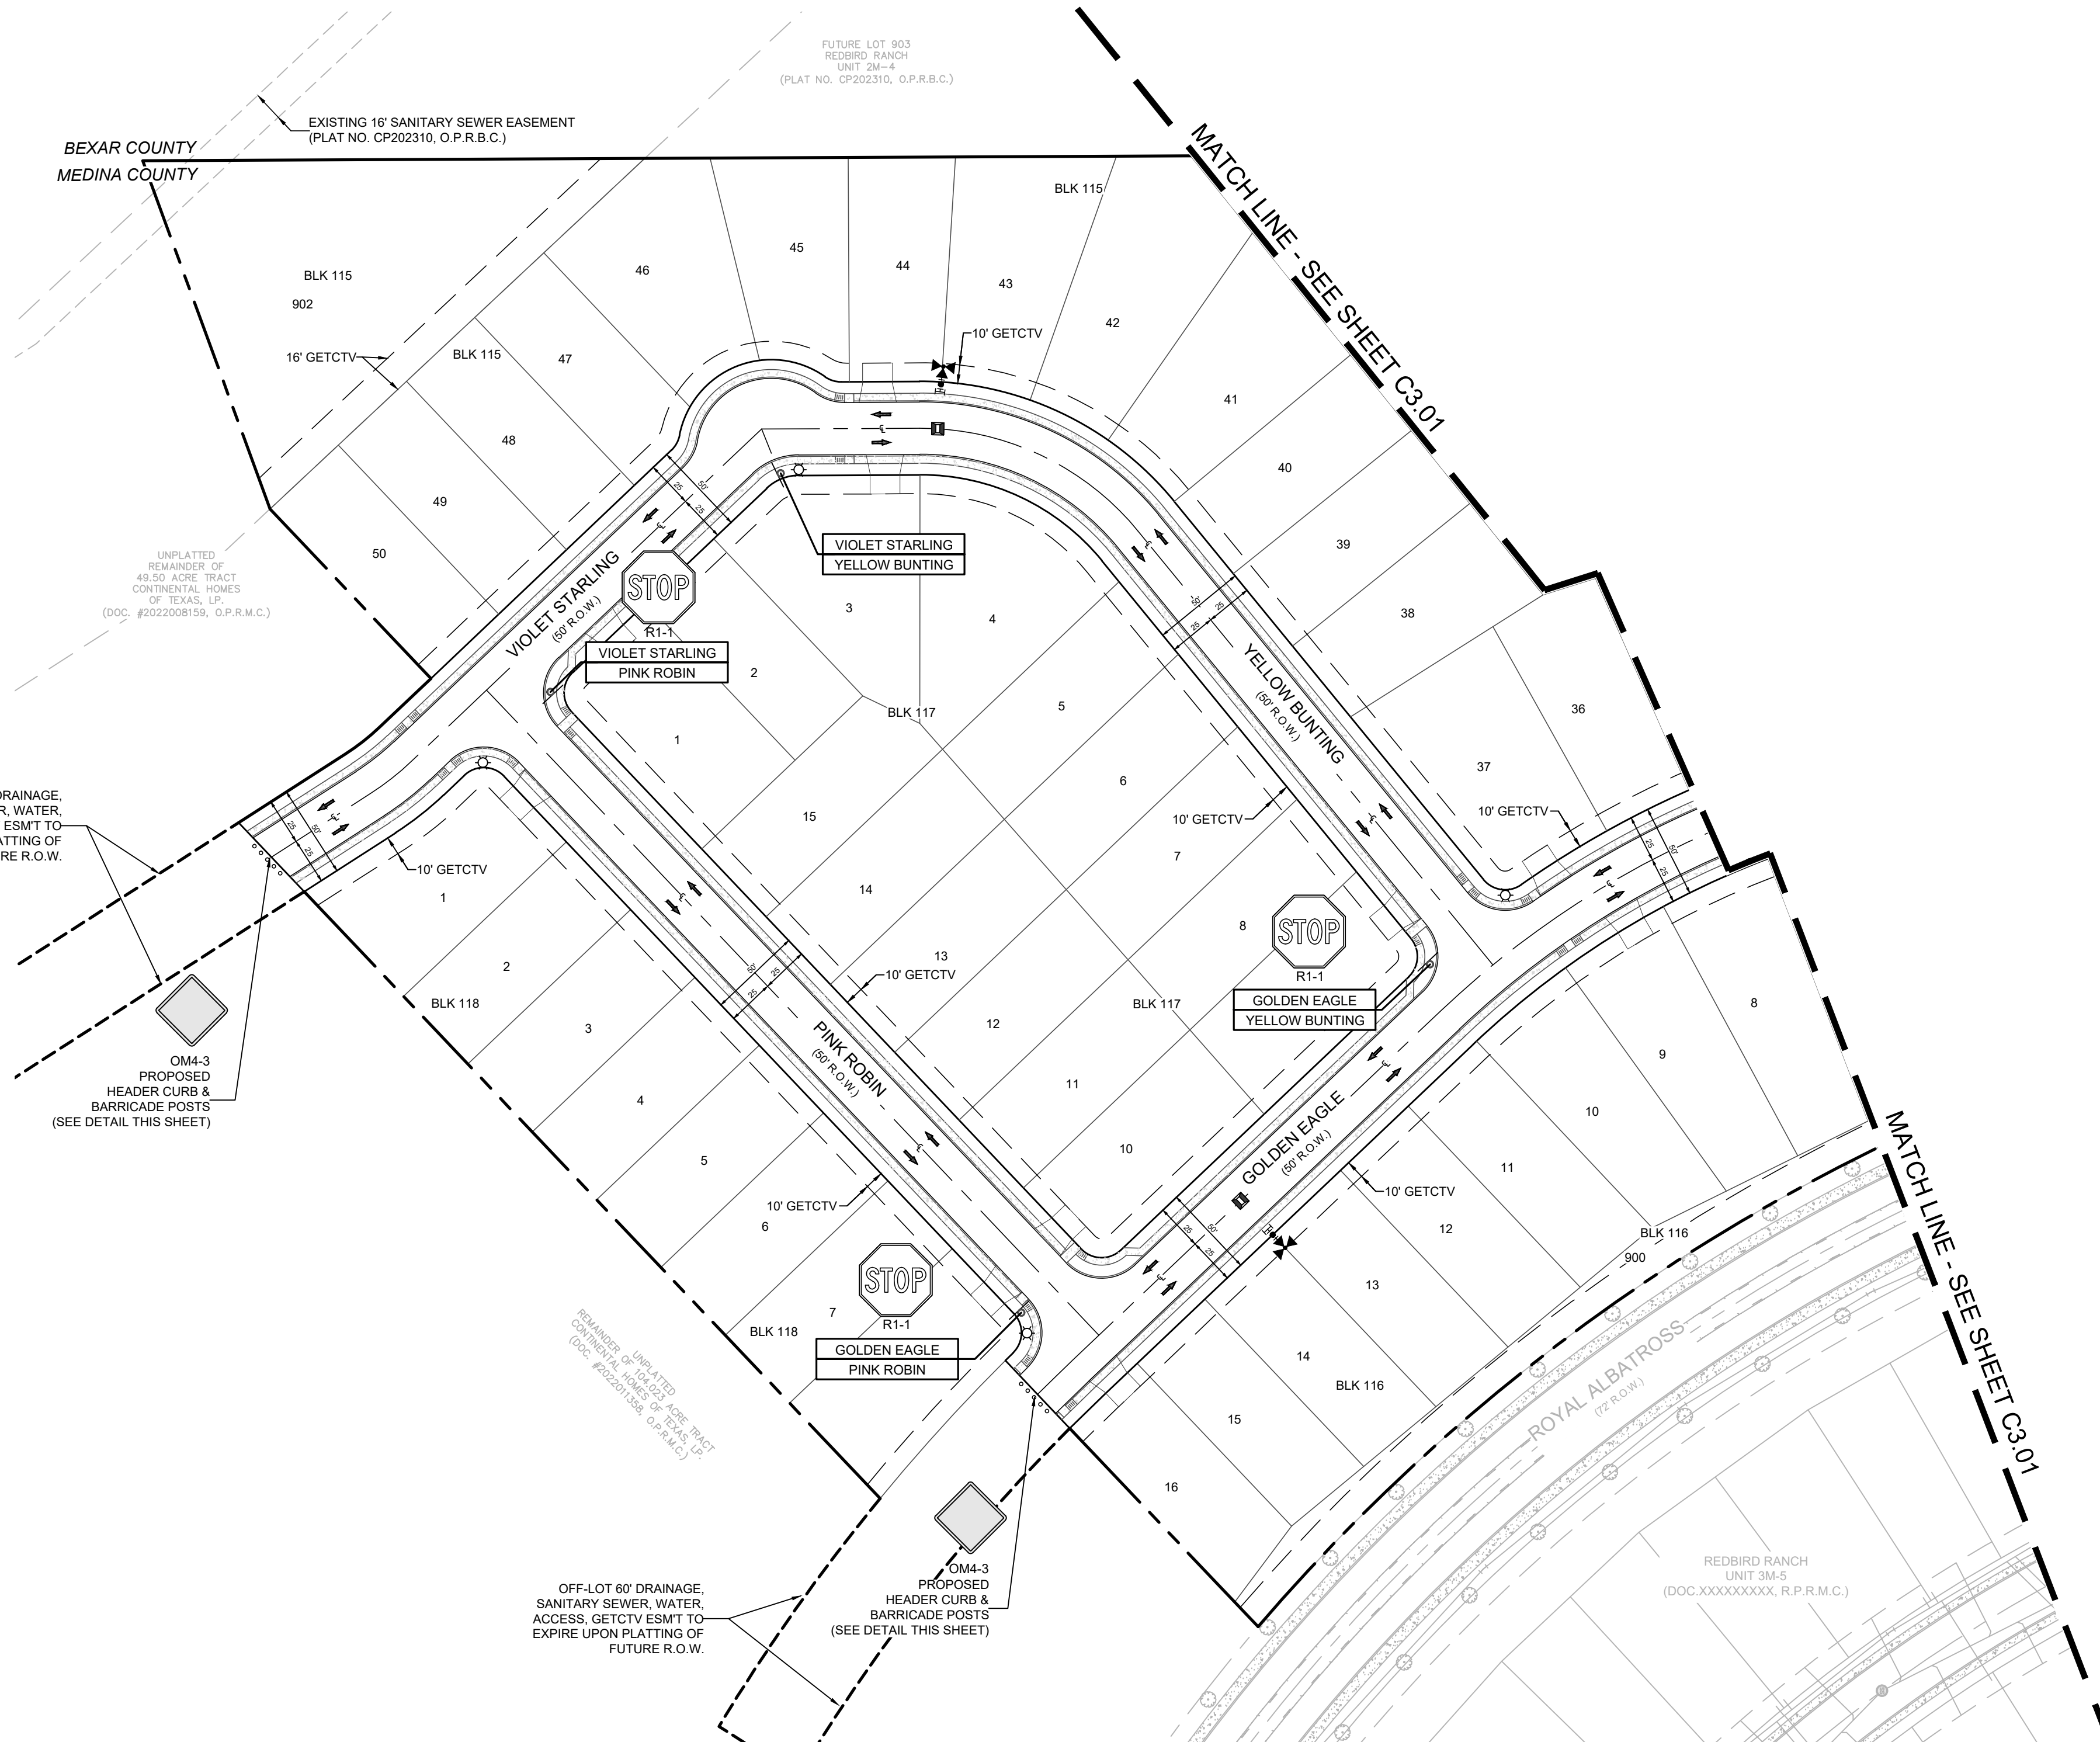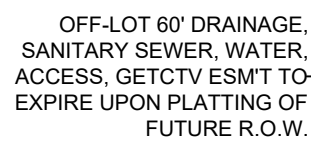





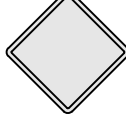


LEGEND (SIGNS)	
	PROJECT LIMITS
	CURB INLET
	STREET NAMES
	SIGN ITEM NO. 531.57
	STOP SIGN (30" X 30")
R1-1	SIGN ITEM NO. 531.3
	TYPE II BLUE PVMT MARKER
	SIDEWALK (DEVELOPER RESPONSIBILITY)
	SIDEWALK (HOMEOWNER RESPONSIBILITY)
	OM4-3 (531.56) END OF ROAD MARKER
	DEAD END STREET MARKER SIGN ITEM NO. 531.58
W14-1a	

**DRIVEWAY NOTE:**  
DRIVEWAYS SHOWN ON THIS PLAN ARE FOR THE SOLE PURPOSE OF INDICATION A POTENTIAL CONFLICT WITH CURB RAMP, DRAINAGE INFRASTRUCTURE, OR OTHER CONFLICT. DRIVEWAY LOCATION IS SUBJECT TO CHANGE BASED ON HOME SELECTION AND FINAL LOT DESIGN.

**CAUTION!!!**

CONTRACTOR SHALL BE REQUIRED TO LOCATE ALL PUBLIC OR PRIVATE UTILITIES INCLUDING BUT NOT LIMITING TO, WATER, SEWER, TELEPHONE AND FIBER OPTIC LINES, SITE LIGHTING ELECTRIC, SECONDARY ELECTRIC, PRIMARY ELECTRICAL AND GAS LINES AND UNDERGROUND UTILITIES. CONTRACTOR SHALL BE RESPONSIBLE FOR ANY CONFLICTS THAT ARISE SHOULD BE COMMUNICATED TO THE ENGINEER IMMEDIATELY AND PRIOR TO CONSTRUCTION. THE CONTRACTOR SHALL CONTACT 1-800-DIG-TESS A MINIMUM OF 48 HOURS PRIOR TO THE START OF CONSTRUCTION. ANY DAMAGE TO EXISTING UTILITIES SHALL BE THE SOLE RESPONSIBILITY OF THE CONTRACTOR AND THE REPAIR SHALL BE AT CONTRACTOR'S EXPENSE WHETHER THE UTILITY IS SHOWN ON THE RECORD SHALL BE AT CONTRACTOR'S EXPENSE OR NOT.

**TRENCH EXCAVATION PROTECTION**

THE CONTRACTOR AND CONTRACTOR'S INDEPENDENTLY RETAINED EMPLOYEE OR TO STRUCTURAL DESIGN, GEOTECHNICAL, SAFETY, EQUIPMENT CONSULTANT, IF ANY, SHALL REVIEW THESE PLANS AND ANY AVAILABLE GEOTECHNICAL INFORMATION AND SHALL BE RESPONSIBLE FOR THE PROTECTION OF ALL EXISTING UTILITIES. CONTRACTOR SHALL IMPLEMENT CONTRACTOR'S TRENCH EXCAVATION SAFETY PROTECTION SYSTEM PROGRAMS AND/OR PROCEDURES FOR THE PROJECT DESCRIBED IN THE CONTRACT DOCUMENTS. THE CONTRACTOR SHALL BE RESPONSIBLE FOR THE DESIGN, INSTALLATION AND PROCEDURES SHALL PROVIDE FOR ADEQUATE TRENCH EXCAVATION SAFETY PROTECTION THAT COMPLY WITH AS A MINIMUM, OSHA STANDARDS FOR TRENCH PROTECTION. CONTRACTOR'S SPECIFIC TRENCH EXCAVATION SAFETY PROGRAMS, RETAINED EMPLOYEE OR SAFETY CONSULTANT SHALL IMPLEMENT A TRENCH SAFETY PROGRAM IN ACCORDANCE WITH OSHA STANDARDS FOR TRENCH EXCAVATION AND THE ACTIVITIES OF INDIVIDUALS WORKING IN AND AROUND TRENCH EXCAVATION.

REDBIRD RANCH UNIT 2M-2  
SAN ANTONIO, TX  
OVERALL SIGNAGE PLAN

DESIGNED BY:	JWS
DRAWN BY:	SQV/JWS
DATE:	3/20/2024
JOB NO.:	05000-200
SHEET NO.	

C3.00



**DHI**









**DHI Engineering, LLC.**  
5419 N. LOOP 1604 EAST  
SAN ANTONIO, TX 78247  
(210) 496-2668 | [dhiengineering.com](http://dhiengineering.com)  
TBP REG. NO. F-19561

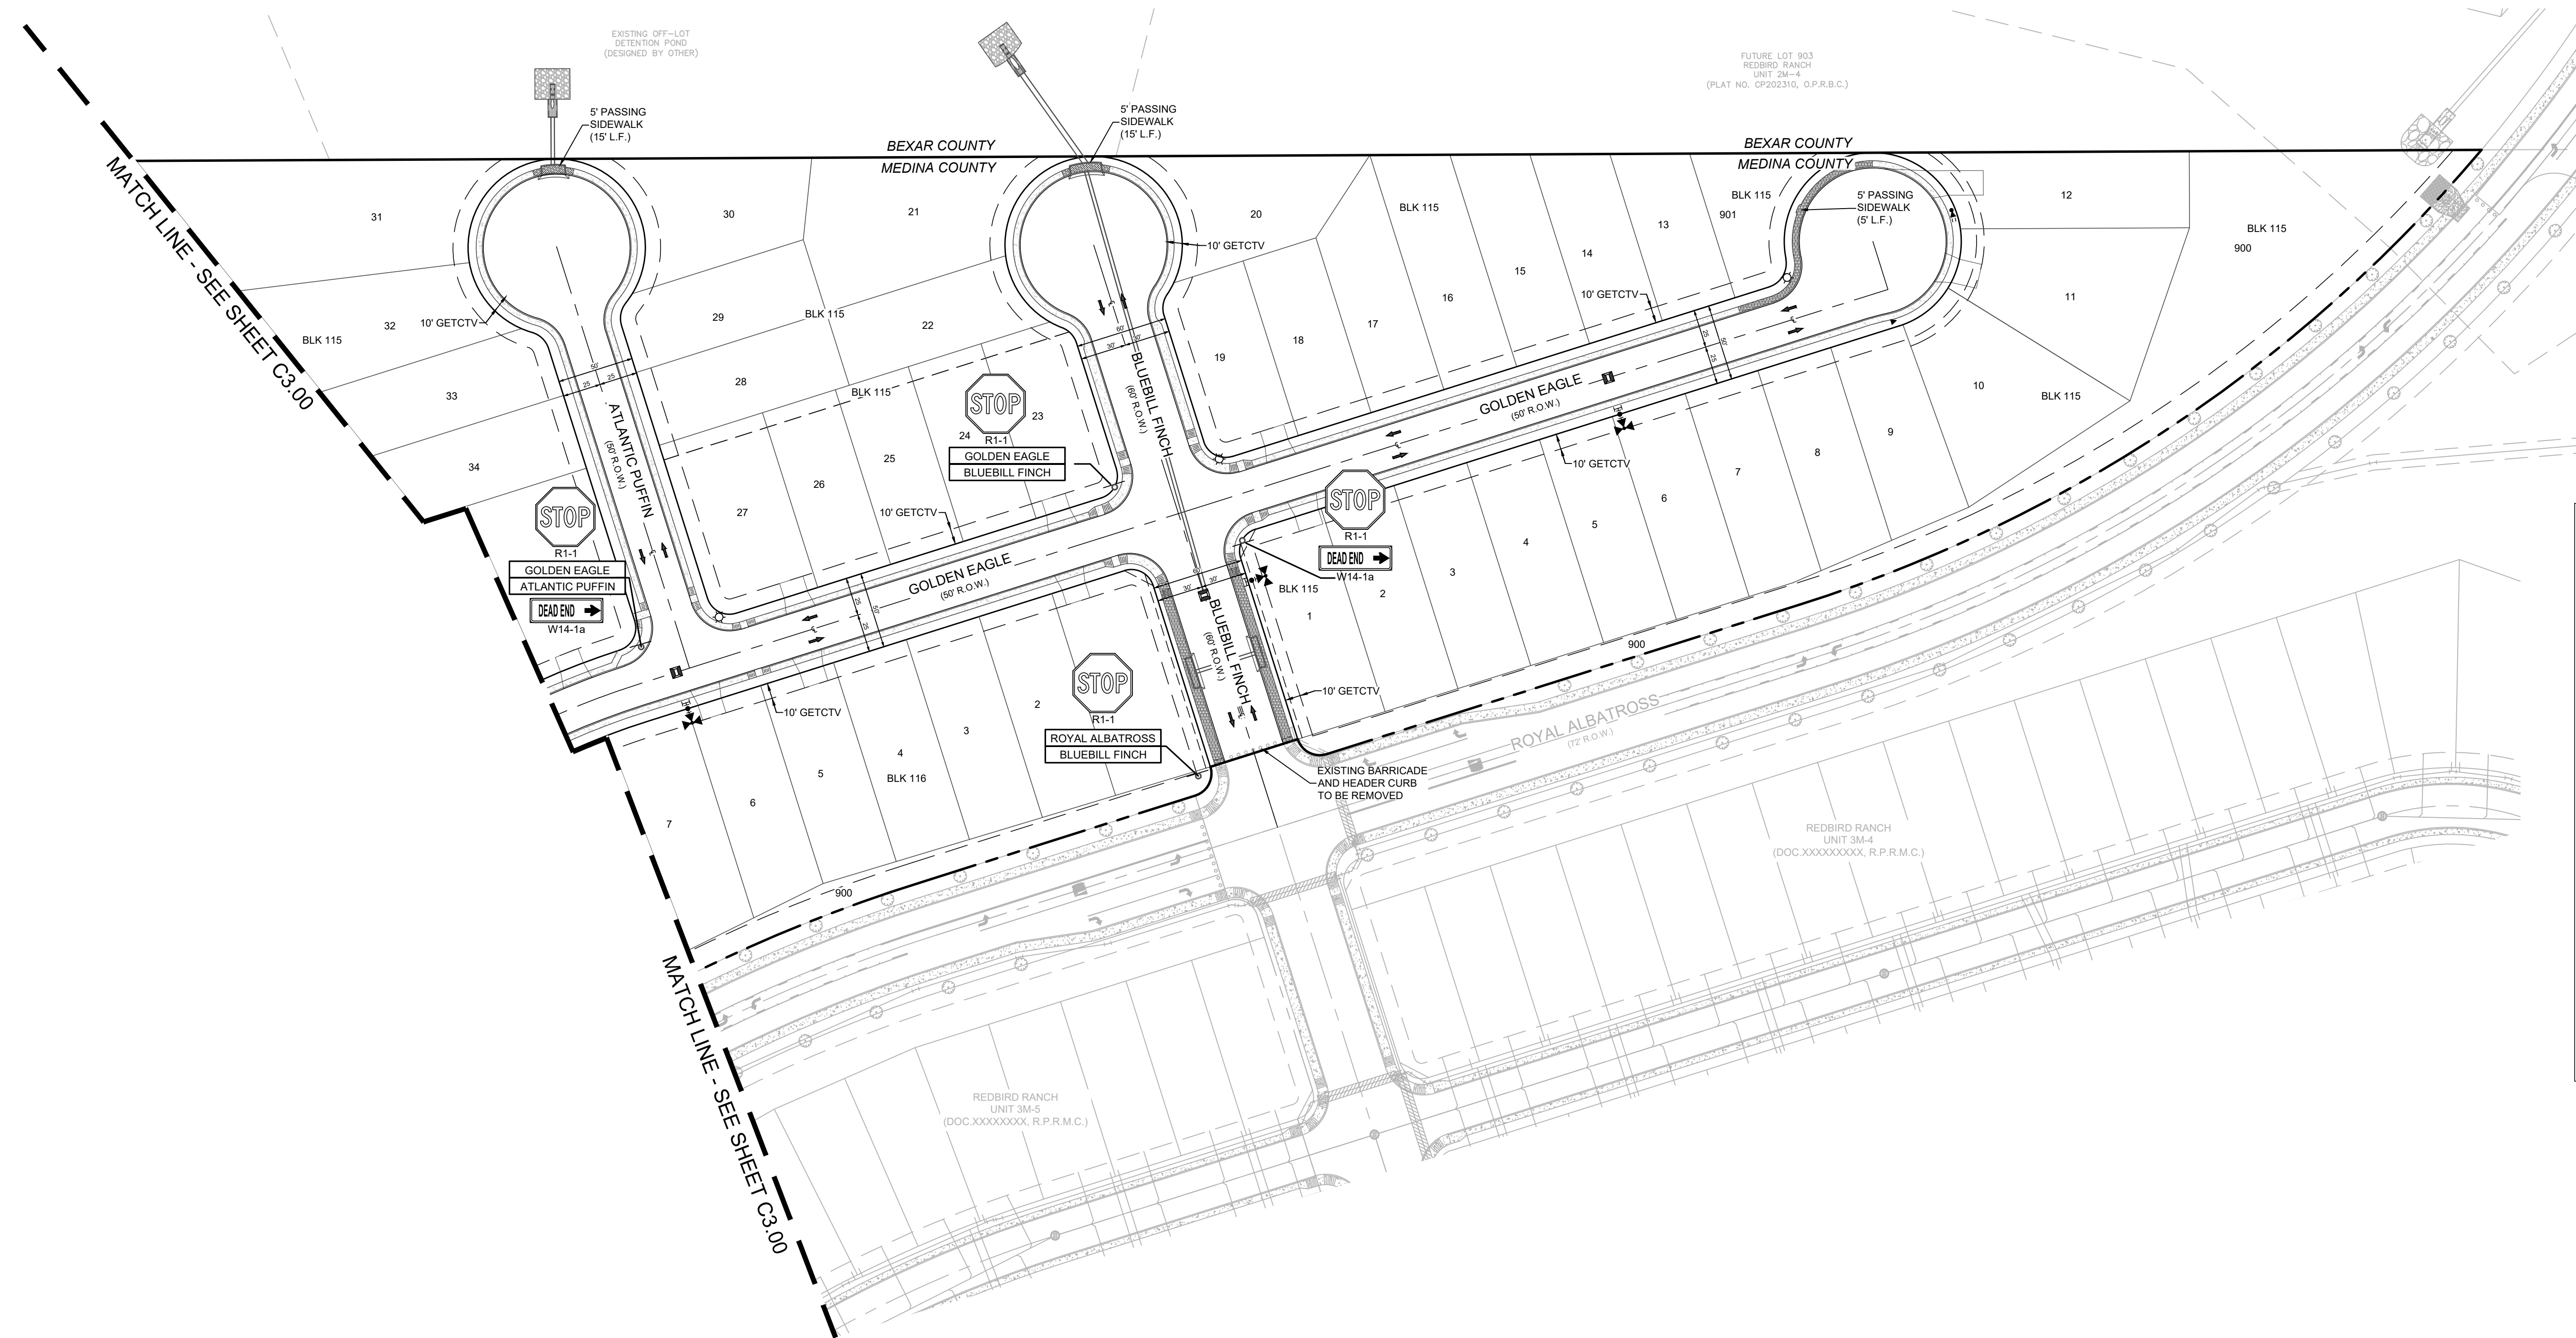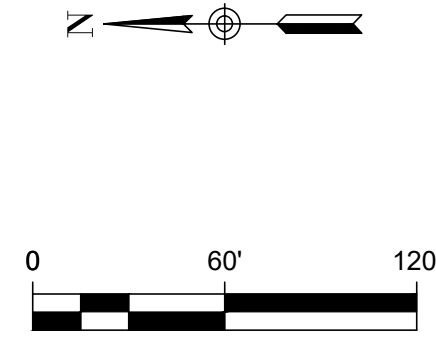[illegible]

Date: Mar 20, 2024, 2:03pm User ID: AMStiller File: \\phorion.com\dev-srv\VEBGROUPS\Engineering\\_PROJECT\05000\2001600 - Design\330 - Sheets\CL00 OVERALL STORAGE PLAN.dwg DOC # XXXXXXXXXXXX REDBIRD RANCH UNIT 2M-2



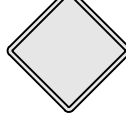

<h1 style="text-align: center; margin: 0;">LEGEND (SIGNS)</h1>	
    <div style="border: 1px solid black; padding: 5px; width: fit-content; margin: 5px auto;">STREET NAME 1</div> <div style="border: 1px solid black; padding: 5px; width: fit-content; margin: 5px auto;">STREET NAME 2</div>   R1-1          <div style="border: 1px solid black; padding: 5px; width: fit-content; margin: 5px auto;"> DEAD END  </div> W14-1a	<p><b>PROJECT LIMITS</b></p> <p><b>CURB INLET</b></p> <p><b>STREET NAMES</b> SIGN ITEM NO. 531.57</p> <p><b>STOP SIGN (30" X 30")</b> SIGN ITEM NO. 531.3</p> <p><b>TYPE II BLUE PVMT MARKER</b></p> <p><b>SIDEWALK (DEVELOPER RESPONSIBILITY)</b></p> <p><b>SIDEWALK (HOMEBUILDER RESPONSIBILITY)</b></p> <p><b>OM4-3 (531.56)</b> <b>END OF ROAD MARKER</b></p> <p><b>DEAD END STREET MARKER</b> SIGN ITEM NO. 531.58</p>

**CAUTION!!!**

CONTRACTOR SHALL BE REQUIRED TO LOCATE ALL PUBLIC OR PRIVATE UTILITIES INCLUDING BUT NOT LIMITING TO: WATER, SEWER, TELEPHONE AND FIBER OPTIC LINES, SITE LIGHTING ELECTRIC, SECONDARY ELECTRIC, PRIMARY ELECTRICAL, DUCTS/CHASES, LANDSCAPE IRRIGATION, GAS LINES, ANY UTILITY CONFLICTS THAT ARISE SHOULD BE COMMUNICATED TO THE ENGINEER IMMEDIATELY AND PRIOR TO CONSTRUCTION. THE CONTRACTOR SHALL CONTACT 1-800-DIG-TEST A MINIMUM OF 48 HOURS PRIOR TO THE START OF CONSTRUCTION. ANY DAMAGE TO EXISTING UTILITIES SHALL BE THE SOLE RESPONSIBILITY OF THE CONTRACTOR AND THE REPAIR SHALL BE AT CONTRACTORS EXPENSE WHETHER THE UTILITY IS SHOWN ON THESE PLANS OR NOT.

**DRIVEWAY NOTE**  
DRIVEWAYS SHOWN ON THIS PLAN ARE FOR THE SOLE PURPOSE OF INDICATION A POTENTIAL CONFLICT WITH EXISTING OR PROPOSED INFRASTRUCTURE, OR OTHER CONFLICT. DRIVEWAY LOCATION IS SUBJECT TO CHANGE BASED ON HOME SLECTION AND FINAL LOT DESIGN.

**TRENCH EXCAVATION PROTECTION**

CONTRACTOR AND CONTRACTOR'S INDEPENDENTLY RETAINED EMPLOYEE, IF ANY, SHALL REVIEW DESIGN AND GEOTECHNICAL SAFETY EQUIPMENT CONSULTANT, IF ANY, SHALL REVIEW THESE PLANS AND ANY AVAILABLE GEOTECHNICAL INFORMATION. THE ANTICIPATED INSTALLATION SITE WITHIN THE PROJECT'S WORK AREA IN ORDER TO IMPLEMENT CONTRACTOR'S TRENCH EXCAVATION SAFETY PROTECTION SYSTEM PROJECT AND AT ALL TIMES THROUGHOUT THE PROJECT. THE CONTRACTOR'S IMPLEMENTATION OF THESE SYSTEMS, PROCEDURES AND PROCEDURES SHALL PROVIDE FOR ADEQUATE TRENCH EXCAVATION SAFETY PROTECTION. THE CONTRACTOR SHALL BE RESPONSIBLE FOR THE SAFETY OF ALL TRENCH EXCAVATIONS SPECIFICALLY, CONTRACTOR AND CONTRACTOR'S INDEPENDENT RETAINED EMPLOYEE OR SAFETY CONSULTANT SHALL IMPLEMENT A TRENCH SAFETY PROTECTION PLAN FOR THE PROJECT. THE CONTRACTOR SHALL BE RESPONSIBLE FOR THE SAFETY OF ALL INDIVIDUALS WORKING IN AND AROUND TRENCH EXCAVATION.

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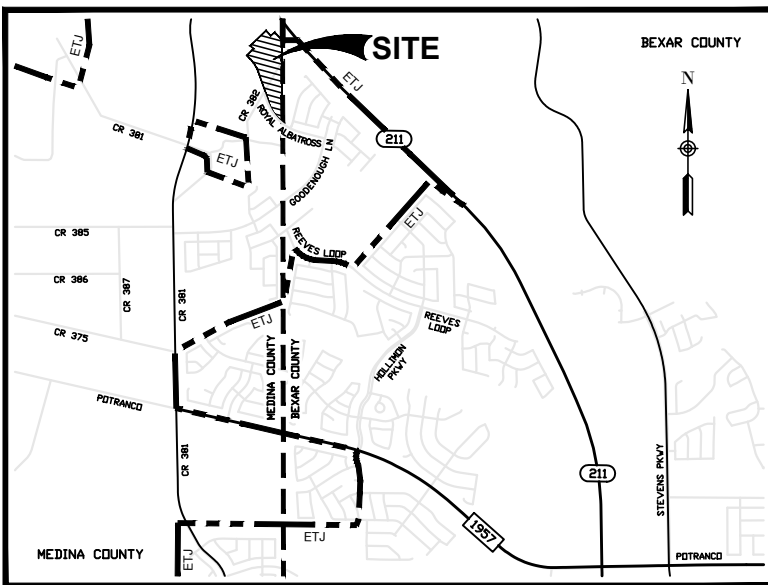









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LOCATION MAP  
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INDEX MAP  
NOT-TO-SCALE



**TRENCH EXCAVATION PROTECTION**

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**CAUTION!!!**
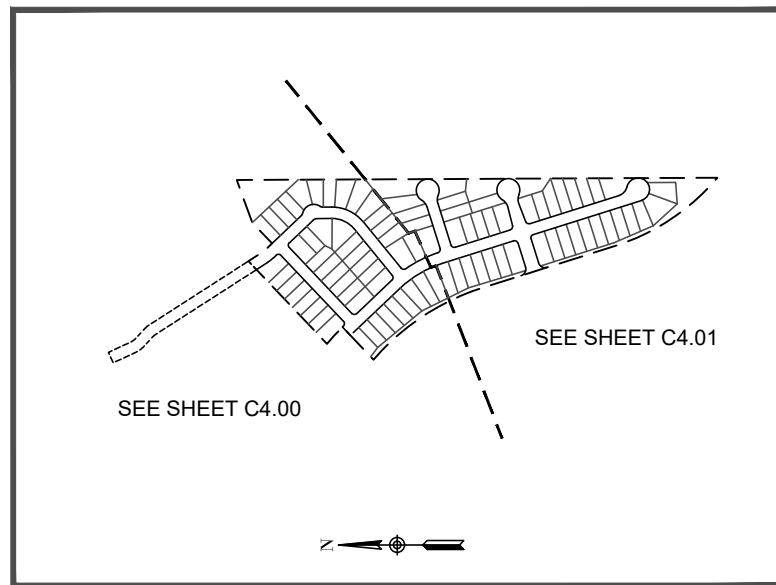
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LEGEND (UTILITY)	
	PROJECT LIMITS
	PROPOSED WATER
	PROPOSED SEWER
	EXISTING WATER
	EXISTING SEWER
	PROPOSED MANHOLE
	EXISTING MANHOLE
	FIRE HYDRANT
	PROPOSED WYE & LATERAL
	SINGLE WATER SERVICE
	DUEL WATER SERVICE
	STREET LIGHT
	GAS, ELECTRIC, TELEPHONE & CABLE TELEVISION EASEMENT
	FINISHED FLOOR ELEVATION FOR SEWER




FOR PLASTIC PIPE ONLY 6" AND SMALLER			
SUBDIVISION (2)	ROW (2)	EQP+10'	EQP+10'
A	36"	36"	60"

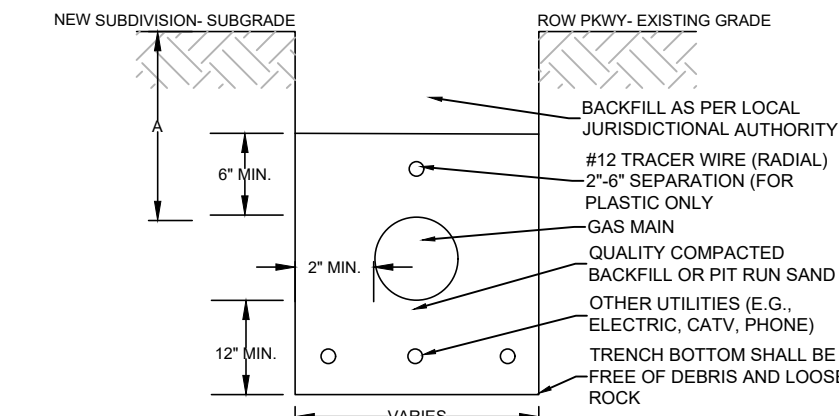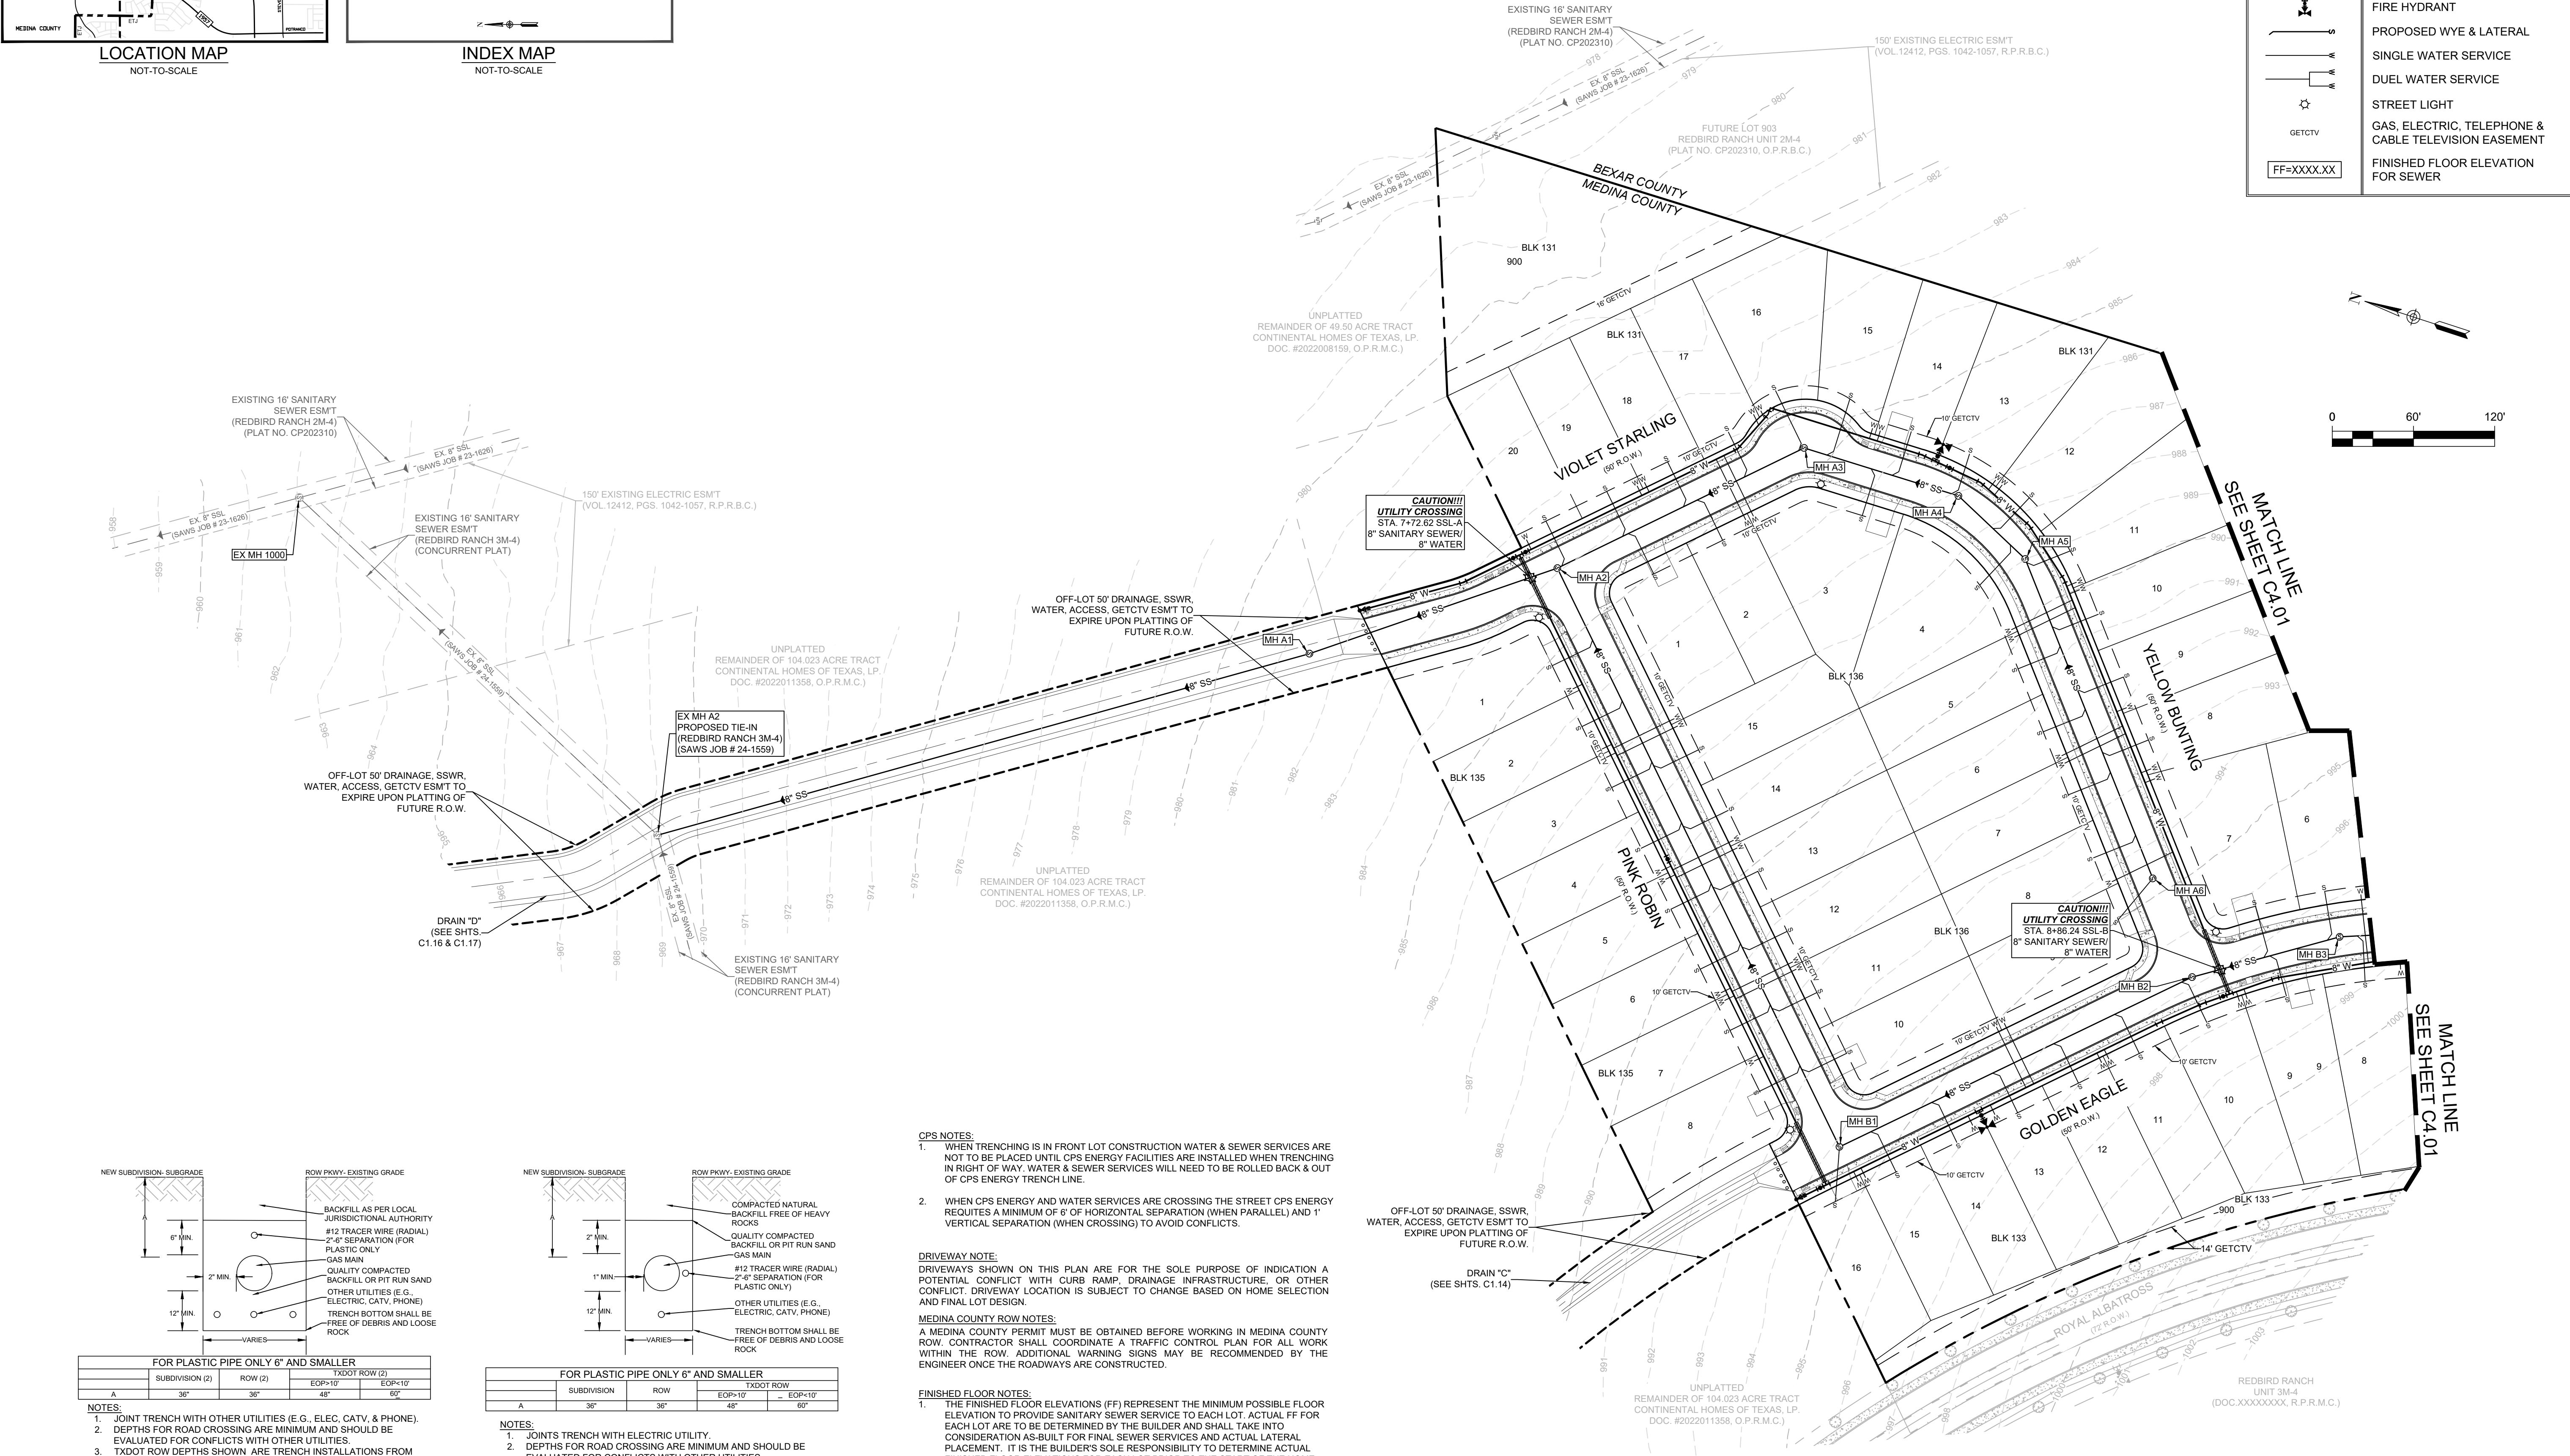- NOTES:
- JOINT TRENCH WITH OTHER UTILITIES (E.G., ELEC. CATV. & PHONE).
  - DEPTHS FOR ROAD CROSSING ARE MINIMUM AND SHOULD BE EVALUATED FOR CONFLICTS WITH OTHER UTILITIES.
  - TXDOT ROW DEPTHS SHOWN ARE TRENCH INSTALLATIONS FROM THE EDGE OF PAVEMENT (EOP) OF STATE ROAD.
  - DIMENSIONS SHOWN FOR PROJECTS IN COSA AND COUNTY ROW SHOULD BE VERIFIED WITH JURISDICTIONAL ENTITY.
  - APPROVED EXCEPTIONS FOR DEPTH REQUIREMENTS MUST BE MADE BY A SUPERVISOR AND BE IN ACCORDANCE WITH HRC REGULATIONS & O&M PROCEDURES. (MINIMUM 2" COVER)

**TRENCHING AND BACKFILL DETAIL OF PLASTIC GAS MAIN CONSTRUCTION**

NOT TO SCALE

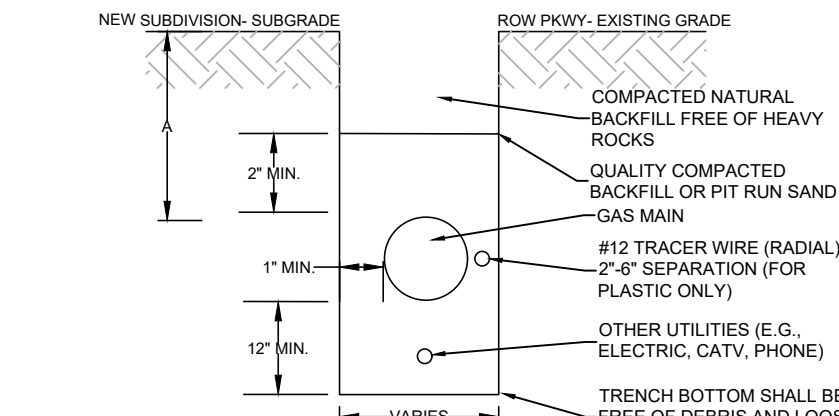

FOR PLASTIC PIPE ONLY 6" AND SMALLER			
SUBDIVISION	ROW	EQP+10'	EQP+10'
A	36"	36"	60"

- NOTES:
- JOINTS TRENCH WITH ELECTRIC UTILITY.
  - DEPTHS FOR ROAD CROSSING ARE MINIMUM AND SHOULD BE EVALUATED FOR CONFLICTS WITH OTHER UTILITIES.
  - TXDOT ROW DEPTHS SHOWN ARE TRENCH INSTALLATIONS FROM THE EDGE OF PAVEMENT (EOP) OF STATE ROAD.
  - DIMENSIONS SHOWN FOR PROJECTS IN COSA AND COUNTY ROW SHOULD BE VERIFIED WITH JURISDICTIONAL ENTITY.
  - SUBDIVISION- INSTALLATION FOR SERVICES FOR NEW SUBDIVISIONS.

**RESIDENTIAL SERVICE JOINT TRENCH & BACKFILL**

NOT TO SCALE

- CPS NOTES:**
- WHEN TRENCHING IS IN FRONT LOT CONSTRUCTION WATER & SEWER SERVICES ARE NOT TO BE PLACED UNTIL CPS ENERGY FACILITIES ARE INSTALLED WHEN TRENCHING IN RIGHT OF WAY. WATER & SEWER SERVICES WILL NEED TO BE ROLLED BACK & OUT OF CPS ENERGY TRENCH LINE.
  - WHEN CPS ENERGY AND WATER SERVICES ARE CROSSING THE STREET CPS ENERGY REQUIRES A MINIMUM OF 6' OF HORIZONTAL SEPARATION (WHEN PARALLEL) AND 1' VERTICAL SEPARATION (WHEN CROSSING) TO AVOID CONFLICTS.

**DRIVEWAY NOTE:**

DRIVEWAYS SHOWN ON THIS PLAN ARE FOR THE SOLE PURPOSE OF INDICATION A POTENTIAL CONFLICT WITH CURB RAMP, DRAINAGE INFRASTRUCTURE, OR OTHER CONFLICT. DRIVEWAY LOCATION IS SUBJECT TO CHANGE BASED ON HOME SELECTION AND FINAL LOT DESIGN.

**MEDINA COUNTY ROW NOTES:**

A MEDINA COUNTY PERMIT MUST BE OBTAINED BEFORE WORKING IN MEDINA COUNTY ROW. CONTRACTOR SHALL COORDINATE A TRAFFIC CONTROL PLAN FOR ALL WORK WITHIN THE ROW. ADDITIONAL WARNING SIGNS MAY BE RECOMMENDED BY THE ENGINEER ONCE THE ROADWAYS ARE CONSTRUCTED.

- FINISHED FLOOR NOTES:**
- THE FINISHED FLOOR ELEVATIONS (FF) REPRESENT THE MINIMUM POSSIBLE FLOOR ELEVATION TO PROVIDE SANITARY SEWER SERVICE TO EACH LOT. ACTUAL FF FOR EACH LOT ARE TO BE DETERMINED BY THE BUILDER AND SHALL TAKE INTO CONSIDERATION AS-BUILT FOR FINAL SEWER SERVICES AND ACTUAL LATERAL PLACEMENT. IT IS THE BUILDER'S SOLE RESPONSIBILITY TO DETERMINE ACTUAL FINISHED FLOOR ELEVATIONS FOR EACH LOT PRIOR TO THE START OF THE HOME FOUNDATION CONSTRUCTION TAKING INTO CONSIDERATION SITE DRAINAGE, STREET ACCESS AND SANITARY SEWER SERVICE ELEVATION.
  - THE MINIMUM SANITARY SEWER LATERAL GRADES WERE BASED UPON THE MINIMUM FINISHED FLOOR ELEVATIONS FOR THE LOTS LOCATED ON THE DOWNHILL SIDES OF THE PROPOSED ROADWAYS.

DEVELOPER'S NAME:	CONTINENTAL HOMES OF TEXAS, L.P.
ADDRESS:	5419 N. LOOP 1604 EAST
CITY:	SAN ANTONIO
STATE:	TEXAS
ZIP:	78247
PHONE #:	(210) 496-2668
FAX #:	(210) 496-2668
SAWS BLOCK MAP #:	062388
TOTAL EDUS:	89
TOTAL ACREAGE:	20.795
TOTAL LINEAR FOOTAGE OF PIPE:	3,625 L.F. (8")
DOC. NO. (MEDINA COUNTY):	
NUMBER OF LOTS:	89
SAWS JOB NO.:	24-1513

REDBIRD RANCH UNIT 2M-2  
SAN ANTONIO, TX  
OVERALL UTILITY PLAN

DESIGNED BY: JWS  
DRAWN BY: SQV/JWS  
DATE: 8/21/2024  
JOB NO.: 05000-200  
SHEET NO. C4.00

8/21/2024  
VANCE L. WEYMAN  
99269  
LICENSED PROFESSIONAL ENGINEER  
T.B.P.E. REG. NO. F-19561


DHI Engineering, LLC.  
5419 N. LOOP 1604 EAST  
SAN ANTONIO, TEXAS 78247  
(210) 496-2668 | dhiengineering.com  
T.B.P.E. REG. NO. F-19561

REDBIRD RANCH UNIT 2M-2  
DOC # XXXXXXXXXX


8/21/2024  
VANCE L. WEYMAN  
99269  
LICENSED PROFESSIONAL ENGINEER  
T.B.P.E. REG. NO. F-19561



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LOCATION MAP  
NOT-TO-SCALE

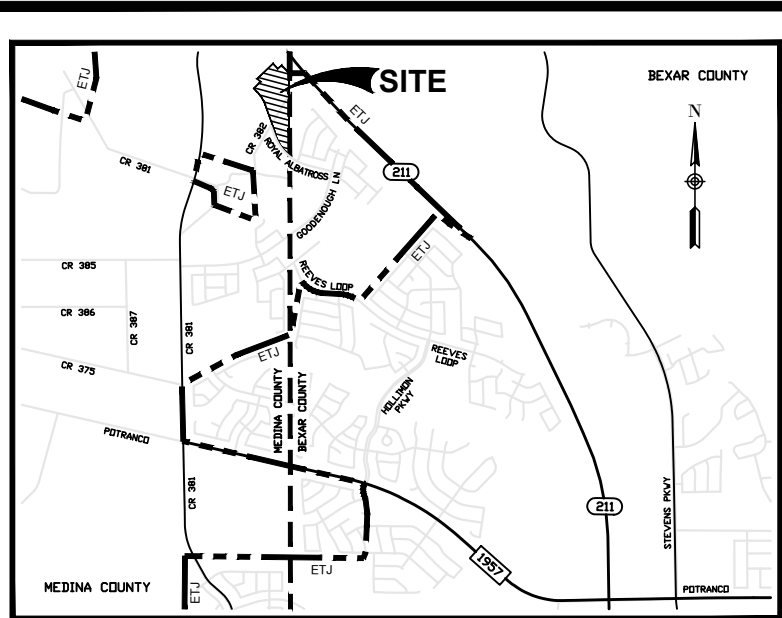

INDEX MAP  
NOT-TO-SCALE

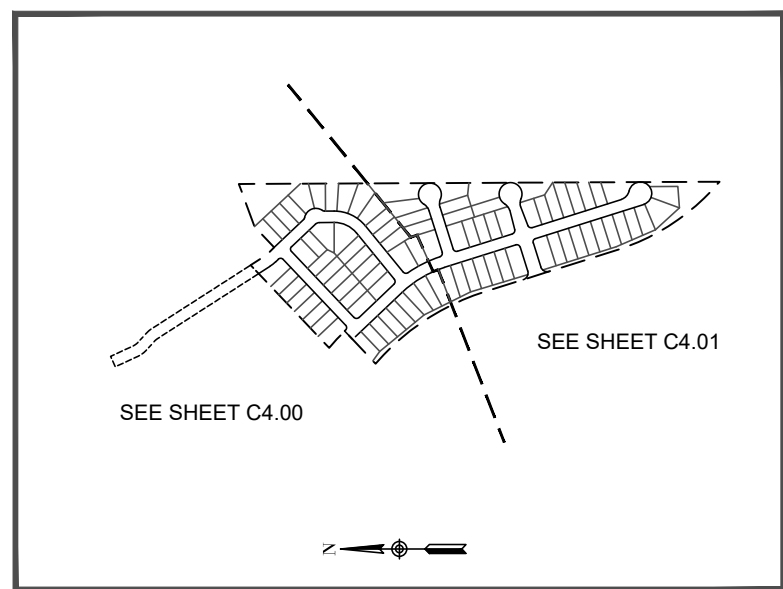FINISHED FLOOR NOTES:

- THE FINISHED FLOOR ELEVATIONS (FF) REPRESENT THE MINIMUM POSSIBLE FLOOR ELEVATION TO PROVIDE SANITARY SEWER SERVICE TO EACH LOT. ACTUAL FF FOR EACH LOT ARE TO BE DETERMINED BY THE BUILDER AND SHALL TAKE INTO CONSIDERATION AS-BUILT FOR FINAL SEWER SERVICES AND ACTUAL LATERAL PLACEMENT. IT IS THE BUILDER'S SOLE RESPONSIBILITY TO DETERMINE ACTUAL FINISHED FLOOR ELEVATIONS FOR EACH LOT PRIOR TO THE START OF THE HOME FOUNDATION CONSTRUCTION TAKING INTO CONSIDERATION SITE DRAINAGE, STREET ACCESS AND SANITARY SEWER SERVICE ELEVATION.
- THE MINIMUM SANITARY SEWER LATERAL GRADES WERE BASED UPON THE MINIMUM FINISHED FLOOR ELEVATIONS FOR THE LOTS LOCATED ON THE DOWNHILL SIDES OF THE PROPOSED ROADWAYS.

CPS NOTES:

- WHEN TRENCHING IS IN FRONT LOT CONSTRUCTION WATER & SEWER SERVICES ARE NOT TO BE PLACED UNTIL CPS ENERGY FACILITIES ARE INSTALLED WHEN TRENCHING IN RIGHT OF WAY. WATER & SEWER SERVICES WILL NEED TO BE ROLLED BACK & OUT OF CPS ENERGY TRENCH LINE.
- WHEN CPS ENERGY AND WATER SERVICES ARE CROSSING THE STREET CPS ENERGY REQUIRES A MINIMUM OF 6" OF HORIZONTAL SEPARATION (WHEN PARALLEL) AND 1' VERTICAL SEPARATION (WHEN CROSSING) TO AVOID CONFLICTS.

DRIVEWAY NOTE:



A MEDINA COUNTY PERMIT MUST BE OBTAINED BEFORE WORKING IN MEDINA COUNTY ROW. CONTRACTOR SHALL COORDINATE A TRAFFIC CONTROL PLAN FOR ALL WORK WITHIN THE ROW. ADDITIONAL WARNING SIGNS MAY BE RECOMMENDED BY THE ENGINEER ONCE THE ROADWAYS ARE CONSTRUCTED.

MEDINA COUNTY ROW NOTES:

A MEDINA COUNTY PERMIT MUST BE OBTAINED BEFORE WORKING IN MEDINA COUNTY ROW. CONTRACTOR SHALL COORDINATE A TRAFFIC CONTROL PLAN FOR ALL WORK WITHIN THE ROW. ADDITIONAL WARNING SIGNS MAY BE RECOMMENDED BY THE ENGINEER ONCE THE ROADWAYS ARE CONSTRUCTED.

LEGEND (UTILITY)

---	PROJECT LIMITS
---	PROPOSED WATER
---	PROPOSED SEWER
---	EXISTING WATER
---	EXISTING SEWER
⊙	PROPOSED MANHOLE
⊙	EXISTING MANHOLE
⊙	FIRE HYDRANT
---	PROPOSED WYE & LATERAL
---	SINGLE WATER SERVICE
---	DUEL WATER SERVICE
⊙	STREET LIGHT
⊙	GAS, ELECTRIC, TELEPHONE & CABLE TELEVISION EASEMENT
FF=XXXX.XX	FINISHED FLOOR ELEVATION FOR SEWER

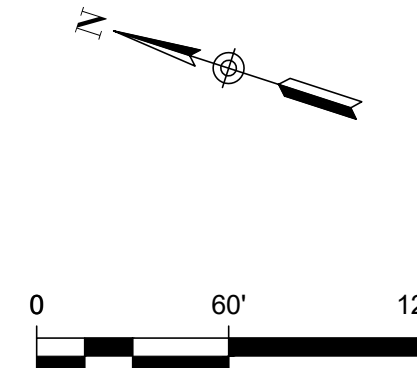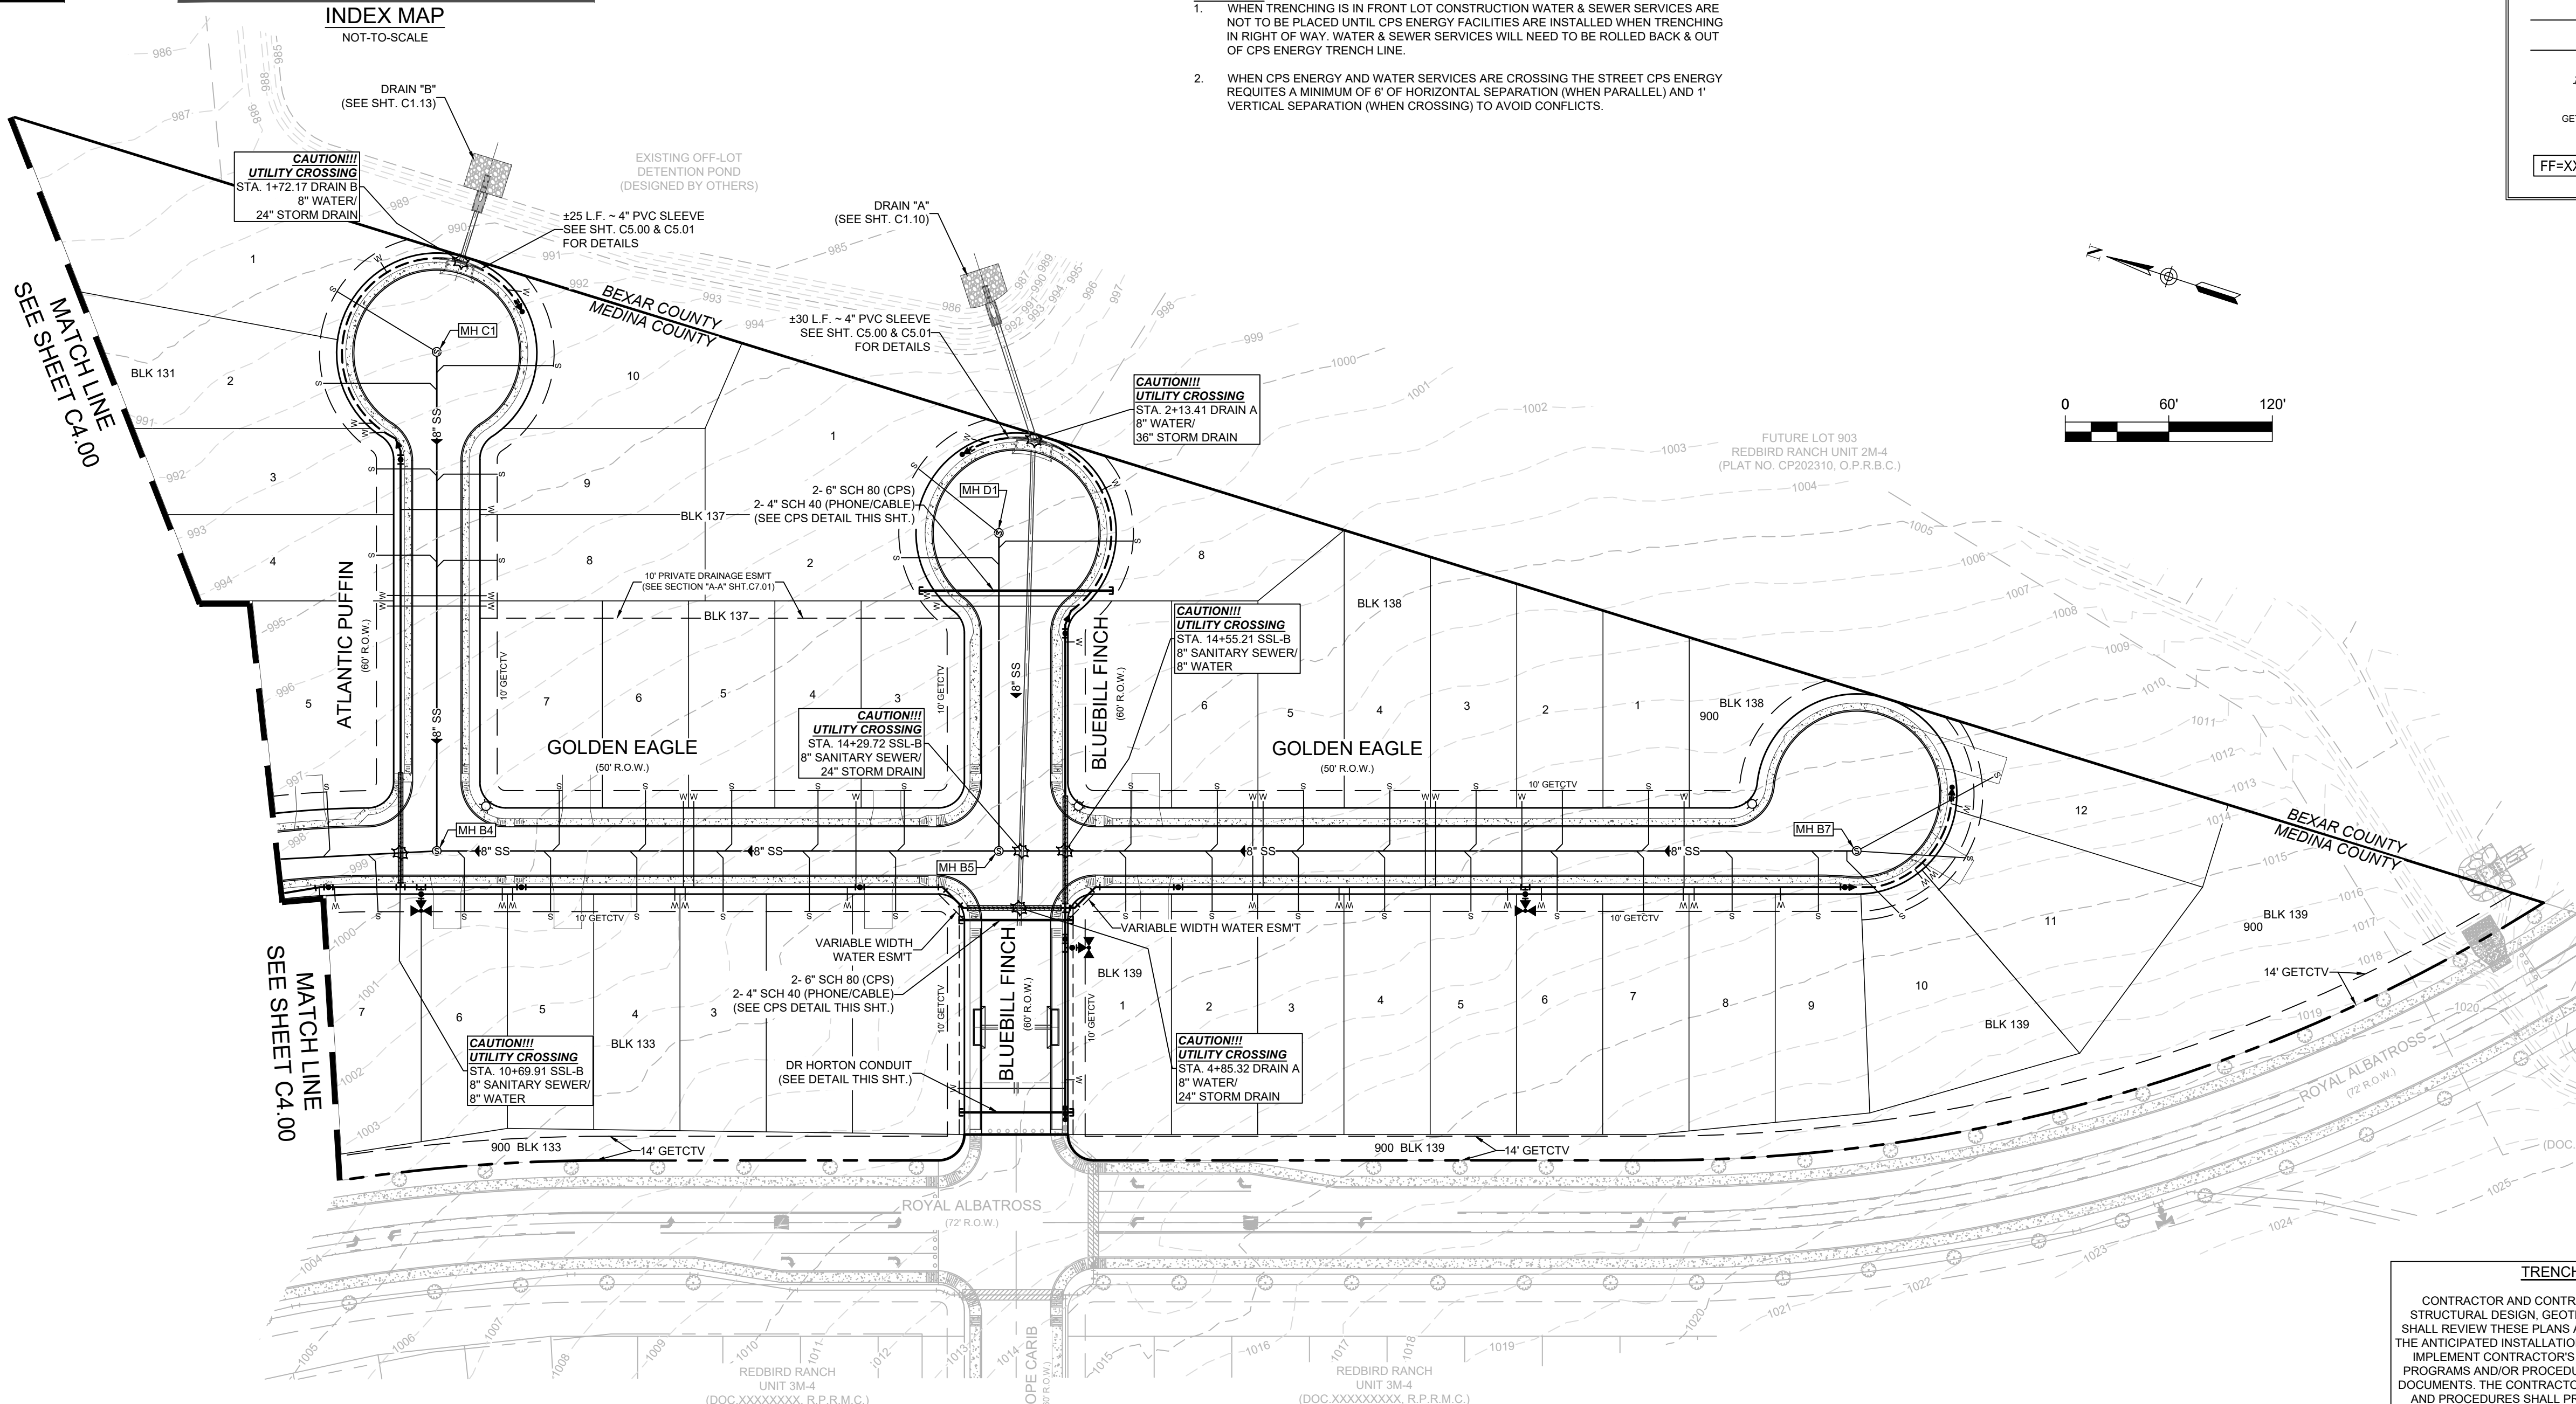


TRENCH EXCAVATION PROTECTION

CONTRACTOR AND CONTRACTOR'S INDEPENDENTLY RETAINED EMPLOYEE OR STRUCTURAL DESIGN, GEOTECHNICAL, SAFETY, EQUIPMENT CONSULTANT, IF ANY, SHALL REVIEW THESE PLANS AND ANY AVAILABLE GEOTECHNICAL INFORMATION AND THE ANTICIPATED INSTALLATION SITE WITHIN THE PROJECT'S WORK AREA IN ORDER TO IMPLEMENT CONTRACTOR'S TRENCH EXCAVATION SAFETY PROTECTION SYSTEM. PROGRAMS AND/OR PROCEDURES FOR THE PROJECT DESCRIBED IN THE CONTRACT DOCUMENTS. THE CONTRACTOR'S IMPLEMENTATION OF THESE SYSTEMS, PROGRAMS, AND PROCEDURES SHALL PROVIDE FOR ADEQUATE TRENCH EXCAVATION SAFETY PROTECTION THAT COMPLY WITH AS A MINIMUM, OSHA STANDARDS FOR TRENCH EXCAVATIONS SPECIFICALLY, CONTRACTOR AND CONTRACTOR'S INDEPENDENTLY RETAINED EMPLOYEE OR SAFETY CONSULTANT SHALL IMPLEMENT A TRENCH SAFETY PROGRAM IN ACCORDANCE WITH OSHA STANDARDS GOVERNING THE PRESENCE AND ACTIVITIES OF INDIVIDUALS WORKING IN AND AROUND TRENCH EXCAVATION.

CAUTION!!!

CONTRACTOR SHALL BE REQUIRED TO LOCATE ALL PUBLIC OR PRIVATE UTILITIES INCLUDING BUT NOT LIMITING TO: WATER, SEWER, TELEPHONE AND FIBER OPTIC LINES, SITE LIGHTING ELECTRIC, SECONDARY ELECTRIC, PRIMARY ELECTRICAL DUCTBANKS, LANDSCAPE IRRIGATION FACILITIES, AND GAS LINES. ANY UTILITY CONFLICTS THAT ARISE SHOULD BE COMMUNICATED TO THE ENGINEER IMMEDIATELY AND PRIOR TO CONSTRUCTION. THE CONTRACTOR SHALL CONTACT 1-800-DIG-TESS A MINIMUM OF 48 HOURS PRIOR TO THE START OF CONSTRUCTION. ANY DAMAGE TO EXISTING UTILITIES SHALL BE THE SOLE RESPONSIBILITY OF THE CONTRACTOR AND THE REPAIR SHALL BE AT CONTRACTOR'S EXPENSE WHETHER THE UTILITY IS SHOWN ON THESE PLANS OR NOT.

DEVELOPER'S NAME:	CONTINENTAL HOMES OF TEXAS, L.P.
ADDRESS:	5419 N. LOOP 1604 EAST
CITY:	SAN ANTONIO
STATE:	TEXAS
ZIP:	78247
PHONE #:	(210) 496-2668
FAX #:	(210) 496-2668
SAWS BLOCK MAP #:	062586
TOTAL EDUS:	89
TOTAL ACREAGE:	20.795
TOTAL LINEAR FOOTAGE OF PIPE:	3,625 L.F. (8')
DOC. NO. (MEDINA COUNTY):	
NUMBER OF LOTS:	89
SAWS JOB NO.:	24-1513

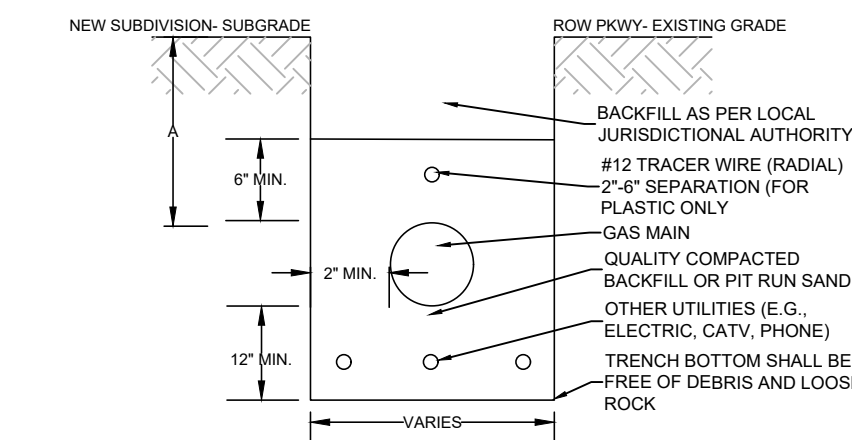


FOR PLASTIC PIPE ONLY 6" AND SMALLER			
SUBDIVISION (2)	ROW (2)	TXDOT ROW (2)	EOP<10' / 60'
A	36'	36'	48'

- NOTES:
- JOINT TRENCH WITH OTHER UTILITIES (E.G., ELEC, CATV, & PHONE).
  - DEPTHS FOR ROAD CROSSING ARE MINIMUM AND SHOULD BE EVALUATED FOR CONFLICTS WITH OTHER UTILITIES.
  - TXDOT ROW DEPTHS SHOWN ARE TRENCH INSTALLATIONS FROM THE EDGE OF PAVEMENT (EOP) OF STATE ROAD.
  - DIMENSIONS SHOWN FOR PROJECTS IN COSA AND COUNTY ROW SHOULD BE VERIFIED WITH JURISDICTIONAL ENTITY.
  - APPROVED EXCEPTIONS FOR DEPTH REQUIREMENTS MUST BE MADE BY A SUPERVISOR AND BE IN ACCORDANCE WITH RRC REGULATIONS & O&M PROCEDURES. (MINIMUM 2' IF COVER)

TRENCHING AND BACKFILL DETAIL OF PLASTIC GAS MAIN CONSTRUCTION

NOT TO SCALE

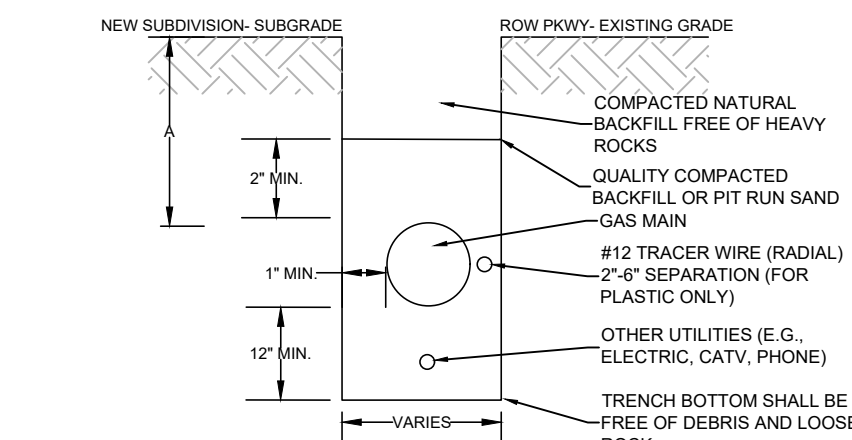


FOR PLASTIC PIPE ONLY 6" AND SMALLER			
SUBDIVISION	ROW	TXDOT ROW	EOP<10' / 60'
A	36'	36'	48'

- NOTES:
- JOINTS TRENCH WITH ELECTRIC UTILITY.
  - DEPTHS FOR ROAD CROSSING ARE MINIMUM AND SHOULD BE EVALUATED FOR CONFLICTS WITH OTHER UTILITIES.
  - TXDOT ROW DEPTHS SHOWN ARE TRENCH INSTALLATIONS FROM THE EDGE OF PAVEMENT (EOP) OF STATE ROAD.
  - DIMENSIONS SHOWN FOR PROJECTS IN COSA AND COUNTY ROW SHOULD BE VERIFIED WITH JURISDICTIONAL ENTITY.
  - SUBDIVISION: INSTALLATION FOR SERVICES FOR NEW SUBDIVISIONS.

RESIDENTIAL SERVICE JOINT TRENCH & BACKFILL

NOT TO SCALE

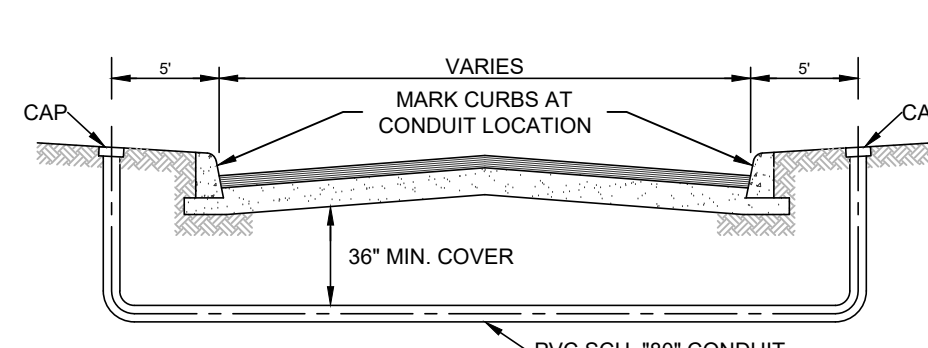

TYPICAL CONDUIT DETAIL (CPS)

NOT TO SCALE


NOTES:

CONTRACTOR SHALL INSTALL PERMANENT MARKERS IN PROPOSED CURB WHERE CONDUIT CROSS THE ROADWAY (BOTH SIDES).

ALL CONDUIT SHALL BE P.V.C. SCHEDULE 80 WITH MINIMUM BURY OF 30 INCHES.

ALL CONDUIT SHALL BE EXTENDED BEHIND CURBS OR PROPOSED SIDEWALKS A MINIMUM OF 3 FEET AND CAPPED FOR FUTURE USE.

A NYLON "PULL STRING" SHALL BE LEFT IN PLACE IN ALL CONDUITS AFTER FINAL ACCEPTANCE OF CONDUIT WORK. THE NYLON "PULL STRING" SHALL HAVE A MINIMUM TENSILE STRENGTH OF 100 LBS.

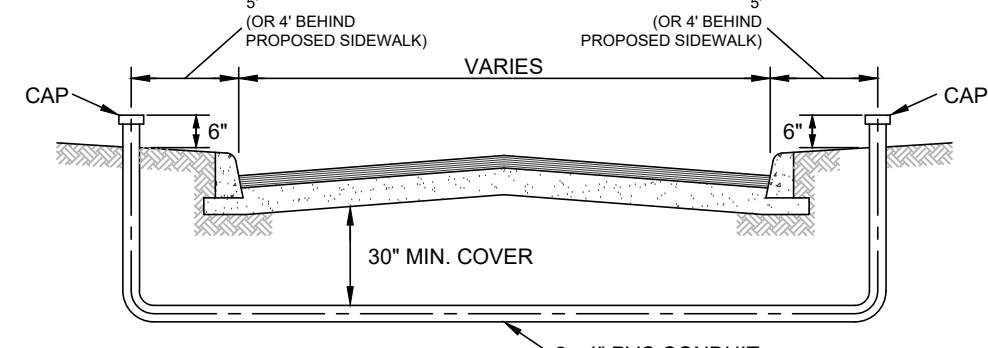

TYPICAL CONDUIT DETAIL (D.R. HORTON)

NOT TO SCALE

NOTE:

IN ADDITION TO ANY CONDUIT REQUIRED FOR CPS, AT&T, AND/OR SPECTRUM CABLE UTILITY CROSSINGS, D.R. HORTON REQUIRES THE FOLLOWING CONDUITS TO BE INSTALLED AT ALL STREET CROSSINGS:

1. 2 - 4" P.V.C. SCHEDULE 40 CONDUITS, GRAY WITH LONG SWEEPS, UNLESS OTHERWISE NOTED.

REDBIRD RANCH UNIT 2M-2  
SAN ANTONIO, TX  
OVERALL UTILITY PLAN

DESIGNED BY: JWS  
DRAWN BY: SQV/JWS  
DATE: 8/21/2024  
JOB NO.: 05000-200  
SHEET NO. C4.01

DHI Engineering, LLC.  
4419 N. LOOP 1604 EAST  
SAN ANTONIO, TEXAS 78247  
(210) 496-2668 | dhiengineering.com  
TBP REG. NO. F-19561

DHI


Vance Weyand  
Professional Engineer  
No. 99269  
State of Texas

Doc: Aug 21, 2024, 2:56pm User: S:\DW\Proj\105000\200\0500 - Design\3430 - Sheet C4.01 OVERALL UTILITY PLAN.dwg


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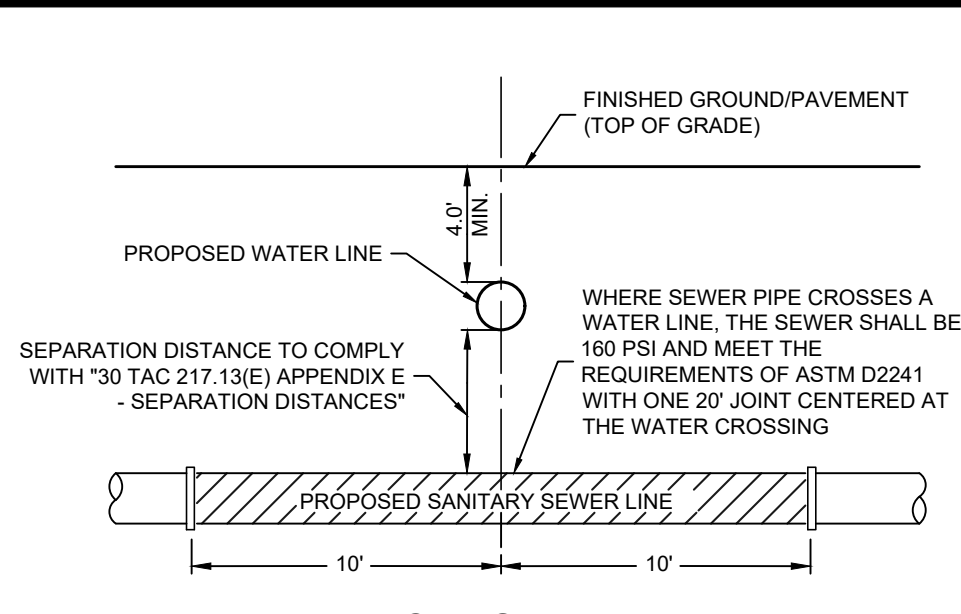
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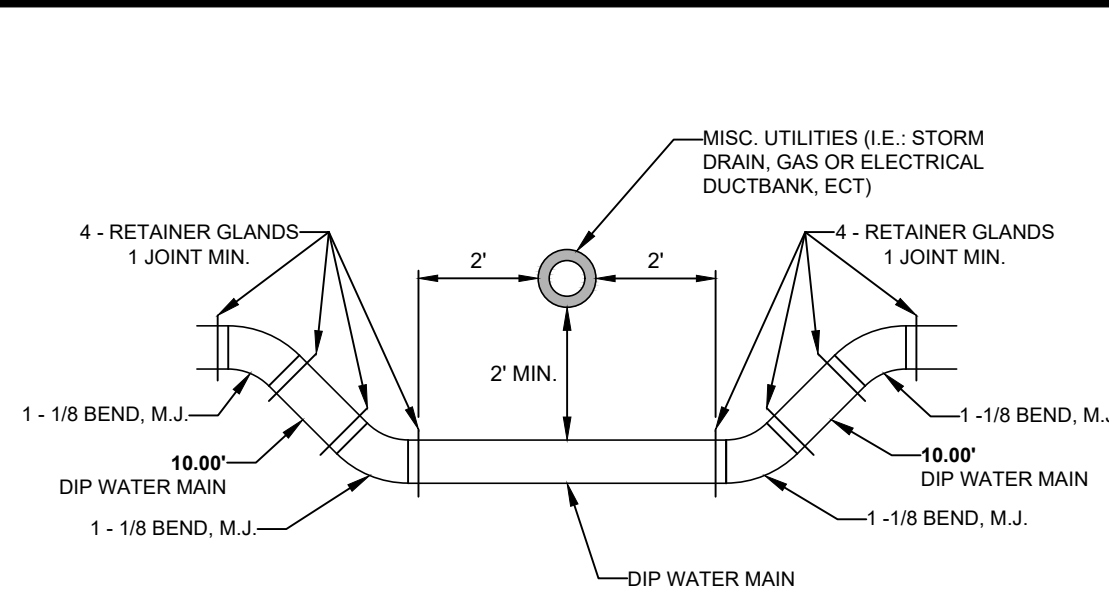
LOCATION MAP  
NOT-TO-SCALE



INDEX MAP  
NOT-TO-SCALE

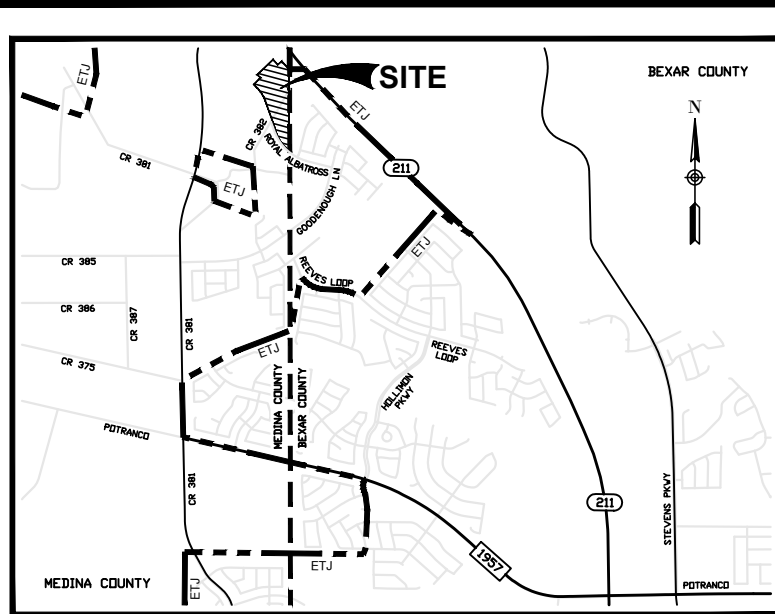

TYPICAL SANITARY  
SEWER/WATER CROSSING DETAIL  
NOT-TO-SCALE

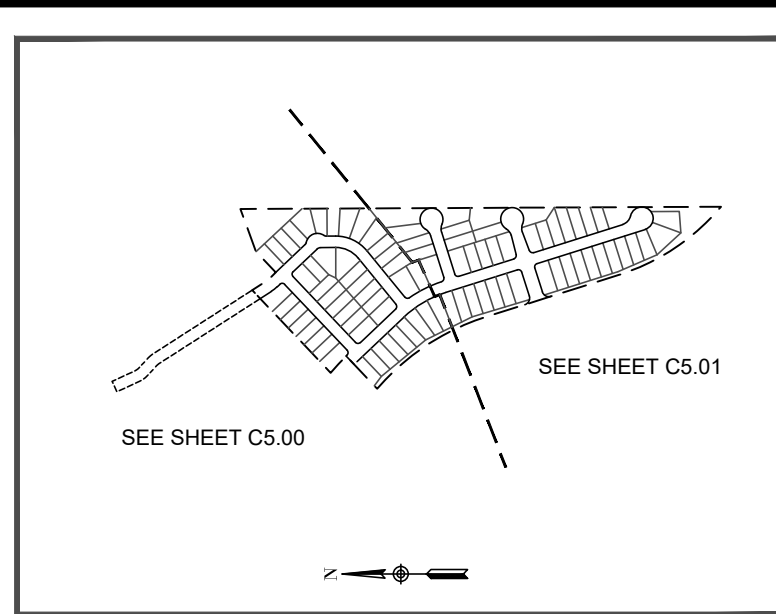

TYPICAL UTILITIES/WATER CROSSING DETAIL  
NOT TO SCALE



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LEGEND (WATER DISTRIBUTION)	
---	PROJECT LIMITS
---	PROPOSED WATER
---	PROPOSED SEWER
---	EXISTING WATER
---	EXISTING SEWER
⊙	MANHOLE
⊙	FIRE HYDRANT
---	PROPOSED WYE & LATERAL
---	PROPOSED 3" SINGLE SERVICE WITH 1/2" METER
---	PROPOSED 1" DUAL SERVICE WITH 1/2" METER
⊙	STREET LIGHT
⊙	GAS, ELECTRIC, TELEPHONE & CABLE TELEVISION EASEMENT
⊙	JOINT RESTRAINT



**JOINT RESTRAINT NOTE !!!**

ALL WATER PIPES WITHIN STEEL CASING SHALL BE FULLY RESTRAINED.

**FIRE FLOW NOTE:**

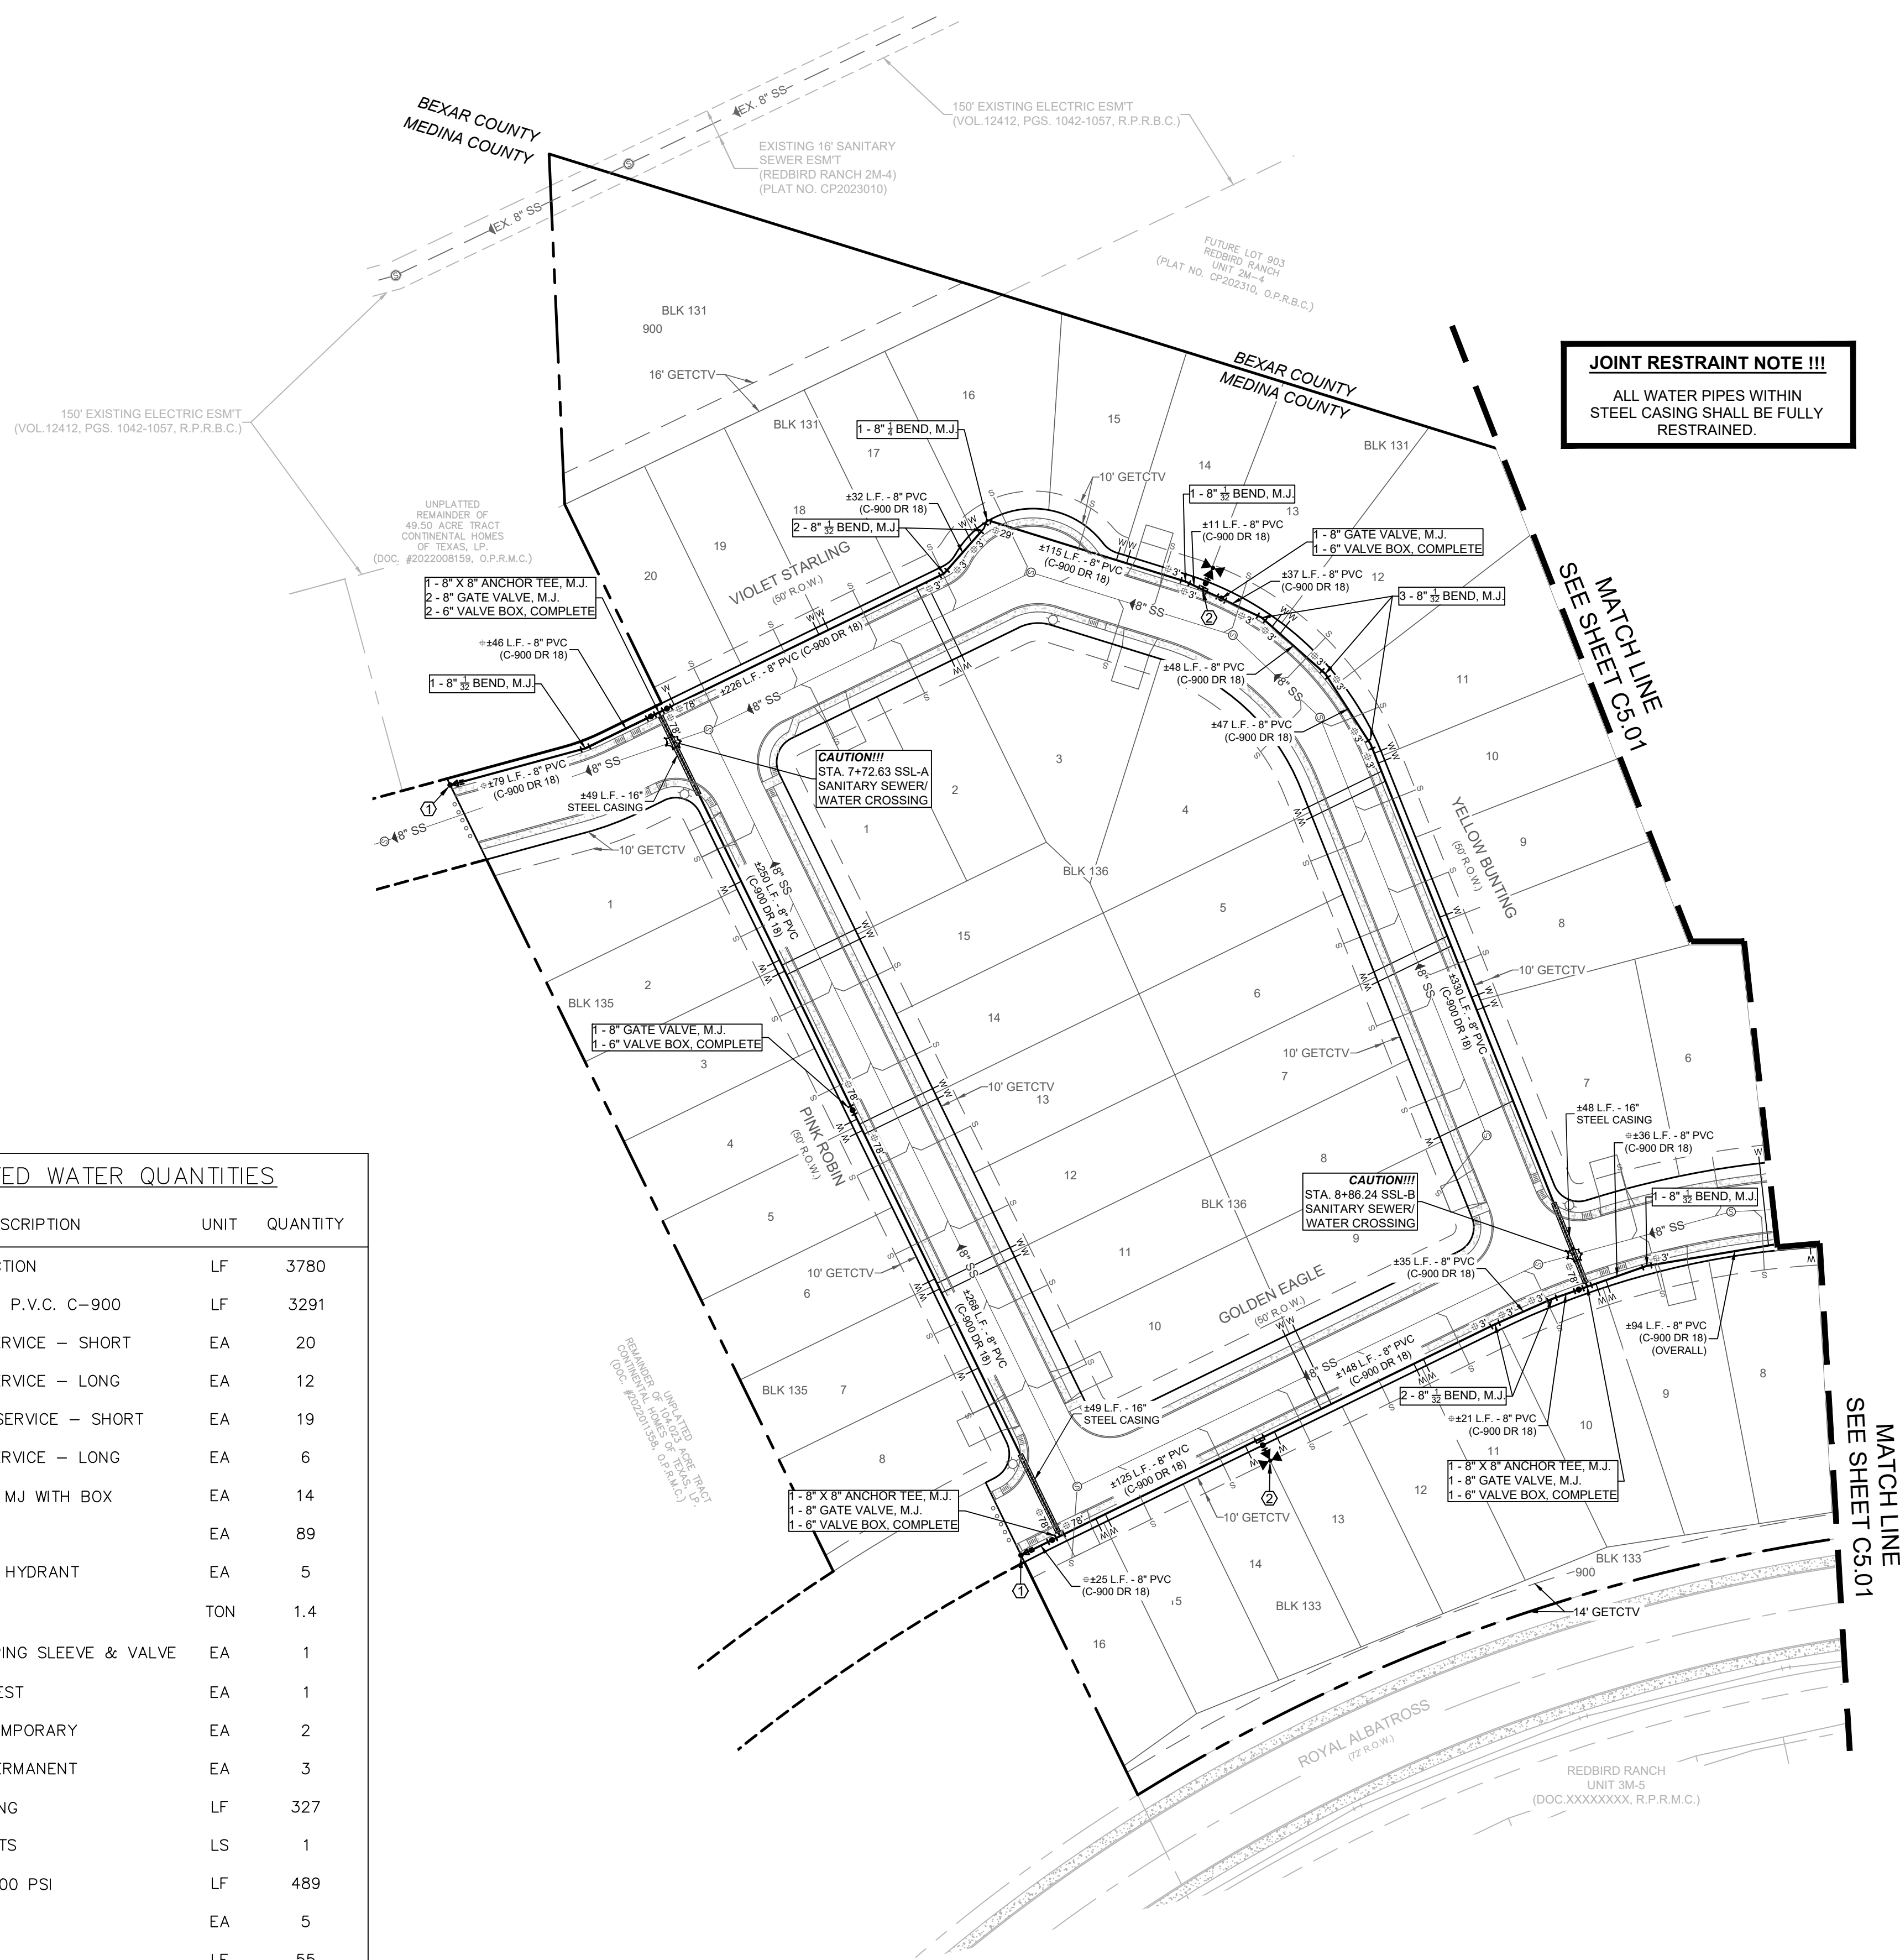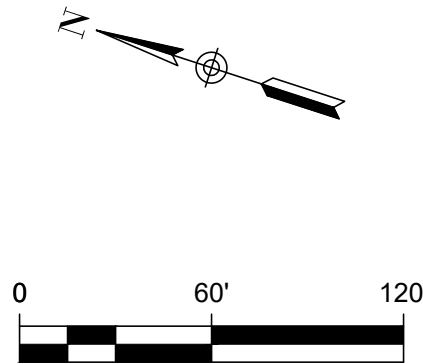IN AN EFFORT TO MEET THE CITY OF SAN ANTONIO'S FIRE FLOW REQUIREMENTS FOR THE PROPOSED RESIDENTIAL DEVELOPMENT, THE PUBLIC WATER MAIN SYSTEM HAS BEEN DESIGNED FOR A MINIMUM FIRE FLOW DEMAND OF 1000 GPM AT 25 PSI RESIDUAL PRESSURE. THE FIRE FLOW REQUIREMENTS FOR INDIVIDUAL STRUCTURES WILL BE REVIEWED DURING THE BUILDING PERMIT PROCESS IN ACCORDANCE WITH THE PROCEDURES SET FORTH BY THE CITY OF SAN ANTONIO DIRECTOR OF DEVELOPMENT SERVICES DEPARTMENT AND THE SAN ANTONIO FIRE DEPARTMENT FIRE MARSHAL.

**PRESSURE REDUCING VALVE NOTE:**

PRESSURE REDUCING VALVE TO BE INSTALLED ON CUSTOMER'S SIDE OF METER BY HOME/BUILDER.

**PRESSURE NOTE:**

CONTRACTOR TO VERIFY THAT NO PORTION OF THE TRACT IS BELOW GROUND ELEVATION OF 985 FEET WHERE THE STATIC PRESSURE WILL NORMALLY EXCEED 80 PSI. AT ALL SUCH LOCATION WHERE THE GROUND LEVEL IS BELOW 985 FEET, THE DEVELOPER OR BUILDER SHALL INSTALL AT EACH LOT, ON THE CUSTOMER'S SIDE OF THE METER, AN APPROVED TYPE PRESSURE REGULATOR IN CONFORMANCE WITH THE PLUMBING CODE OF THE CITY OF SAN ANTONIO. NO DUAL SERVICES ALLOWED FOR ANY LOT(S) IF "PRV" IS/ARE REQUIRED FOR SUCH LOT(S). ONLY SINGLE SERVICE CONNECTIONS SHALL BE ALLOWED.

**\*NOTE:** A PRESSURE REGULATOR IS ALSO KNOWN AS A PRESSURE REDUCING VALVE (PRV).

**JOINT RESTRAINT NOTE:**

CONTRACTOR SHALL INSTALL RETAINER GLANDS AT ALL FITTINGS AND PROVIDE JOINT RESTRAINING HARNESSES OR FIELD LOCK GASKETS AT ALL JOINTS WITHIN THE LENGTH SHOWN. CONTRACTOR SHALL INSURE THAT ALL TEES, BENDS, VALVES, ECT. HAVE A MINIMUM OF 5' OF PIPE WITH NO JOINTS ON EACH SIDE OF THE FITTING. JOINT RESTRAINTS AND RETAINER GLANDS SHALL BE CALCULATED BY YANCEY APPROVED PROGRAMS. THERE WILL BE NO SEPARATE PAY ITEM FOR RETAINER GLANDS AND OTHER JOINT RESTRAINING HARNESSES AND GASKETS, BUT SHALL BE SUBSIDIARY TO THE UNIT COST PER LINEAL FOOT OF PIPE INSTALLED.

ESTIMATED WATER QUANTITIES			
ITEM	DESCRIPTION	UNIT	QUANTITY
1	TRENCH PROTECTION	LF	3780
2	8" PIPE, D.I. OR P.V.C. C-900	LF	3291
3	DUAL WATER SERVICE - SHORT	EA	20
4	DUAL WATER SERVICE - LONG	EA	12
5	SINGLE WATER SERVICE - SHORT	EA	19
6	DUAL WATER SERVICE - LONG	EA	6
7	8" GATE VALVE MJ WITH BOX	EA	14
8	METER BOX	EA	89
9	STANDARD FIRE HYDRANT	EA	5
10	D.I. FITTINGS	TON	1.4
11	TIE-IN OR TAPPING SLEEVE & VALVE	EA	1
12	HYDROSTATIC TEST	EA	1
13	2" BLOWOFF, TEMPORARY	EA	2
14	2" BLOWOFF, PERMANENT	EA	3
15	16" STEEL CASING	LF	327
16	JOINT RESTRAINTS	LS	1
17	2" HDPE DR9 200 PSI	LF	489
18	TEST STATION	EA	5
19	4" PVC SLEEVE	LF	55

①	FOR CHLORINATION INJECTION <ul style="list-style-type: none"><li>2- 1" CORPORATION STOP, C.C.XI.P</li><li>1- 1" COPPER TUBING, CUT AS REQUIRED</li><li>2- 1" COMP. 1 1/2" COUPLING, CORP. STOP</li><li>2- 1 1/2" THD. SOLID CAPS, THR.</li></ul>
	UPON SUCCESSFUL HYDROSTATIC TESTING, DISINFECTION OF THE NEW MAIN AND ACCEPTANCE BY YANCEY W.S.C., THE CONTRACTOR SHALL TIE INTO EXISTING 8" WATER MAIN.
②	1- 2" TEMPORARY BLOWOFF ASSEMBLY (SEE YANCEY DETAIL DWG. W-31 SHEET C5.11)
	1- STANDARD FIRE HYDRANT
③	1- 8"X6" ANCHOR TEE, M.J.
	6" D.I. PIPE, CUT AS REQ'D
④	1- 6" ANCHOR BEND, M.J.
	1- 6" GATE VALVE, M.J.
⑤	1- 6" VALVE BOX, COMPLETE (SEE YANCEY DETAIL DWG. W-20 SHEET C5.10)
	TEST STATION
⑥	1- 2" PERMANENT BLOWOFF ASSEMBLY (SEE YANCEY DETAIL DWG. W-32 SHEET C5.11)

DESIGNED BY: JWS  
DRAWN BY: SQV/JWS  
DATE: 8/21/2024  
JOB NO.: 05000-200  
SHEET NO.

C5.00

REDBIRD RANCH UNIT 2M-2  
SAN ANTONIO, TX

WATER DISTRIBUTION PLAN





8/21/2024  
VANCE L. WEYMAN  
PROFESSIONAL ENGINEER  
99269  
TBP REG. NO. F-19561

DHI Engineering, LLC.  
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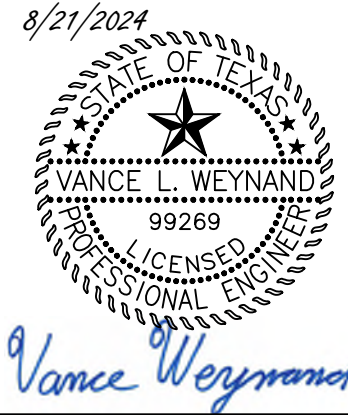
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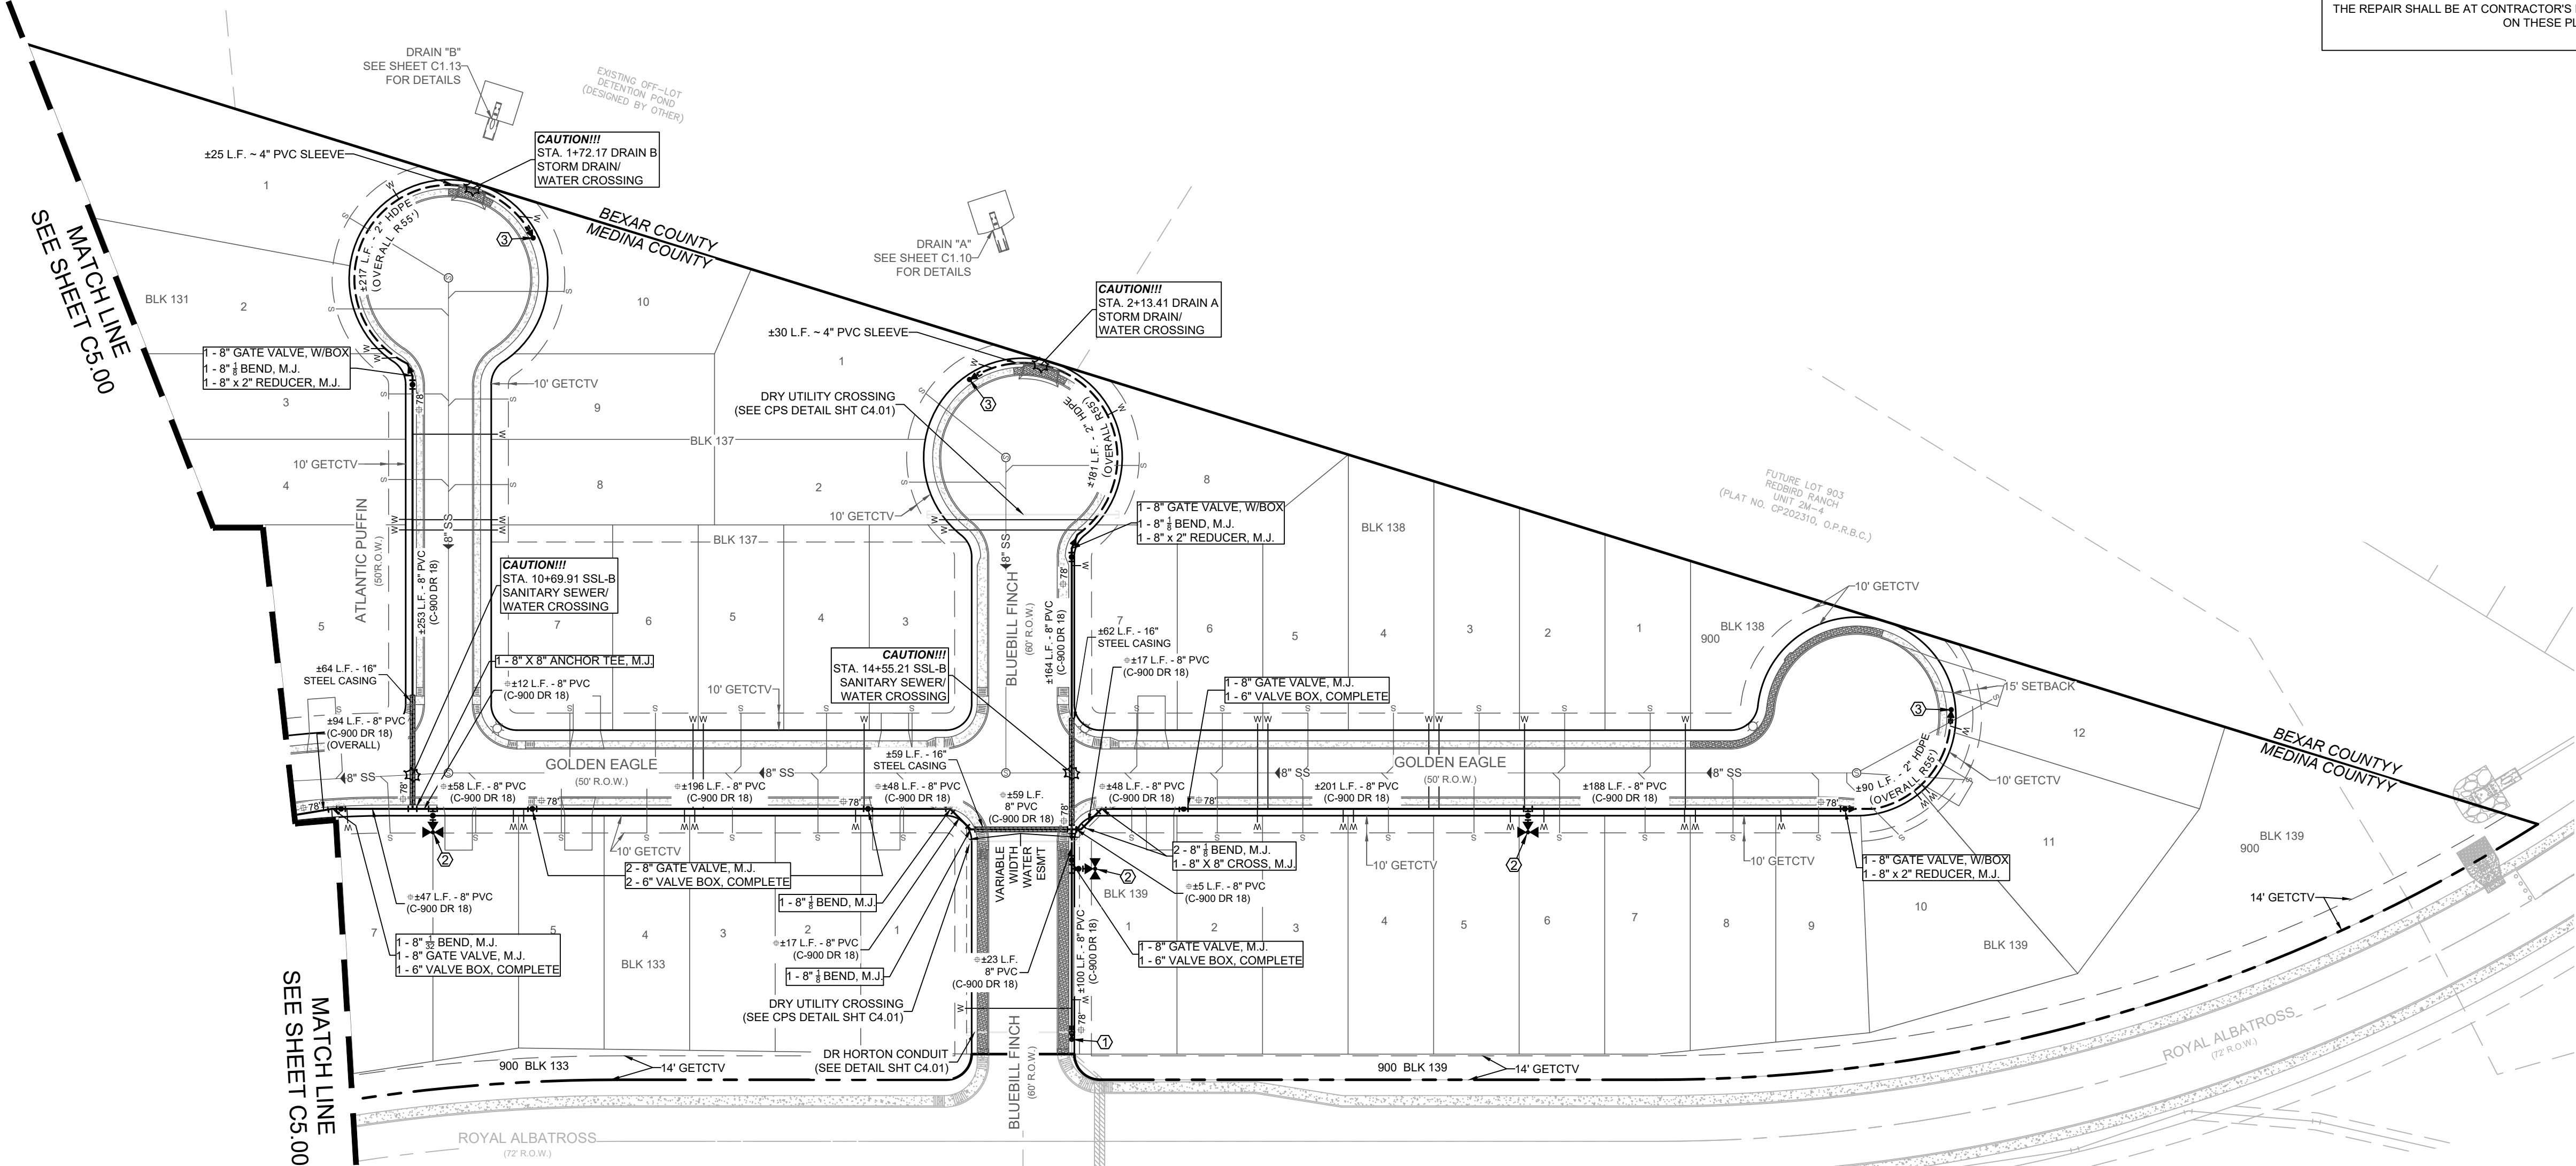
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---	PROPOSED SEWER
---	EXISTING WATER
---	EXISTING SEWER
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⊙	FIRE HYDRANT
---	PROPOSED WYE & LATERAL
---	PROPOSED 3" SINGLE SERVICE WITH 1/2" METER
---	PROPOSED 1" DUAL SERVICE WITH 1/2" METER
⊙	STREET LIGHT
⊙	GAS, ELECTRIC, TELEPHONE & CABLE TELEVISION EASEMENT
⊙	JOINT RESTRAINT



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**DHI**

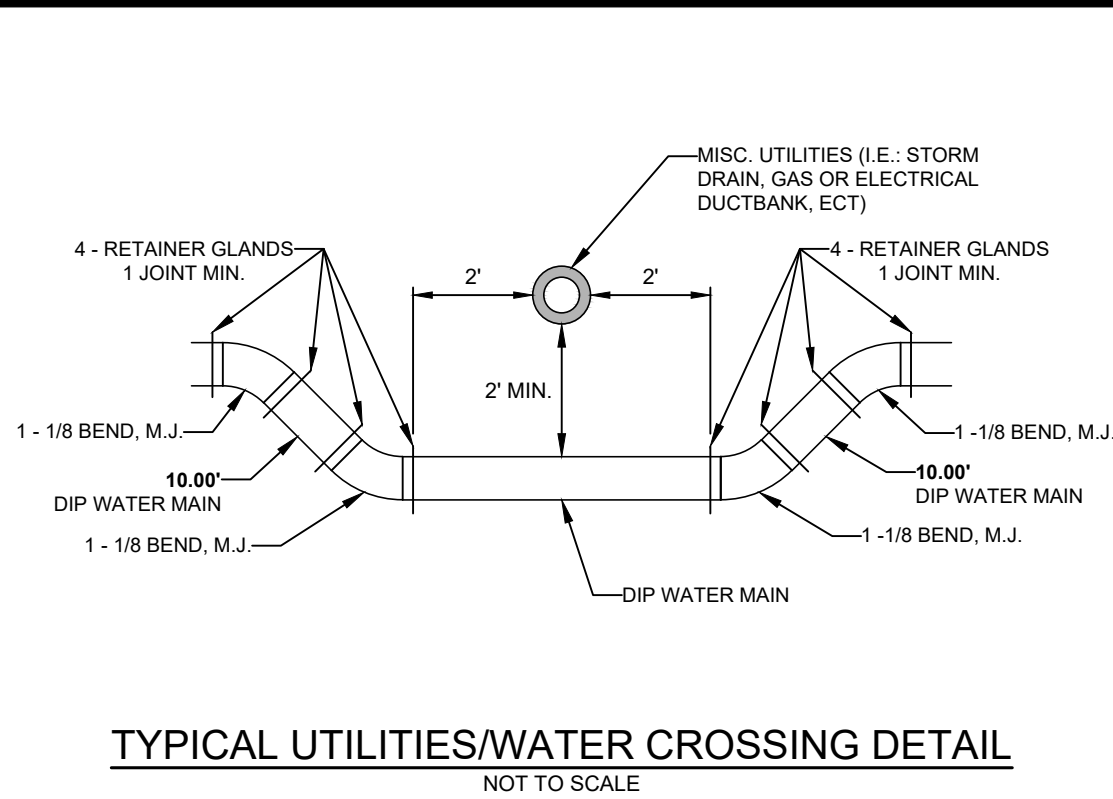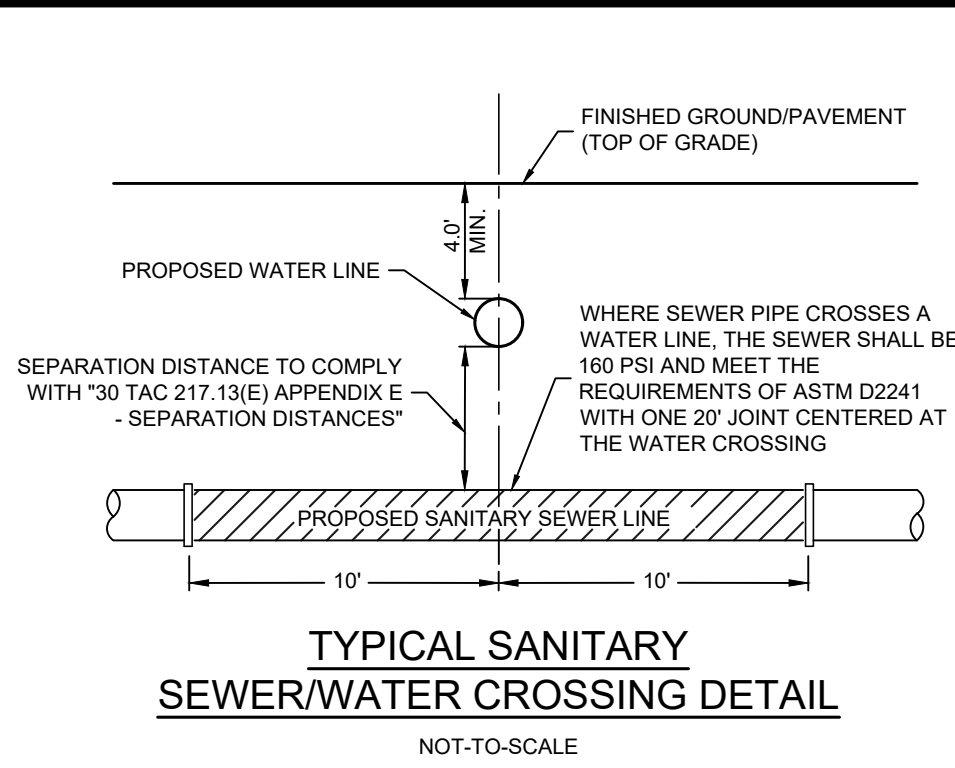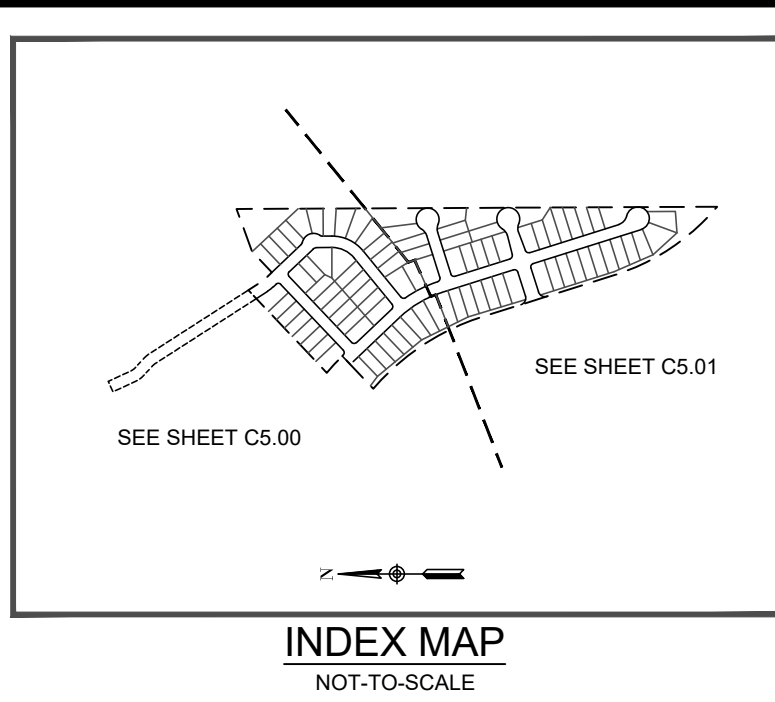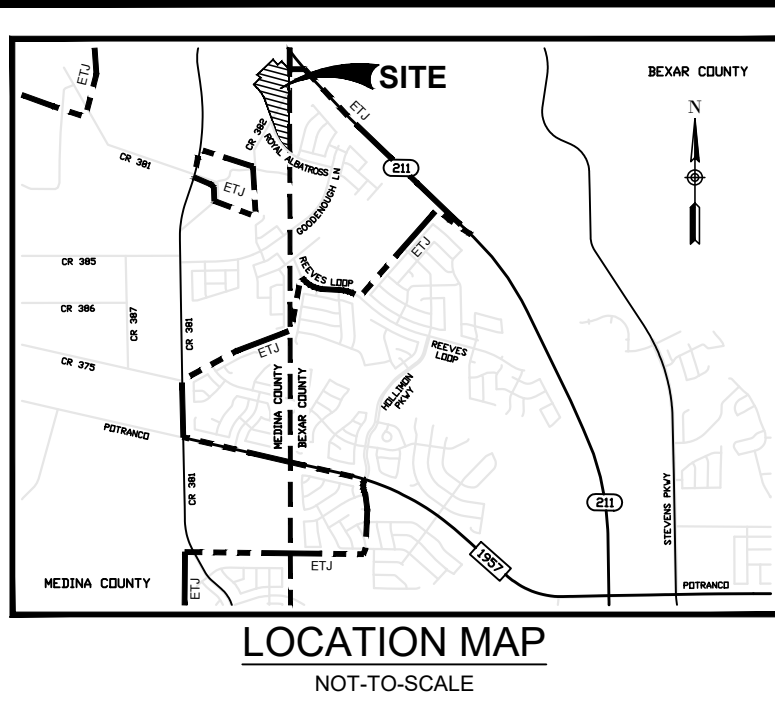

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• 1-1" COPPER TUBING, CUT AS REQUIRED	
• 2-1" COMP. 1" COUPLING, CORP. STOP	
• 2-1 1/2 THD. SOLID CAPS, THR.	
①	UPON SUCCESSFUL HYDROSTATIC TESTING, DISINFECTION OF THE NEW MAIN AND ACCEPTANCE BY YANCEY W.S.C., THE CONTRACTOR SHALL TIE INTO EXISTING 8" WATER MAIN.
	1-2" TEMPORARY BLOWOFF ASSEMBLY (SEE YANCEY DETAIL DWG. W-31 SHEET C5.11)
②	1-STANDARD FIRE HYDRANT 1-8"x6" ANCHOR TEE, M.J. 6" D.I. PIPE, CUT AS REQD 1-6" ANCHOR BEND, M.J. 1-6" GATE VALVE, M.J. 1-6 VALVE BOX, COMPLETE (SEE YANCEY DETAIL DWG. W-20 SHEET C5.10) TEST STATION
③	1-2" PERMANENT BLOWOFF ASSEMBLY (SEE YANCEY DETAIL DWG. W-32 SHEET C5.11)

**JOINT RESTRAINT NOTE !!!**

ALL WATER PIPES WITHIN STEEL CASING SHALL BE FULLY RESTRAINED.

**REDBIRD RANCH UNIT 2M-2**  
SAN ANTONIO, TX

**WATER DISTRIBUTION PLAN**

DESIGNED BY: JWS  
DRAWN BY: SQV/JWS  
DATE: 8/21/2024  
JOB NO.: 05000-200  
SHEET NO.


**C5.01**

REDBIRD RANCH UNIT 2M-2 DOC # XXXXXXXXXXXX Date: Aug 21, 2024, 2:10pm User: B: SQV File: E:\PROJECTS\05000 200\0500 - Shared\05.00 WATER DISTRIBUTION PLAN.dwg







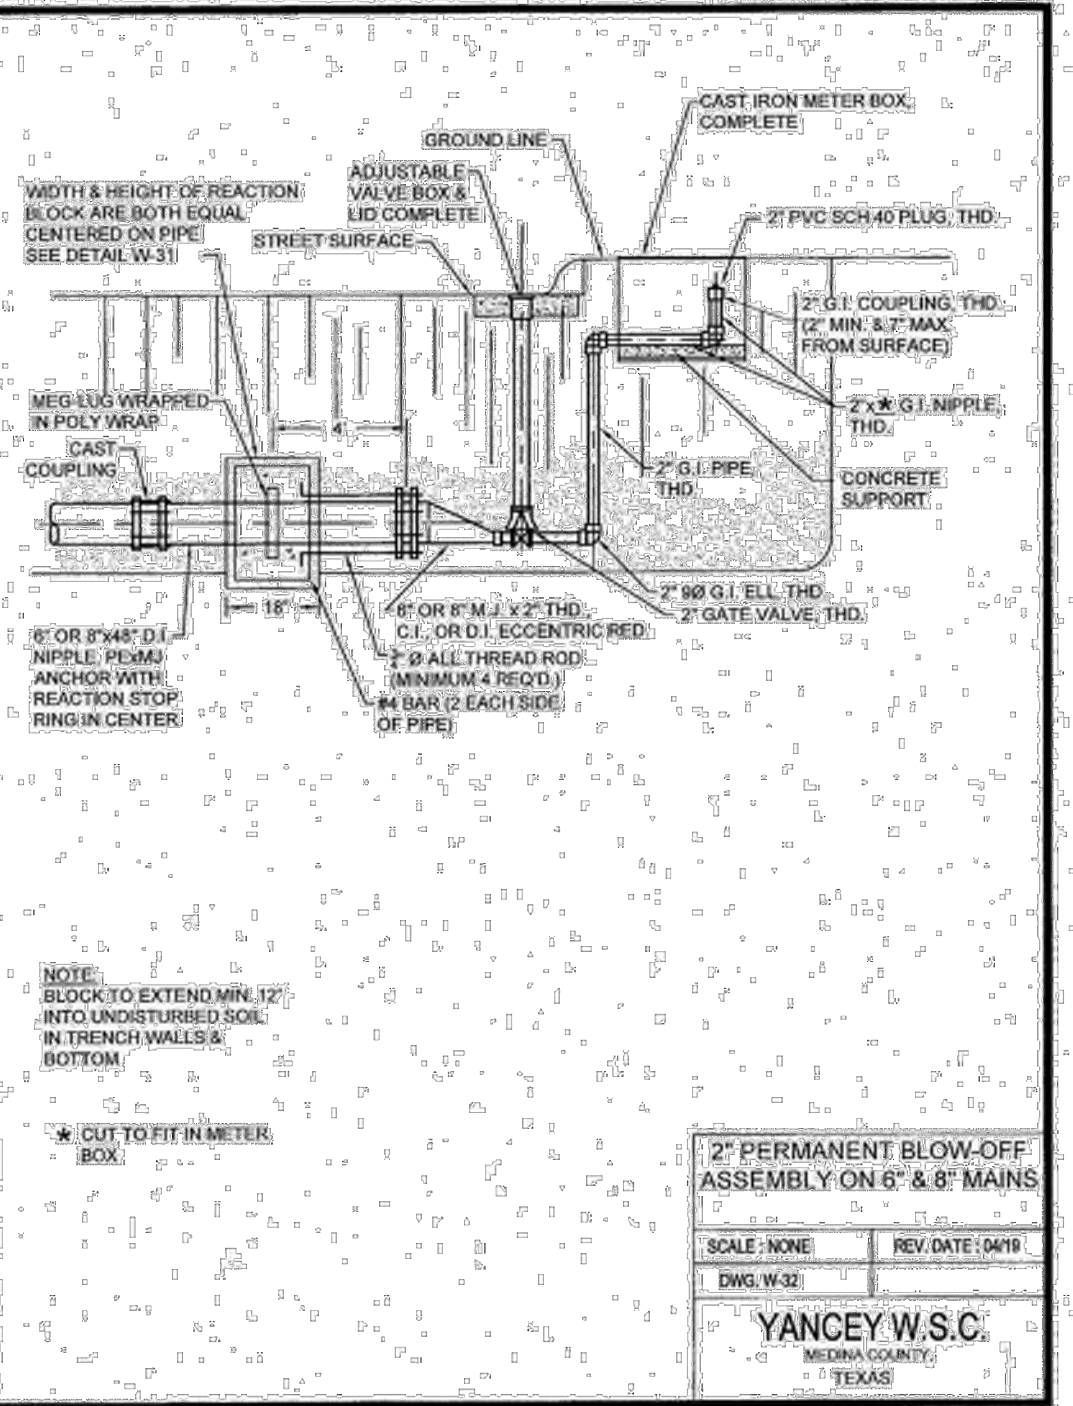







### TRENCH EXCAVATION PROTECTION

[illegible]

**CAUTION!!!**

CONTRACTOR SHALL BE REQUIRED TO LOCATE ALL PUBLIC OR PRIVATE UTILITIES INCLUDING BUT NOT LIMITING TO: WATER, SEWER, TELEPHONE AND FIBER OPTIC LINES, SITE LIGHTING ELECTRIC, SECONDARY ELECTRIC, PRIMARY ELECTRICAL, DUCTBANKS, LANDSCAPE IRRIGATION FACILITIES, AND GAS LINES. ANY UTILITY CONFLICTS THAT ARISE SHOULD BE COMMUNICATED TO THE ENGINEER IMMEDIATELY AND PRIOR TO CONSTRUCTION. THE CONTRACTOR SHALL CONDUCT 1-800-DIG-TESS AT A MINIMUM OF 48 HOURS PRIOR TO THE START OF CONSTRUCTION. ANY DAMAGE TO EXISTING UTILITIES SHALL BE THE SOLE RESPONSIBILITY OF THE CONTRACTOR AND THE REPAIR SHALL BE AT CONTRACTOR'S EXPENSE WHETHER THE UTILITY IS SHOWN ON THESE PLANS OR NOT.

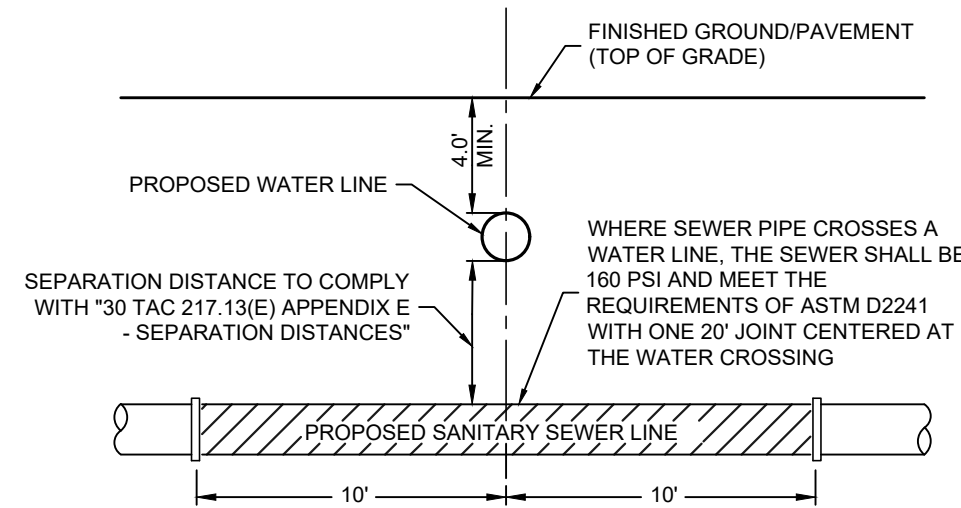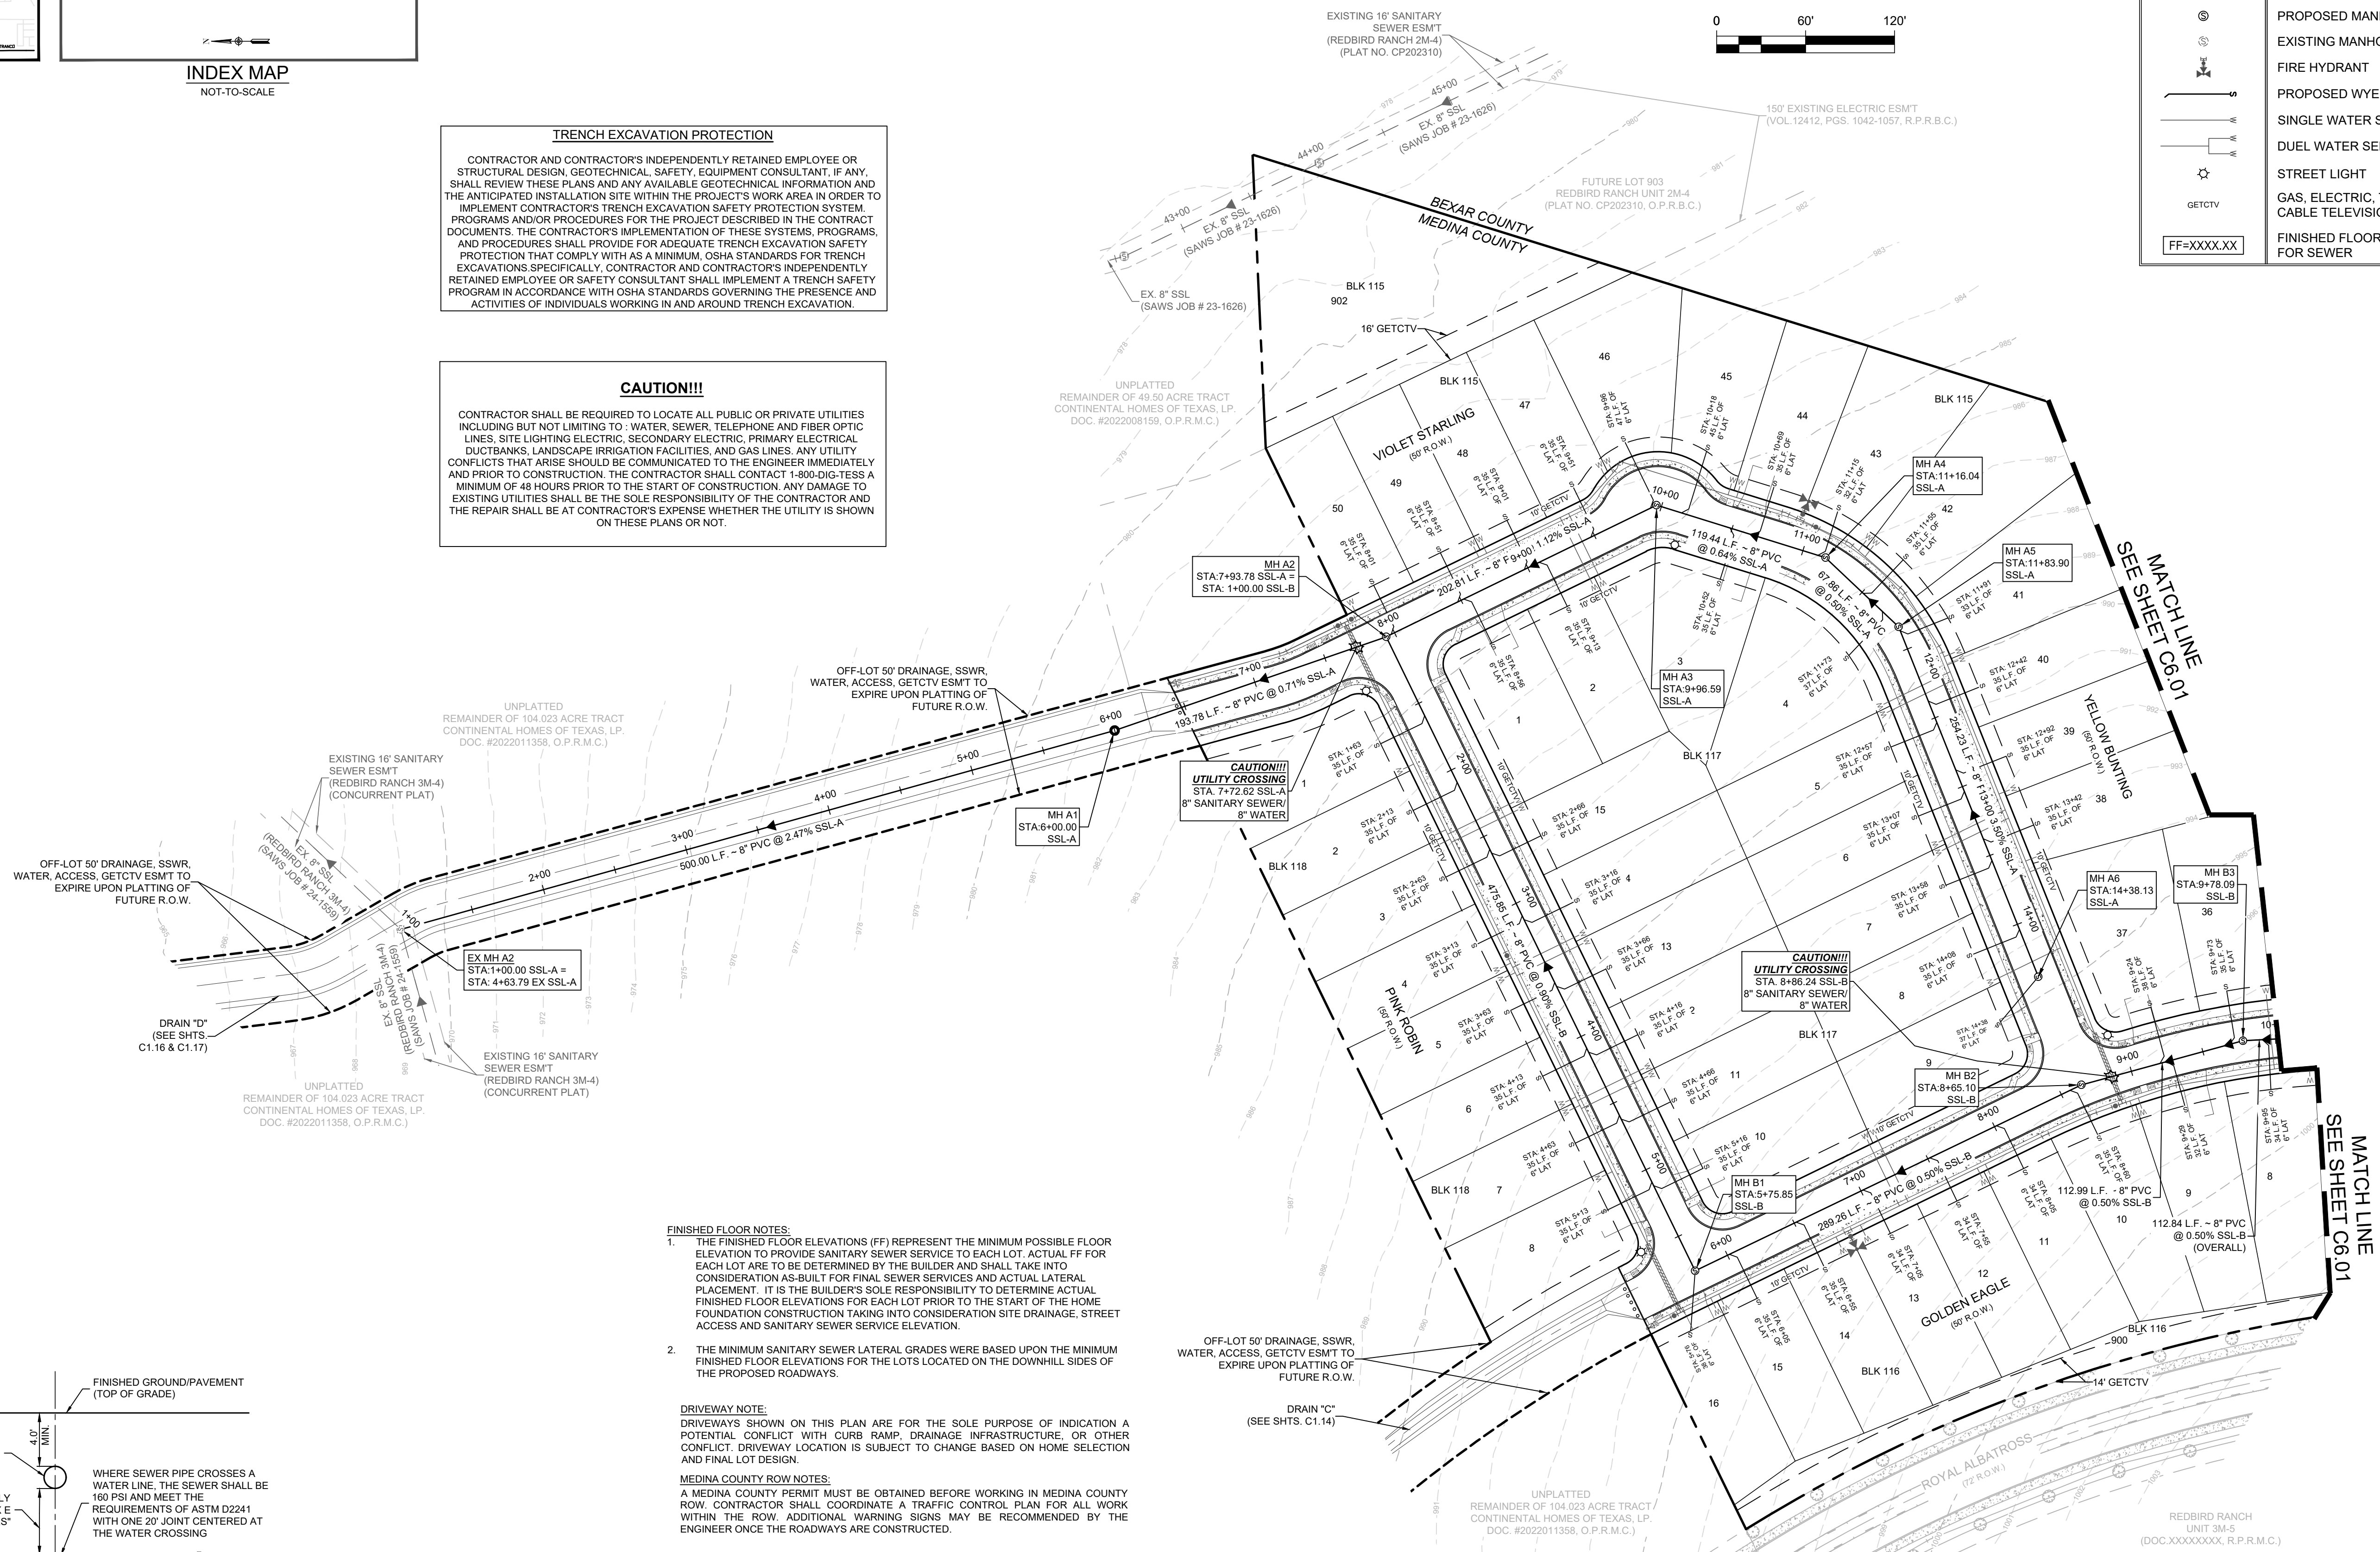

TYPICAL SANITARY  
SEWER/WATER CROSSING DETAIL  
NOT-TO-SCALE

SEWER: SAWS MEDIO CREEK WRC

DEVELOPER'S NAME: CONTINENTAL HOMES OF TEXAS, L.P.  
ADDRESS: 5419 N. LOOP 1604 EAST  
CITY: SAN ANTONIO STATE: TEXAS ZIP: 78247  
PHONE # (210) 496-2668 FAX # (210) 496-2668  
SAWS BLOCK MAP # 062588 TOTAL EDUS: 89 TOTAL ACREAGE: 20.795  
TOTAL LINEAR FOOTAGE OF PIPE: 3,625 LF. (S) DOC. NO: (MEDINA COUNTY)  
NUMBER OF LOTS: 89 SAWS JOB NO: 24-1513

**DHI Engineering, LLC.**  
5419 N. LOOP 1604 EAST  
SAN ANTONIO, TX 78247



REDBIRD RANCH UNIT 2M-2  
SAN ANTONIO, TX




# OVERALL SANITARY SEWER PLAN

DESIGNED BY:	JWS
DRAWN BY:	SQV/JWS
DATE:	5/31/2024
SB NO.:	05000-200
SHEET NO.	

C6.00



DHI ENGINEERING, LLC. THIS DOCUMENT HAS BEEN PRODUCED FROM MATERIAL THAT WAS STORED AND/OR TRANSMITTED ELECTRONICALLY AND MAY HAVE BEEN INADVERTENTLY ALTERED. RELY ONLY ON ORIGINAL HARD COPY MATERIALS BEARING THE CONSULTANT'S ORIGINAL SIGNATURE AND SEAL.

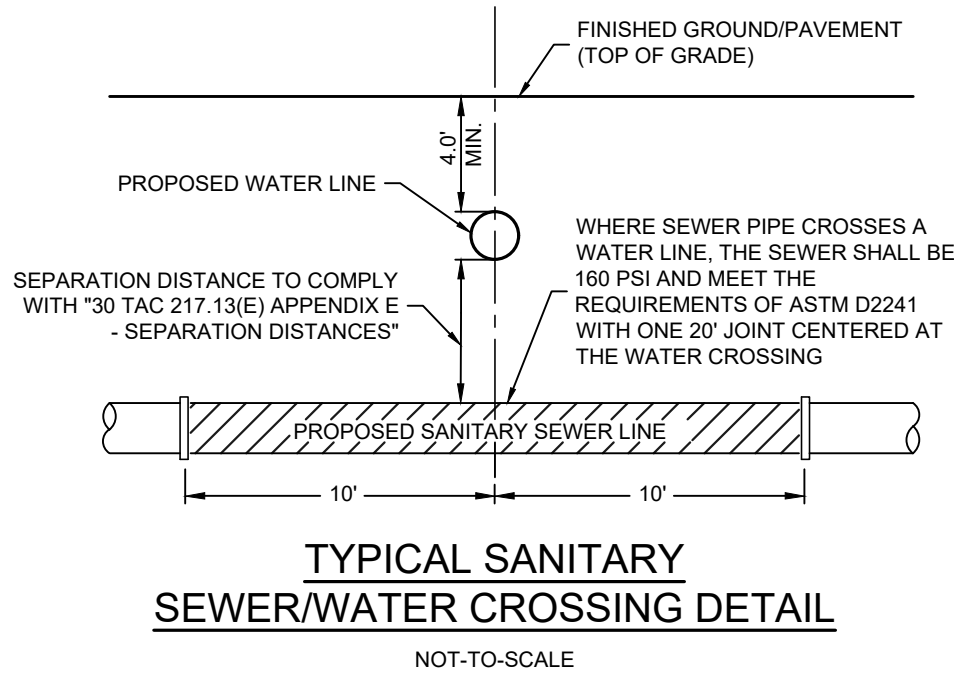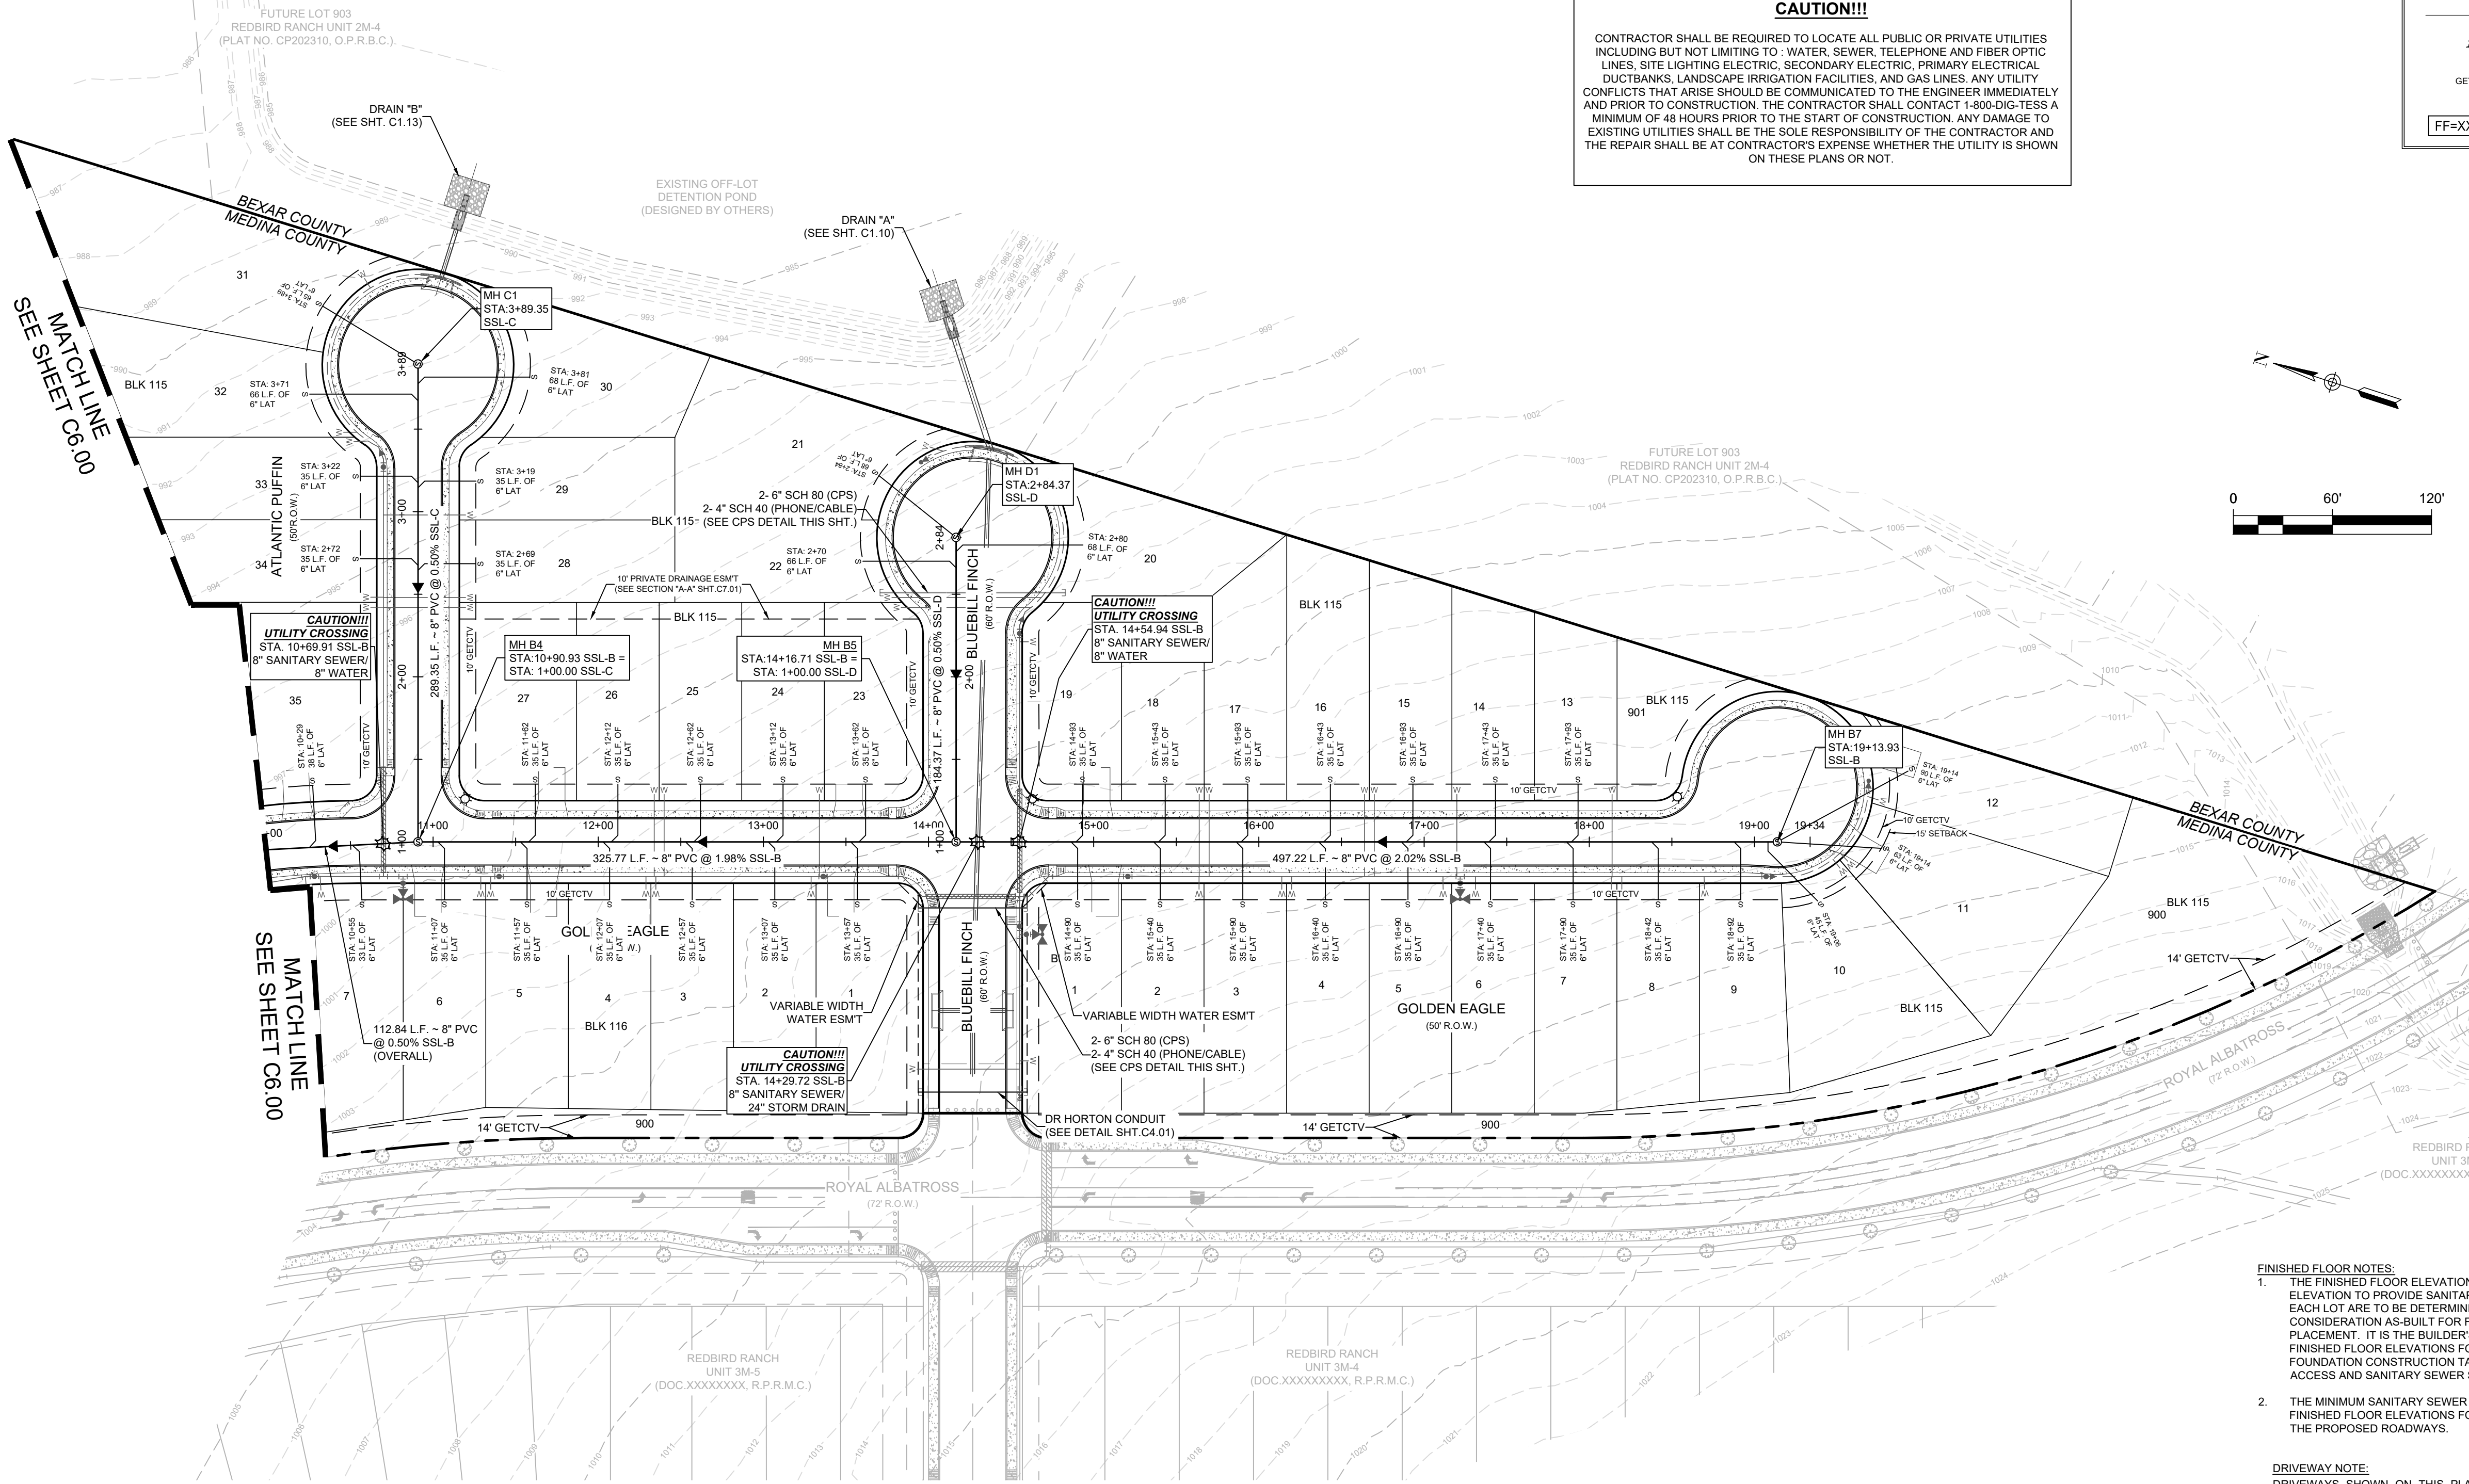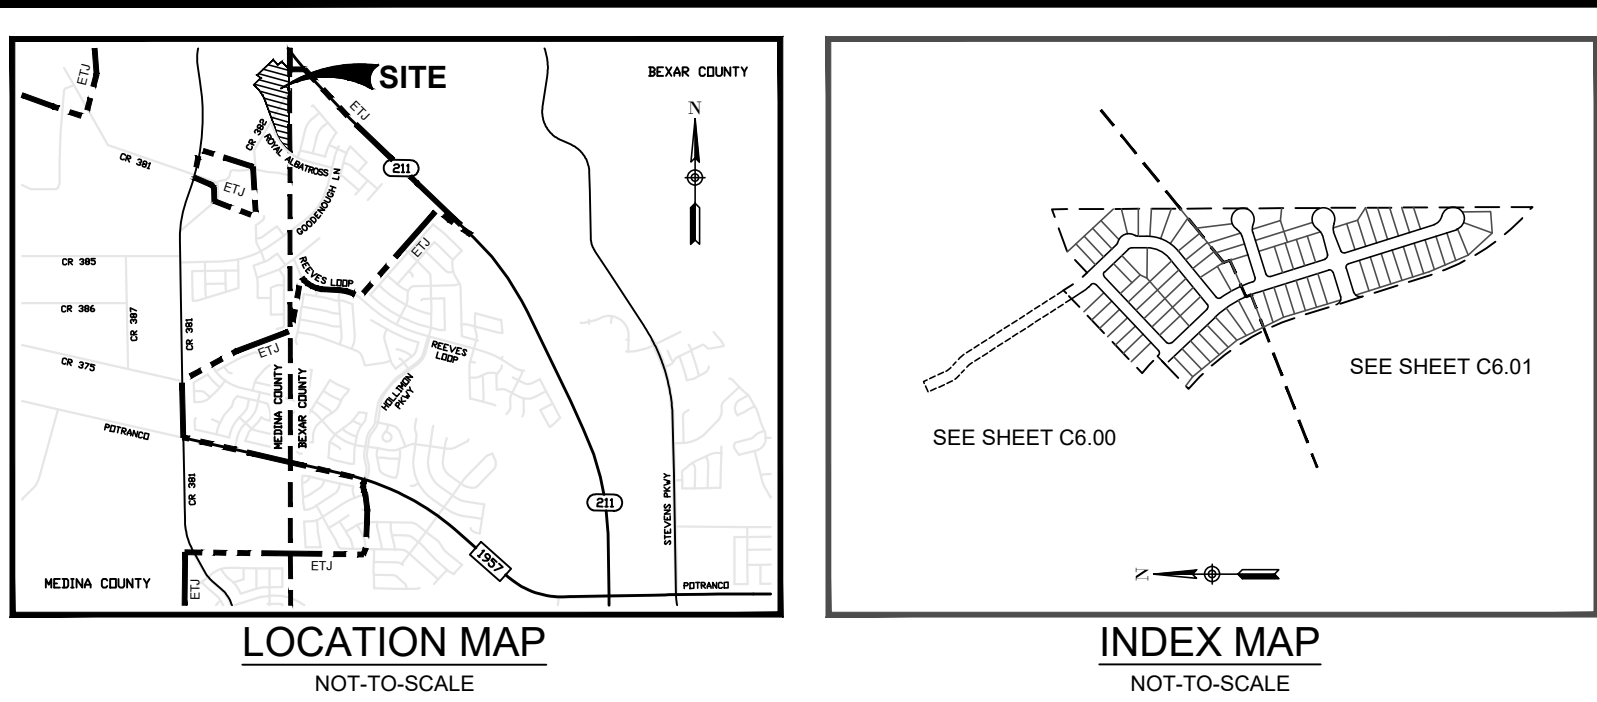


**TRENCH EXCAVATION PROTECTION**

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**CAUTION!!!**

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LEGEND (SANITARY SEWER)	
	PROJECT LIMITS
	OFFSITE EASEMENT
	PROPOSED WATER
	PROPOSED SEWER
	EXISTING WATER
	EXISTING SANITARY SEWER LINE
	PROPOSED MANHOLE
	EXISTING MANHOLE
	FIRE HYDRANT
	PROPOSED WYE & LATERAL
	SINGLE WATER SERVICE
	DUEL WATER SERVICE
	STREET LIGHT
	GAS, ELECTRIC, TELEPHONE & CABLE TELEVISION EASEMENT
	FINISHED FLOOR ELEVATION FOR SEWER



- FINISHED FLOOR NOTES:**
- THE FINISHED FLOOR ELEVATIONS (FF) REPRESENT THE MINIMUM POSSIBLE FLOOR ELEVATION TO PROVIDE SANITARY SEWER SERVICE TO EACH LOT. ACTUAL FF FOR EACH LOT ARE TO BE DETERMINED BY THE BUILDER AND SHALL TAKE INTO CONSIDERATION AS-BUILT FOR FINAL SEWER SERVICES AND ACTUAL LATERAL PLACEMENT. IT IS THE BUILDER'S SOLE RESPONSIBILITY TO DETERMINE ACTUAL FINISHED FLOOR ELEVATIONS FOR EACH LOT PRIOR TO THE START OF THE HOME FOUNDATION CONSTRUCTION TAKING INTO CONSIDERATION SITE DRAINAGE, STREET ACCESS AND SANITARY SEWER SERVICE ELEVATION.
  - THE MINIMUM SANITARY SEWER LATERAL GRADES WERE BASED UPON THE MINIMUM FINISHED FLOOR ELEVATIONS FOR THE LOTS LOCATED ON THE DOWNHILL SIDES OF THE PROPOSED ROADWAYS.

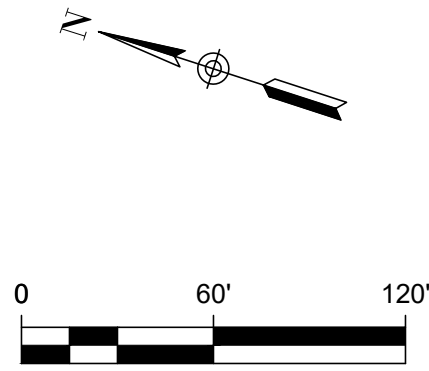**DRIVEWAY NOTE:**  
DRIVEWAYS SHOWN ON THIS PLAN ARE FOR THE SOLE PURPOSE OF INDICATION A POTENTIAL CONFLICT WITH CURB RAMP, DRAINAGE INFRASTRUCTURE, OR OTHER CONFLICT. DRIVEWAY LOCATION IS SUBJECT TO CHANGE BASED ON HOME SELECTION AND FINAL LOT DESIGN.

**MEDINA COUNTY ROW NOTES:**  
A MEDINA COUNTY PERMIT MUST BE OBTAINED BEFORE WORKING IN MEDINA COUNTY ROW. CONTRACTOR SHALL COORDINATE A TRAFFIC CONTROL PLAN FOR ALL WORK WITHIN THE ROW. ADDITIONAL WARNING SIGNS MAY BE RECOMMENDED BY THE ENGINEER ONCE THE ROADWAYS ARE CONSTRUCTED.

**SEWER: SAWS MEDIO CREEK WRC**

DEVELOPER'S NAME:	CONTINENTAL HOMES OF TEXAS, L.P.
ADDRESS:	5419 N. LOOP 1604 EAST
CITY:	SAN ANTONIO
STATE:	TEXAS
ZIP:	78247
PHONE #	(210) 496-2668
FAX #	(210) 496-2668
SAWS BLOCK MAP #	062588
TOTAL EDUS:	89
TOTAL ACREAGE:	20.795
TOTAL LINEAR FOOTAGE OF PIPE:	3,625 L.F. (87)
DOC. NO.:	(MEDINA COUNTY)
NUMBER OF LOTS:	89
SAWS JOB NO.:	24-1513

DESIGNED BY: JWS  
DRAWN BY: SQV/JWS  
DATE: 5/31/2024  
JOB NO.: 05000-200  
SHEET NO. C6.01


REDBIRD RANCH UNIT 2M-2  
SAN ANTONIO, TX  
OVERALL SANITARY SEWER PLAN

DHI Engineering, LLC.  
4419 N. LOOP 1604 EAST  
SAN ANTONIO, TEXAS 78247  
(210) 496-2668 | dhiengineering.com  
TBP REG. NO. F-195661


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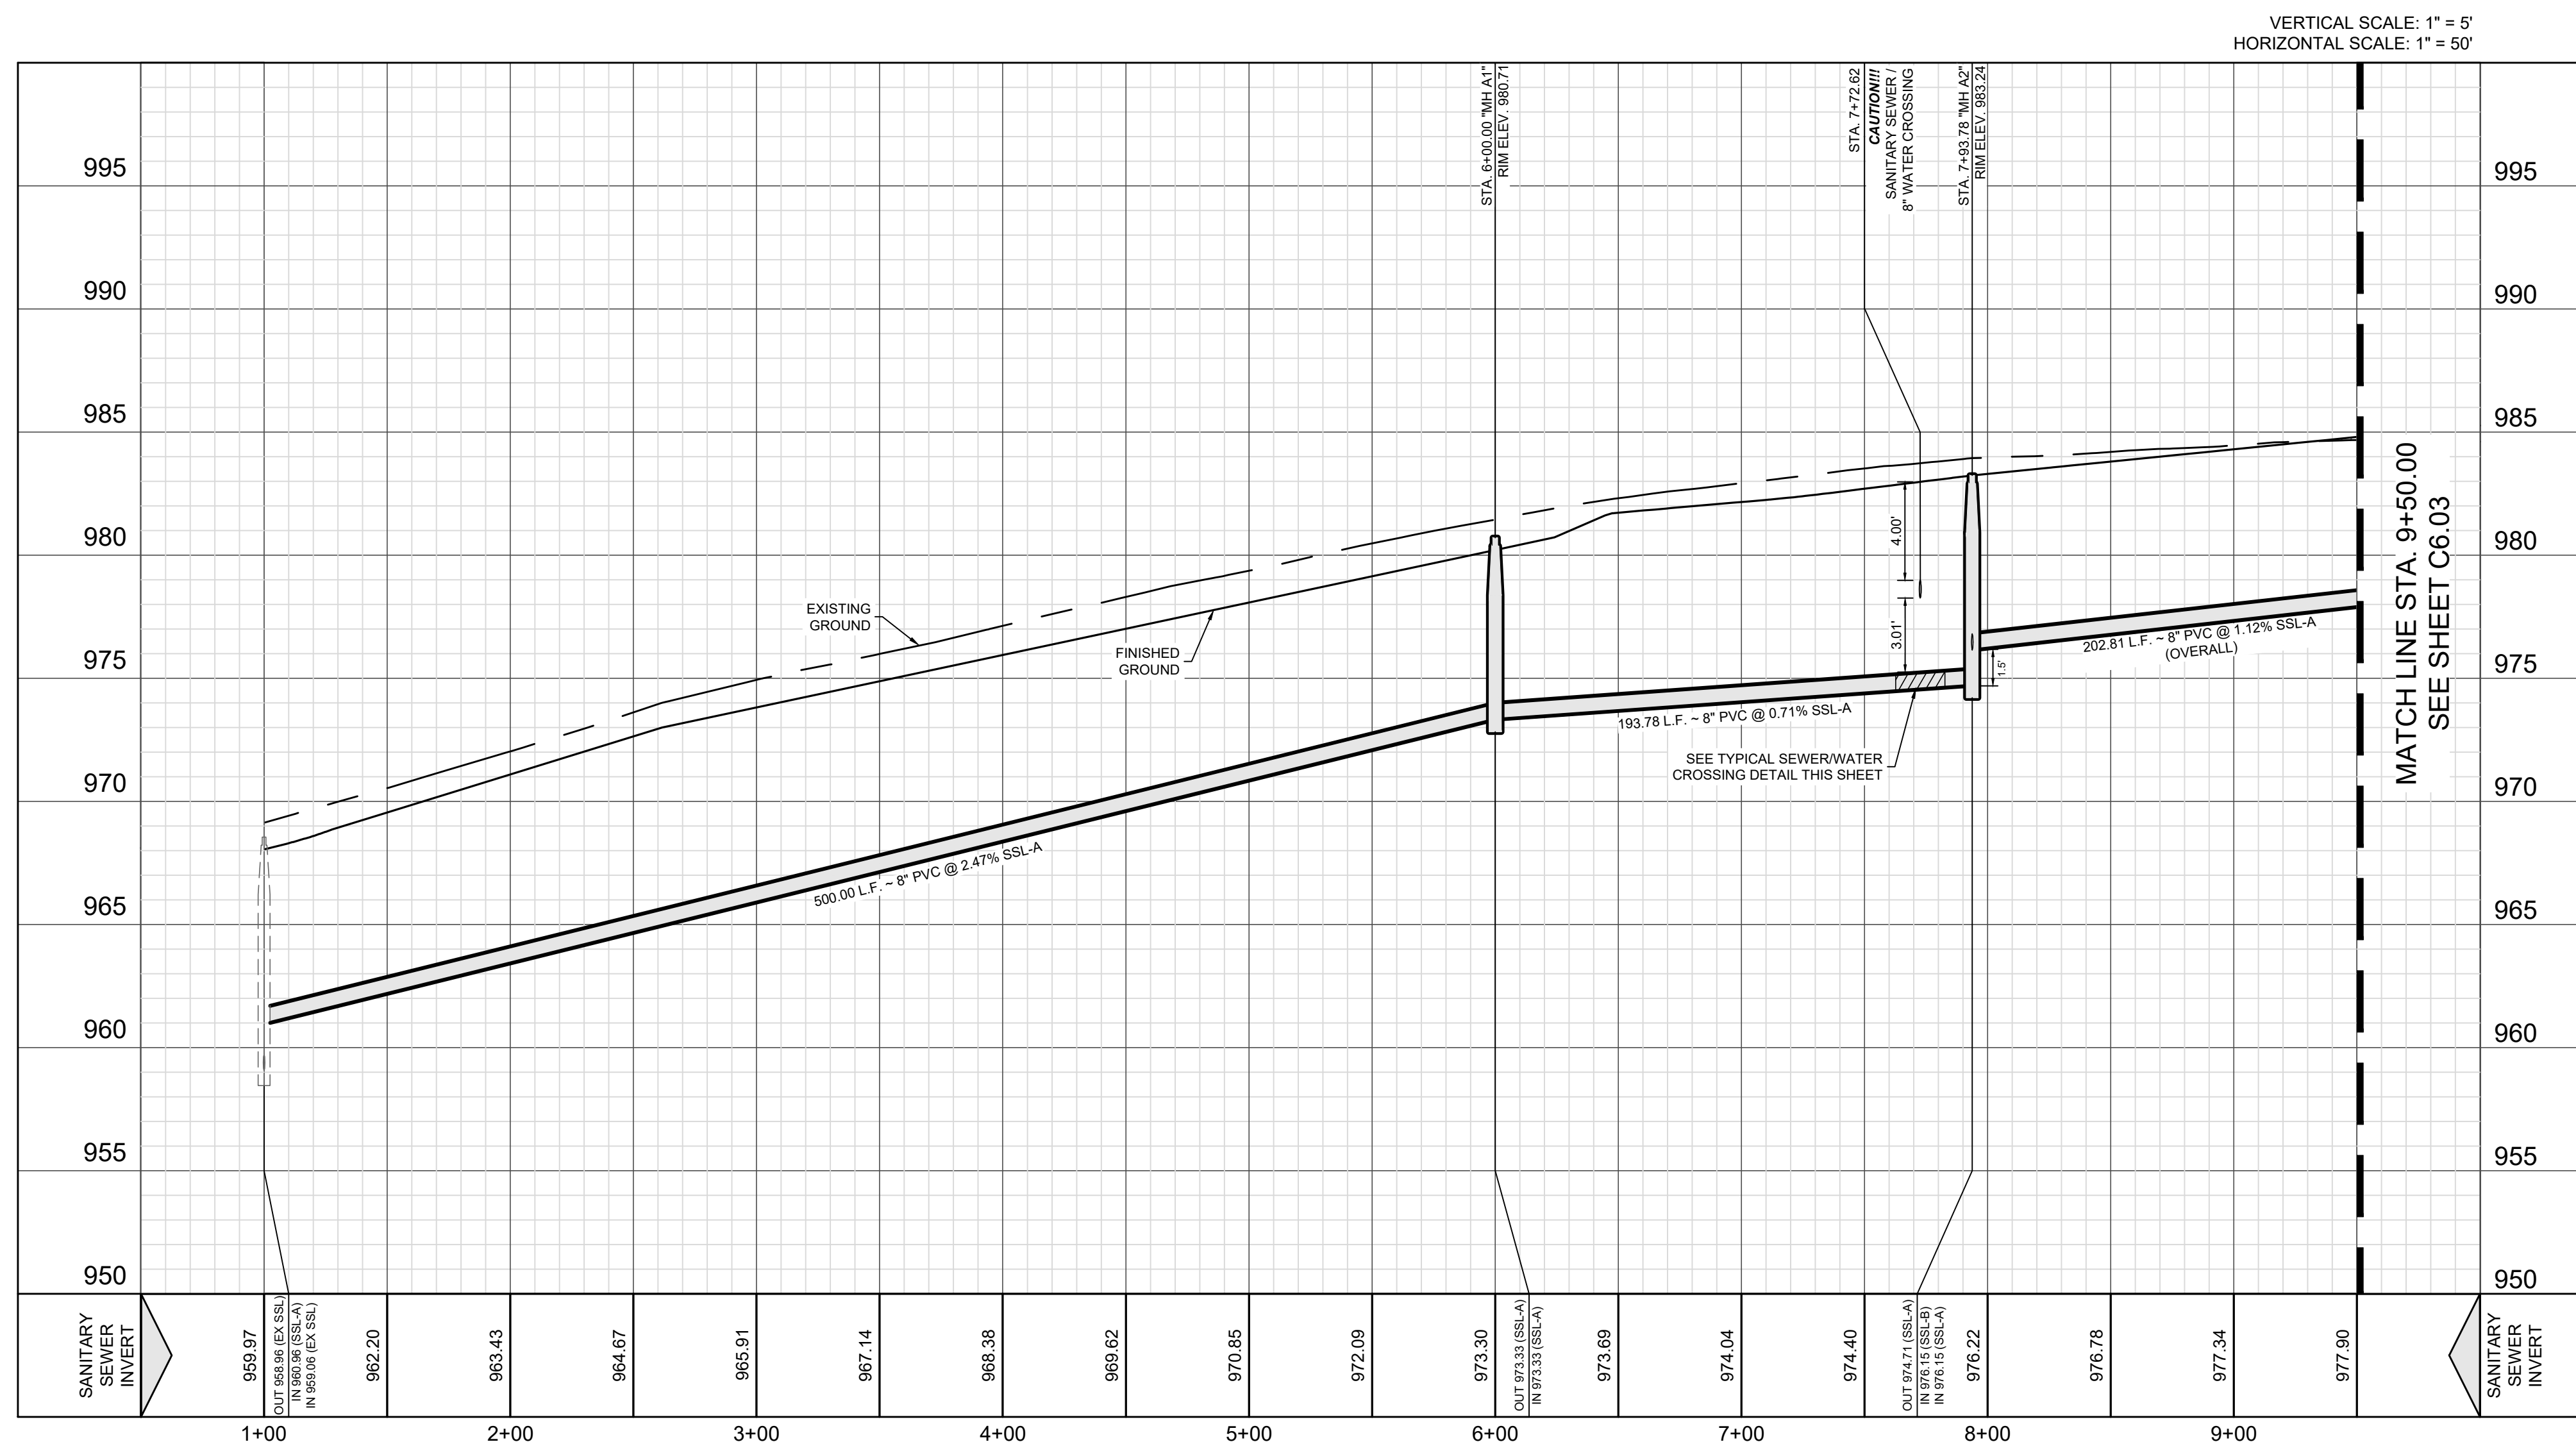




TYPICAL SANITARY  
SEWER/WATER CROSSING DETAIL  
NOT-TO-SCALE

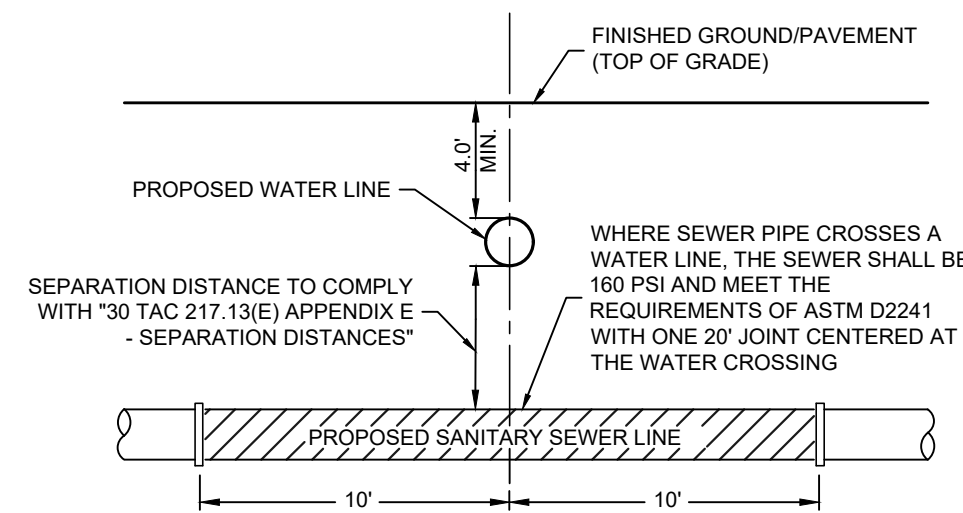

SSL-A  
STA. 1+00.00 TO 9+50.00

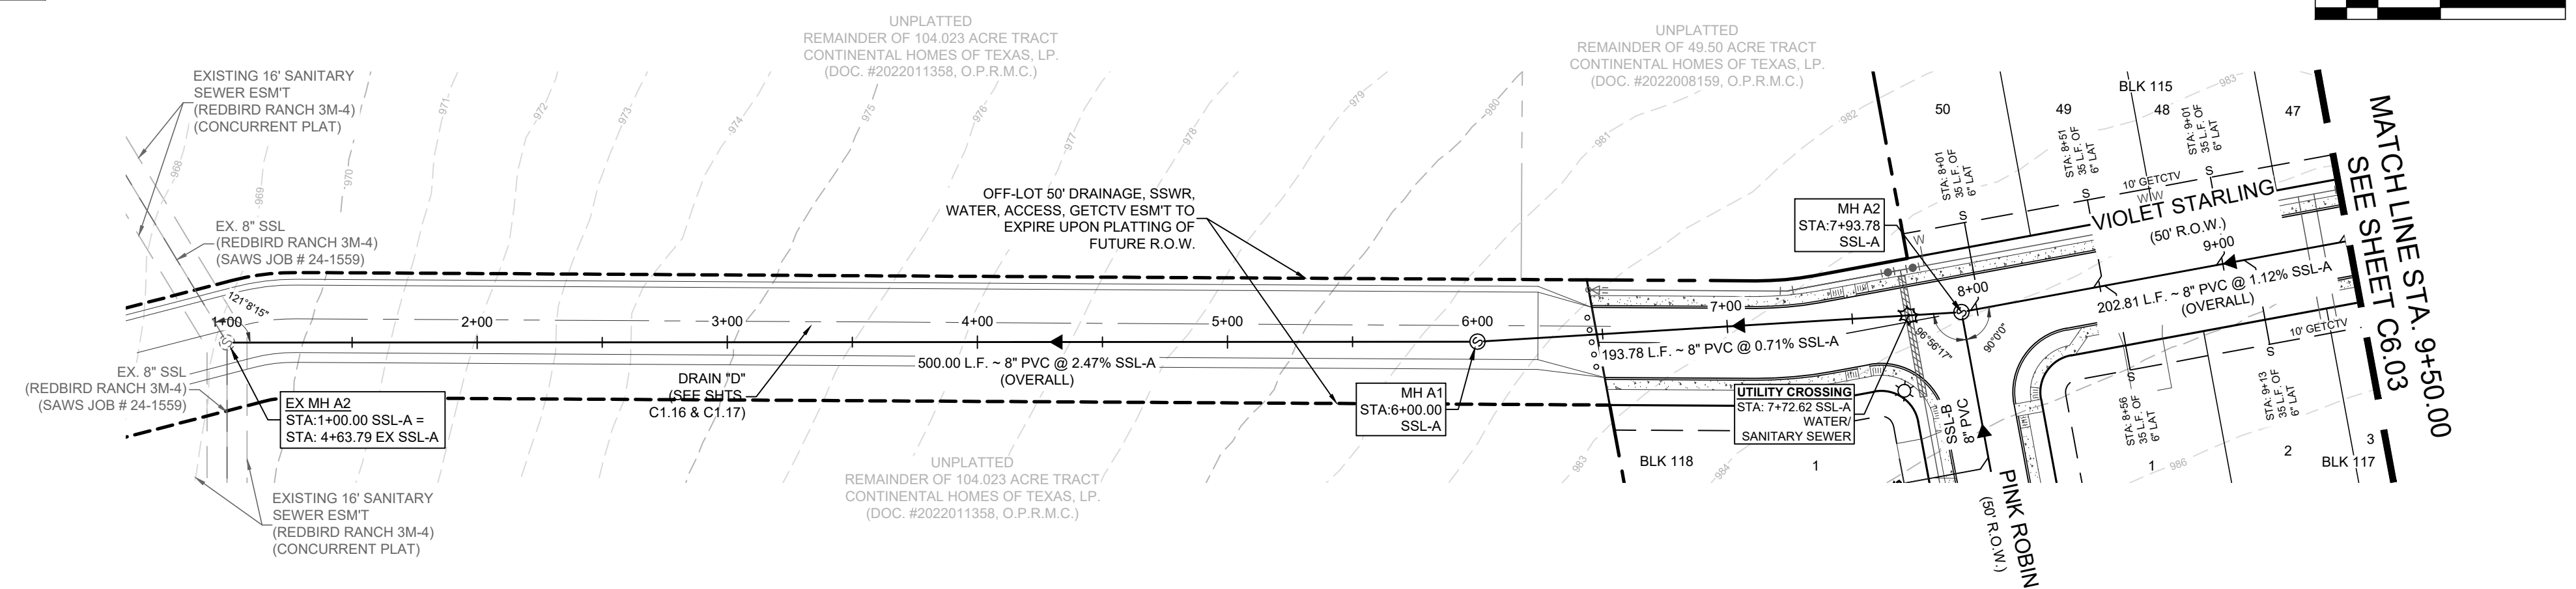

SEWER: SAWS MEDIO CREEK WRC

DEVELOPER'S NAME: CONTINENTAL HOMES OF TEXAS, L.P.  
ADDRESS: 5419 N. LOOP 1604 EAST  
CITY: SAN ANTONIO STATE: TEXAS ZIP: 78242  
PHONE # (210) 496-2668 FAX # (210) 496-2668  
SAWS BLOCK MAP # 062588 TOTAL EDUS: 89 TOTAL ACREAGE: 20.2975  
TOTAL LINEAR FOOTAGE OF PIPE: 3,625 L.F. (8') DOC. NO: (MEDINA COUNTY)  
NUMBER OF LOTS: 89 SAWS JOB NO: 24-1513

DESIGNED BY:	JWS
DRAWN BY:	SQV/JWS
DATE:	5/21/2024
JOB NO.:	05000-200
SHEET NO.	

## C6.02

REDBIRD RANCH UNIT 2M-2  
SAN ANTONIO, TX  
SANITARY SEWER LINE A -  
STA. 1+00.00 - 9+50.00

## TRENCH EXCAVATION PROTECTION

CONTRACTOR AND CONTRACTOR'S INDEPENDENTLY RETAINED EMPLOYEE OR STRUCTURAL DESIGN, GEOTECHNICAL, SAFETY, EQUIPMENT CONSULTANT, IF ANY, SHALL REVIEW THESE PLANS AND ANY AVAILABLE GEOTECHNICAL INFORMATION AND THE ADEQUACY OF THE PROPOSED TRENCH EXCAVATION SAFETY PROTECTION SYSTEM. IMPLEMENT CONTRACTOR'S TRENCH EXCAVATION SAFETY PROTECTION SYSTEM PROGRAMS AND/OR PROCEDURES FOR THE PROJECT DESCRIBED IN THE CONTRACT DOCUMENTS AND THE CONTRACTOR'S IMPLEMENTATION OF THESE SYSTEMS, PROGRAMS, AND PROCEDURES SHALL BE THE PROJECT'S DESIGNATED TRENCH EXCAVATION SAFETY PROTECTION SYSTEM. THE PROJECT'S DESIGNATED TRENCH EXCAVATION SAFETY PROTECTION SYSTEM SHALL MEET AT A MINIMUM THE AASHTO STANDARDS FOR TRENCH EXCAVATIONS SPECIFICALLY. CONTRACTOR AND CONTRACTOR'S INDEPENDENTLY RETAINED EMPLOYEE OR SAFETY CONSULTANT SHALL IMPLEMENT A TRENCH SAFETY PROGRAM OCCURRING AT THE PROJECT'S DESIGNATED TRENCH EXCAVATION AND ACTIVITIES OF INDIVIDUALS WORKING IN AND AROUND TRENCH EXCAVATION.

**CAUTION!!**

CONTRACTOR SHALL BE REQUIRED TO LOCATE ALL PUBLIC OR PRIVATE UTILITIES INCLUDING BUT NOT LIMITING TO: WATER, SEWER, TELEPHONE AND FIBER OPTIC LINES, SITE LIGHTING ELECTRICAL AND/OR ELECTRICAL PRIMARY ELECTRICAL DISTRIBUTION, LANDSCAPE IRRIGATION FACILITIES, AND GAS LINES. ANY UTILITY CONFLICTS THAT ARISE SHOULD BE COMMUNICATED TO THE ENGINEER IMMEDIATELY AND PRIOR TO CONSTRUCTION. THE CONTRACTOR SHALL CONTACT 1-800-DIG-TESS A MINIMUM OF 48 HOURS PRIOR TO THE START OF CONSTRUCTION, ANY DAMAGE TO EXISTING UTILITIES SHALL BE THE SOLE RESPONSIBILITY OF THE CONTRACTOR AND THE REPAIR SHALL BE AT CONTRACTOR'S EXPENSE WHETHER THE UTILITY IS SHOWN ON THESE PLANS OR NOT.

FINISHED FLOOR NOTES:

1. THE FINISHED FLOOR ELEVATIONS (FF) REPRESENT THE MINIMUM POSSIBLE FLOOR ELEVATION TO PROVIDE SANITARY SEWER SERVICE TO EACH LOT. ACTUAL FF FOR EACH LOT ARE TO BE DETERMINED BY THE BUILDER AND SHALL TAKE INTO CONSIDERATION AS-BUILT FOR FINAL SEWER SERVICES AND ACTUAL LATERAL ALIGNMENT. IT IS THE BUILDER'S SOLE RESPONSIBILITY TO DETERMINE THE FINISHED FLOOR ELEVATIONS FOR EACH LOT PRIOR TO THE START OF THE HOME FOUNDATION CONSTRUCTION TAKING INTO CONSIDERATION SITE DRAINAGE, STREET ACCESS AND SANITARY SEWER SERVICE ELEVATION.
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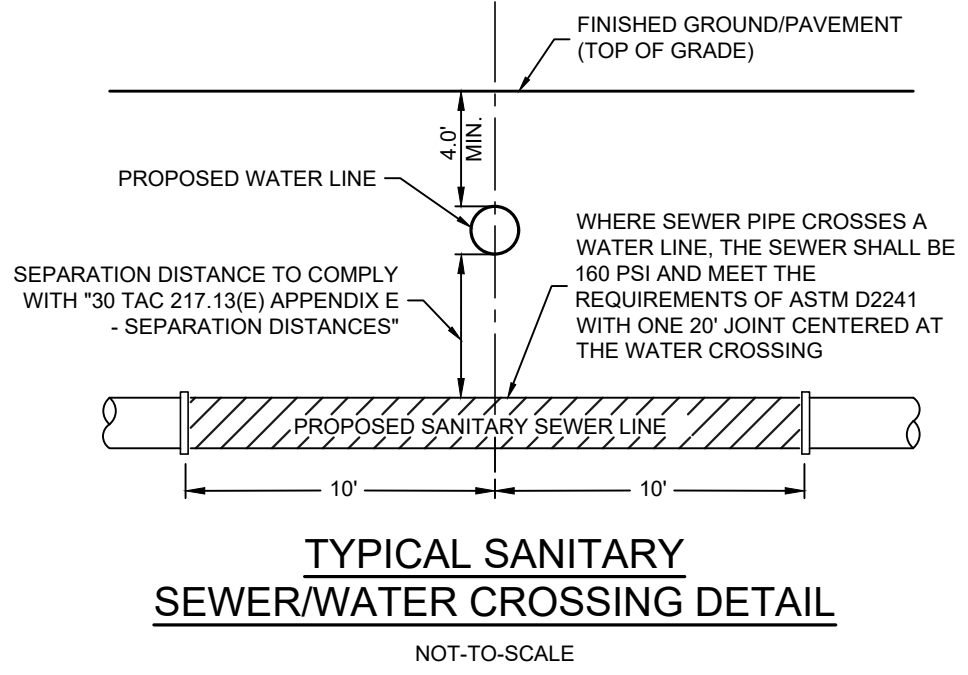
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AND FINAL LOT DESIGN.

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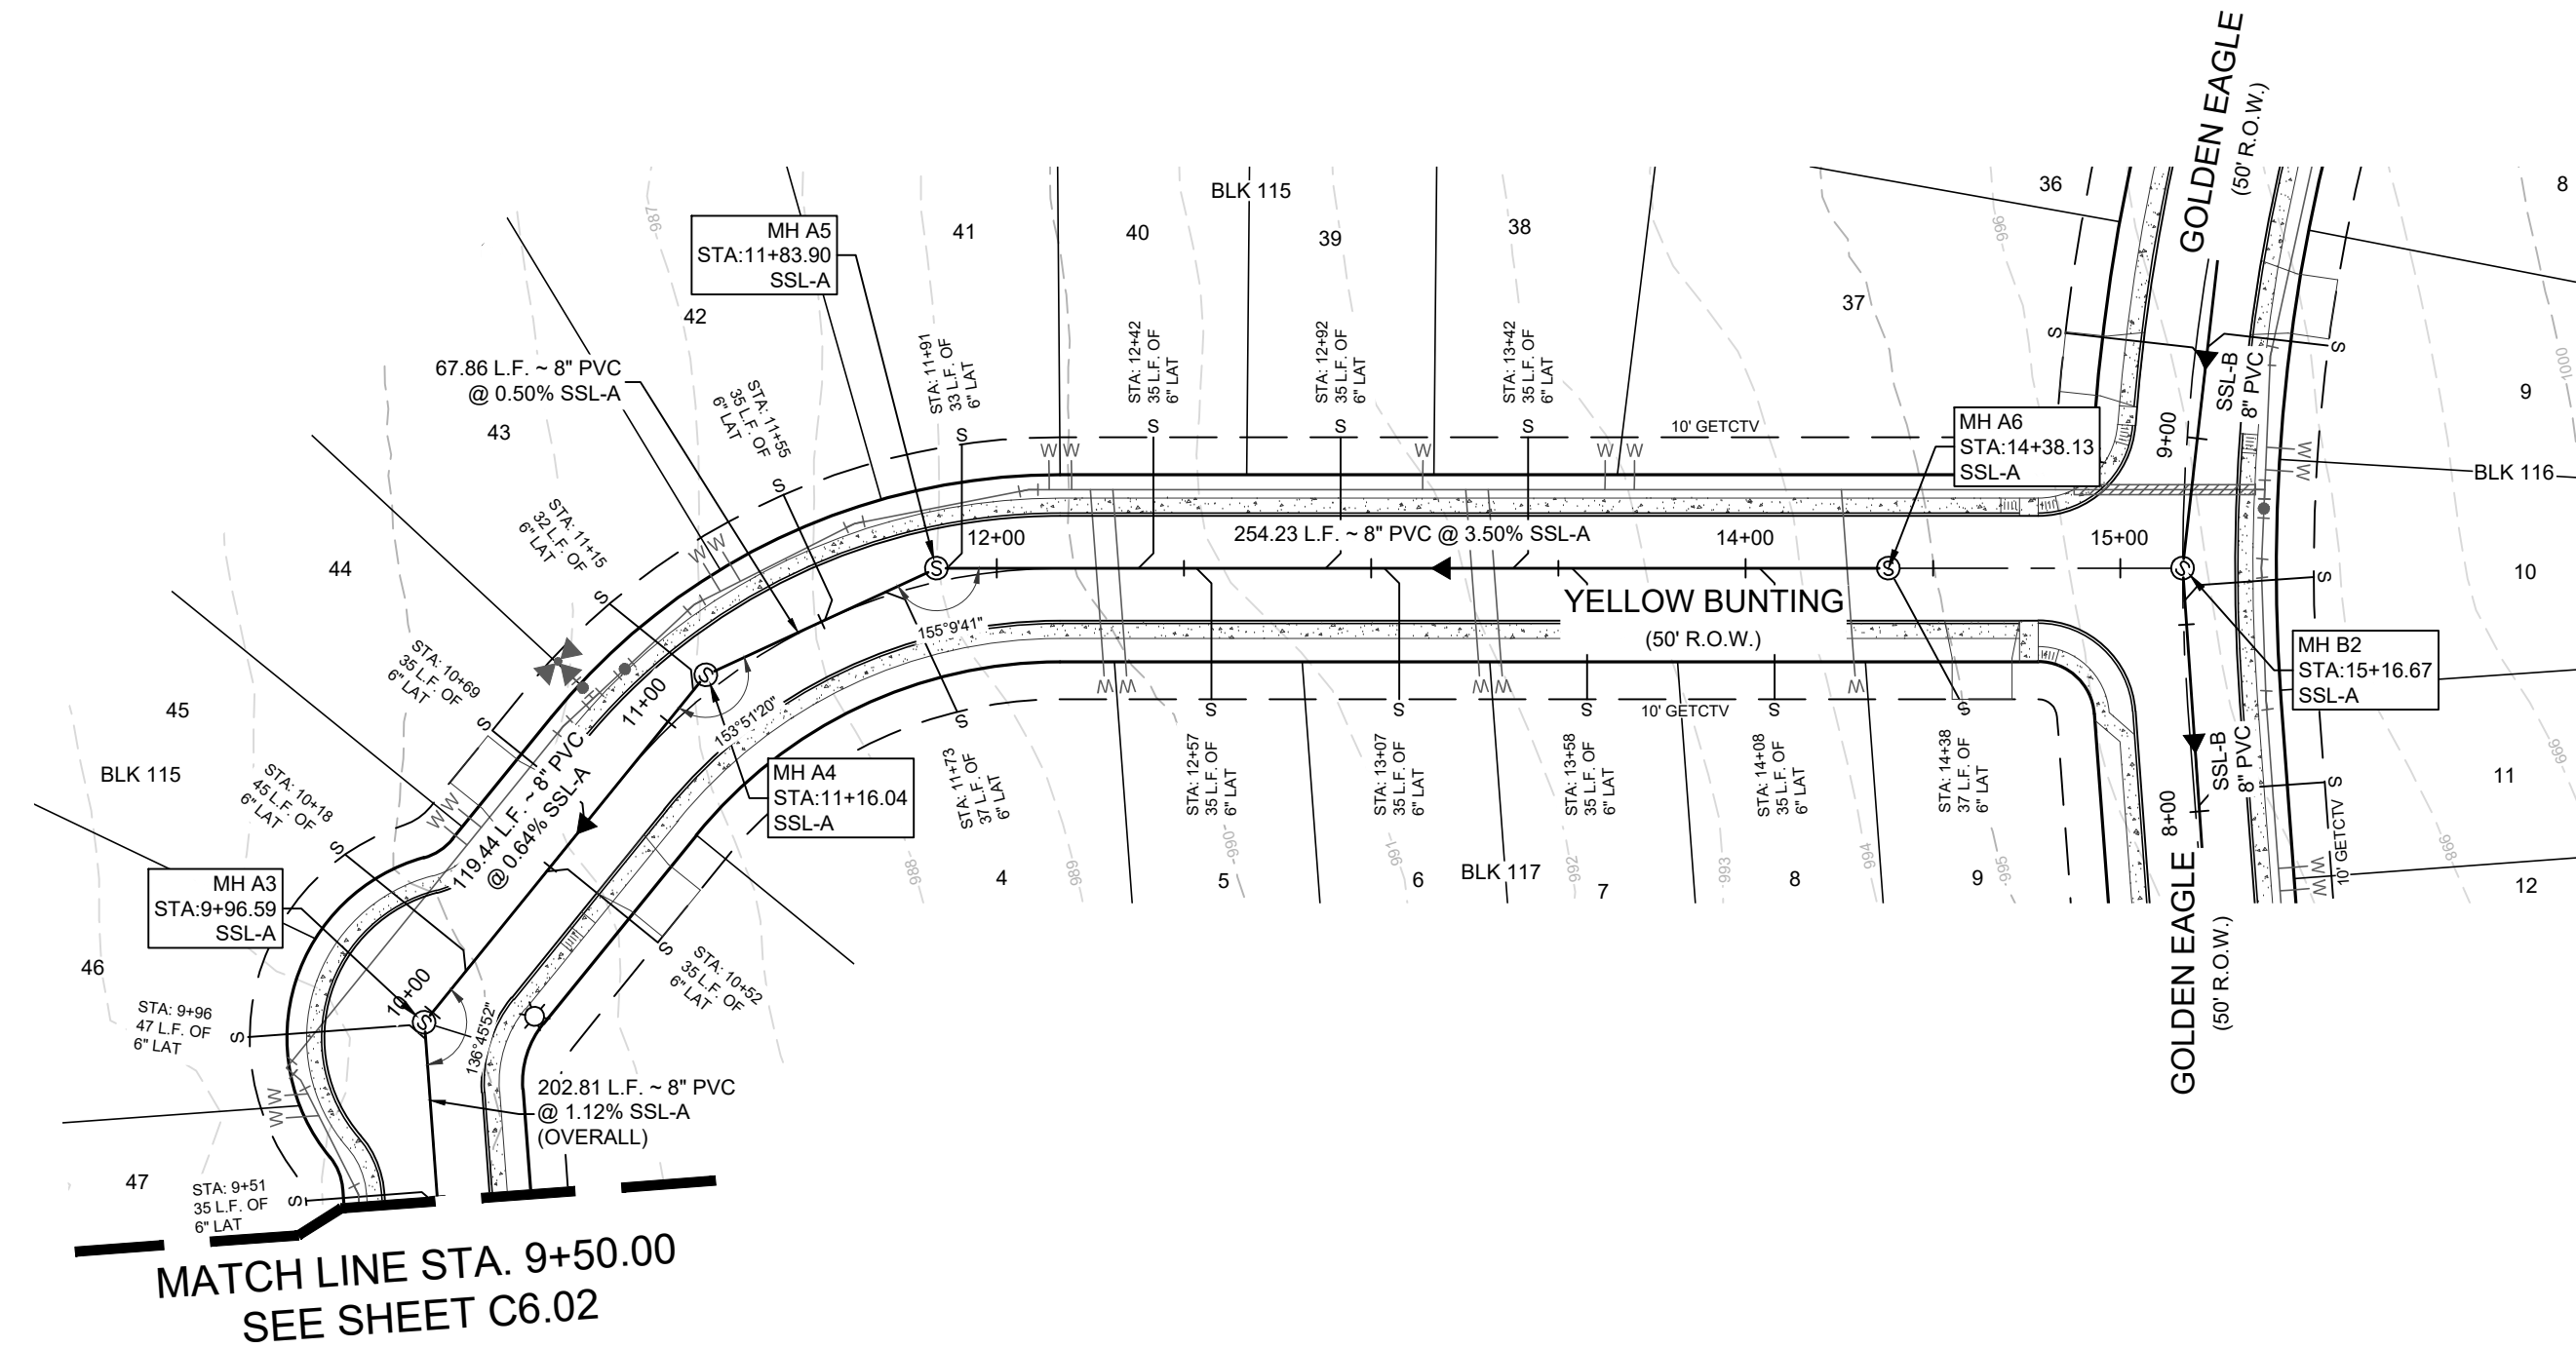


**TRENCH EXCAVATION PROTECTION**




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







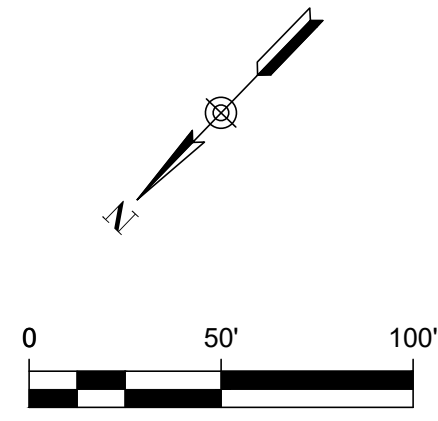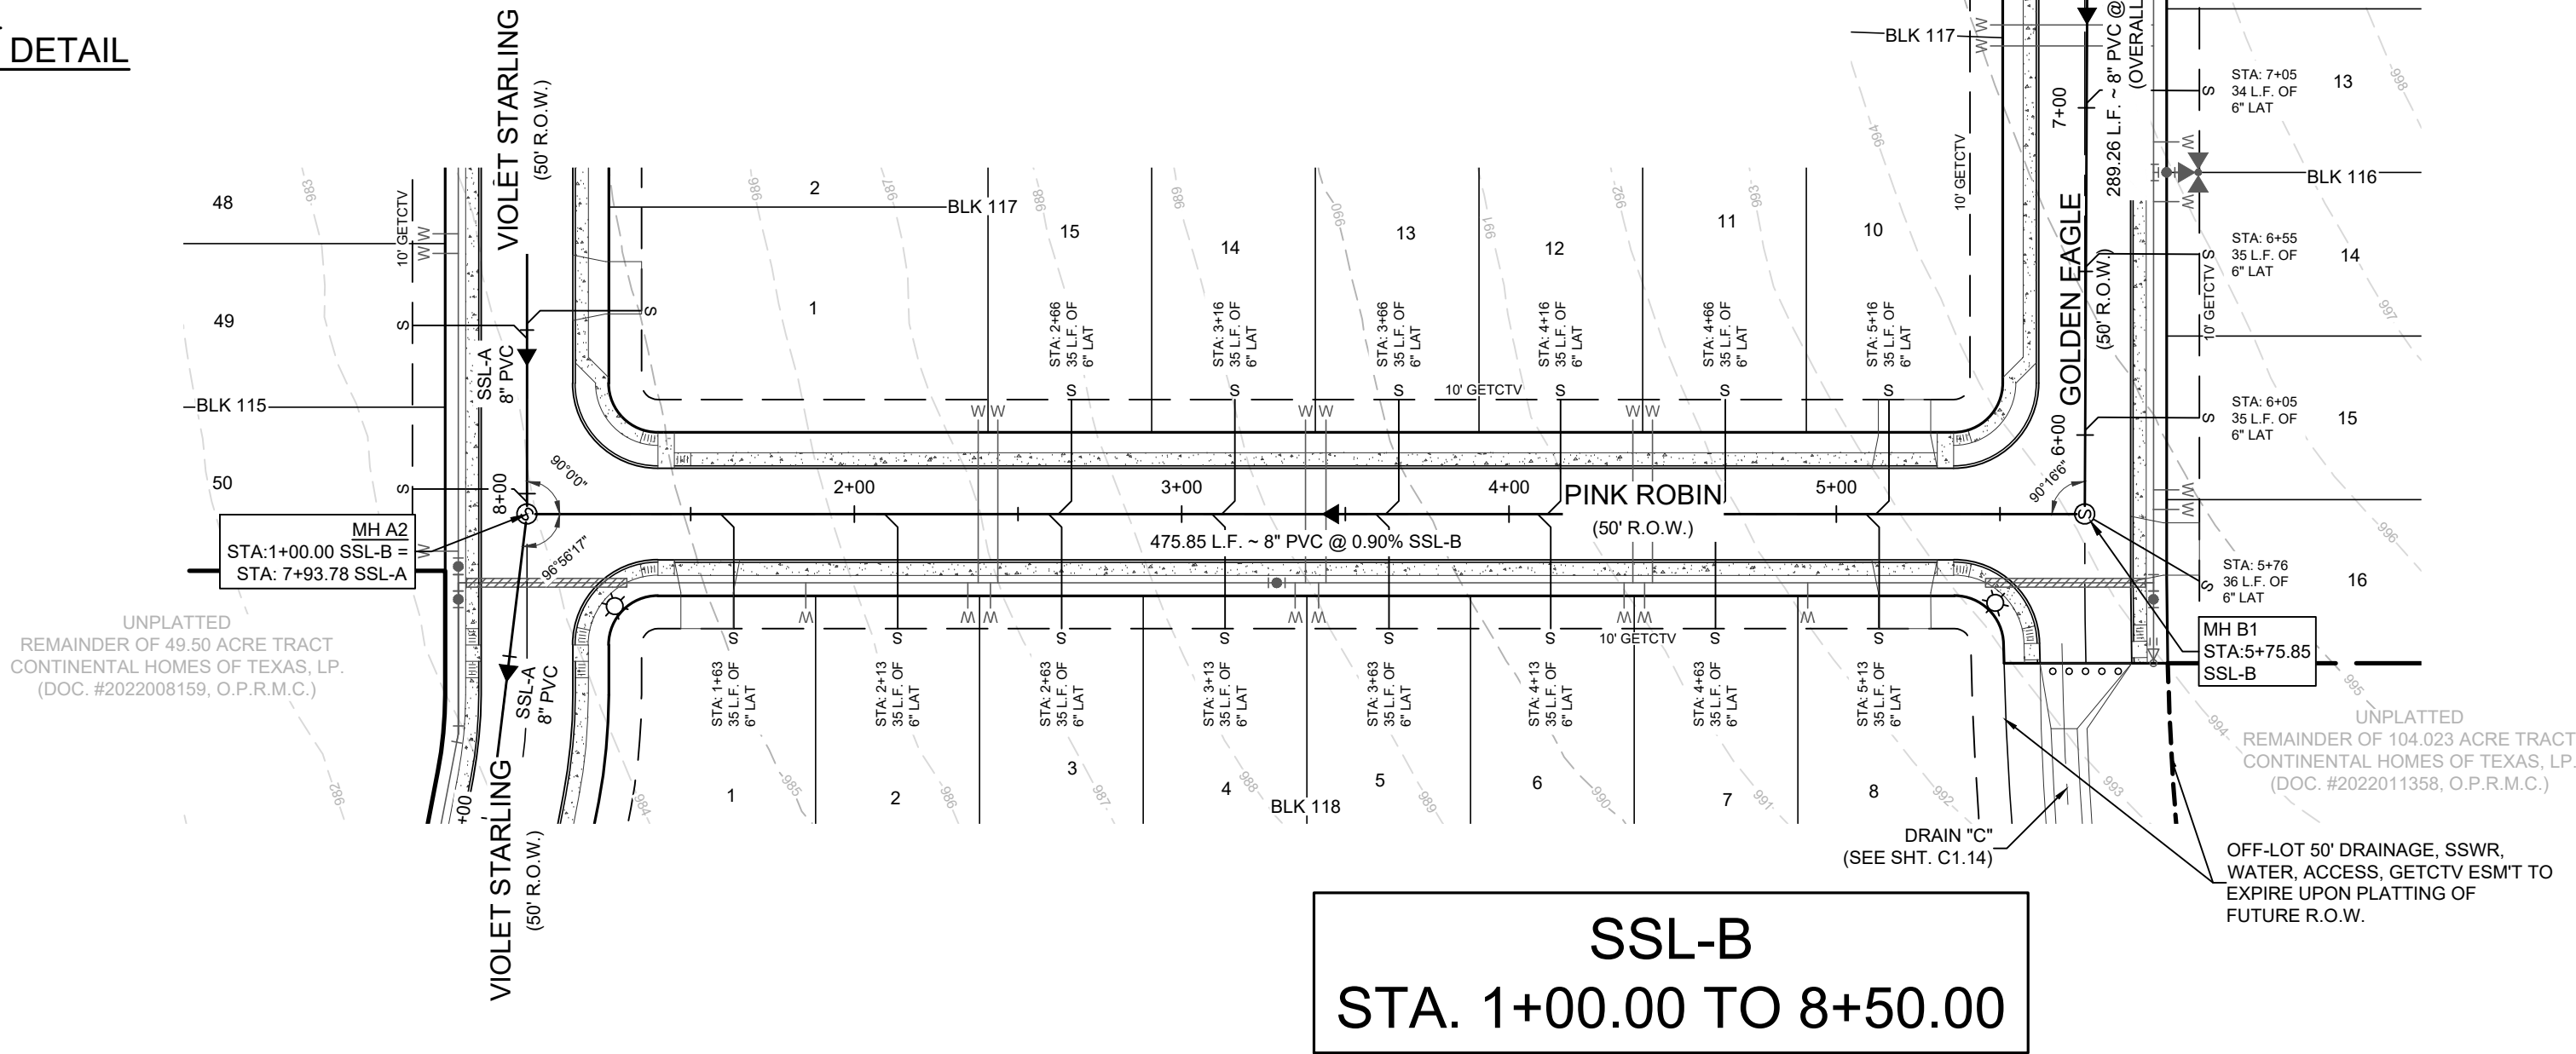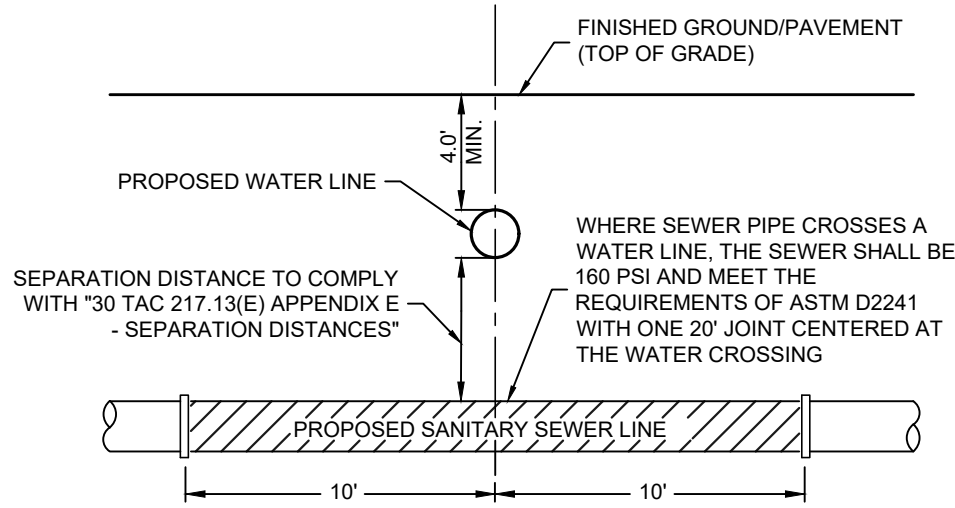


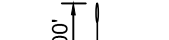


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LEGEND (SANITARY SEWER)	
	PROJECT LIMITS
	OFFSITE EASEMENT
	PROPOSED WATER
	PROPOSED 2" HDPE WATER
	PROPOSED SEWER
	EXISTING WATER
	EXISTING SEWER
	PROPOSED MANHOLE
	EXISTING MANHOLE
	FIRE HYDRANT
	DUEL WATER SERVICE
	SINGLE WATER SERVICE
	PROPOSED WYE & LATERAL
	VERTICAL STACK

**TRENCH EXCAVATION PROTECTION**

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**FINISHED FLOOR NOTES:**

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2. THE MINIMUM SANITARY SEWER LATERAL GRADES WERE BASED UPON THE MINIMUM FINISHED FLOOR ELEVATIONS FOR THE LOTS LOCATED ON THE DOWNHILL SIDES OF THE PROPOSED ROADWAYS.

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SEWER: SAWS MEDIO CREEK WRC

DEVELOPER'S NAME: CONTINENTAL HOMES OF TEXAS, L.P.  
ADDRESS: 5419 N. LOOP 1604 EAST  
CITY: SAN ANTONIO STATE: TEXAS ZIP: 78247  
PHONE # (210) 496-2668 FAX # (210) 496-2668  
SAWS BLOCK MAP # 062586 TOTAL EDUS: 89 TOTAL ACREAGE: 20.795  
TOTAL LINEAR FOOTAGE OF PIPE: 3,625 L.F. (87) DOC. NO: (MEDINA COUNTY)  
NUMBER OF LOTS: 89 SAWS JOB NO: 24-1513

REDBIRD RANCH UNIT 2M-2  
SAN ANTONIO, TX  
SANITARY SEWER LINE B -  
STA. 1+00.00 - 8+50.00

DESIGNED BY: JWS  
DRAWN BY: SQV/JWS  
DATE: 3/20/2024  
JOB NO.: 05000-200  
SHEET NO. C6.04


DHI Engineering, LLC.  
4419 N. LOOP 1604 EAST  
SAN ANTONIO, TEXAS 78247  
(210) 496-2668 | dhiengineering.com  
TBP REG. NO. F-195661

DHI

3/20/2024  
Vance L. Weynand  
Professional Engineer  
No. 99269  
State of Texas

REDBIRD RANCH UNIT 2M-2  
DOC. # XXXXXXXXXX



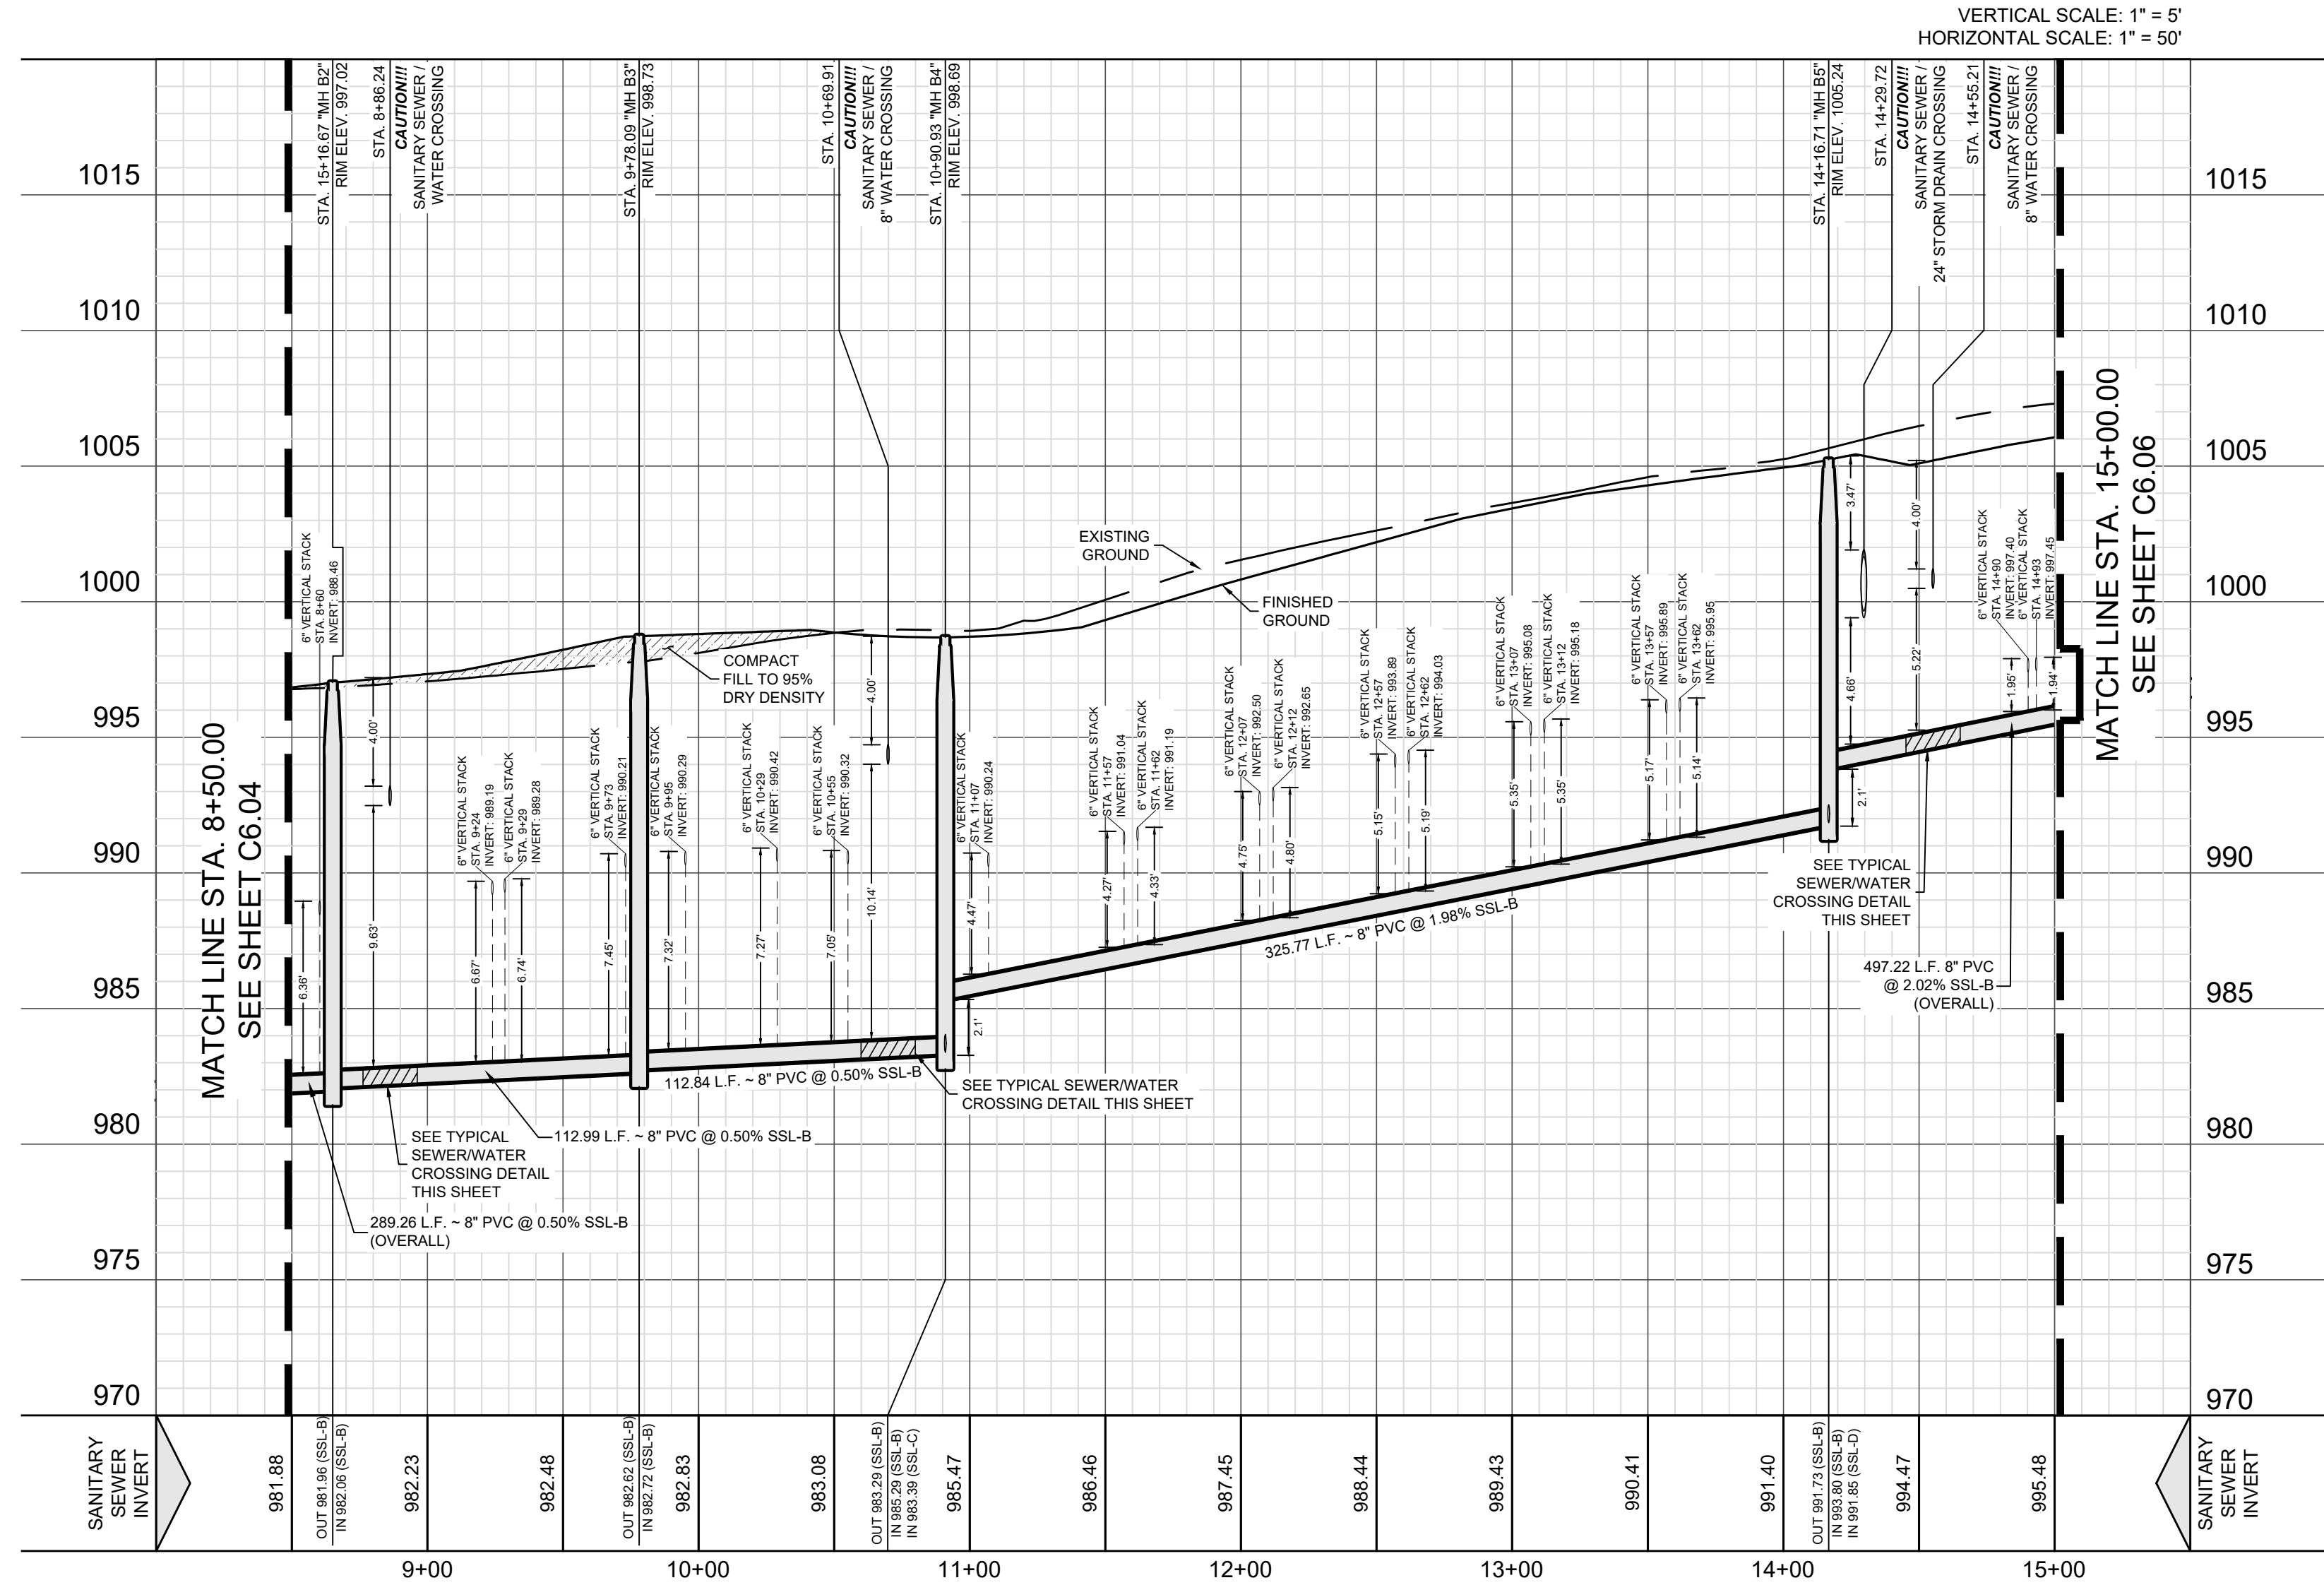

**TRENCH EXCAVATION PROTECTION**



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**CAUTION!!!**


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DESIGNED BY:	JWS
DRAWN BY:	SQV/JWS
DATE:	5/31/2024
JOB NO.:	05000-200
SHEET NO.	

## C6.05

[illegible]

5/31/2024

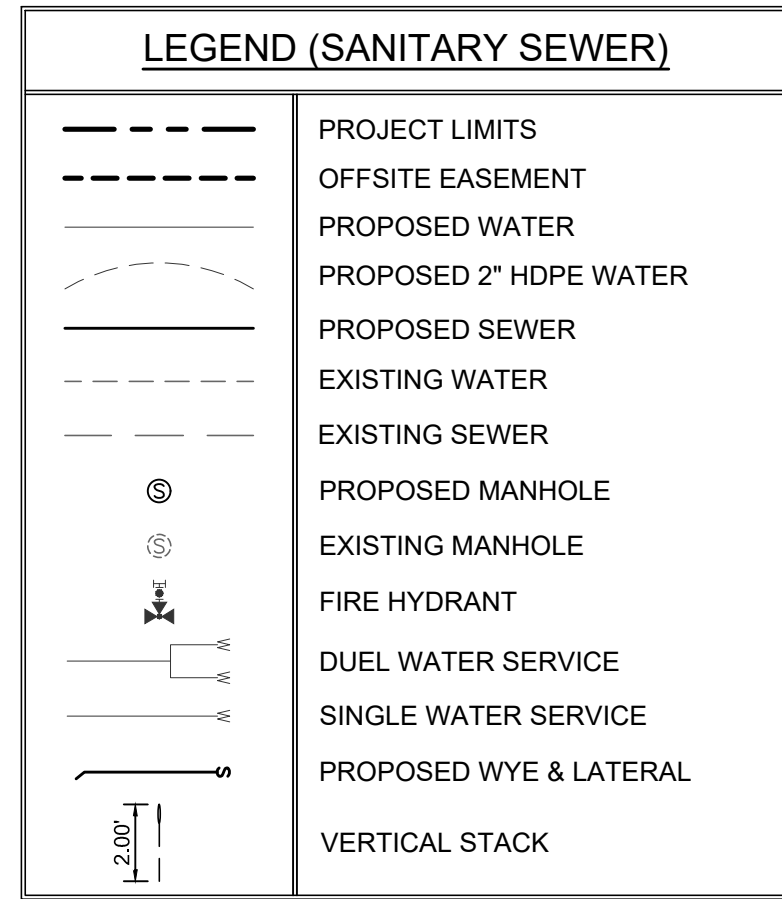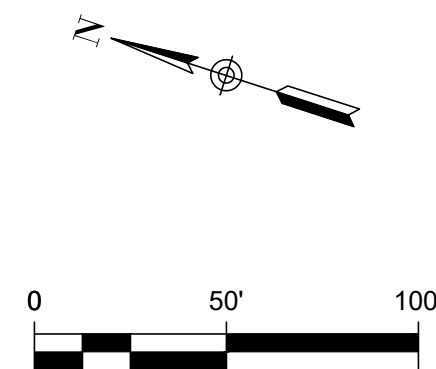

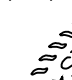
Vance Weynand

**DHI**  
**DHI Engineering, LLC.**  
5419 N. LOOP 1604 EAST  
SAN ANTONIO, TX 78247  
(210) 496-2668 | [dhiengineering.com](http://dhiengineering.com)  
TBPB REG. NO. F-19561


REDBIRD RANCH UNIT 2M-2  
SAN ANTONIO, TX  
SANITARY SEWER LINE B -  
STA. 8+50.00 - 15+00.00

Date: May 31, 2024, 8:26am User ID: JMSMST File: E:\PROJECT\050000\200\800 - Design\930 - Streets\05.05 SANITARY SEWER LINE B - STA. 8+50.00 - 15+00.00.dwg



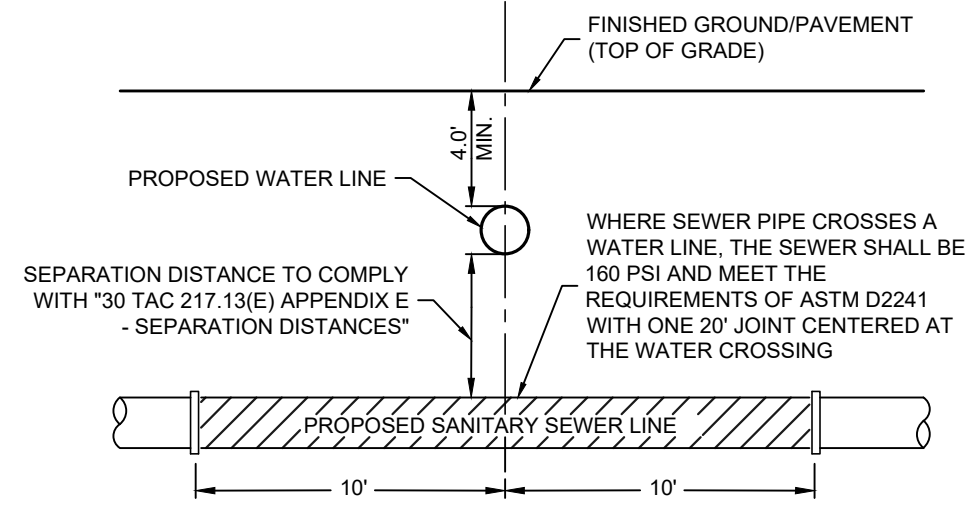




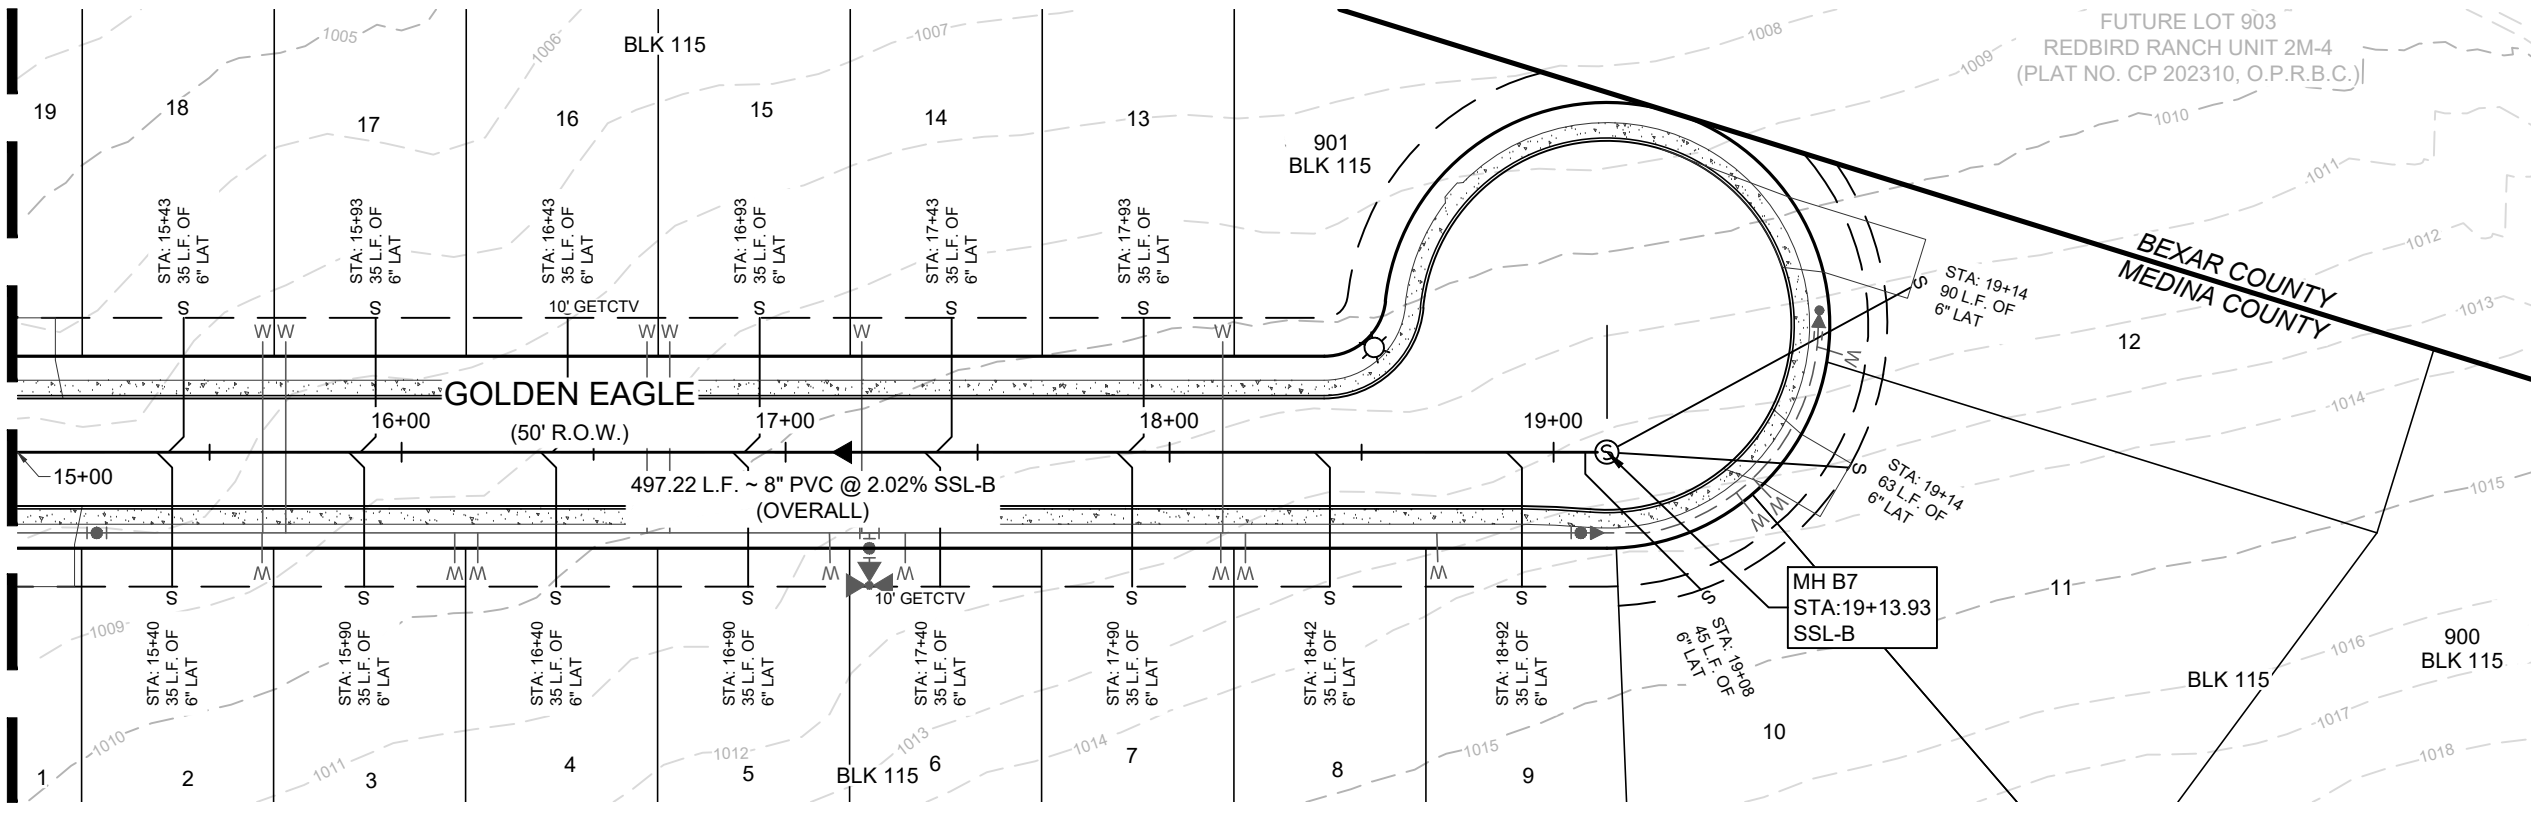





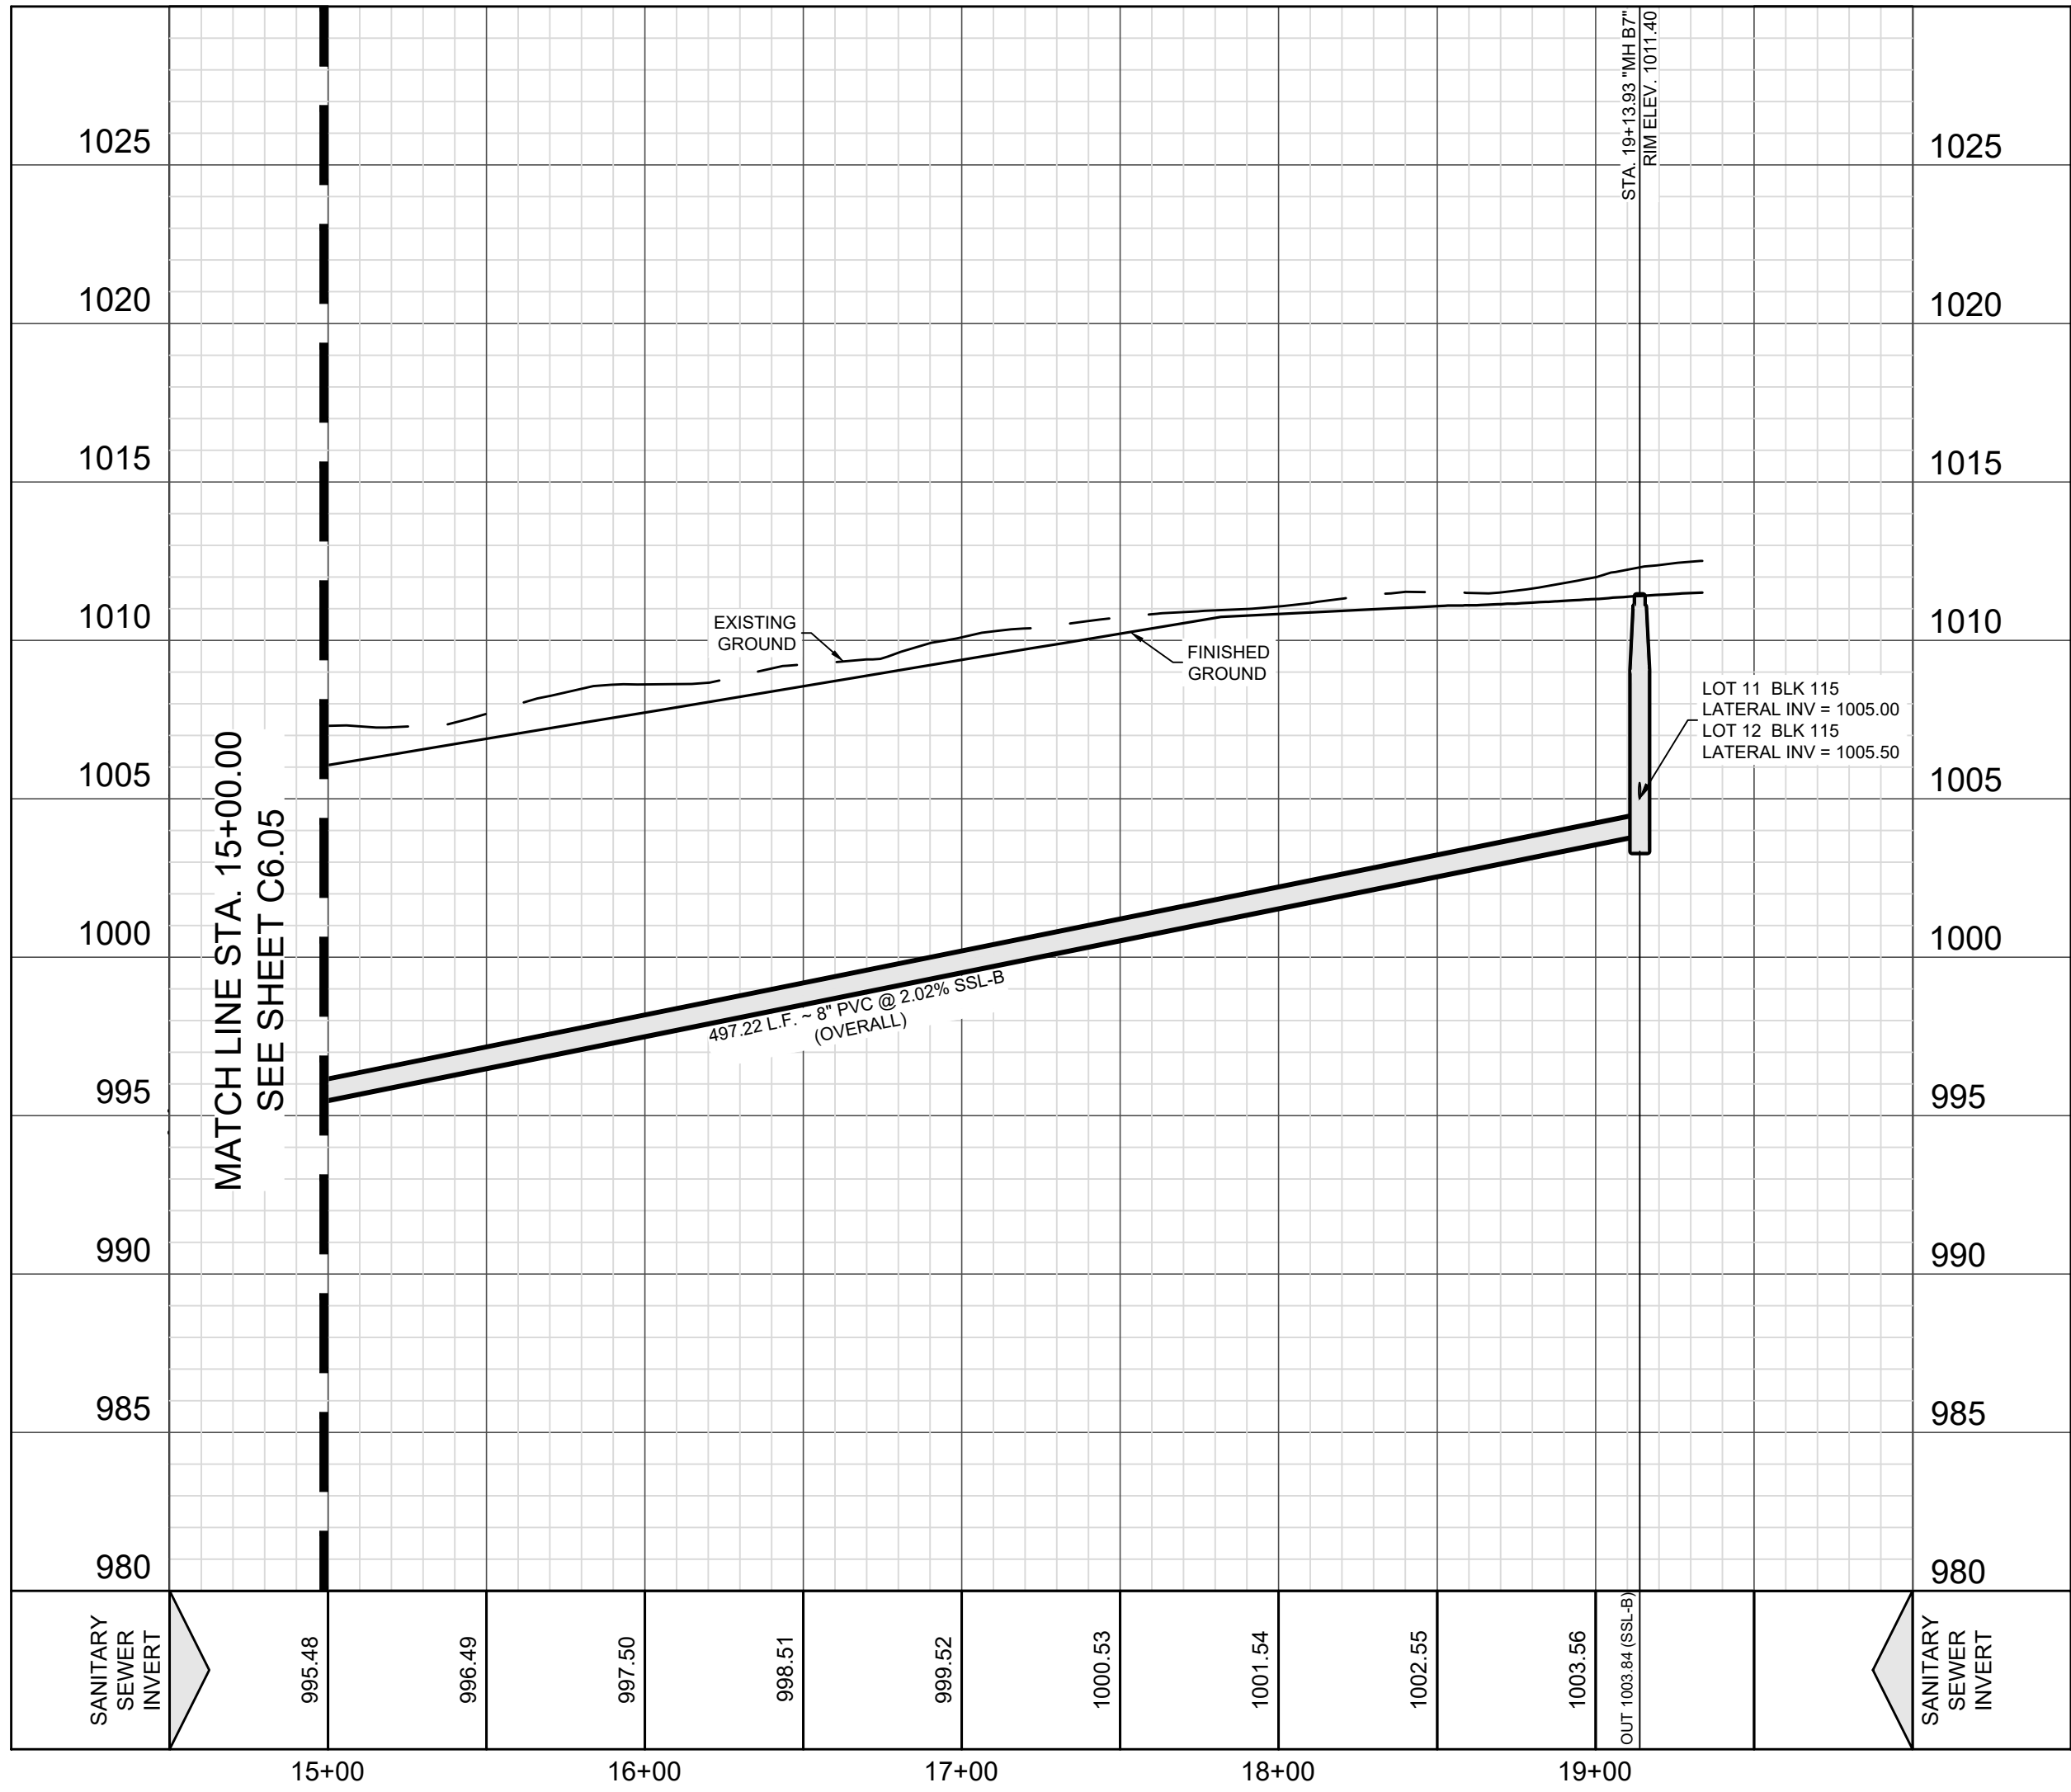





MATCH LINE STA. 15+00.00  
SEE SHEET C6.05



SSL-B  
STA. 15+00.00 TO 19+13.93

VERTICAL SCALE: 1" = 5'  
HORIZONTAL SCALE: 1" = 50'

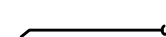

LEGEND (SANITARY SEWER)	
	PROJECT LIMITS
	OFFSITE EASEMENT
	PROPOSED WATER
	PROPOSED 2" HDPE WATER
	PROPOSED SEWER
	EXISTING WATER
	EXISTING SEWER
	PROPOSED MANHOLE
	EXISTING MANHOLE
	FIRE HYDRANT
	DUEL WATER SERVICE
	SINGLE WATER SERVICE
	PROPOSED WYE & LATERAL
	VERTICAL STACK

- FINISHED FLOOR NOTES:
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MEDINA COUNTY ROW NOTES:  
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#### SEWER: SAWS MEDIO CREEK WRC

DEVELOPER'S NAME: CONTINENTAL HOMES OF TEXAS, L.P.  
ADDRESS: 5419 N. LOOP 1604 EAST  
CITY: SAN ANTONIO STATE: TEXAS ZIP: 78247  
PHONE # (210) 496-2668 FAX # (210) 496-2668  
SAWS BLOCK MAP # 062586 TOTAL EDUS: 89 TOTAL ACREAGE: 20.795  
TOTAL LINEAR FOOTAGE OF PIPE: 3,625 L.F. (87) DOC. NO: (MEDINA COUNTY)  
NUMBER OF LOTS: 89 SAWS JOB NO: 24-1513

REDBIRD RANCH UNIT 2M-2

SANITARY SEWER LINE B - STA. 15+00.00 - 19+13.93

DESIGNED BY: JWS  
DRAWN BY: SQV/JWS  
DATE: 3/20/2024  
JOB NO.: 05000-200  
SHEET NO. C6.06

DHI Engineering, LLC.  
4419 N. LOOP 1604 EAST  
SAN ANTONIO, TEXAS 78247  
(210) 496-2668 | dhiengineering.com  
TBP REG. NO. F-195661

DHI

3/20/2024

99269

Vance L. Weynand

PROFESSIONAL ENGINEER

DESCRIPTION


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REV



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REDBIRD RANCH UNIT 2M-2








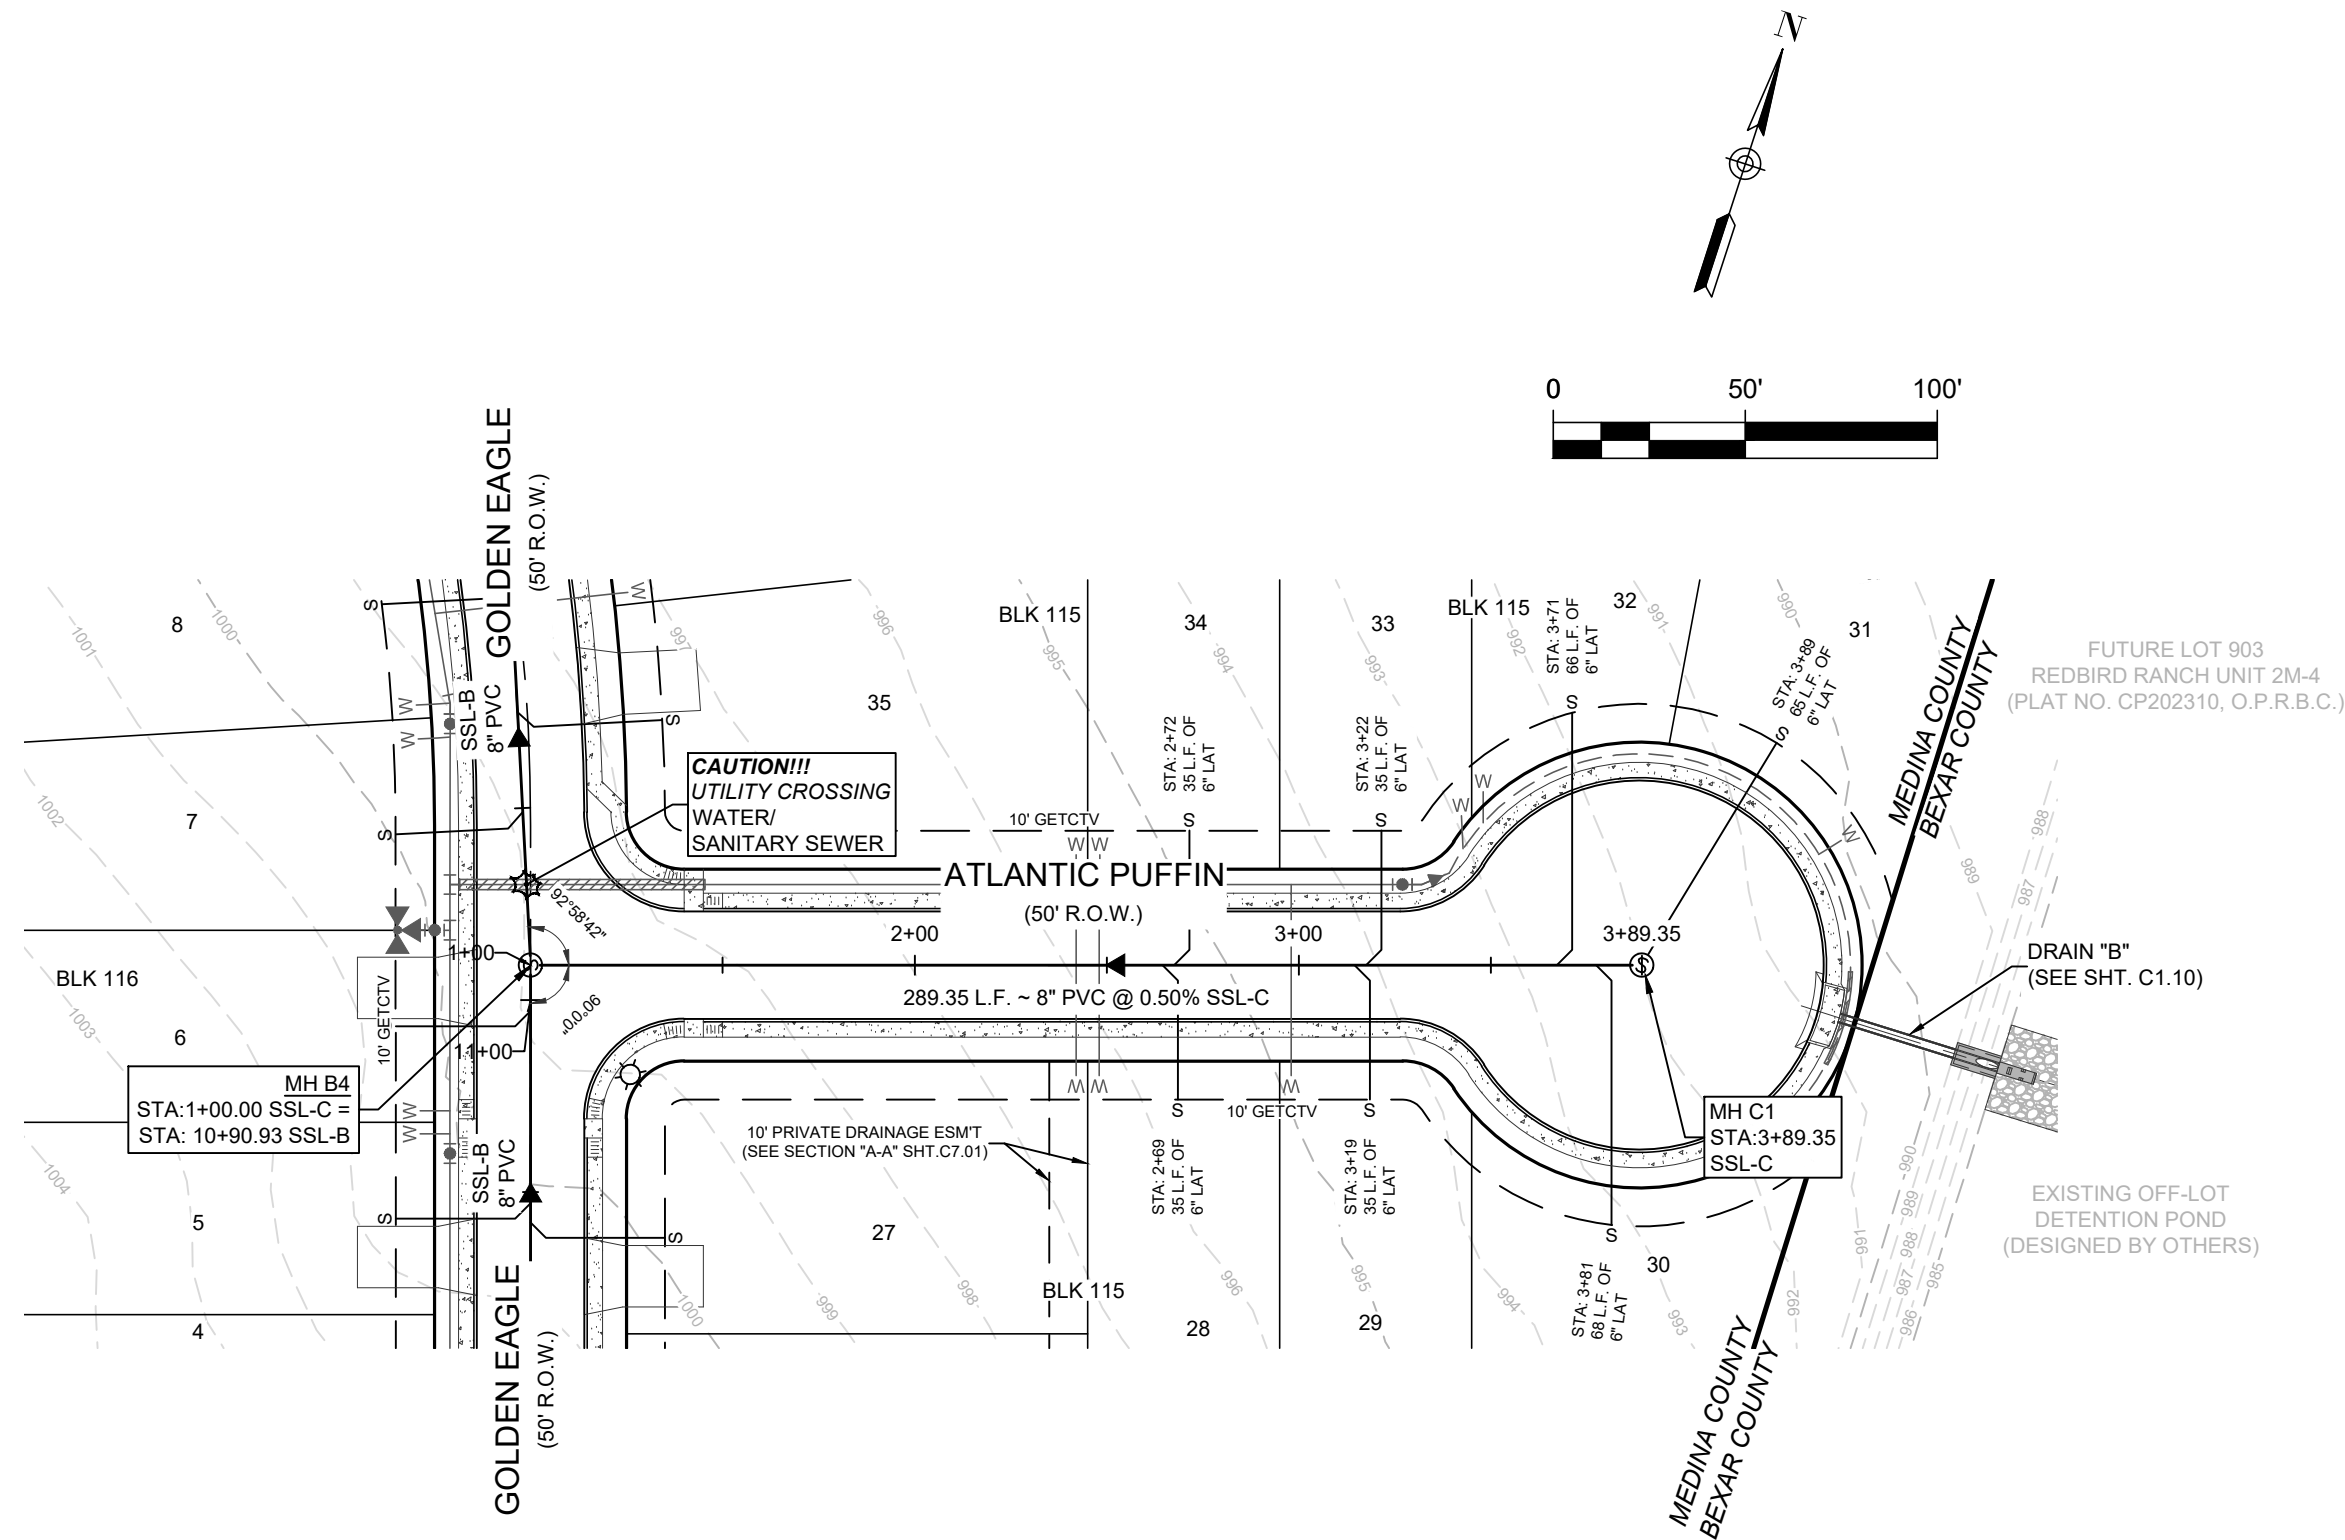

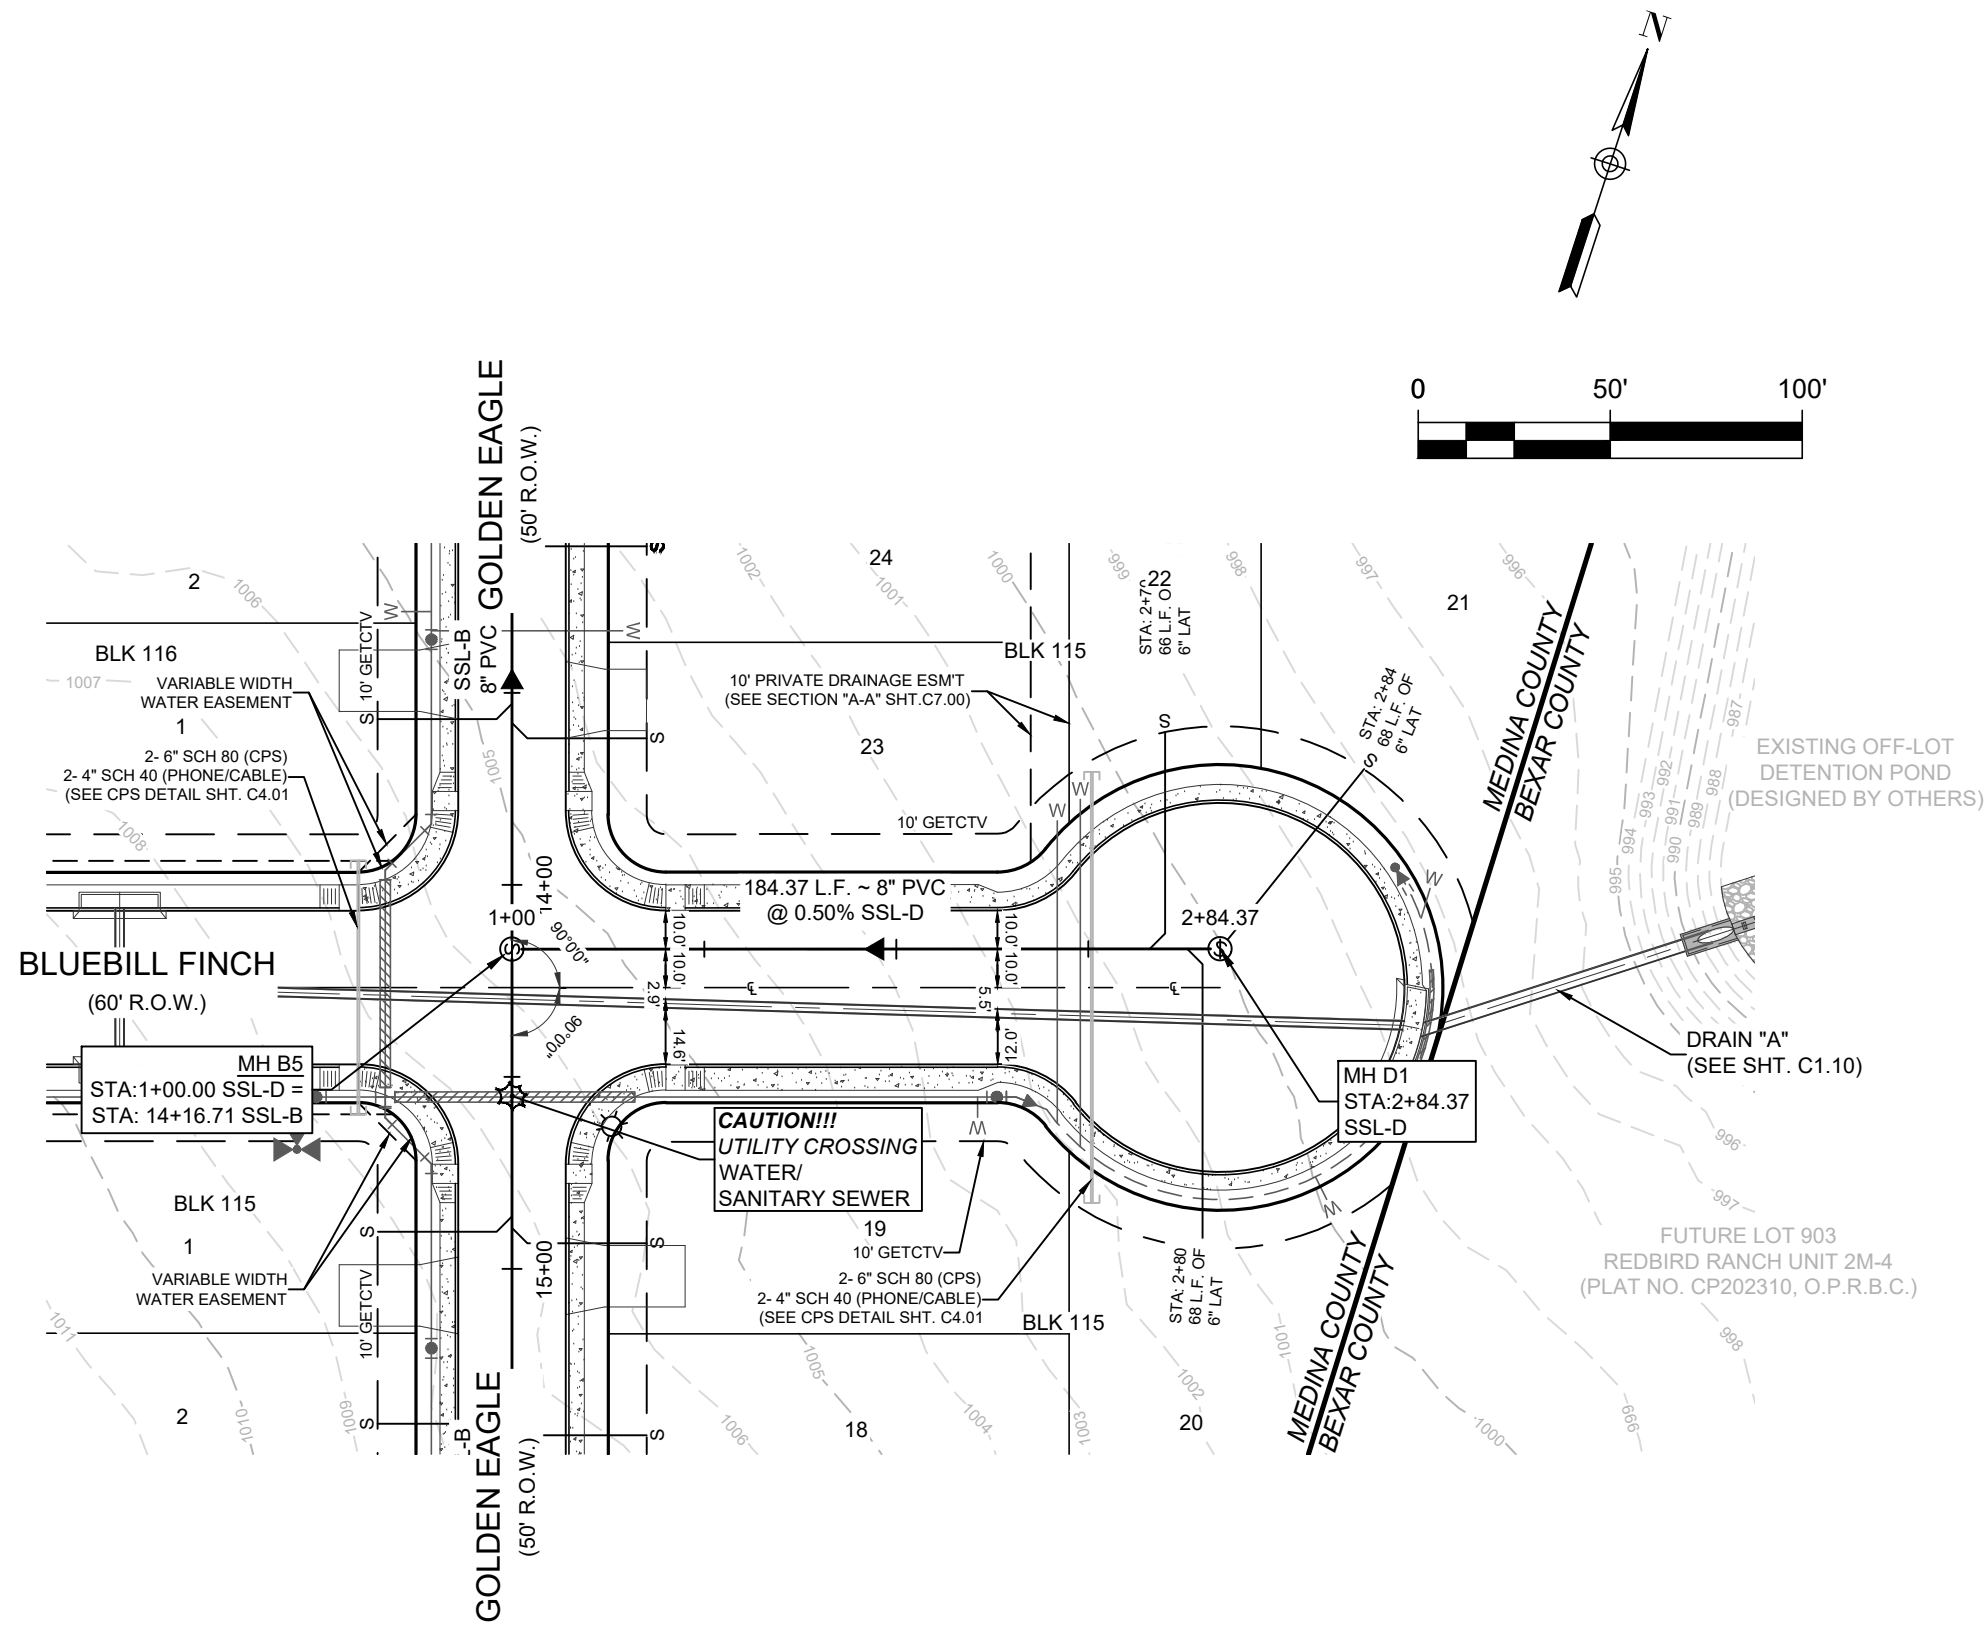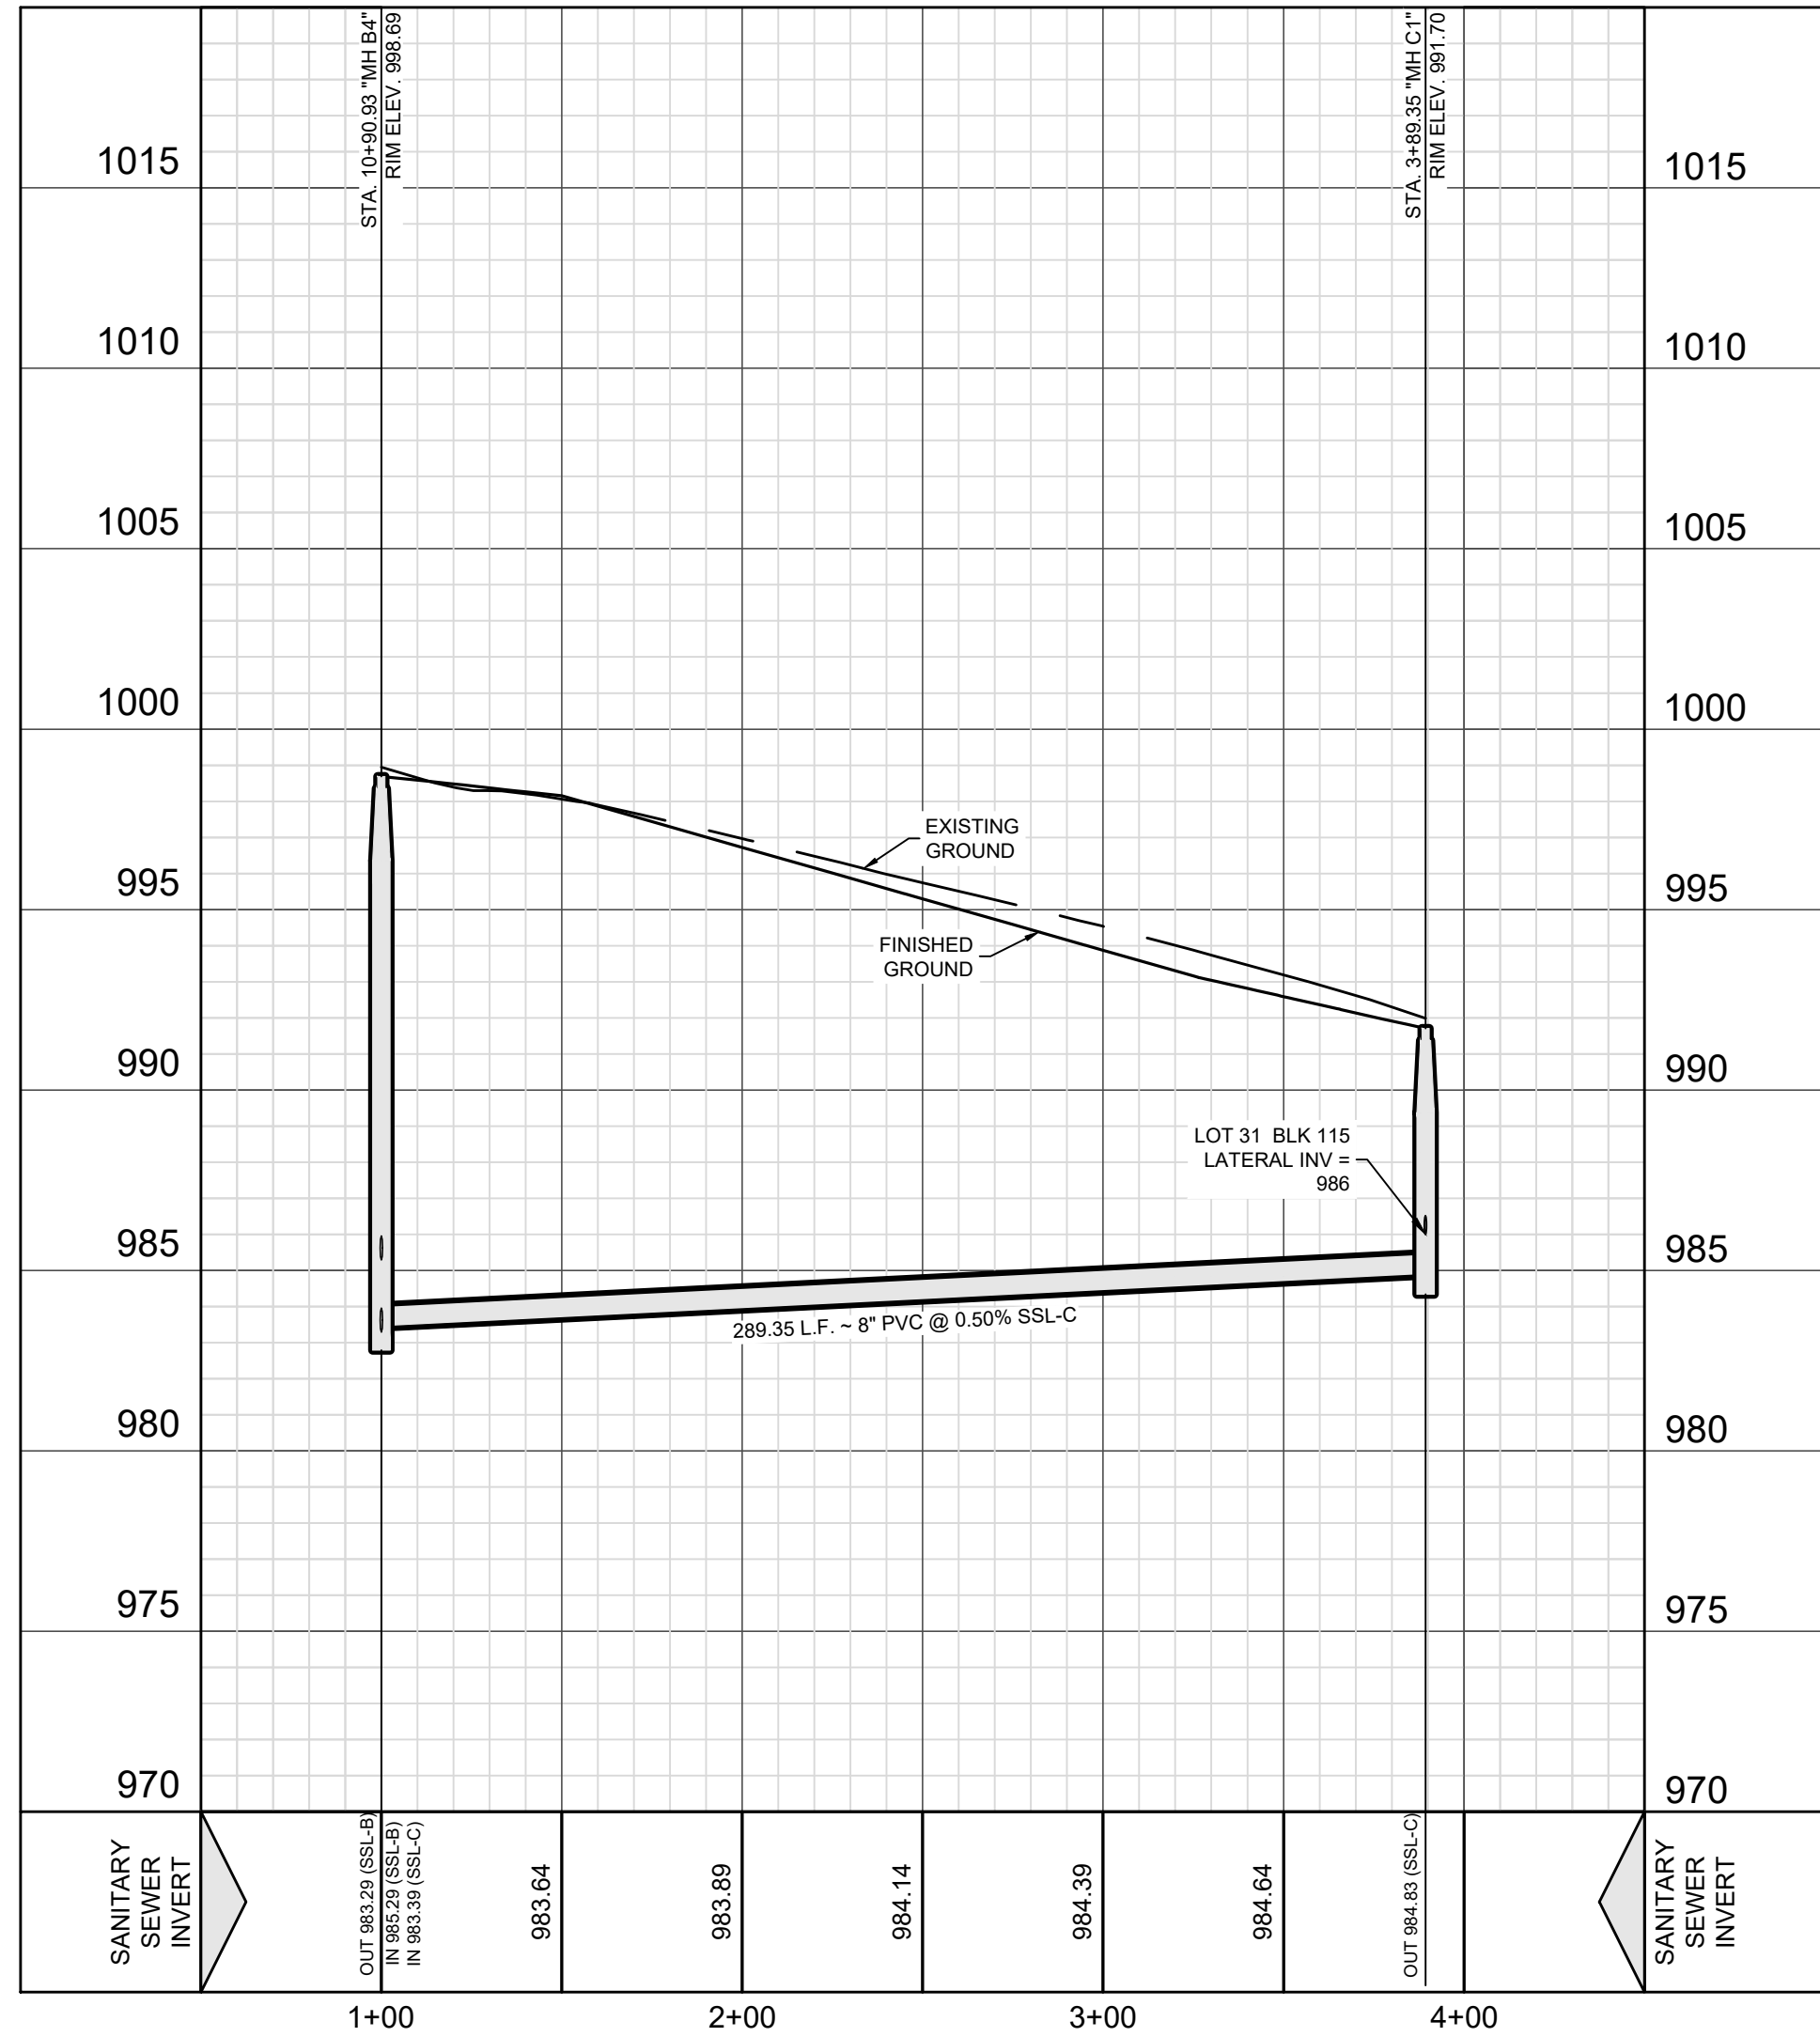

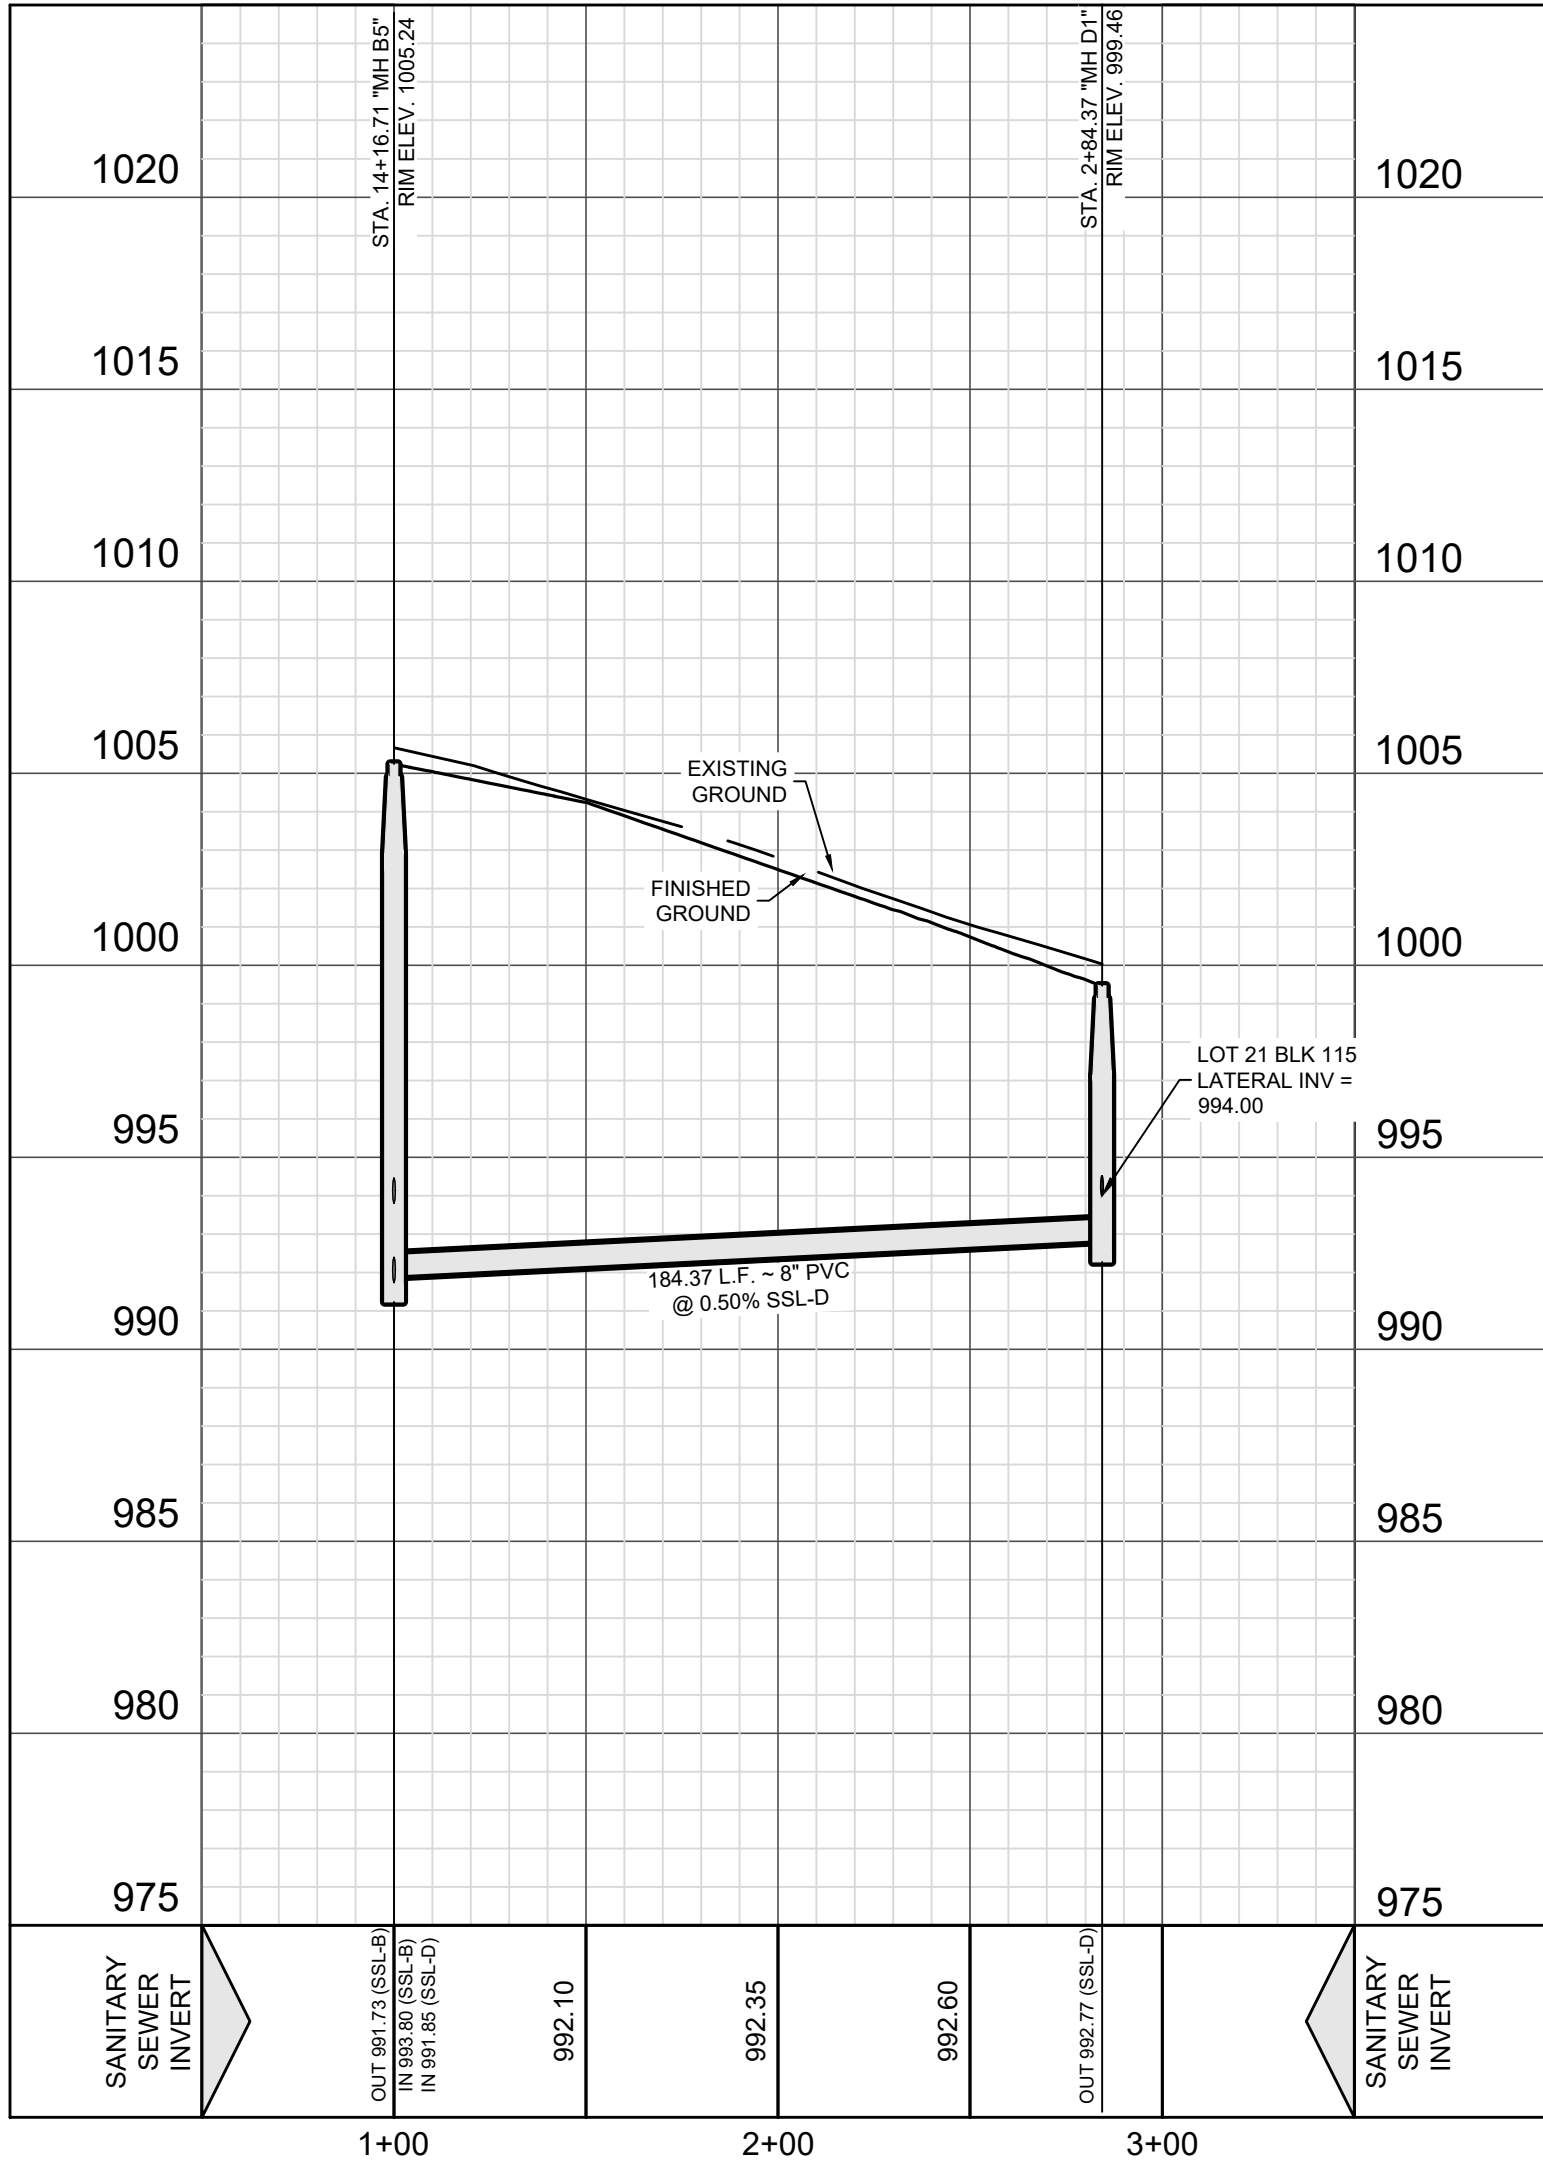







SSL-C  
STA. 1+00.00 TO 3+89.35



SSL-D  
STA. 1+00.00 TO 2+84.37

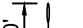

LEGEND (SANITARY SEWER)	
	PROJECT LIMITS
	OFFSITE EASEMENT
	PROPOSED WATER
	PROPOSED SEWER
	EXISTING WATER
	EXISTING SEWER
	PROPOSED MANHOLE
	EXISTING MANHOLE
	FIRE HYDRANT
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	SINGLE WATER SERVICE
	PROPOSED WYE & LATERAL
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SEWER: SAWS MEDIO CREEK WRC

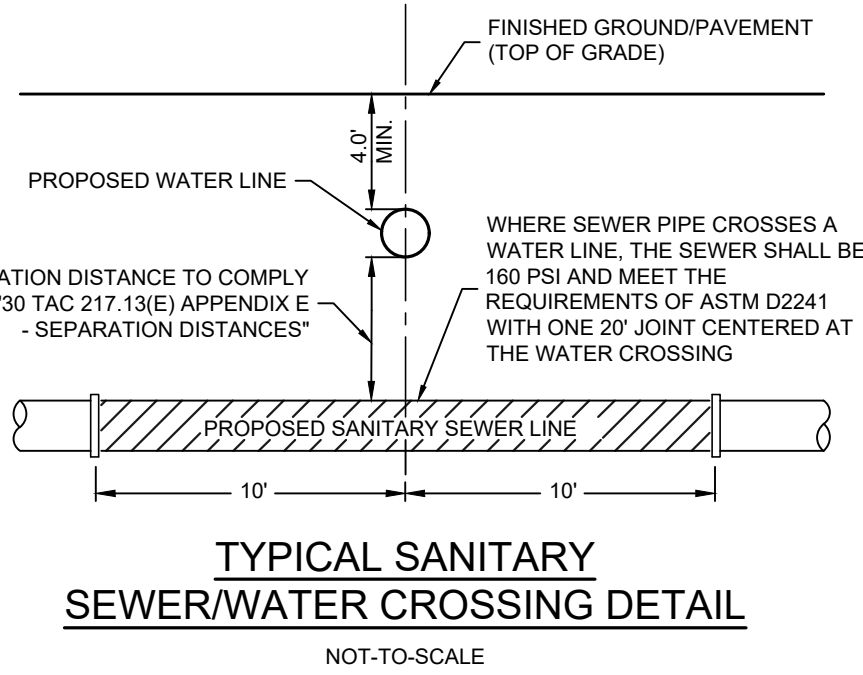DEVELOPER'S NAME:	CONTINENTAL HOMES OF TEXAS, L.P.		
ADDRESS:	3419 N. LOOP 1604 EAST		
CITY:	SAN ANTONIO	STATE:	TEXAS
PHONE #	(210) 496-2668	FAX #	(210) 496-2668
SAWS BLOCK MAP #	062586	TOTAL EDUS:	89
TOTAL LINEAR FOOTAGE OF PIPE:	3,625 L.F. (87)	DOC. NO. (MEDINA COUNTY)	
NUMBER OF LOTS:	89	SAWS JOB NO.:	24-1513

REDBIRD RANCH UNIT 2M-2  
SAN ANTONIO, TX  
SANITARY SEWER LINE C &  
SANITARY SEWER LINE D

DESIGNED BY: JWS  
DRAWN BY: SQV/JWS  
DATE: 5/31/2024  
JOB NO.: 05000-200  
SHEET NO. C6.07

DHI Engineering, LLC.  
4419 N. LOOP 1604 EAST  
SAN ANTONIO, TEXAS 78247  
(210) 496-2668 | dhiengineering.com  
TBP REG. NO. F-19561

5/31/2024  
Vance L. Weyand  
Professional Engineer  
No. 99269  
State of Texas

DESCRIPTION  
DATE  
REV

Doc: May 31, 2024, 8:30am User: E:\PROJECT\05000-200\0400 - Design\0400 - Sewer\0400 SANITARY SEWER LINE C & SANITARY SEWER LINE D.dwg

REDBIRD RANCH UNIT 2M-2  
DOC. # XXXXXXXXXXXXX



SAWS STANDARD GENERAL CONSTRUCTION NOTES  
ASSOCIATED WITH 2021 SAWS STANDARD SPECS

Updated December 14, 2021

SAWS GENERAL CONSTRUCTION

1. ALL MATERIALS AND CONSTRUCTION PROCEDURES WITHIN THE SCOPE OF THIS CONTRACT SHALL BE APPROVED BY THE SAN ANTONIO WATER SYSTEM (SAWS) AND COMPLY WITH THE PLANS, SPECIFICATIONS, GENERAL CONDITIONS AND WITH THE FOLLOWING AS APPLICABLE:

A. CURRENT TEXAS COMMISSION ON ENVIRONMENTAL QUALITY (TCEQ) "DESIGN CRITERIA FOR DOMESTIC WASTEWATER SYSTEM", TEXAS ADMINISTRATIVE CODE (TAC) TITLE 30 PART 1 CHAPTER 217 AND "PUBLIC DRINKING WATER", TAC TITLE 30 PART 1 CHAPTER 290.

B. CURRENT TXDOT "STANDARD SPECIFICATIONS FOR CONSTRUCTION OF HIGHWAYS, STREETS AND DRAINAGE."

C. CURRENT "SAN ANTONIO WATER SYSTEM STANDARD SPECIFICATIONS FOR WATER AND SANITARY SEWER CONSTRUCTION."

D. CURRENT CITY OF SAN ANTONIO "STANDARD SPECIFICATIONS FOR CONSTRUCTION."

E. CURRENT CITY OF SAN ANTONIO "UTILITY EXCAVATION CRITERIA MANUAL" (UECM).

2. THE CONTRACTOR SHALL OBTAIN SAWS STANDARD DETAILS FROM SAWS WEBSITE, [https://apps.saws.org/business\\_center/specs/constspecs/](https://apps.saws.org/business_center/specs/constspecs/) UNLESS OTHERWISE NOTED WITHIN DESIGN PLANS.

3. THE CONTRACTOR IS TO NOTIFY AND MAKE ARRANGEMENTS WITH THE SAWS CONSTRUCTION INSPECTION DIVISION AT 210-233-3500 (DURING REGULAR SAWS WORKING HOURS) AND PROVIDE NOTIFICATION PROCEDURES THE CONTRACTOR WILL USE TO NOTIFY AFFECTED HOME RESIDENTS AND/OR PROPERTY OWNERS TWO (2) WEEKS PRIOR TO EXCAVATION. OUTSIDE OF REGULAR SAWS WORKING HOURS THE SAWS EOC SHOULD BE CONTACTED AT 210-704-7297.

4. IF NECESSARY, CONTRACTOR WILL COORDINATE USE OF SAWS PREMISES AT NO ADDITIONAL COST TO SAWS. SUCH EFFORTS INCLUDE, BUT ARE NOT LIMITED TO, OBTAINING SECURITY IDENTIFICATION BADGES REQUIRED FOR ACCESS TO SAWS FACILITIES.

5. LOCATIONS AND DEPTHS OF EXISTING UTILITIES AND SERVICE LATERALS SHOWN ON THE PLANS ARE UNDERSTOOD TO BE APPROXIMATE. ACTUAL LOCATIONS AND DEPTHS MUST BE FIELD VERIFIED BY THE CONTRACTOR PRIOR TO CONSTRUCTION. IT SHALL BE THE CONTRACTOR'S RESPONSIBILITY TO LOCATE UTILITY SERVICE LINES AS REQUIRED FOR CONSTRUCTION AND TO PROTECT THEM DURING CONSTRUCTION AT NO COST TO SAWS.

6. THE CONTRACTOR SHALL VERIFY THE EXACT LOCATION OF UNDERGROUND UTILITIES AND DRAINAGE STRUCTURES PRIOR TO CONSTRUCTION WHETHER SHOWN ON PLANS OR NOT. AS-BUILTS FOR SAWS INFRASTRUCTURE CAN BE OBTAINED AT WEBSITE BELOW. CONTRACTOR SHALL COORDINATE PHYSICAL LOCATES FOR SAWS INFRASTRUCTURE THROUGH THE SAWS INSPECTOR. PLEASE ALLOW UP TO 7 BUSINESS DAYS FOR LOCATES REQUESTING PIPE LOCATION MARKERS ON SAWS INFRASTRUCTURE. THE FOLLOWING CONTACT INFORMATION ARE SUPPLIED FOR VERIFICATION PURPOSES:

SAN ANTONIO WATER SYSTEM:  
REQUEST AS-BUILTS: <https://www.saws.org/service/locates-service/>  
COSA DRAINAGE 210-206-8433  
COSA TRAFFIC SIGNAL OPERATIONS 210-207-7720  
TEXAS STATEWIDE ONE CALL LOCATOR 1-800-545-6005 OR 811

7. THE CONTRACTOR SHALL BE RESPONSIBLE FOR RESTORING EXISTING FENCES, CURBS, STREETS, DRIVEWAYS, SIDEWALKS, LANDSCAPING, AND STRUCTURES TO ITS ORIGINAL OR BETTER CONDITION AS A RESULT OF DAMAGES DONE BY THE PROJECT'S CONSTRUCTION.

8. CONTRACTOR SHALL NOT MAKE USE OF DUMPSTERS OR WASTE BINS THAT ARE INTENDED TO SERVE RESIDENTS AND/OR BUSINESSES.

9. ALL WORK IN TEXAS DEPARTMENT OF TRANSPORTATION AND BEXAR COUNTY RIGHT-OF-WAY SHALL BE DONE IN ACCORDANCE WITH RESPECTIVE CONSTRUCTION SPECIFICATIONS AND PERMIT.

10. THE CONTRACTOR SHALL COMPLY WITH CITY OF SAN ANTONIO OR OTHER GOVERNING MUNICIPALITY'S TREE ORDINANCES WHEN EXCAVATING NEAR TREES.

11. ALL WORK WITHIN THE 100-YEAR FLOODPLAIN SHALL BE DONE IN ACCORDANCE WITH FLOODPLAIN DEVELOPMENT PERMIT.

12. ANY WORK COMPLETED WITHOUT PRIOR WRITTEN AUTHORIZATION WHICH IS NOT INCLUDED IN THESE PLANS AND SPECIFICATIONS WILL NOT BE COMPENSATED BY THE SAN ANTONIO WATER SYSTEM.

13. HOLIDAY WORK: CONTRACTORS WILL NOT BE ALLOWED TO PERFORM SAWS WORK ON SAWS RECOGNIZED HOLIDAYS.

WEEKEND WORK: CONTRACTORS ARE REQUIRED TO SUBMIT REQUEST TO THE SAWS INSPECTION CONSTRUCTION DEPARTMENT BY 12:00PM ON THE WEDNESDAY PRIOR TO THE WEEKEND BEING REQUESTED. REQUEST SHOULD BE SENT TO [CONSTWORKREQ@SAWS.ORG](mailto:CONSTWORKREQ@SAWS.ORG).

ANY AND ALL SAWS UTILITY WORK INSTALLED WITHOUT WEEKEND APPROVAL WILL BE SUBJECT TO BE UNCOVERED FOR PROPER INSPECTION AT NO COST TO SAWS.

14. PRE-CON SITE VIDEO: BEFORE THE START OF ANY CONSTRUCTION. THE SITE MUST BE VIDEO RECORDED BY THE CONTRACTOR WITH ONE COPY SUBMITTED TO SAWS INSPECTIONS. A PRE-SITE VIDEO WILL PROVIDE ACCURATE DOCUMENTATION OF THE EXISTING CONDITIONS (NSPI).

15. POWER POLE BRACING: CONTRACTORS SHOULD BE ADVISED THAT THERE ARE EXISTING OVERHEAD UTILITY POLES ALONG THE PROJECT CORRIDOR. CONTRACTORS SHOULD FURTHER BE ADVISED THAT IF THE DISTANCE FROM THE OUTSIDE FACE OF A UTILITY TRENCH TO THE FACE OF A UTILITY POLE IS LESS THAN 5 FEET, SAID UTILITY POLE IS SUBJECT TO BRACING BASED ON A DETERMINATION MADE BY UTILITY POLE OWNER. COSTS INCURRED BY CONTRACTOR FOR BRACING OF THESE UTILITY POLES IS SUBSIDIARY TO THAT RESPECTIVE UTILITY COMPANY'S WORK. IT IS ADVISABLE FOR THE CONTRACTOR TO REVIEW THE CONSTRUCTION DOCUMENTS AND VISIT THE CONSTRUCTION SITE TO DETERMINE POTENTIAL IMPACTS.

16. CONSTRUCTION SEQUENCING: IT IS THE CONTRACTOR'S SOLE RESPONSIBILITY TO SCHEDULE SEQUENCING FOR REMOVAL AND INSTALLATION OF EXISTING AND PROPOSED SAWS UTILITIES IN CONJUNCTION WITH GENERAL PROJECT CONSTRUCTION. SEQUENCE OF CONSTRUCTION ACTIVITIES SHALL BE CONSIDERED IN ORDER TO MINIMIZE THE EXTENT AND DURATION OF DISTURBANCES.

17. CONTRACTOR SHALL COMPLY WITH APPLICABLE REGULATIONS INCLUDING, BUT NOT LIMITED TO, THOSE OVERSEEN BY THE U.S. OCCUPATIONAL SAFETY AND HEALTH ADMINISTRATION (OSHA). OSHA INFORMATION AND RELATED MATERIALS MAY BE OBTAINED AT <https://www.osha.gov/> OR AT THE OSHA SAN ANTONIO OFFICE LOCATED AT FOUNTAINHEAD TOWER, SUITE 605 8200 W. INTERSTATE 10 SAN ANTONIO, TX 78230 WHICH IS ALSO REACHABLE BY PHONE AT (210) 472-5040.

18. TRENCH EXCAVATION SAFETY PROTECTION: CONTRACTOR AND/OR CONTRACTOR'S INDEPENDENTLY RETAINED EMPLOYEE OR STRUCTURAL DESIGN/GEOTECHNICAL/SAFETY/EQUIPMENT CONSULTANT, IF ANY, SHALL REVIEW THESE PLANS AND AVAILABLE GEOTECHNICAL INFORMATION AND THE ANTICIPATED INSTALLATION SITE(S) WITHIN THE PROJECT WORK AREAS IN ORDER TO IMPLEMENT CONTRACTOR'S TRENCH EXCAVATION SAFETY PROTECTION SYSTEMS, PROGRAMS AND/OR PROCEDURES. THE CONTRACTOR'S IMPLEMENTATION OF THE SYSTEMS, PROGRAMS AND/OR PROCEDURES SHALL PROVIDE FOR ADEQUATE TRENCH EXCAVATION SAFETY PROTECTION THAT COMPLIES WITH, AS A MINIMUM, OSHA STANDARDS FOR TRENCH EXCAVATIONS. SPECIFICALLY, CONTRACTOR AND/OR CONTRACTOR'S INDEPENDENTLY RETAINED EMPLOYEE OR SAFETY CONSULTANT SHALL IMPLEMENT A TRENCH SAFETY PROGRAM IN ACCORDANCE WITH OSHA STANDARDS GOVERNING THE PRESENCE AND ACTIVITIES OF INDIVIDUALS WORKING IN AND AROUND TRENCH EXCAVATION.

SAWS SEWER

19. THE CONTRACTOR IS RESPONSIBLE FOR ENSURING THAT NO SANITARY SEWER OVERFLOW (SSO) OCCURS AS A RESULT OF THEIR WORK. ALL CONTRACTOR PERSONNEL RESPONSIBLE FOR SSO PREVENTION AND CONTROL SHALL BE TRAINED ON PROPER RESPONSE. SHOULD AN SSO OCCUR, THE CONTRACTOR SHALL:

A. IDENTIFY THE SOURCE OF THE SSO AND NOTIFY SAWS EMERGENCY OPERATIONS CENTER (EOC) IMMEDIATELY AT 210-704-SAWS (210-704-7297). PROVIDE THE ADDRESS OF THE SPILL AND AN ESTIMATED VOLUME OR FLOW.

B. ATTEMPT TO ELIMINATE THE SOURCE OF THE SSO.

C. CONTAIN SEWAGE FROM THE SSO TO THE EXTENT OF PREVENTING A POSSIBLE CONTAMINATION OF WATERWAYS.

D. CLEAN UP SPILL SITE (RETURN CONTAINED SEWAGE TO THE COLLECTION SYSTEM IF POSSIBLE) AND PROPERLY DISPOSE OF CONTAMINATED SOIL/MATERIALS.

E. CLEAN THE AFFECTED SEWER MAINS AND REMOVE ANY DEBRIS.

F. MEET ALL POST-SSO REQUIREMENTS AS PER THE EPA CONSENT DECREE, INCLUDING LINE CLEANING AND TELEVISIONING THE AFFECTED SEWER MAINS (AT SAWS DIRECTION) WITHIN 24 HOURS.

SHOULD THE CONTRACTOR FAIL TO ADDRESS AN SSO IMMEDIATELY AND TO SAWS SATISFACTION, THEY WILL BE RESPONSIBLE FOR ALL COSTS INCURRED BY SAWS, INCLUDING ANY FINES FROM EPA.

NO SEPARATE MEASUREMENT OR PAYMENT SHALL BE MADE FOR THIS WORK. ALL WORK SHALL BE DONE ACCORDING TO GUIDELINES SET BY THE TCEQ AND SAWS.

20. THE CONTRACTOR SHALL PROVIDE BYPASS PUMPING OF SEWAGE AROUND EACH SEGMENT OF PIPE TO BE REPLACED, IN ACCORDANCE WITH SAWS STANDARD SPECIFICATION ITEM NO. 865, "BYPASS PUMPING SMALL DIAMETER SANITARY SEWER MAINS" AND STANDARD SPECIFICATION ITEM NO. 864, "BYPASS PUMPING LARGE DIAMETER SANITARY SEWER MAINS" AS APPLICABLE. PAYMENT FOR SUCH WORK WILL BE MADE UNDER THE APPROPRIATE BID ITEM ASSOCIATED WITH SANITARY SEWER BYPASS PUMPING IN ACCORDANCE WITH SAWS STANDARD SPECIFICATIONS 865 AND 864.

21. PRIOR TO TIE-INS, ANY SHUTDOWNS OF EXISTING FORCE MAINS OF ANY SIZE MUST BE COORDINATED WITH THE SAWS CONSTRUCTION INSPECTION DIVISION AT 210-233-3500 AND/OR SAWS PRODUCTION GROUPS AT LEAST TWO WEEKS OR MORE IN ADVANCE OF THE SHUTDOWN. THE CONTRACTOR MUST ALSO PROVIDE A SEQUENCE OF WORK AS RELATED TO THE TIE-INS; THIS IS AT NO ADDITIONAL COST TO SAWS OR THE PROJECT AND IT IS THE RESPONSIBILITY OF THE CONTRACTOR TO SEQUENCE THE WORK ACCORDINGLY.

22. ELEVATIONS POSTED FOR TOP OF MANHOLES ARE FOR REFERENCE ONLY: IT SHALL BE THE RESPONSIBILITY OF THE CONTRACTOR TO MAKE ALLOWANCES AND ADJUSTMENTS FOR TOP OF MANHOLES TO MATCH THE FINISHED GRADE OF THE PROJECT'S IMPROVEMENTS (NSPI).

23. MANHOLE REMOVAL: WHERE EXISTING MANHOLES ARE TO BE REPLACED BY THE CONTRACTOR, THE EXISTING MANHOLES SHALL BE REMOVED. (NSPI)

24. SMART MANHOLE COVERS: THE CONTRACTOR SHALL NOTIFY SAWS EOC AT 210-704SAWS (210-233-7297) AND EITHER AMERICA ESPINOZA AT 210-233-2934 OR JOSE A. MARTINEZ AT 210-233-3071 A MINIMUM OF 72 HOURS, NOT COUNTING WEEKENDS OR SAWS HOLIDAYS, BEFORE WORKING ON THE PIPE OR MANHOLE, IN ORDER TO HAVE SAWS REMOVE THE SMART COVER. ANY DAMAGE DONE TO THE SMART COVER WILL BE CHARGED TO THE CONTRACTOR THROUGH A CHANGE ORDER.

25. FLOW METERS IN MANHOLES: THE CONTRACTOR SHALL NOTIFY BOBBY JOHNSON AT 210233-3493 OR ABEL BORUNDA AT 210-233-3704 A MINIMUM OF 72 HOURS, NOT COUNTING WEEKENDS OR SAWS HOLIDAYS, BEFORE WORKING ON THE PIPE OR MANHOLE, IN ORDER TO HAVE SAWS REMOVE THE FLOW METER IN THE MANHOLE. ANY DAMAGE DONE TO THE FLOW METER WILL BE CHARGED TO THE CONTRACTOR THROUGH A CHANGE ORDER.

PROJECT SEWER NOTES

1. ALL RESIDENTIAL SEWER SERVICE LATERALS ARE 6" DIA. AND SHALL BE EXTENDED TO 10' PAST THE PROPERTY LINE AND CAPPED AND SEALED. CONTRACTOR SHALL INSTALL A 2" X 4" STAKE, FOUR FEET LONG AND 2 FEET DEEP INTO THE GROUND AT THE END OF EACH SERVICES. NO SEPARATE PAY ITEM.

2. CONTRACTOR TO INSTALL CLEANOUTS AT THE END OF ALL SEWER LATERALS, PER LATERAL DETAIL SHEET C6.21.

3. NO VERTICAL STACKS ALLOWED FOR ANY LOTS UNLESS OTHERWISE SPECIFIED BY THE ENGINEER.

4. ALL 6" SEWER LATERALS WILL BE SET AT 2% GRADE FROM THE MAIN TO THE PROPERTY LINE.

5. WHEN HORIZONTAL DISTANCE BETWEEN SEWER PIPES AND WATER MAIN IS LESS THAN 9 FOOT SEPARATION, SEWER MAIN SHALL BE INSTALLED WITH 150 PSI (MIN) PRESSURE PIPE AND FITTINGS IN ACCORDANCE WITH SAWS CONSTRUCTION CRITERIA FOR CONSTRUCTION OF SEWER MAINS IN THE VICINITY OF WATER MAINS.

6. CONTRACTOR SHALL ENSURE THAT MANHOLES OUTSIDE OF PAVED AREAS ARE SET WITH TOP ELEVATION 6" ABOVE FINISHED GRADE WITH CONCRETE RING ENCASEMENT.

7. ALL SEWER PIPES SHALL BE 8" PVC(SDR 26), UNLESS OTHERWISE NOTED.

8. CONTRACTOR IS TO VERIFY EXISTING INVERT OF EXISTING SANITARY SEWER MAINS AND ALERT ENGINEER IMMEDIATELY OF ANY DIFFERENCE FROM INVERT SHOWN ON PLANS.

9. CONTRACTOR SHALL PROTECT ALL EXISTING FENCES, ANY FENCE DAMAGE BY THE CONTRACTOR SHALL BE REPAIRED BY THE CONTRACTOR AT THEIR EXPENSE.

10. THE CONTRACTOR WILL BE RESPONSIBLE FOR DETERMINING EXACT LOCATION OF ALL UTILITIES AND DRAINAGE STRUCTURES WHETHER SHOWN ON THE PLANS OR NOT. THE CONTRACTOR SHALL UNCOVER EXISTING UTILITIES PRIOR TO CONSTRUCTION TO VERIFY SIZE, GRADE, AND LOCATION. THE CONTRACTOR SHALL NOTIFY THE ENGINEER IMMEDIATELY OF ANY DEVIATIONS FROM PLANS PRIOR TO BEGINNING CONSTRUCTION. ANY DAMAGE TO EXISTING UTILITIES, WHETHER SHOWN ON THE PLANS OR NOT, SHALL BE THE CONTRACTOR'S RESPONSIBILITY TO REPAIR, AT HIS EXPENSE.

11. CONCRETE RING ENCASEMENT TO BE INSTALLED ON ALL MANHOLES AND, WITHIN LIMITS OF PLACEMENT, BE INSTALLED TO THE TOP OF THE BASE LAYER WITH A MINIMUM OF 2" OF ASPHALT ON TOP OF THE RING ENCASEMENT.

12. MANHOLE OPENING INCREASED TO 630" AS PER TAC CHAPTER 217.55.

13. ALL SEWER PIPE LATERALS SHALL BE SDR 26 (CLASS 160) PVC PIPE.

14. IF THE GIVEN TOP OF MANHOLE ELEVATION DOES NOT AGREE ON ACTUAL GROUND SURFACE OR FINISHED PAVEMENT, THE CONTRACTOR SHALL ADJUST ELEVATIONS SUCH THAT THE TOP OF THE MANHOLE SHALL BE 0.5' ABOVE EXISTING GROUND, OR FLUSH TO FINISH ASPHALT PAVEMENT.

15. ALL MANHOLES CONSTRUCTED OVER THE EDWARDS AQUIFER RECHARGE ZONE SHOULD BE WATERTIGHT.

SEWER: SAWS MEDIO CREEK WRC

DEVELOPER'S NAME: <u>CONTINENTAL HOMES OF TEXAS, L.P.</u>	
ADDRESS: <u>5419 N. LOOP 1604 EAST</u>	
CITY: <u>SAN ANTONIO</u>	STATE: <u>TEXAS</u> ZIP: <u>78247</u>
PHONE # <u>(210) 496-2668</u>	FAX # <u>(210) 496-2668</u>
SAWS BLOCK MAP # <u>062586</u>	TOTAL EDU'S: <u>89</u> TOTAL ACREAGE: <u>20.795</u>
TOTAL LINEAR FOOTAGE OF PIPE: <u>3,625 L.F. (87)</u> DOC. NO: <u>MEDINA COUNTY</u>	
NUMBER OF LOTS: <u>89</u>	SAWS JOB NO: <u>24-1513</u>

REDBIRD RANCH UNIT 2M-2  
SAN ANTONIO, TX  
SANITARY SEWER NOTES

DESIGNED BY: JWS  
DRAWN BY: SQV/JWS  
DATE: 3/20/2024  
JOB NO.: 05000-200  
SHEET NO.

C6.20

REV	DATE	DESCRIPTION

DHI Engineering, LLC.  
5419 N. LOOP 1604 EAST  
SUITE 700  
SAN ANTONIO, TEXAS 78247  
(210) 496-2668 | dhiengineering.com  
TXBPE REG. NO. F-195661


DHI

Date: Mar 20, 2024, 2:16pm User ID: jws@dh-engineering.com \\dh-engineering.com\New-ant\WEBGROUPS\Engineering\_L\PROJECTS\05000-200\0500 - Design\320 - Sheets\06.20 SANITARY SEWER NOTES.dwg

DOC # XXXXXXXXXXXXXXX

REDBIRD RANCH UNIT 2M-2



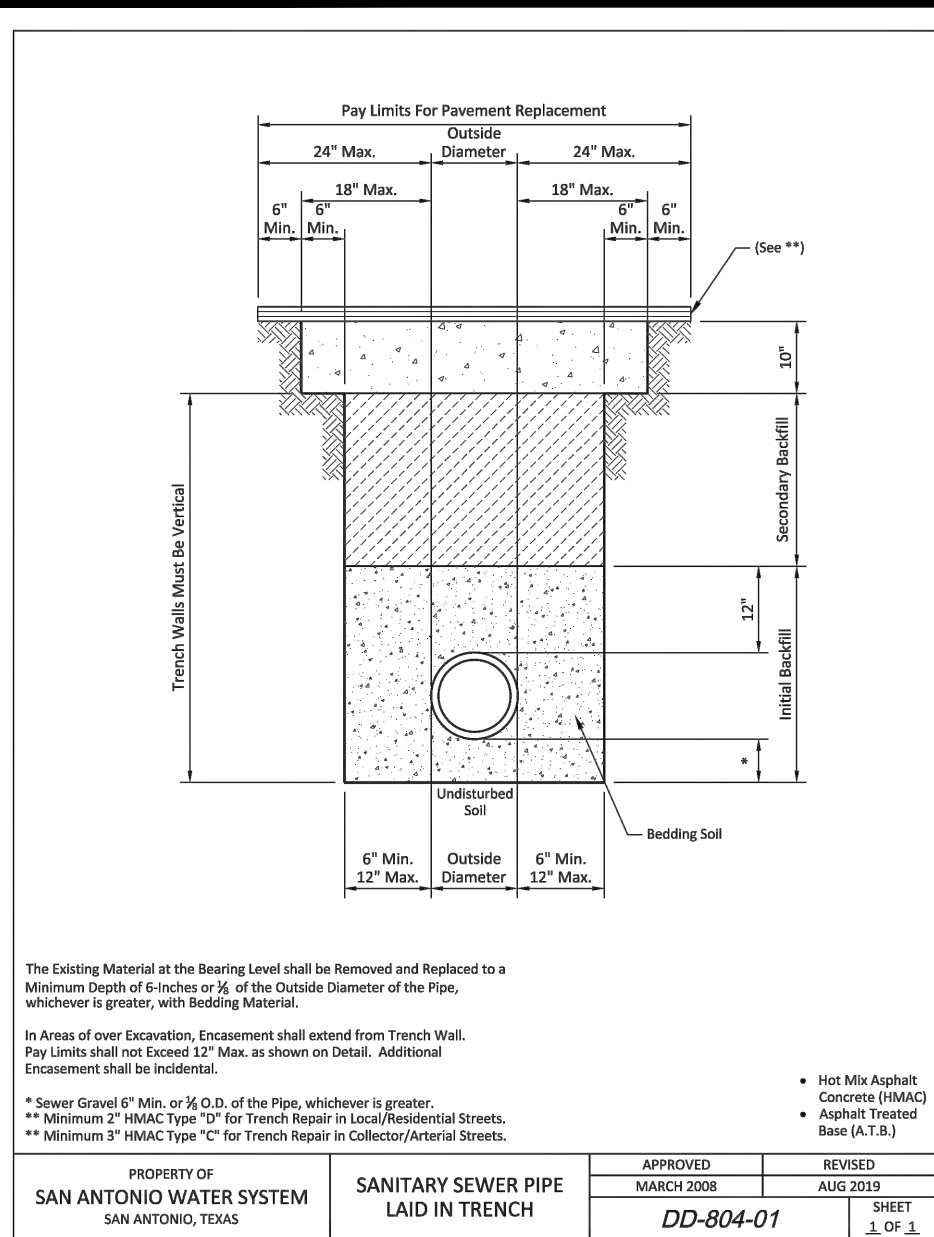



**LOCATION MAP**  
NOT-TO-SCALE

**INDEX MAP**  
NOT-TO-SCALE

GENERAL GRADING NOTES:


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|---|---|
| 1. ALL CONSTRUCTION PROCEDURES AND MATERIALS WITHIN THE SCOPE OF THE PROJECT THAT IS NOT SPECIFICALLY COVERED IN THE PLANS OF GEOTECHNICAL REPORT SHALL BE CONFORMED TO ALL APPLICABLE CITY, COUNTY AND TXDOT STANDARD REQUIREMENTS FOR PUBLICS WORKS CONSTRUCTION. | 8. THE CONTRACTOR SHALL REMOVE TOP SOIL, GRASS, ROOTS, DEBRIS, ETC. AND DISPOSE OF THOSE ITEMS THAT ARE NOT SUITABLE FOR EMBANKMENT AND TOPSOIL. CLEAN LOCATION STRIPS AND TOPSOIL MAY BE STOCKPILED ON SITE FOR REUSE IN A LOCATION SPECIFIED BY THE OWNER.                        |
| 2. SITE PREPARATION AND GRADING SHALL BE COMPLETED IN ACCORDANCE WITH THE PROJECTS GEOTECHNICAL REPORT AND SPECIFICATIONS.  | 9. THE CONTRACTOR IS RESPONSIBLE FOR REVEGETATE ALL DISTURBED AREAS IN ACCORDANCE WITH PROJECT SPECIFICATION AND TPDES/SWPPP REQUIREMENTS. REFER TO THE LANDSCAPE ARCHITECT'S PLAN IF APPLICABLE.   |
| 3. ALL SELECT FILL MATERIALS PROVIDED SHALL BE APPROVED BY THE GEOTECHNICAL ENGINEER PRIOR TO PLACING AND COMPACTING.   | 10. THE CONTRACTOR SHALL TAKE ALL NECESSARY PRECAUTIONS TO KEEP DRAINAGE AND SILT FROM WASHING ONTO ADJACENT PROPERTY, STREETS, OR DRAINAGE WAY. CONTRACTOR SHALL IMMEDIATELY REMOVE SILT/DEBRIS THAT WASHES OFFSITE OR INTO EXISTING STORM DRAIN SYSTEMS. REFER TO THE SWPPP PLAN. |
| 4. ALL ELEVATIONS AND PROPOSED CONTOURS SHOWN ON THIS PLAN REFLECTS FINISHED GRADES. THE THICKNESS OF PAVEMENT, BASE, GRASS, AND TOP SOIL MUST BE SUBTRACTED TO OBTAINED SUBGRADE ELEVATIONS.   | 11. THE CONTRACTOR SHALL OBTAIN GRADES SHOWN HEREON WITHIN $\pm$ ONE TENTH OF A FOOT.   |
| 5. THE CONTRACTOR SHALL NOTIFY THE ENGINEER OF ANY QUESTIONS THEY HAVE REGARDING THE INTENT, PLACEMENT, OR LIMITS OF DIMENSIONS OR GRADES NECESSARY FOR CONSTRUCTION OF THIS PROJECT.   | 12. IN PROPOSED PAVED AREAS AND STREET DESIGN PLANS SHALL CONTROL ALL EARTHEN SLOPES SHALL BE A MAXIMUM OF 3:1 AND A MINIMUM OF 1:0% UNLESS OTHERWISE STATED.   |
| 6. THE CONTRACTOR SHALL VERIFY THE SUITABILITY OF ALL EXISTING AND PROPOSED SITE CONDITIONS INCLUDING GRADES AND DIMENSIONS BEFORE THE START OF CONSTRUCTION. IF THERE ARE ANY DISCREPANCIES, CONTACT THE ENGINEER.   | 13. THE CONTRACTOR SHALL PROVIDE A SMOOTH TRANSITION BETWEEN EXISTING AND PROPOSED SITE CONDITIONS.   |
| 7. THE CONTRACTOR SHALL BE RESPONSIBLE FOR ACQUIRING ALL PERMITS, TEST, APPROVALS AND ACCEPTANCES REQUIRED TO COMPLETE CONSTRUCTION OF THIS PROJECT.  | 14. THE CONTRACTOR SHALL BE RESPONSIBLE FOR RESTORING ANY DAMAGE DONE TO EXISTING TREES, BUILDINGS, UTILITIES, FENCES, PAVEMENT, CURBS, OR DRIVEWAYS BACK TO EXISTING CONDITIONS OR BETTER. (NO SEPARATE PAY ITEMS.)  |

## TRENCH EXCAVATION PROTECTION

CONTRACTOR AND CONTRACTOR'S INDEPENDENTLY RETAINED EMPLOYEE OR STRUCTURAL DESIGN, GEOTECHNICAL, SAFETY, EQUIPMENT CONSULTANT, IF ANY, SHALL REVIEW THESE PLANS AND ANY AVAILABLE GEOTECHNICAL INFORMATION AND THE CONTRACTOR'S DESIGN AND CONSTRUCTION METHODS TO DETERMINE WHETHER TO IMPLEMENT CONTRACTOR'S TRENCH EXCAVATION SAFETY PROTECTION SYSTEM PROGRAMS AND/OR PROCEDURES FOR THE PROJECT DESCRIBED IN THE CONTRACT DOCUMENTS. THE CONTRACTOR'S IMPLEMENTATION OF THESE SYSTEMS, PROGRAMS, AND PROCEDURES SHALL BE IN ACCORDANCE WITH THE FOLLOWING REQUIREMENTS: PROTECTION THAT COMPLY WITH AS A MINIMUM, OSHA STANDARDS FOR TRENCH EXCAVATIONS SPECIFICALLY, CONTRACTOR AND CONTRACTOR'S INDEPENDENTLY RETAINED EMPLOYEE OR SAFETY CONSULTANT SHALL IMPLEMENT A TRENCH SAFETY PLAN AND/OR PROCEDURES TO PROTECT THE HEALTH AND SAFETY OF THE PERSONNEL AND ACTIVITIES OF INDIVIDUALS WORKING IN AND AROUND TRENCH EXCAVATION.

**CAUTION!!!**

CONTRACTOR SHALL BE REQUIRED TO LOCATE ALL PUBLIC OR PRIVATE UTILITIES INCLUDING BUT NOT LIMITING TO: WATER, SEWER, TELEPHONE AND FIBER OPTIC LINES, SITE LIGHTING ELECTRIC, SECONDARY ELECTRIC, PRIMARY ELECTRICAL DUCTBANKS, LANDSCAPE IRRIGATION FACILITIES, AND GAS LINES. ANY UTILITY CONFLICTS THAT ARISE SHOULD BE COMMUNICATED TO THE ENGINEER IMMEDIATELY AND PRIOR TO CONSTRUCTION. THE CONTRACTOR SHALL CONTACT 1-800-DIG-TESS A MINIMUM OF 48 HOURS PRIOR TO THE START OF CONSTRUCTION. ANY DAMAGE TO EXISTING UTILITIES SHALL BE THE SOLE RESPONSIBILITY OF THE CONTRACTOR AND THE REPAIR SHALL BE AT CONTRACTOR'S EXPENSE WHETHER THE UTILITY IS SHOWN ON THESE PLANS OR NOT.

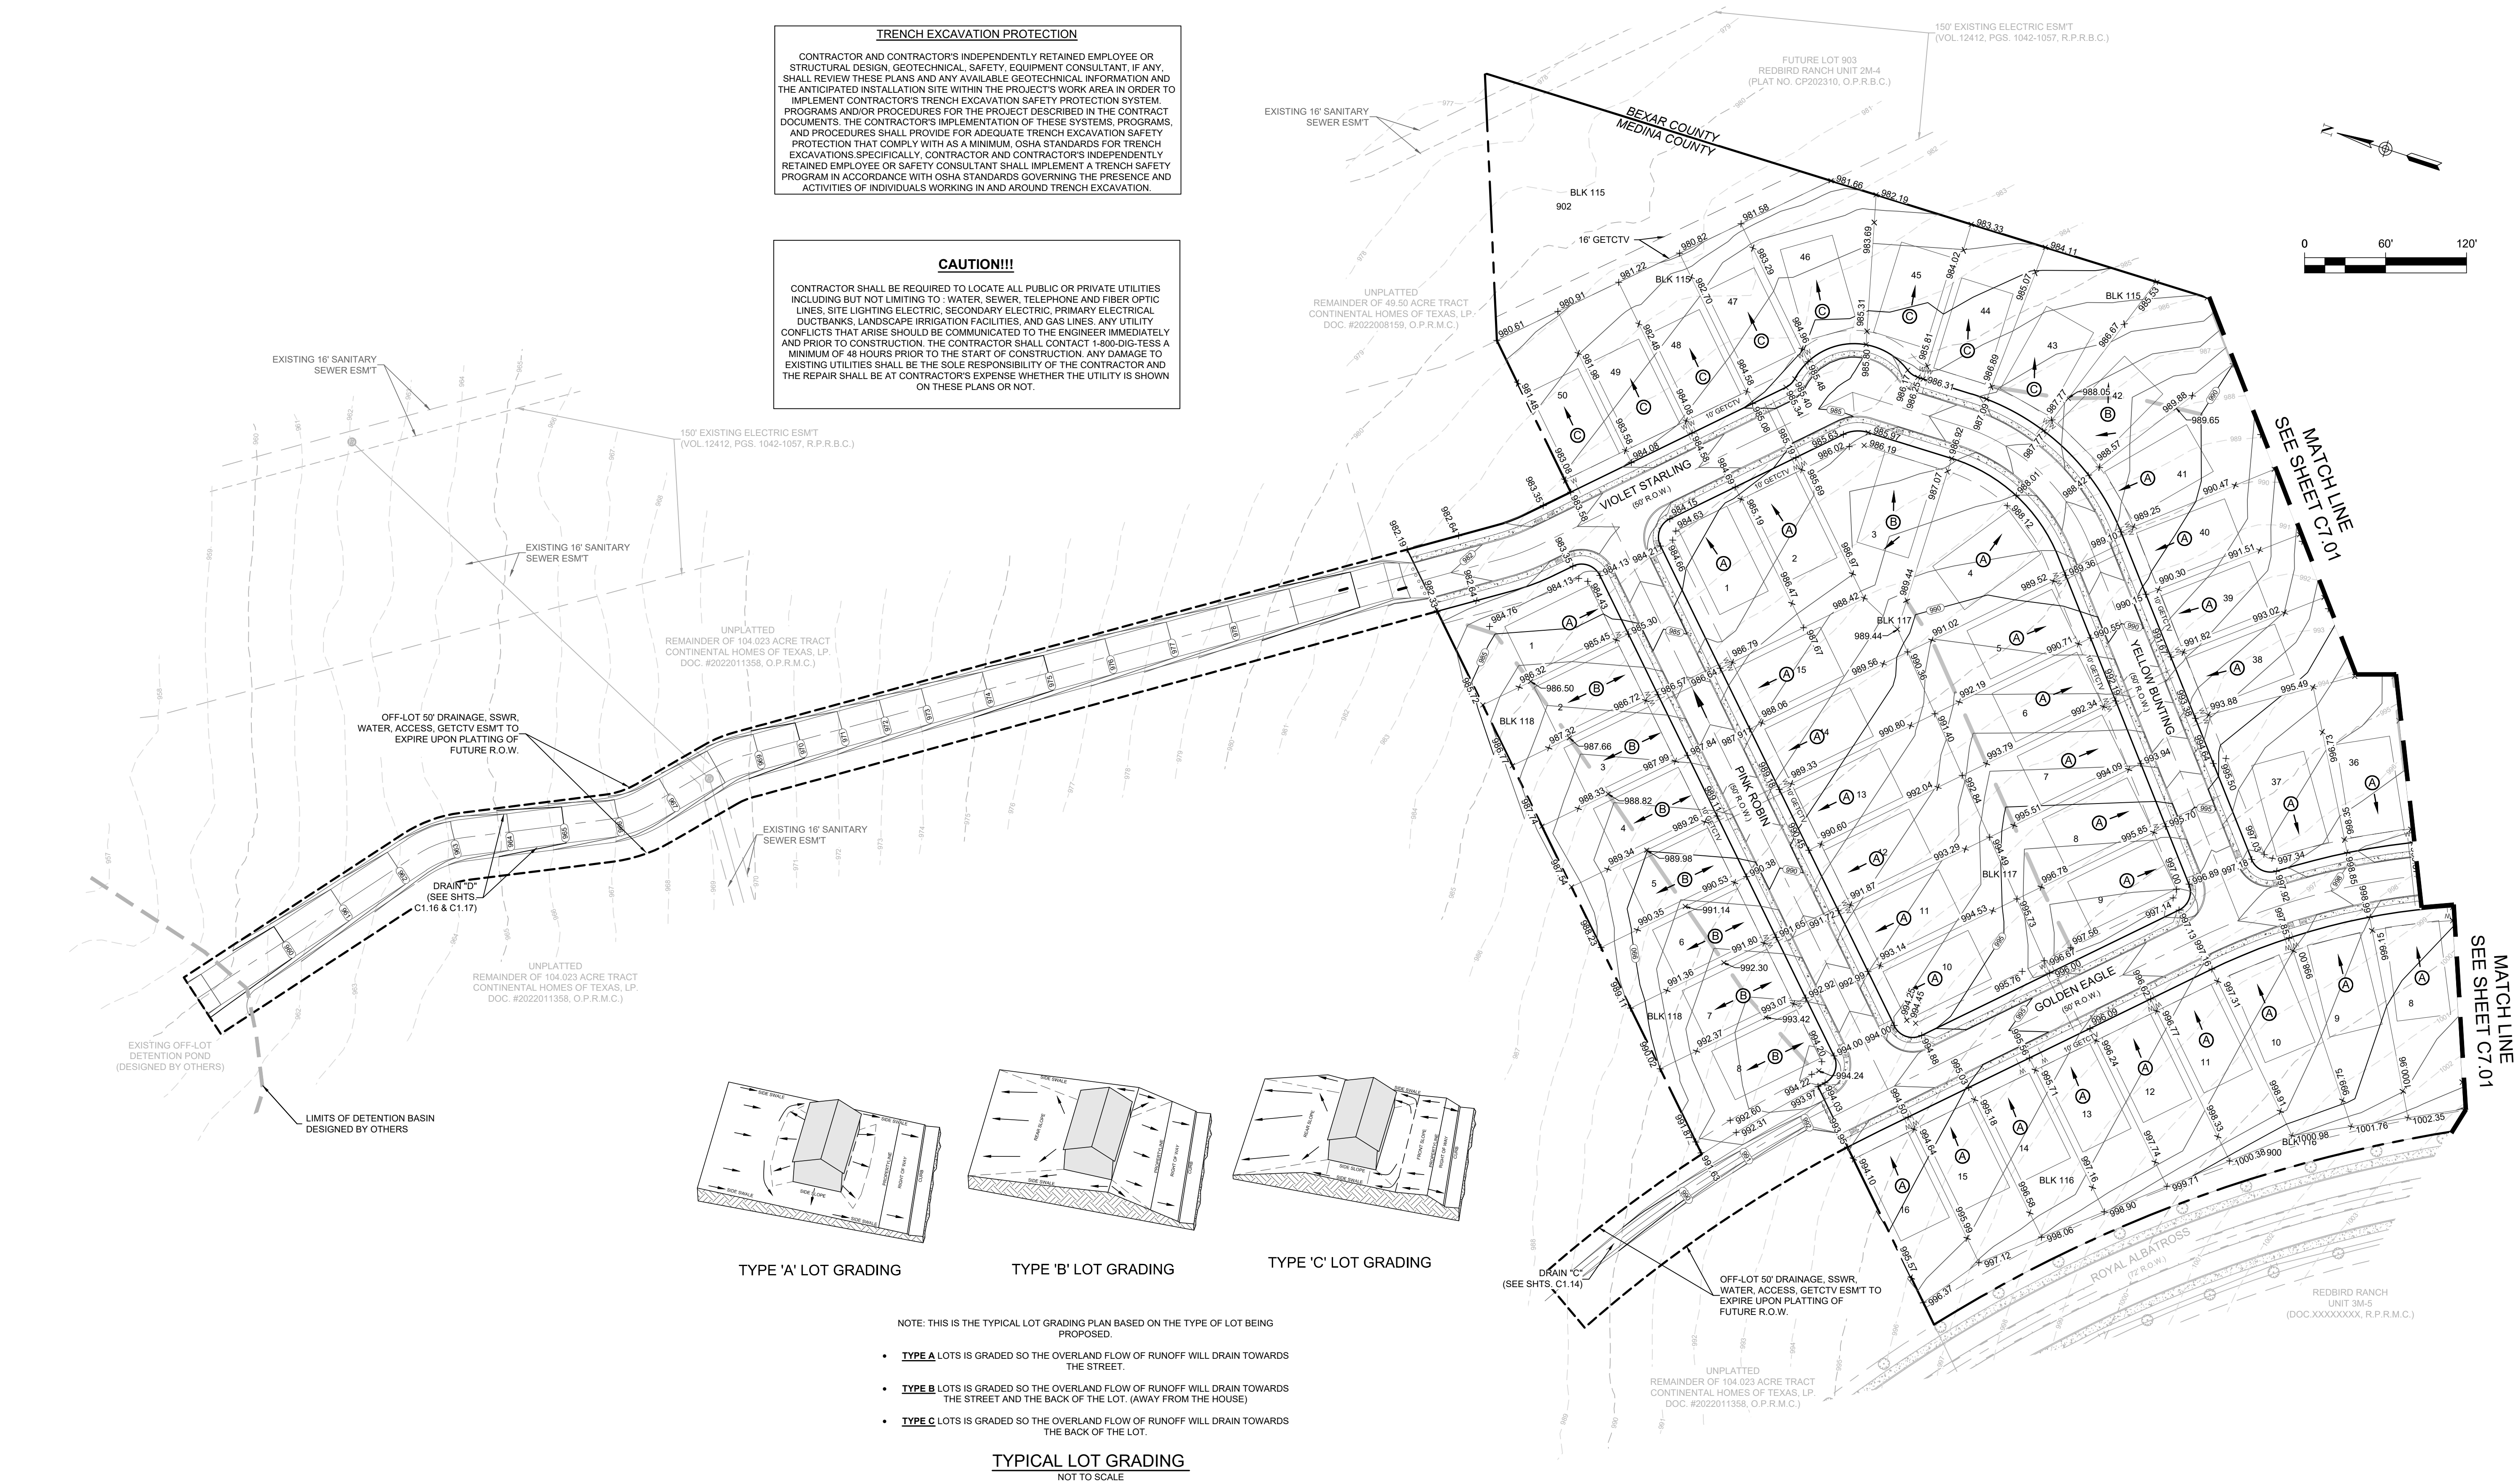[illegible]

3/20/2024



**DHI Engineering, LLC.**

**HL Engineering, LLC**  
5419 N. LOOP 1604 EAST  
SAN ANTONIO, TX 78247  
(210) 496-2668 | [hlengineering.com](http://hlengineering.com)  
TBPE REG. NO. F-19561

REDBIRD RANCH UNIT 2M-2  
SAN ANTONIO, TX


## OVERALL GRADING PLAN

DESIGNED BY:	JWS
DRAWN BY:	SQV/JWS
DATE:	3/20/2024
JOB NO.:	05000-200
SHEET NO.	

C7.00









DHI ENGINEERING, LLC. THIS DOCUMENT HAS BEEN PRODUCED FROM MATERIAL THAT WAS STORED AND/OR TRANSMITTED ELECTRONICALLY AND MAY HAVE BEEN INADVERTENTLY ALTERED. RELY ONLY ON FINAL HARD COPY MATERIALS BEARING THE CONSULTANT'S ORIGINAL SIGNATURE AND SEAL.

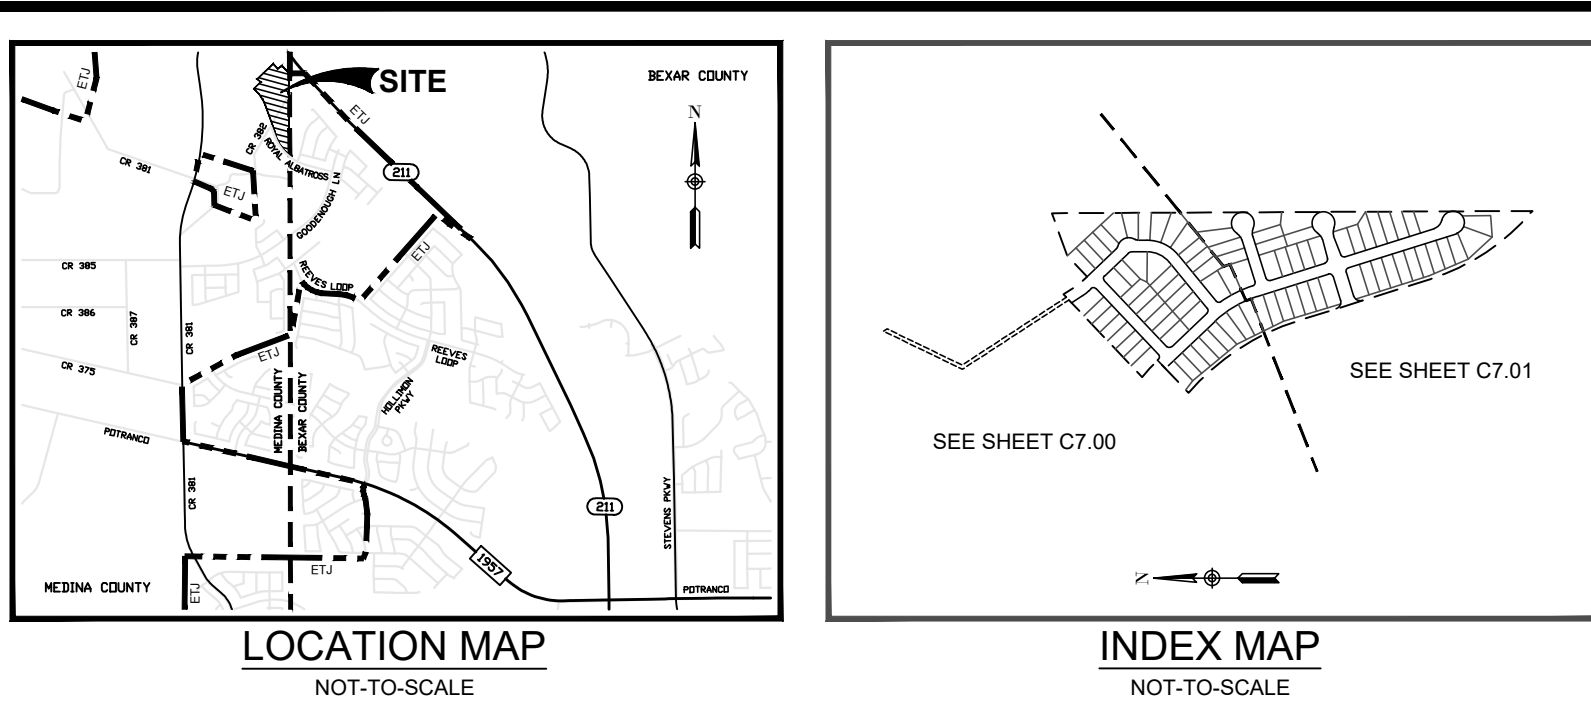

GENERAL GRADING NOTES:

1. ALL CONSTRUCTION PROCEDURES AND MATERIALS WITHIN THE SCOPE OF THE PROJECT THAT IS NOT SPECIFICALLY COVERED IN THE PLANS OF GEOTECHNICAL REPORT SHALL BE CONFORMED TO ALL APPLICABLE CITY, COUNTY AND TXDOT STANDARD REQUIREMENTS FOR PUBLICS WORKS CONSTRUCTION.
2. SITE PREPARATION AND GRADING SHALL BE COMPLETED IN ACCORDANCE WITH THE PROJECTS GEOTECHNICAL REPORT AND SPECIFICATIONS.
3. ALL SELECT FILL MATERIALS PROVIDED SHALL BE APPROVED BY THE GEOTECHNICAL ENGINEER PRIOR TO PLACING AND COMPACTING.
4. ALL ELEVATIONS AND PROPOSED CONTOURS SHOWN ON THIS PLAN REFLECTS FINISHED GRADES. THE THICKNESS OF PAVEMENT, BASE, GRASS, AND TOP SOIL MUST BE SUBTRACTED TO OBTAINED SUBGRADE ELEVATIONS.
5. THE CONTRACTOR SHALL NOTIFY THE ENGINEER OF ANY QUESTIONS THEY HAVE REGARDING THE INTENT, PLACEMENT, OR LIMITS OF DIMENSIONS OR GRADES NECESSARY FOR CONSTRUCTION OF THIS PROJECT.
6. THE CONTRACTOR SHALL VERIFY THE SUITABILITY OF ALL EXISTING AND PROPOSED SITE CONDITIONS INCLUDING GRADES AND DIMENSIONS BEFORE THE START OF CONSTRUCTION. IF THERE ARE ANY DISCREPANCIES, CONTACT THE ENGINEER.
7. THE CONTRACTOR SHALL BE RESPONSIBLE FOR ACQUIRING ALL PERMITS, TEST, APPROVALS AND ACCEPTANCES REQUIRED TO COMPLETE CONSTRUCTION OF THIS PROJECT.
8. THE CONTRACTOR SHALL REMOVE TOP SOIL, GRASS, ROOTS, DEBRIS, ETC. AND DISPOSE OF THOSE ITEMS THAT ARE NOT SUITABLE FOR EMBANKMENT AND TOPSOIL. CLEAN STRIPPING AND TOPSOIL MAY BE STOCKPILED ON SITE FOR REUSE IN A LOCATION SPECIFIED BY THE OWNER.
9. THE CONTRACTOR IS RESPONSIBLE FOR REVEGETATE ALL DISTURBED AREAS IN ACCORDANCE WITH PROJECT SPECIFICATION AND TPDES/SWPPP REQUIREMENTS. REFER TO THE LANDSCAPE ARCHITECT'S PLAN IF APPLICABLE.
10. THE CONTRACTOR SHALL TAKE ALL NECESSARY PRECAUTIONS TO KEEP DRAINAGE AND SILT FROM WASHING ONTO ADJACENT PROPERTY, STREETS, OR DRAINAGE WAY. CONTRACTOR SHALL IMMEDIATELY REMOVE SILT/DEBRIS THAT WASHES OFFSITE OR INTO EXISTING STORM DRAIN SYSTEMS. REFER TO THE SWPPP PLAN.
11. THE CONTRACTOR SHALL OBTAIN GRADES SHOWN HEREIN WITHIN  $\pm 0.1$  TENTH OF A FOOT.
12. IN PROPOSED PAVED AREAS AND STREET DESIGN PLANS SHALL CONTROL. ALL EARTHEN SLOPES SHALL BE A MAXIMUM OF 3:1 AND A MINIMUM OF 1:0% UNLESS OTHERWISE STATED.
13. THE CONTRACTOR SHALL PROVIDE A SMOOTH TRANSITION BETWEEN EXISTING AND PROPOSED SITE CONDITIONS.
14. THE CONTRACTOR SHALL BE RESPONSIBLE FOR RESTORING ANY DAMAGE DONE TO EXISTING TREES, BUILDINGS, UTILITIES, FENCES, PAVEMENT, CURBS, OR DRIVEWAYS BACK TO EXISTING CONDITIONS OR BETTER. (NO SEPARATE PAY ITEMS.)
15. THE CONTRACTOR SHALL EXERCISE EXTREME CAUTION IN WORKING NEAR UTILITIES, GAS LINES, SEWER, OR EXISTING APPURTENANCES PRIOR TO PERFORMING ANY EXCAVATION. CONTRACTOR SHALL CONTACT ALL UTILITY COMPANIES AND ASSURE HIMSELF THAT ALL UTILITIES HAVE BEEN ADEQUATELY LOCATED AND IDENTIFIED. THE ENGINEER SHALL BE NOTIFIED IF ANY UTILITY CONFLICTS ARE IDENTIFIED.
16. UTILITIES SHOWN ON THE PLANS ARE FROM INFORMATION SOURCES AVAILABLE AT THE TIME OF DESIGN BUT MAY NOT REPRESENT ALL EXISTING UTILITIES ON SITE. THE CONTRACTOR WILL BE RESPONSIBLE FOR DETERMINING EXACT LOCATIONS OF ALL UTILITIES. WEATHER SHOWN ON THE PLANS OR NOT. THE CONTRACTOR SHALL UNCOVER EXISTING UTILITIES BEFORE CONSTRUCTION TO CONFIRM SIZE, GRADE AND LOCATION AND WILL CONTACT THE ENGINEER OF ANY DEVIATIONS FROM THE PLANS PRIOR TO BEGINNING CONSTRUCTION. ANY DAMAGE TO EXISTING UTILITIES WHETHER SHOWN ON THE PLANS OR NOT SHALL BE THE CONTRACTORS RESPONSIBILITY TO REPAIR AND THEIR OWN EXPENSE.
17. POSITIVE DRAINAGE SHALL BE MAINTAINED THROUGHOUT THE SCOPE OF THE PROJECT. DRAINAGE SHALL BE DIRECTED AWAY FROM ALL BUILDING FOUNDATIONS. CONTRACTOR SHALL TAKE PRECAUTIONS NOT TO ALLOW ANY PONDING OF WATER.
18. FILL PLACED ON HILL SIDES OR STEEP SLOPED AREAS, THE CONTRACTOR SHALL REFER TO THE PROJECT'S SPECIFICATIONS AND GEOTECHNICAL REPORT FOR SPECIAL INSTRUCTION REGARDING BENCHING.
19. NO WORK SHALL BE PERFORMED IN A PUBLIC RIGHT-OF-WAY WITHOUT A PERMIT.

LEGEND (GRADING)	
	PROJECT LIMITS
	OFFSITE EASEMENT
	EXISTING CONTOUR
	PROPOSED CONTOUR
	FLOW ARROW
	TYPICAL LOT GRADING
	PROPOSED ELEVATION
	GRADE BREAK

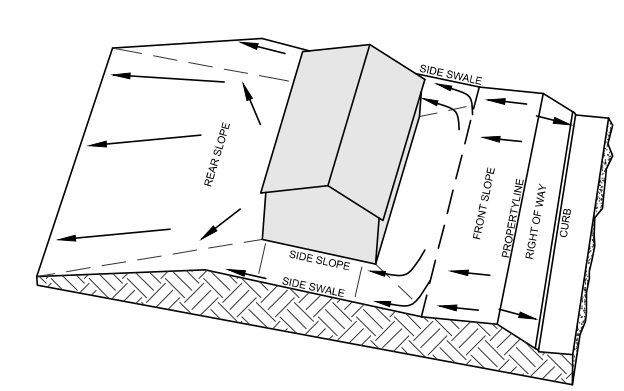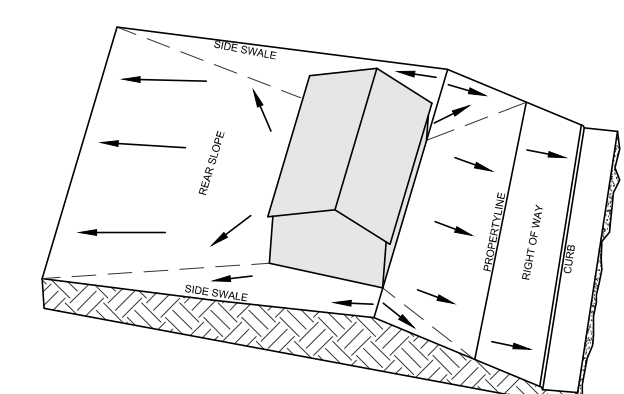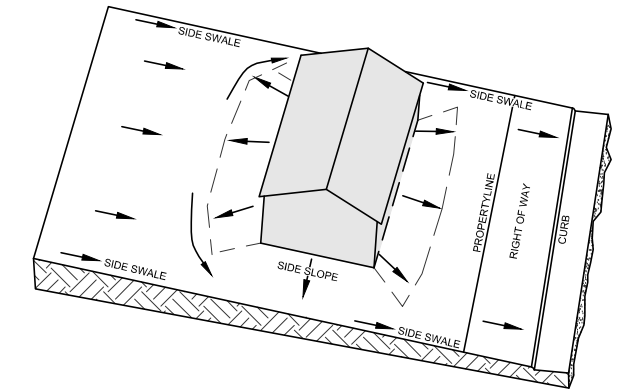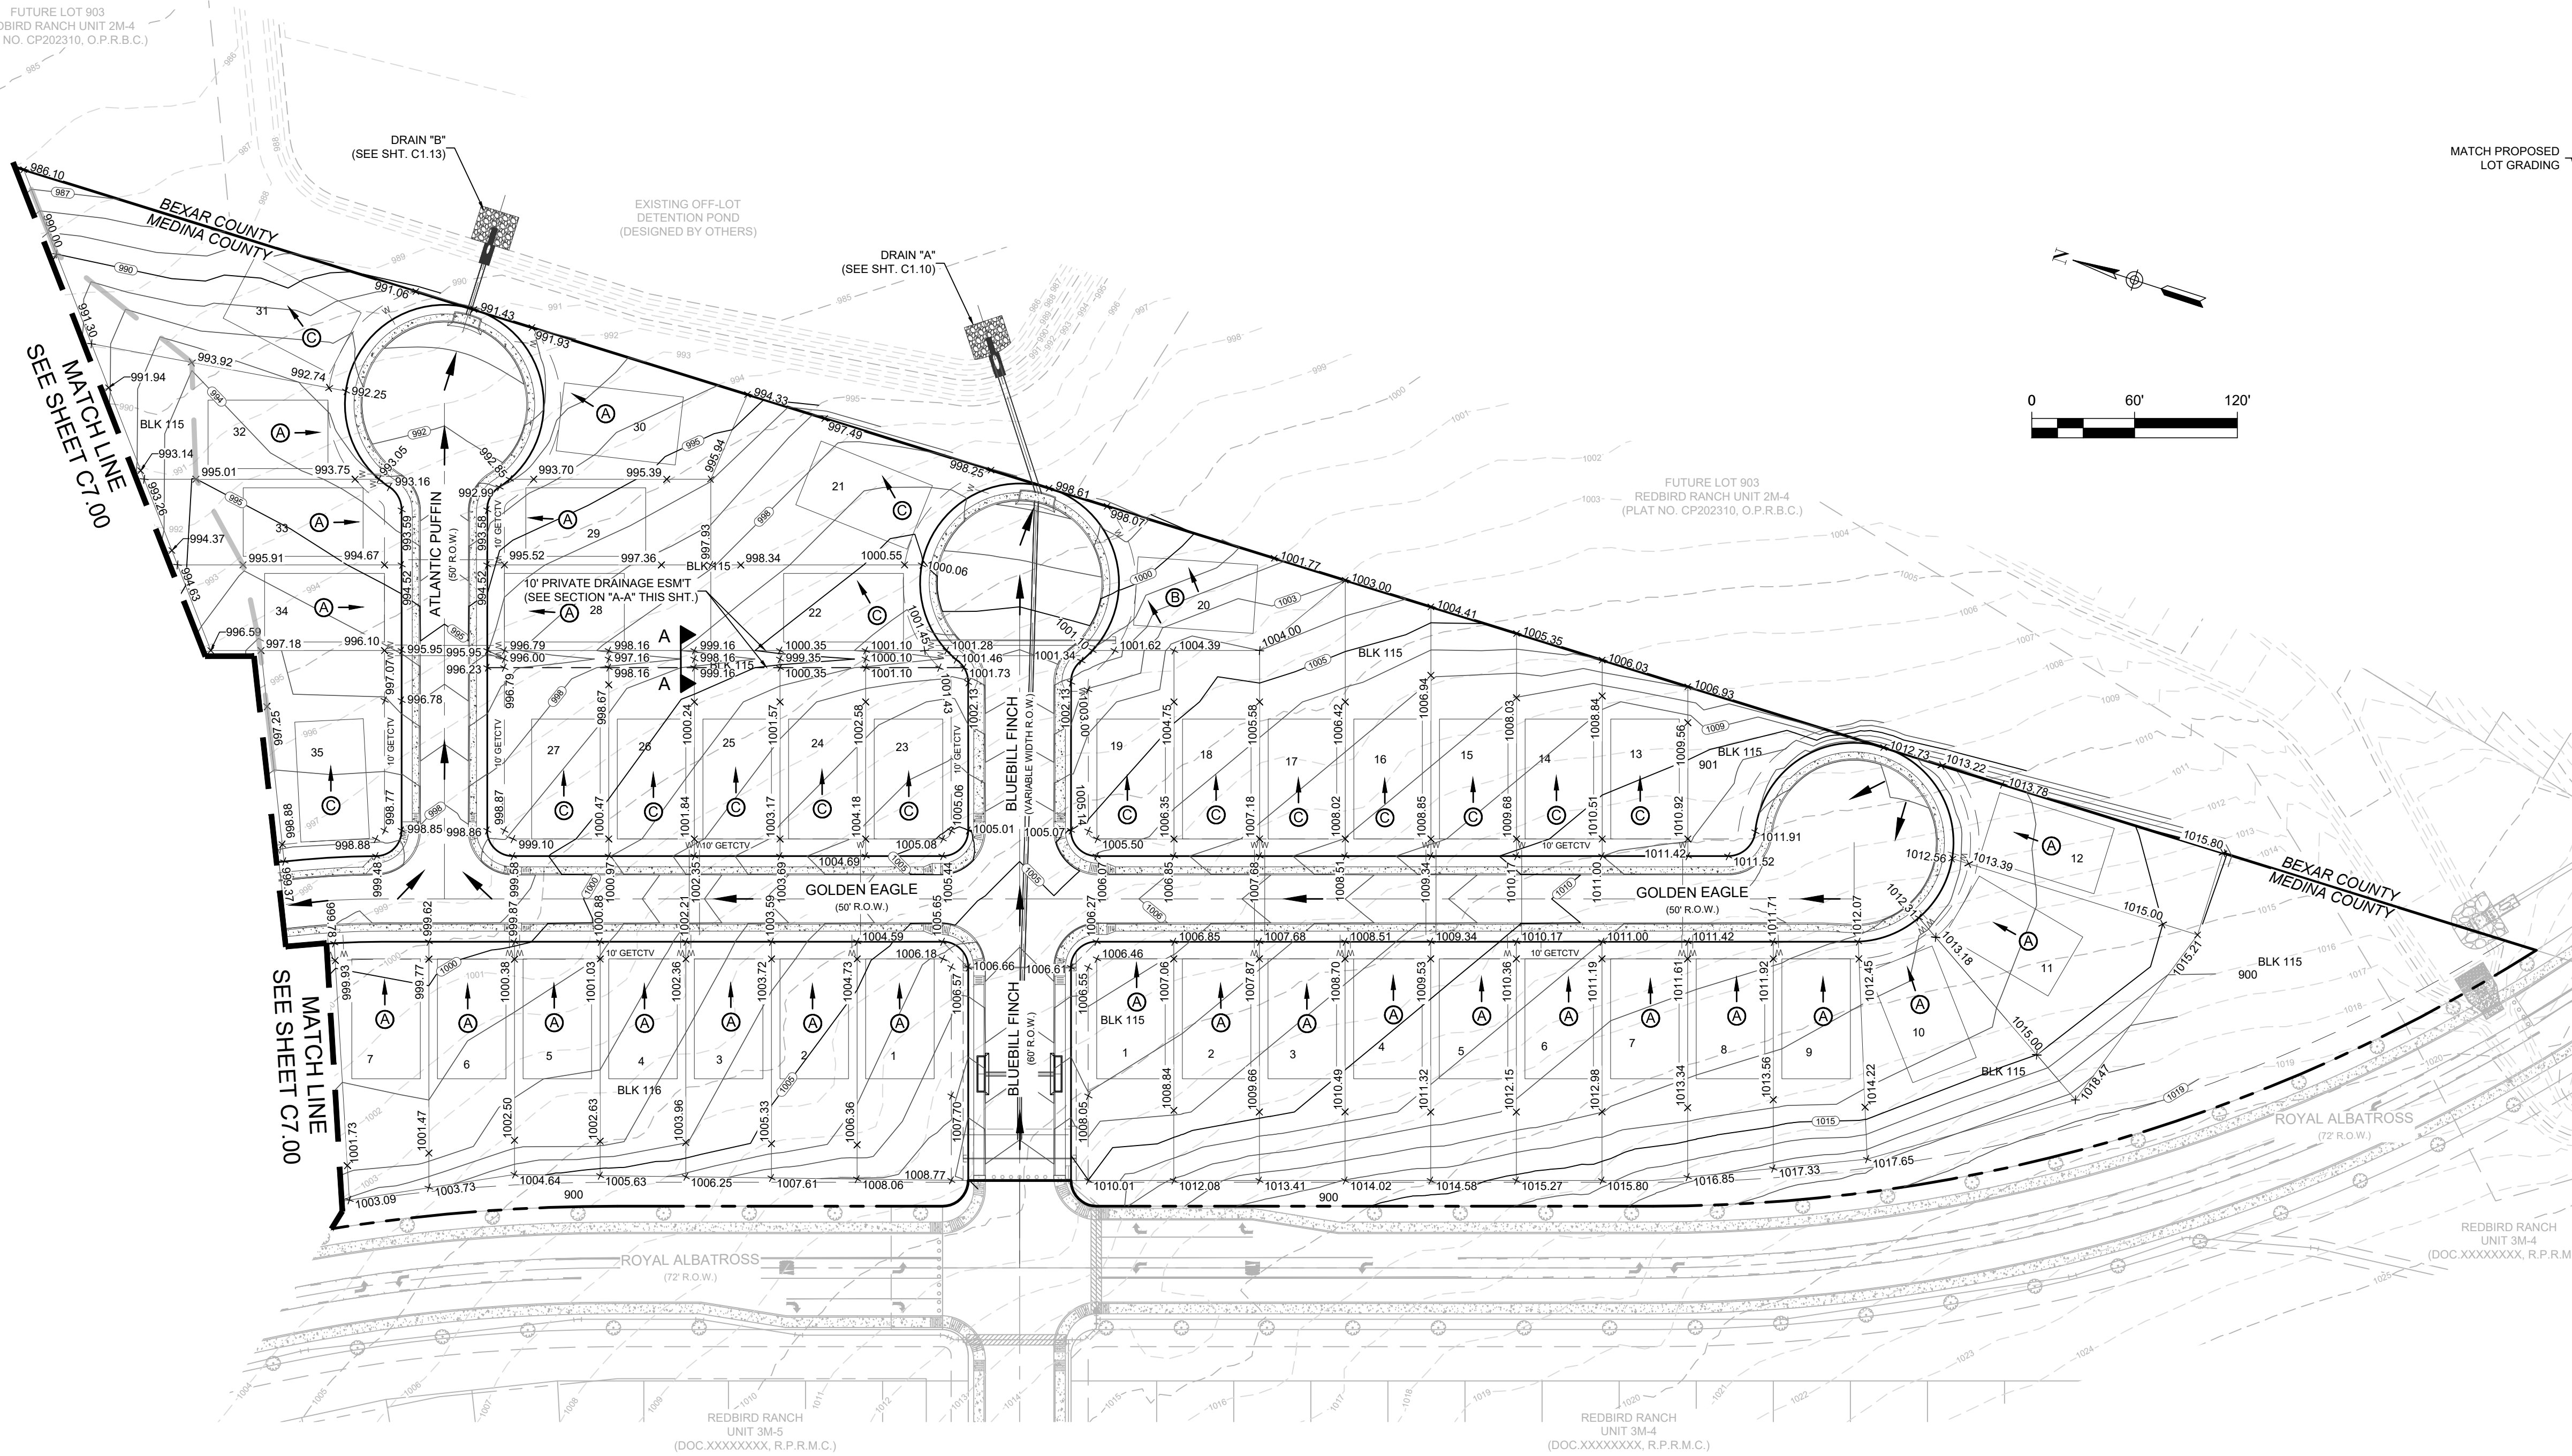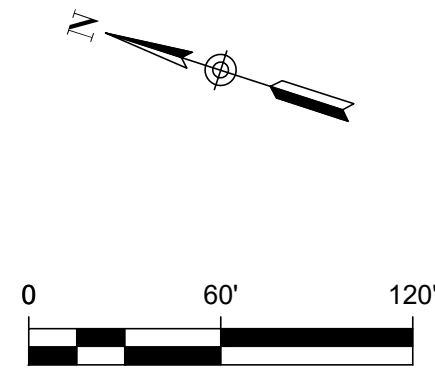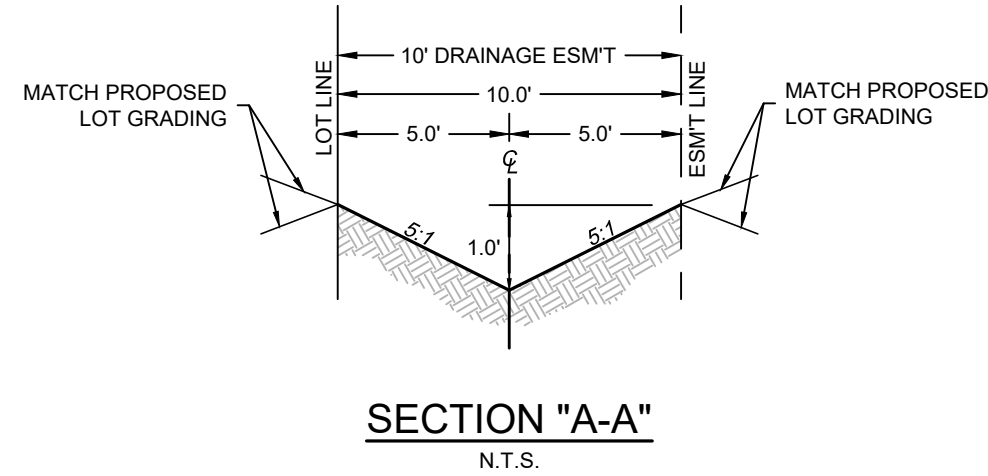

NOTE: THIS IS THE TYPICAL LOT GRADING PLAN BASED ON THE TYPE OF LOT BEING PROPOSED.

- **TYPE A** LOTS IS GRADED SO THE OVERLAND FLOW OF RUNOFF WILL DRAIN TOWARDS THE STREET.
- **TYPE B** LOTS IS GRADED SO THE OVERLAND FLOW OF RUNOFF WILL DRAIN TOWARDS THE STREET AND THE BACK OF THE LOT. (AWAY FROM THE HOUSE)
- **TYPE C** LOTS IS GRADED SO THE OVERLAND FLOW OF RUNOFF WILL DRAIN TOWARDS THE BACK OF THE LOT.

TYPICAL LOT GRADING  
NOT TO SCALE

TRENCH EXCAVATION PROTECTION

CONTRACTOR AND CONTRACTOR'S INDEPENDENTLY RETAINED EMPLOYEE OR STRUCTURAL DESIGN, GEOTECHNICAL, SAFETY, EQUIPMENT CONSULTANT, IF ANY, SHALL REVIEW THESE PLANS AND ANY AVAILABLE GEOTECHNICAL, INFORMATION AND THE ANTICIPATED INSTALLATION SITE WITHIN THE PROJECT'S WORK AREA IN ORDER TO IMPLEMENT CONTRACTOR'S TRENCH EXCAVATION SAFETY PROTECTION SYSTEM. PROGRAMS AND/OR PROCEDURES FOR THE PROJECT DESCRIBED IN THE CONTRACT DOCUMENTS. THE CONTRACTOR'S IMPLEMENTATION OF THESE SYSTEMS, PROGRAMS, AND PROCEDURES SHALL PROVIDE FOR ADEQUATE TRENCH EXCAVATION SAFETY PROTECTION THAT COMPLY WITH AS A MINIMUM, OSHA STANDARDS FOR TRENCH EXCAVATIONS SPECIFICALLY, CONTRACTOR AND CONTRACTOR'S INDEPENDENTLY RETAINED EMPLOYEE OR SAFETY CONSULTANT SHALL IMPLEMENT A TRENCH SAFETY PROGRAM IN ACCORDANCE WITH OSHA STANDARDS GOVERNING THE PRESENCE AND ACTIVITIES OF INDIVIDUALS WORKING IN AND AROUND TRENCH EXCAVATION.

CAUTION!!!

CONTRACTOR SHALL BE REQUIRED TO LOCATE ALL PUBLIC OR PRIVATE UTILITIES INCLUDING BUT NOT LIMITING TO: WATER, SEWER, TELEPHONE AND FIBER OPTIC LINES, SITE LIGHTING ELECTRIC, SECONDARY ELECTRIC, PRIMARY ELECTRICAL DUCTBANKS, LANDSCAPE IRRIGATION FACILITIES, AND GAS LINES. ANY UTILITY CONFLICTS THAT ARISE SHOULD BE COMMUNICATED TO THE ENGINEER IMMEDIATELY AND PRIOR TO CONSTRUCTION. THE CONTRACTOR SHALL CONTACT 1-800-DIG-TESS A MINIMUM OF 48 HOURS PRIOR TO THE START OF CONSTRUCTION. ANY DAMAGE TO EXISTING UTILITIES SHALL BE THE SOLE RESPONSIBILITY OF THE CONTRACTOR AND THE REPAIR SHALL BE AT CONTRACTOR'S EXPENSE WHETHER THE UTILITY IS SHOWN ON THESE PLANS OR NOT.

REDBIRD RANCH UNIT 2M-2  
SAN ANTONIO, TX

OVERALL GRADING PLAN

DESIGNED BY: JWS  
DRAWN BY: SQV/JWS  
DATE: 3/20/2024  
JOB NO.: 05000-200  
SHEET NO.

C7.01


DHI Engineering, LLC.  
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TXBPE REG. NO. F-19561




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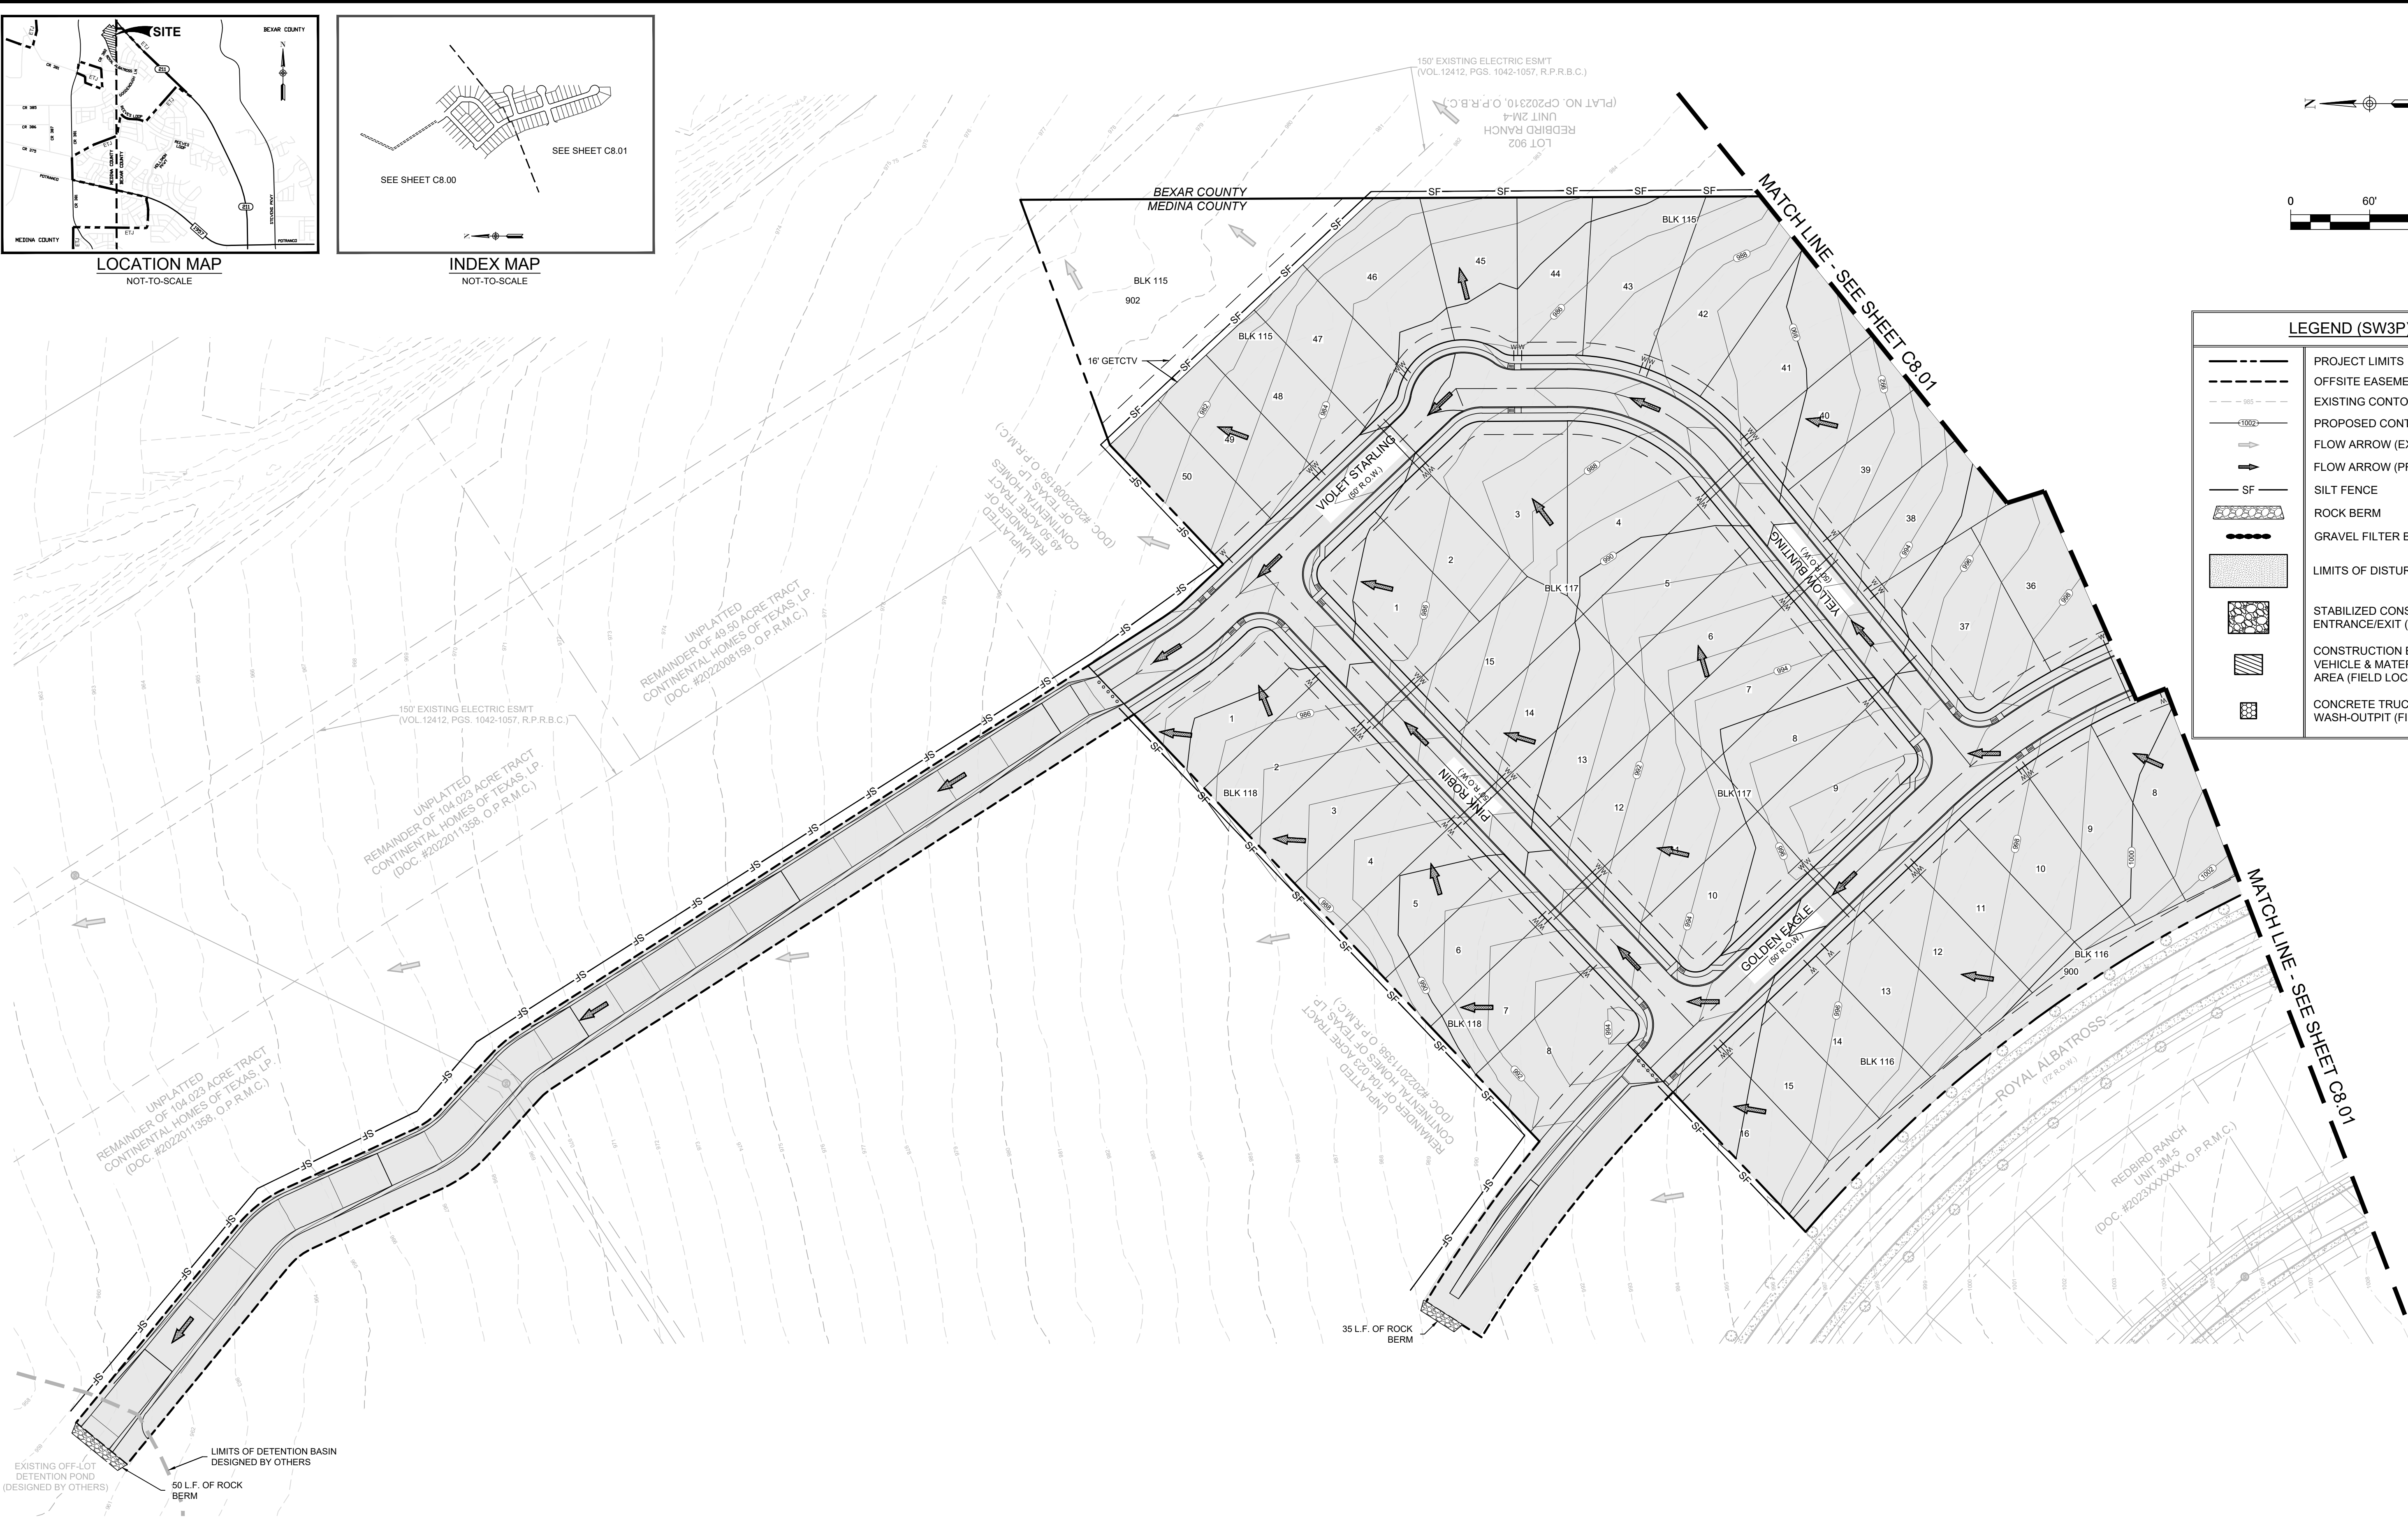
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LOCATION MAP  
NOT-TO-SCALE



INDEX MAP  
NOT-TO-SCALE

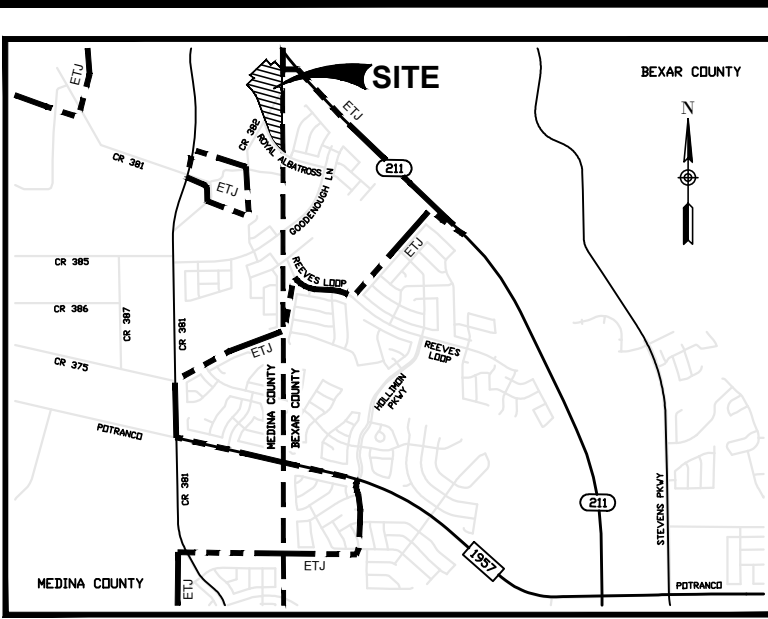

SW3P MODIFICATIONS		
DATE	SIGNATURE	DESCRIPTION

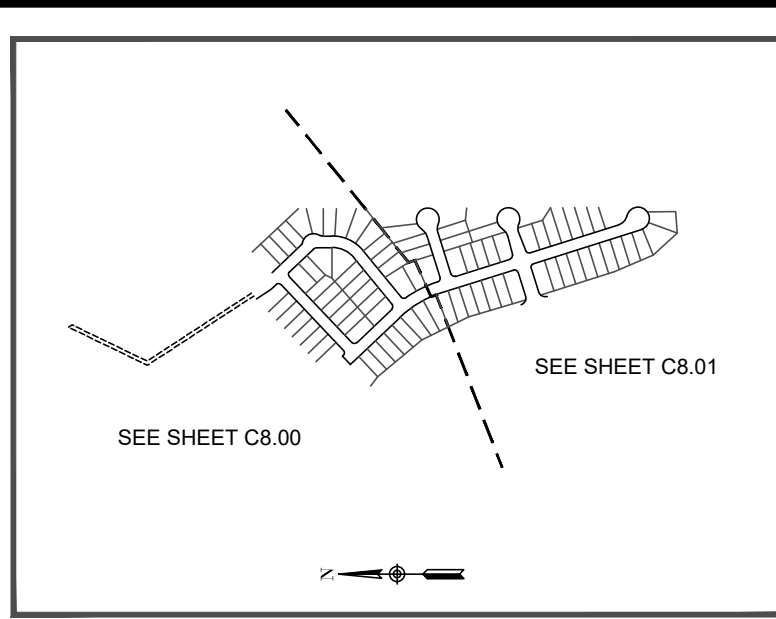- GENERAL NOTES:
- DO NOT DISTURB VEGETATED AREAS (TREES, GRASS, WEEDS, BRUSH, ETC.) ANY MORE THAN NECESSARY FOR CONSTRUCTION.
  - CONSTRUCTION ENTRANCE/EXIT LOCATION, CONCRETE WASH-OUT PIT, AND CONSTRUCTION EQUIPMENT AND MATERIAL STORAGE YARD TO BE DETERMINED IN THE FIELD.
  - STORM WATER POLLUTION PREVENTION CONTROLS MAY NEED TO BE MODIFIED IN THE FIELD TO ACCOMPLISH THE DESIRED EFFECT. ALL MODIFICATIONS ARE TO BE NOTED ON THIS EXHIBIT AND SIGNED AND DATED BY THE RESPONSIBLE PARTY.
  - RESTRICT ENTRY/EXIT TO PROJECT SITE TO DESIGNATED LOCATIONS BY USE OF ADEQUATE FENCING IF NECESSARY.
  - ALL STORM WATER POLLUTION PREVENTION CONTROLS ARE TO BE MAINTAINED AND IN WORKING CONDITIONS AT ALL TIMES.
  - FOR A COMPLETE LISTING OF TEMPORARY STORM WATER POLLUTION PREVENTION CONTROLS REFER TO THE TPDES STORM WATER POLLUTION PREVENTION PLAN.
  - STORM WATER POLLUTION PREVENTION STRUCTURES SHOULD BE CONSTRUCTED WITHIN THE SITE BOUNDARIES. SOME OF THESE FEATURES MAY BE SHOWN OUTSIDE THE SITE BOUNDARIES ON THIS PLAN FOR VISUAL CLARITY.
  - AS SOON AS POSSIBLE, ALL DISTURBED SOIL THAT WILL NOT BE COVERED BY IMPERVIOUS COVER SUCH AS PARKWAY AREAS, EASEMENTS AREAS, EMBANKMENT SLOPES, ETC. WILL BE STABILIZED PER APPLICABLE PROJECT SPECIFICATIONS.
  - BEST MANAGEMENT PRACTICES MAY BE INSTALLED IN STAGES TO COINCIDE WITH THE DISTURBANCE OF UNGRADED AREAS.
  - BEST MANAGEMENT PRACTICES MAY BE REMOVED IN STAGES ONCE THE WATERSHED FOR THAT PORTION CONTROLLED BY THE BEST MANAGEMENT PRACTICE HAS BEEN STABILIZED IN ACCORDANCE WITH TPDES REQUIREMENTS.

- UPON COMPLETION OF THE PROJECT, INCLUDING SITE STABILIZATION, AND BEFORE FINAL PAYMENT IS ISSUED, CONTRACTOR SHALL REMOVE ALL SEDIMENT AND EROSION CONTROL MEASURES, PAYING SPECIAL ATTENTION TO ROCK BERMS IN DRAINAGE FEATURES.
- WHERE VEGETATED FILTER STRIPS ARE INDICATED, CONTRACTOR SHALL VERIFY THAT SUFFICIENT VEGETATION EXISTS. OTHERWISE CONTRACTOR SHALL PLACE SILT FENCING IN LIEU OF VEGETATED FILTER STRIP.
- SHADED AREA DENOTING LIMITS OF DISTURBED AREAS, OTHER AREAS WITHIN THE PROJECT LIMITS, WITH THE EXPECTATION OF A CONSTRUCTION EQUIPMENT AND MATERIALS STORAGE YARD, ARE NOT A PART OF THIS TPDES STORM WATER POLLUTION PREVENTION PLAN (SW3P) AND WILL NOT BE DISTURBED BY CIVIL CONSTRUCTION ACTIVITIES/ HOUSE CONSTRUCTION ACTIVITIES WILL REQUIRE A SEPARATE STORM WATER POLLUTION PREVENTION PLAN.
- PRIOR TO BEGINNING CONSTRUCTION, CONTRACTOR SHALL COORDINATE PLACEMENT OF TEMPORARY BEST MANAGEMENT PRACTICES WITHIN 1X20 FT RIGHT-OF-WAY WITH TxDOT.
- CPS ENERGY WILL FUNCTION AS A SECONDARY OPERATOR ON THIS PROJECT AND WILL BE INSTALLING ELECTRIC UTILITIES FOR ON-SITE CONSTRUCTION AND OFF-SITE FEED TO THE PROJECT.
- THE ENGINEERING SEAL HAS BEEN AFFIXED TO THIS SHEET ONLY FOR THE PURPOSE OF DEMONSTRATING COMPLIANCE WITH THE TPDES-STORM WATER POLLUTION PREVENTION PLAN (SW3P) REGULATIONS.
- THIS SHEET HAS BEEN PREPARED FOR PURPOSES OF THE SW3P ONLY. ALL OTHER CIVIL ENGINEERING RELATED INFORMATION SHOULD BE ACQUIRED FROM THE APPROPRIATE SHEET IN THE CIVIL IMPROVEMENTS PLANS.

CAUTION!!!

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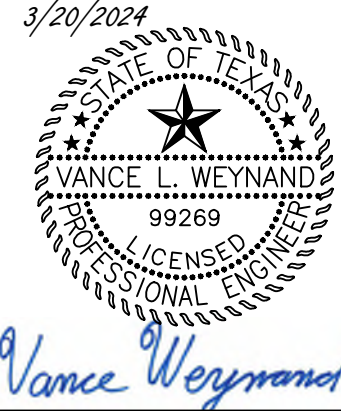
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REDBIRD RANCH UNIT 2M-2  
SAN ANTONIO, TX  
STORM WATER POLLUTION PREVENTION PLAN

DESIGNED BY: JWS  
DRAWN BY: SQV/JWS  
DATE: 3/20/2024  
JOB NO.: 05000-200  
SHEET NO.

C8.00




DHI Engineering, LLC.  
4419 LOOP 1604 EAST  
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(210) 482-2988 | dhiengineering.com  
TBP REG. NO. F-195661

DHI


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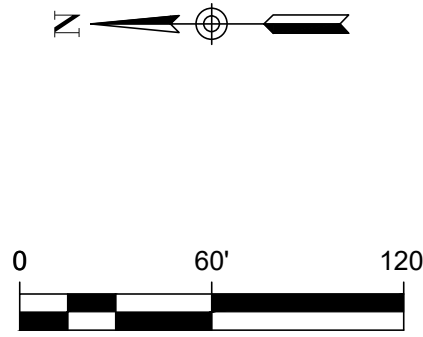
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LOCATION MAP  
NOT-TO-SCALE



INDEX MAP  
NOT-TO-SCALE

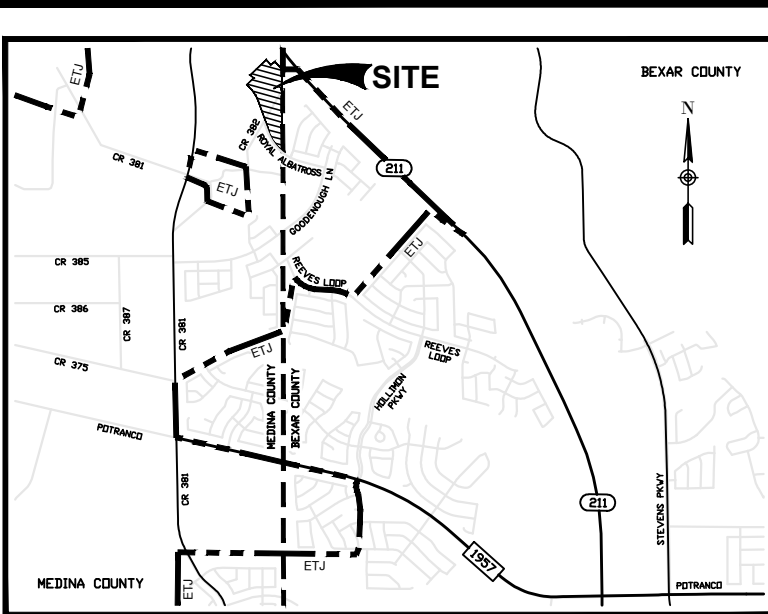

LEGEND (SW3P)	
	PROJECT LIMITS
	OFFSITE EASEMENTS
	EXISTING CONTOUR
	PROPOSED CONTOUR
	FLOW ARROW (EXISTING)
	FLOW ARROW (PROPOSED)
	SILT FENCE
	ROCK BERM
	GRAVEL FILTER BAGS
	LIMITS OF DISTURBED AREA
	STABILIZED CONSTRUCTION ENTRANCE/EXIT (FIELD LOCATE)
	CONSTRUCTION EQUIPMENT, VEHICLE & MATERIALS STORAGE AREA (FIELD LOCATE)
	CONCRETE TRUCK WASH-OUT PIT (FIELD LOCATE)

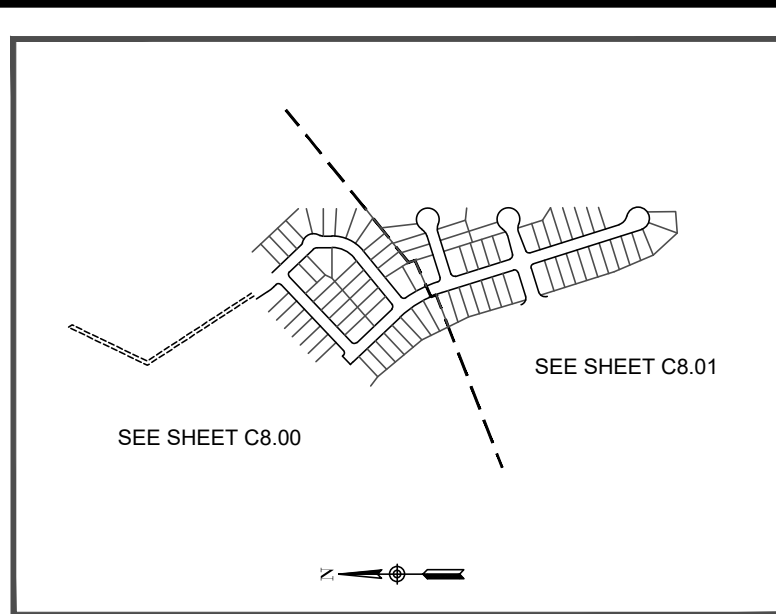SW3P MODIFICATIONS		
DATE	SIGNATURE	DESCRIPTION

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DESIGNED BY: JWS

DRAWN BY: SQV/JWS

DATE: 3/20/2024

JOB NO.: 05000-200

SHEET NO. C8.01

REDBIRD RANCH UNIT 2M-2

SAN ANTONIO, TX

STORM WATER POLLUTION PREVENTION PLAN

DHI Engineering, LLC.

4419 LOOP 1604 EAST  
SUITE 100  
SAN ANTONIO, TEXAS 78217  
(210) 482-2988 | dhiengineering.com  
TBP REG. NO. F-19561

DHI

3/20/2024

REV

DATE

DESCRIPTION

STATE OF TEXAS

99269



VANCE L. WEYLAND

PROFESSIONAL ENGINEER

DOC # XXXXXXXXXXXXX




REDBIRD RANCH UNIT 2M-2



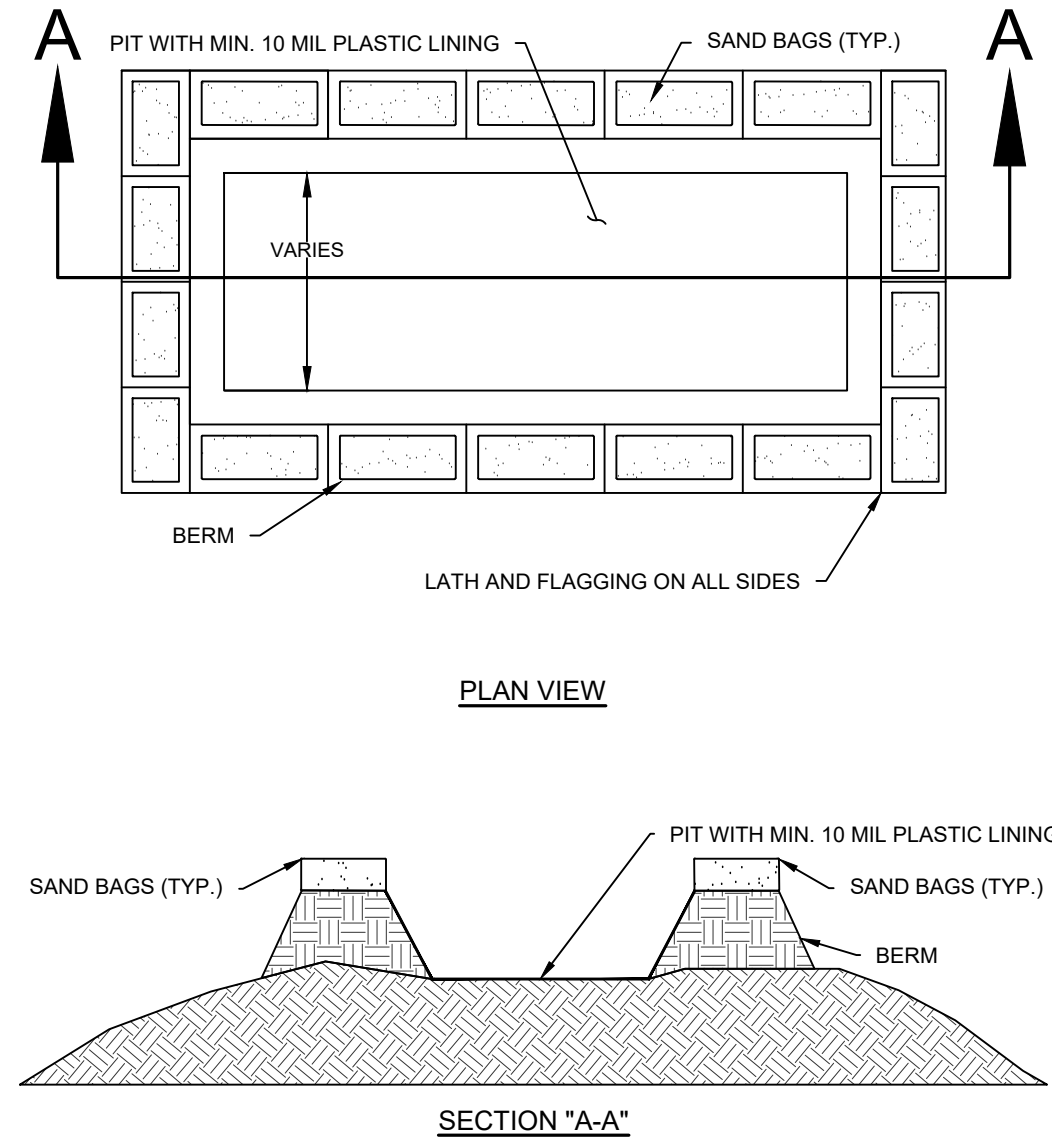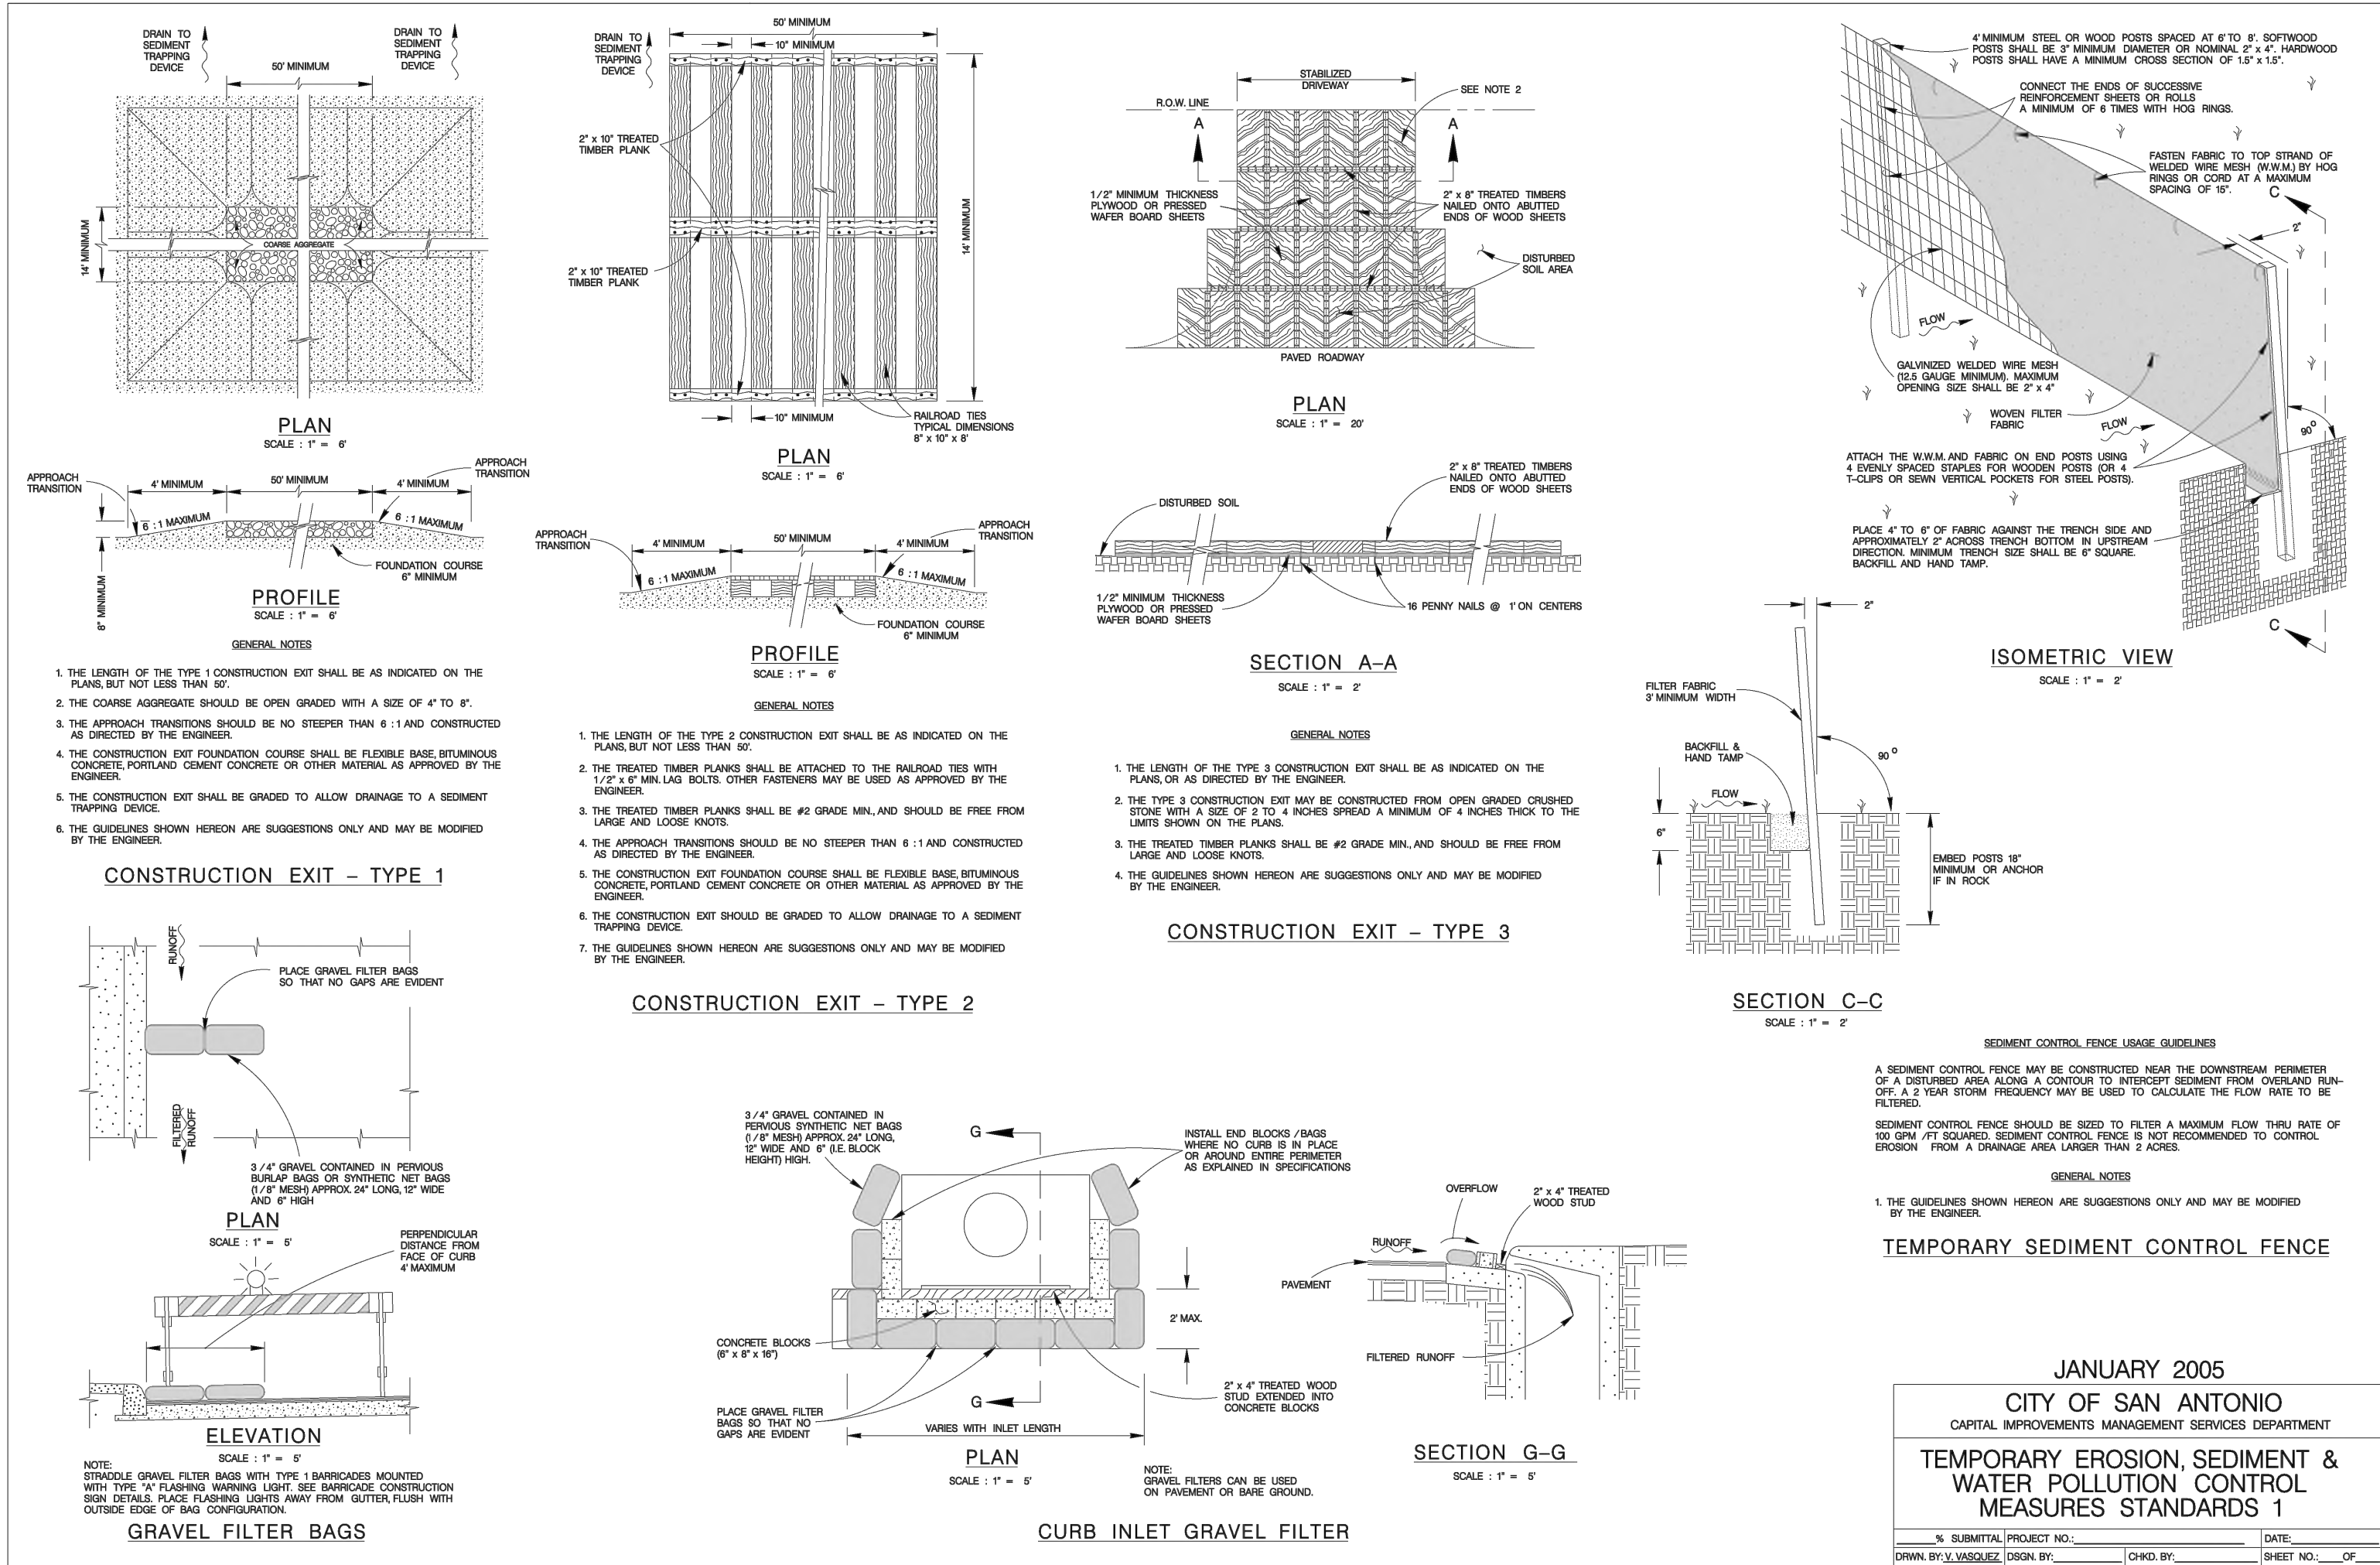

- MATERIALS:**  
A IMPERMEABLE POLYETHYLENE LINING SHEET (MIN. 10 MIL) SHOULD BE INSTALLED WITH NO DEFECTS IN ORDER TO PREVENT LEAKS.
- GENERAL NOTES:**  
1. DETAIL ABOVE ILLUSTRATES MINIMUM DIMENSIONS AND CAN BE RESIZED DEPENDING ON EXPECTED FREQUENCY OF USE.  
2. WASHOUT PIT SHALL BE LOCATED AS DESIGNATED ON PLANS UNLESS A MORE SUITABLE LOCATION IS FOUND ONSITE.  
3. WASHOUT PIT SHALL BE LOCATED IN AN AREA EASILY ACCESSIBLE TO CONSTRUCTION TRAFFIC, BUT OUT OF THE WAY OF STORM WATER RUNOFF.  
4. WASHOUT PIT SHALL BE LOCATED 50 FEET WAY FROM ANY SITE SENSITIVE FEATURES, RECEIVING BODIES OF WATER, OR DRAINAGE STRUCTURES.  
5. WASHOUT PIT SHALL BE SIZED TO CONTAIN THE QUANTITY AND VOLUME TO REQUIRED TO CONTAIN THE WASTE GENERATED BY WASHOUT OPERATIONS.
- MAINTENANCE:**  
1. REMOVE AND DISPOSE HARDENED CONCRETE LEFT IN THE WASHOUT PIT ONCE THE PROJECT IS COMPLETED.  
2. DECONSTRUCT THE WASHOUT PIT AND DISPOSED OF THE MATERIALS USED ONCE THE PROJECT IS COMPLETED.  
3. BACKFILL AND REPAIR ANY GROUND DISTURBANCES CAUSED BY THE REMOVAL OF THE WASHOUT PIT.

**CONCRETE TRUCK WASHOUT PIT DETAIL**  
NOT TO SCALE

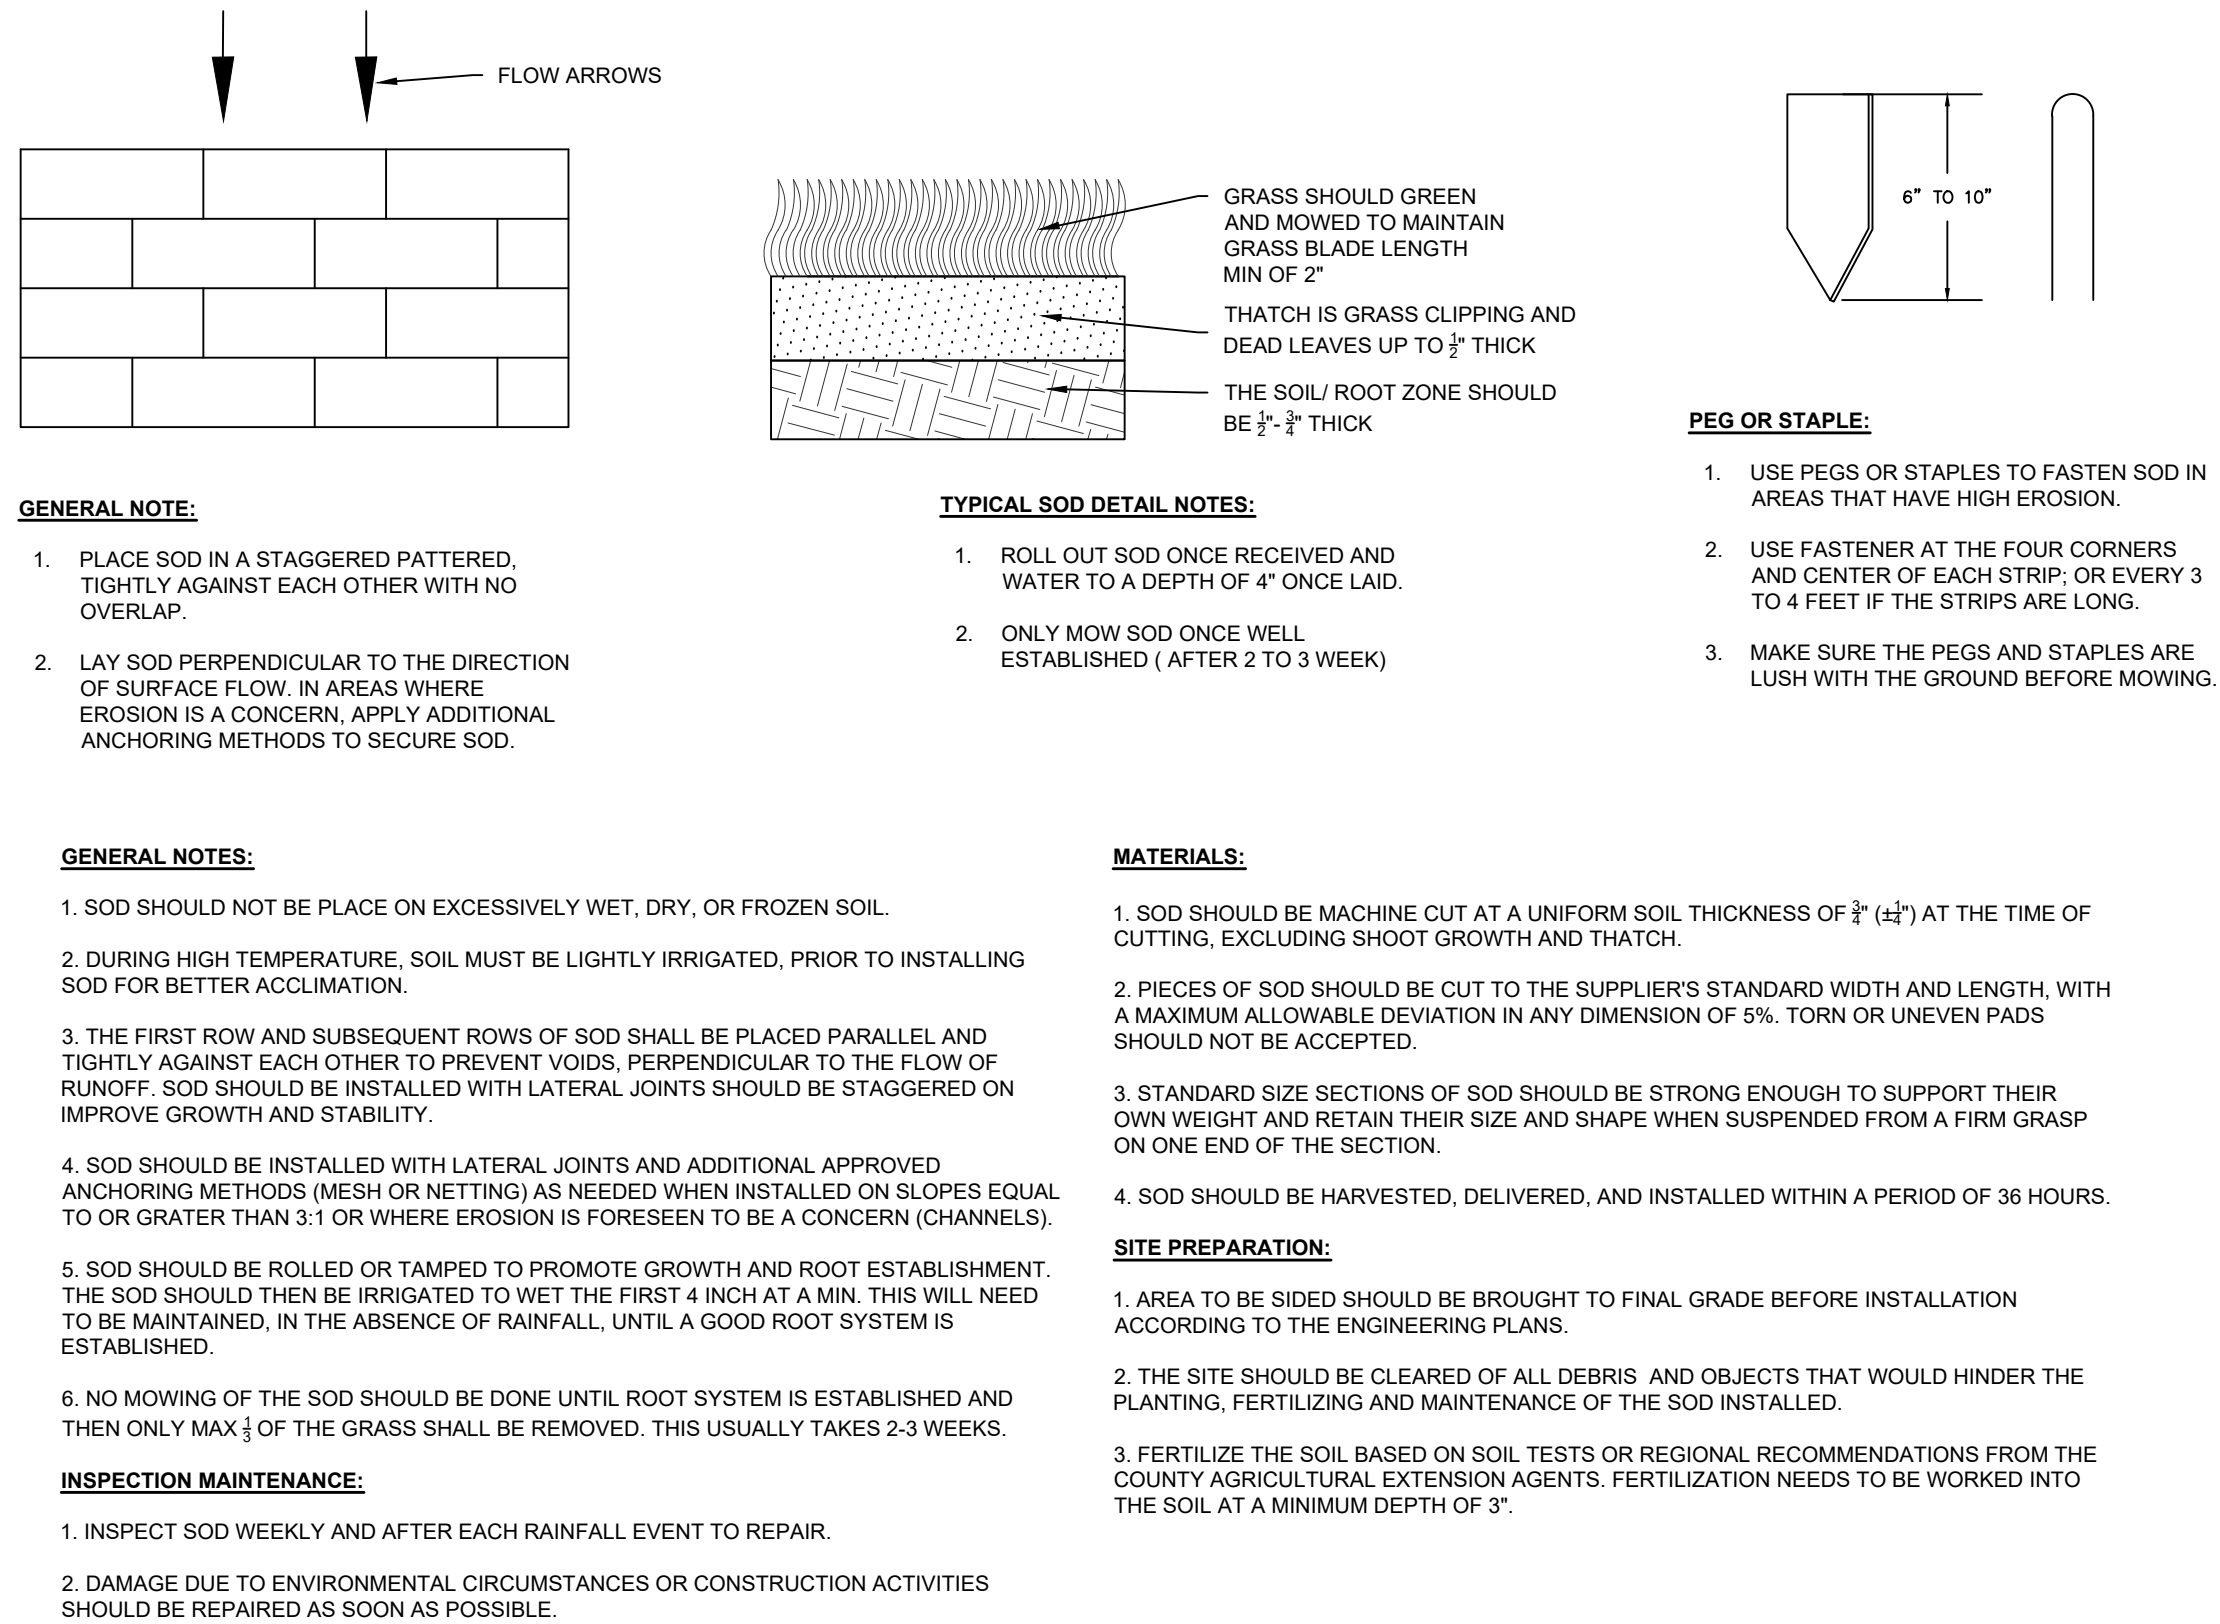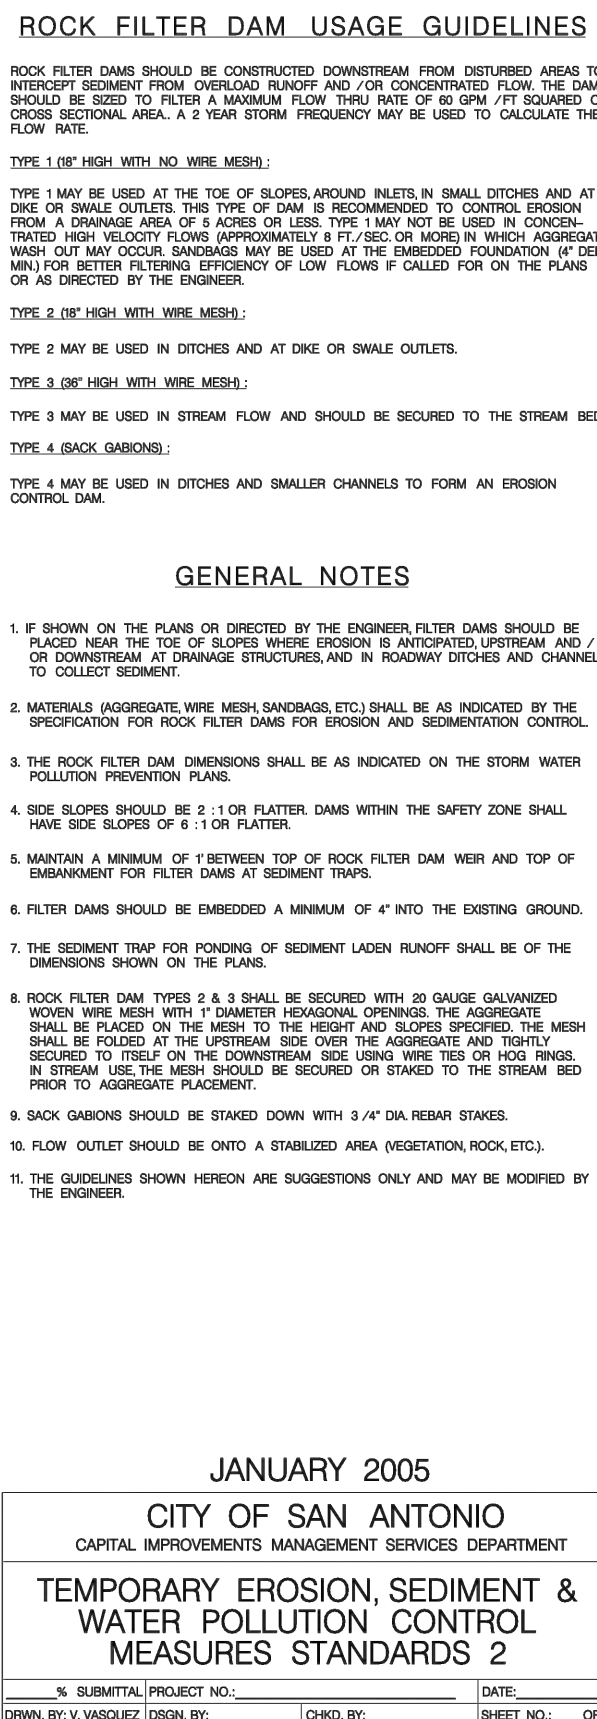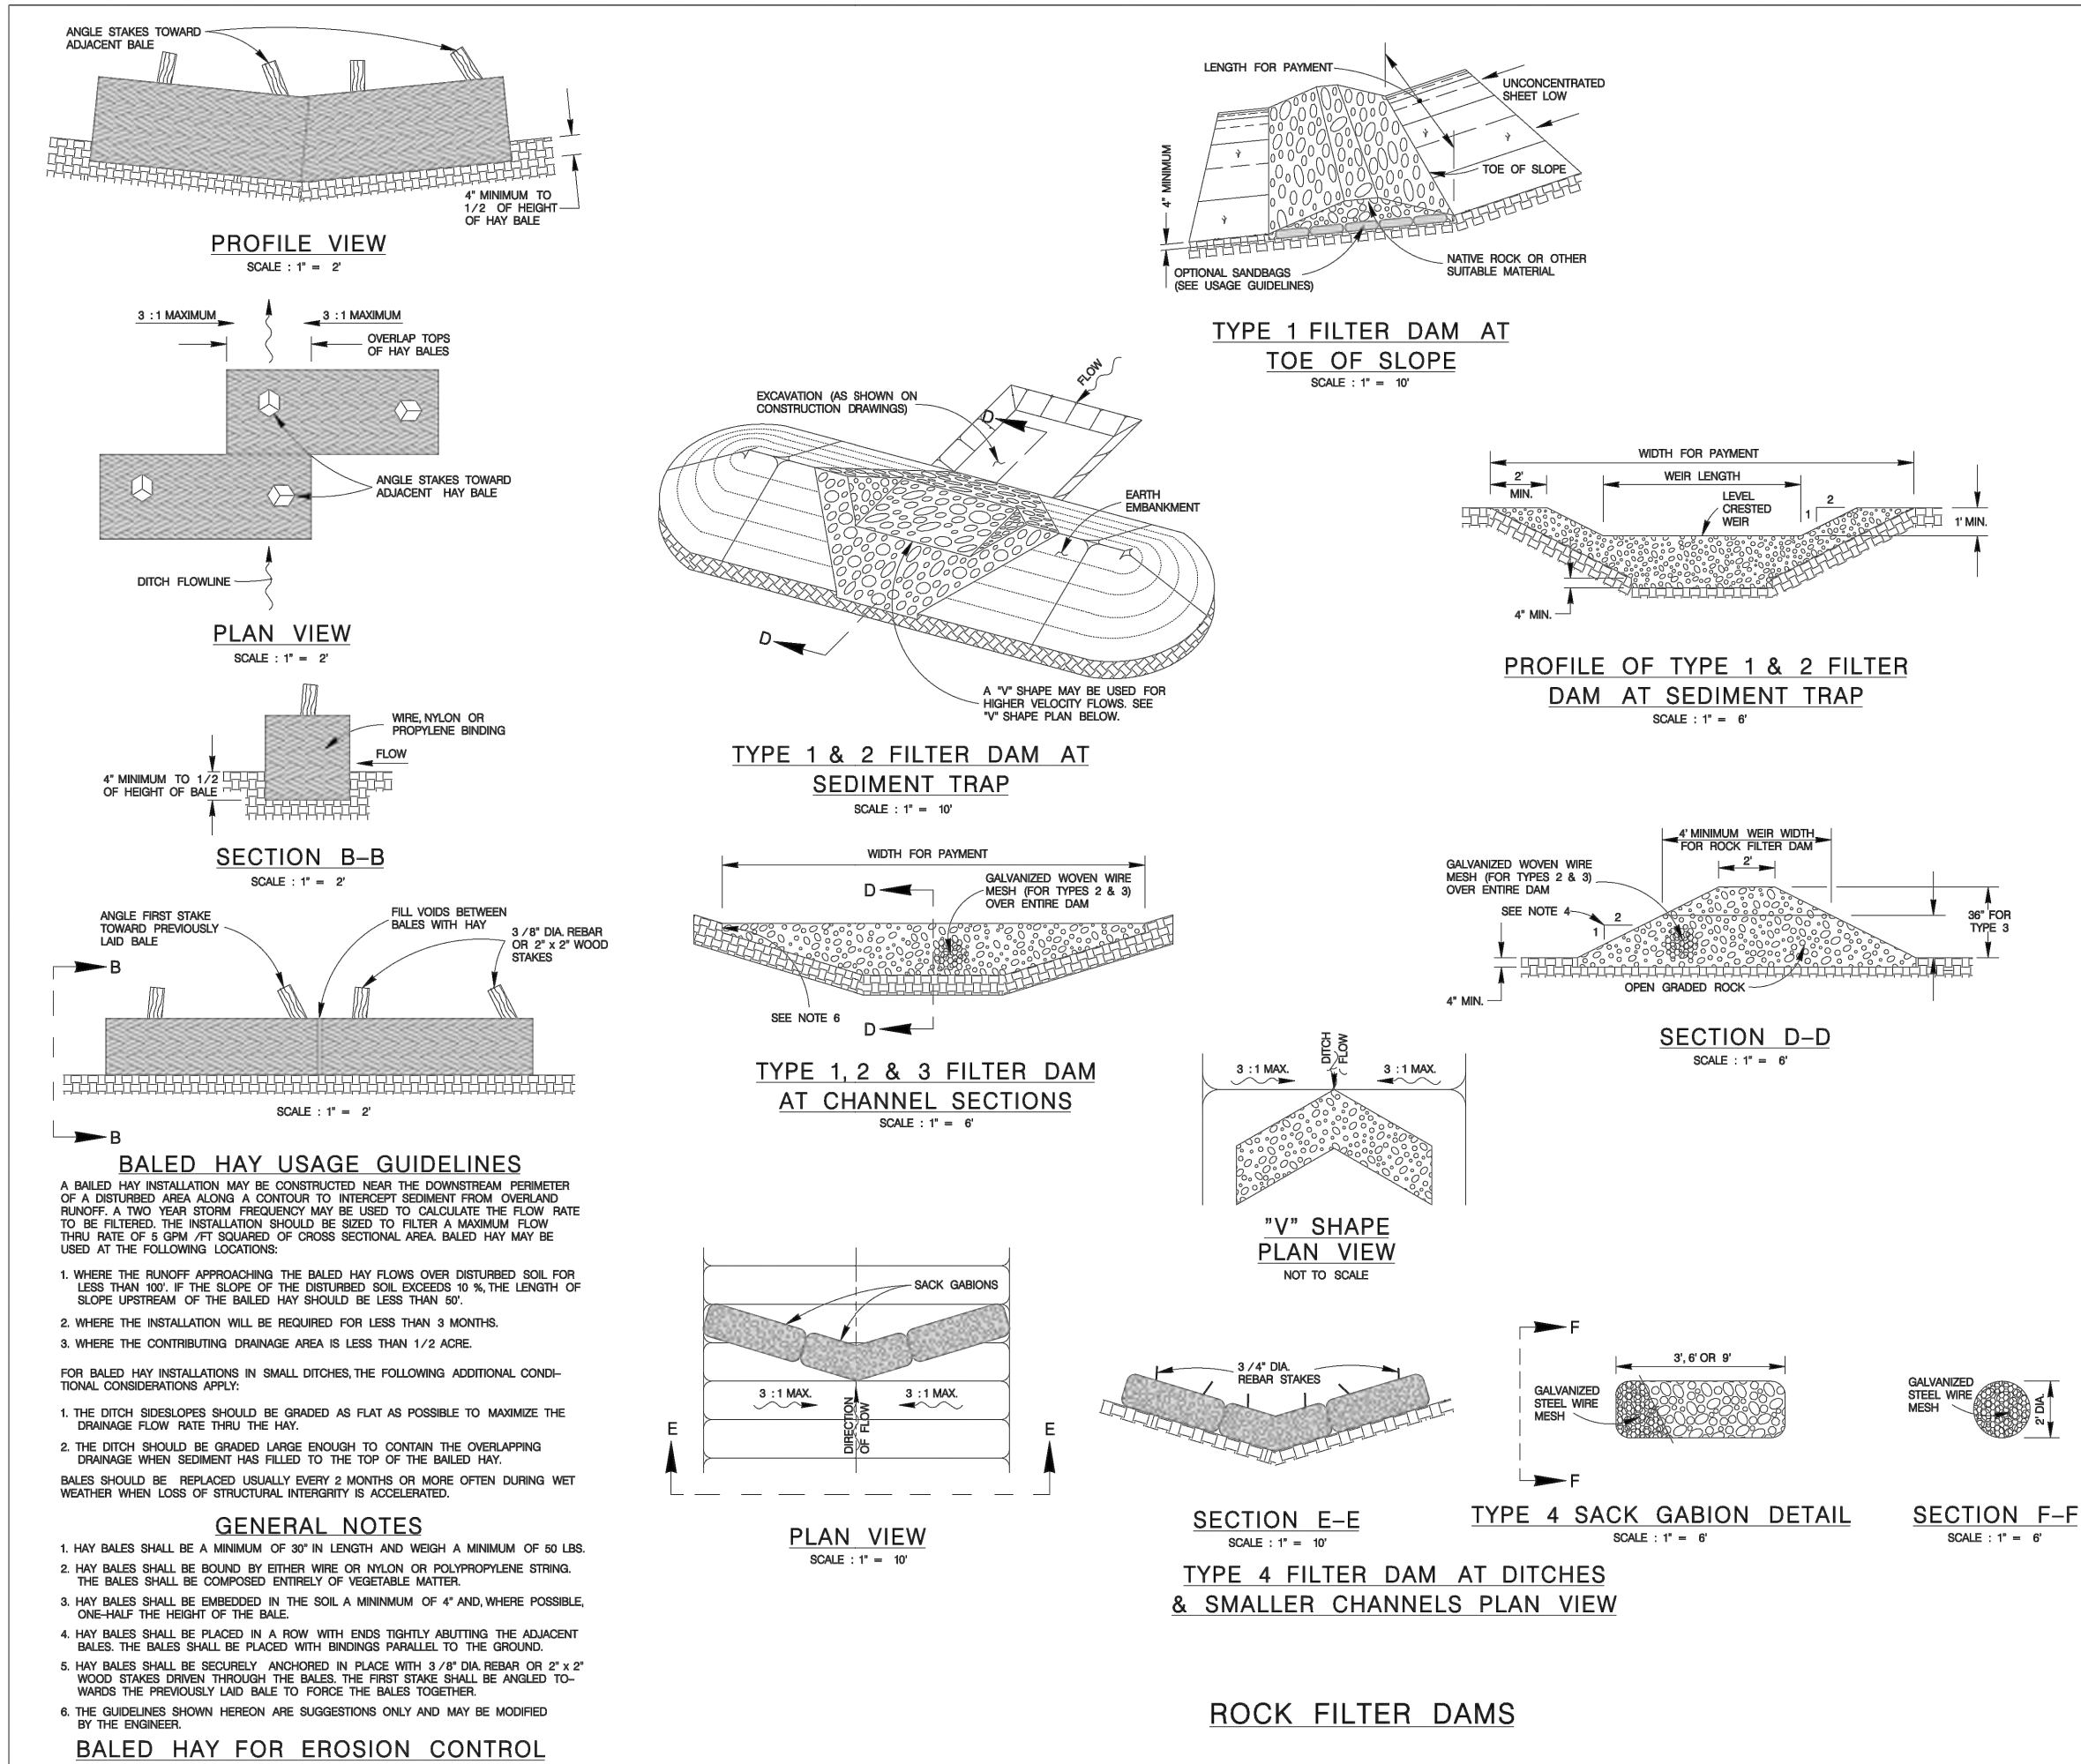

**REDBIRD RANCH UNIT 2M-2**  
SAN ANTONIO, TX  
**STORM WATER POLLUTION PREVENTION PLAN DETAILS**

DESIGNED BY: JWS  
DRAWN BY: SQV/JWS  
DATE: 3/20/2024  
JOB NO.: 05000-200  
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DESCRIPTION  
DATE  
REV  
3/20/2024  
Vance L. Weynand  
Professional Engineer  
No. 99269  
State of Texas