# ROSE VALLEY PHASE 1B

## SAN ANTONIO, TEXAS

# STREET, DRAINAGE, WATER, SANITARY SEWER, AND UTILITY IMPROVEMENTS

### GENERAL NOTES

- ALL CONSTRUCTION SHALL CONFORM TO THE CITY OF SAN ANTONIO STANDARD SPECIFICATIONS FOR CONSTRUCTION JUNE 2008, OR LATEST.
- NO EXTRA PAYMENT SHALL BE ALLOWED FOR WORK CALLED FOR ON THE PLANS. BUT NOT INCLUDED IN THE BID PROPOSAL. THIS INCIDENTAL WORK WILL BE REQUIRED AND SHALL BE INCLUDED IN THE PAY ITEM TO WHICH IT RELATES.
- THE CONTRACTOR SHALL PROVIDE ACCESS FOR THE DELIVERY OF MAIL BY THE U.S. POSTAL SERVICE. 4. THE CONTRACTOR SHALL BE RESPONSIBLE FOR RESTORING TO ITS ORIGINAL OR BETTER CONDITION ANY DAMAGE DONE TO EXISTING FENCES, CONCRETE ISLANDS, STREET PAVING, CURBS, SHRUBS, BUSHES OR DRIVEWAYS. (NO SEPARATE PAY ITEM).
- IT IS THE CONTRACTOR'S RESPONSIBILITY TO SEE THAT ALL SIGNS AND BARRICADES ARE UPON IN THE FIELD BY THE CONTRACTOR, USING THE "TEXAS MANUAL ON UNIFORM TRAFFIC INCORRECTLY PLACED OR ARE INSUFFICIENT IN QUANTITY TO PROTECT THE GENERAL PUBLIC. THE CONSTRUCTION INSPECTOR SHALL HAVE THE OPTION TO STOP OPERATIONS UNTIL SUCH TIME AS THE CONDITIONS ARE CORRECTED.
- IF THE NEED ARISES, ADDITIONAL BARRICADES AND DIRECTIONAL DEVICES MAY BE ORDERED BY THE TRAFFIC ENGINEERING REPRESENTATIVE AT THE CONTRACTOR'S EXPENSE.
- DUE TO FEDERAL REGULATIONS TITLE 49, PART 192.171 C.P.S. MUST MAINTAIN ACCESS TO GAS VALVES AT ALL TIMES. THE CONTRACTOR MUST PROTECT AND WORK AROUND ANY GAS VALVES THAT ARE IN THE PROJECT AREA.
- CONTRACTOR SHALL NOTIFY THE CITY INSPECTOR TWENTY FOUR (24) HOURS PRIOR TO BACKFILL OF ANY UTILITY TRENCHES TO SCHEDULE FOR DENSITY TEST AS REQUIRED.
- CONTRACTOR SHALL PRESERVE ALL CONSTRUCTION STAKES, MARKS, ETC. IF ANY ARE DESTROYED OR REMOVED BY THE CONTRACTOR OR HIS EMPLOYEES, THEY SHALL BE REPLACED AT THE CONTRACTOR'S EXPENSE.
- CONTRACTOR SHALL NOTIFY ALL UTILITY COMPANIES PRIOR TO CONSTRUCTION TO DETERMINE THE LOCATION OF EXISTING UTILITIES. CONTRACTOR SHALL NOTIFY THE FOLLOWING AT LEAST FORTY-EIGHT (48) HOURS PRIOR TO EXCAVATION OPERATION:

SAN ANTONIO WATER SYSTEM (SAW) BEXAR METROPOLITAN WATER DISTRICT (BEXAR MET) 354-6538 / 357-5741 COSA DRAINAGE 207-8048 207-7720 / 207-7765 COSA SIGNAL OPERATIONS 1-800-344-8377

TEXAS STATE WIDE ONE CALL LOCATOR CITY PUBLIC SERVICE ENERGY - TIME WARNER - AT&T - MCI


- 10. THE EXISTENCE AND LOCATION OF UNDERGROUND UTILITIES INDICATED ON THE PLANS ARE TAKEN FROM AVAILABLE RECORDS AND ARE NOT GUARANTEED, BUT SHALL BE INVESTIGATED AND VERIFIED BY THE CONTRACTOR BEFORE STARTING WORK, THE CONTRACTOR SHALL BE HELD RESPONSIBLE FOR ANY DAMAGE TO AND FOR THE MAINTENANCE AND PROTECTION OF THE EXISTING UTILITIES EVEN IF THEY ARE NOT SHOWN ON THE PLANS. LOCATION AND DEPTH OF EXISTING UTILITIES SHOWN HERE ARE APPROXIMATE ONLY. ACTUAL LOCATIONS AND DEPTHS MUST BE VERIFIED BY THE CONTRACTOR PRIOR TO CONSTRUCTION AND HE SHALL BE RESPONSIBLE FOR PROTECTION OF SAME DURING CONSTRUCTION.
- ALL WASTE MATERIAL SHALL BECOME PROPERTY OF THE CONTRACTOR AND SHALL BE HIS SOLE RESPONSIBILITY TO DISPOSE OF THIS MATERIAL OFF THE LIMITS OF THE PROJECT. NO WASTE MATE- RIAL SHALL BE PLACED IN EXISTING LOWS THAT WILL BLOCK OR ALTER FLOW LIMITS OF EXISTING ARTIFICIAL OR NATURAL DRAINAGE.
- 12. THE CONTRACTOR SHALL NOT PLACE ANY WASTE MATERIAL IN THE 100-YEAR FLOOD PLAIN WITHOUT FIRST OBTAINING AN APPROVED FLOOD PLAIN DEVELOPMENT PERMIT.
- 13. THE CONTRACTOR SHALL MAINTAIN ALL ADJOINING STREETS AND TRAVELED ROUTES FREE FROM SPILLED AND / OR TRACKED CONSTRUCTION MATERIALS AND / OR DEBRIS.
- 14. IF THE CONTRACTOR ENCOUNTERS ANY ARCHAEOLOGICAL DEPOSITS DURING CONSTRUCTION OPERATIONS, THE CONTRACTOR MUST STOP EXCAVATION IMMEDIATELY, CONTACT THE CITY INSPECTOR, AND CALL THE CITY HISTORIC PRESERVATION OFFICE AT 207-7306 OR 207-3327 FOR AN ARCHAEOLOGICAL INVESTIGATION. THE CONTRACTOR CANNOT BEGIN EXCAVATION AGAIN WITHOUT WRITTEN PERMISSION FROM THE CITY. IF MORE THAN THREE (3) DAYS ARE REQUIRED FOR INVESTIGATION (NOT INCLUDING HOLIDAY AND WEEKENDS) AND IF THE CONTRACTOR IS UNABLE TO WORK IN OTHER AREAS, THEN THE CONTRACTOR WILL BE ALLOWED TO NEGOTIATE FOR ADDITIONAL CONSTRUCTION TIME UPON WRITTEN REQUEST WITHIN TEN (10) DAYS AFTER THE FIRST NOTICE TO THE CITY OF ARCHAEOLOGICAL INVESTIGATION FOR EACH EVENT. IF THE TIME REQUIRED FOR INVESTIGATION IS LESS THAN OR EQUAL TO THREE (3) DAYS FOR EACH EVENT, CONTRACT DURATION WILL NOT BE EXTENDED.
- IF SUSPECTED CONTAMINATION IS ENCOUNTERED DURING CONSTRUCTION OPERATIONS, C.O.S.A. SHALL BE NOTIFIED IMMEDIATELY WHEN CONTAMINATED SOILS AND / OR GROUNDWATER ARE ENCOUNTERED AT LOCATIONS NOT IDENTIFIED IN THE PLANS. THE NOTIFICATION SHOULD INCLUDE THE STATION NUMBER, TYPE OF CONTAMINATED MEDIA, EVIDENCE OF CONTAMINATION AND MEASURES TAKEN TO CONTAIN THE CONTAMINATED MEDIA AND PREVENT PUBLIC ACCESS. THE CONTAMINATED SOIL AND / OR GROUNDWATER SHALL NOT BE REMOVED FROM THE LOCATION WITHOUT PRIOR C.O.S.A. APPROVAL. THE CONTRACTOR MUST STOP THE EXCAVATION IMMEDIATELY AND CONTACT THE C.O.S.A. INSPECTOR. THE CONTRACTOR CANNOT BEGIN EXCAVATION ACTIVITIES WITHOUT WRITTEN PERMISSION FROM
- CONTRACTOR IS TO INCLUDE A MAILBOX POST BLOCKOUT FOR VACANT LOTS AND ALL RESIDENCES WHICH DO NOT HAVE MAILBOXES AT THE CURB. BLOCKOUTS ARE PROVIDED FOR FUTURE USE BY THE POST OFFICE.
- CONTRACTOR SHALL NOT REMOVE OR ADJUST ANY VIA FACILITIES. THE CONTRACTOR MUST CONTACT VIA FOURTEEN DAYS PRIOR, FOR THE REMOVAL OF BENCHES, STOP POLES OR ANY OTHER VIA FACILITIES THAT MAY BE PRESENT. PLEASE PROVIDE THIRTY DAYS PRIOR NOTICE FOR SHELTER REMOVAL (TELEPHONE NOS: (210) 362-2155 OR (210) 362-2096). THE CONTRACT-OR WILL BE LIABLE FOR ANY DAMAGES TO VIA FACILITIES NOT REMOVED BY VIA. THE CON-TRACTOR IS REQUIRED TO REPLACE ALL FLATWORK REMOVED OR DAMAGED IN THE COURSE OF EXECUTING THE CONTRACT UNLESS OTHERWISE NOTED BY VIA. THE CONTRACTOR WILL BE RESPONSIBLE FOR PROTECTING VIA FACILITIES IF ADJACENT TO WORK AREA.

### TREE PROTECTION AND PRESERVATION GENERAL NOTE

- NO UTILITY OR STREET EXCAVATION WORK SHALL BEGIN IN AREAS WHERE TREE PRESERVATION AND TREATMENT MEASURES HAVE NOT BEEN COMPLETED AND
- TREE PROTECTION FENCING SHALL BE REQUIRED. TREE PROTECTION FENCING SITE CONSTRUCTION, DURING CONSTRUCTION ACTIVITY, AT LEAST A SIX-INCH LAYER OF COARSE MULCH SHALL BE PLACED AND MAINTAINED OVER THE ROO
- DIAMETER WHEN EXCAVATING NEAR EXISTING TREES, EXCAVATION IN THE VICINITY OF TREES SHALL PROCEED WITH CAUTION. THE CONTRACTOR SHALL CONTACT THE
- ROOTS WILL BE CUT WITH A ROCK SAW OR BY HAND, NOT BY AN EXCAVATOR OR OTHER ROAD CONSTRUCTION FOUIPMENT.
- ALL CURB AND SIDEWALK WORK SHALL USE ALTERNATIVE CONSTRUCTION METHODS TO MINIMIZE EXTENSIVE ROOT DAMAGE TO TREES (REFER TO DETAILS)
- EXPOSED ROOTS SHALL BE COVERED AT THE END OF THE DAY USING TECHNIQUES SUCH AS COVERING WITH SOIL, MULCH, OR WET BURLAP.
- NO EQUIPMENT. VEHICLES OR MATERIALS SHALL OPERATE OR BE STORED WITHIN THE TREE. ROOTS OR BRANCHES IN CONFLICT WITH THE CONSTRUCTION SHALL BE CUT CLEANLY ACCORDING TO PROPER PRUNING METHODS. OAK WOUNDS SHALL BE PAINTED OVER WITHIN 30 MINUTES TO PREVENT OAK WILT.
- SAPLINGS, SHRUBS OR BUSHES TO BE CLEARED FROM THE PROTECTED ROOT
- 9. NO WIRES, NAILS OR OTHER MATERIAL MAY BE ATTACHED TO PROTECTED TREES.
- 10. TREES, TREE LIMBS, BUSHES AND SHRUBS LOCATED IN THE CITY STREET OR ALLEY RIGHT-OF-WAY OR PERMANENT EASEMENTS WHICH INTERFERE WITH PROPOSED CONSTRUCTION ACTIVITIES SHALL BE PROPERLY PRUNED FOLLOWING THE ANSI A-300 STANDARDS FOR PRUNING. ALL TREE PRUNING SHALL BE COMPLETED BY A CITY OF SAN ANTONIO TREE MAINTENANCE LICENSED CONTRACTOR (ARTICLE 21-171, CITY CODE) ONLY AFTER APPROVAL FROM THE CAPITAL PROJECTS MANAGEMENT THROUGH THE INSPECTOR.
- 11. NO EXCESSIVE TREE TRIMMING WILL BE PERMITTED.
- 12. ALL DEBRIS GENERATED BY THE PRUNING AND TRIMMING OF THE TREES AND / OR BUSHES SHALL BECOME THE PROPERTY OF THE CONTRACTOR AND SHALL BE DISPOSED OF PROPERLY (NO SEPARATE PAY ITEM).
- 13. TREES MUST BE MAINTAINED IN GOOD HEALTH THROUGHOUT THE CONSTRUCTION PROCESS. MAINTENANCE MAY INCLUDE, BUT NOT LIMITED TO: WATERING THE ROOT PROTECTION ZONE, WASHING FOLIAGE, FERTILIZATION, PRUNING, ADDITIONAL MULCH APPLICATIONS AND OTHER MAINTENANCE AS NEEDED ON THE
- 14. ANY TREE REMOVAL SHALL BE APPROVED BY THE CITY ARBORIST. (207-0278).
- 15. TREES WHICH ARE DAMAGED OR LOST DUE TO THE CONTRACTOR'S NEGLIGENCE DURING CONSTRUCTION SHALL BE MITIGATED TO THE CITY'S SATISFACTION.
- 16. TREE PLANTING FOR MITIGATION OR ENHANCEMENT: ALL PLANTED TREES SHALL BE MAINTAINED IN A HEALTHY CONDITION AT ALL TIMES. THIS INCLUDES IRRIGATION, FERTILIZING, PRUNING AND OTHER MAINTENANCE AS NEEDED ON THE PROJECT. TREES THAT DIE WITHIN TWELVE (12) MONTHS SHALL BE REPLACED WITH

### ACCESSIBILITY REQUIREMENTS

- THE CONTRACTOR SHALL PROVIDE AND MAINTAIN VEHICULAR AND PEDESTRIAN ACCESS AT ALL TIMES TO
- WHEN THE WORK REQUIRES THE EXCAVATION OF THE STREET AND THE REMOVAL OF THE EXISTING DRIVEWAY APPROACHES AND SIDEWALKS. THE CONTRACTOR SHALL BE RESPONSIBLE FOR PROVIDING TEMPORARY ALL-WEATHER ACCESS TO THE BUSINESSES AND RESIDENCES. THE TEMPORARY DRIVEWAY APPROACHES SHALL BE CONSTRUCTED WITH FLEXIBLE BASE OR GRAVEL MATERIAL AT NO SEPARATE COST TO THE CITY.
- PRIOR TO INITIATING THE CONSTRUCTION OF NEW DRIVEWAY APPROACHES, THE CONTRACTOR SHALL GIVE ADVANCE WARNING IN PERSON, OR IN WRITING, OF AT LEAST 48 HOURS TO EACH RESIDENCE THAT WILL BE IMMEDIATELY AFFECTED, SO THAT ALTERNATE PLANS MAY BE MADE BY THE RESIDENTS.
- FOR BUSINESSES WITH MORE THAN ONE DRIVEWAY. AT LEAST ONE DRIVEWAY SHALL REMAIN OPEN WHILE THE OTHER NEW DRIVEWAY APPROACHES ARE CONSTRUCTED. FOR BUSINESSES WITH ONLY ONE DRIVEWAY, THE NEW DRIVEWAY APPROACH SHALL BE CONSTRUCTED IN HALF WIDTHS, UNLESS A TEMPORARY ASPHALT DRIVEWAY IS FIRST INSTALLED AT NO SEPARATE COST TO THE CITY.

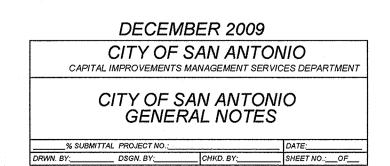




OWNER/DEVELOPER: LENNAR HOMES 1922 DRY CREEK WAY, SUITE 101 SAN ANTONIO, TEXAS 78259 PHONE: (210) 403-6282


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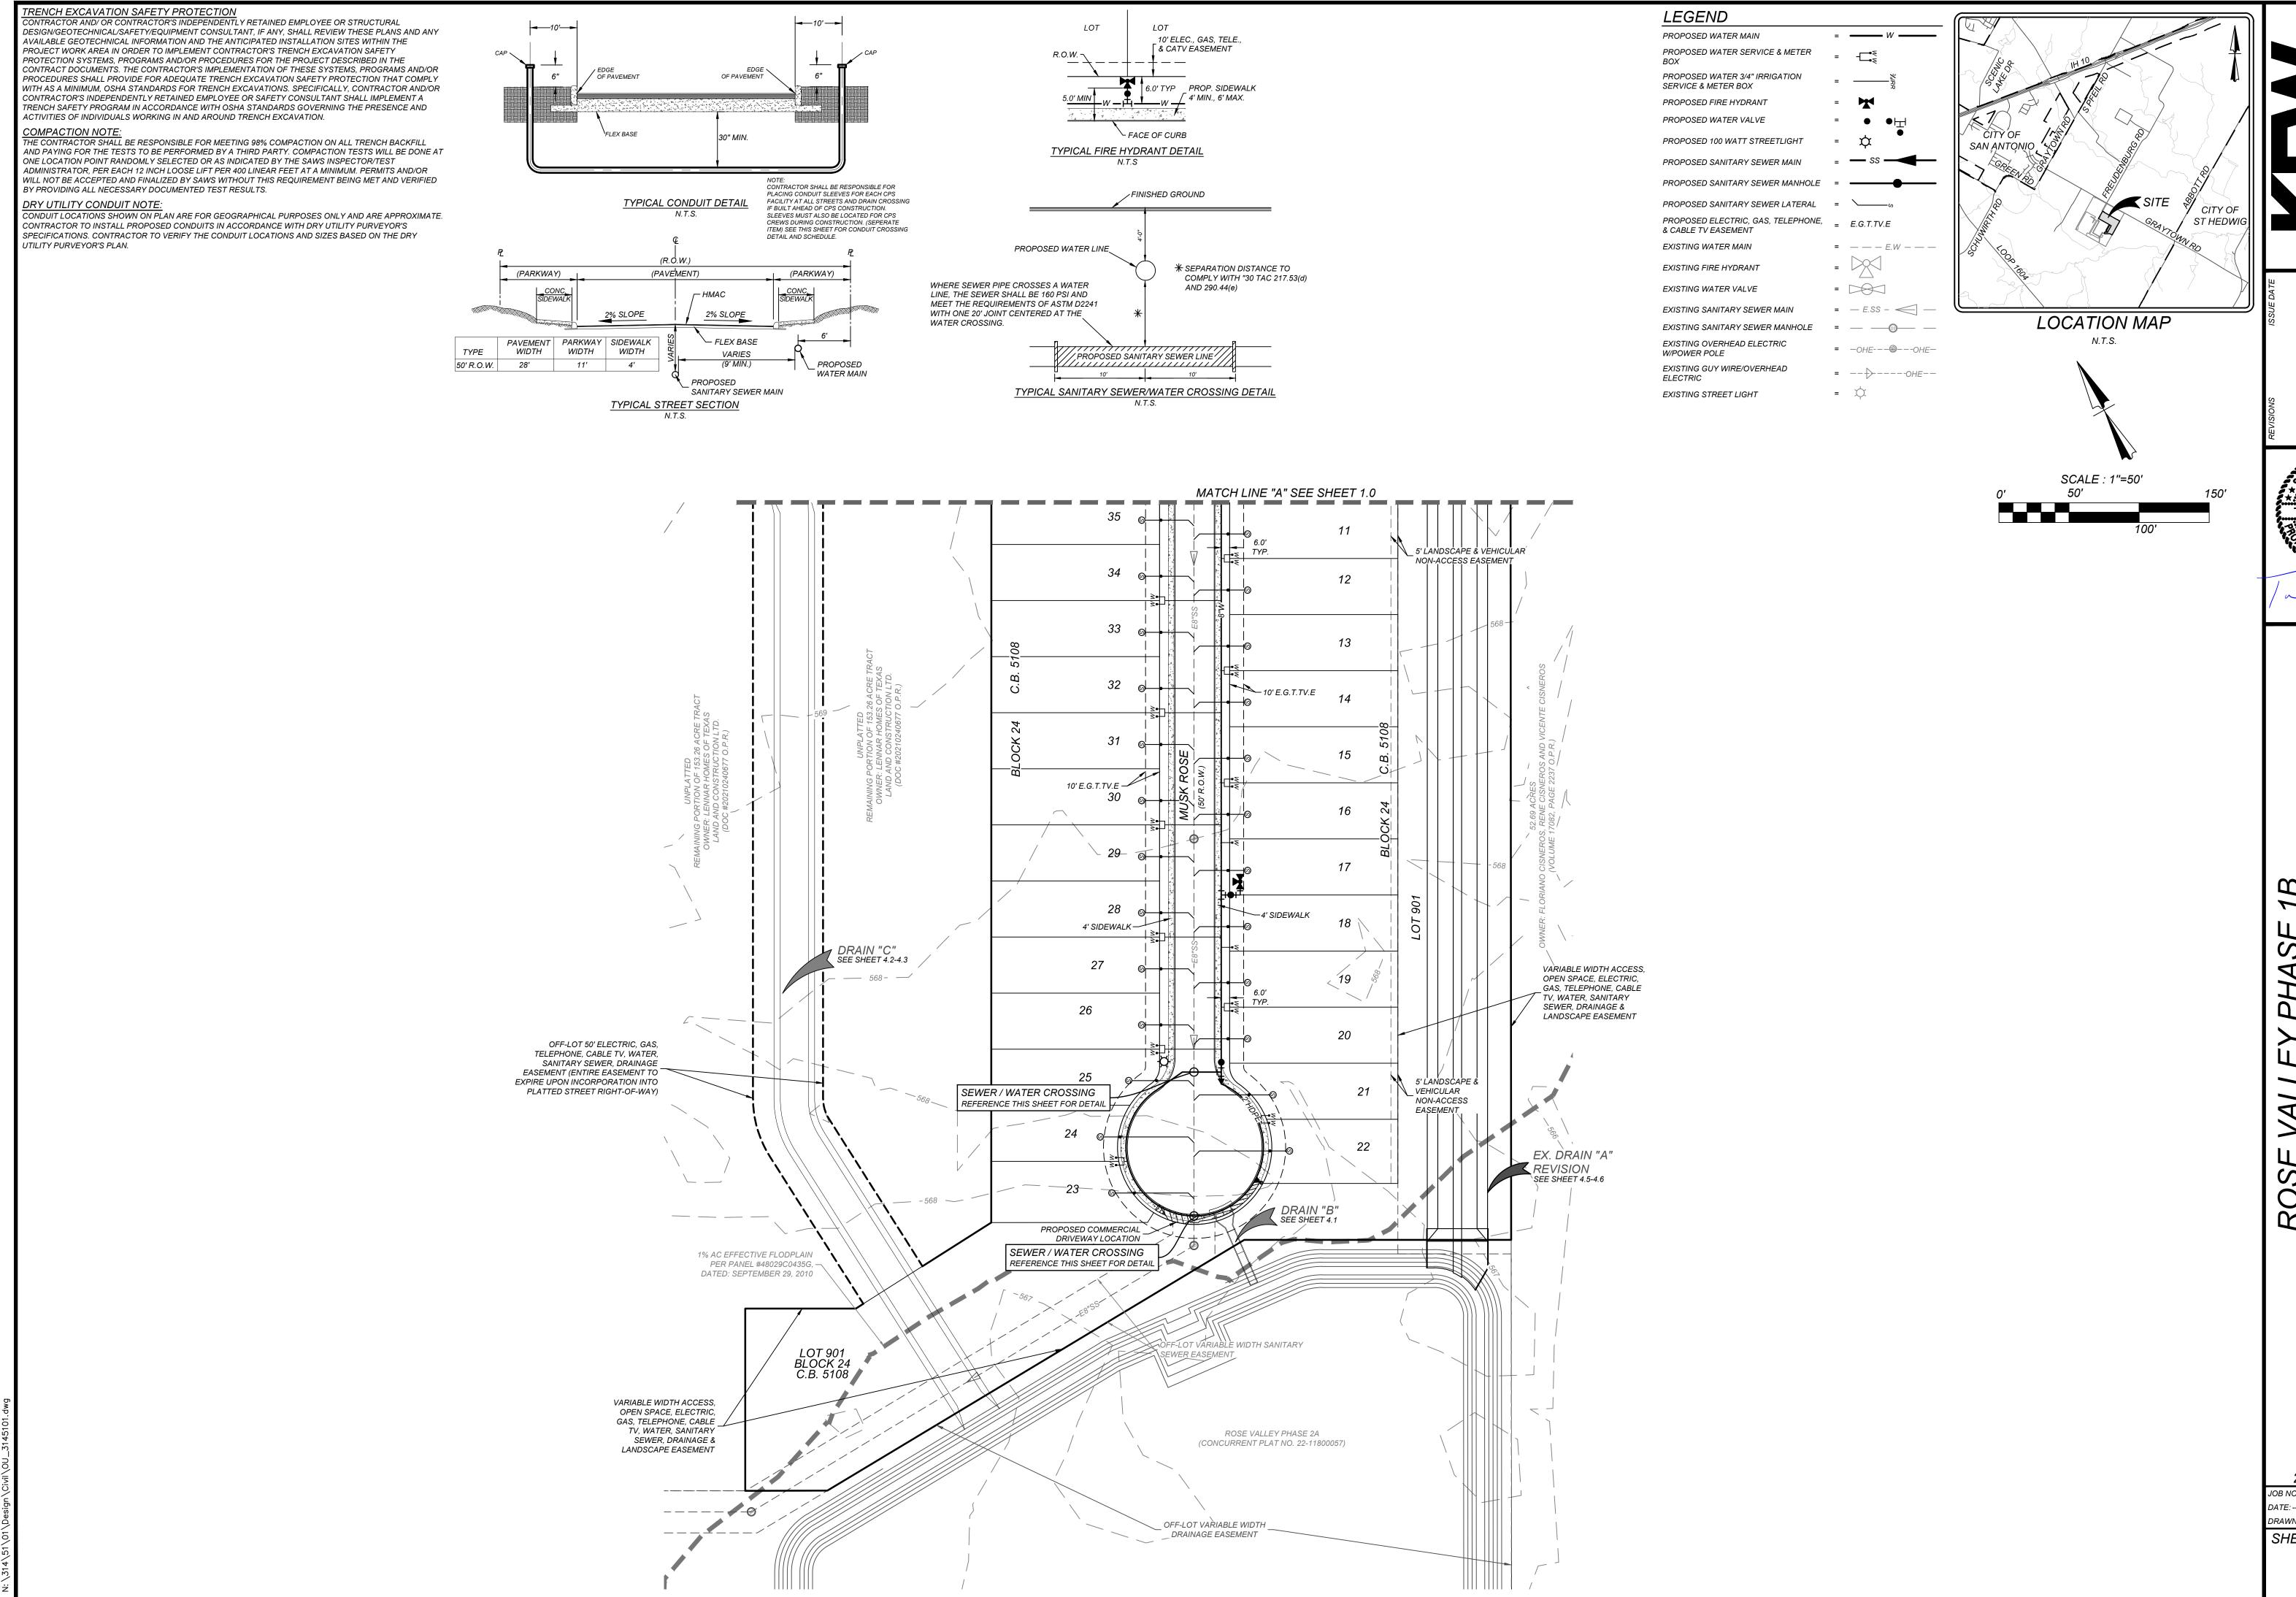
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OVERALL UTILITY PLAN (2 OF 2)	1.1
MASTER DRAINAGE PLAN	2.0
OVERALL GRADING PLAN	3.0
OVERALL GRADING PLAN	3.1
DRAIN "A" PLAN & PROFILE	4.0
DRAIN "B" PLAN & PROFILE	4.1
DRAIN "C" PLAN & PROFILE (1 OF 2)	4.2
DRAIN "C" PLAN & PROFILE (2 OF 2)	4.3
DRAIN "D" PLAN & PROFILE	4.4
EX. DRAIN "A" REVISION PLAN & PROFILE (1 OF 2)	4.5
EX. DRAIN "A" REVISION PLAN & PROFILE (2 OF 2)	4.6
EX. DRAIN "A" REVISION DETAILS	4.7
PIPE BEDDING AND CONCRETE WINGWALLS	4.8
MISCELLANEOUS BOX CULVERT DETAILS AND CONCRETE	10
COLLAR DETAILS	4.9
STREET PLAN AND PROFILE	5.0
STREET PLAN AND PROFILE	5.1
STREET PLAN AND PROFILE	5.2
STREET PLAN AND PROFILE	5.3
STREET PLAN AND PROFILE	5.4
STREET PLAN AND PROFILE	5.5
STREET DETAIL SHEET	5.6
WHEELCHAIR RAMP DETAIL SHEET	5.7
MISCELLANEOUS DETAL SHEET (1 OF 2)	5.8
MISCELLANEOUS DETAL SHEET (2 OF 2)	5.9
TRAFFIC SIGNAGE & SIDEWALK PLAN (1 OF 2)	5.10
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TRAFFIC SIGNAGE DETAILS	5.12
TRAFFIC SIGNAGE NOTES & DETAIL SHEET	5.13
SANITARY SEWER COVER SHEET	6.0
SANITARY SEWER GENERAL NOTES	6.1
SANITARY SEWER GENERAL NOTES	6.2
OVERALL SANITARY SEWER PLAN (1 OF 2)	6.3
OVERALL SANITARY SEWER PLAN (2 OF 2)	6.4
SEWER LINE "H" STA 1+00.00 - 8+00.00	6.5
SEWER LINE "H" STA 8+00.00 - END	6.6
SEWER LINE "J" STA 1+00.00 - 7+50.00	6.7
SEWER LINE "J" STA 7+50.00 - END	6.8
SEWER LINE "J1" STA 1+00.00 - END	6.9
SEWER EX. LINE "A" STA 13+50.00 - 24+50.00	6.10
SANITARY SEWER DETAIL SHEET	6.11
WATER IMPROVEMENT COVER SHEET	7.0
OVERALL WATER PLAN (1 OF 2)	7.1
OVERALL WATER PLAN (2 OF 2)	7.2
WATER IMPROVEMENT DETAIL SHEET	7.3
STORM WATER POLLUTION PREVENTION PLAN	8.0
STORM WATER POLLUTION PREVENTION PLAN	8.1
STORM WATER POLLUTION PREVENTION PLAN DETAILS	8.2



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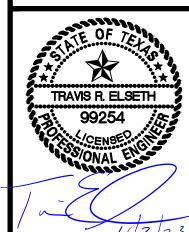




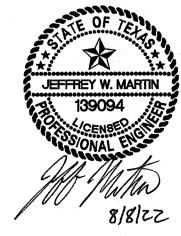
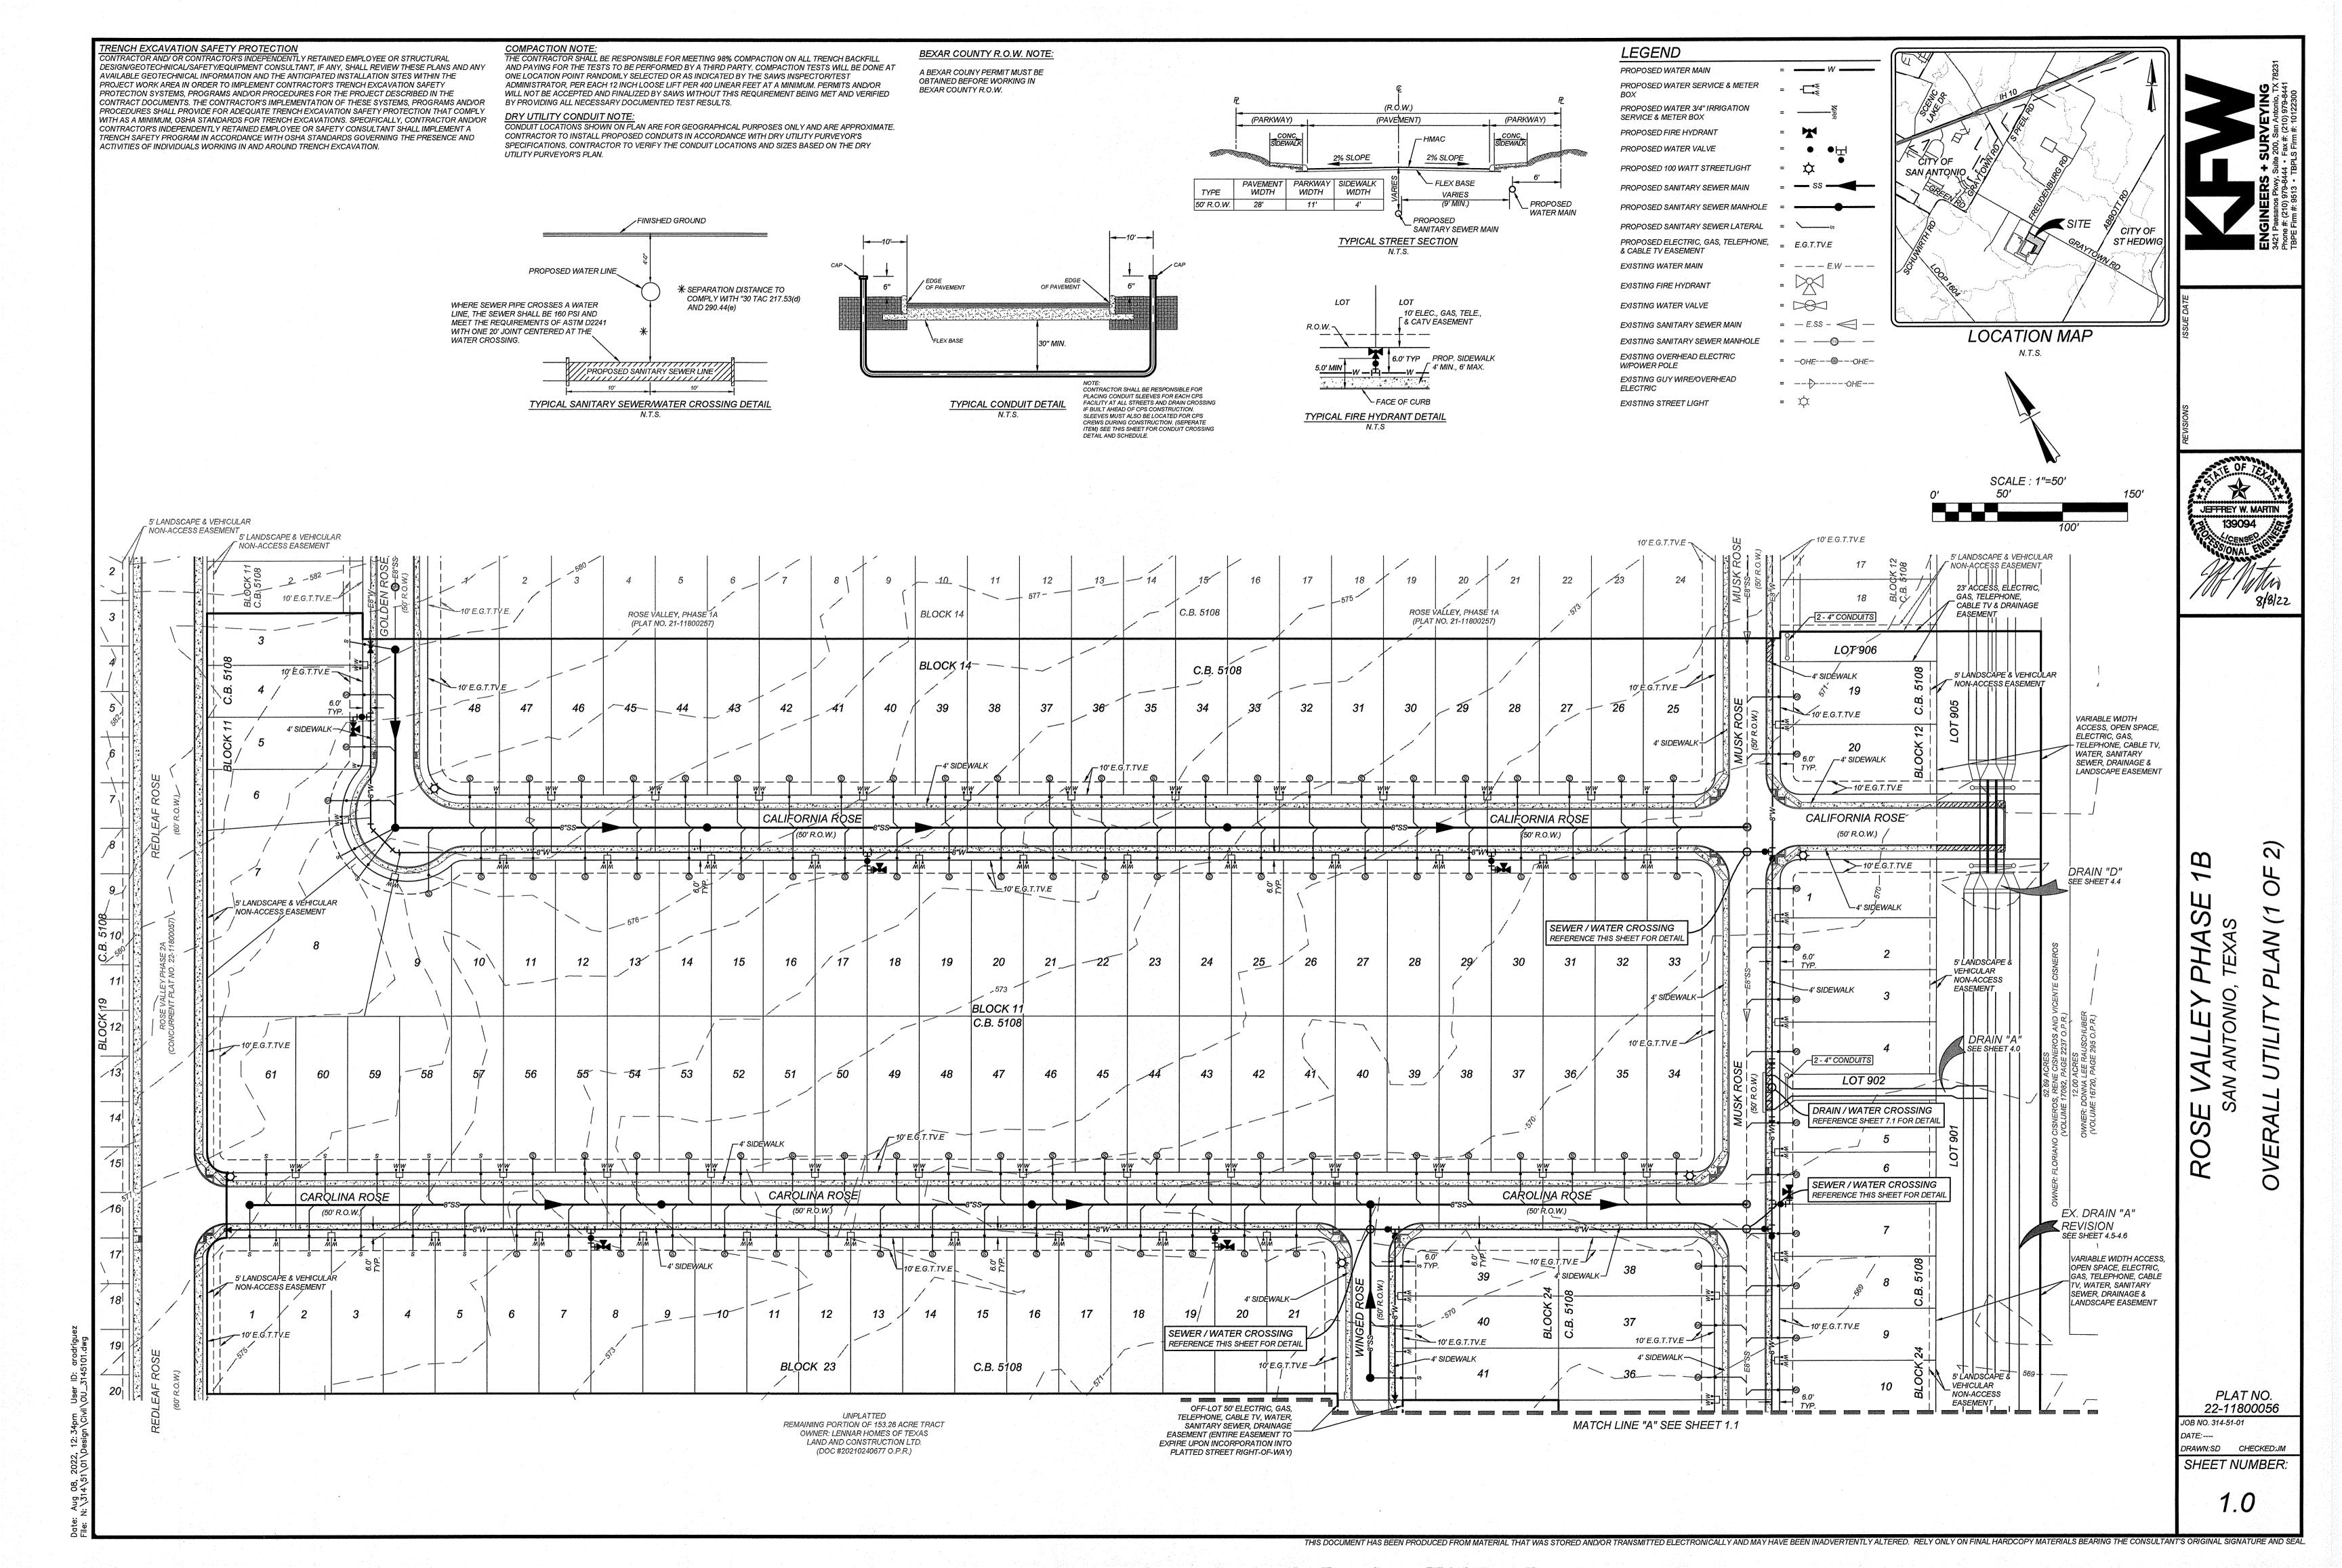
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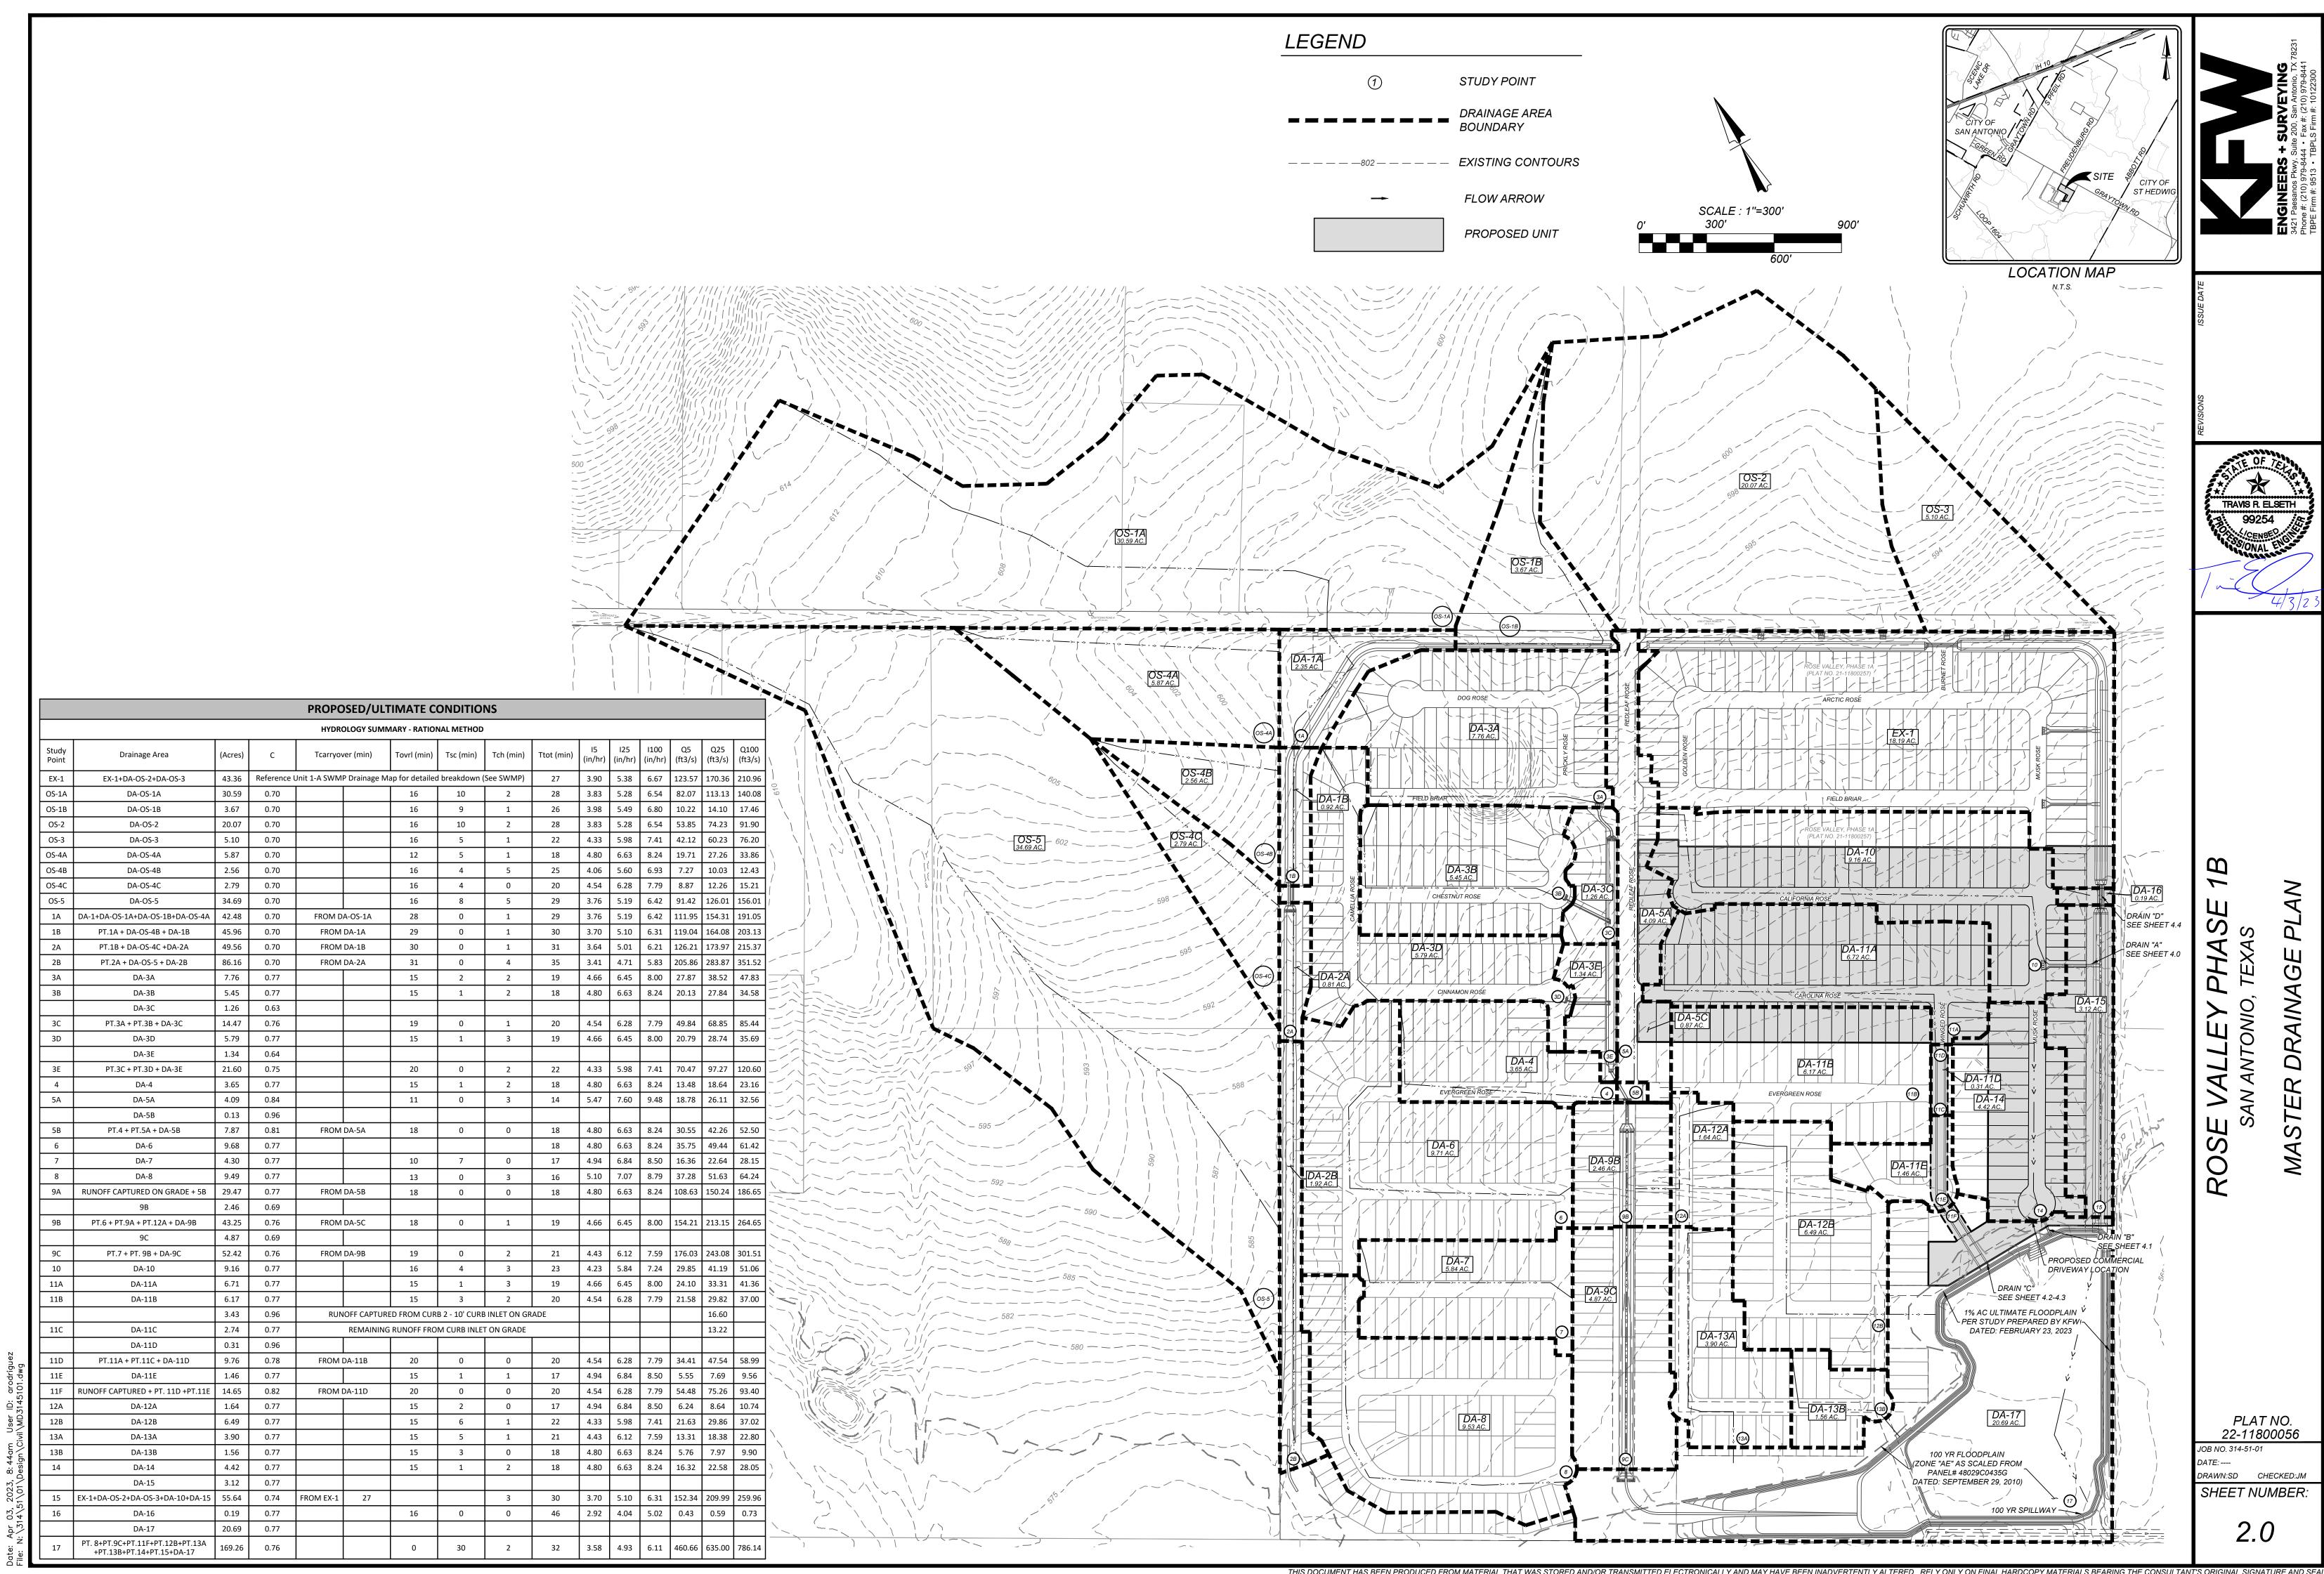
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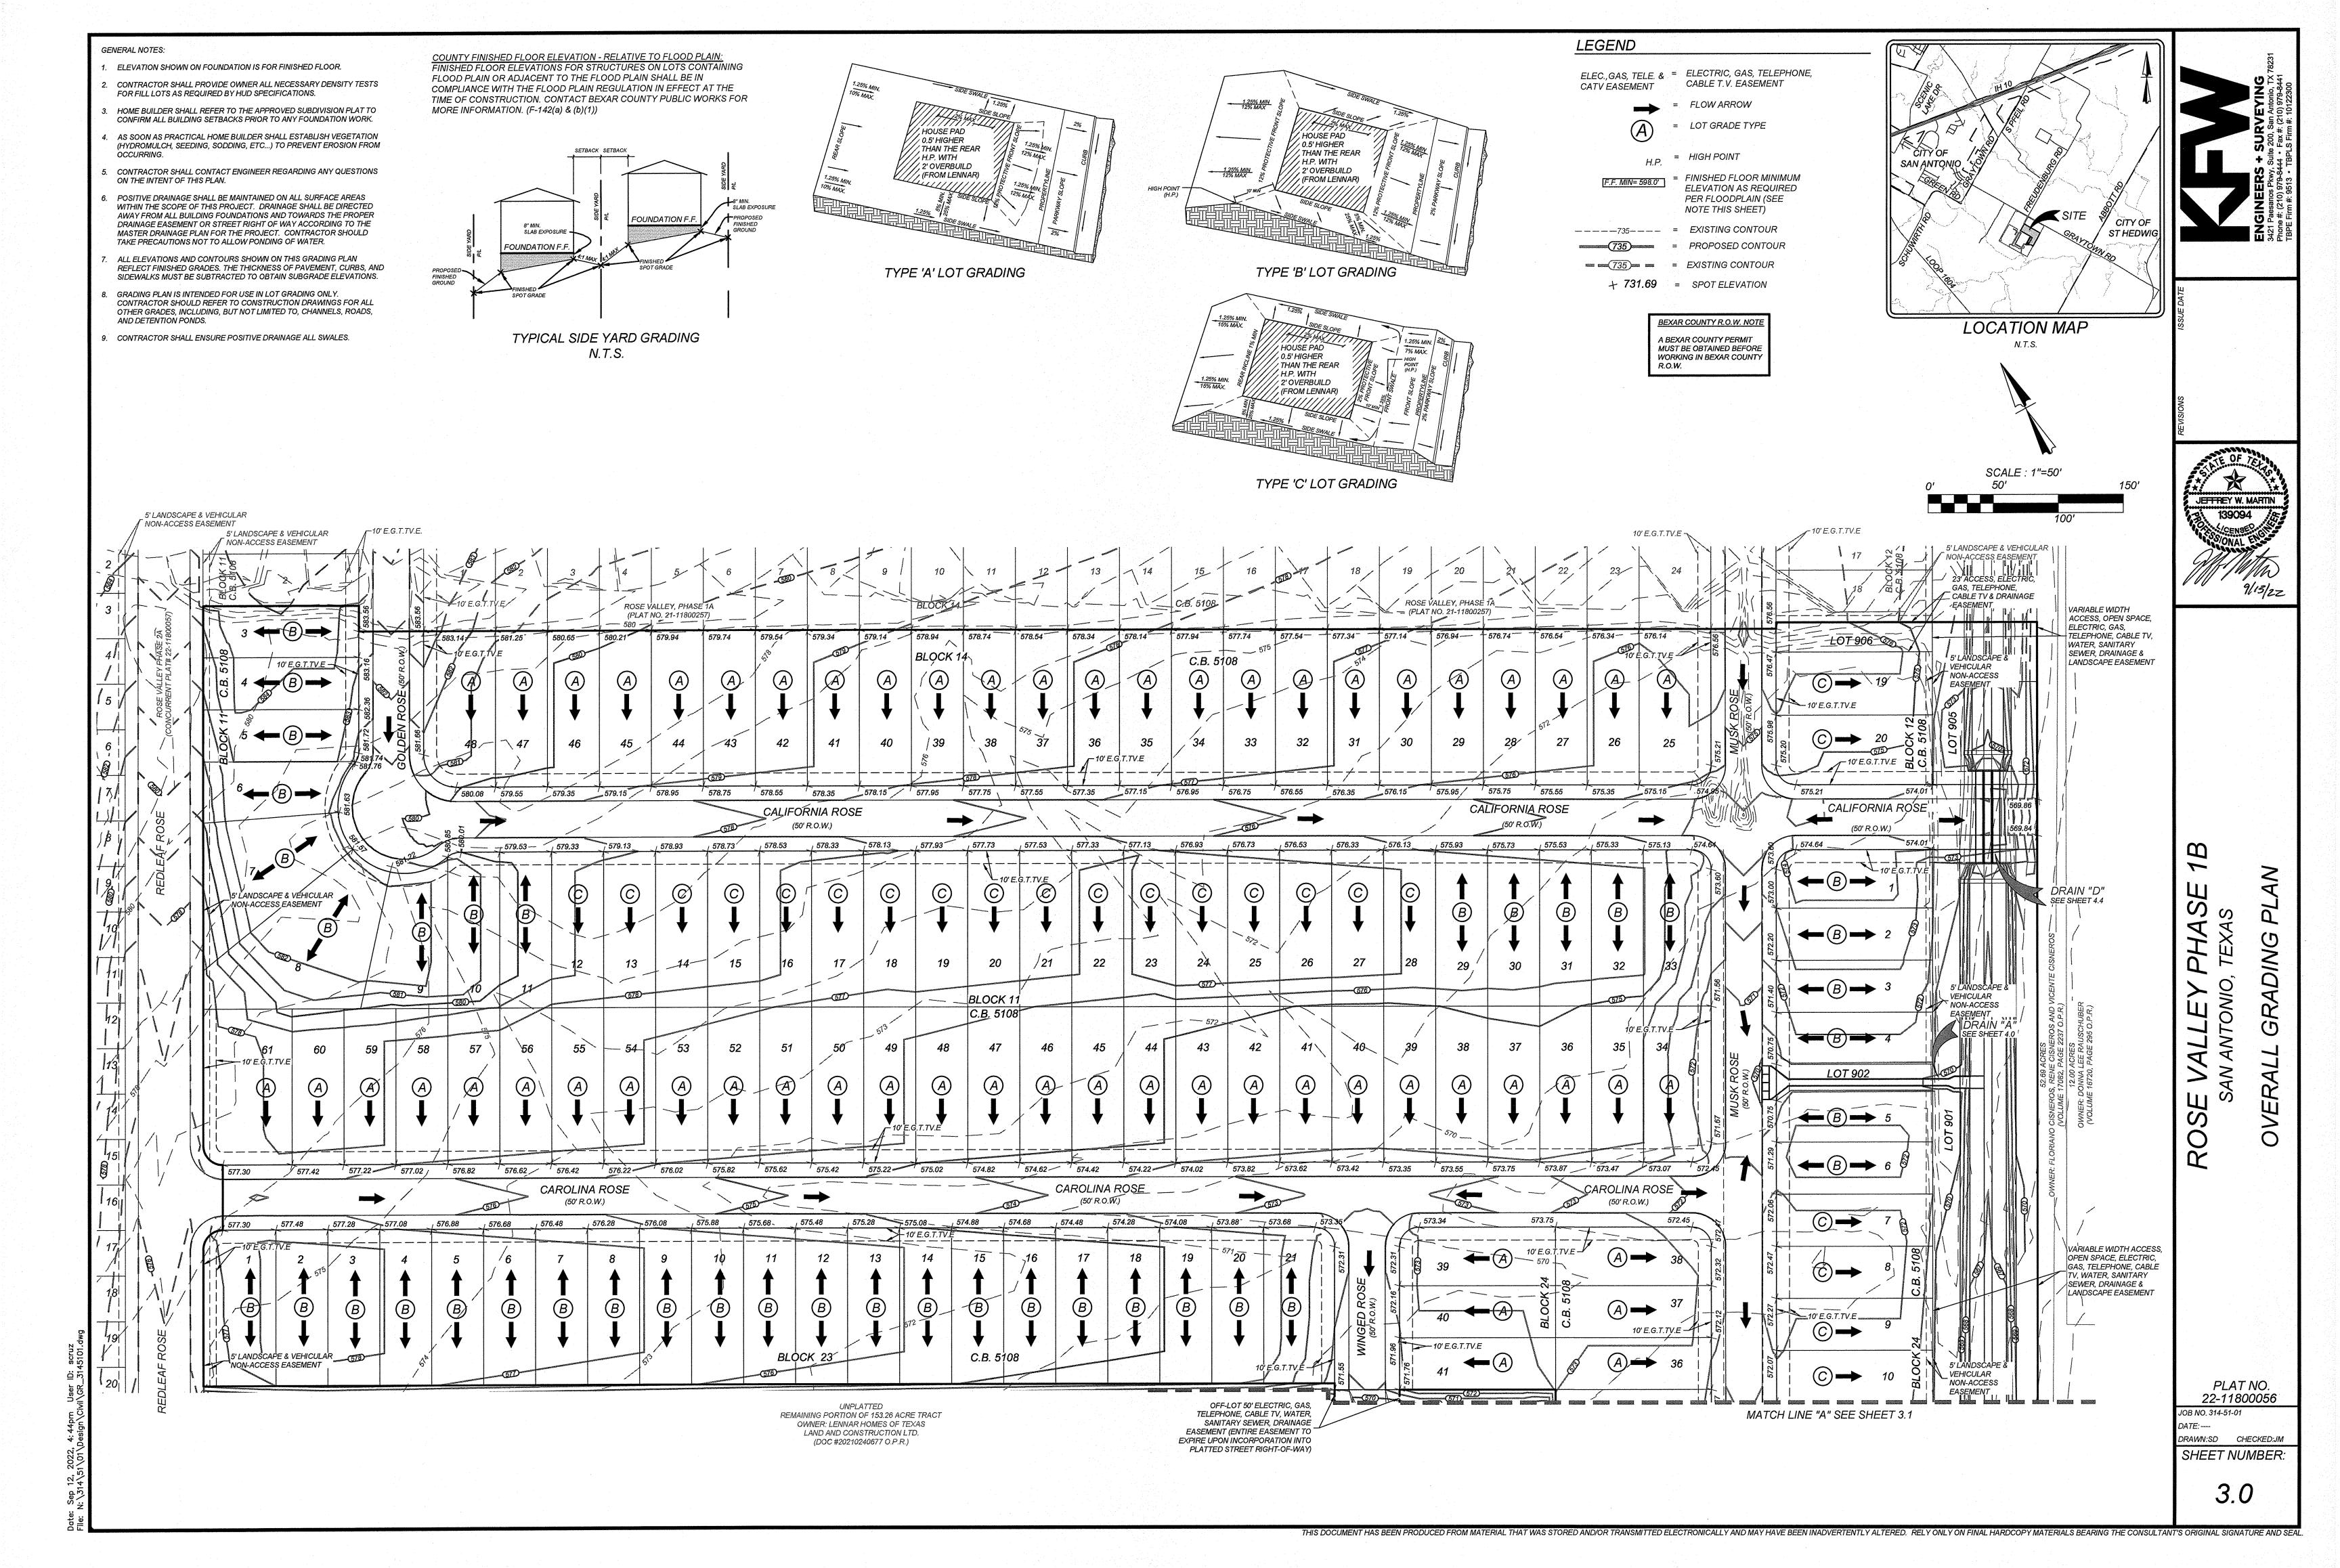
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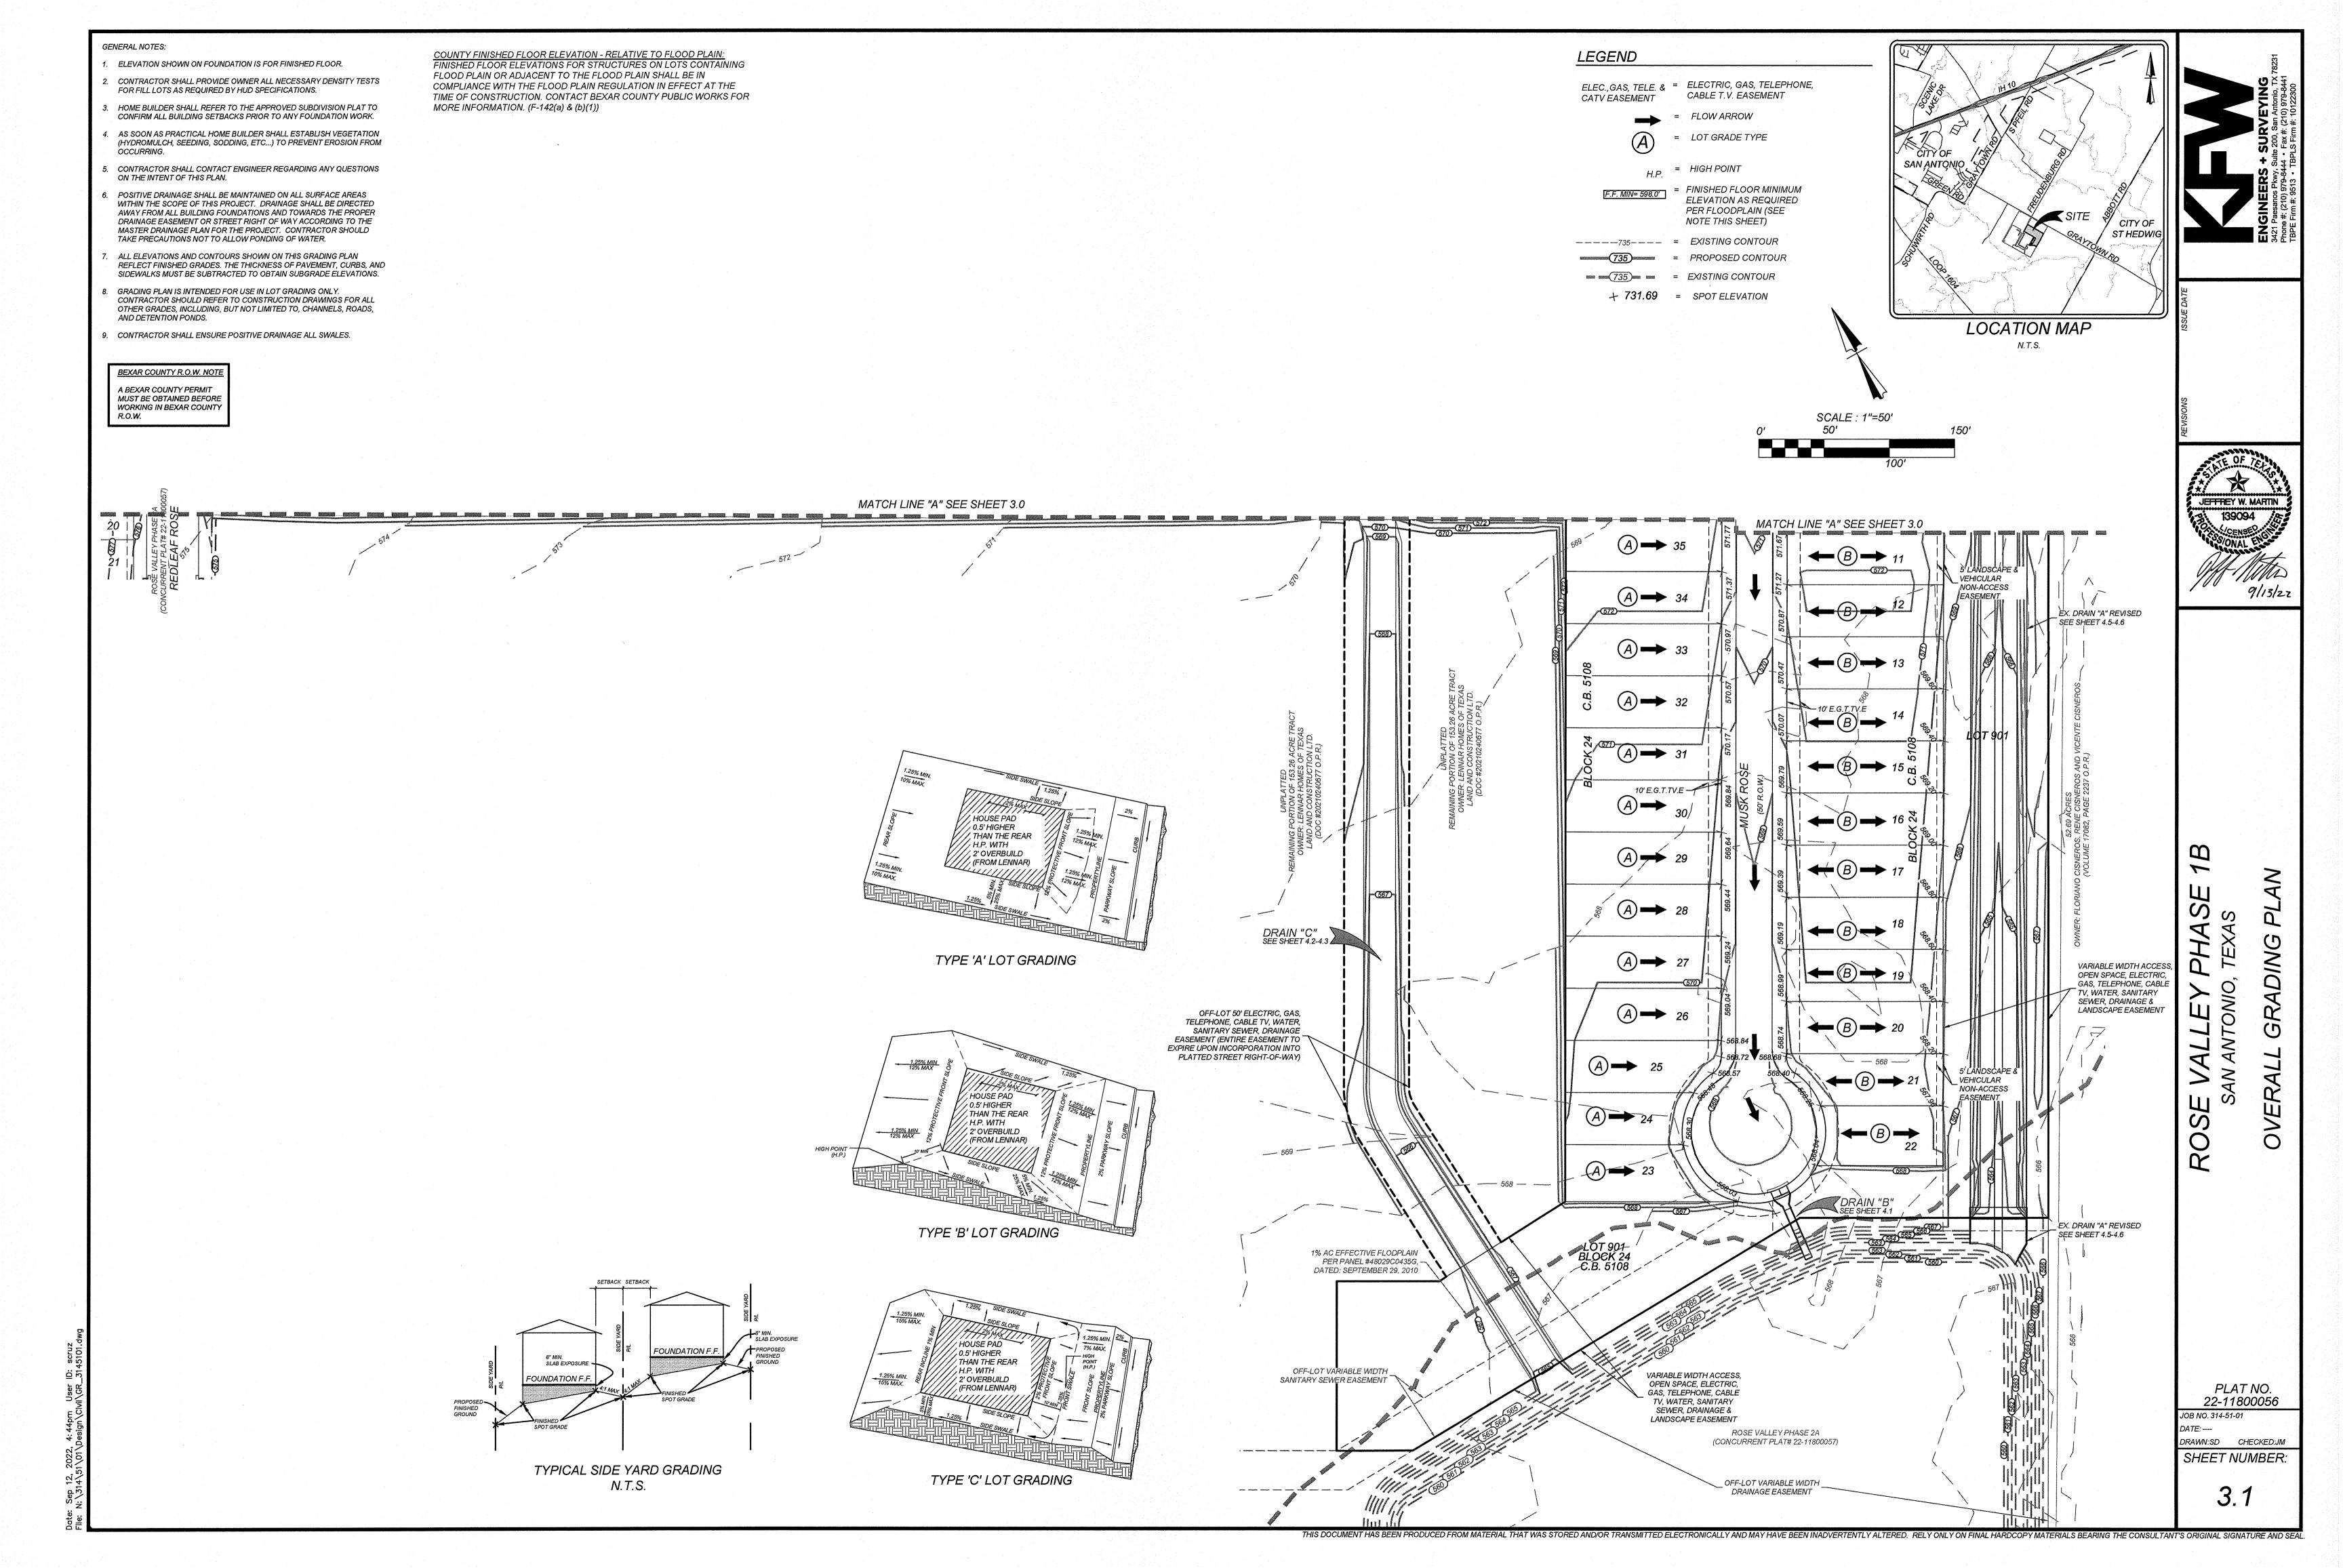
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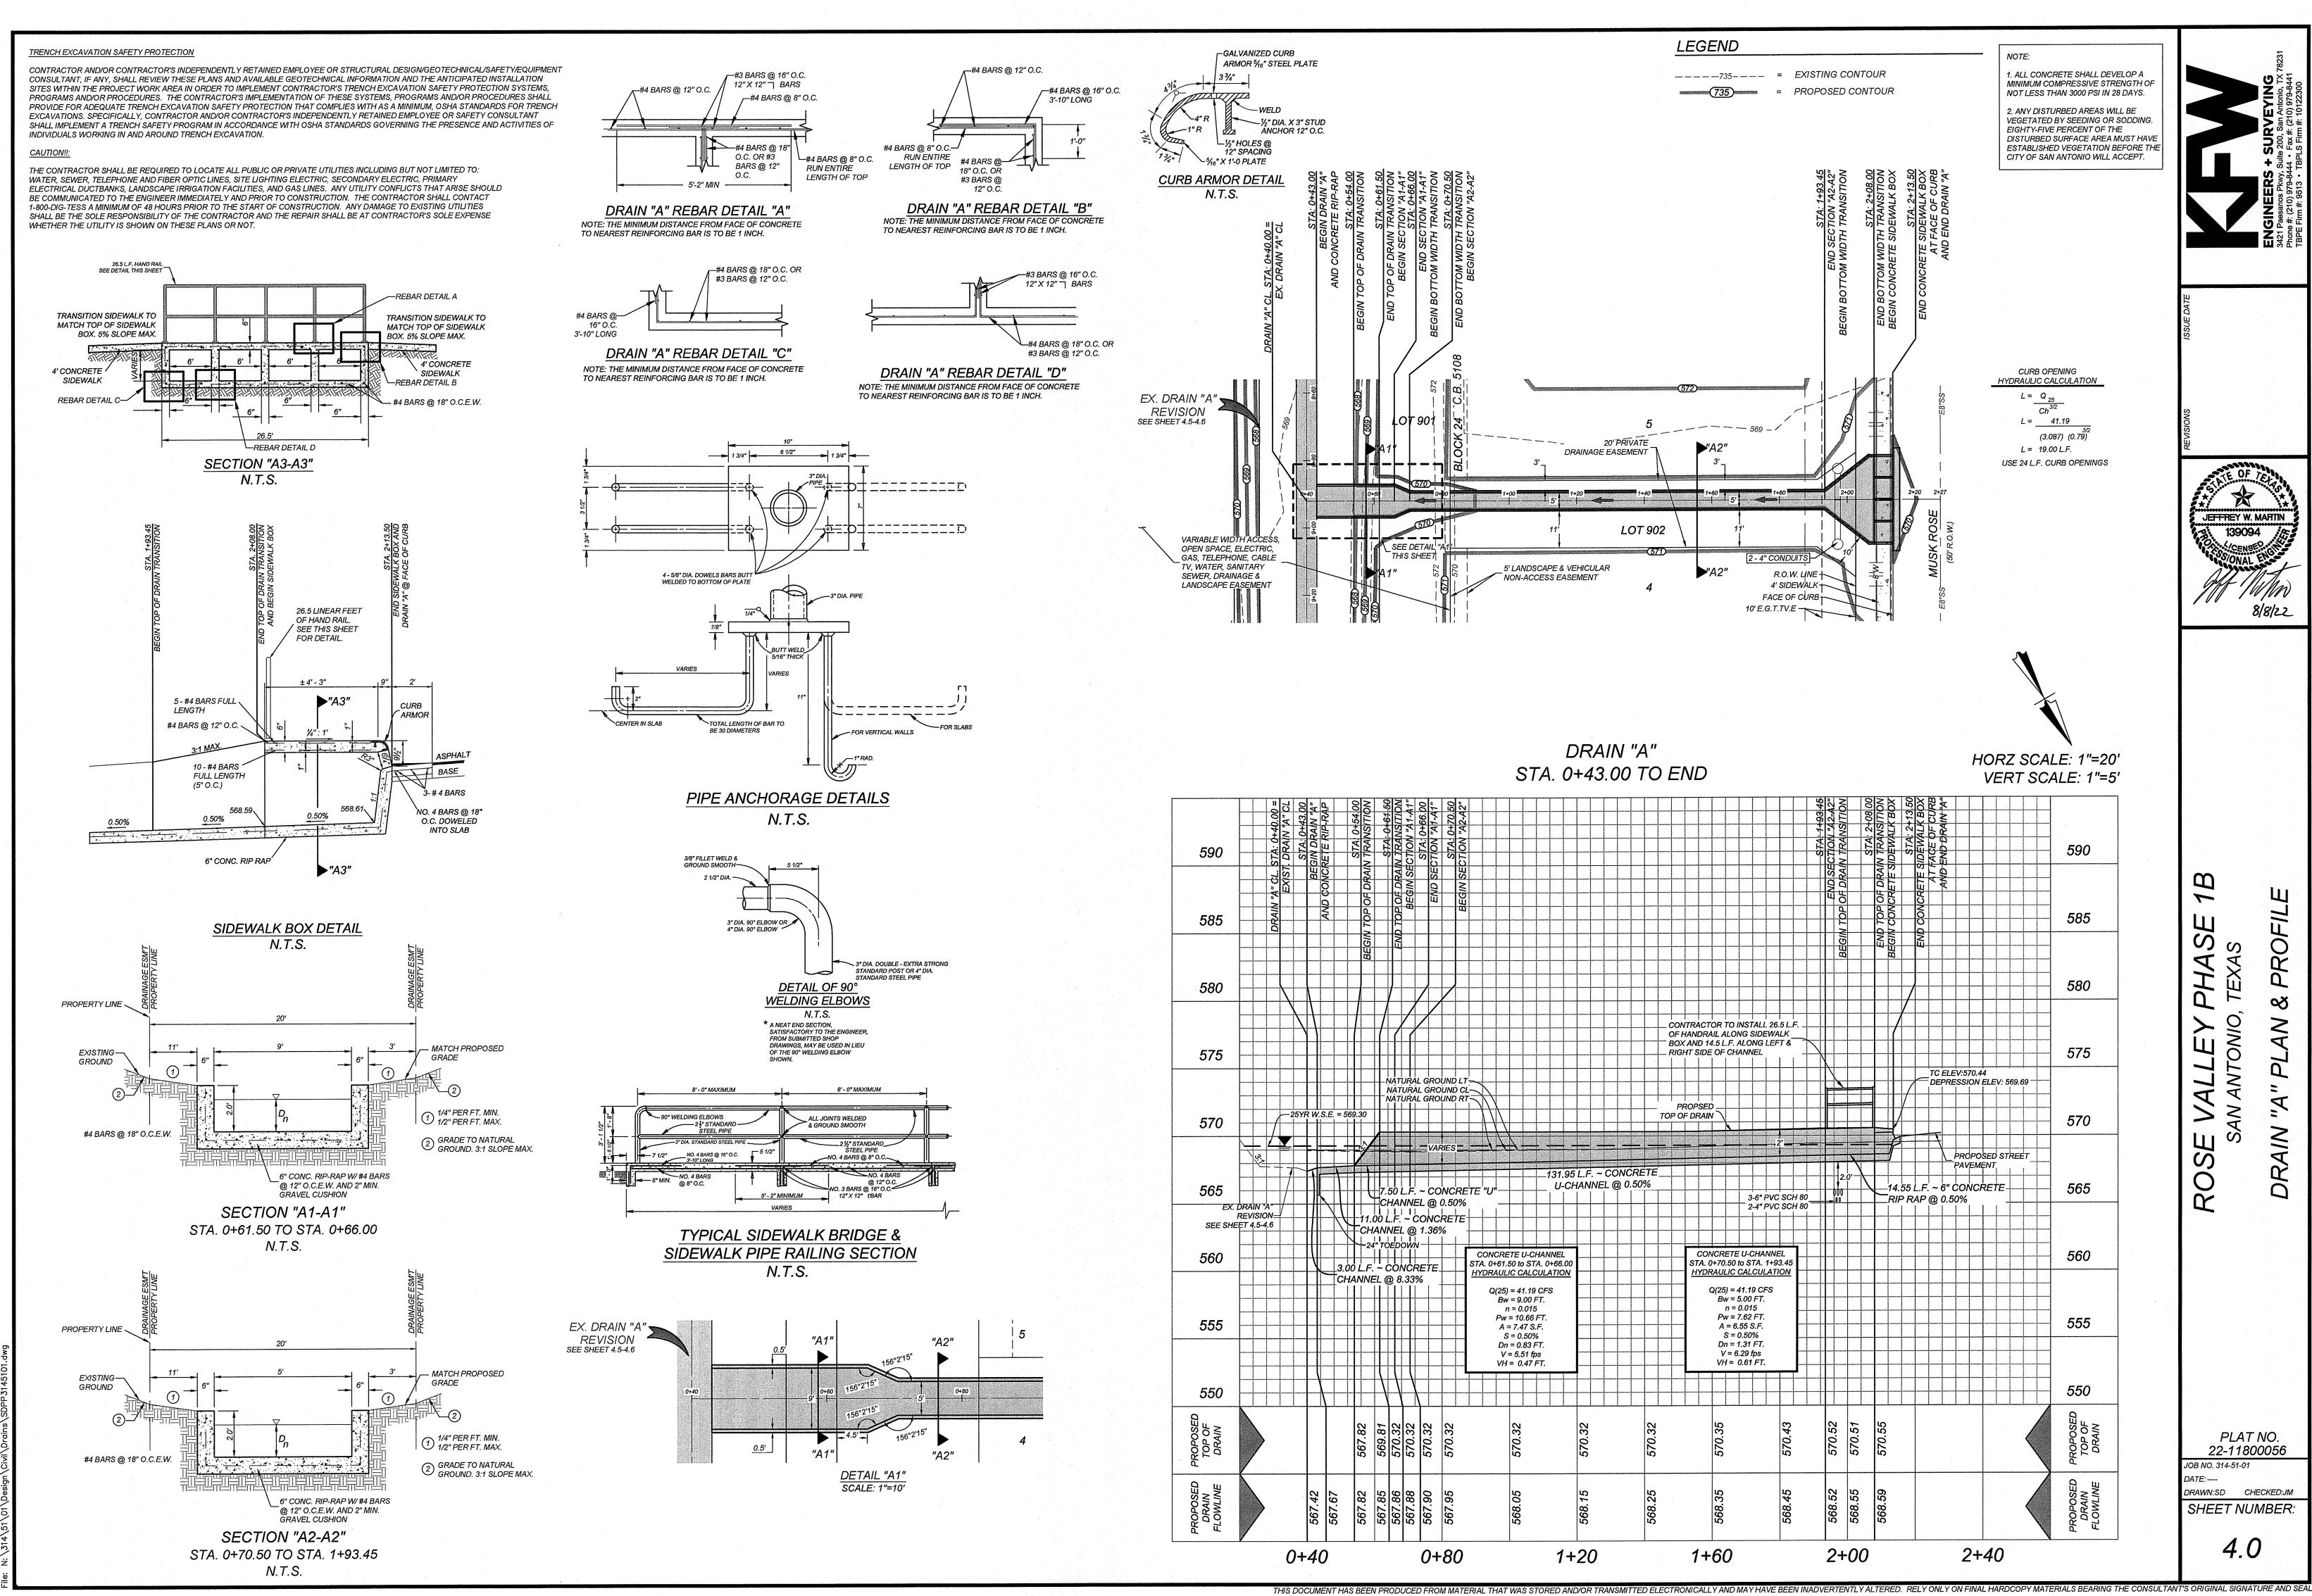
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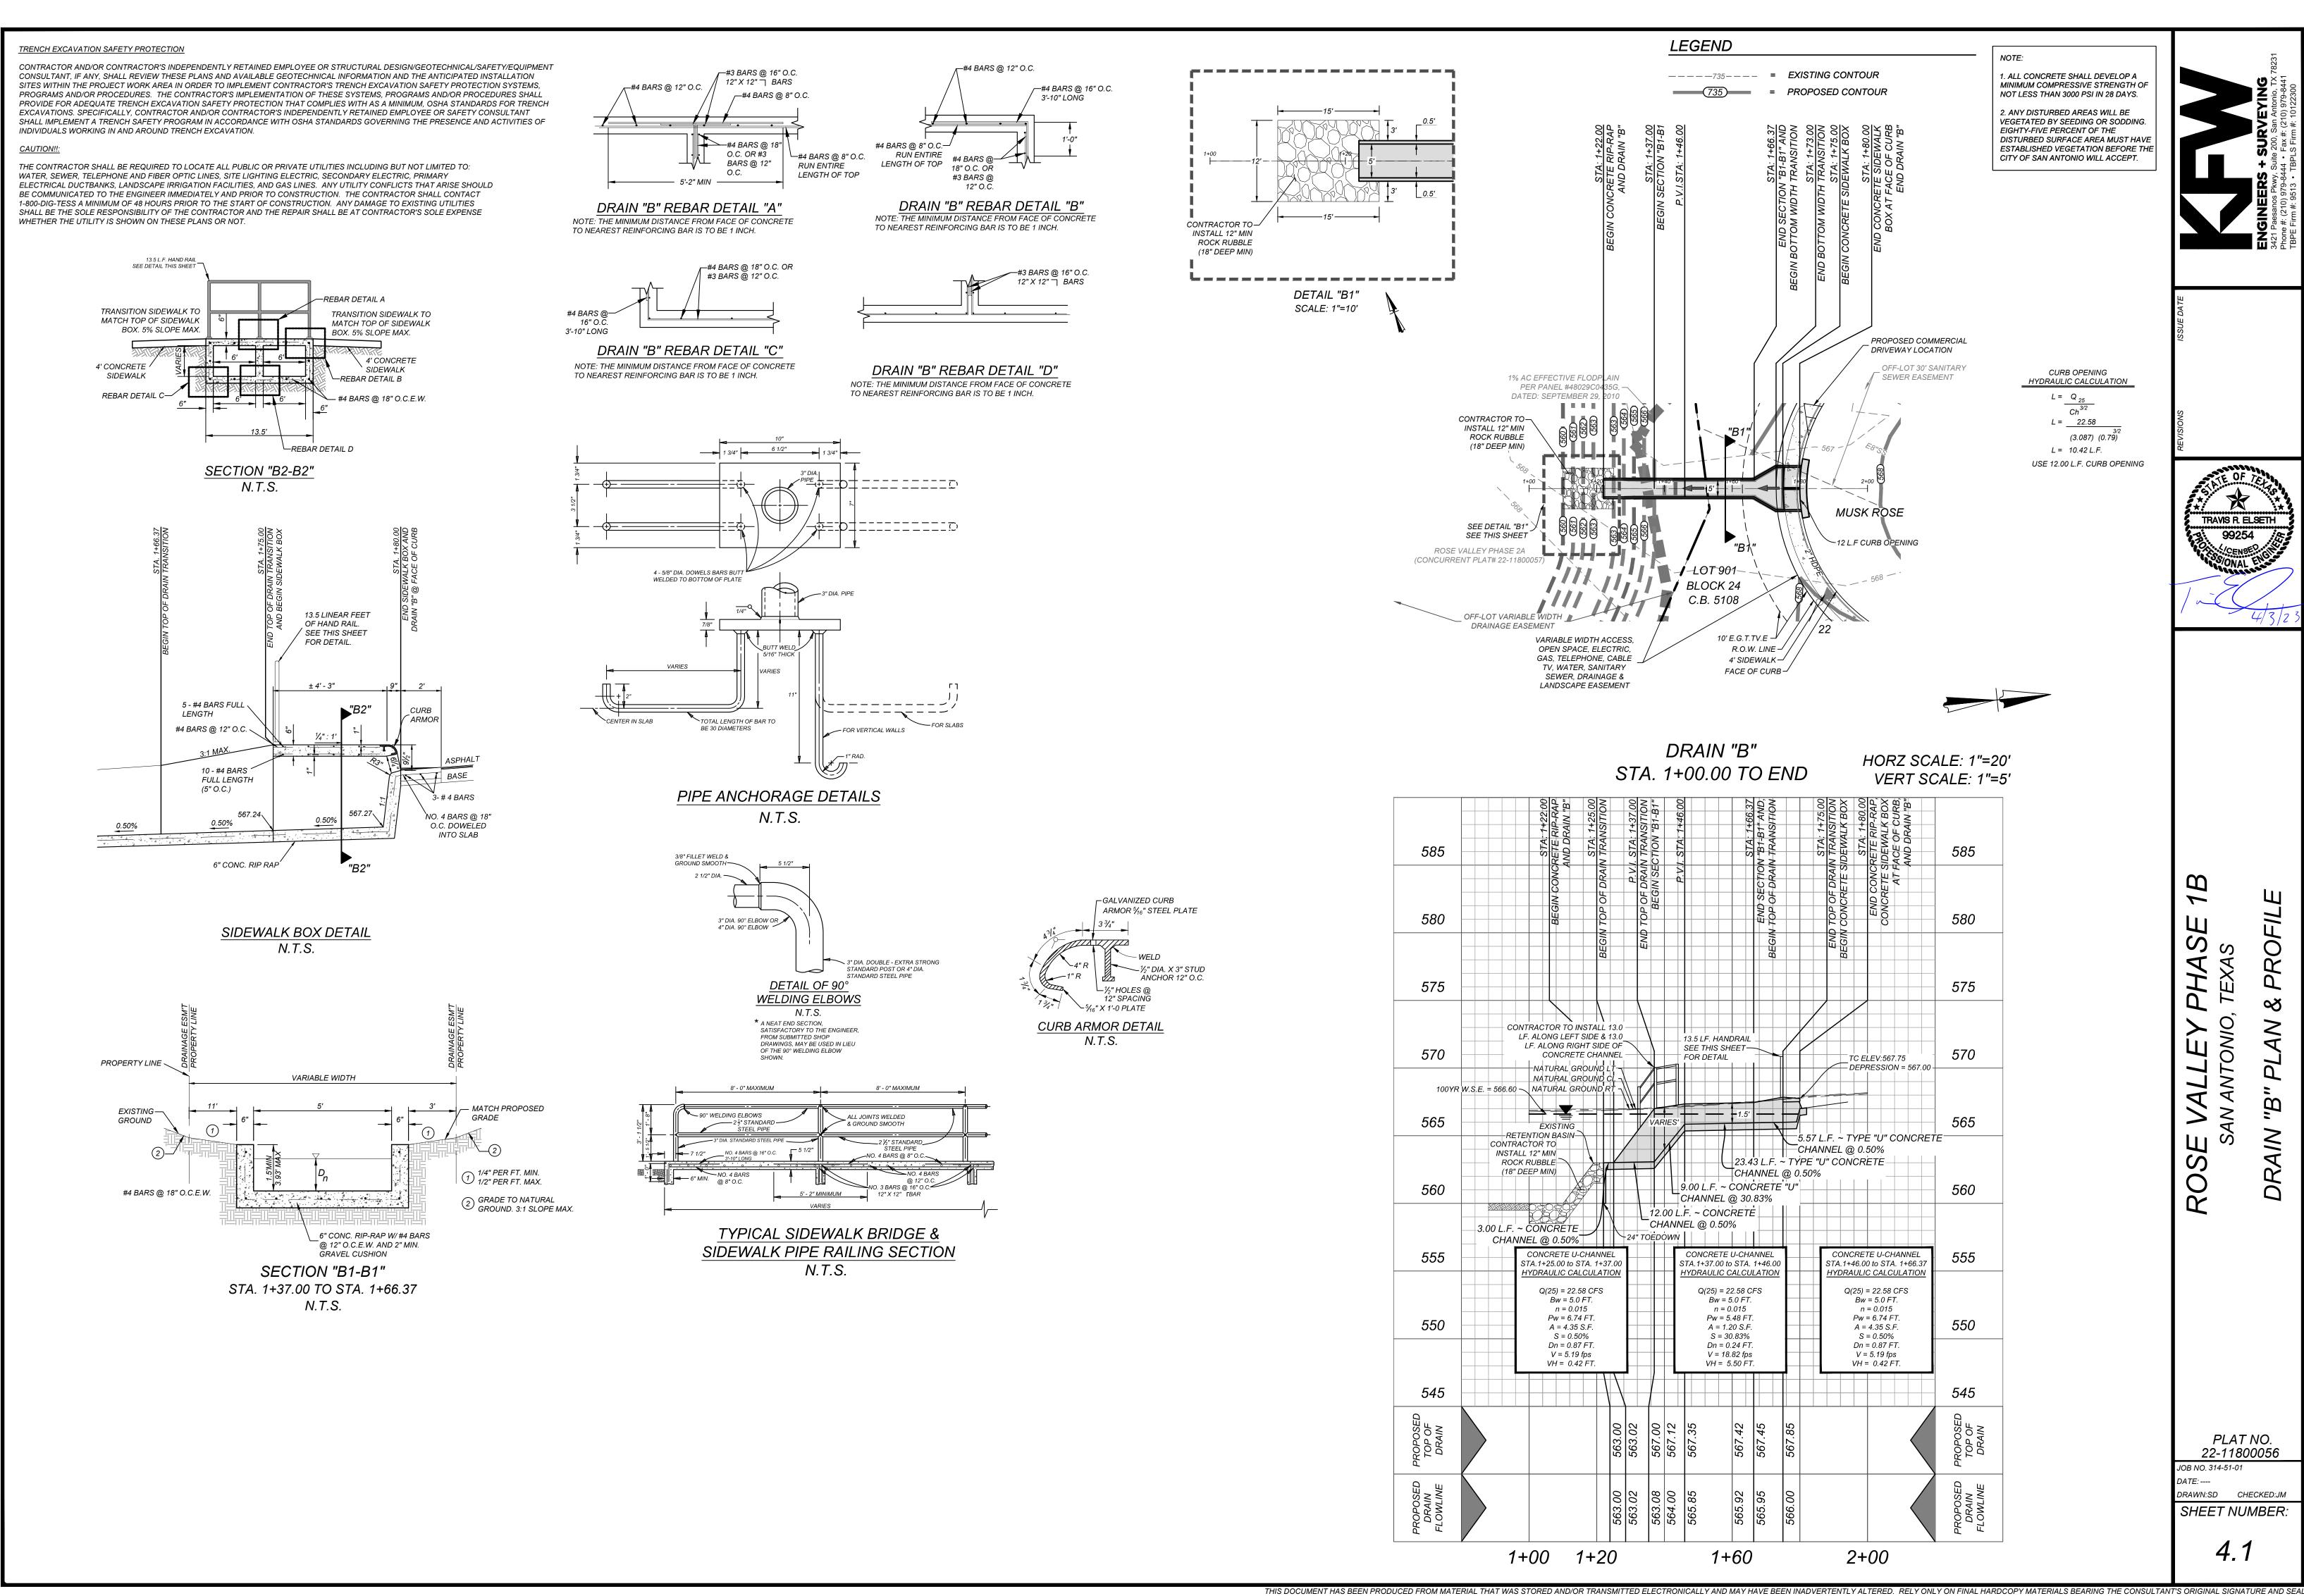
JEFFREY W. MARTIN

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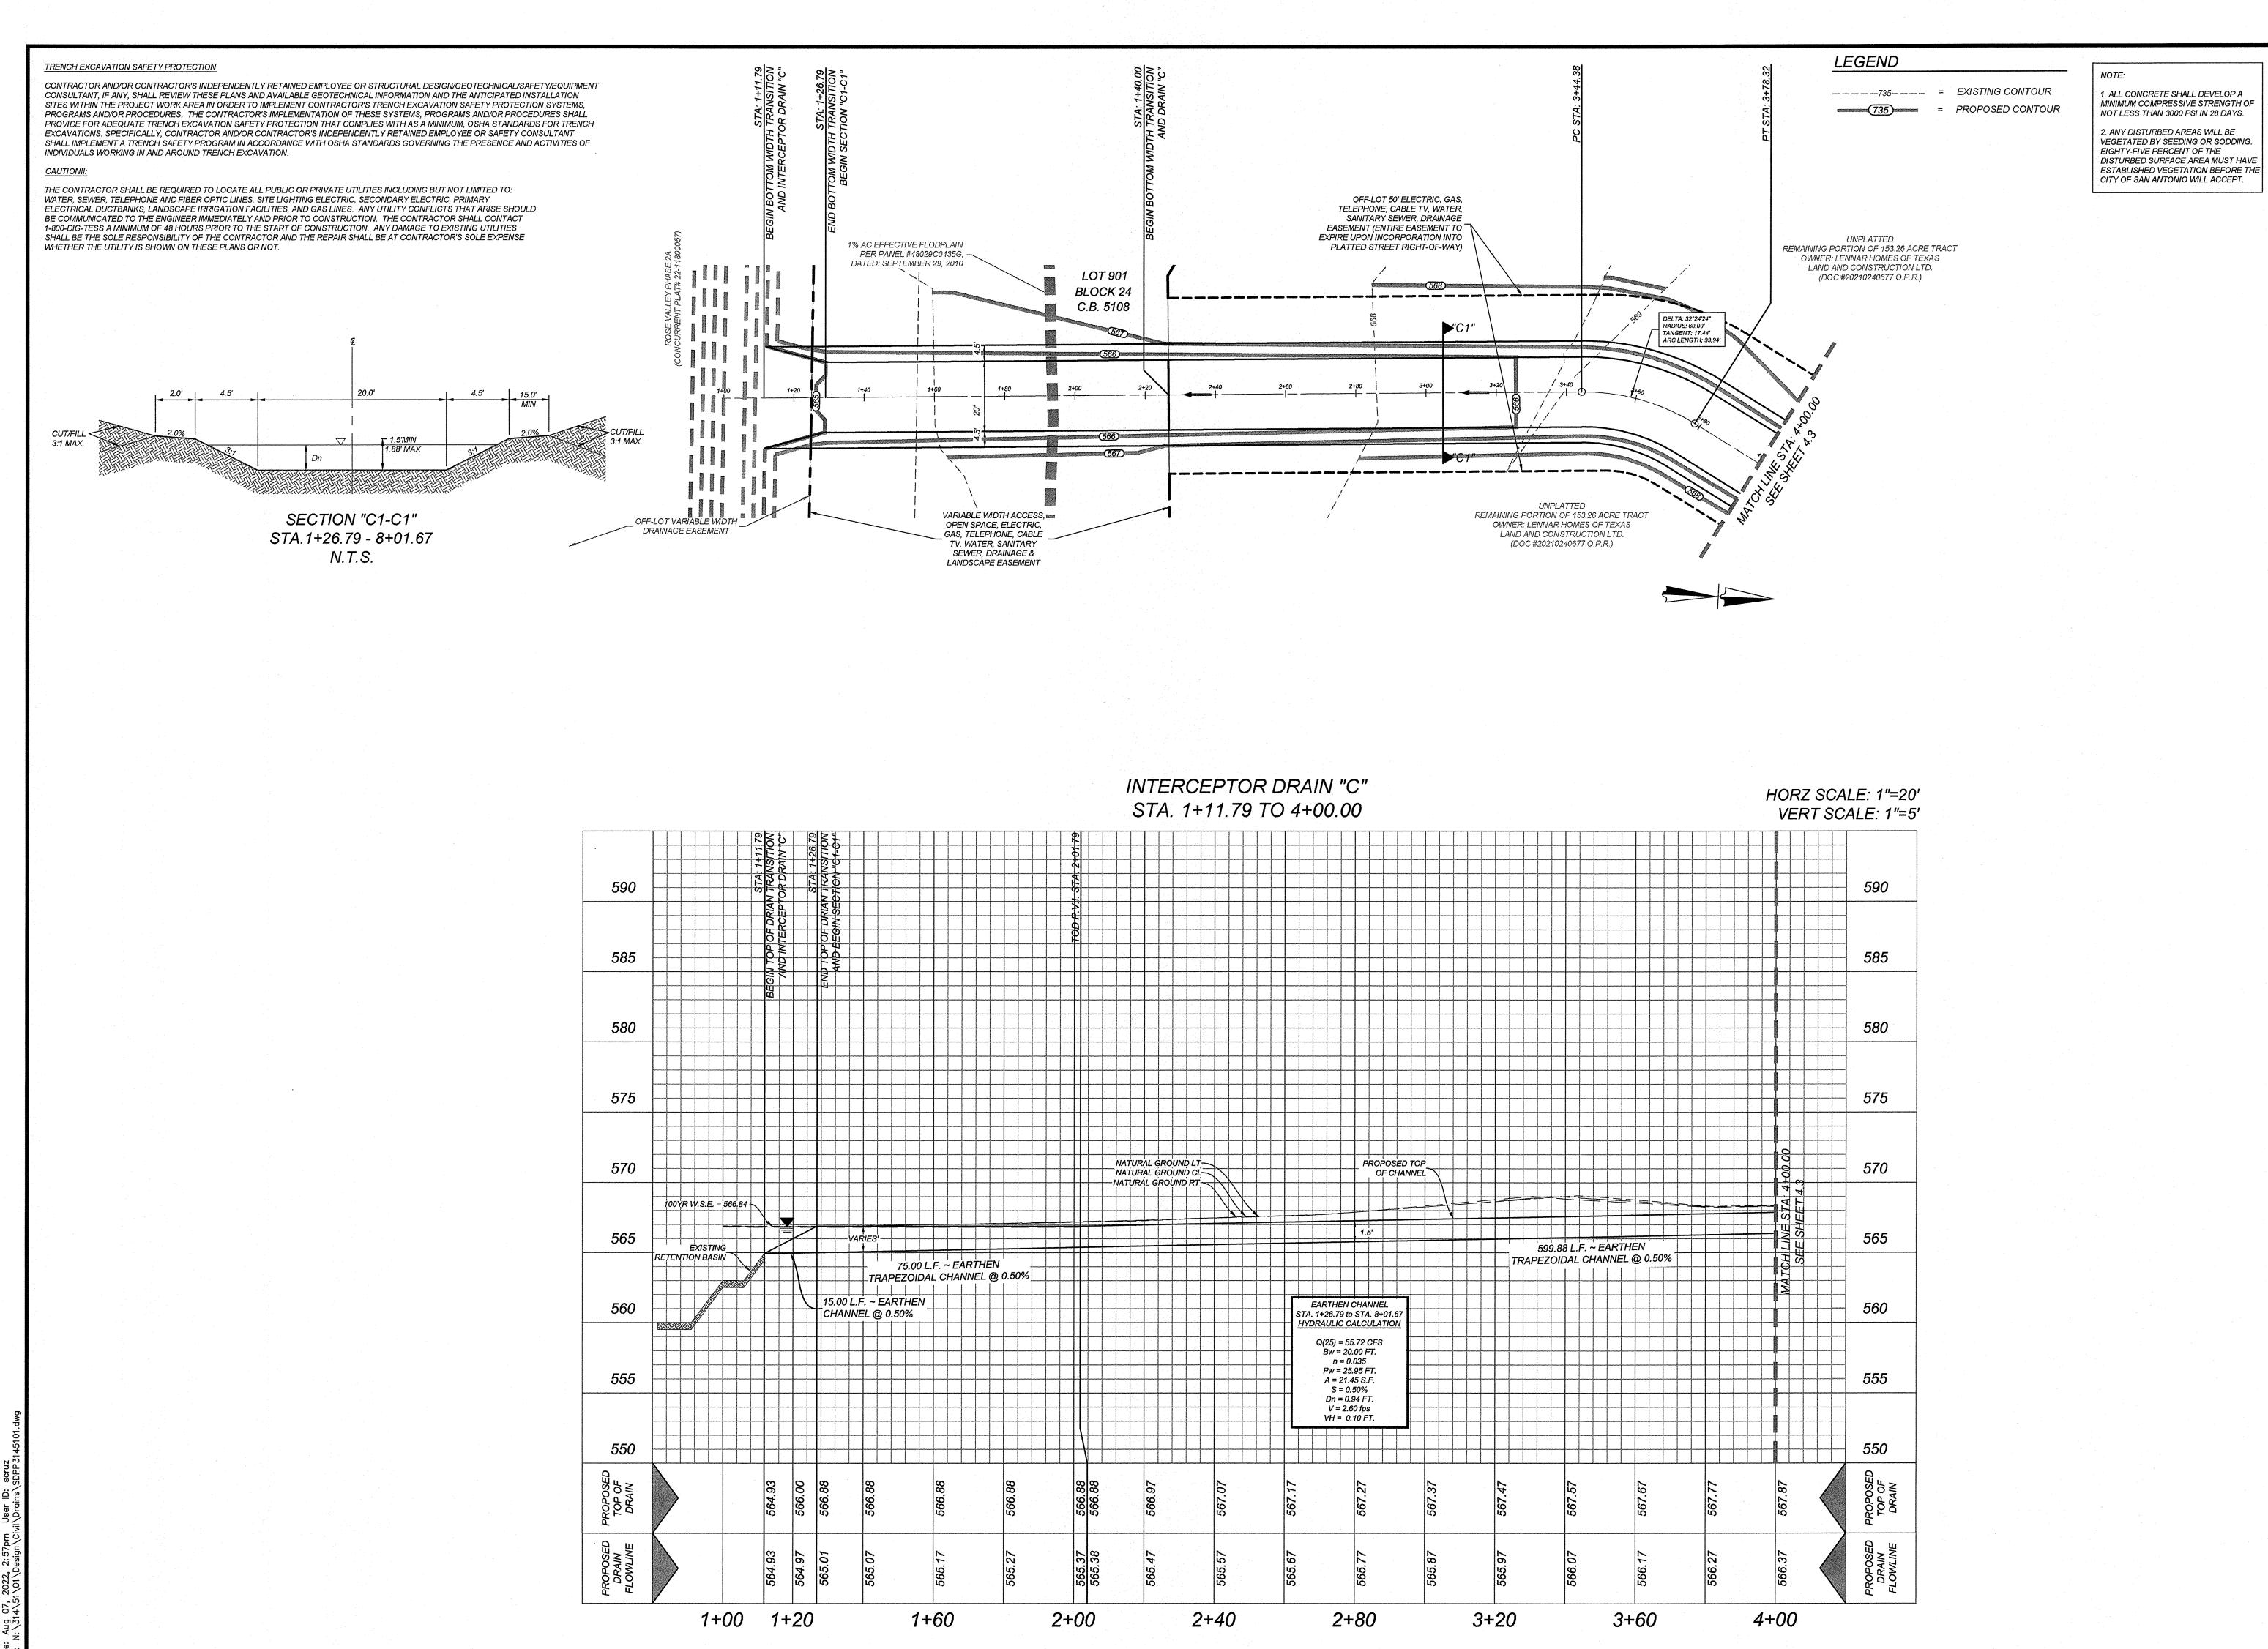
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TRAVIS R. ELSETH

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JEFFREY W. MARTIN

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CENSES
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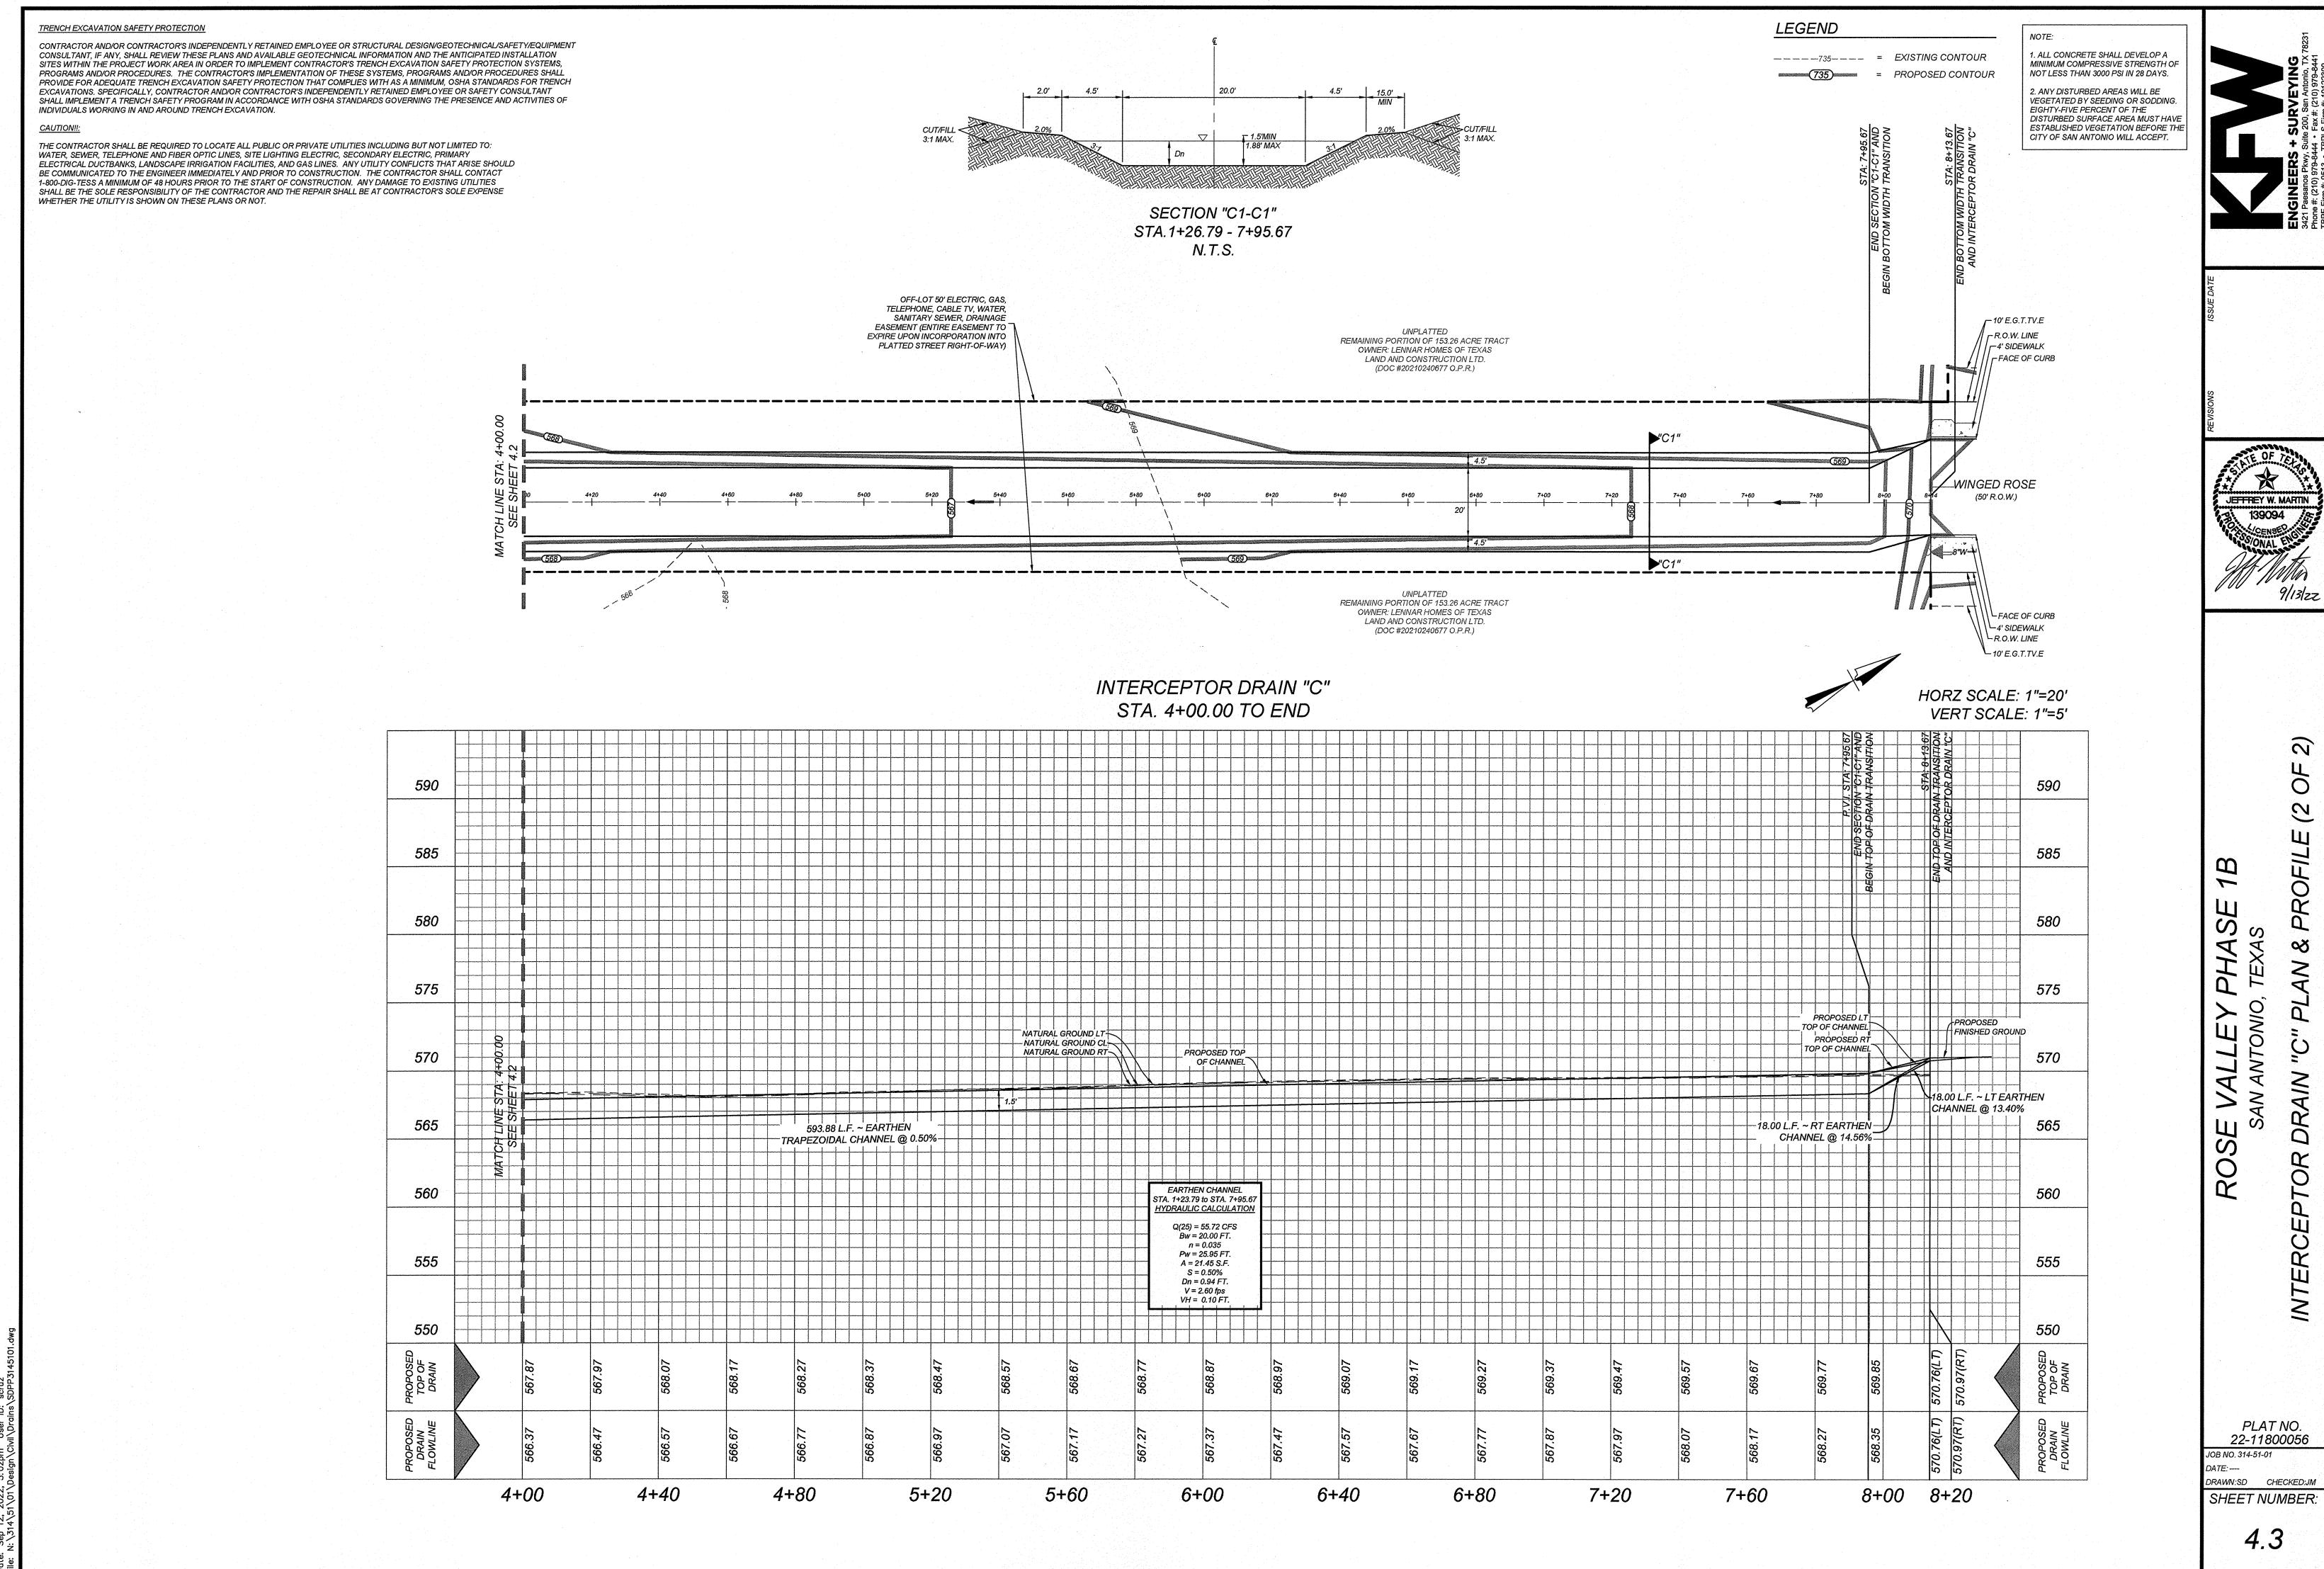
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ROSE VALLEY PHASE 1B
SAN ANTONIO, TEXAS
INTERCEPTOR DRAIN "C" PLAN &
PROFILE (1.0F.2)


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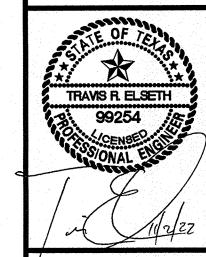
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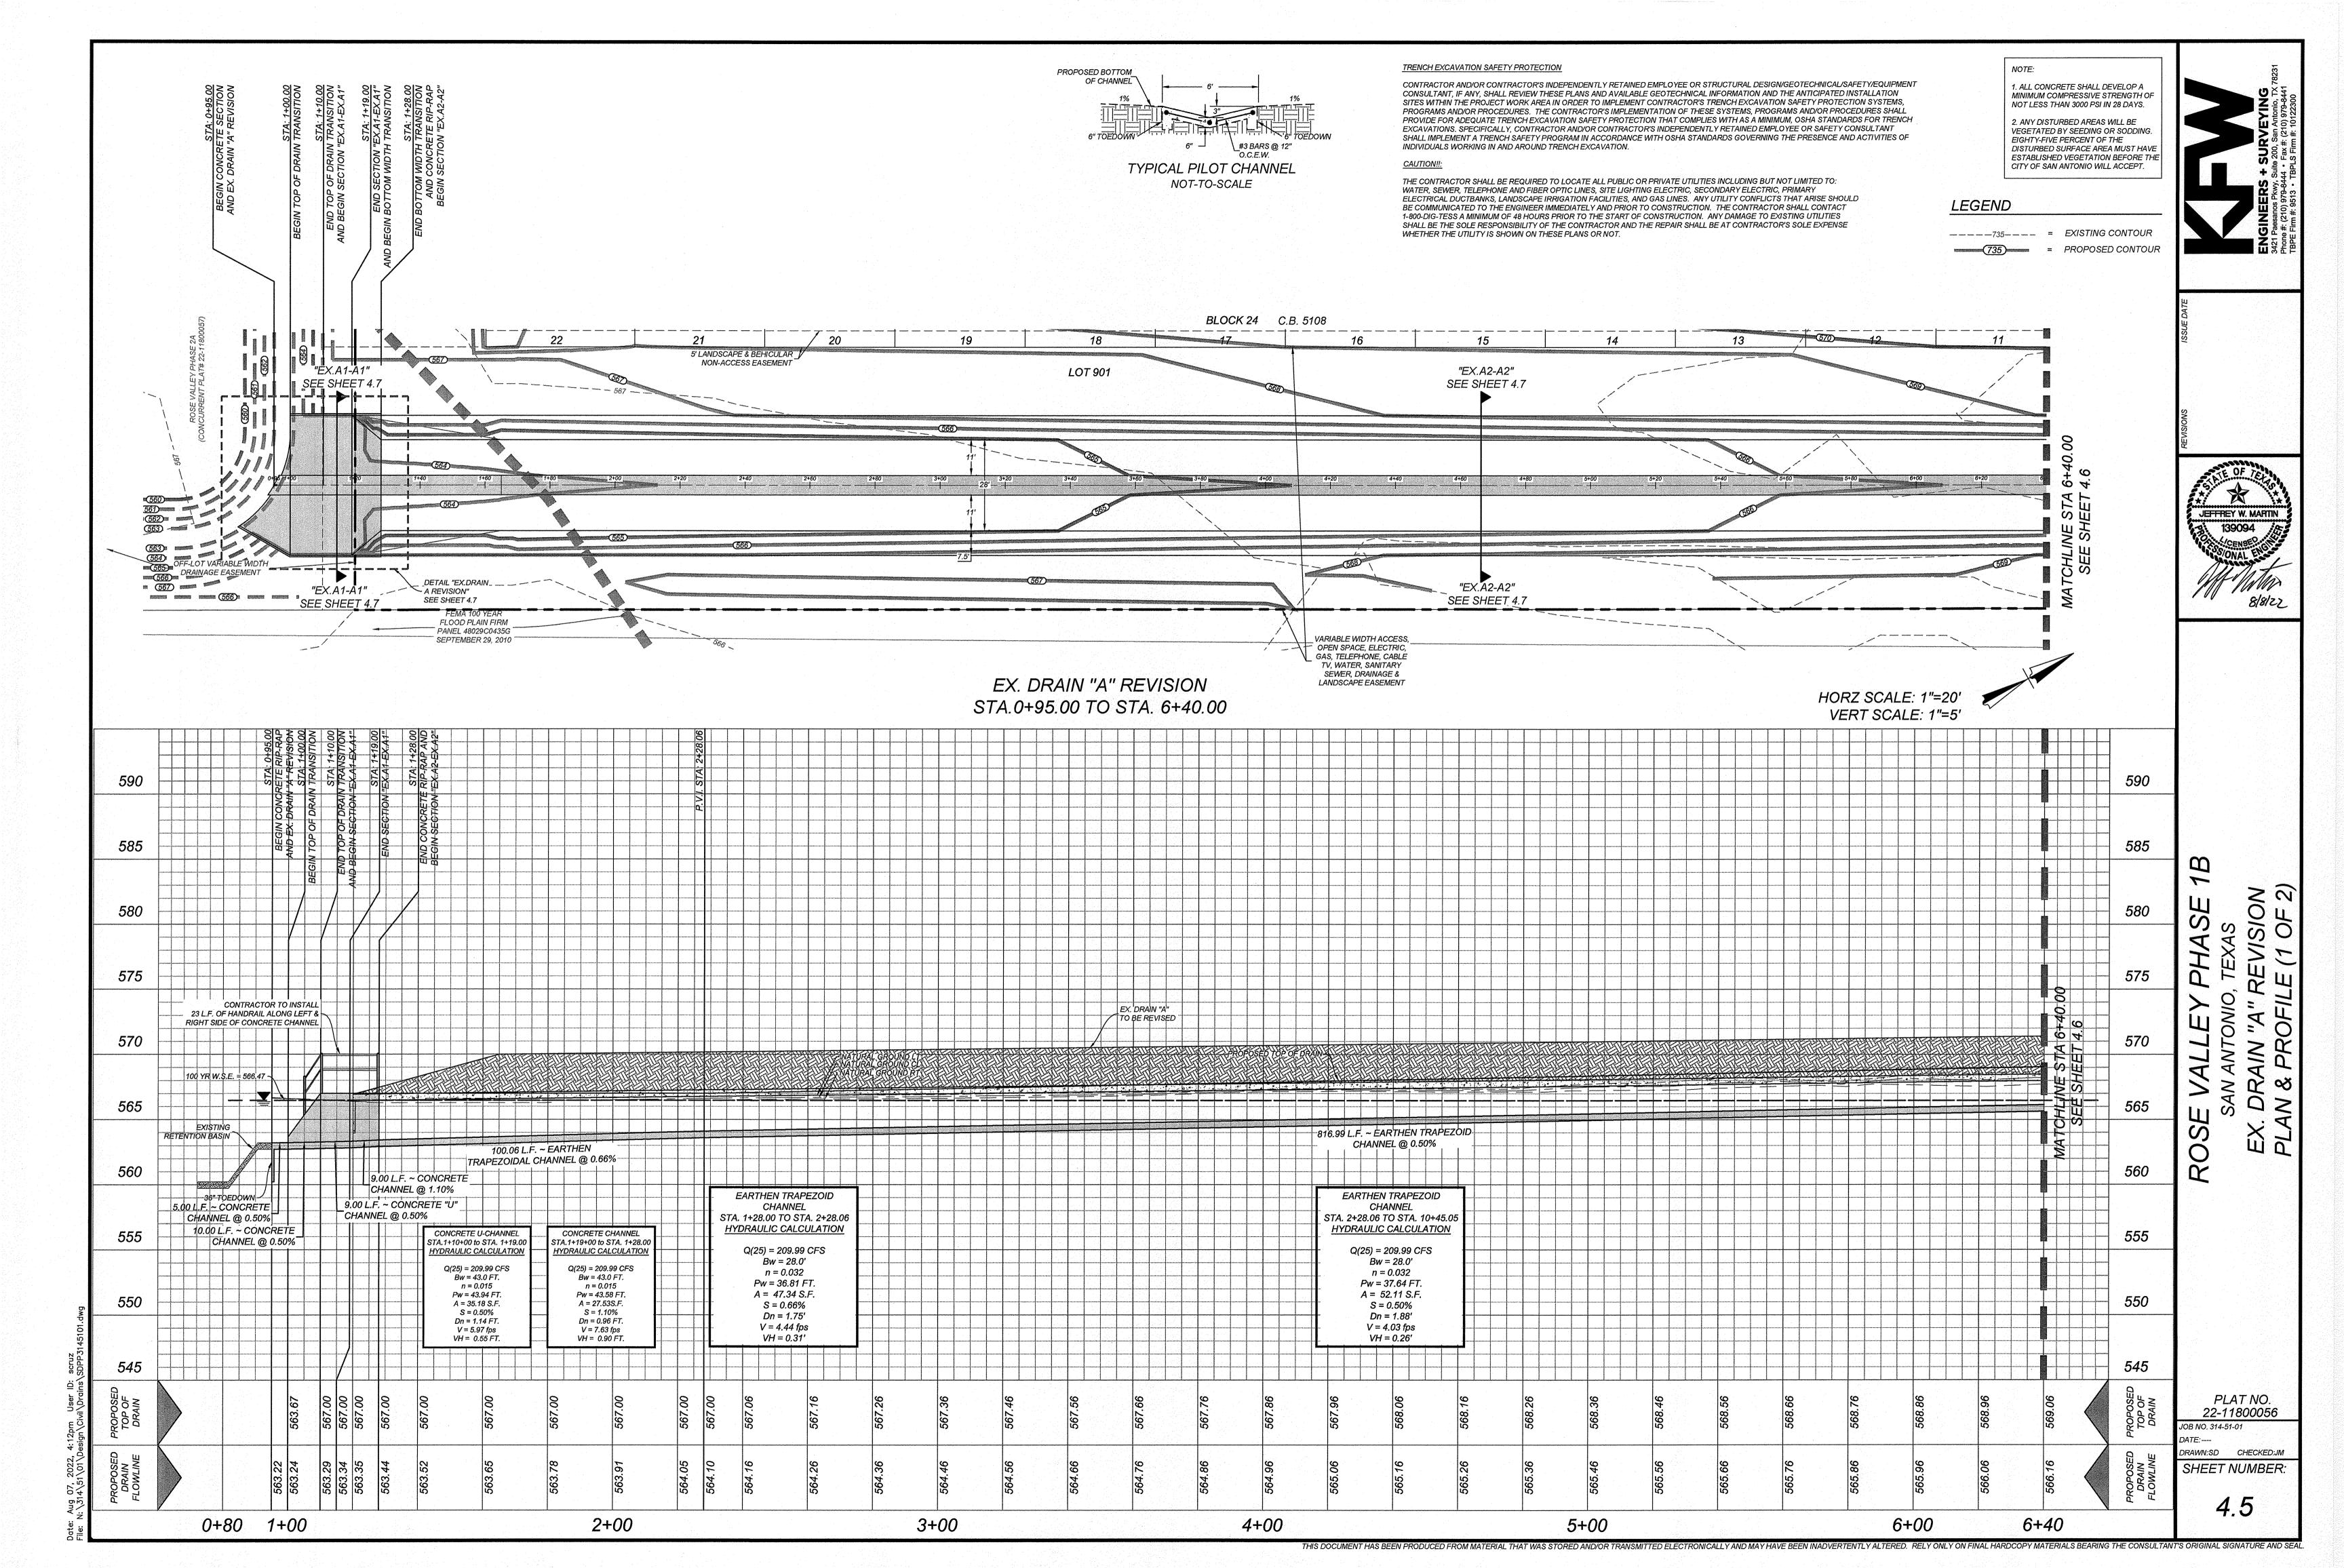
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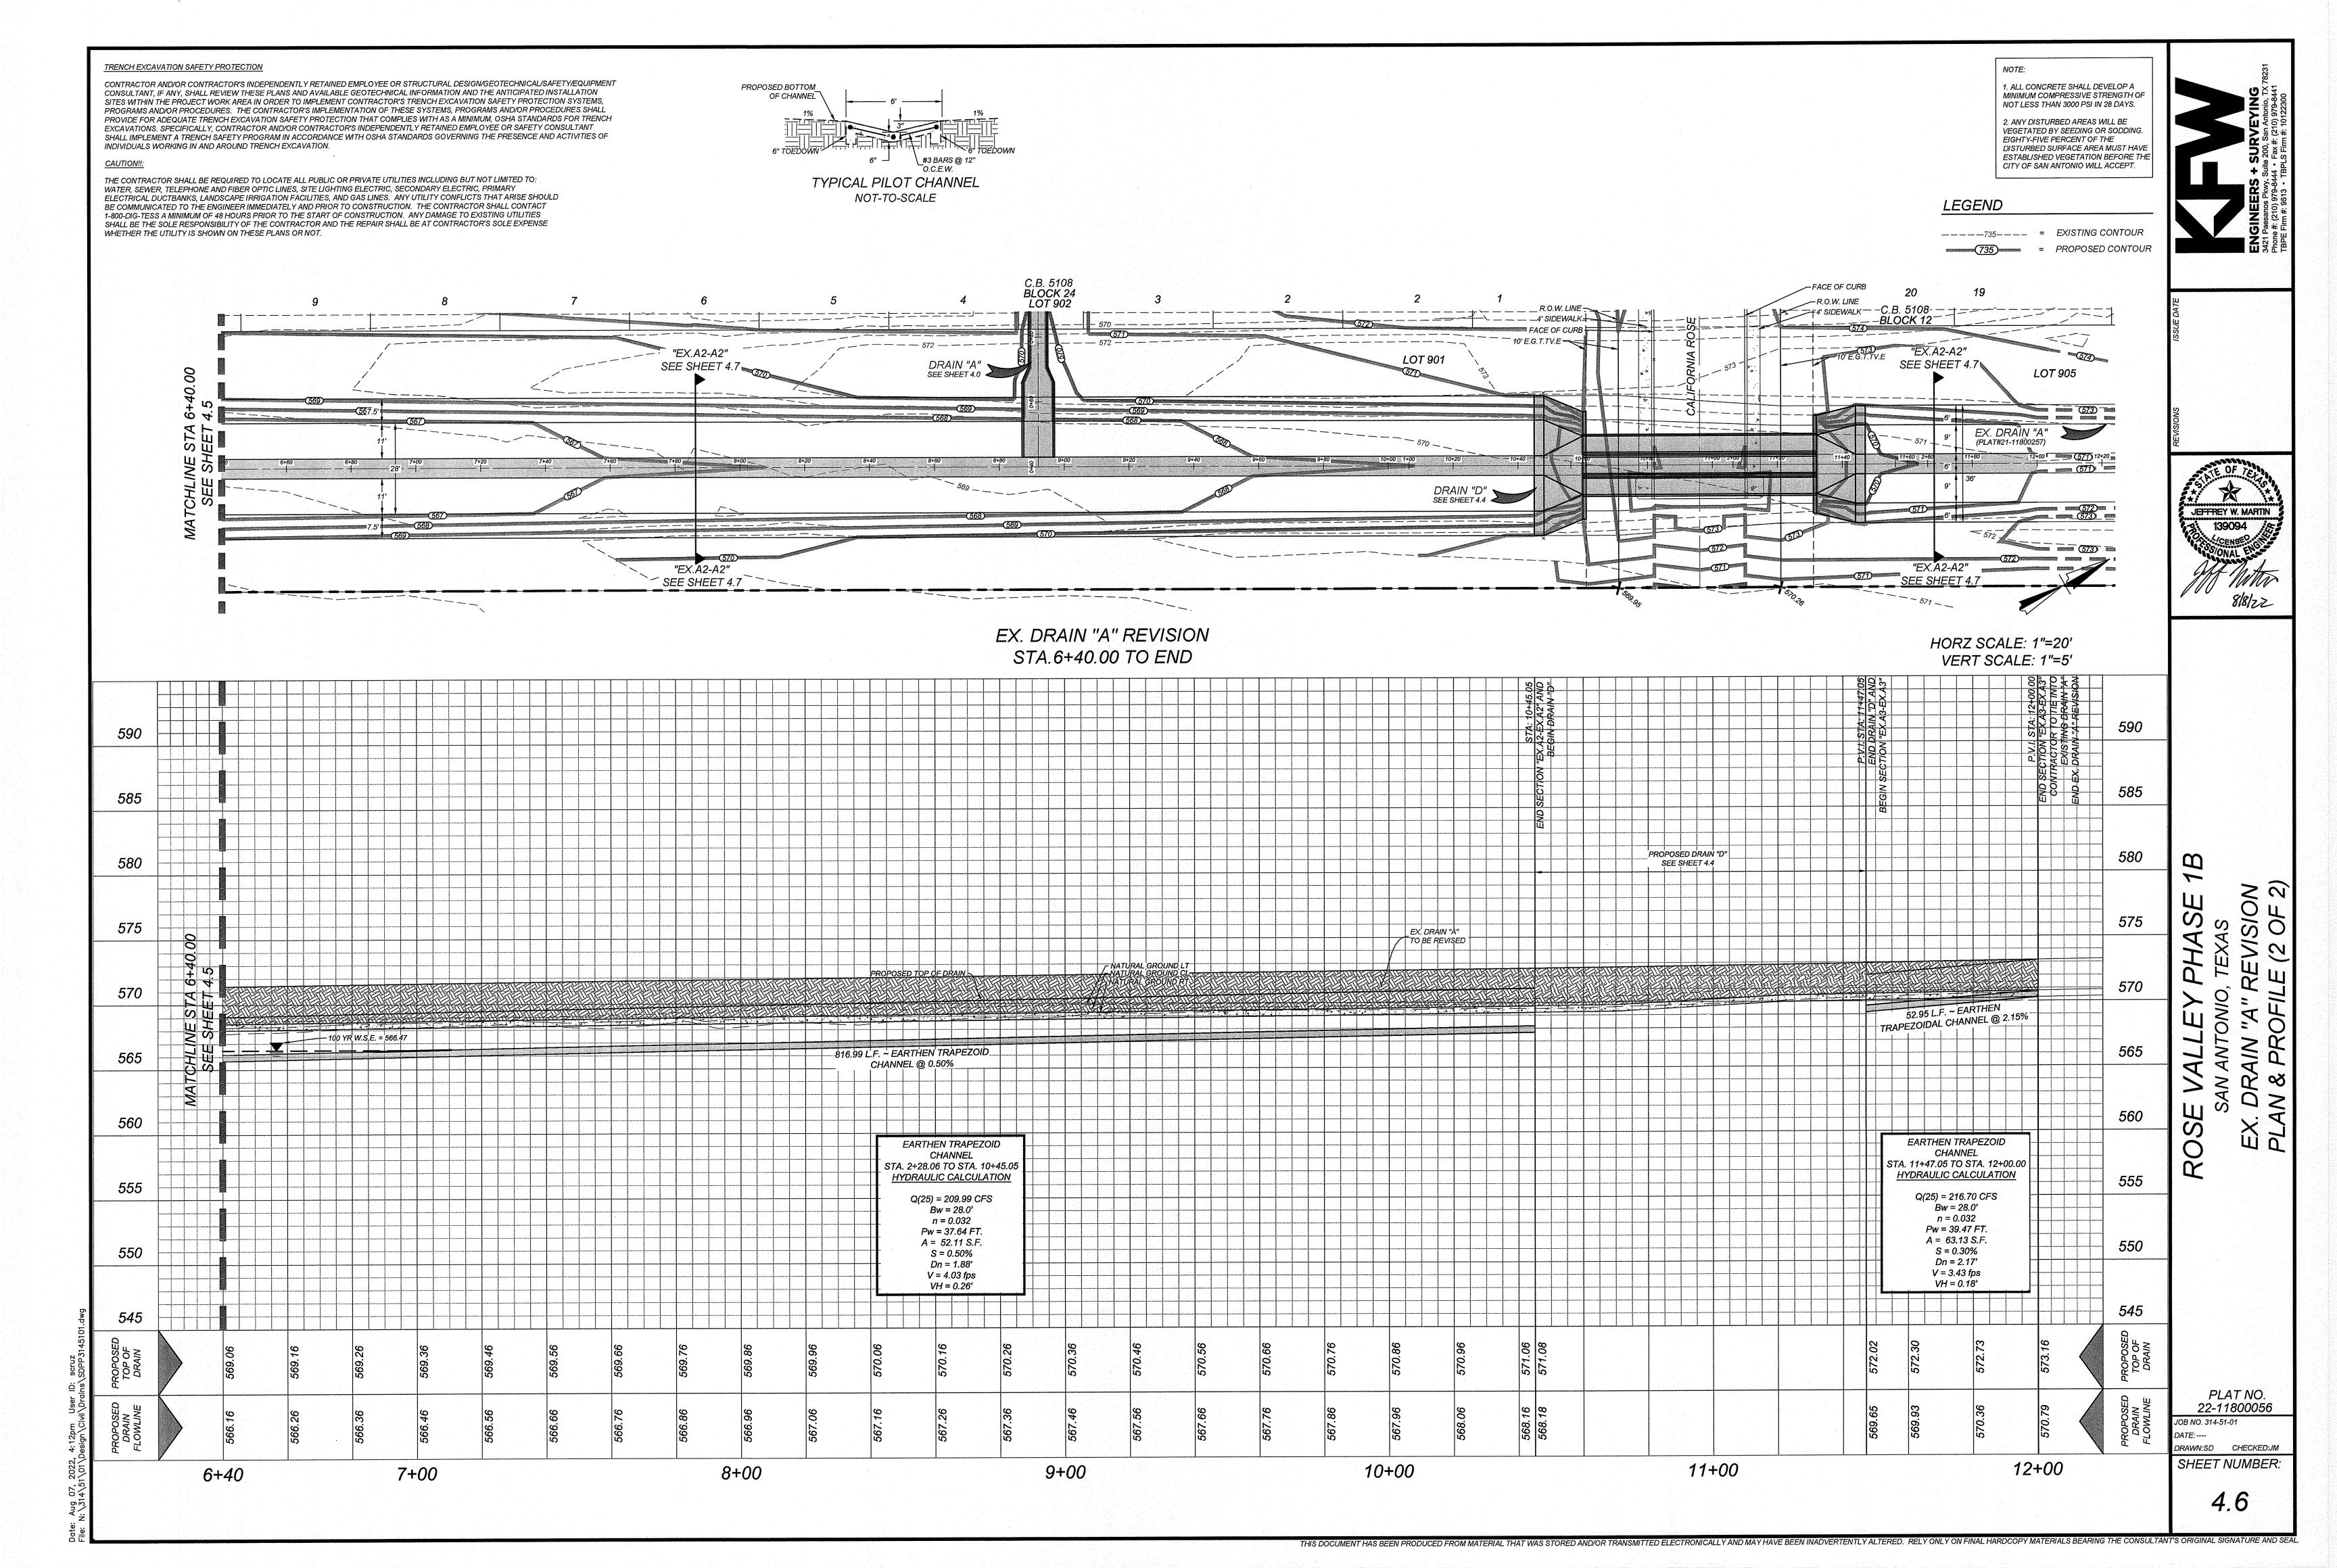



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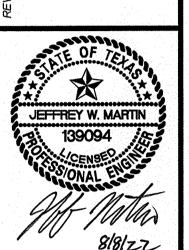






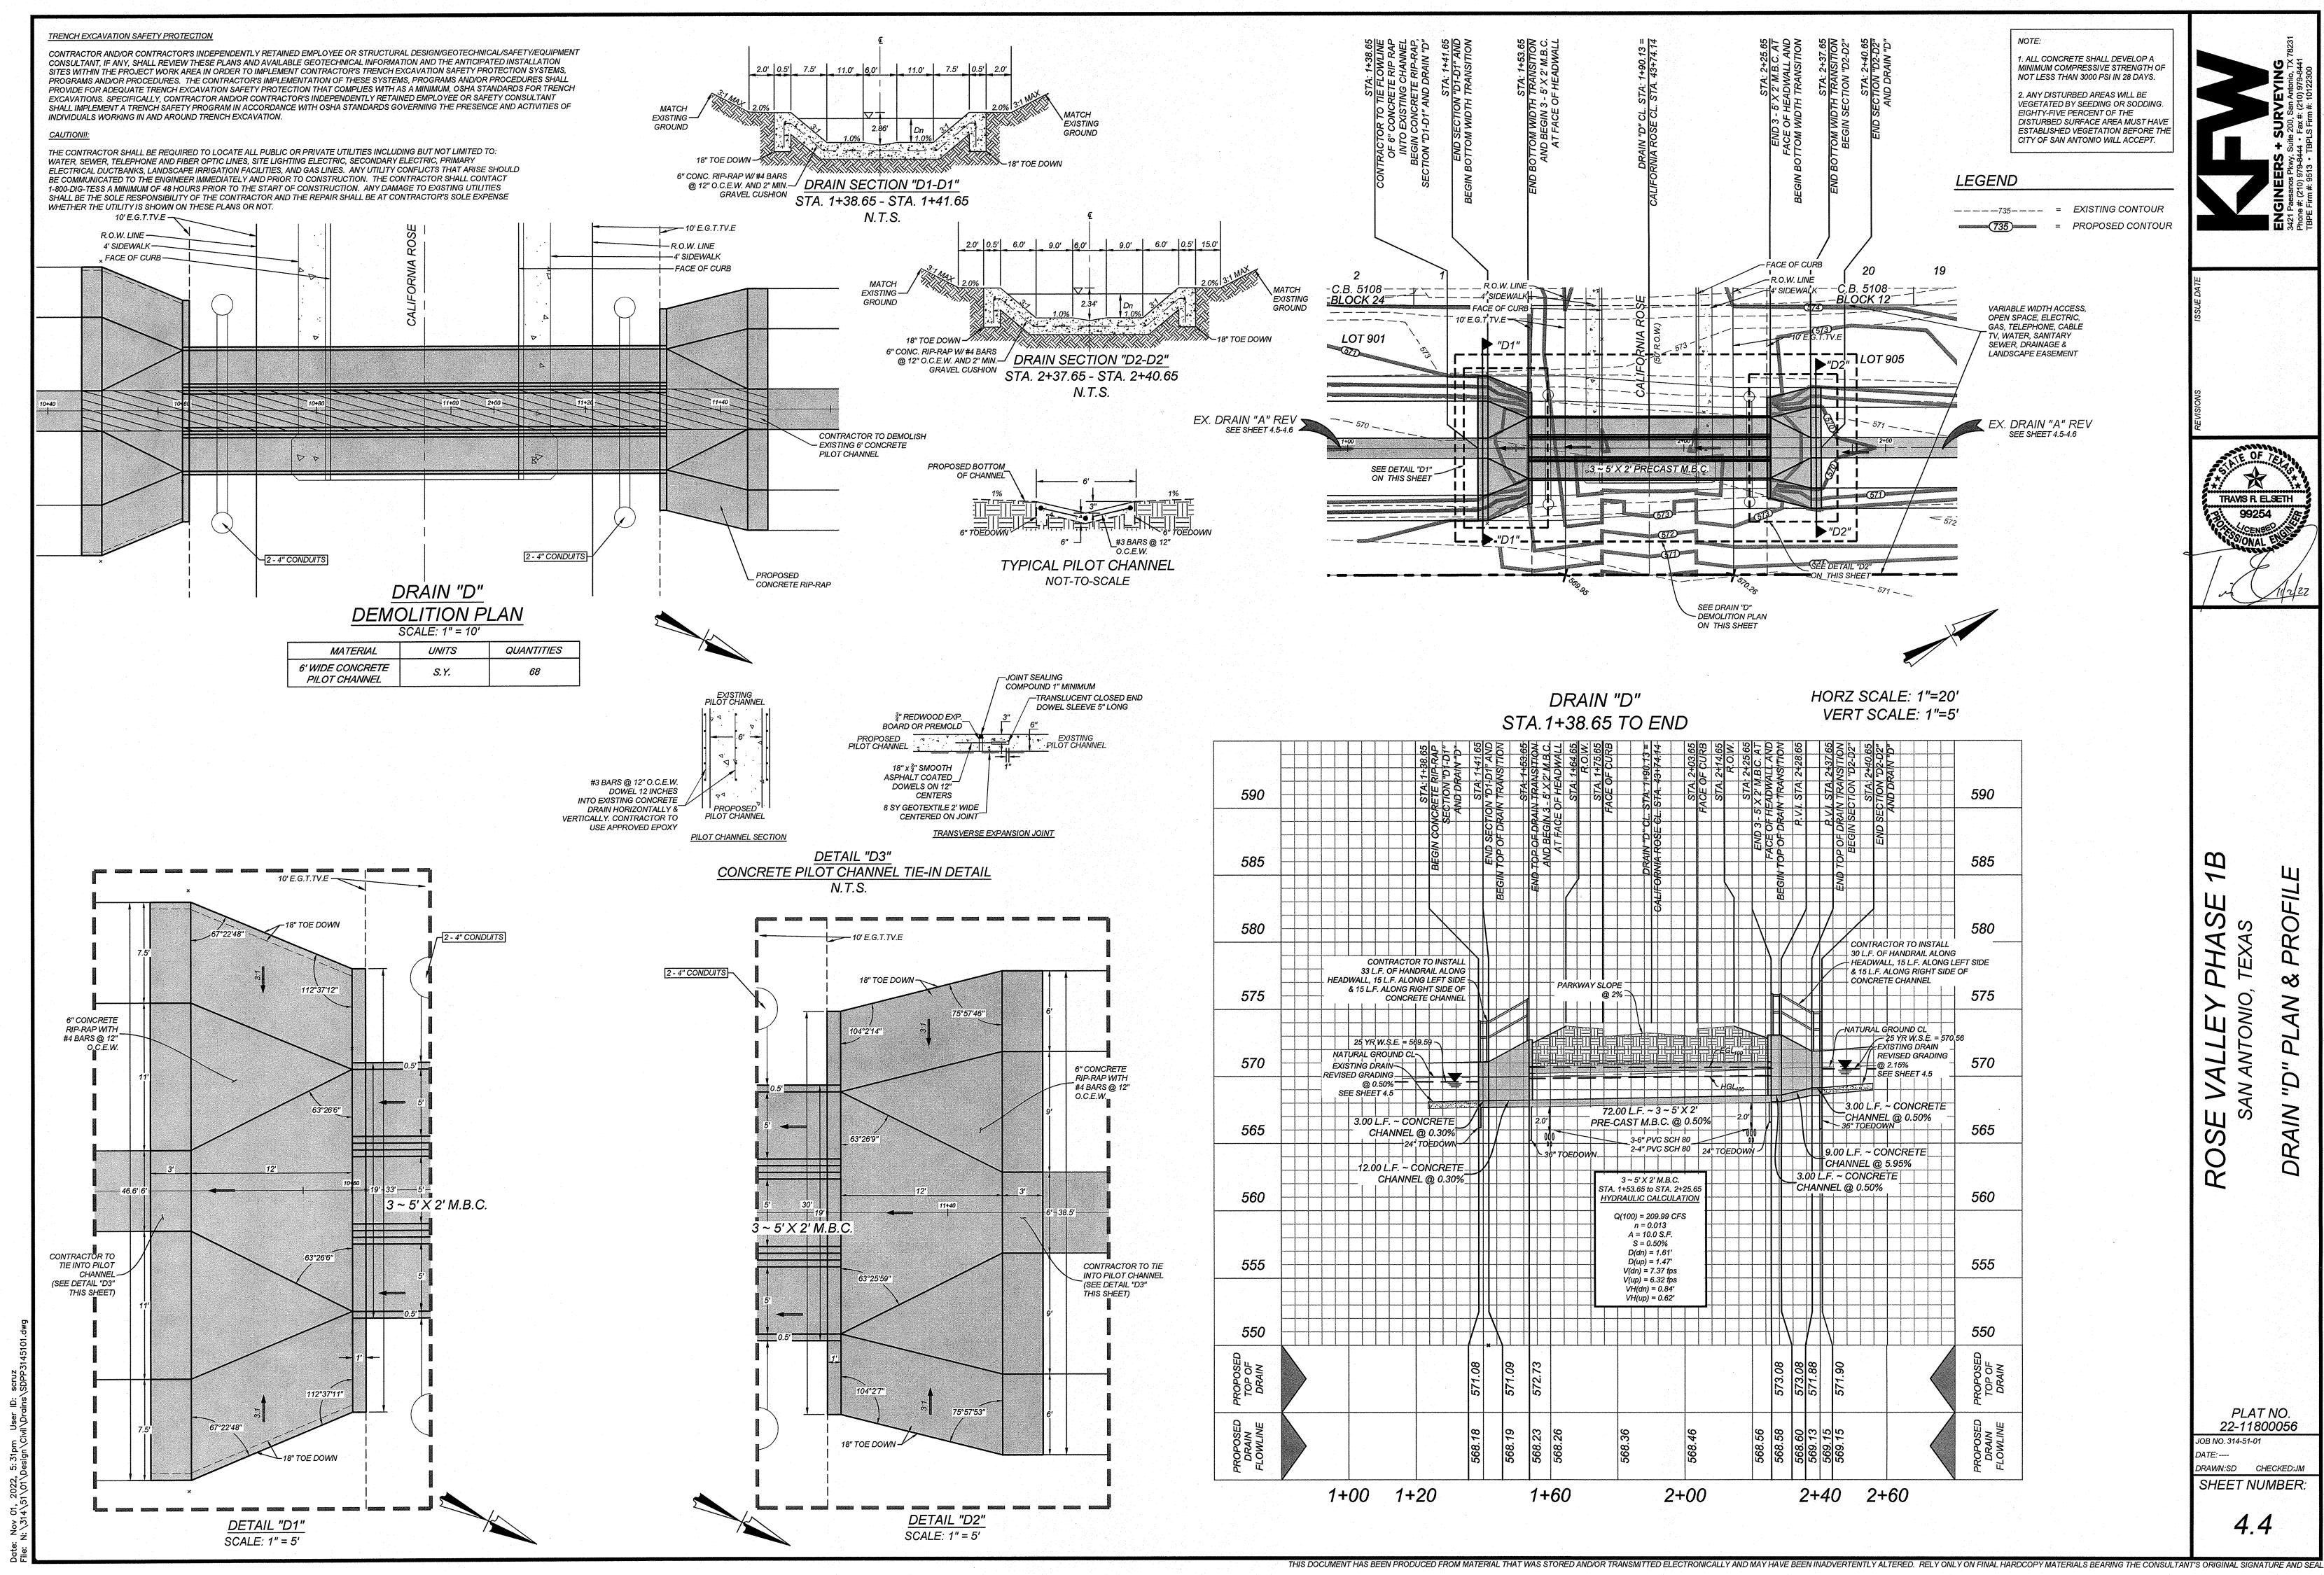

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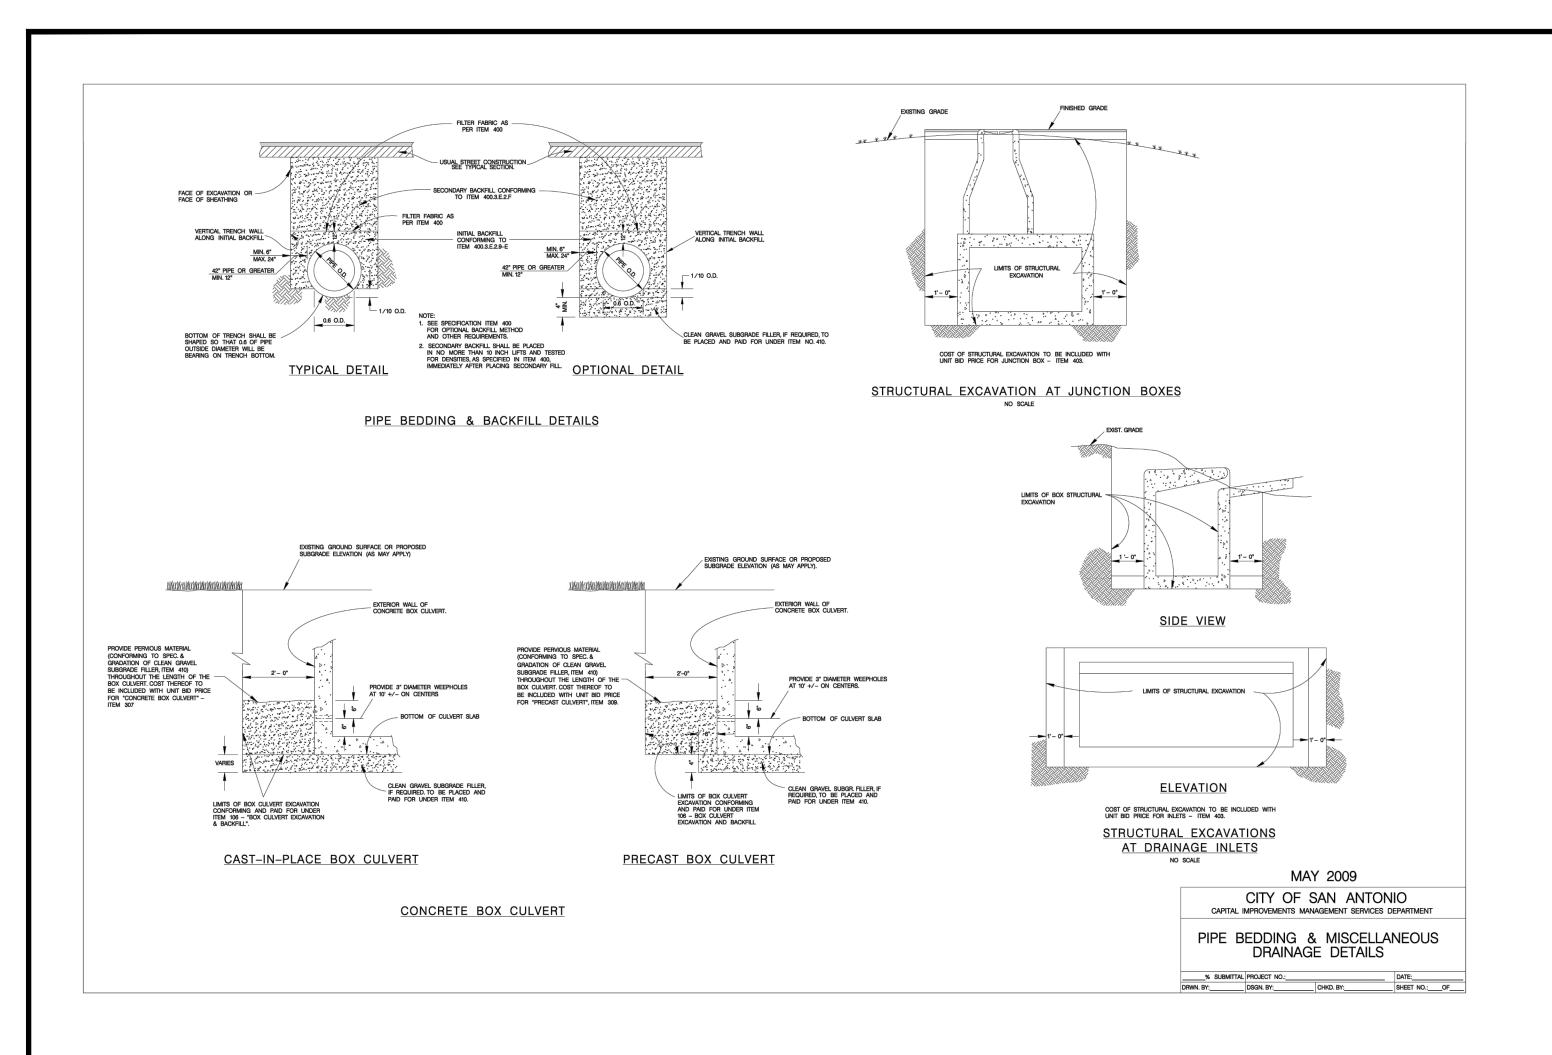
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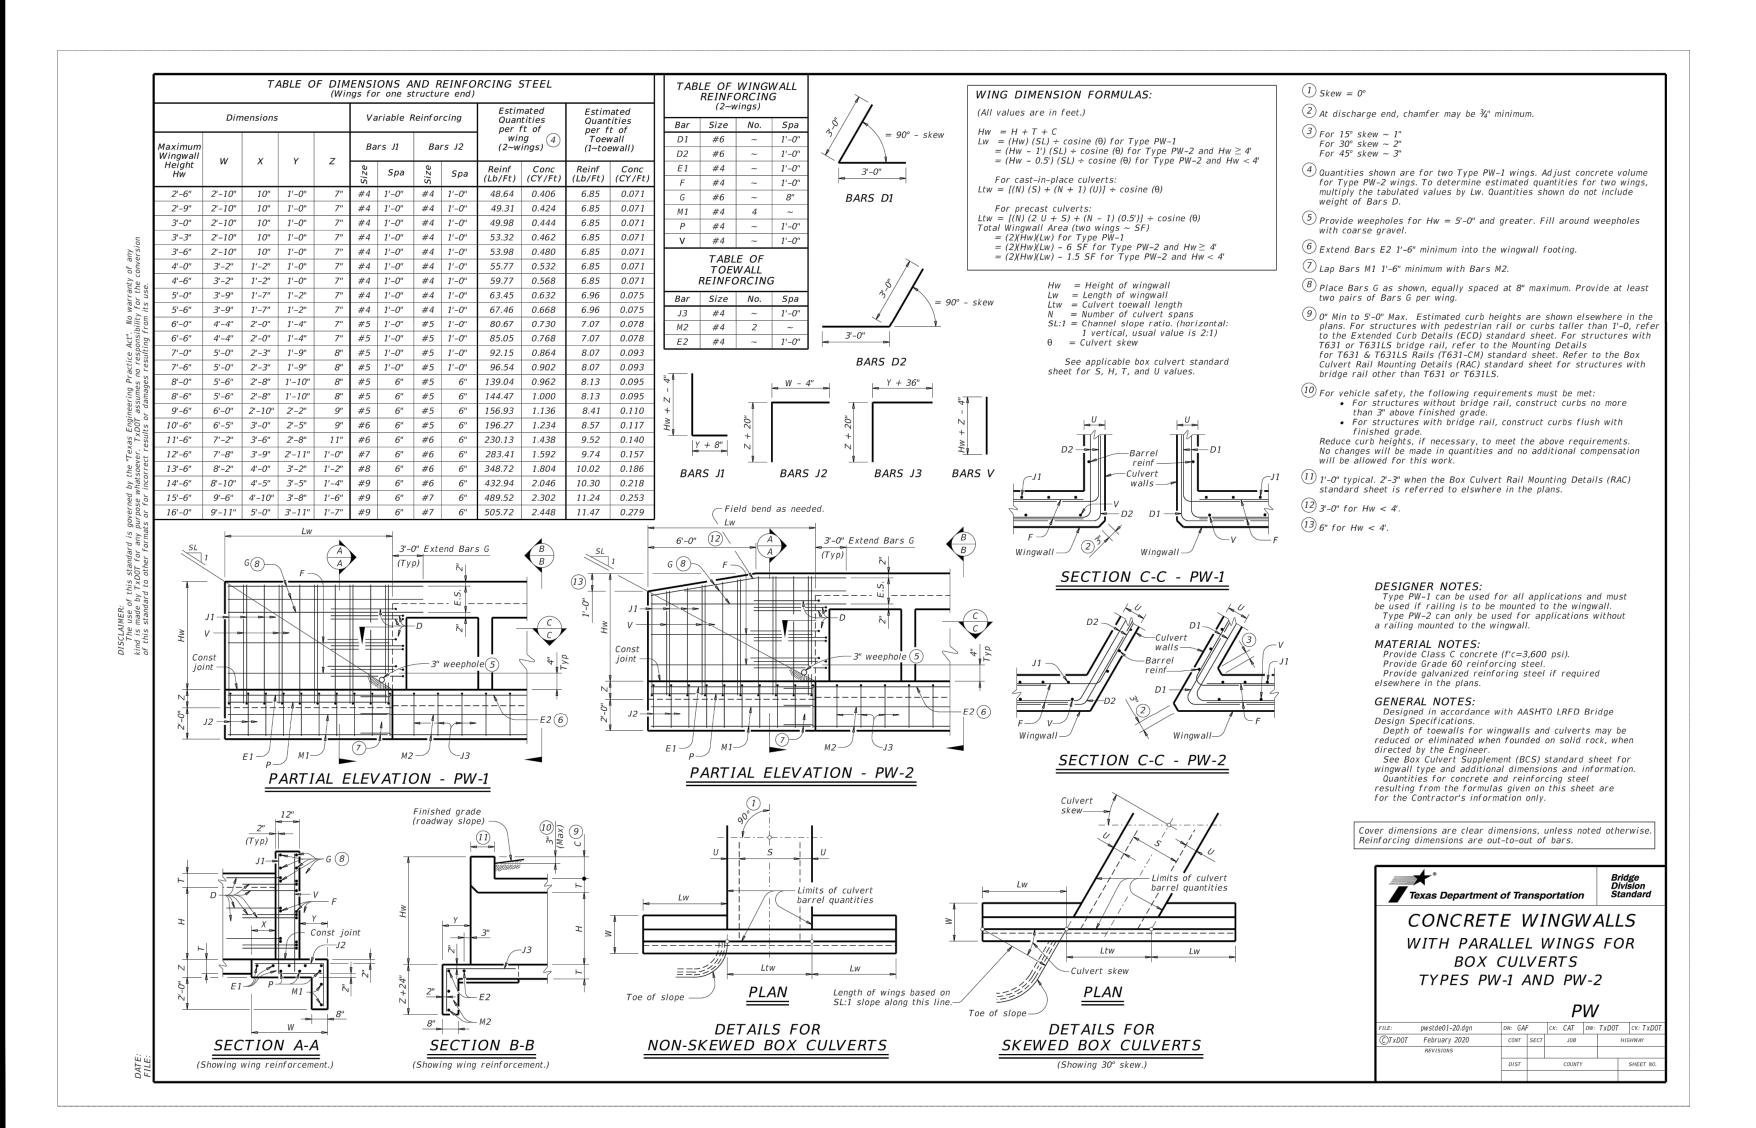
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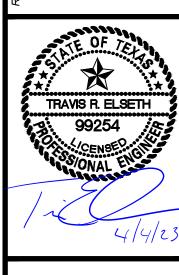
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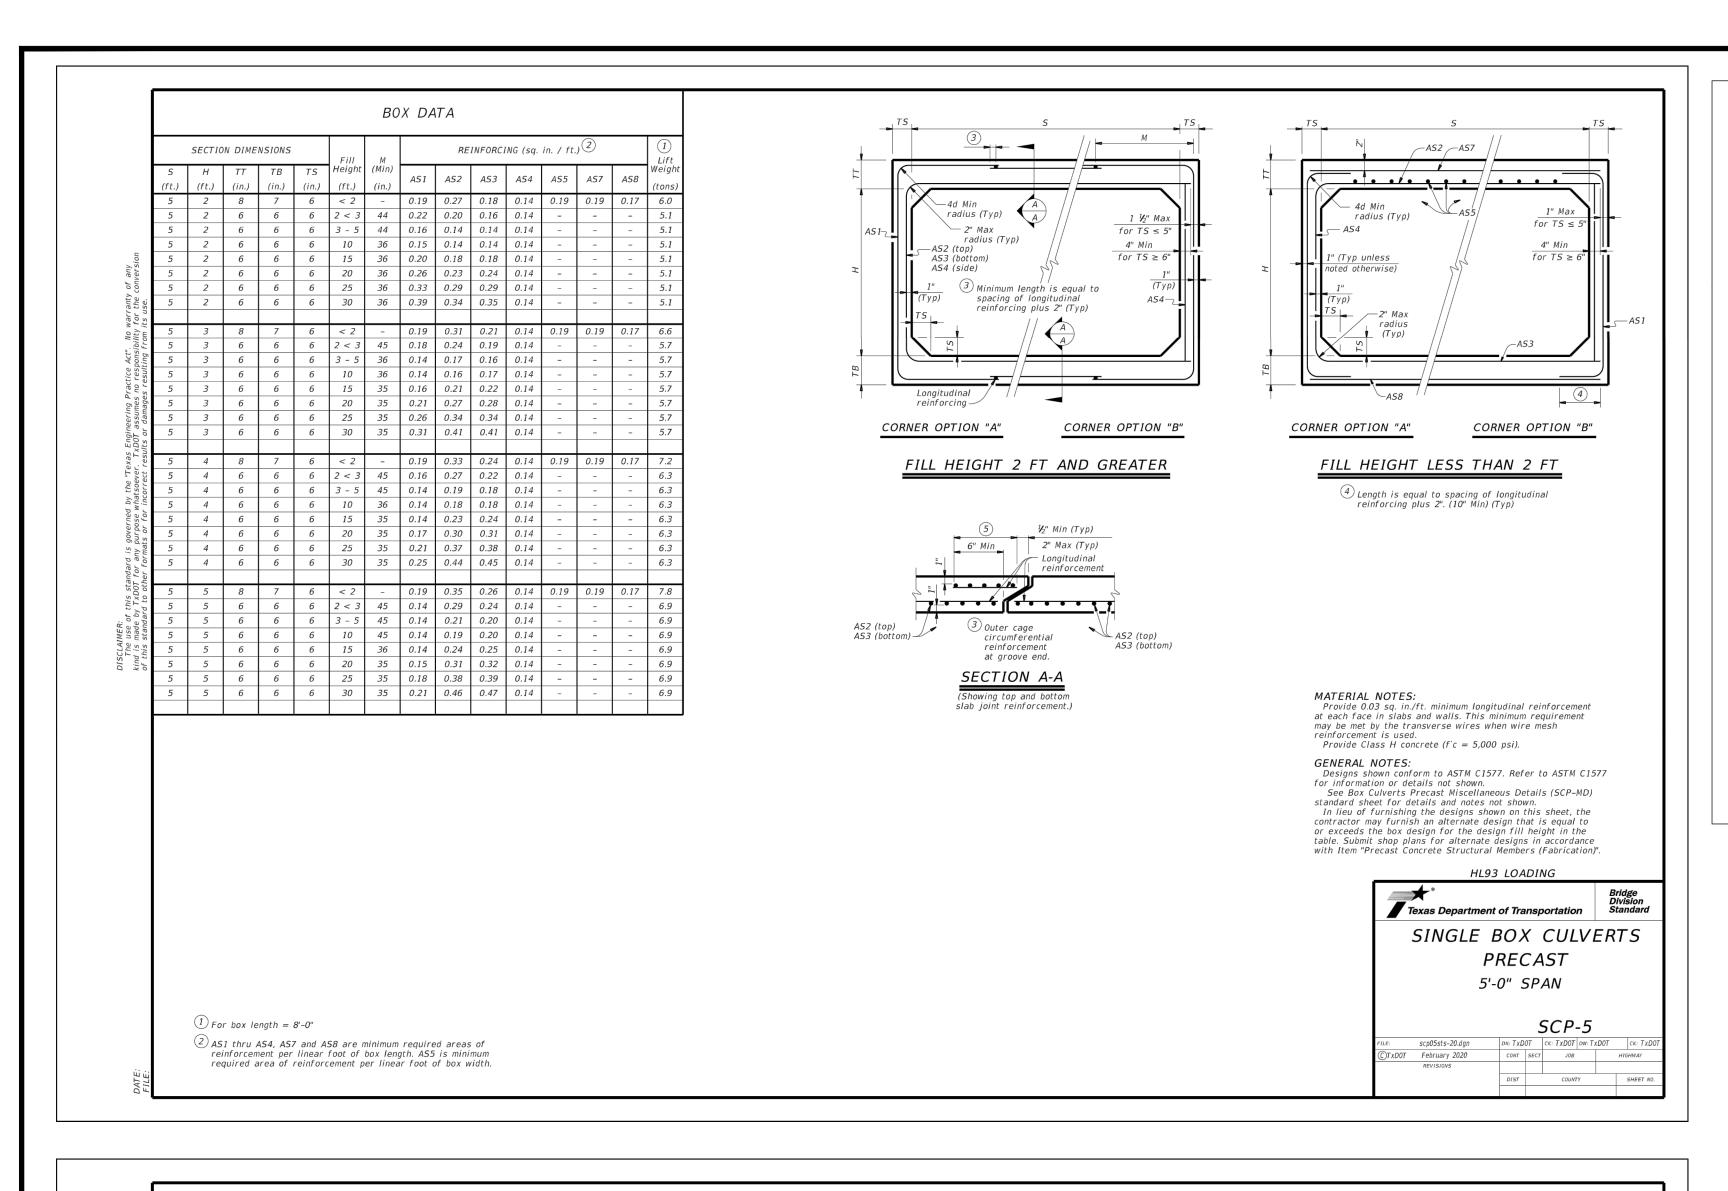
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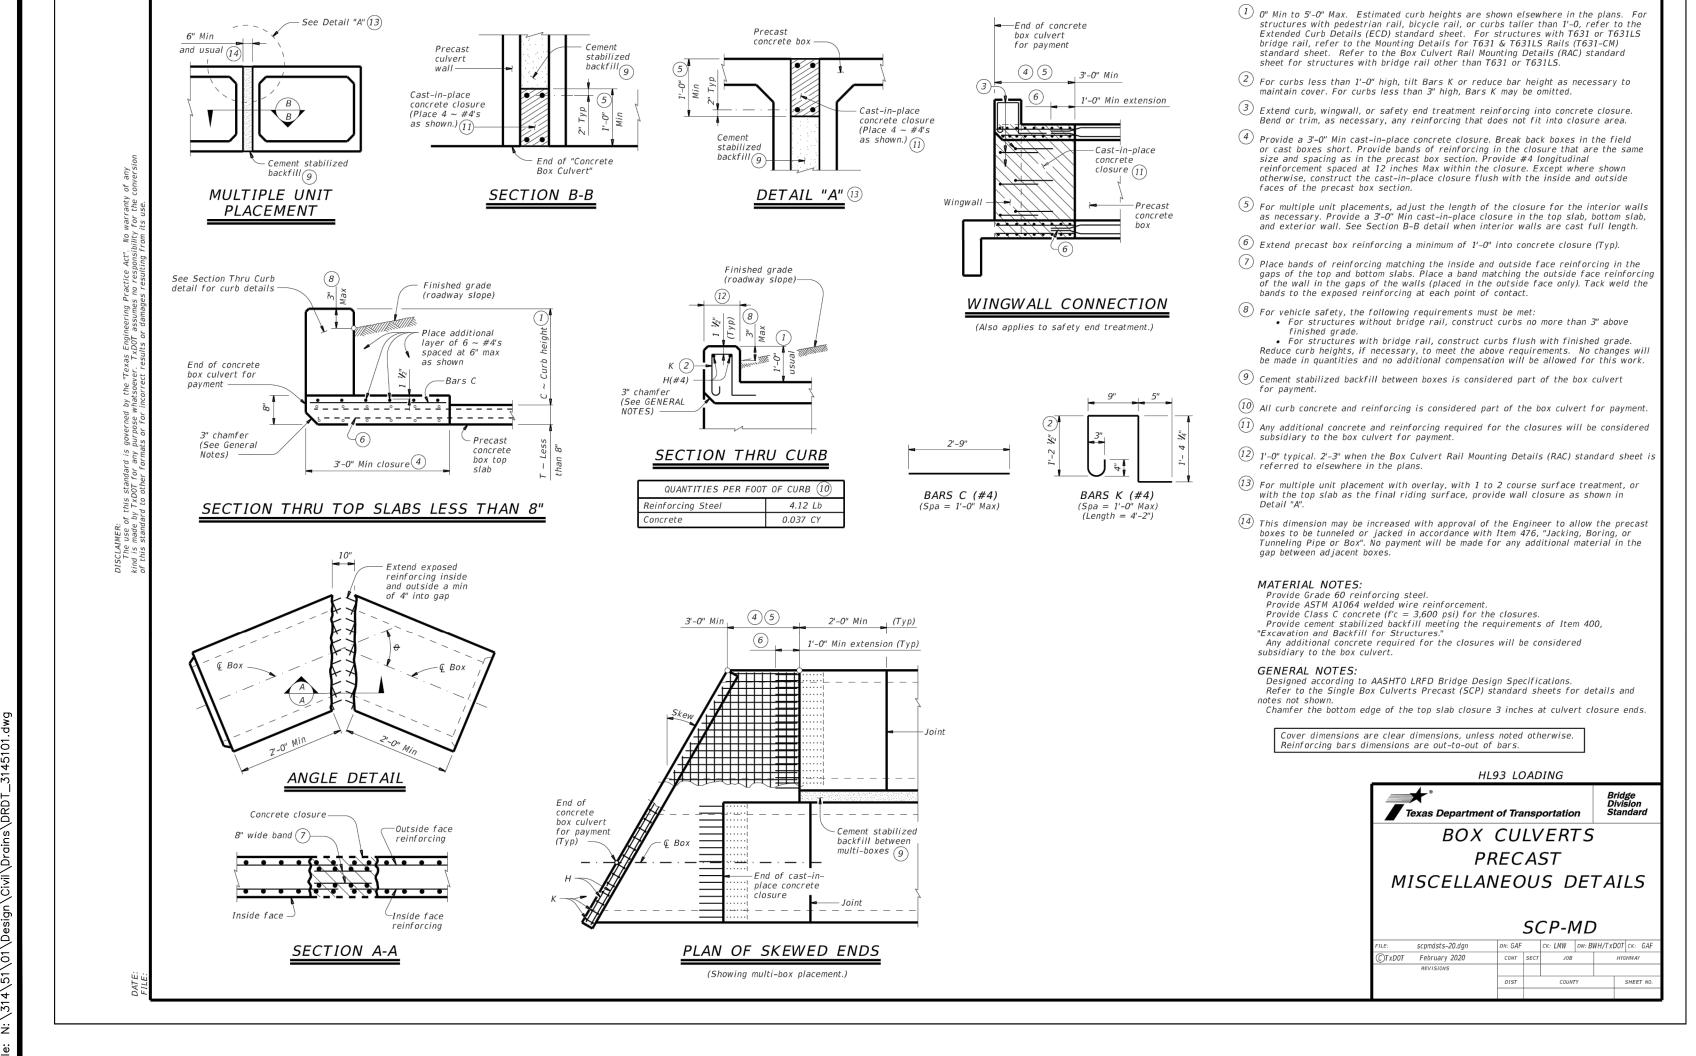
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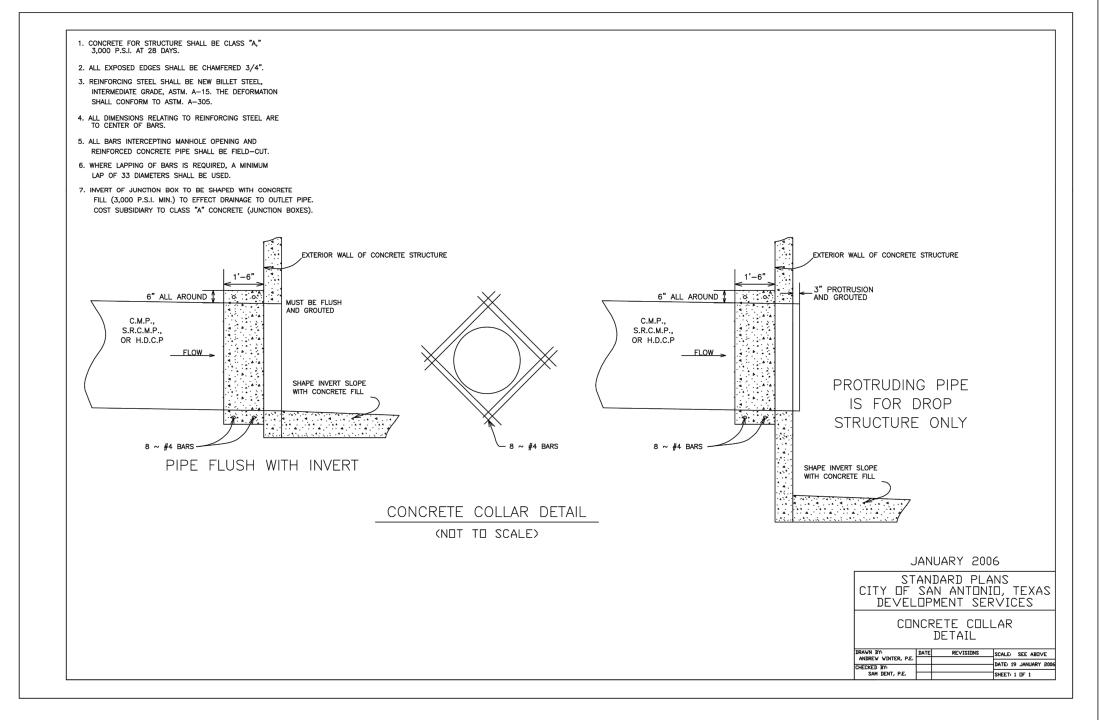
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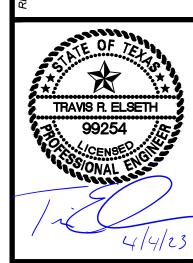


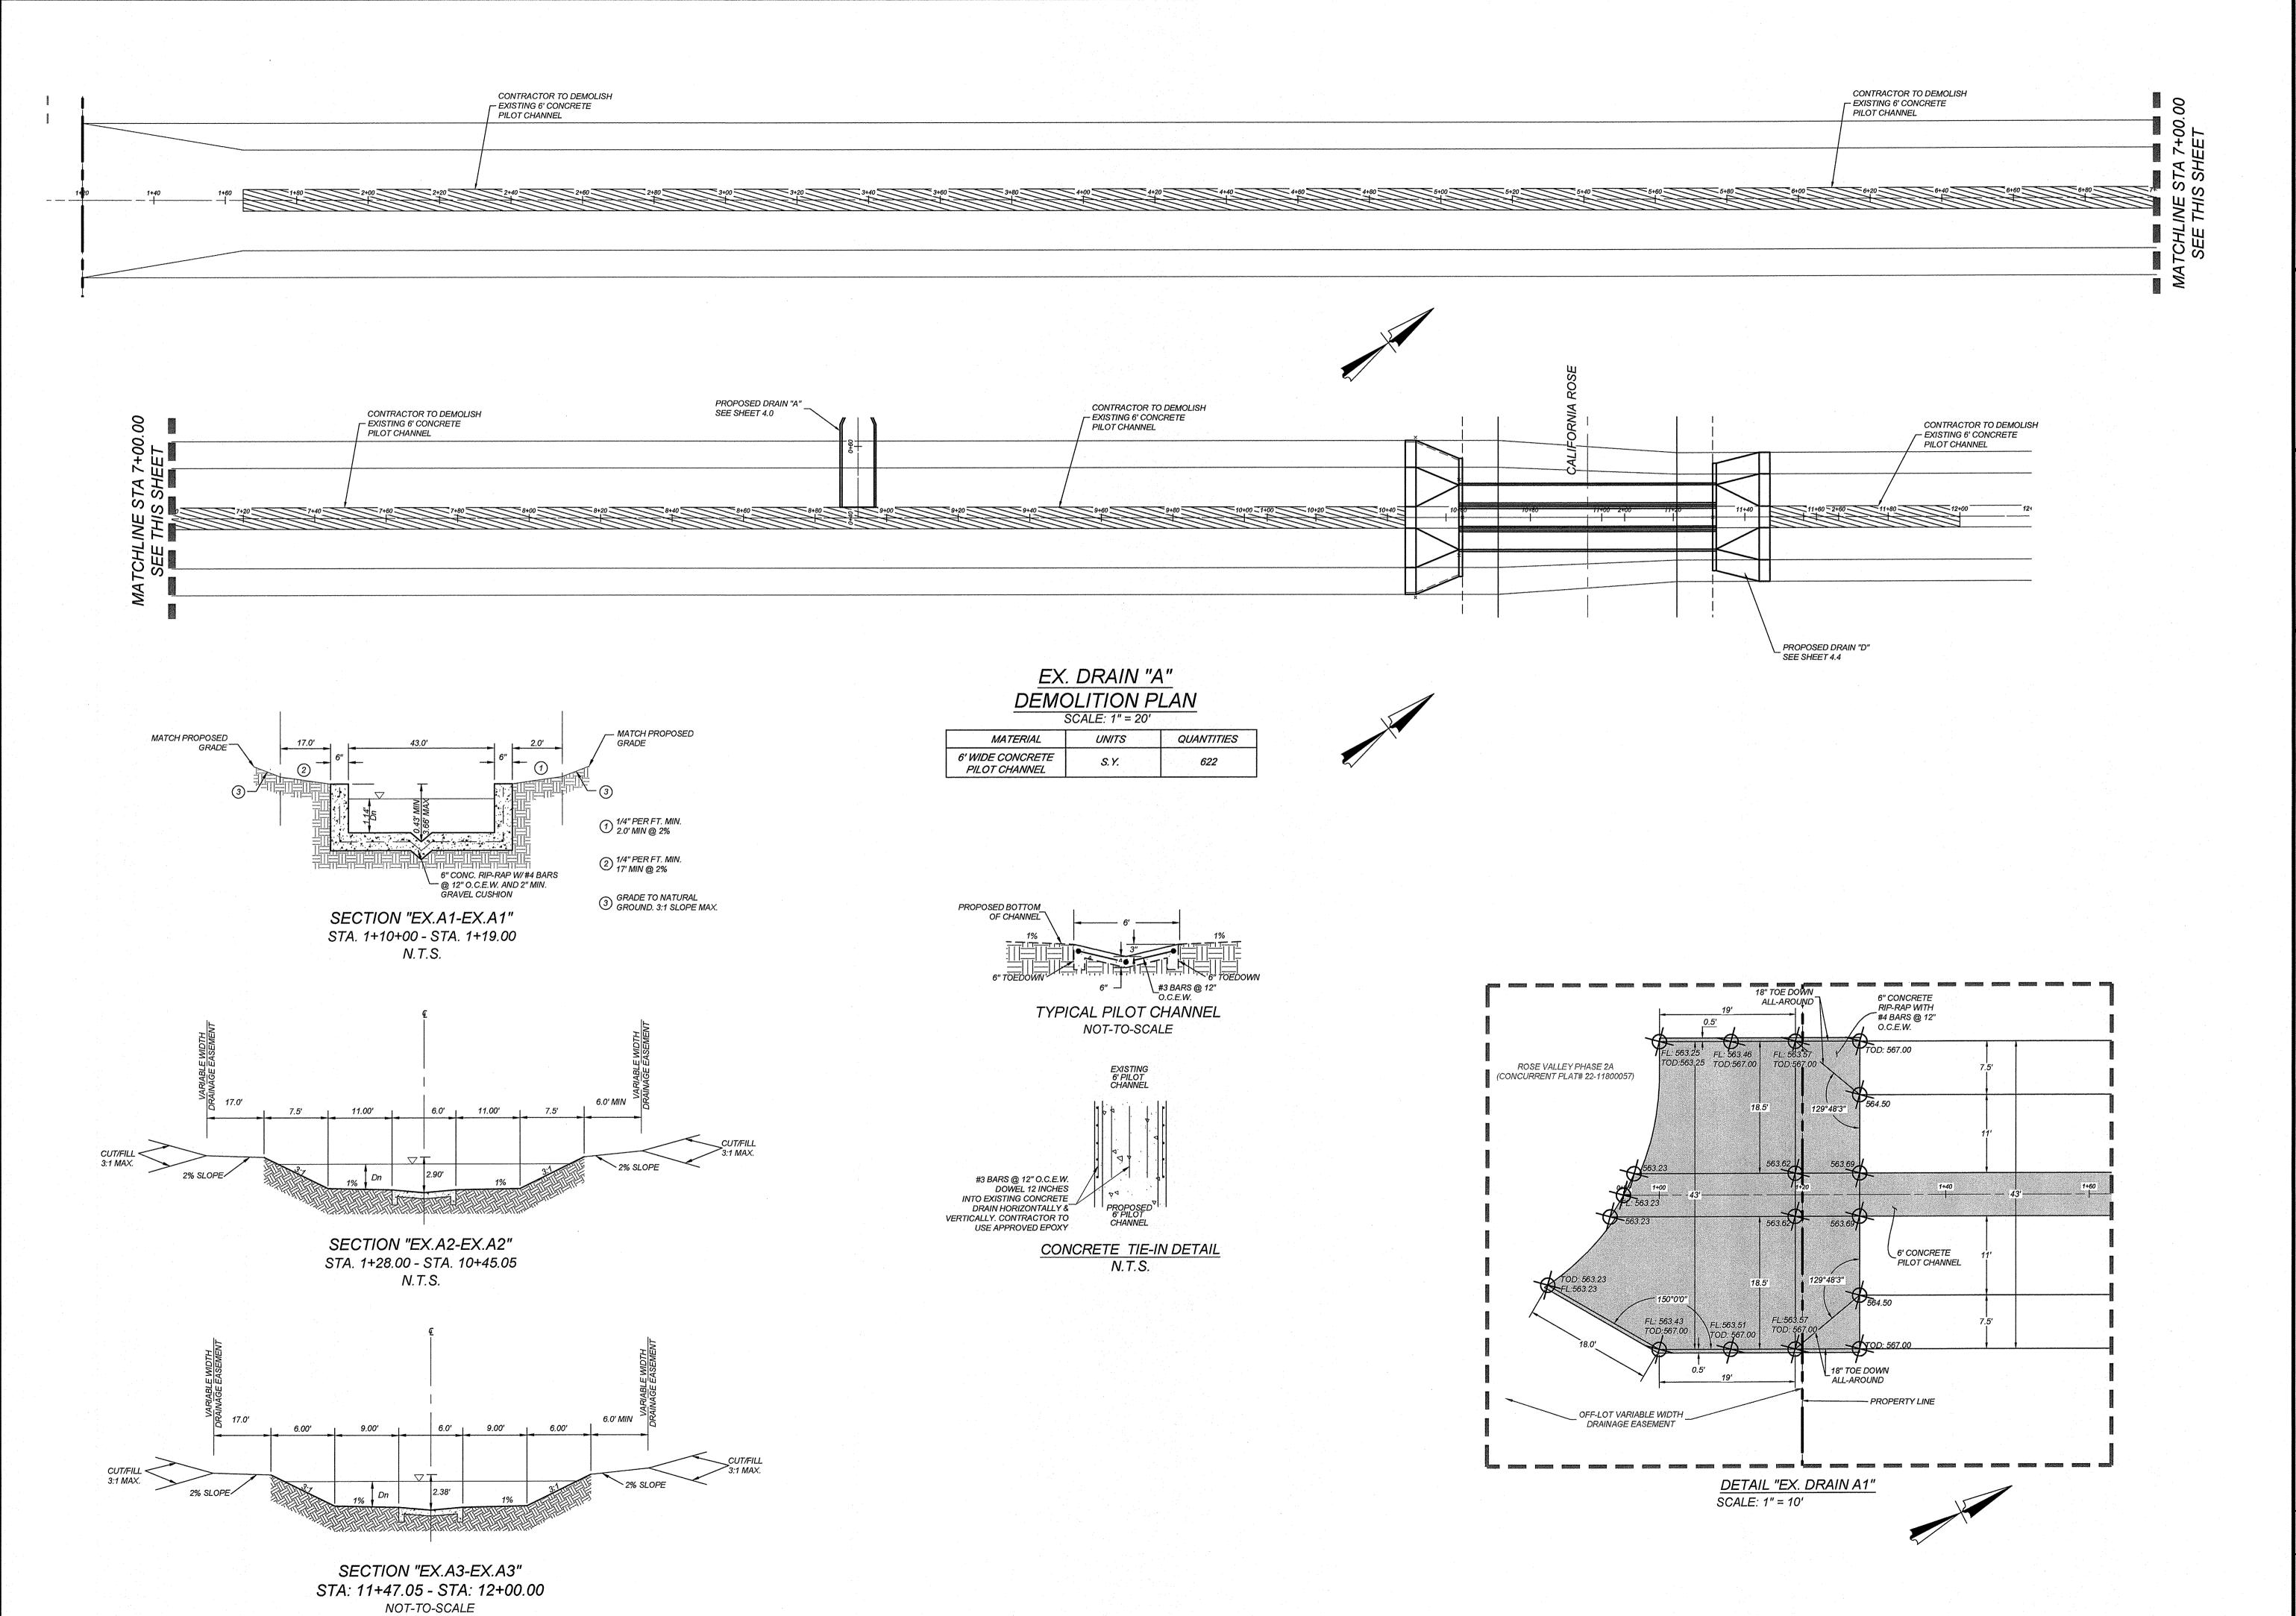



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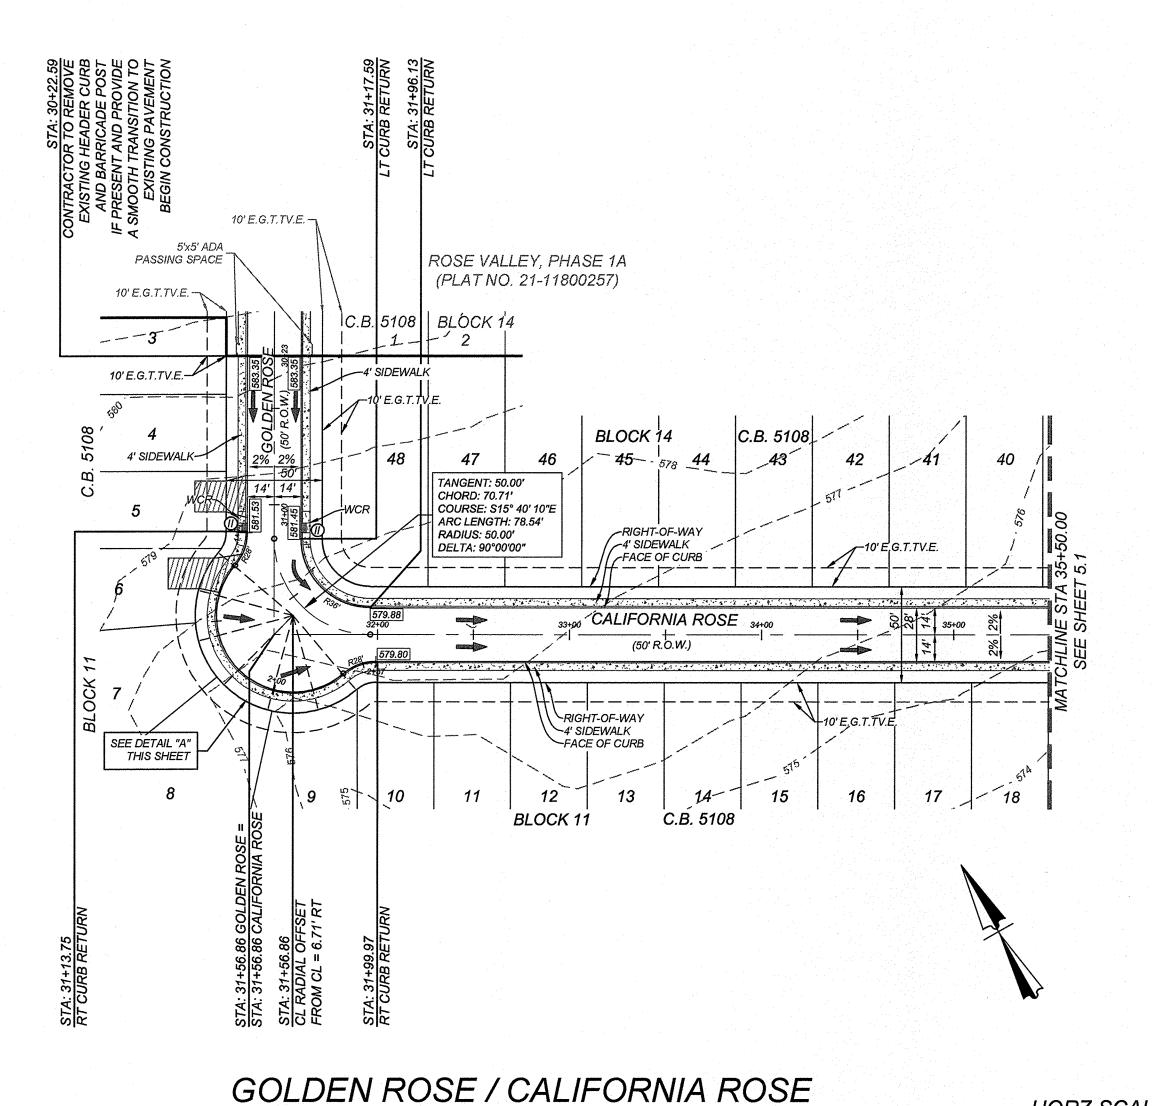
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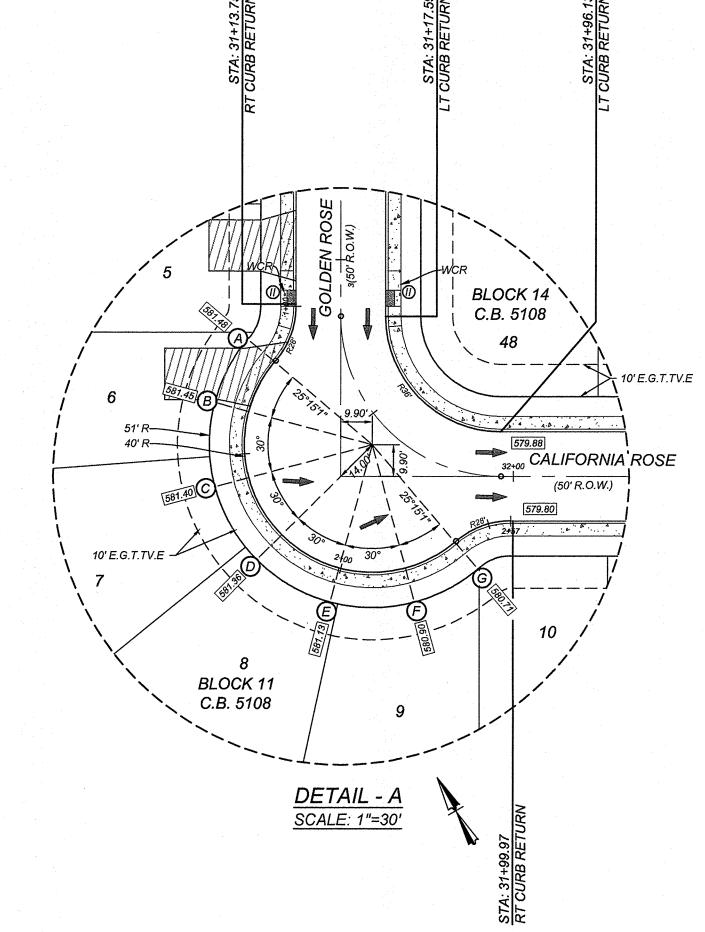
CONTRACTOR AND/OR CONTRACTOR'S INDEPENDENTLY RETAINED EMPLOYEE OR STRUCTURA DESIGN/GEOTECHNICAL/SAFETY/EQUIPMENT CONSULTANT, IF ANY, SHALL REVIEW THESE PLANS AND AVAILABLE GEOTECHNICAL INFORMATION AND THE ANTICIPATED INSTALLATION SITES WITHIN THE PROJECT WORK AREA IN ORDER TO IMPLEMENT CONTRACTOR'S TRENCH EXCAVATION SAFETY PROTECTION SYSTEMS, PROGRAMS AND/OR PROCEDURES. THE SHALL PROVIDE FOR ADEQUATE TRENCH EXCAVATION SAFETY PROTECTION THAT COMPLIES WITH AS A MINIMUM, OSHA STANDARDS FOR TRENCH EXCAVATIONS. SPECIFICALLY, CONTRACTOR AND/OR CONTRACTOR'S INDEPENDENTLY RETAINED EMPLOYEE OR SAFETY CONSULTANT SHALL IMPLEMENT A TRENCH SAFETY PROGRAM IN ACCORDANCE WITH OSHA STANDARDS GOVERNING THE PRESENCE AND ACTIVITIES OF INDIVIDUALS WORKING IN AND AROUND TRENCH EXCAVATION.


R.O.W.

INCLUDING BUT NOT LIMITED TO: WATER, SEWER, TELEPHONE AND FIBER OPTIC LINES, SITE LIGHTING ELECTRIC, SECONDARY ELECTRIC, PRIMARY ELECTRICAL DUCTBANKS, LANDSCAPE IRRIGATION FACILITIES, AND GAS LINES. ANY UTILITY CONFLICTS THAT ARISE SHOULD BE CONTRACTOR SHALL CONTACT 1-800-DIG-TESS A MINIMUM OF 48 HOURS PRIOR TO THE START OF CONSTRUCTION. ANY DAMAGE TO EXISTING UTILITIES SHALL BE THE SOLE RESPONSIBILITY OF THE CONTRACTOR AND THE REPAIR SHALL BE AT CONTRACTOR'S SOLE EXPENSE WHETHER THE UTILITY IS SHOWN ON THESE PLANS OR NOT.

A BEXAR COUNTY PERMIT MUST BE OBTAINED BEFORE WORKING IN BEXAR COUNTY





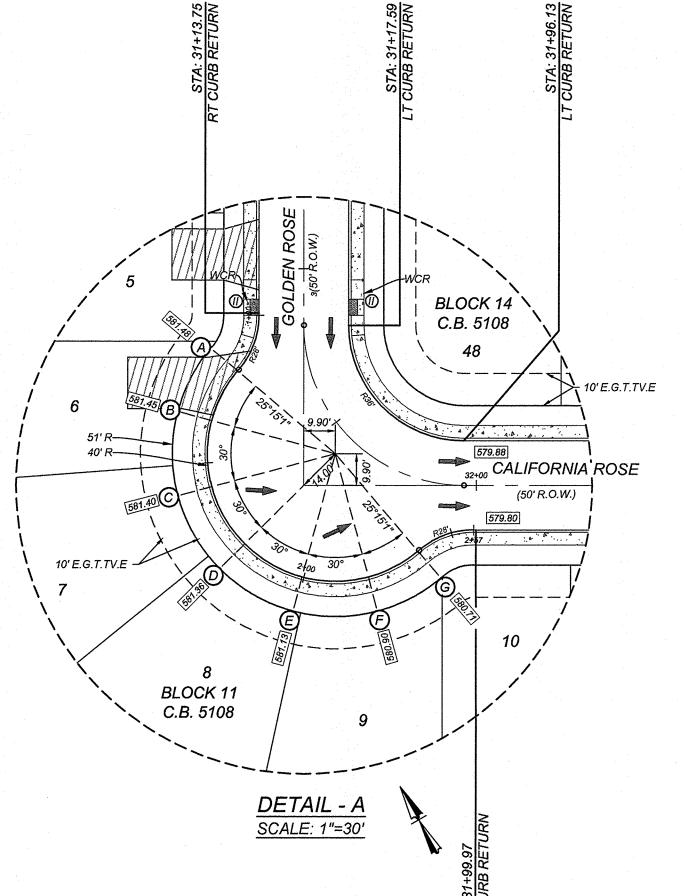

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S.D.W.C.R. = SINGLE DIRECTIONAL WHEEL CHAIR RAMP D.D.W.C.R. = DOUBLE DIRECTIONAL WHEEL CHAIR RAMP

LEGEND

= FLOW ARROW

= WASHOUT CROWN

V.N.A.E. = VEHICULAR NON-ACCESS EASEMENT

= WHEELCHAIR RAMP TYPE II

SEE SHEET 5.7

SEE SHEET 5.7

SEE SHEET 5.7

SEE SHEET 5.7

\*\*\*\*\*\*\*\*\*\*\*\*\* = SIDEWALK TO BE CONSTRUCTED

732.87 = TOP OF CURB ELEVATIONS

BY DEVELOPER.


= SIDEWALK TO BE BUILT AT THE TIME

OF HOME CONSTRUCTION

= PROPOSED DRIVEWAY LOCATIONS

E.G.T.TV.E. = ELECTRIC, GAS, TELEPHONE & CABLE EASEMENT

W.C.R. = WHEELCHAIR RAMPS

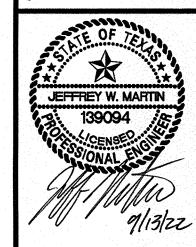

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PLAT NO. 22-11800056

JOB NO. 314-51-01 DRAWN:SD CHECKED:JM SHEET NUMBER:

HORZ SCALE: 1"=50' STA: 30+22.59 - 35+50.00 EXIST. LT & RT TOP OF CURB 585 580 VERIFY EXISTING TOP OF CURB ELEVATIONS PRIOR TO THE START OF CONSTRUCTION 575 & NOTIFY PROPOSED FILL IMMEDIATELY OF ANY AT 95% MIN NATURAL GROUND LT. NATURAL GROUND CL. DISCREPANCIES COMPACTED DENSITY NATURAL GROUND RT. 570 570 565 560

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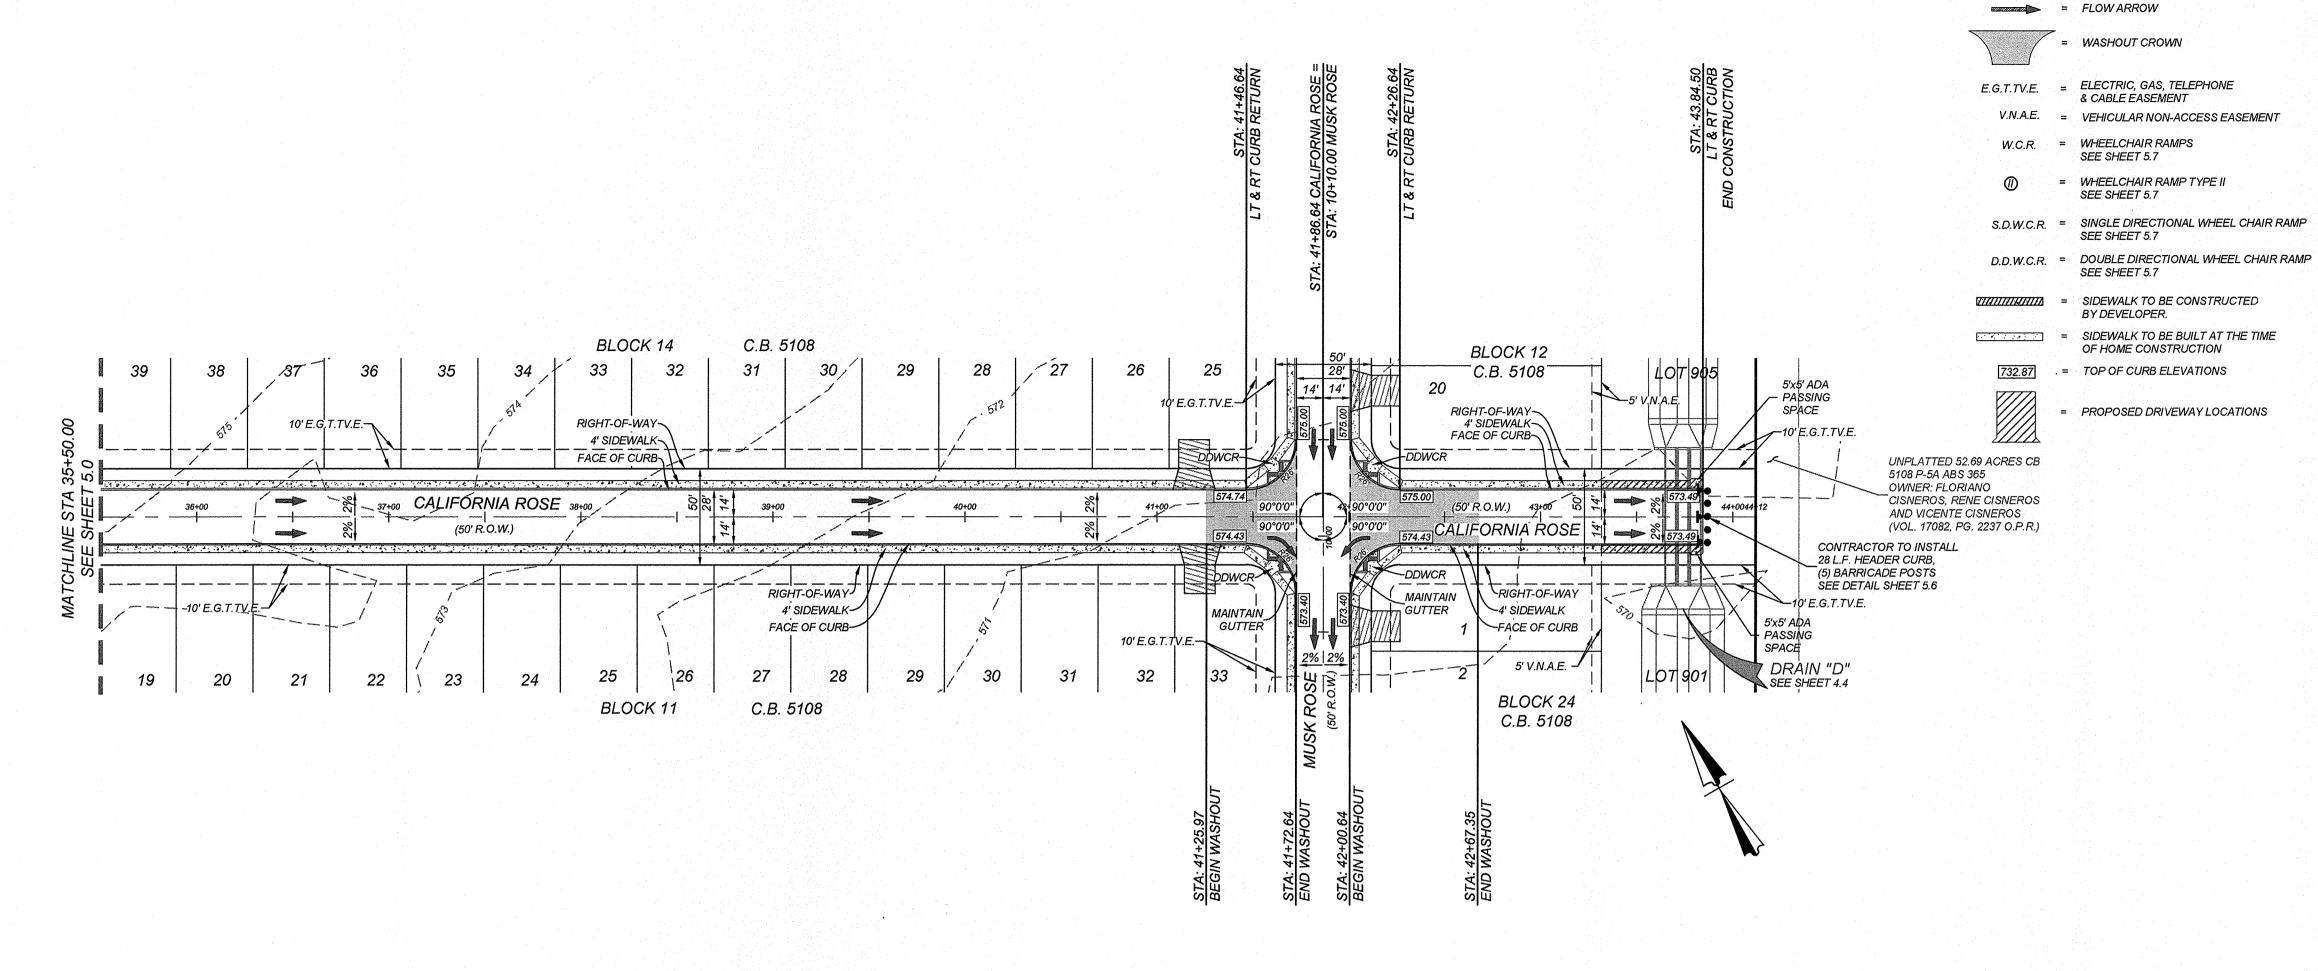
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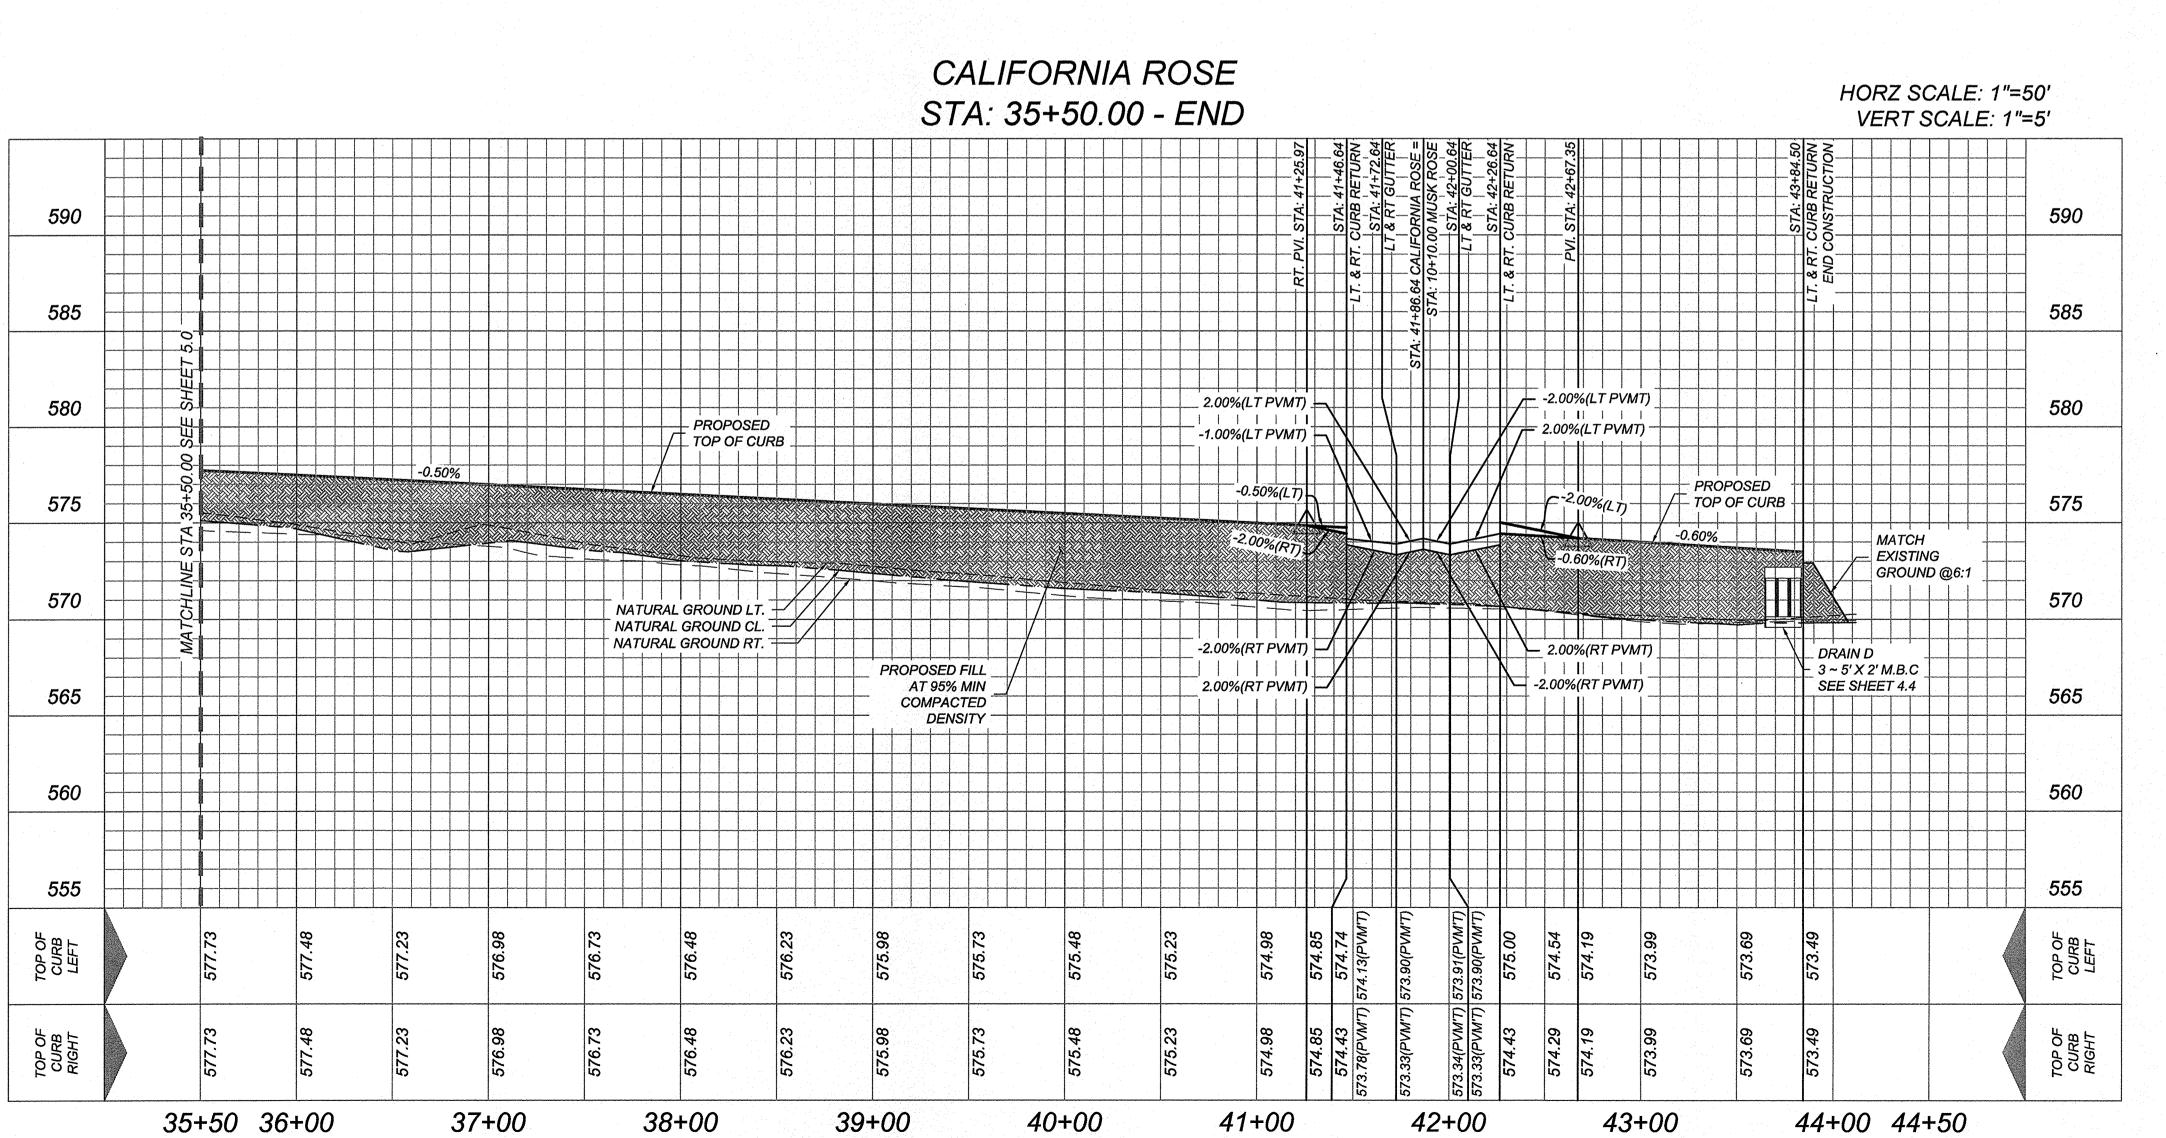
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### BEXAR COUNTY R.O.W. NOT


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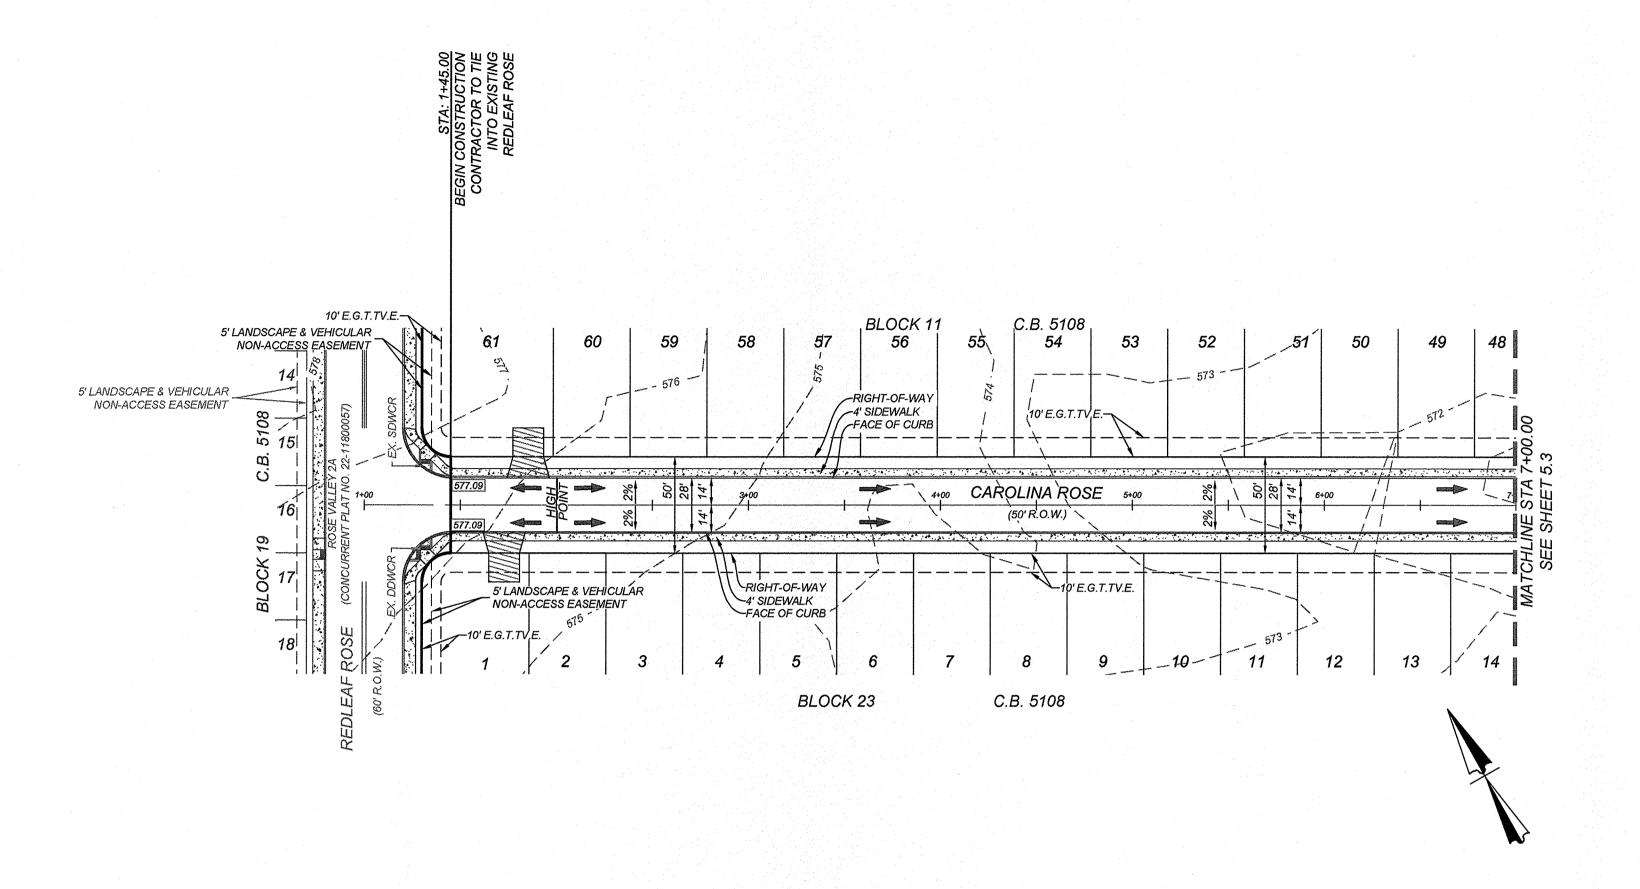
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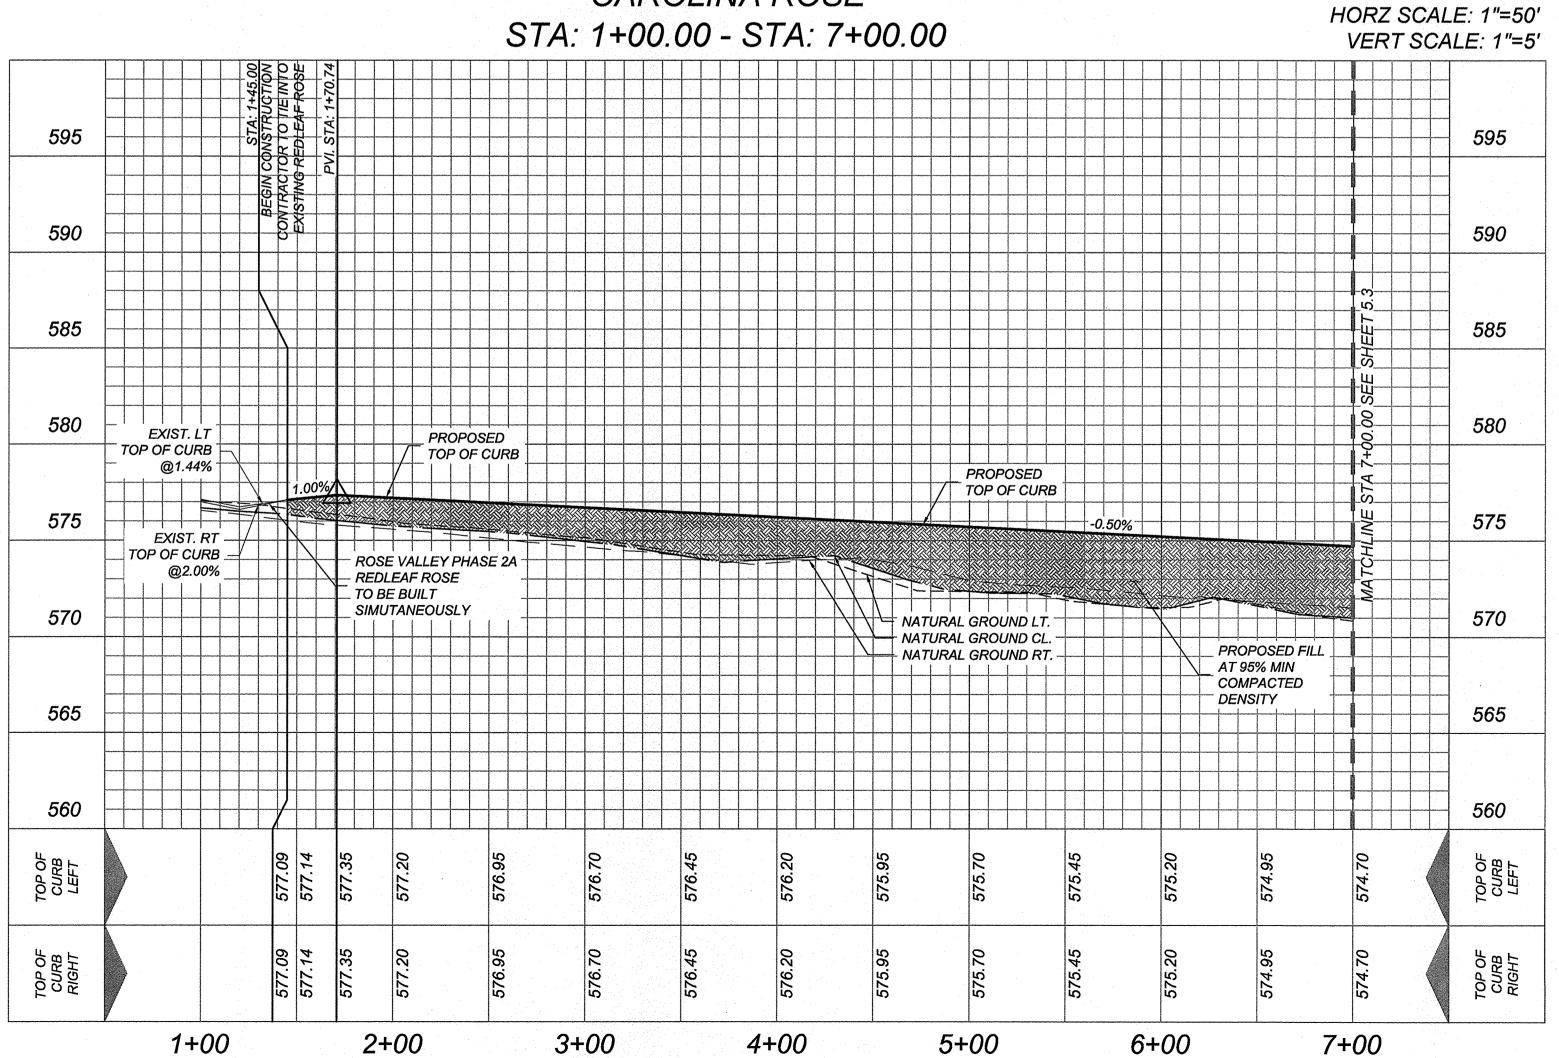
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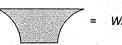


CAROLINA ROSE



LEGEND

= FLOW ARROW = WASHOUT CROWN

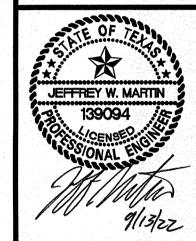

E.G.T.TV.E. = ELECTRIC, GAS, TELEPHONE & CABLE EASEMENT

V.N.A.E. = VEHICULAR NON-ACCESS EASEMENT W.C.R. = WHEELCHAIR RAMPS

SEE SHEET 5.7

= WHEELCHAIR RAMP TYPE II SEE SHEET 5.7

S.D.W.C.R. = SINGLE DIRECTIONAL WHEEL CHAIR RAMP SEE SHEET 5.7 D.D.W.C.R. = DOUBLE DIRECTIONAL WHEEL CHAIR RAMP

SEE SHEET 5.7

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= SIDEWALK TO BE BUILT AT THE TIME OF HOME CONSTRUCTION

= TOP OF CURB ELEVATIONS

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= PROPOSED DRIVEWAY LOCATIONS

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PLAT NO. 22-11800056 JOB NO. 314-51-01


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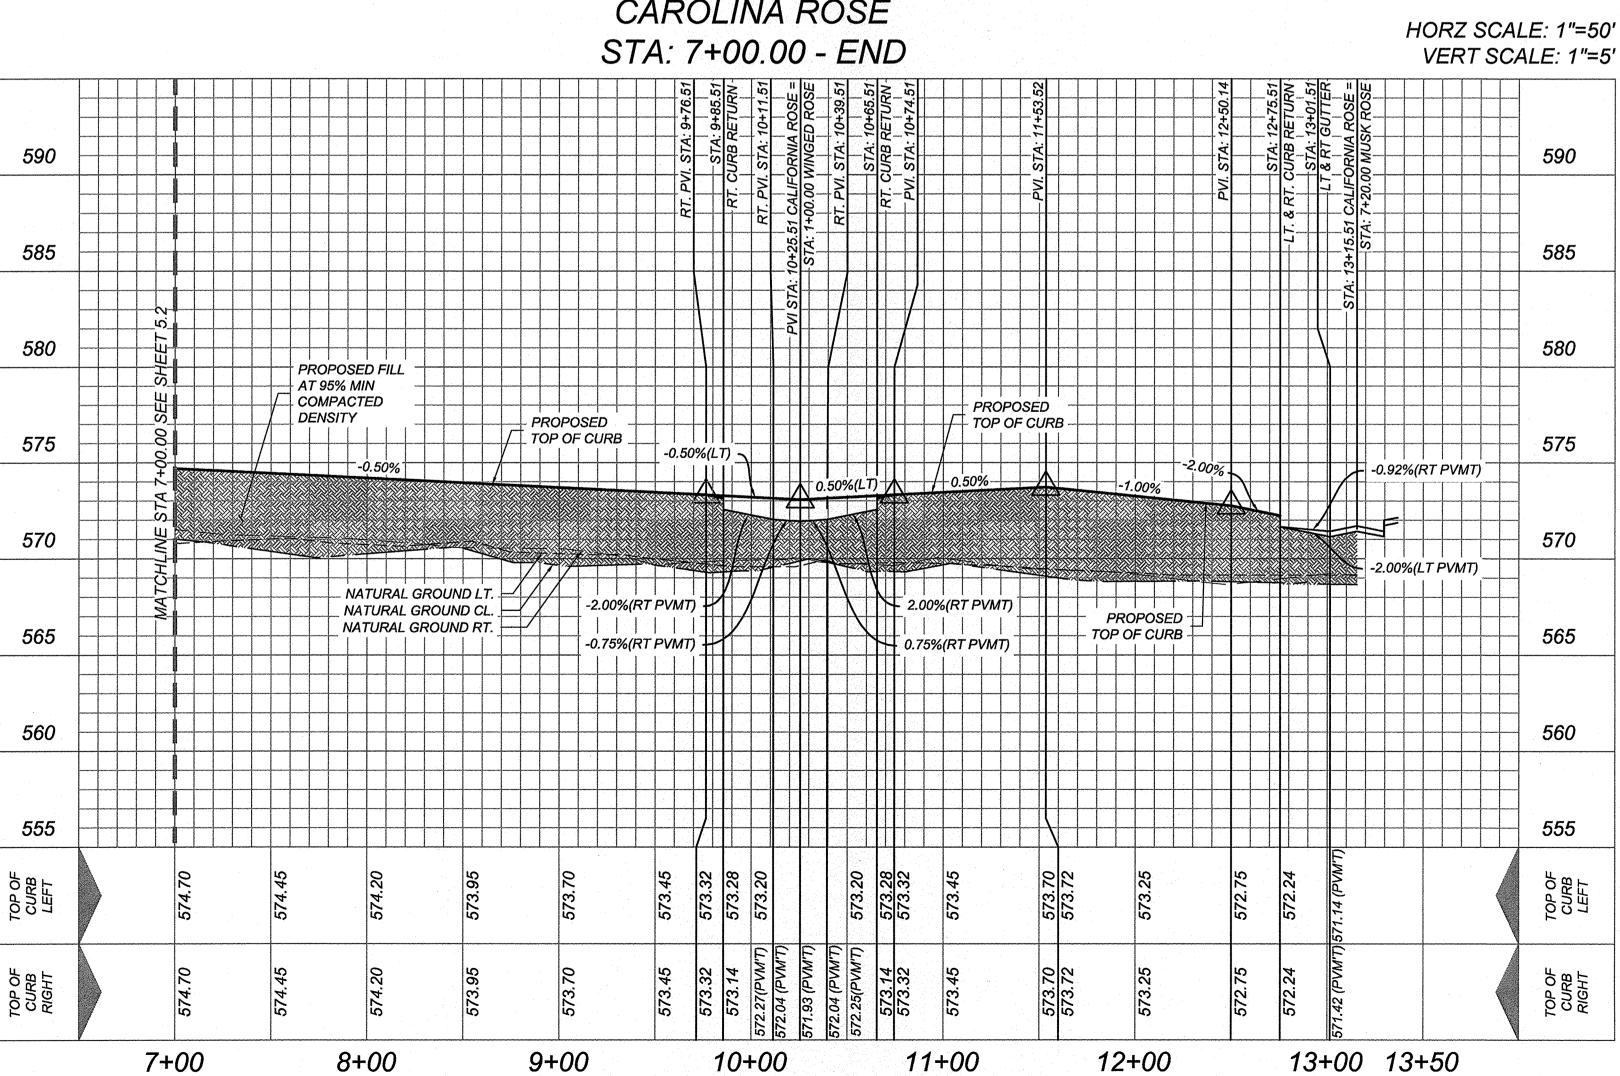
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CAROLINA ROSE



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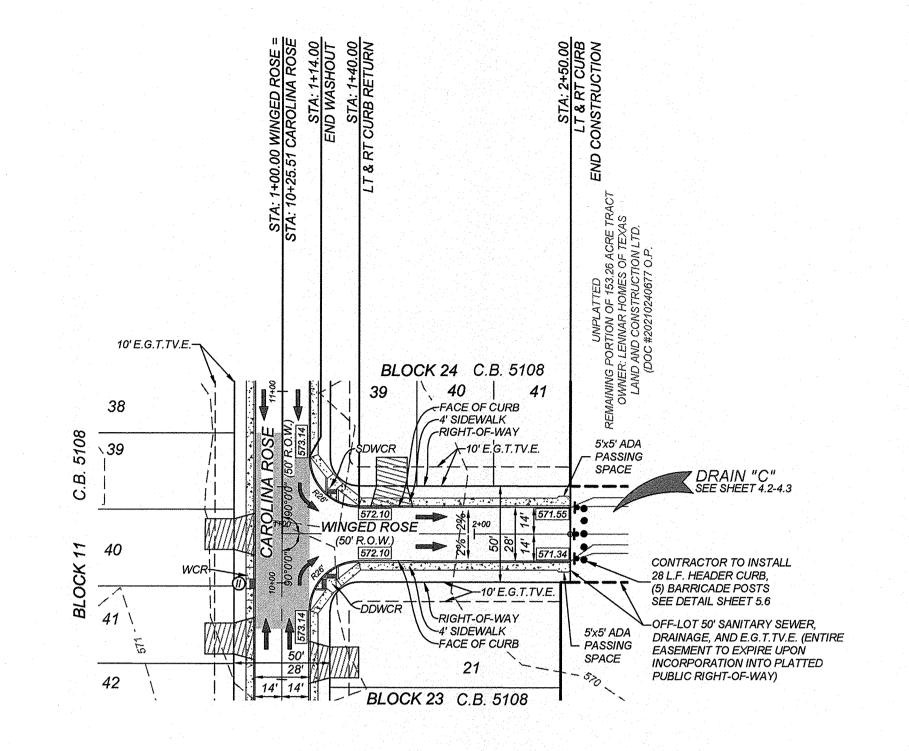
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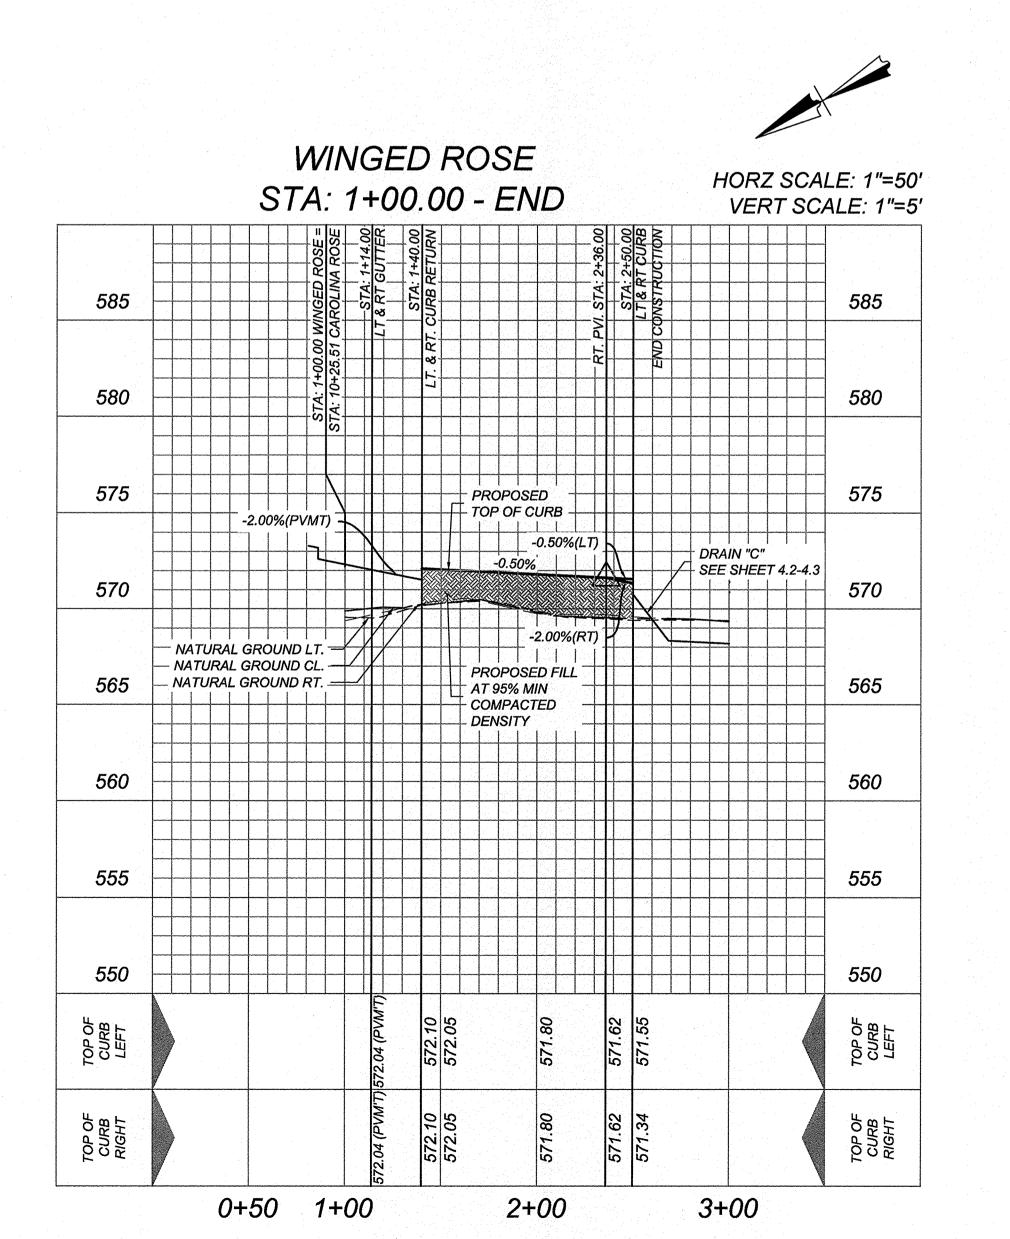
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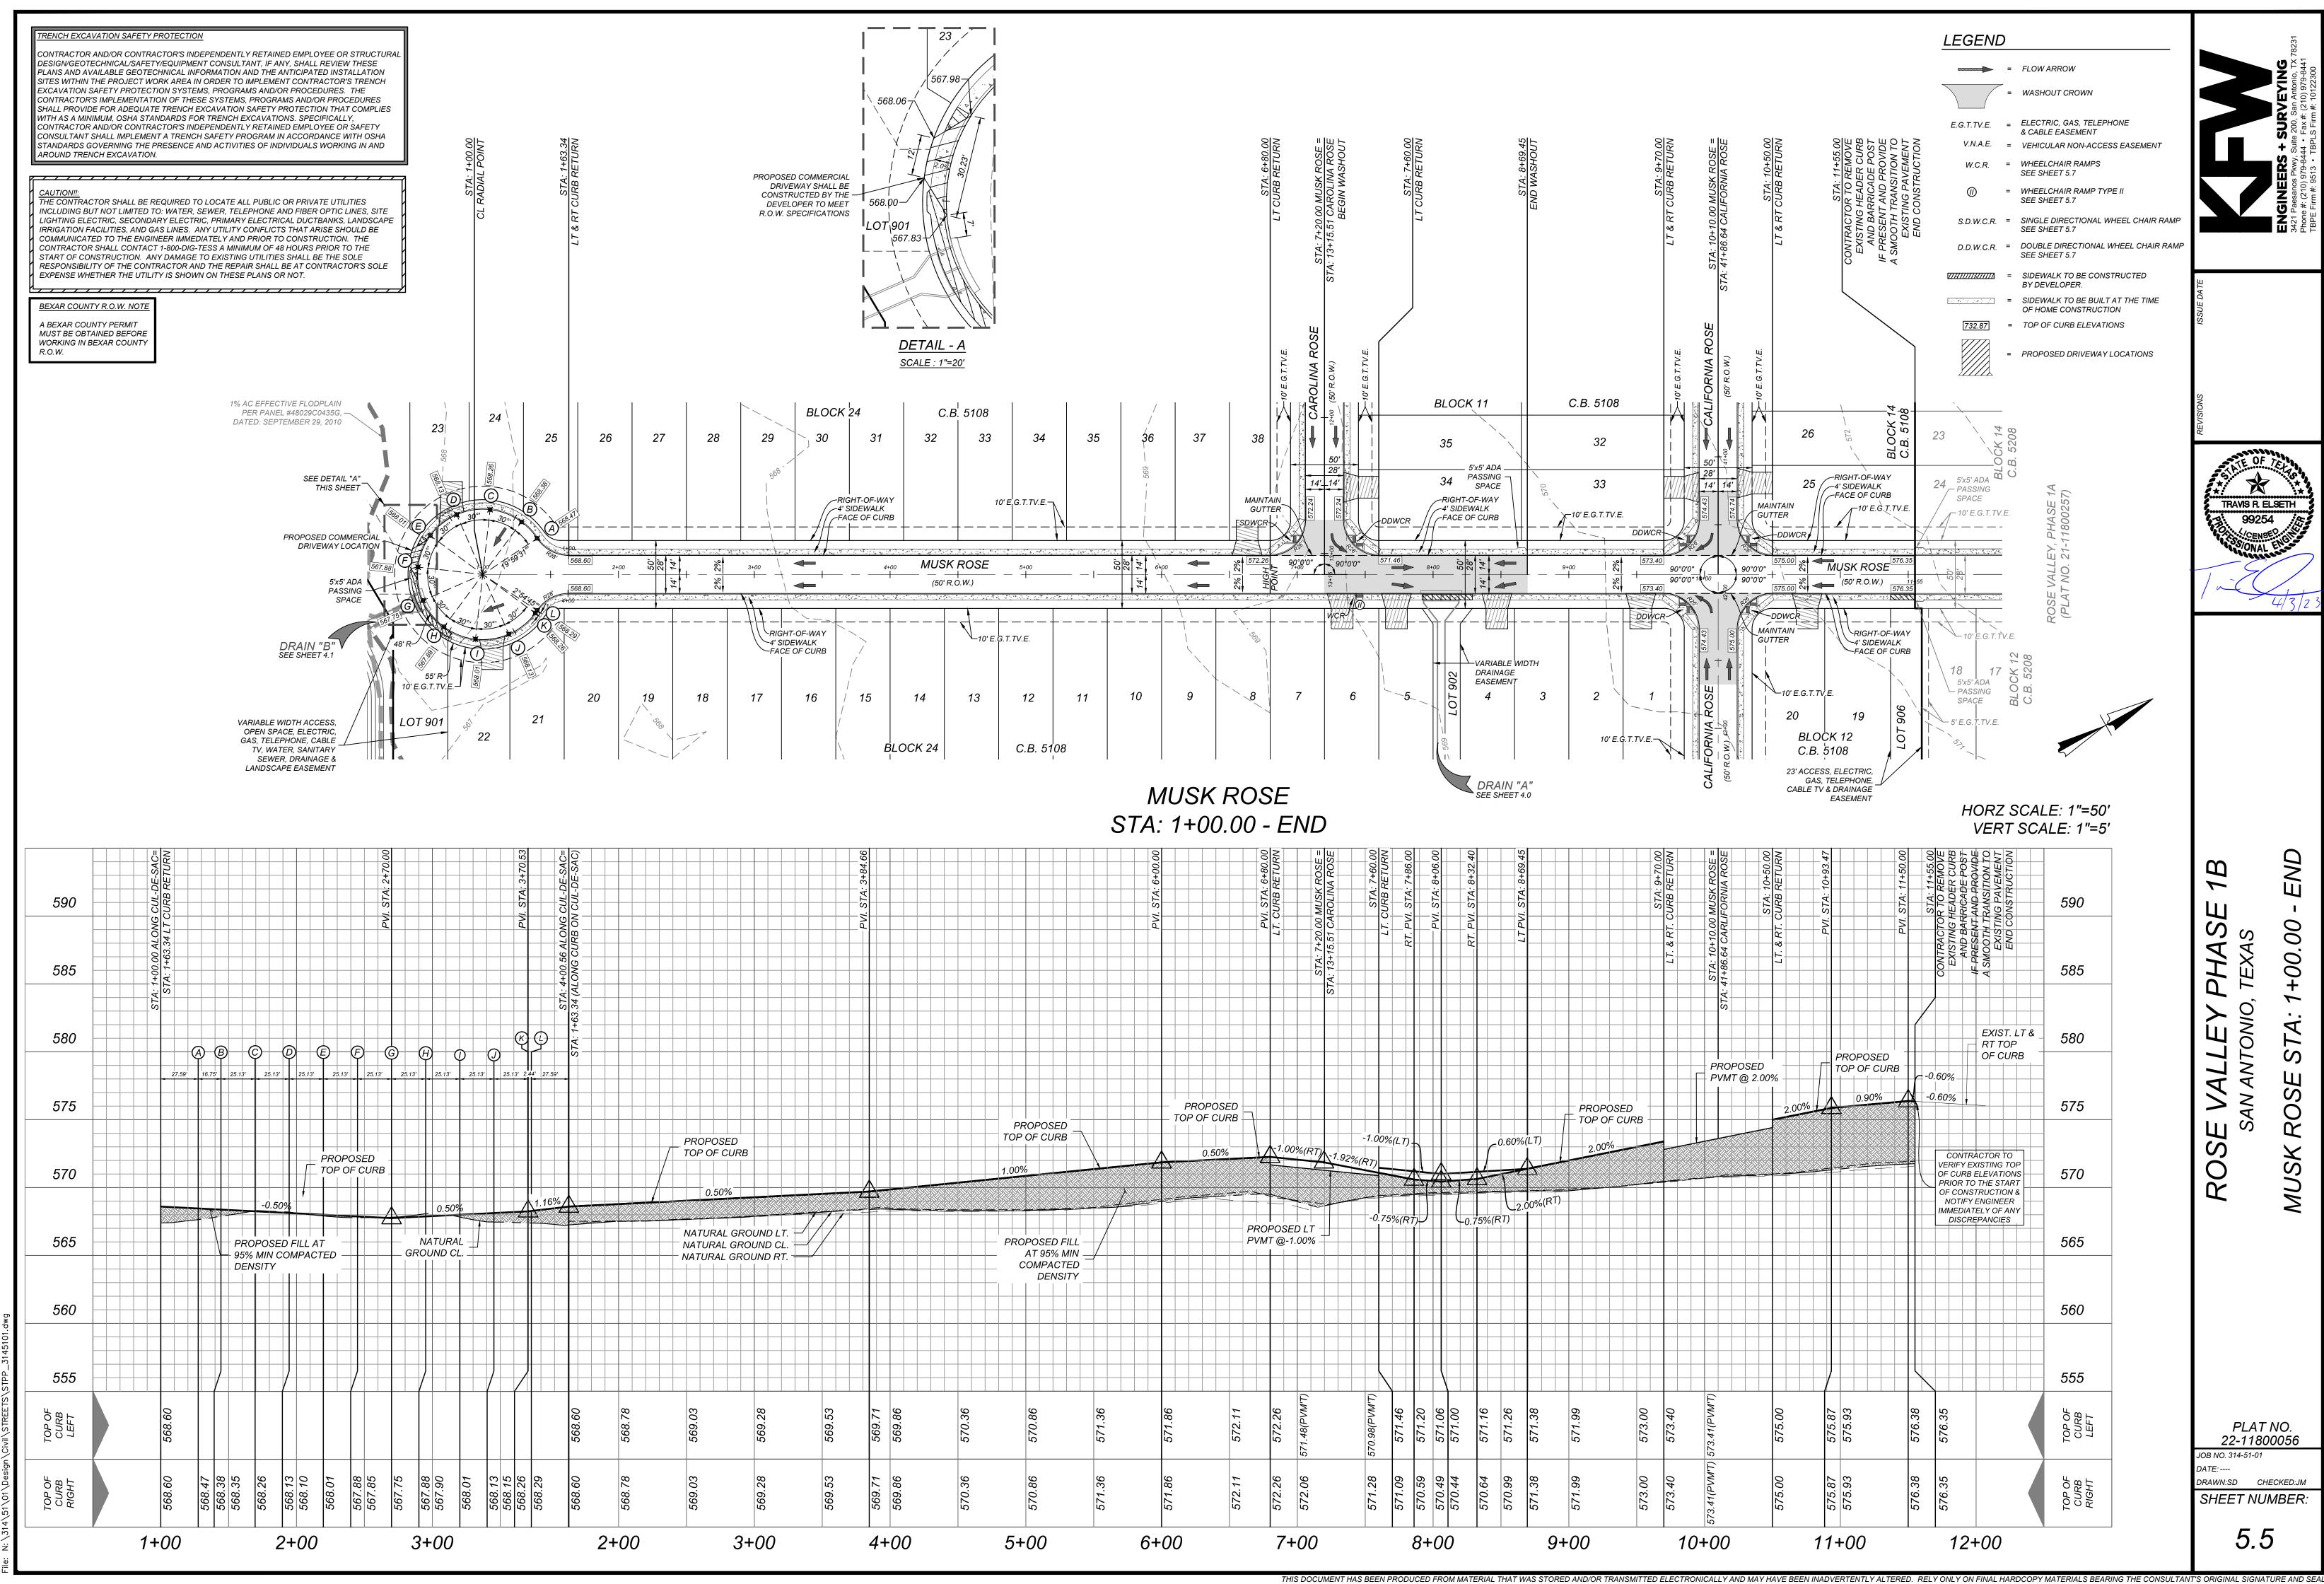
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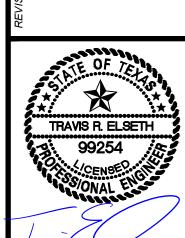
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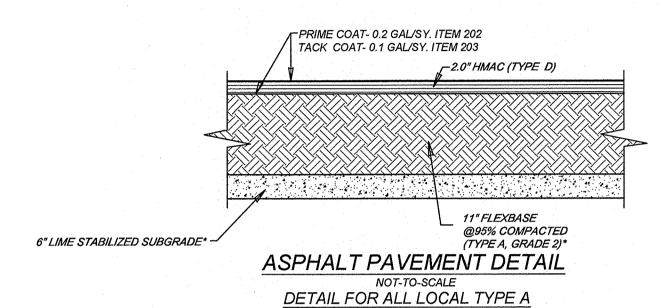
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### TYPICAL LOCAL "A" STREET SECTION

NOT TO SCALE GOLDEN ROSE: STA. 30+22.59 - 31+56.86 CALIFORNIA ROSE: STA: 31+56.86 - END CAROLINA ROSE: STA: 1+00.00 - END WINGED ROSE: STA: 1+00.00 - END MUSK ROSE: STA. 1+00.00 - END

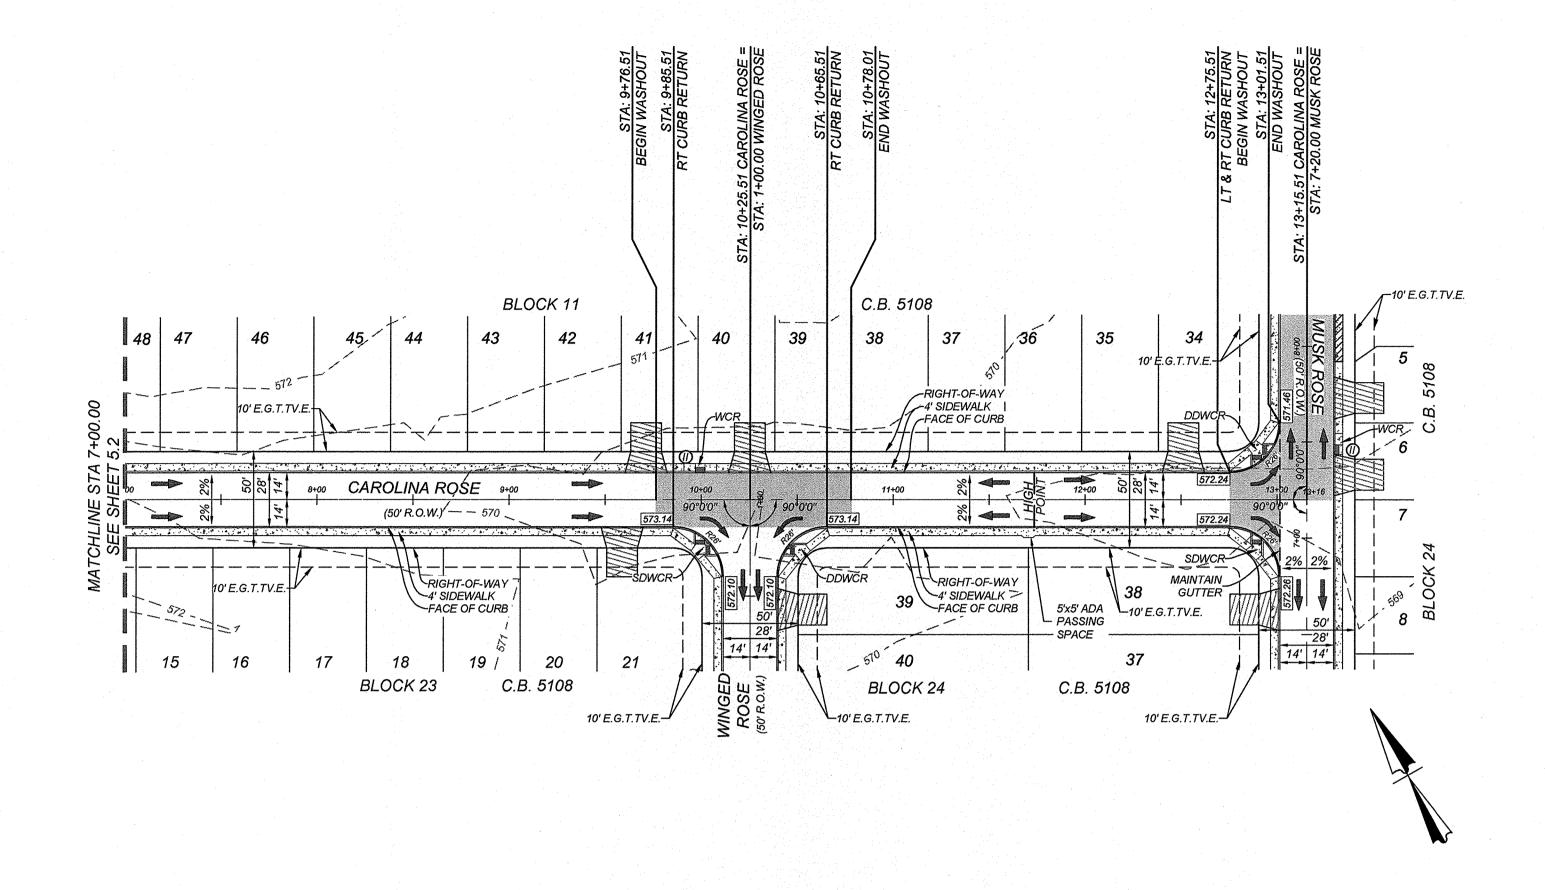

### FLEXIBLE PAVEMENT SYSTEM (DARK BROWN CLAY SUBGRADE)

Pavement Section 2.0" HMAC (TYPE "D")

11" FLEXBASE COURSE (TYPE "A" GRADE 2) 6.0" LIME STABILIZED SUBGRADE (33 LBS/SY) Total: 19"

Structural No: 2.90 C.B.R = 2.0


InTEC PROJECT NO. S211189-2-P JUNE 21, 2021

1. PAVEMENT DESIGN THICKNESS BASED ON GEOTECHNICAL REPORT BY INTEC REPORT NO. S211189-2-P DATED JUNE 21, 2021

2, REFERENCE PROJECT GEOTECHNICAL REPORT AND PROJECT SPECIFICATION FOR ADDITIONAL REQUIREMENTS AND ALTERNATE PAVEMENT SECTIONS.

3. CONTRACTOR SHALL BE RESPONSIBLE FOR COORDINATING MATERIAL TESTING. TESTING TO BE PAID BY OWNER.

4. THERE SHALL BE NO SUBSTITUTION OF LIME.

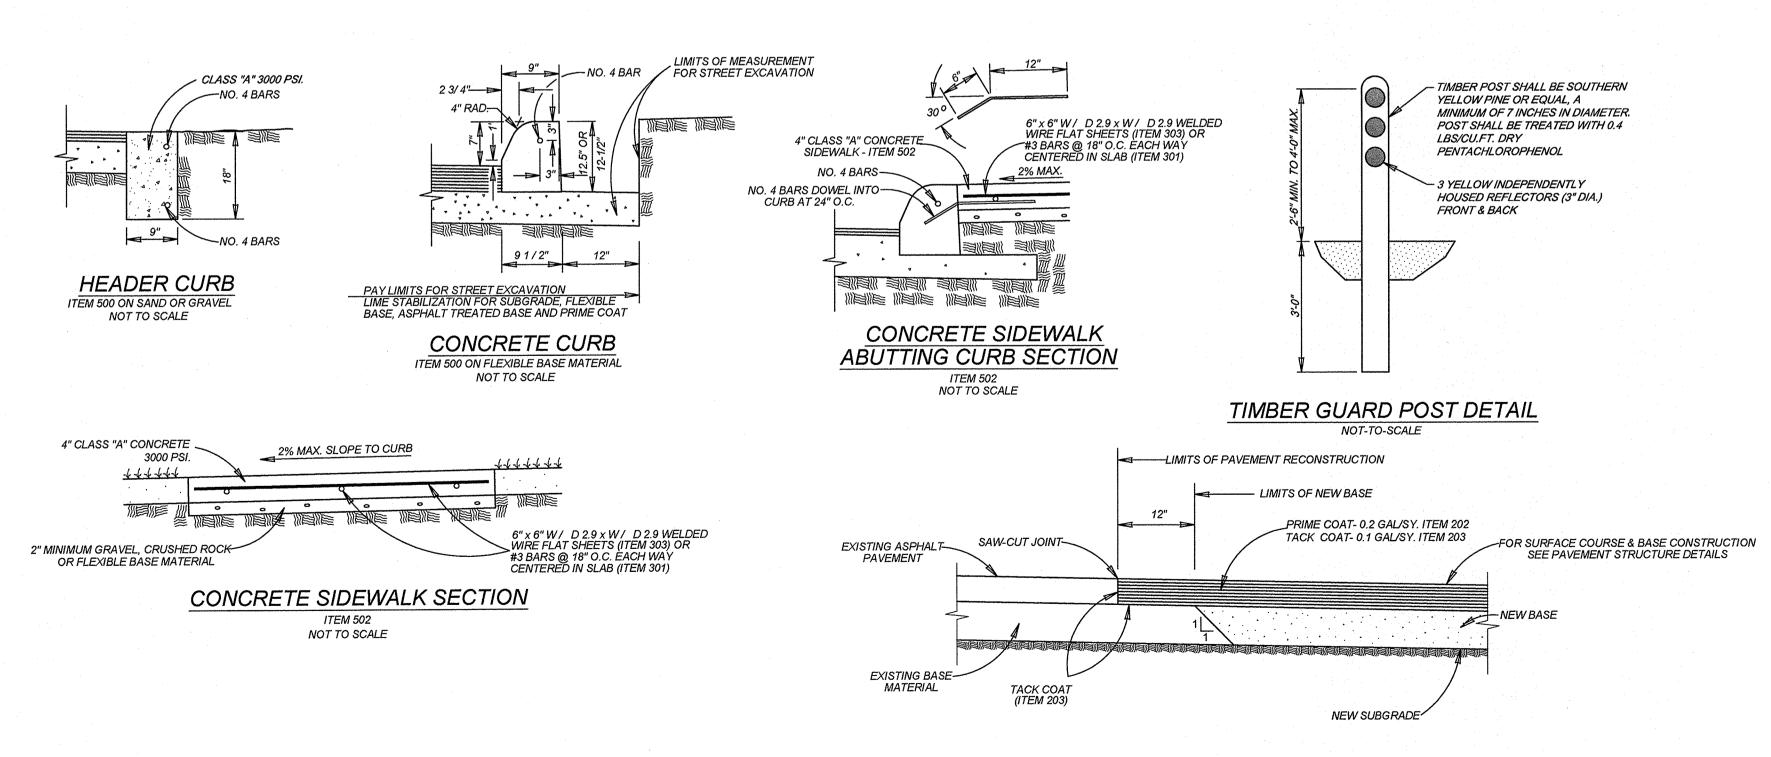

\*NOTE: LIME OR CEMENT CONTENT OF 8.0 PERCENT OF THE DRY WEIGHT OF THE SOIL TO BE TREATED SHOULD BE USED. SUBGRADE STABILIZATION SHALL BE APPLIED AT A RATE OF 33 LBS/S.Y. AS PER GEOTECHNICAL REPORT BY INTEC, DATED JUNE 21, 2021.

\*\*NOTE: ASPHALT PAVEMENT SHALL BE INSTALLED IN ACCORDANCE WITH THE CURRENT CITY OF SAN ANTONIO STANDARD SPECIFICATIONS FOR CONSTRUCTION, ITEMS NO. 200, 202, 203, 204, AND 205 (PRIME COAT APPLIED AT A RATE NOT TO EXCEED 0.20 GAL/S.Y. AND TACK COAT APPLIED AT A RATE NOT TO EXCEED 0.10 GAL/S.Y.).

\*\*\*NOTE: GEOTECHNICAL ENGINEER TO BE ON SITE TO MAKE FINAL SUBGRADE DETERMINATION. CHANGES TO THIS PAVEMENT DESIGN SHALL BE SUBMITTED TO COSA-DSD PRIOR TO PLACEMENT OF BASE

### GENERAL NOTES:

1. THE SUBGRADE SOILS SHOULD BE TESTED FOR SOLUBLE SULPHATE CONTENT PRIOR TO INSTALLATION OF THE LIME OR CEMENT.

FOR CONSTRUCTION VERIFICATION THE FOLLOWING SHALL BE CONDUCTED IN THE FIELD:

 AFTER INITIAL MIXING THE SOIL-LIME MIXTURE SHALL MELLOW FOR A PERIOD OF TWO TO THREE (2-3) DAYS. MAINTAIN MOISTURE DURING MELLOWING; MINIMUM PASSING 1 3/4" SIEVE

MINIMUM PASSING 3/4" SIEVE MINIMUM PASSING NO. 4 SIEVE

- SAMPLE SOIL-LIME MIXTURE FOR DETERMINATION OF MAXIMUM DRY DENSITY (MDD). IN THE LABORATORY, MOLD SPECIMENS TO 95% OF MDD AT OPTIMUM MOISTURE CONTENT AND VERIFY UCS TO BE AT LEAST 160 PSI IN ACCORDANCE WITH PROCEDURE OUTLINED ABOVE FOR MIXTURE DESIGN.
- COMPACT AND CHECK FIELD DENSITY (MINIMUM OF 95% OF MDD REQUIRED); • CURE FOR AN ADDITIONAL 2 TO 5 DAYS (TOTAL MELLOWING AND CURING TIME SHOULD
- TOTAL AT LEAST 5 DAYS). • VERIFY DEPTH OF LIME STABILIZED LAYER TO DEPTH AS NOTED ON PLAN TO WITHIN +/- 1.0

### NOTES:


- ANY FILL USED TO RAISE THE SUBGRADE:
- SHOULD NOT CONTAIN ANY DELETERIOUS MATERIAL. SHOULD HAVE A CBR VALUE OF 2.0 OR GREATER
- SHOULD NOT HAVE GRAVELS LARGER THAN 3 INCH IN SIZE SHOULD HAVE THE "LIME PERCENTAGE/APPLICATION RATE" RE-RUN
- PRIOR TO INSTALLATION PI SHOULD BE LESS THAN 70

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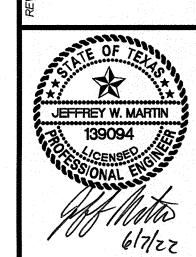
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ENGINEERS + SURVEYING 3421 Paesanos Pkwy, Suite 200, San Antonio, TX Phone #: (210) 979-8444 • Fax #: (210) 979-8441 TBPE Firm #: 9513 • TBPLS Firm #: 10122300




ROSE VALLEY PHASE 1B
SAN ANTONIO, TEXAS
JEEL CHAIR RAMP DETAIL SHEET


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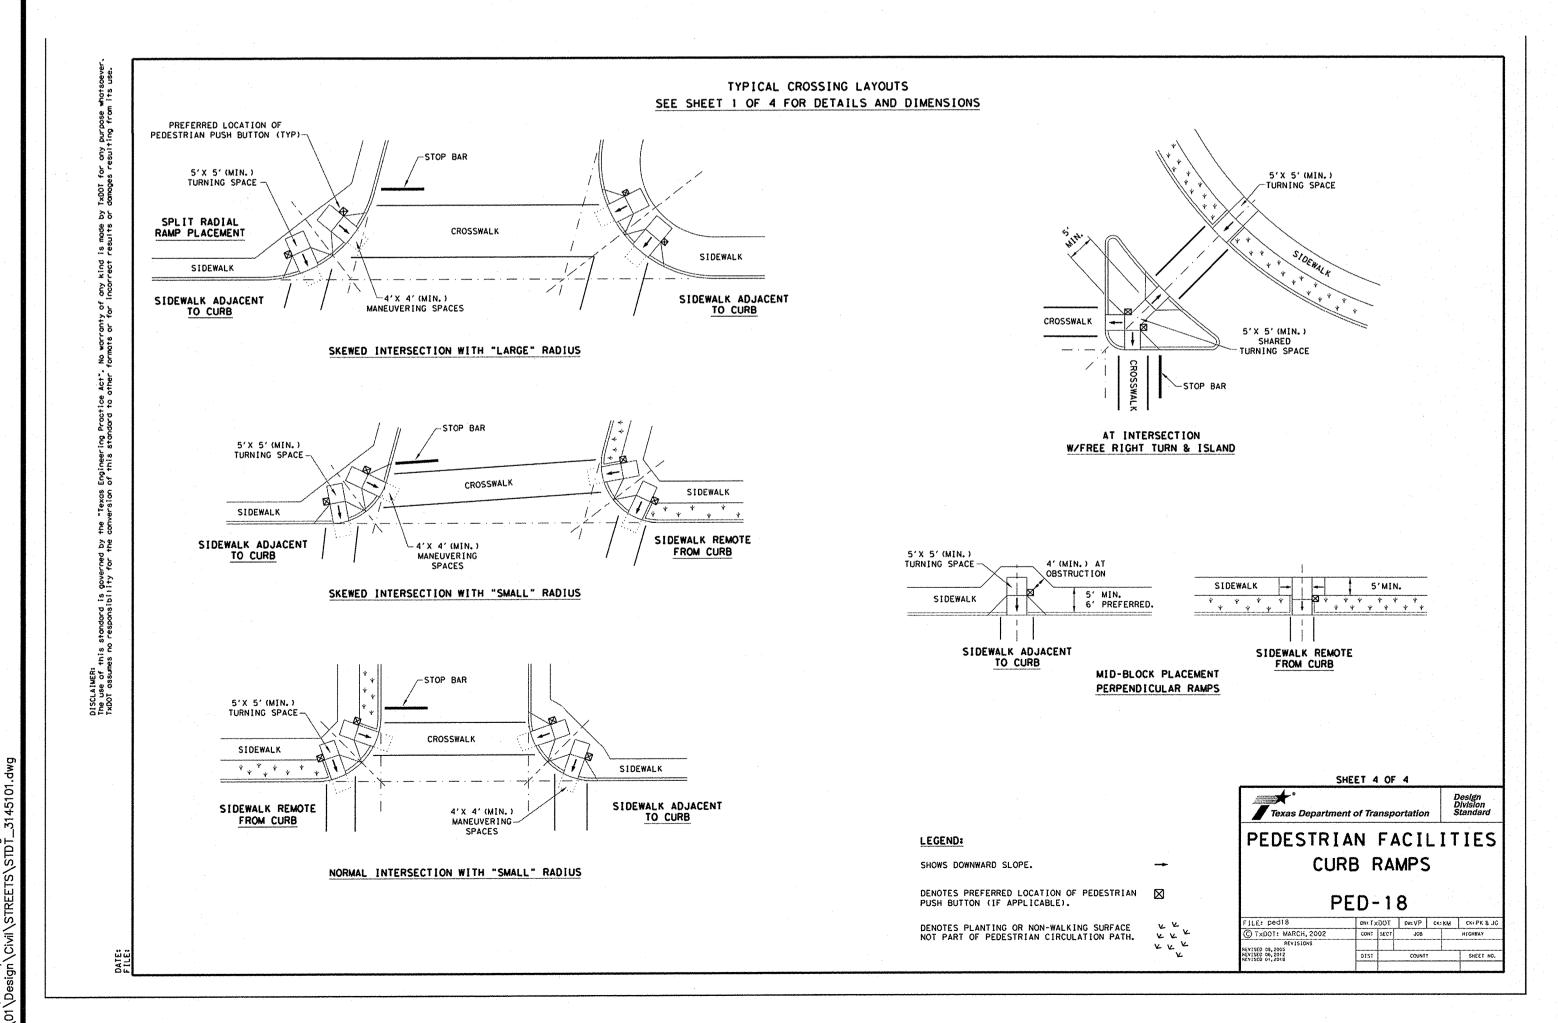
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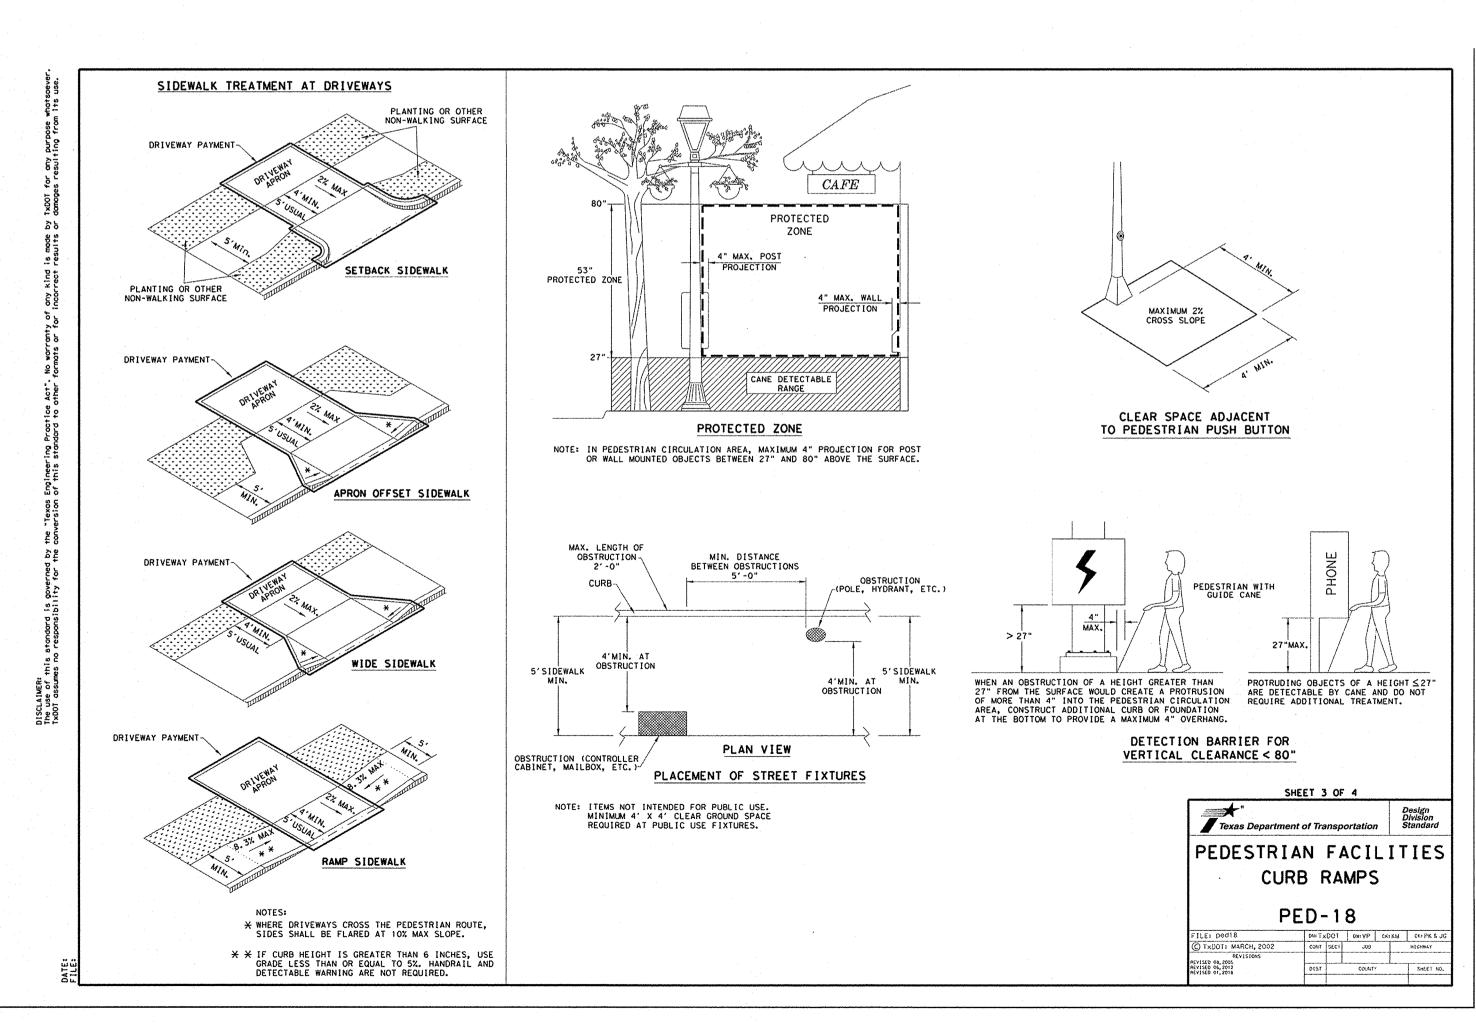
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ROSE VALLEY PHASE 1B SAN ANTONIO, TEXAS MISCELLANEOUS DETAL SHEET (1 OF
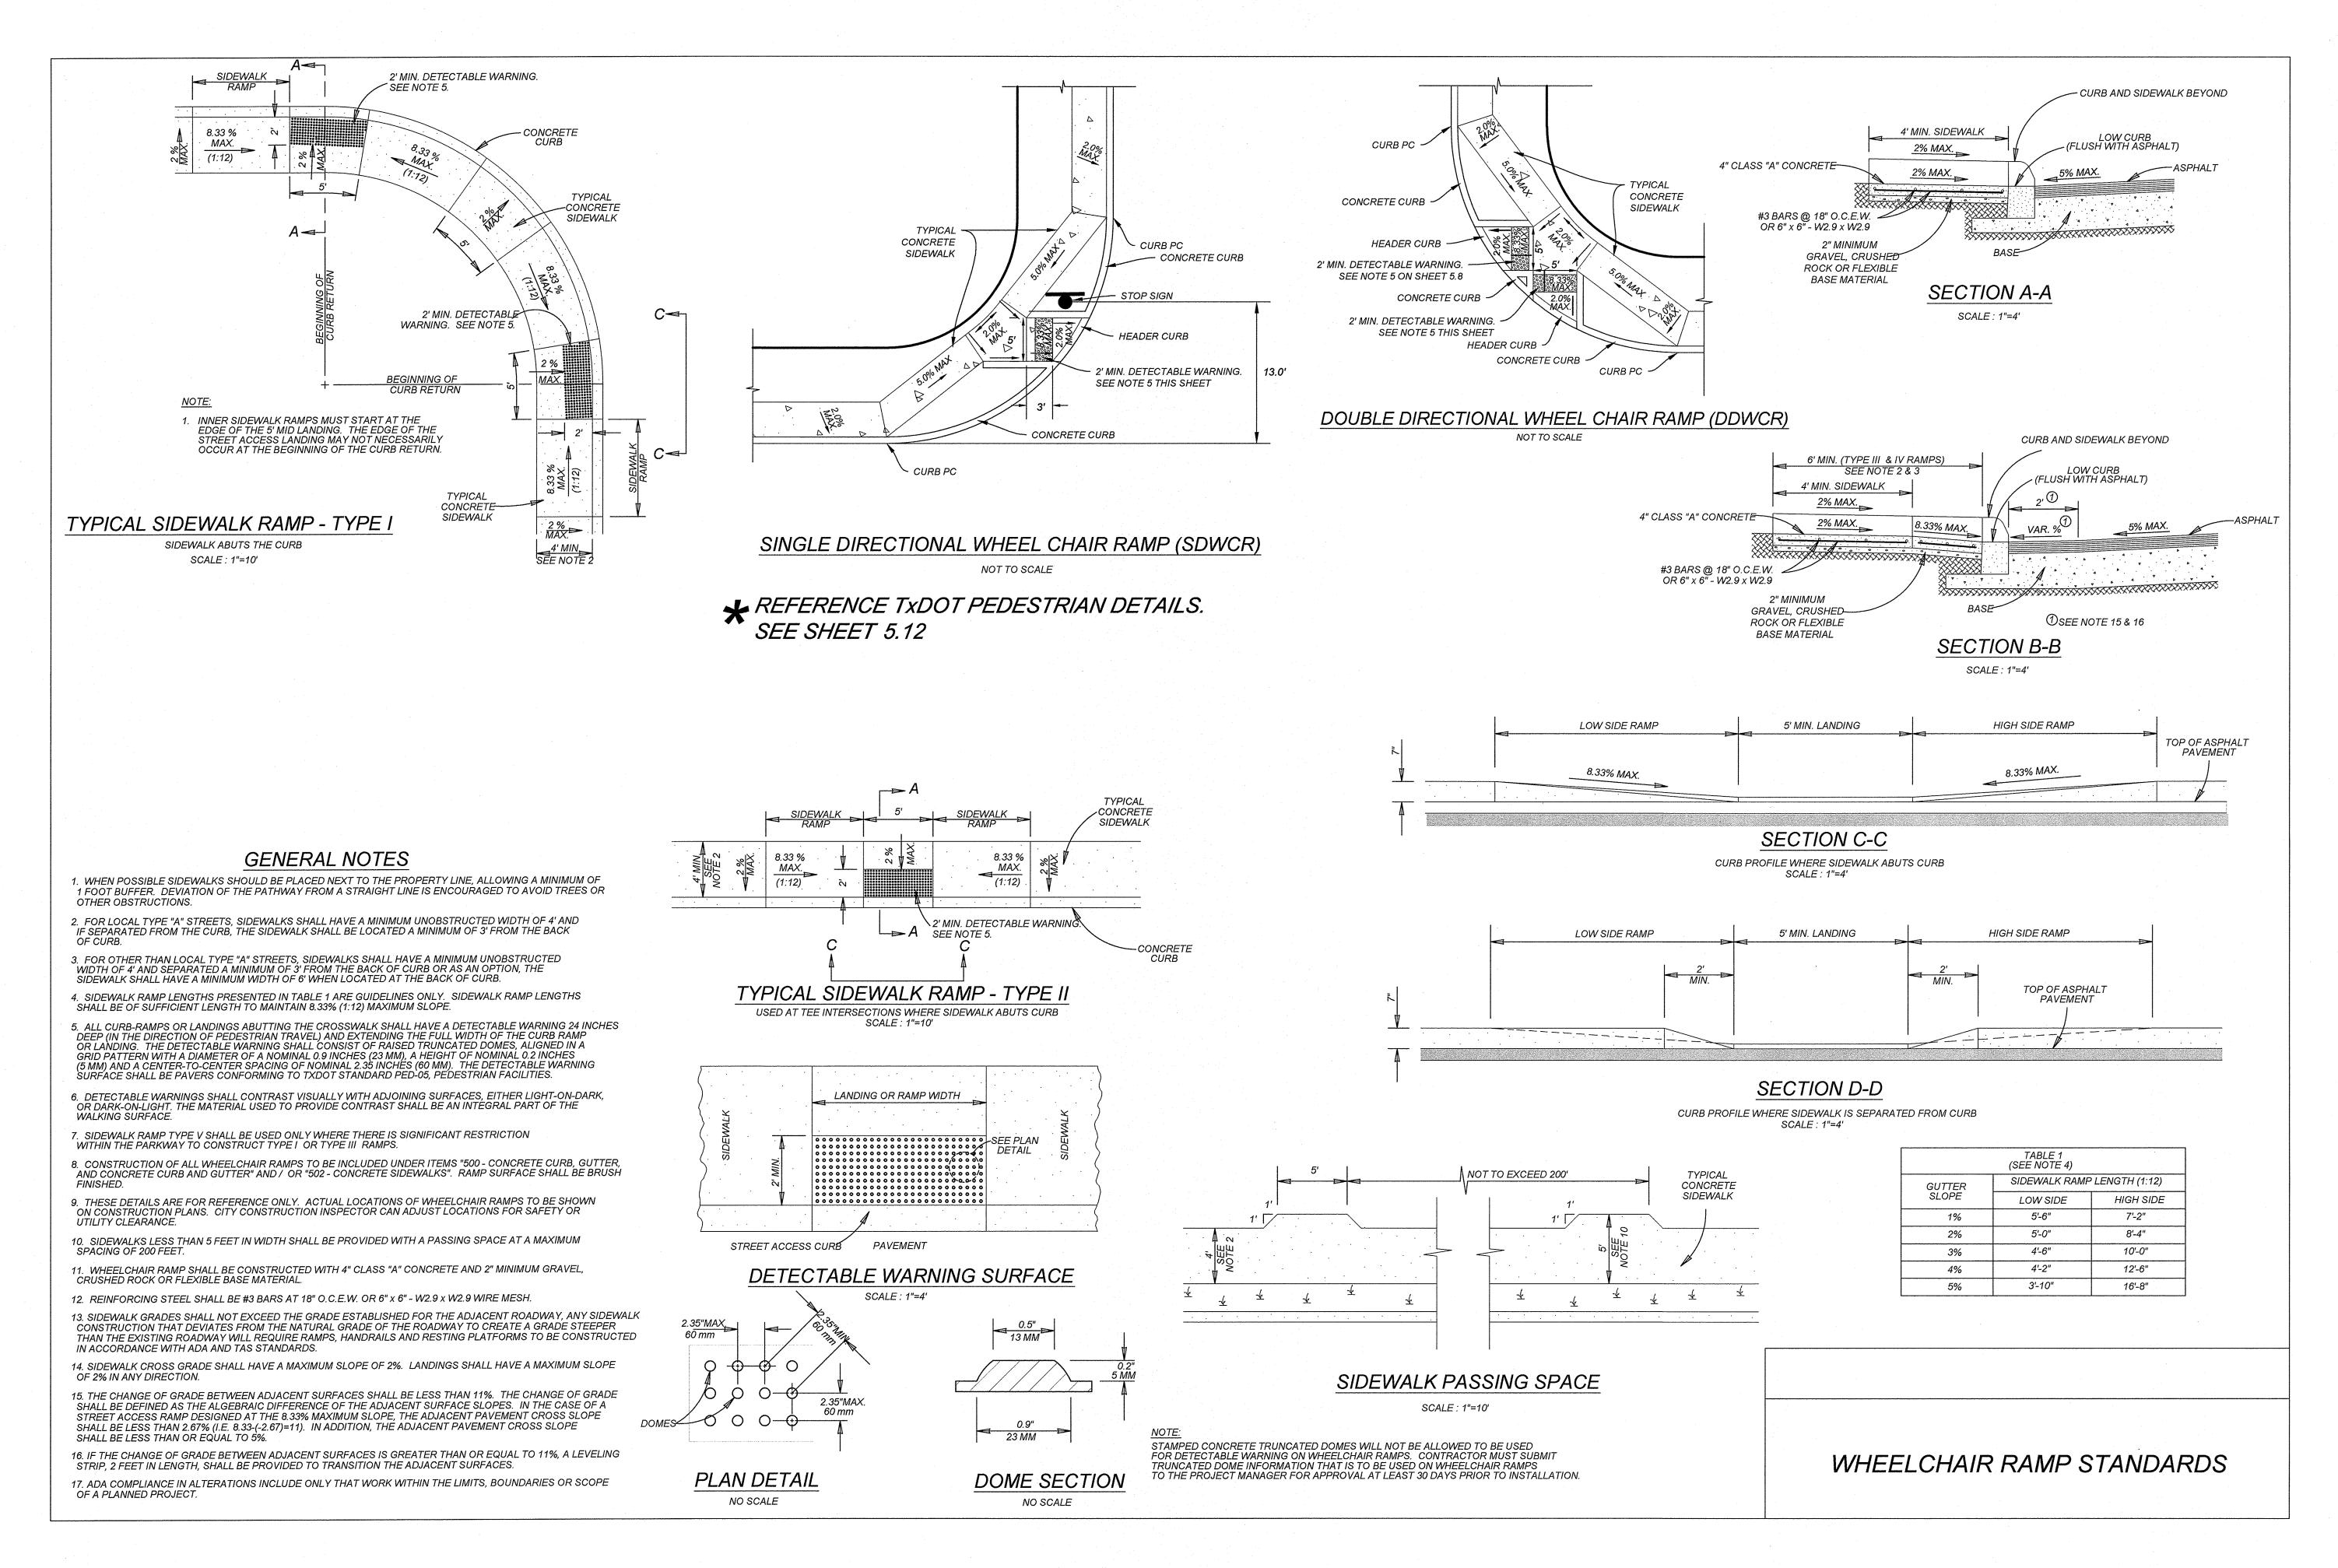
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PLAT NO. 22-11800056 JOB NO. 314-51-01 DATE:----

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JOB NO. 314-51-01 DATE:----DRAWN:SD CHECKED:JM SHEET NUMBER:

DRIVEWAY DRIVEWAY APRON LENGTH 4' SIDEWALK AS SHOWN ON PLANS PENETRATION SEE NOTE 1 CURB & SIDEWALK BEYOND 5" CLASS "A" CONCRETE \_LOW CURB --- 2%MAX: ----2" MINIMUM FLEXIBLE BASE MATERIAL, CEMENT TREATED BASE OR ASPHALTIC CONCRETE #3 BARS 12" O.C. BOTH WAYS (ITEM 301) OR 6" x 6" W/ D5 x "W" D5 WELDED WIRE FLAT SHEETS (ITEM 303)

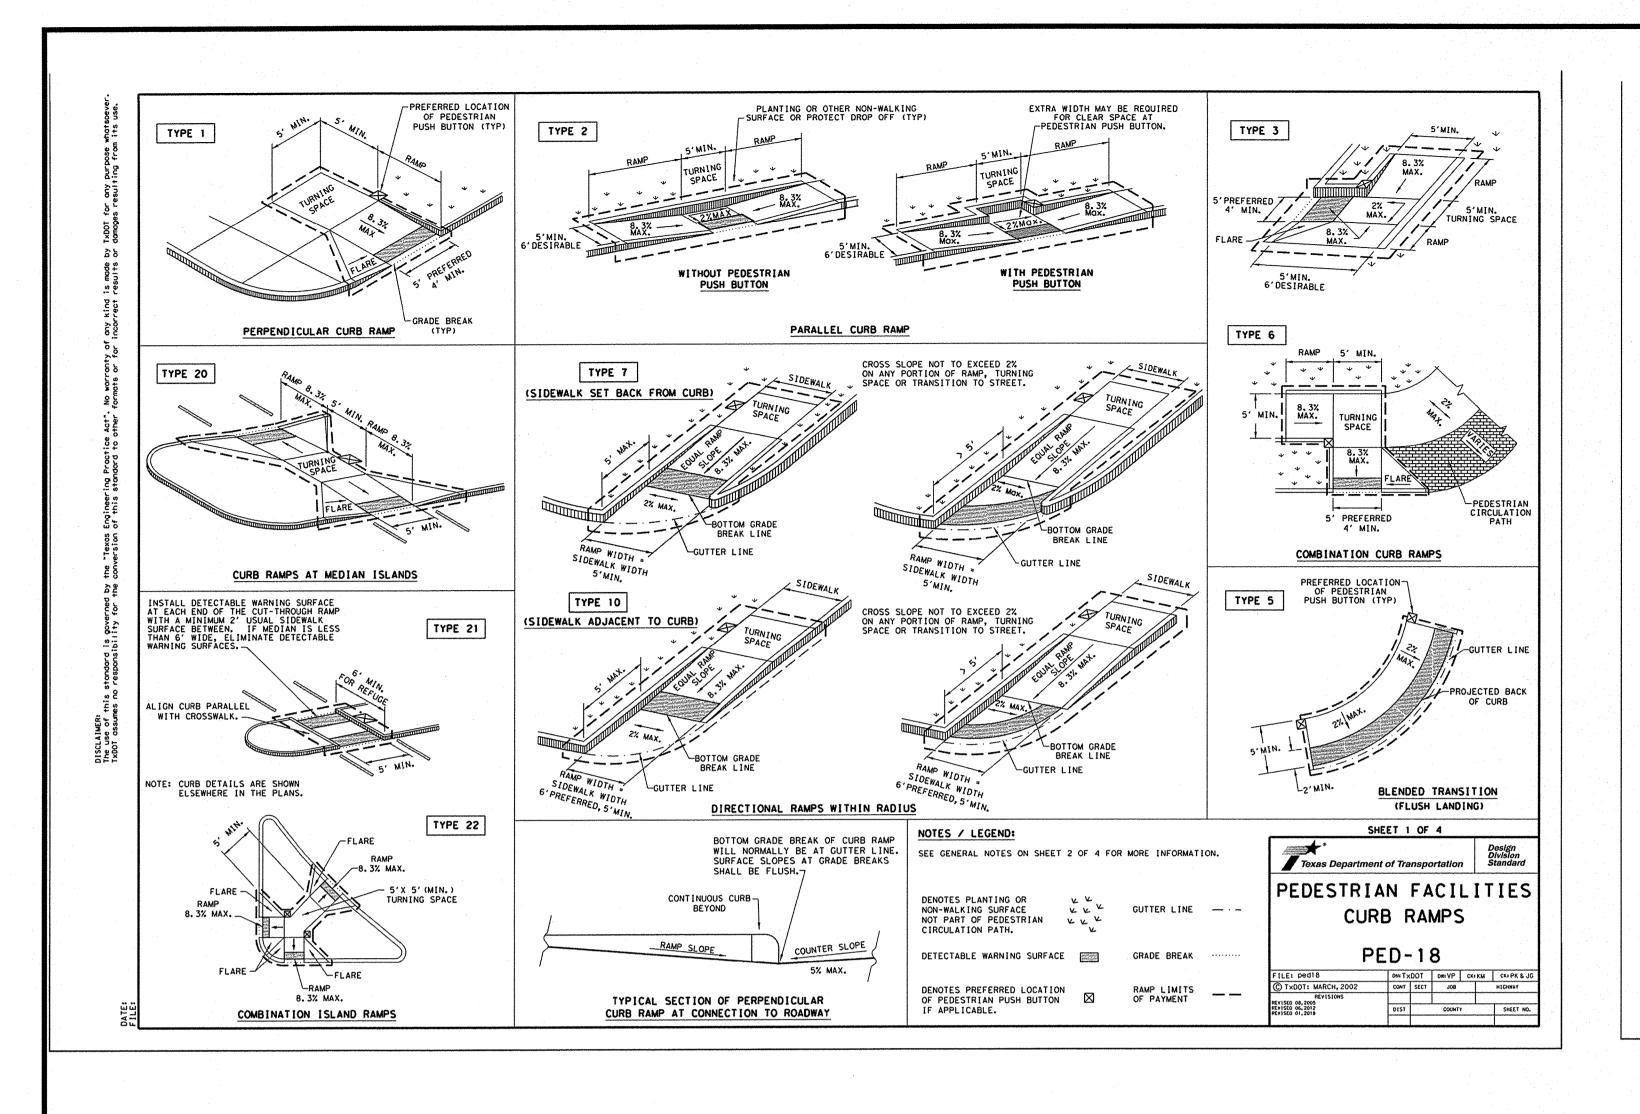
### TYPICAL RESIDENTIAL DRIVEWAY SECTION

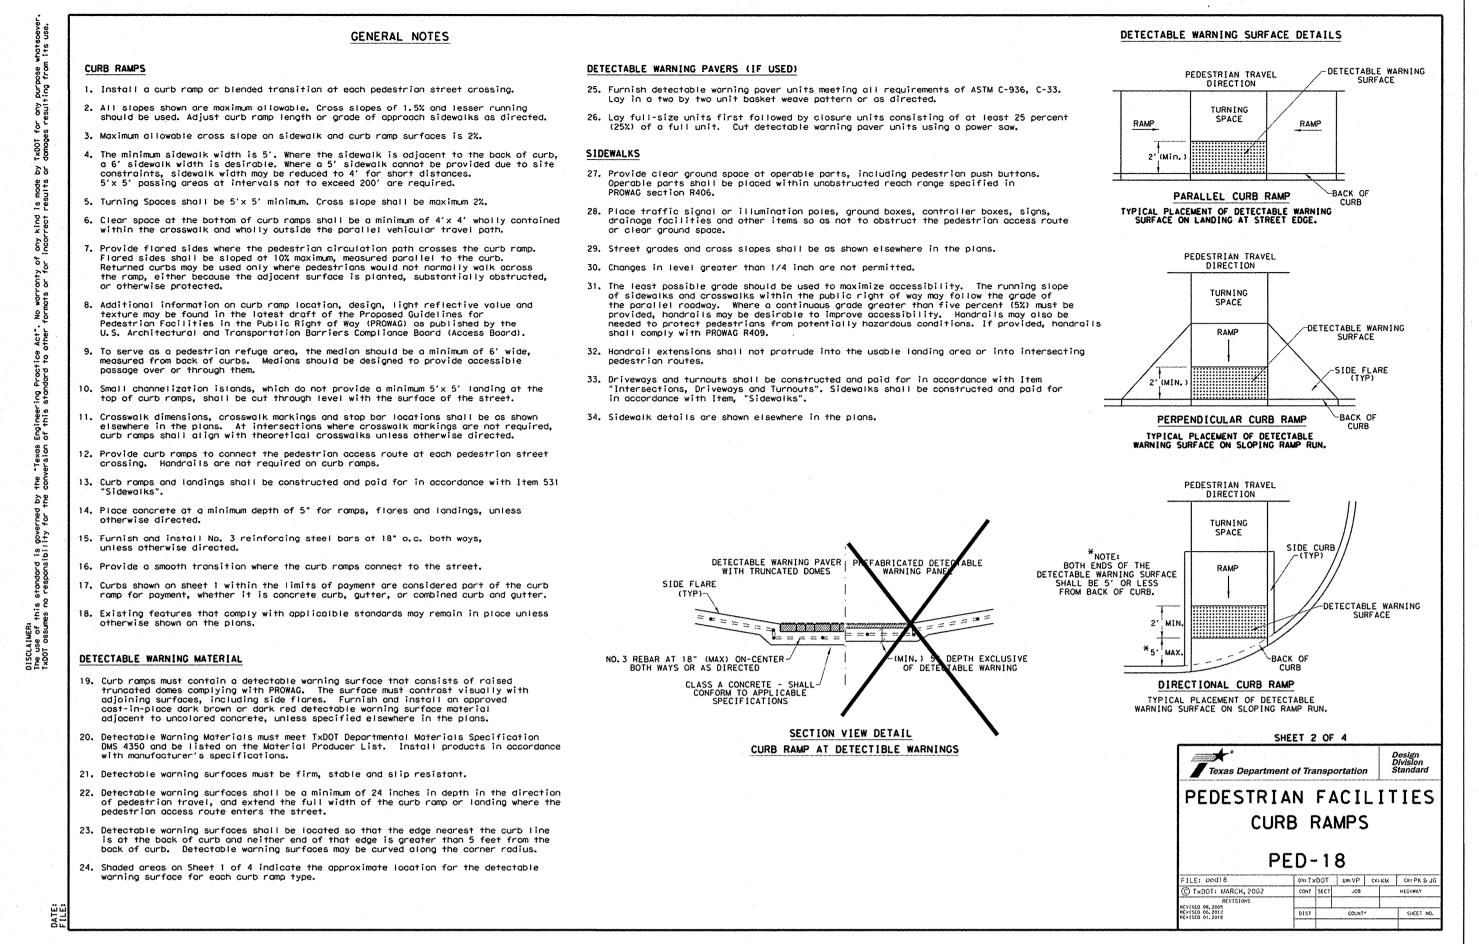WITH SIDEWALK ABUTTING CURB ITEM 503.1

DRIVEWAY DRIVEWAY APRON LENGTH 4' SIDEWALK PENETRATION AS SHOWN ON PLANS SEE NOTE 1 **CURB & SIDEWALK** 5" CLASS "A" CONCRETE LOW CURB 7%MAX.(G1) 2" MINIMUM FLEXIBLE BASE MATERIAL, CEMENT TREATED BASE #3 BARS 12" O.C. BOTH WAYS (ITEM 301) OR 6" x 6" W/ D5 x W/ D5 WELDED WIRE FLAT SHEETS (ITEM 303) OR ASPHALTIC CONCRETE BASE (2) THE ALGEBRAIC DIFFERENCE OF G1 & G2 SHALL BE 14% OR LESS

### TYPICAL RESIDENTIAL DRIVEWAY SECTION

WHERE PROPERTY IS LOWER THAN STREET & SIDEWALK IS ABUTTING CURB ITEM 503.1

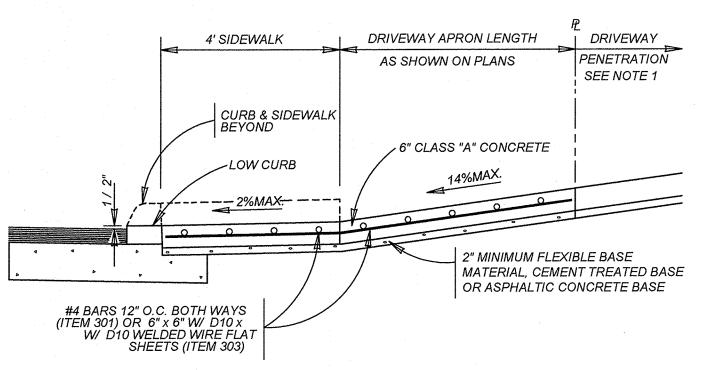

### TYPICAL COMMERCIAL DRIVEWAY SECTION

WITH SIDEWALK ABUTTING CURB ITEM 503.2

### CONCRETE DRIVEWAY NOTES

1. DRIVEWAY PENETRATION REFERS TO A PORTION OF THE DRIVEWAY THAT MAY BE NECESSARY TO RECONSTRUCT WITHIN PRIVATE PROPERTY TO COMPLY WITH A MAXIMUM DRIVEWAY SLOPE. THIS PORTION OF THE DRIVEWAY SHALL BE PAID FOR UNDER THE FOLLOWING ITEMS AS MAY APPLY: A.) CONCRETE DRIVEWAY PAID FOR UNDER ITEM NO. 503.1 OR 503.2.

B.) ASPHALTIC CONCRETE DRIVEWAY PAID FOR UNDER ITEM NO. 503.4 AND SHALL INCLUDE A MINIMUM OF 1" ASPHALT TYPE 'D' & 6" FLEXIBLE BASE C.) GRAVEL DRIVEWAY PAID FOR UNDER ITEM NO. 503.5 AND SHALL INCLUDE A MINIMUM OF 6" FLEXIBLE BASE

2. 7" MINIMUM HEIGHT WILL NOT NECESSARILY OCCUR AT THE PROPERTY LINE. IT MAY OCCUR WITHIN THE RIGHT OF WAY OR WITHIN THE DRIVEWAY PENETRATION ON PRIVATE PROPERTY.

3. THE PROPOSED DRIVEWAY SHOULD MATCH THE EXISTING WIDTH AT THE PROPERTY LINE BUT UNLESS AUTHORIZED BY THE CITY TRAFFIC ENGINEER, THE WIDTH SHALL BE WITHIN THE FOLLOWING VALUES:

TYPE	MINIMUM	MAXIMUM
RESIDENTIAL	10'	20'
COMMERCIAL - ONE WAY	12'	20'
COMMERCIAL - TWO WAY	24'	30'

4. FOR LOCAL TYPE "A" STREETS, SIDEWALK SHALL HAVE A MINIMUM WIDTH OF 4' AND IF SEPARATED FROM THE CURB, THE SIDEWALK SHALL BE LOCATED A MINIMUM OF 3' FROM THE BACK OF CURB.

5. FOR OTHER THAN LOCAL TYPE "A" STREETS, THE SIDEWALK SHALL HAVE A MINIMUM WIDTH OF 4' AND SEPARATED A MINIMUM OF 3' FROM THE BACK OF CURB OR, AS AN OPTION, THE SIDEWALK SHALL HAVE A MINIMUM WIDTH OF 6' WHEN LOCATED AT THE BACK OF CURB.

6. DUMMY JOINTS PARALLEL TO THE CURB SHALL BE PLACED WHERE THE SIDEWALK MEETS THE DRIVEWAY. DUMMY JOINTS PERPENDICULAR TO THE CURB, AND WITHIN THE BOUNDARIES OF THE PARALLEL DUMMY JOINTS, SHALL BE PLACED AT INTERVALS EQUAL TO THE WIDTH OF THE SIDEWALK.

7. A MINIMUM OF TWO ROUND AND SMOOTH DOWEL BARS 3/8" IN DIAMETER AND 18" IN LENGTH SHALL BE SPACED 18" APART AT EACH EXPANSION JOINT.


8. SIDEWALK RAMP LENGTHS SHALL BE OF SUFFICIENT LENGTH TO MAINTAIN 8.33% (1:12) MAXIMUM SLOPE. WHERE SIDEWALKS CROSS DRIVEWAYS, SIDEWALK CROSS SLOPE SHALL NOT EXCEED 2%.

9. SIDEWALK RAMP SURFACE SHALL BE BRUSH FINISHED.

DRIVEWAY APRON | DRIVEWAY 4' SIDEWALK LENGTH AS SHOWN | PENETRATION MINIMUM ON PLANS SEE NOTE 1 CURB AND SIDEWALK BEYOND · 5" CLASS "A" CONCRETE LOW CURB -2% MAX + +-" MINIMUM FLEXIBLE BASE MATERIAL, CEMENT TREATED BASE #3 BARS 12" O.C. BOTH WAYS (ITEM 301) OR 6" x 6" W/ D5 x W/ D5 WELDED WIRE FLAT SHEETS (ITEM 303) OR ASPHALTIC CONCRETE BASE 10 8% MAX. TO THE EDGE OF THE SIDEWALK IF SIDEWALK SEPARATION

### IS 4' OR GREATER. TYPICAL RESIDENTIAL DRIVEWAY SECTION


WITH SIDEWALK SEPARATED FROM CURB ITEM 503.1

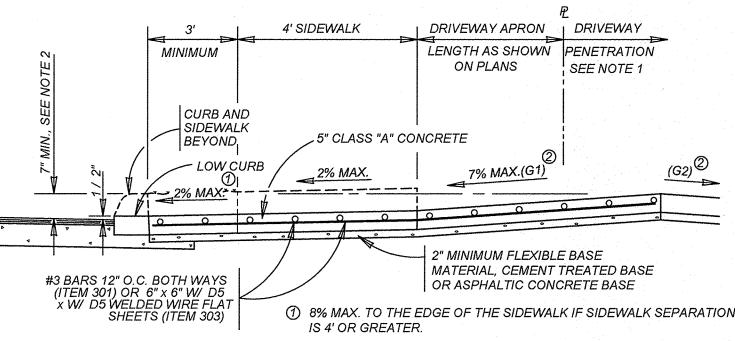

② THE ALGEBRAIC DIFFERENCE OF G1 & G2 SHALL BE 14% OR LESS


### TYPICAL RESIDENTIAL DRIVEWAY SECTION

WHERE PROPERTY IS LOWER THAN STREET & SIDEWALK IS SEPARATED FROM CURB

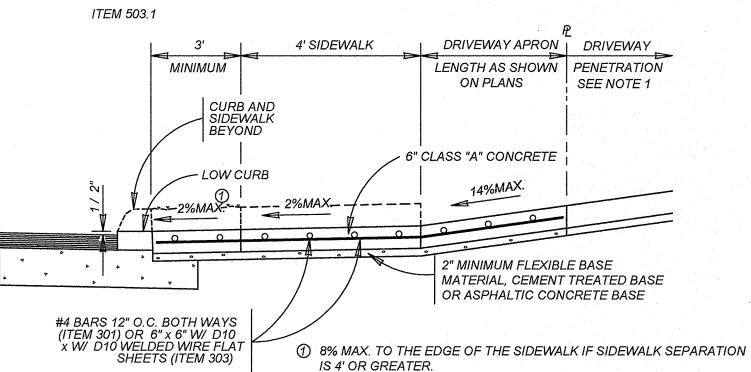

### TYPICAL COMMERCIAL DRIVEWAY SECTION WITH SIDEWALK SEPARATED FROM CURB


ITEM 503.2

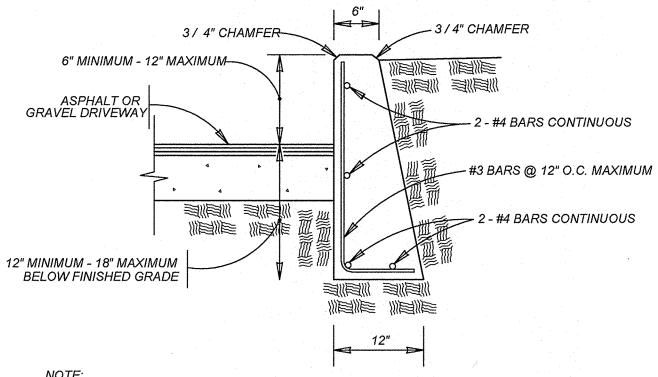

- 1. COST OF REINFORCEMENT TO BE INCLUDED IN UNIT COST OF ITEM 307.1.
- 2. CONCRETE RETAINING WALL COMBINATION TYPE SHALL BE USED FOR CONCRETE DRIVEWAYS.


### DRIVEWAY - CONCRETE RETAINING WALL

ON COMPACTED SUBGRADE ITEM 307.1

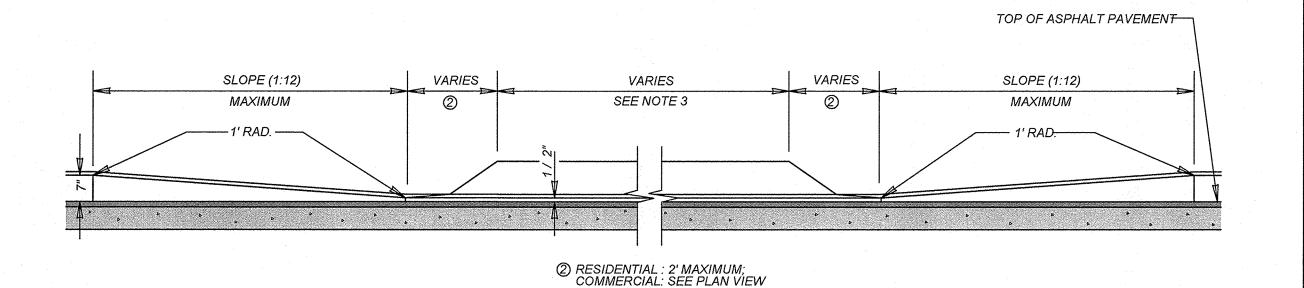


### CURB PROFILE AT DRIVEWAY

WITH SIDEWALK ABUTTING CURB

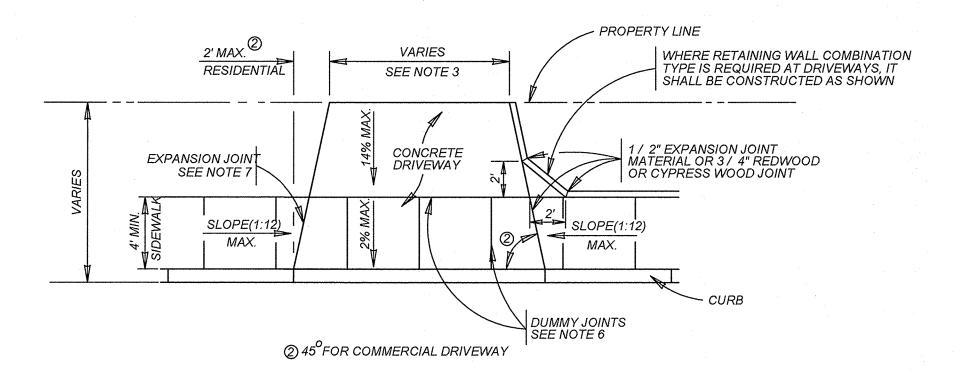

### TYPICAL DRIVEWAY PLAN VIEW


WITH SIDEWALK ABUTTING CURB

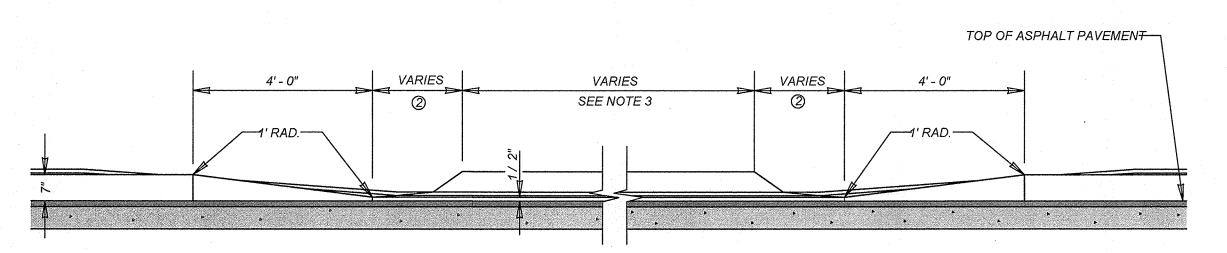

② RESIDENTIAL : 2' MAXIMUM; COMMERCIAL: SEE PLAN VIEW

### CURB PROFILE AT DRIVEWAY

WITH SIDEWALK SEPARATED FROM CURB

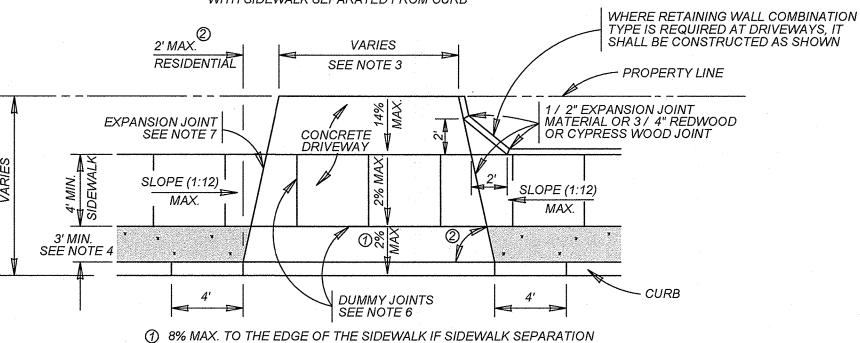

2 45 FOR COMMERCIAL DRIVEWAY

TYPICAL DRIVEWAY PLAN VIEW

IS 4' OR GREATER.

WITH SIDEWALK SEPARATED FROM CURB

### MAY 2009

### CITY OF SAN ANTONIO


CAPITAL IMPROVEMENTS MANAGEMENT SERVICES DEPARTMENT


### CONCRETE DRIVEWAY STANDARDS

% SUBMITTAL	PROJECT NO.:	4.	DATE:
DRWN. BY: V. VASQUEZ	DSGN. BY:	CHKD. BY: R.S. HOSSEINI, P.E.	SHEET NO.:OF

THIS DOCUMENT HAS BEEN PRODUCED FROM MATERIAL THAT WAS STORED AND/OR TRANSMITTED ELECTRONICALLY AND MAY HAVE BEEN INADVERTENTLY ALTERED. RELY ONLY ON FINAL HARDCOPY MATERIALS BEARING THE CONSULTANT'S ORIGINAL SIGNATURE AND SEAL.

RO

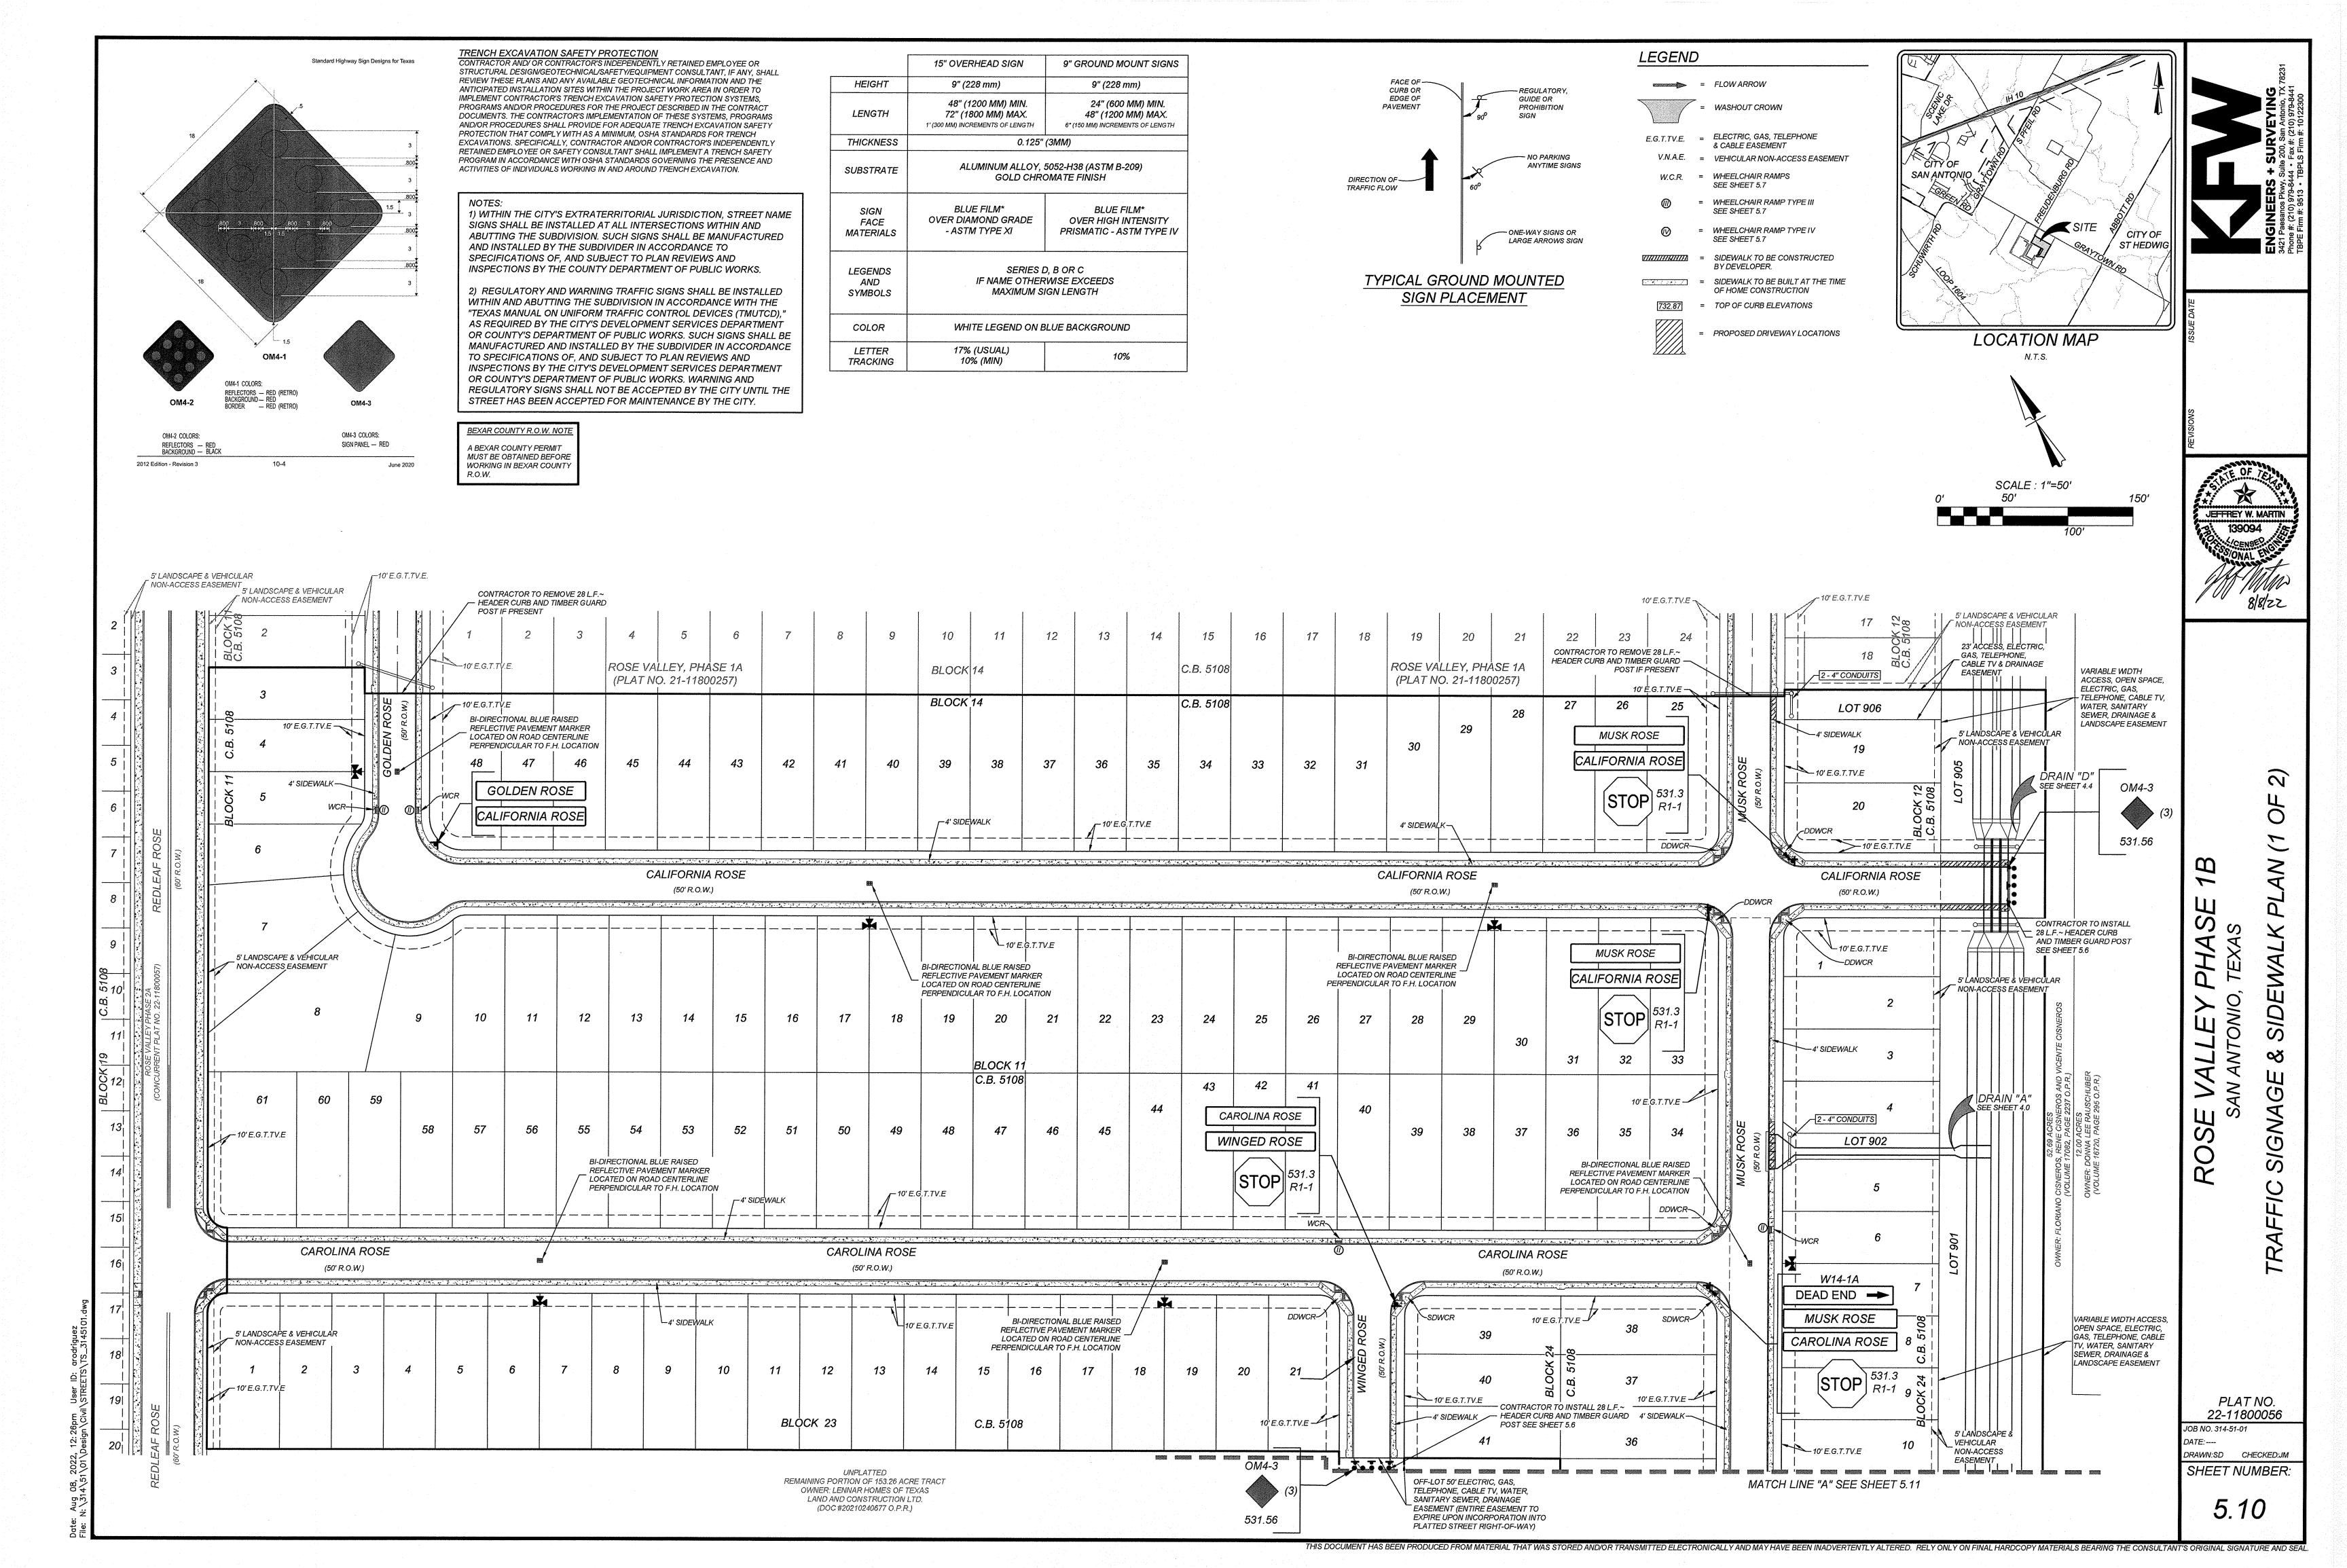

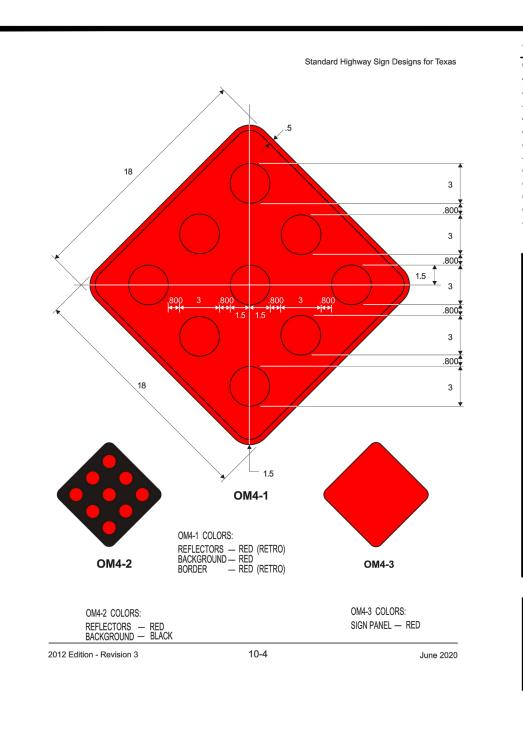

	TRENCH EXCAVATION SAFETY PROTECTION CONTRACTOR AND/ OR CONTRACTOR'S INDEPENDENTLY RETAINED EMPLOYEE OR STRUCTURAL DESIGN/GEOTECHNICAL/SAFETY/EQUIPMENT CONSULTANT, IF ANY, SHALL REVIEW THESE PLANS AND ANY AVAILABLE GEOTECHNICAL INFORMATION AND THE	ИГ
-	ANTICIPATED INSTALLATION SITES WITHIN THE PROJECT WORK AREA IN ORDER TO	HEI
IMPLEMENT CONTRACTOR'S TRENCH EXCAVATION SAFETY PROTECTION SYSTEMS, PROGRAMS AND/OR PROCEDURES FOR THE PROJECT DESCRIBED IN THE CONTRACT DOCUMENTS. THE CONTRACTOR'S IMPLEMENTATION OF THESE SYSTEMS, PROGRAMS AND/OR PROCEDURES SHALL PROVIDE FOR ADEQUATE TRENCH EXCAVATION SAFETY PROTECTION THAT COMPLY WITH AS A MINIMUM. OSHA STANDARDS FOR TRENCH	LEN	
	EXCAVATIONS. SPECIFICALLY, CONTRACTOR AND/OR CONTRACTOR'S INDEPENDENTLY	THIC
RETAINED EMPLOYEE OR SAFETY CONSULTANT SHALL IMPLEMENT A TRENCH SAFETY PROGRAM IN ACCORDANCE WITH OSHA STANDARDS GOVERNING THE PRESENCE AND ACTIVITIES OF INDIVIDUALS WORKING IN AND AROUND TRENCH EXCAVATION.		SUBS
	NOTES:  1) WITHIN THE CITY'S EXTRATERRITORIAL JURISDICTION, STREET NAME SIGNS SHALL BE INSTALLED AT ALL INTERSECTIONS WITHIN AND ABUTTING THE SUBDIVISION. SUCH SIGNS SHALL BE MANUFACTURED AND INSTALLED BY THE SUBDIVIDER IN ACCORDANCE TO	SI FA MATE
	SPECIFICATIONS OF, AND SUBJECT TO PLAN REVIEWS AND INSPECTIONS BY THE COUNTY DEPARTMENT OF PUBLIC WORKS.  2) REGULATORY AND WARNING TRAFFIC SIGNS SHALL BE INSTALLED WITHIN AND ABUTTING THE SUBDIVISION IN ACCORDANCE WITH THE	LEGI AI SYM
	"TEXAS MANUAL ON UNIFORM TRAFFIC CONTROL DEVICES (TMUTCD),"	

AS REQUIRED BY THE CITY'S DEVELOPMENT SERVICES DEPARTMENT

TO SPECIFICATIONS OF, AND SUBJECT TO PLAN REVIEWS AND INSPECTIONS BY THE CITY'S DEVELOPMENT SERVICES DEPARTMENT OR COUNTY'S DEPARTMENT OF PUBLIC WORKS. WARNING AND

STREET HAS BEEN ACCEPTED FOR MAINTENANCE BY THE CITY.

OR COUNTY'S DEPARTMENT OF PUBLIC WORKS. SUCH SIGNS SHALL BE MANUFACTURED AND INSTALLED BY THE SUBDIVIDER IN ACCORDANCE


REGULATORY SIGNS SHALL NOT BE ACCEPTED BY THE CITY UNTIL THE


	15" OVERHEAD SIGN	9" GROUND MOUNT SIGNS	
HEIGHT	9" (228 mm)	9" (228 mm)	
LENGTH	48" (1200 MM) MIN. 24" (600 MM) 72" (1800 MM) MAX. 48" (1200 MM) 1' (300 MM) INCREMENTS OF LENGTH 6" (150 MM) INCREMENTS OF		
THICKNESS	0.125"	(3MM)	
SUBSTRATE	ALUMINUM ALLOY, 5052-H38 (ASTM B-209) GOLD CHROMATE FINISH		
SIGN FACE MATERIALS	BLUE FILM* OVER DIAMOND GRADE - ASTM TYPE XI	BLUE FILM* OVER HIGH INTENSITY PRISMATIC - ASTM TYPE IV	
LEGENDS AND SYMBOLS	SERIES D, B OR C IF NAME OTHERWISE EXCEEDS MAXIMUM SIGN LENGTH		
COLOR	WHITE LEGEND ON BLUE BACKGROUND		
LETTER TRACKING	17% (USUAL) 10% (MIN)		


FACE OF ———————————————————————————————————	REGULATORY, GUIDE OR PROHIBITION SIGN		
DIRECTION OF TRAFFIC FLOW	NO PARKING ANYTIME SIGNS 60°		
	ONE-WAY SIGNS OR LARGE ARROWS SIGN		
TYPICAL GROUND MOUNTED SIGN PLACEMENT			


LEGEND			
summum >	=	FLOW ARROW	
	=	WASHOUT CROWN	
E.G.T.TV.E.	=	ELECTRIC, GAS, TELEPHONE & CABLE EASEMENT	
V.N.A.E.	=	VEHICULAR NON-ACCESS EASEMENT	
W.C.R.	=	WHEELCHAIR RAMPS SEE SHEET 5.7	
<i>(</i> ()	=	WHEELCHAIR RAMP TYPE III SEE SHEET 5.7	
<b>@</b>	=	WHEELCHAIR RAMP TYPE IV SEE SHEET 5.7	
	=	SIDEWALK TO BE CONSTRUCTED BY DEVELOPER.	
ক্ৰেটিক ক	=	SIDEWALK TO BE BUILT AT THE TIME OF HOME CONSTRUCTION	
732.87	=	TOP OF CURB ELEVATIONS	
	=	PROPOSED DRIVEWAY LOCATIONS	


THIS DOCUMENT HAS BEEN PRODUCED FROM MATERIAL THAT WAS STORED AND/OR TRANSMITTED ELECTRONICALLY AND MAY HAVE BEEN INADVERTENTLY ALTERED. RELY ONLY ON FINAL HARDCOPY MATERIALS BEARING THE CONSULTANT'S ORIGINAL SIGNATURE AND SEAL.

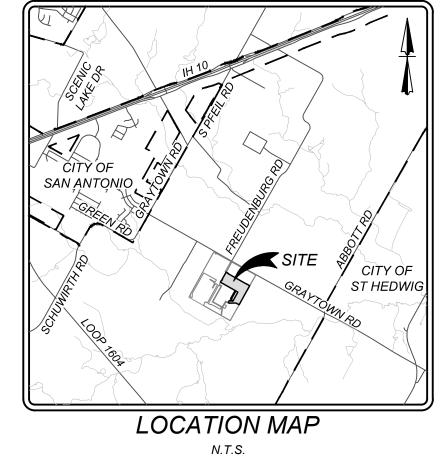

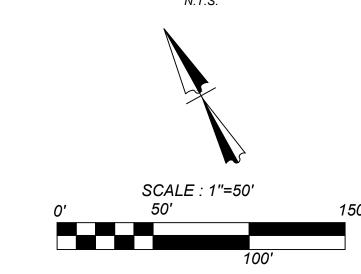

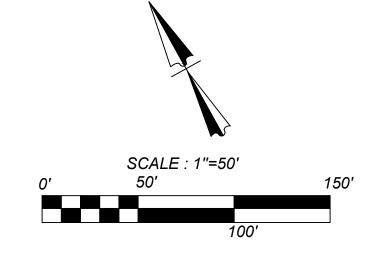

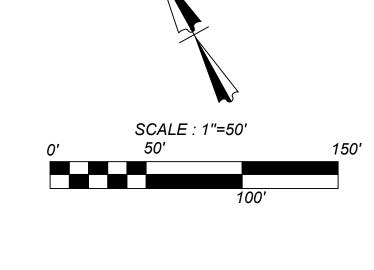


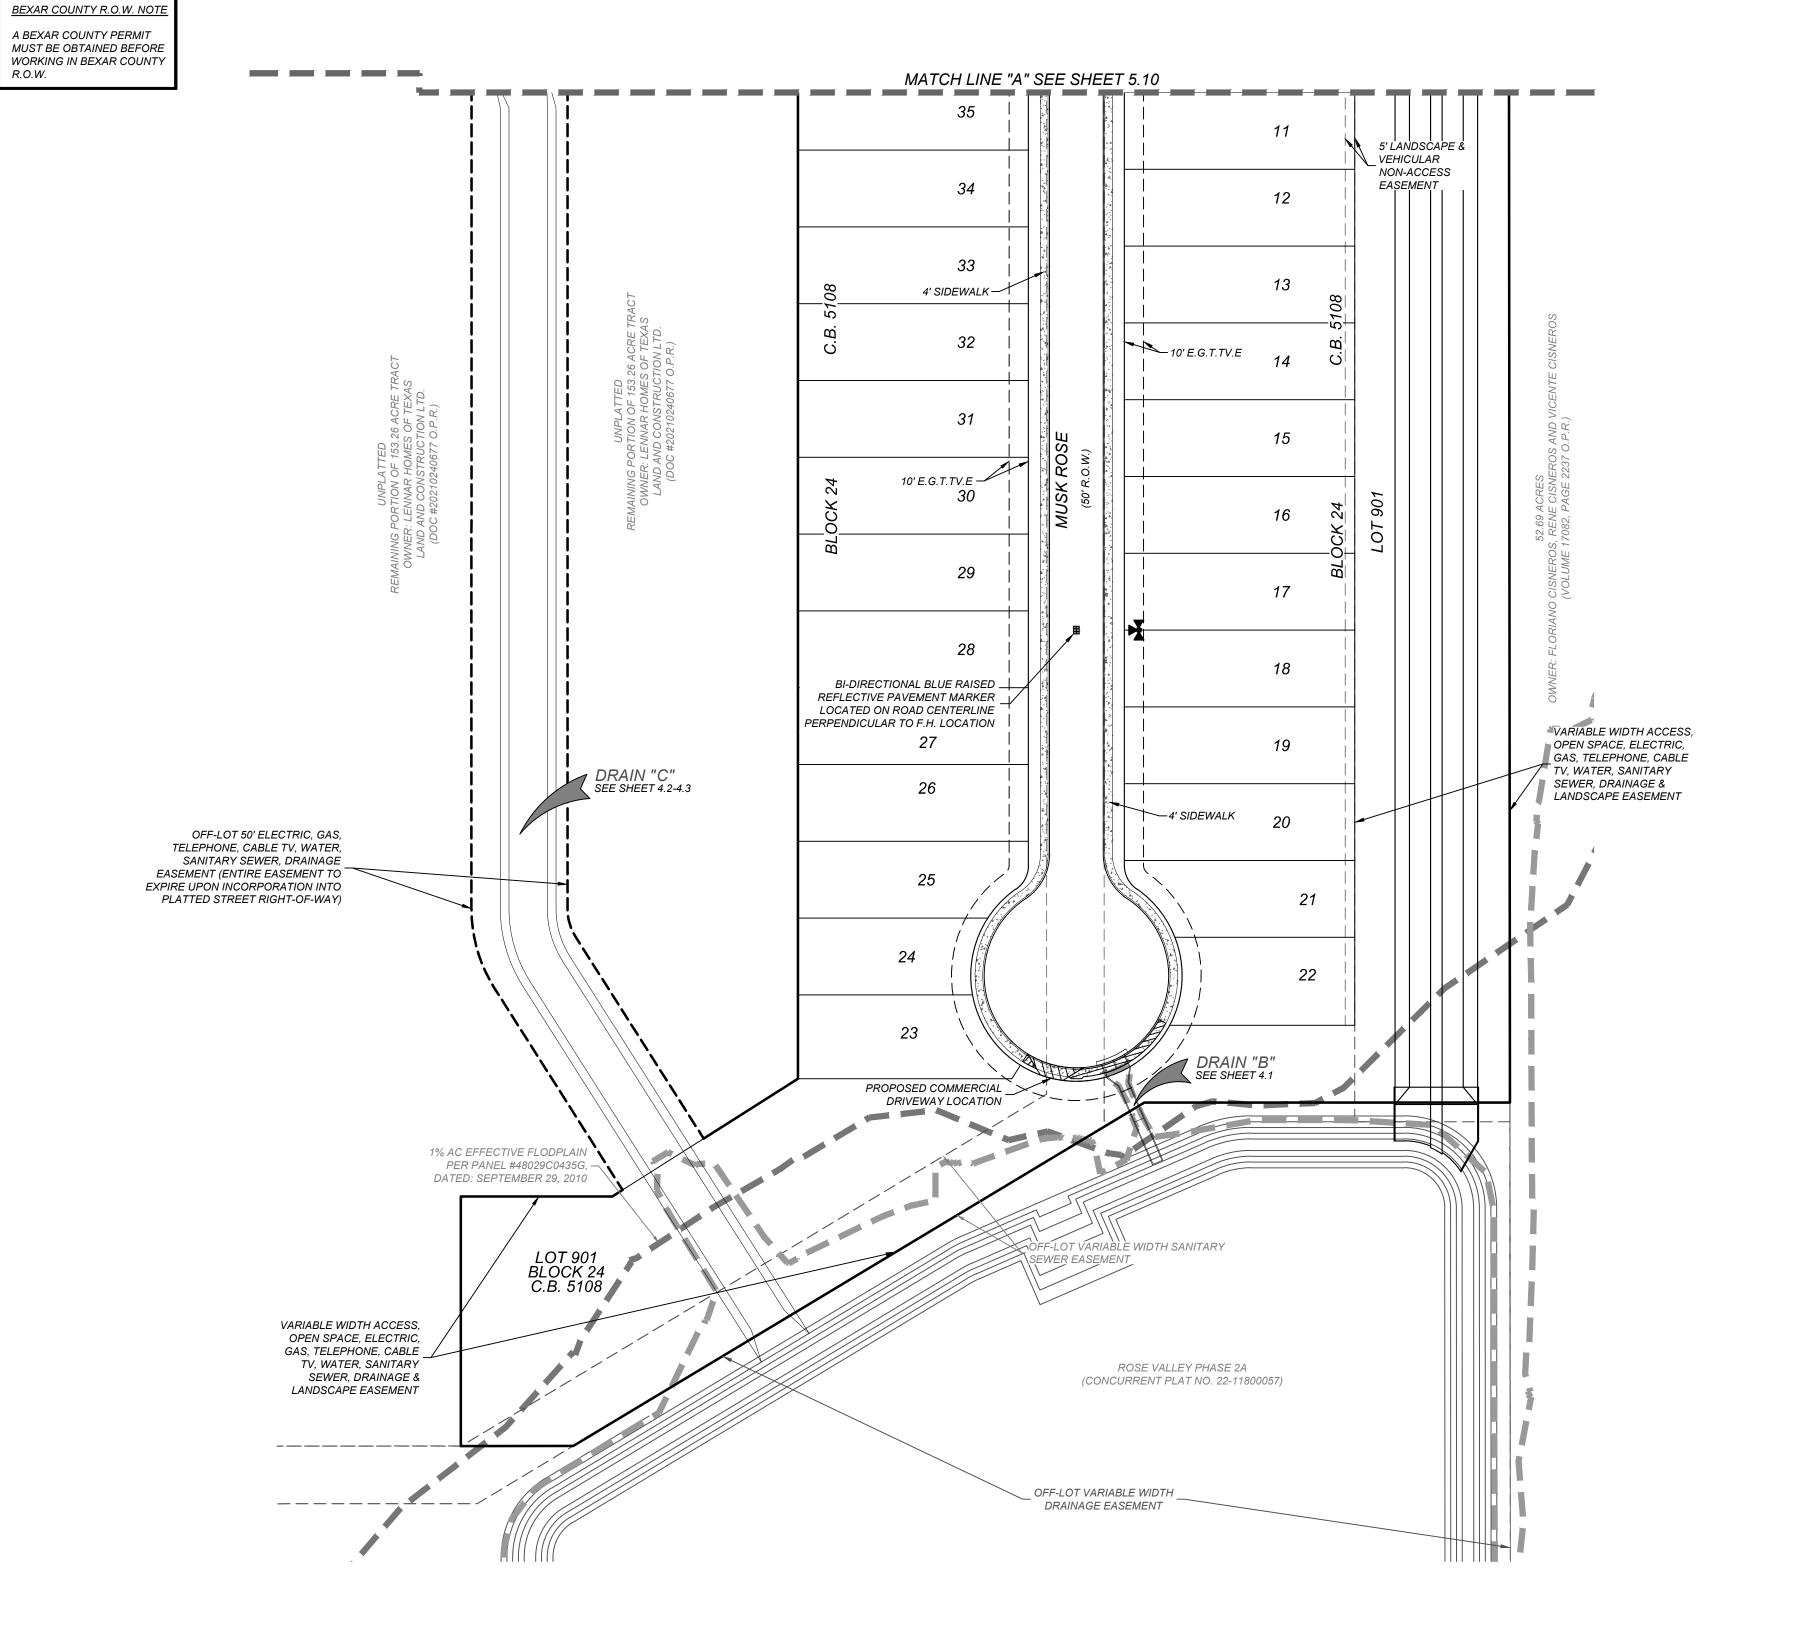

TRAVIS R. ELSETH

PLAT NO. 22-11800056 JOB NO. 314-51-01


DRAWN:SD CHECKED:JM SHEET NUMBER:

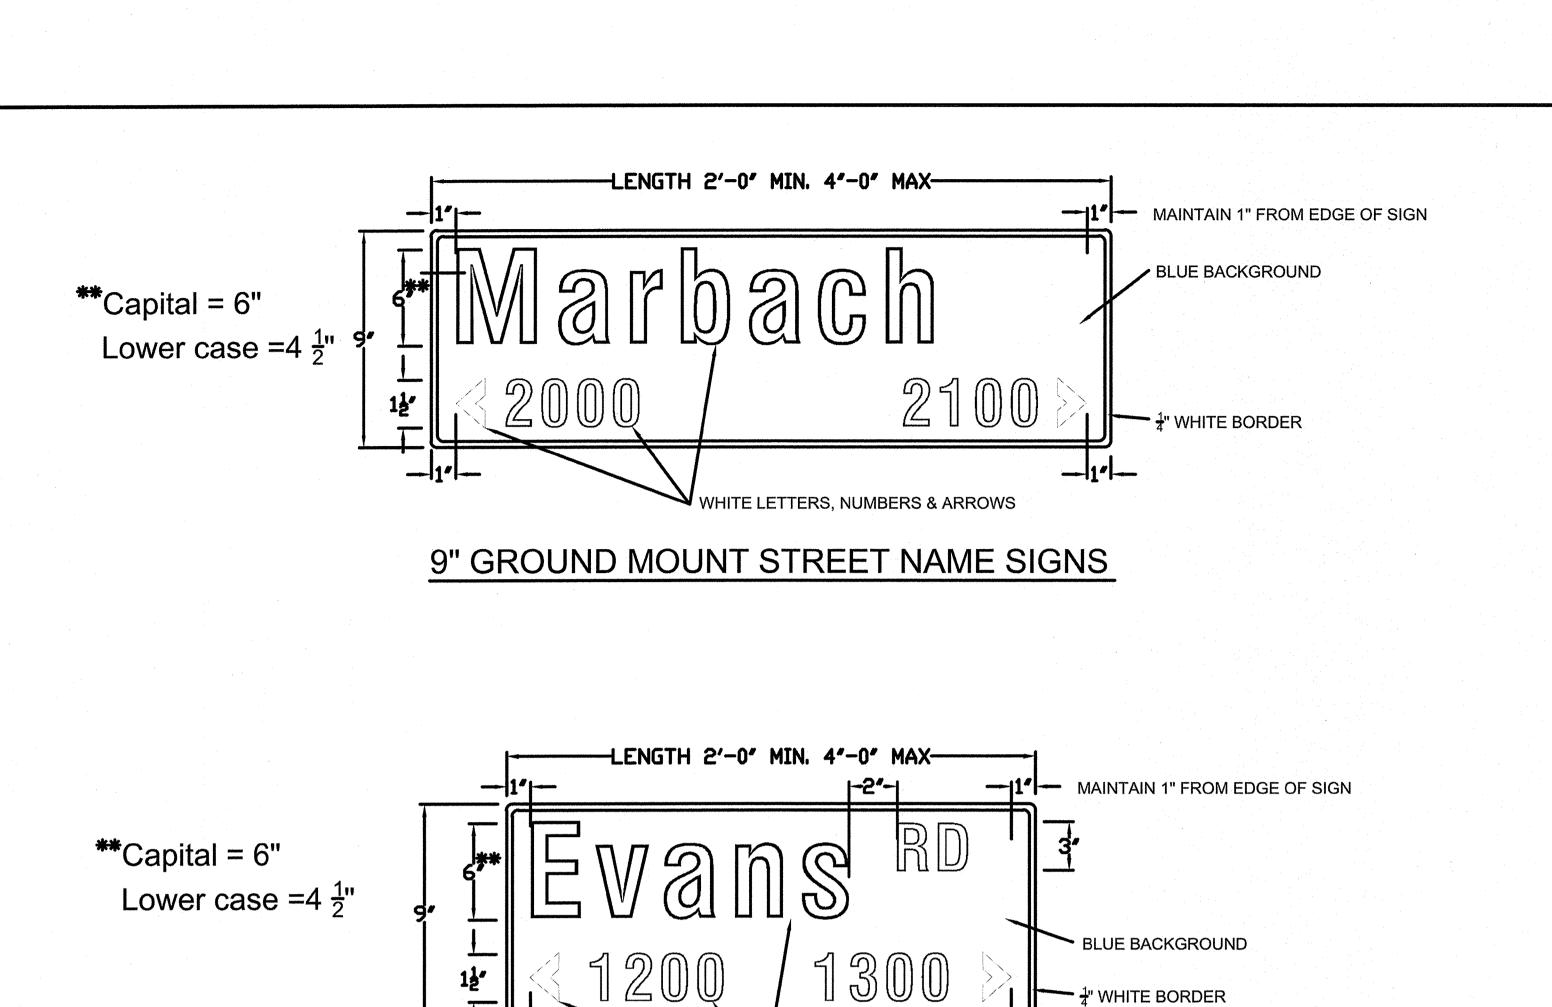

9" GROUND MOUNT STREET NAME SIGNS WITH STREET DESIGNATION

18" OVERHEAD STREET NAME SIGNS

Lower case =6"

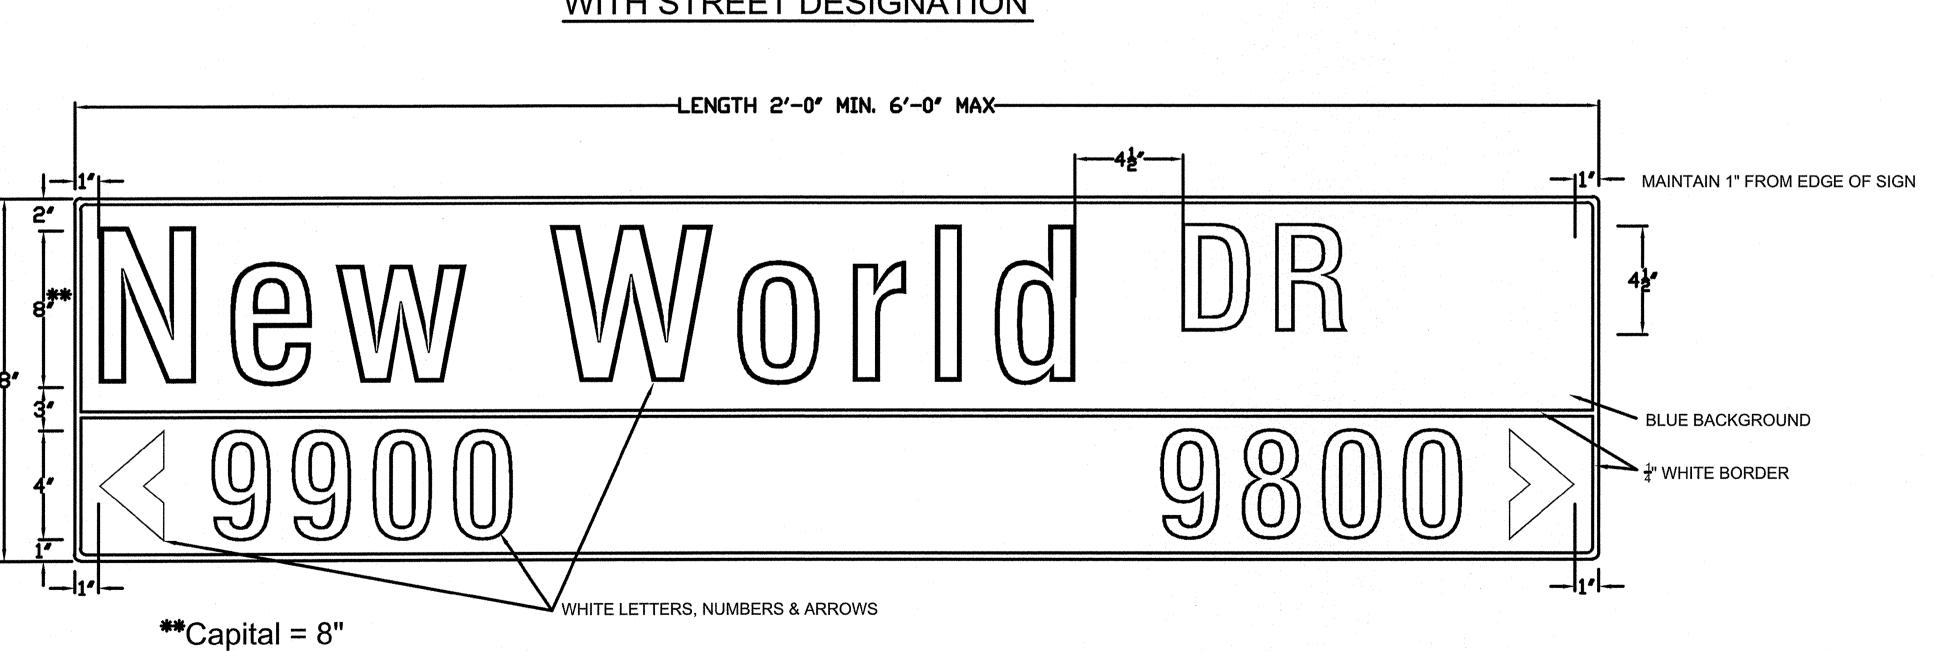



WHITE LETTERS, NUMBERS & ARROWS

— ⅓" WHITE BORDER

	18" OVERHEAD SIGN	9" GROUND MOUNT SIGNS	
HEIGHT	18" (381 mm)	9" (228 mm)	
LENGTH	48" (1200 mm) MIN. 72" (1800 mm) MAX. 1' (300mm) INCREMENTS OF LENGTH	24" (600 mm) MIN. 48" (1200 mm) MAX. 6" (150mm) INCREMENTS OF LENGTH	
THICKNESS	0.125" (3 mm) ALUMINUM ALLOY, 5052-H38 (ASTM B-209 GOLD CHROMATE FINISH		
SUBSTRATE			
SIGN FACE MATERIALS	BLUE FILM <del>**</del> OVER DIAMOND GRADE - ASTM Type XI Non-Fluorescent	BLUE FILM <b>*</b> OVER HIGH INTENSITY PRISMATIC- ASTM Type IV	
LEGENDS AND SYMBOLS	SERIES D, B OR C IF NAME OTHERWISE EXCEEDS MAXIMUM SIGN LENGTH WHITE LEGEND ON BLUE BACKGROUND		
COLOR			
LETTER TRACKING	17% (USUAL) 10% (MIN.)	10%	

\* ACRYLIC ELECTRONIC CUTTABLE FILM

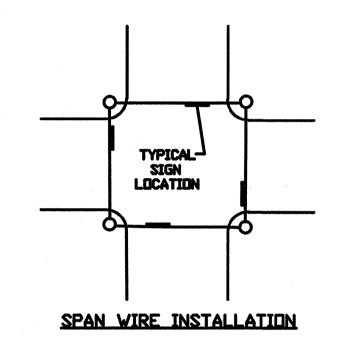

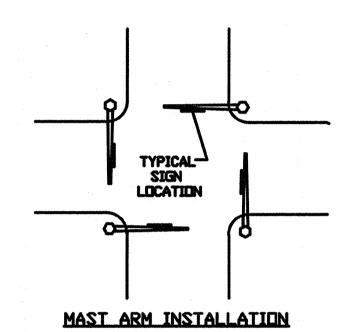


SIGN FACE MATERIALS SHALL CONFORM TO:

- 1. STANDARD SPECIFICATIONS FOR CONSTRUCTION OF ROADS & **BRIDGES ON FEDERAL HIGHWAY** PROJECTS - FP-03 U.S. **CUSTOMARY UNITS SECTION 718**
- 2. GENERAL SERVICES ADMINISTRATION FEDERAL SPECIFICATIONS L-S-300C

3. ASTM D 4956 - 09**€**1

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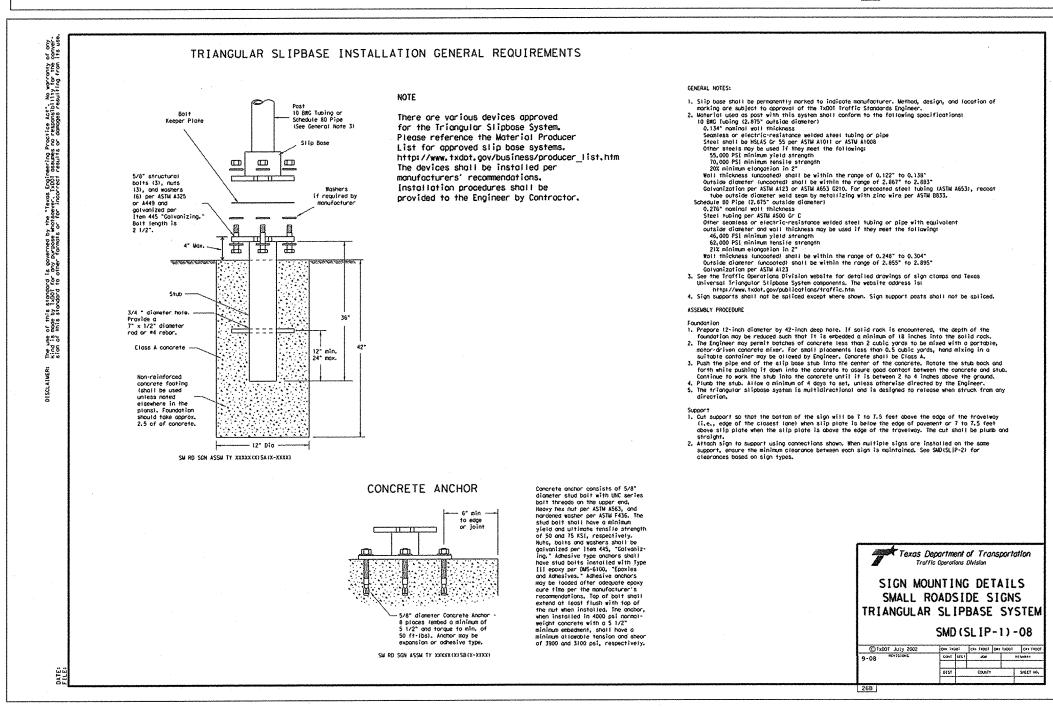
SHEET \_\_1


PHASE, TEXAS SIGNAG ROSE

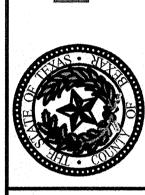
PLAT NO. 22-11800056 DRAWN:SD CHECKED:JM


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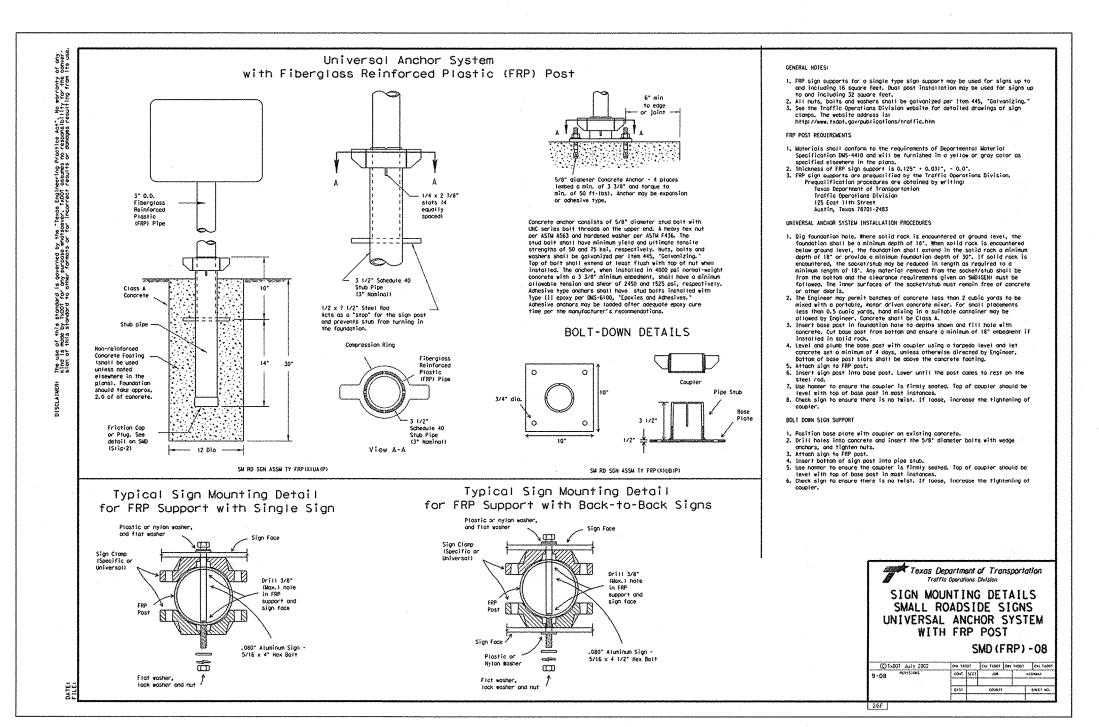
5.12





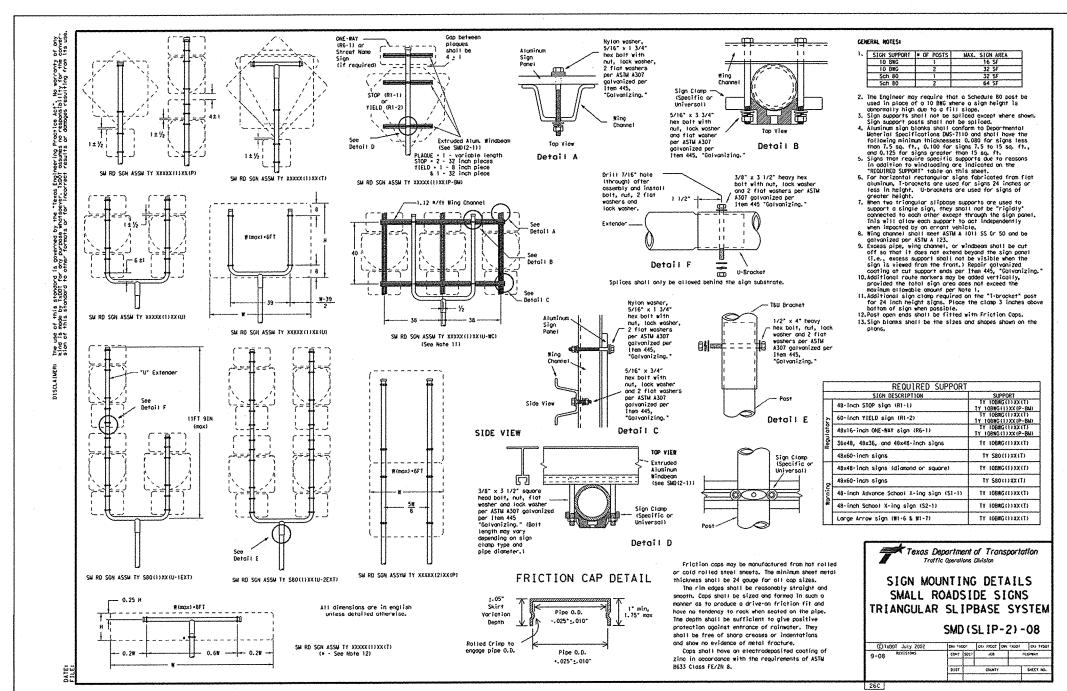


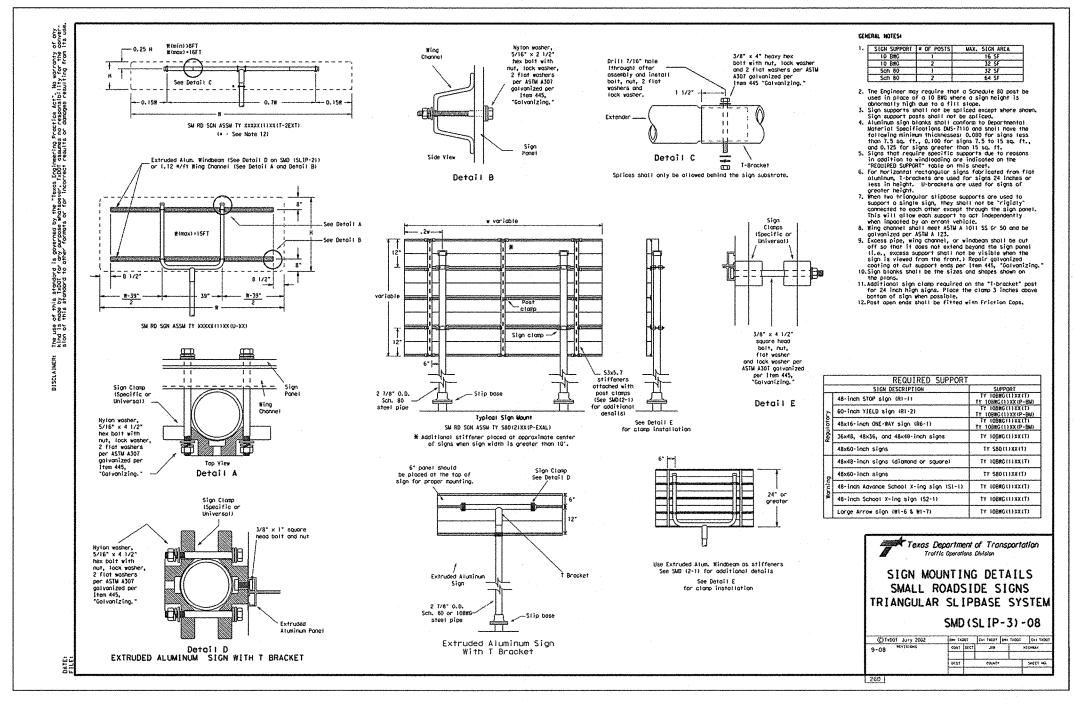

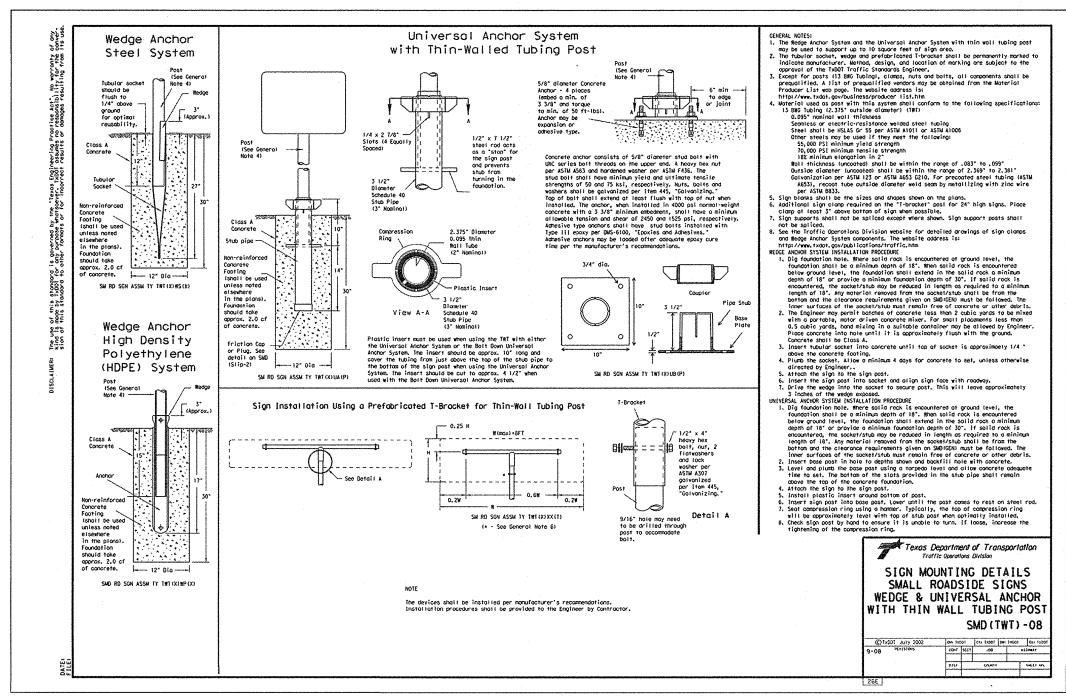

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ENGINEERS + SURVEYING
3421 Paesanos Pkwy, Suite 200, San Antonio, TX 78231
Phone #: (210) 979-8444 • Fax #: (210) 979-8441

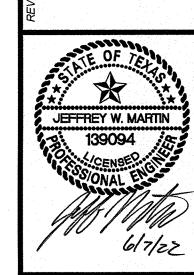

SAN ANTONIO, TEXAS
TRAFFIC SIGNAGE NOTES & DETAIL SHEE

PLAT NO.
22-11800056

JOB NO. 314-51-01


DATE: ---DRAWN:SD CHECKED:JM

SHEET NUMBER:

5.13

# ROSE VALLEY PHASE 1B

## SAN ANTONIO, TEXAS SANITARY SEWER IMPROVEMENTS

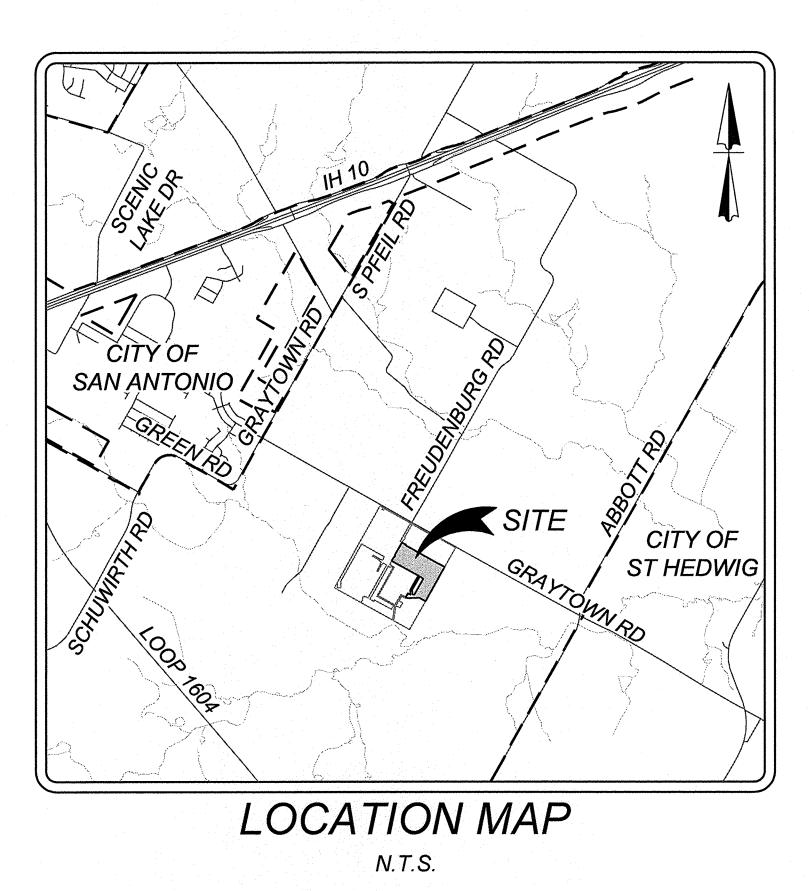

INDEX


DESCRIPTION	SHEET NO.
SANITARY SEWER COVER SHEET	6.0
SANITARY SEWER GENERAL NOTES	6.1
SANITARY SEWER GENERAL NOTES	6.2
OVERALL SANITARY SEWER PLAN (1 OF 2)	6.3
OVERALL SANITARY SEWER PLAN (2 OF 2)	6.4
SEWER LINE H STA 1+00.00 - 8+00.00	6.5
SEWER LINE H STA 8+00.00 - END	6.6
SEWER LINE J STA 1+00.00 - 7+50.00	6.7
SEWER LINE J STA 7+50.00 - END	6.8
SEWER LINE J1 STA 1+00.00 - END	6.9
SEWER EX. LINE A STA 13+50.00 - 24+50.00	6.10
SANITARY SEWER DETAIL SHEET	6.11

OWNER/DEVELOPER: LENNAR HOMES OF TEXAS LAND & CONSTRUCTION LTD. 1922 DRY CREEK WAY, STE. 101 SAN ANTONIO, TX 78259 PHONE: (210) 403-6282





100 E. GUENTHER STREET P.O. BOX 839980 SAN ANTONIO, TEXAS 78283-9980

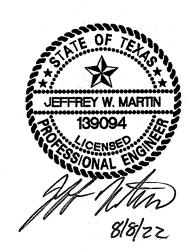



At any time these specifications and drawing may be altered or superseded by the general conditions, specific conditions, or drawing within the bid documents issued for each project.

December 9, 2010 - Revise Interceptors Testing November 2, 2010 - Revise Sewer Pipe SDR 35 to SDR-26 ASTM 115 PSI September 8, 2010 - Infiltration I/I Coating July 30, 2009 - Revise Items 10, 11, 13, 14,14B January 28, 2010 - Revise Sewer Service Laterals (Item 21A, Item 1, 2, 3) January 22, 2010 - Revise Sewer Line Location (Item 23A, Item 1, 2, 3, 4, 5, 6, 7, 8) June 11, 2010 -Update Note 11A -Gator Wrap

GENERAL: THE OWNER, DEVELOPER, ENGINEERING FIRM SHALL SUBMIT TO THE SAN ANTONIO RIVER AUTHORITY (SARA) ENGINEER, FOR APPROVAL, TWO (2) COPIES OF ALL PLATS, PLANS AND PROFILES, PLUMBING LAYOUT, WHICH HAVE BEEN DESIGNED AND THE DRAWINGS SEALED BY A REGISTERED PROFESSIONAL ENGINEER. WHEN APPROVED, ONE (1) COPY WILL BE RETURNED TO THE OWNER DEVELOPER, ENGINEERING FIRM, SO MARKED. THE OWNER WILL BE REQUIRED TO MAKE ALL CHANGES INDICATED BY THE SARA ENGINEER, AND RETURN WITH ALL CHANGES, CORRECTIONS, BACK TO SARA FOR APPROVAL.

- 1. ALL MATERIALS AND CONSTRUCTION PROCEDURES WITHIN THE SCOPE OF THIS CONTRACT SHALL BE APPROVED BY THE SARA AND COMPLY WITH:
- CURRENT SARA TECHNICAL SPECIFICATIONS FOR UTILITIES CONSTRUCTION.
- TEXAS COMMISSION ON ENVIRONMENTAL QUALITY (TCEQ), FORMERLY TEXAS NATURAL RESOURCE CONSERVATION COMMISSION (TNRCC), DESIGN CRITERIA FOR SEWAGE SYSTEMS 31 TAC 317.1, 31 TAC 317.2 AND 31 TAC 317.3., 30 TAC & 213, 30
- THE CONTRACTOR IS TO NOTIFY AND MAKE ARRANGEMENTS WITH THE SARA INSPECTIONS DIVISION AT (210) 302-4210 OR (210) 663-8561 -- 48 HOURS PRIOR TO ANY EXCAVATION. A PRE-CONSTRUCTION CONFERENCE SHALL BE HELD BEFORE ANY EXCAVATION, OR START OF PROJECT.
- 3. WORK SHALL NOT BE PERFORMED ON SATURDAYS, SUNDAYS OR HOLIDAYS BEFORE 7:30 A.M., OR AFTER 4:30 P.M., UNLESS PRIOR APPROVAL IS GRANTED BY THE SARA ENGINEER. A LETTER WILL NEED TO BE FAXED TO (210) 661-9324 FOR ENGINEER APPROVAL (48) HOURS IN ADVANCE.
- THE LOCATIONS AND DEPTHS OF EXISTING UTILITIES TO INCLUDE SURFACE LATERALS, SHOWN IN THESE PLANS ARE APPROXIMATEONLY. IT SHALL BE THE CONTRACTORS RESPONSIBILITY TO LOCATE (POT. HOLE, VERITY LOCATION, ELEVATIONS OF ALL) UTILITYSERVICE LINES 48 HOURS PRIOR TO EXCAVATION AND TO PROTECT THE SAME DURING CONSTRUCTION. CONTRACTOR WILL BE RESPONSIBLE FOR ANY DAMAGES OF EXISTING UTILITIES AND REPAIRS WILL BE AT CONTRACTORS EXPENSE.

SAN ANTONIO WATER SYSTEM (WATER) 704-7817

DRAINAGE 207-5048 1 (800) 828-5127 973-3500 CITY PUBLIC SERVICE 352-4872 TIME WARNER VALERO ENERGY CO. 349-7555 SARA (INSPECTIONS) 210-302-4210 or

210-663-8561

### EXISTING MANHOLES /SEWER

- CONTRACTOR WILL MAINTAIN SERVICE TO ALL EXISTING SANITARY SEWERS AT ALL TIMES DURING CONSTRUCTION. CONTRACTOR WILL MARK, CLEAN ALL DEBRIS, GRAVEL, DIRT, ETC. OUT OF MANHOLES AND ANY STOPPAGES CAUSED BY DEBRIS DURING CONSTRUCTION, CONTRACTOR WILL UNPLUG STOPPAGE AT CONTRACTOR'S EXPENSE. ANY DAMAGE TO EXISTING MANHOLES OR SEWER MAIN WILL BE CORRECTED AT CONTRACTOR'S EXPENSE. CONTRACTOR SHALL TAKE ALL NECESSARY MEASURES TO PREVENT DAMAGE TO EXISTING OR NEW RINGS, COVERS, OR CONES FROM EQUIPMENT AND MATERIALS USED OR TAKEN THROUGH THE WORK AREA. IF AN EXISTING OR NEW MANHOLE COVER, RING, OR CONE IS DAMAGED BY THE CONTRACTOR IT SHALL BE REPLACED AS DIRECTED BY THE SARA INSPECTOR. MANHOLES WILL NEED TO BE RESEALED WITH THE SARA APPROVED SEALING. IF SEAL COATING IS BROKEN, CONTRACTOR WILL HAVE MANHOLE RECOATED. RESEAL ALL LEAKS AT CONTRACTOR EXPENSE.
- CONTRACTOR TO ENSURE ALL PLUGS USED TO PLUG SEWER LINES, WHILE TESTING THE PROJECT (SUCH AS AIR PLUGS, SCREW TYPE PLUGS, ETC.) ARE LABELED. MARKED OR TAGGED. PROJECT INSPECTOR WILL RECORD HOW MANY PLUGS ARE BEING USED, LOCATION AND I.D., WITHIN COLLECTION SYSTEM. CONTRACTOR WILL REPORT TO PROJECT INSPECTOR OF ANY LOST OR UNRESTRAINED PLUGS INTO SEWER COLLECTION SYSTEM.
- CONTRACTOR WILL BE HELD LIABLE FOR ANY DAMAGES TO SEWER COLLECTION SYSTEM STOPPAGES, OVER-FLOWS, BACKUP INTO HOMES CAUSED BY LOST RUN AWAY SEWER PLUGS THAT WERE USED ON THAT PROJECT OR OUTFALL LINE WASTEWATER TREATMENT PLANTS.
- CONTRACTOR WILL ALSO BE RESPONSIBLE FOR ANY DAMAGE TO WASTEWATER TREATMENT APPARATUS, SUCH AS SCREW PUMPS, ETC, CAUSED BY LOST OR RUN AWAY SEWER PLUGS. CONTRACTOR WILL BE HELD LIABLE FOR DAMAGES, AS WELL AS COST OF REPAIRS.
- ALL WORK IN THE TEXAS HIGHWAY DEPARTMENT AND BEXAR COUNTY RIGHT OF WAY SHALL BE DONE IN ACCORDANCE WITH RESPECTIVE CONSTRUCTION SPECIFICATIONS AND PERMIT.
- 6. ALL WORK ON PUBLIC STREETS SHALL BE COORDINATED WITH AND APPROVED BY THE BEXAR COUNTY PUBLIC WORKS DEPARTMENT TRAFFIC DIVISION AND STREET ENGINEER
- DUE TO FEDERAL REGULATIONS TITLE 49, PART 192.161, CITY PUBLIC SERVICE MUST MAINTAIN ACCESS TO GAS VALVES AT ALL TIMES. THE CONTRACTOR MUST PROTECT AND WORK AROUND VALVES THAT ARE IN THE PROJECTED AREAS.
- 8. NO TESTING WILL BE PERFORMED PRIOR TO 30 DAYS FROM THE COMPLETE INSTALLATION OF THE SANITARY SEWER LINES.

THE FOLLOWING SEQUENCE WILL BE STRICTLY ADHERED TO:

- PULL MANDREL- AFTER 30 DAYS OF INSTALLATION PERFORM AIR TEST
- PULL WIPER (AFTER STREET HAS BEEN ASPHALTED IN NEW SUBDIVISIONS)
- VACUUM TEST ALL MANHOLES WITHIN THE PROJECT
- CCTV- ALL NEW LINE PAN /TILL ALL SERVICE LATERALS TO 6"X6" CLEAN OUT .FLOOD ALL LINES BEFOR CCTV, SUMMIT DVD
- CONTRACTOR SHALL SUBMIT FILED COPY PLANS AND PROFILES SHOWING AS-BUILT WORK AT END OF PROJECT, CCTV DVD AND COMPACTION DENSITY REPORTS FOR MAIN SEWER LINE AND ALL SERVICE LATERALS TRENCHS. WARRANTY LETTERS ON MATERIALS, WORKMANSHIP FOR 24 MONTHS AFTER FINAL ACCEPTANCE.

### **MANHOLES**

- 10. ALL MANHOLES SHALL BE CONSTRUCTED SO THAT THE TOP OF THE RING IS AT LEAST FOUR (4) INCHES ABOVE THE FINISHED GRADE OF THE SURROUNDING GROUND EXCEPT WHEN LOCATED IN PAVED AREAS. IN PAVED AREAS THE MANHOLE RING SHALL BE FLUSH WITH THE PAVEMENT. ALL NEW INSTALLED MANHOLES WILL BE WITH A 30" INCH OPENING, MINIMUM, WITH THE SARA LOGO ON THE COVER. EVERY THIRD MANHOLE COVER WILL HAVE A 1" HOLE FOR A VENT.
- ALL MANHOLES SHALL BE WITH A 30" OPENING, HAVE WATERTIGHT RING AND COVERS, WITH THE SARA LOGO, I/I BARRIER, IN ACCORDANCE WITH THE SARA TECHNICAL SPECIFICATIONS FOR UTILITIES CONSTRUCTION. ON PRIVATE PROPERTY, MANHOLE RING AND COVER SHALL BE TYPICAL MANHOLE COVER WATER TIGHT.
- A. BEFORE BACK FILLING/COMPACTION/CONCRETE ENCASTMENT
- ALL MANHOLE JOINT SECTION RISERS, CONE SECTIONS AND GRADE RING SHALL BE WRAPPED WITH GATOR WRAP SEALING SYSTEMS, BUTYL ADHESIVE SEALANT WITH A MINIMUM THICKNESS OF 30 MILS, INFI-SHIELD WRAPPED WITH RISER-WRAP SEALING SYSTEM, GATOR WRAP
- MATERIAL: RUBBER MEETS ASTM C923/MASTIC MEETS ASTM C 990 OR APPROVE BY THE SARA ENGINEER SUBSTITUTION ON OUTSIDE FOR I/I, GROUND WATER TABLE.
- 12. IF CONCRETE THROAT RINGS ARE TO BE INSTALLED THEY MUST BE USED IN CONJUNCTION WITH A UV STABILIZED POLYETHYLENE LINER AND I/I BARRIER. I/I BARRIER MUST MEET THE FOLLOWING ASTM STANDARDS: ASTM D-790/1505 DENSITY OF POLYETHLENE MATERIALS, ASTM D-1238 MELT FLOW INDEX, ASTM 638 TENSILE STRENGTH@ YIELD (50 mm/mm), ASTM 790 FLEXURAL MODULUS, ASTM 648 HEAT DEFLECTION TEMPERATURE @IGEPAL, ASTM 1693 EsCR,100% IGEPAL /10% IGEPAL. A MINIMUM OF TWO AND A MAXIMUM OF FOUR THROAT RINGS WILL BE USED AT EACH MANHOLE FOR ADJUSTMENT.
- INFILTRATION DISHES WILL BE REQUIRED IN MANHOLES WHERE APPLICABLE (I.E, SUCH AS LOW DRAINAGE AREAS) AND EVERY THIRD MANHOLE SHALL BE VENTED. 30" MANHOLE COVER WITH 1" INCH HOLE CENTER OF COVER WHERE APPLICABLE/OR WATER TIGHT /BOLT DOWN.

Note: Manhole cover inserts shall be FRW industries, Inc., "Inflow Protector-Cover" "Preco Industries. Ltd.", "Sewer Guard", or approved equal, and shall be installed in strict accordance with the manufacturer's recommendations. The contractor shall be responsible for making the necessary field measurements for the manufacturer prior to production.

A. ALL MANHOLES MUST HAVE 350-400 FEET SPACING BETWEEN MANHOLES TO PROVIDE ACCESS TO SEWER LINES FOR CLEANING, ON THE SARA PUBLIC SEWER EASEMENT, A 16 FOOT GATE WITH LOCK WILL BE PROVIDE BY CONTRACTOR FOR ACCESS TO CLEANING AND MAINTAIN SEWER LINES.

B. DROP MANHOLES SHALL BE REQUIRED WHEN THE INFLOW ELEVATION IS MORE THAN TWENTY-FOUR (24) INCHES ABOVE THE OUTFLOW ELEVATION. DROP SHALL BE LOCATED OUTSIDE THE MANHOLE WITH ITS FLOWLINE ELEVATION LOCATED BETEEN THE CENTER LINE AND TOP OF SEWER LINE.

- 14. ALL MANHOLES WILL BE CONCRETE ENCASTMENT 1 FOOT AROUND RING, 28-INCH DEEP AFTER GATOR WRAP SEALING SYSTEM HAS BEEN APPLIED.
- 15. NEW MANHOLE PROTECTIVE COATING, LINER IS FOR THE PURPOSE OF I/I INFILTRATION BECAUSE OF HIGH WATER TABLE. APPLICATION PROCEDURES ACCORDANCE WITH MANUFACTURER'S RECOMMENDATION AND PER THE FOLLOWING SPECIFICATIONS:
- A. MANHOLE PROTECTIVE COATING: CONTRACTOR WILL BE RESPONSIBLE FOR MANHOLES ON PROJECT SAFETY ASSESSMENT; CONFINED SPACE ENTRY SET BY OCCUPATIONAL SAFETY AND HEALTH STANDARDS, 29 CFR 1910.146 APP. E.
- B. THE CONTRACTOR, SHALL NOTIFY THE SARA, UTILITIES INSPECTIONS DEPARTMENT WITH A MINIMUM OF 2 DAYS ADVANCE NOTICE OF THE START OF ANY FIELD SURFACE PREPARATION WORK OF COATING APPLICATION WORK OF MANHOLES.

C. ALL NEW MANHOLES IN NEW DEVELOPMENTS SHALL BE 30" OPENING, WATERTIGHT AND THE INTERIOR WALL COATED WITH A SARA APPROVED SEWER STRUCTURE FOR ALL MANHOLES. APPLY A COMBINATION OF BOTH PRODUCTS WITH THE CEMENTITIOUS COATING FIRST, FOLLOWED BY THE EPOXY COATING LAFARGE SEWPERCOAT 2000 HR REGULAR, WITH THE REQUIRED ONE-INCH THICK APPLICATION. THIS IS THE ONLY PRODUCT YET APPROVED WHICH SATISFIES THE REQUIREMENT OF APPLYING THE COMBINATION OF BOTH THE CEMENTITIOUS COATING AND EPOXY COATING

### APPROVED MATERIALS ARE AS FOLLOWS:

CEMENTITIOUS COATING WITH REQUIRED ONE-INCH THICK APPLICATION

- PERMACAST CR 5000
- STRONG-SEAL MS-2C
- STANDARD CEMENT MATERIAL INC PELINER QUADEX ALUMINALINER

### EPOXY COATING: WITH SPECIFIED THICKNESS APPLICATION.

- \* RAVEN 405 SERIES HIGH BUILD EPOXY LINER REQUIRED THICKNESS 125 MILS
- \* SPRAY WALL POLURETHANE SYSTEM REQUIRED THICKNESS 150 MILS
- D. WARRANTY LETTER ON MANHOLE PROTECTIVE COATING FOR 10 YEARS AFTER FINAL ACCEPTANCE OF PROTECTIVE COATINGS CONTRACTOR IS NOT RELIEVED OF ITS RESPONSIBILITIES UNDER THE CONTRACT DOCUMENTS.
  - i. ANY CONNECTIONS TO EXISTING MANHOLES WILL REQUIRE A 36-INCH CRADLE TO SUPPORT INCOMING PIPE. A RUBBER GASKET WILL ALSO BE REQUIRED (CENTERED AT MANHOLE WALL) WITH GROUTING AT INTERIOR AND EXTERIOR PENETRATIONS.
  - PENETRATION INTO MANHOLE WILL BE CORE DRILLED. ANY DAMAGE EXITING MANHOLE WILL BE REPLACED AT CONTRACTOR'S
  - EXPENSE. IF COATING SEAL IS BROKEN, THE MANHOLE WILL BE RECOATED WITH THE SAME MATERIALS. IF EXISTING SEWER MANHOLE SEAL COATING IS BROKEN, ALL OF MANHOLE WILL BE
  - RESEALED WITH SAME MATERIALS.
  - ii. ANY AND ALL EXISTING MANHOLES WITHIN CONSTRUCTION PROJECT THAT TIE IN, ARE DONE BY CONTRACTOR TO STUB-OUT ADJUSTMENT, RECONSTRUCTION, OR LEAKING. MANHOLE WILL BE COAT SEALED AT CONTRACTOR'S EXPENSE.
  - iii. MANHOLES WITH STUB-OUTS (8") INCH OR LARGER MUST BE LOCATED AT THE END OF ALL SEWER LINES THAT MAY BE EXTENDED IN THE FUTURE. MANHOLES PLACED AT THE END OF THE WASTEWATER COLLECTION SYSTEM PIPES THAT MAY BE EXTENDED IN THE FUTURE MUST INCLUDE PIPE STUB-OUTS WITH PLUGS.

### <u>PIPING</u> \*\*\*\*\*\* NEW NOTE \*\*\*\*\*\*

- 16. THE KIND AND DESCRIPTION OF THE PIPE CONDUIT IS SHOWN ON THE PLANS (IF PVC, SDR AND ASTM/ANSI DESIGNATION CLASS). AS SDR 26 PVC, ASTM D-3034 WITH A MINIMUM STIFFNESS OF 115 PSI TEXAS ADMINISTRATIVE CODE (TAC) RILES TO INCLUDE 30 TAC & 213, OR ANY REVISIONS THERE TO APPLICABLE TECQ, 30 TAC 7 217, FOR ALL NEW DEVELOPMENT.
- 17. THE USE OF ASBESTOS CEMENT PIPE WILL BE PROHIBITED UNDER THIS CONTRACT. ALL DUCTILE IRON PIPE USED IN THIS SYSTEM SHALL BE CORROSION PROTECTED ON BOTH THE INTERIOR AND EXTERIOR SURFACES. ALL CORROSION PROTECTION SHALL BE APPLIED AND INSTALLED IN SUCH A MANNER AS TO MAINTAIN A CONTINUOUSLY PROTECTED SURFACE AFTER FINAL PIPE
- 18. ALL PVC SEWER PIPE WITH OVER 14 FEET OF COVER SHALL BE EXTRA STRENGTH; MINIMUM PIPE STIFFNESS OF 150 PSI.
- 19. ALL SEWER PIPES SHALL HAVE COMPRESSION OR MECHANICAL JOINTS.
- 20. SEWER PIPE CONNECTIONS TO PRECAST MANHOLES SHALL BE APPROVED BY THE SARA. THIS CONNECTION SHALL USE A FLEXIBLE "BOOT" TYPE CONNECTOR SUCH AS THE PSX POSITIVE SEAL SYSTEM OR ENGINEER APPROVED EQUAL AND COMPLY WITH ASTM C-923. SEWER PIPE CONNECTIONS TO MONOLITHIC MANHOLES WILL BE AS SHOWN ON THE STANDARD DETAIL SHEET. ANY CHANGES IN THESE METHODS MUST BE APPROVED BY SARA ENGINEER.
- 21. ALL PIPE TRENCHING, BEDDING AND BACKFILL SHALL BE DONE IN ACCORDANCE WITH APPROPRIATE ASTM/ANSI SPECIFICATIONS [REFERENCE 31 TAC 317.2(A)(5)(A); ASTM C-12 (ANSI A106.2) OR ASTM D-2321 (ANSI K65.171)]. All compaction @ 98% density tests across the board, 1 random density test per lift for every 400 feet.
  - A. SAND MIGRATION PREVENTION COLLAR WHEN CHANGING THE INITIAL

BACKFILL FROM SELECT INITIAL BACKFILL TO OPTIONAL SELECT INITIAL BACKFILL. A TWO (2) FOOT LONG CLASS D CONCRETE ENCASEMENT OR FIRMLY COMPACTED, CONSOLIDATED CLAY ENCASEMENT BACKFILL, EVERY 180 FEET ALONG PIPE BETWEEN THE TWO SHALL BE PROVIDED FOR THE ENTIRE HEIGHT OF THE INITIAL AND 20 FEET FROM WALL OF MANHOLE IN EACH DIRECTION.

### B. SEWER LINE LOCATION:

- i. SEWER LINES SHALL BE SIZED AND EXTENDED THROUGH THE LIMITS OF A DEVELOPMENT TO SERVE ADJACENT PROPERTY, WITH MANHOLE AND STUB-OUT AT END OF SEWER LINE.
  - a. IN PHASED CONSTRUCTION OF THOROUGHFARES, THE SEWER LINE SHALL BE EXTENDED THE ENTIRE LENGTH OF THOROUGHFARE BEING CONSTRUCTED.
- NO PUBLIC SEWER LINE SHALL BE LOCATED NEARER THAN FIVE (5) FEET FROM ANY TREE.

iii. SIZES AND GRADES FOR SANITARY SEWER SHALL BE AS REQUIRED BY THE SARA ENGINEER AND CONSIDERATION SHALL BE GIVEN AS TO POSSIBLE EXTENSIONS FOR FUTURE DEVELOPMENT. NO SANITARY SEWERS, OTHER THAN LATERALS AND FORCE MAINS, SHALL BE LESS THAN EIGHT (8) INCH IN DIAMETER.

- 22. WHEN SEWER LATERALS ARE TO BE CONNECTED TO EXISTING SEWER MAINS AND NO STUB-OUT HAS BEEN EARLIER PROVIDED, THE CONNECTION MUST BE MADE WITH AN APPROVED SERVICE SADDLE AS PER 31 TAC 313.5(C) (7). NEW INVERT TO BE BUILT, SMOOTH CHANNEL FOR NEW PIPE/SLOPE AT 2 % FLOW.
- 23. ALL RESIDENTIAL SERVICE LATERALS SHALL BE SDR 26 PVC WITH RATING OF 115 PSI, BE EXTENDED TO THE PROPERTY LINE AT (6 x 6 ) CAPPED AND SEALED. ATTACH SEWER BURIAL TAPE TO THE END OF ALL SEWER LATERALS AND BRING UP TO THE GROUND LEVEL FOR MARKER (GREEN). (SEE HOUSE LATERALS DETAILS).
- A. SEWER SERVICE LATERALS. THE SIZES AND LOCATIONS OF LATERALS SHALL BE DESIGNATED AS FOLLOWS UNLESS OTHERWISE DIRECTED BY THE SARA ENGINEER:

i. IN GENERAL FOR SINGLE FAMILY DWELLING, THE LATERAL SIZE SHALL BE A FOUR (4) INCH MINIMUM. HOUSE LATERALS SHALL BE INSTALLED CENTER OF THE LOT AND SHALL HAVE A TEN (10) FOOT SEPARATION FROM THE WATER SERVICE. THE SERVICE SHALL THEN BE EXTENDED AT A FORTY-FIVE (45) DEGREE ANGLE TO FOUR (4) FEET ABOVE THE FINISHED GRADE AND CAPPED. USE SEWER BURIAL TAPE TO MARK ALL SEWER SERVICE LATERALS.

ii. MULTIPLE UNITS, APARTMENTS, LOCAL RETAIL AND COMMERCIAL SIX (6) INCH MINIMUM, MANUFACTURING AND INDUSTRIAL -EIGHT (8) INCH MINIMUM, OR LARGER AS REQUIRED.

### TRAPS AND INTERCEPTORS (FOG - TECQ)

UNIFORM PLUMBING CODE, CITY OF SAN ANTONIO BUILDING INSPECTIONS DEPARTMENT, ALL COMMERCIAL BUILINGS WILL HAVE TRAPS (FOG -TECQ).

### OIL SEPARATORS

WHICH INCLUDE OIL SEPARATOR- GASOLINE SERVICE STATIONS, CAR WASHES, GARAGES, DRY CLEANERS, CHEMICAL PLANTS, GAS PLANTS, HIDE PROCESSORS, TESTING LABORATORIES, OR ANY PLACE WHERE OIL OR SOLVENTS MAY BE INTRODUCED INTO THE SANITARY SEWER SYSTEM.THE SIZING CRITERIA FOR OIL SEPARATORS SHALL BE BASED ON THE G.P.M. RATE OF ALL FIXTURES. APPLIANCE OR APPURTENANCE. DRAINING INTO SEWER SYSTEM.

### SAND INTERCEPTORS

SAND INTERCEPTORS SHALL BE INSTALLED IN THE SEWER SYSTEM OF THE FOLLOWING ESTABLISHMENTS, GARAGES, CAR WASHES, SERVICE STATIONS, OR ANY PLACE OF BUSINESS WHERE HEAVY SOLIDS MAY BE INTRODUCED INTO THE SANITARY SEWER SYSTEM. THE SIZING CRITERIA FOR A SAND INTERCEPTOR SHALL BE BASED ON THE REQUIRED G.P.M. x 12 MINUTE RETENTION TIMES TO OBTAIN THE TANK SIZE IN GALLONS CAPACITY.

### **AUTOMATIC CAR WASHES**

WITH HIGH PRESSURE SPRAYS AND /OR BRUSHES INSTALL A 50

G.P.M. INTERCEPTOR.MINIMUM, FOR A 4-BAY VEHICLE WASH, THE SIZE OF THE INTERCEPTOR SHALL INCREASE 10 G.P.M. FOR EACH ADDITIONAL WASH BAY OVER 4. SINGLE BAY OR PORTABLE WASHER TYPE VEHICLE WASHES SHALL INSTALL A 20 GPM INTERCEPTOR


### **NEUTRALIZING DEVICES**

IN NO CASE SHALL CORROSIVE LIQUIDS, SPENT ACIDS, OR OTHER

HARMFUL CHEMICALS WHICH MIGHT DESTROY OR INJURE A

DRAIN, SEWER, SOIL, OR WASTE PIPE, OR WHICH MIGHT CREATE NOXIOUS OR TOXIC FUMES, DISCHARGE INTO THE SANITARY SEWER SYSTEM WITHOUT BEING THOROUGHLY NEUTRALIZED BY PASSING THROUGH A PROPERLY CONSTRUCTED AND ACCEPTABLE NEUTRALIZING DEVICE. SUCH DEVICE SHALL BE PROVIDED WITH A SUFFICIENT INTAKE OF NEUTRALIZING MEDIUM, CONSISTING OF LIMESTONE OR MARBLE CHIPS, SO AS TO MAKE ITS CONTENTS NON-INJURIOUS BEFORE BEING DISCHARGED INTO THE SANITARY SEWER SYSTEM.

THIS DOCUMENT HAS BEEN PRODUCED FROM MATERIAL THAT WAS STORED AND/OR TRANSMITTED ELECTRONICALLY AND MAY HAVE BEEN INADVERTENTLY ALTERED. RELY ONLY ON FINAL HARDCOPY MATERIALS BEARING THE CONSULTANT'S ORIGINAL SIGNATURE AND SEAL

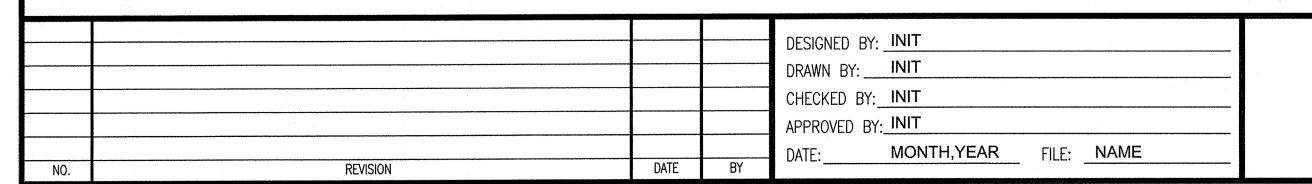



SAN ANTONIO RIVER AUTHORITY

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JOB NO. 314-51-01 DATE: ----DRAWN:SD CHECKED:JM SHEET NUMBER:

6.

### SILVER RECOVERY UNITS

SILVER RECOVERY UNITS SHALL BE INSTALLED IN WASTE LINE(S) LEADING FROM X- RAY PROCESSING, PHOTOGRAPHIC PROCESSING, AND /OR ANY PROCEDURES IN ESTABLISHMENT SUCH AS MEDICAL LABS, DENTAL LABS, PHOTO FINISHERS, PRINTERS, GRAPHIC ARTS PRODUCTION FACILITIES, HOSPITAL, FACILITIES, VETERINARY HOSPITALS, OR OTHER ESTABLISHMENTS WHERE SILVER MAY BE INTRODUCED INTO THE SANITARY SEWER SYSTEM.

### SOLIDS INTERCEPTORS

SOLIDS INTERCEPTORS SHALL BE INSTALLED WHEN PRE-TREATMENT OF WASTE STREAMS IS NECESSARY TO PREVENT SOLIDS GREATER THAN ½" IN DIAMTER, WHICH MAY CAUSE LINE STOPPAGE FROM ENTERING THE SANITARY SEWER SYSTEM.

### INTERCEPTORS

- a. INTERCEPTORS SHALL BE CONSTRUCTED IN ACCORDANCE WITH THE DESIGN APPROVED BY THE SAN ANTONIO RIVER AUTHORITY CONSISTING OF A MINIMUM OF TWO COMPARTMENTS WITH FITTINGS DESIGNED FOR GREASE RETENTION AND PROVIDE FOR A MINIMUM OF TWELVE (12) MINUTES RETENTION.
- b. THERE SHALL BE AN ADEQUATE NUMBER OF MANHOLES TO PROVIDE ACCESS FOR CLEANING ALL AREAS OF AN INTERCEPTOR, ONE MANHOLE PER TRAP COMPARTMENT. MANHOLE COVERS SHALL BE GAS TIGHT IN CONSTRUCTION HAVING A MINIMUM OPENING DIMENSION OF 20 INCH INCHES (0.5 M).
- c. IN AREAS WHERE TRAFFIC MAY EXIST THE INTERCEPTOR SHALL BE DESIGNED TO HAVE ADEQUATE REINFORCMENT AND COVER.
- d. ALL INTERCEPTORS SHALL HAVE THE SIZE OF THE INTERCEPTOR (IN GALLON PER MINUTE OR GALLON CAPACITY) PERMANENTLY AFFIXED TO THE DEVICE.
- e. ALL CONCRETE UTILIZED IN THE CONSTRUCTION OF INTERCEPTOR SHALL HAVE A MINIMUM STRENGTH OF 3000 PSI.
- f. AN EFFLUENT SAMPLING WELL ON ALL INTERCEPTORS SHALL BE REQUIRED. THE SAMPLE WELL SHALL HAVE A RISER A MINIMUM OF 6" INCHES IN DIAMETER AND SHALL BE INSTALLED AFTER THE CONFLUENCE OF ALL WASTE STREAMS FROM THE FACILITY AND PRIOR TO DISCHARGING INTO SANITARY SEWER COLLECTION SYSTEM. THE WELL SHALL BE PERPENDICULAR TO THE EFFLUENT LATERAL TO ALLOW VISUAL OBSERVATION OF THE FLOW STREAM AND PROVIDE FOR SAMPLING OF WASTE WATER.

### WATER TIGHT TESTING (24 HOURS)

g. ALL INTERCEPTORS SHALL BE WATER TESTED OUT AT JOB SITE AFTER BEING INSTALLED (PLUG BOTH ENDS AND FILL TO TOP OF INTERCEPTOR). INTERCEPTOR SHALL SHOW NO LEAKAGE FROM SECTION SEAMS, PINHOLES, OR OTHER IMPERFECTIONS. ANY LEAKAGE IS CAUSE FOR REJECTION. WHEN LEAKAGE OCCURS, ADDITIONAL WATER TESTING SHALL BE MADE. AFTER CORRECTING MEASURE TEST, REPORTS SHALL SHOW TOTAL NUMBER OF INTERCEPTERS TESTED. WHEN LEAKAGE OCCURS CORRECTIVE MEASURES TAKEN SHALL BE REPORTED BY THE SARA INSPECTORS. SARA INSPECTORS SHALL RECORD IN DAILY LOG WITH PROJECT NAME, DATE IT WAS TESTED AND COMPLETED.

LATERALS WHERE THEY CONNECT TO THE MAIN.

DEEPER THAN TWELVE (12) FEET.

B. MANHOLES WILL BE REQUIRED ON SIX (6) INCH AND LARGER

- A. LATERALS WILL NOT BE ATTACHED TO SEWER MAINS THAT ARE
- B. FITTINGS ARE NOT PERMITTED ON LATERALS BETWEEN THE WYE AND THE PROPERTY LINE.
- C. DEEP CUT OR DROP CONNECTIONS SHALL NOT BE PERMITTED.
- F. A MINIMUM OF ONE (1) LATERAL PER BUILDING SHALL BE REQUIRED.
- ALSO, A MINIMUM OF ONE (1) LATERAL PER RESIDENTIAL LOT SHALL BE REQUIRED. DUPLEXES SHALL HAVE TWO (2) LATERALS THAT SHALL BE INDEPENDENTLY ATTACHED TO THE MAIN
- G. ALL SEWER LATERAL CROSSING WATER MAINS SHALL CONFORM TO THE REQUIREMENTS OF THE TCEQ CHAPTER 317 (DESIGN CRITERIA FOR SEWERAGE SYSTEMS) LATEST REVISION, SDR 26 150 PSI, OR DUCT IRON PIPE, CONCRETE ENCASMENT.
- 24. WHERE REQUIRED CONCRETE ENCASEMENT SHALL BE PLACED FOR
  FULL WIDTH OF THE TRENCH TO A PLAIN SIX (6) INCHES ABOVE THE TOP OF THE PIPE WITH PAY UNITS AS SHOWN ON
  THE STANDARD DETAIL SHEET.
- 25. A MINIMUM OF FOUR (4) FEET OF COVER IS TO BE MAINTAINED OVER THE SANITARY SEWER MAIN AND LATERALS AT GRADE, OTHERWISE CONCRETE ENCASEMENT IS REQUIRED.
- 26. WHERE POROUS MATERIAL INCLUDING "SUBGRADE FILLER" IS USED FOR BACKFLL IN THE BEDDING AND INITIAL BACKFILL ZONES, SEEPAGE RETAINERS ARE REQUIRED AT AN APPROXIMATE OF 180 FEET. RETAINERS SHALL CONSIST OF CLASS "D" CONCRETE ENCASEMENT OR FIRMLY COMPACTED. CONSOLIDATED CLAY ENCASEMENT, THE RETAINERS SHALL EXTEND FROM THE BOTTOM OF THE TRENCH TO THE TOP OF THE GRANULAR MATERIAL FOR THE ENTIRE TRENCH WIDTH. ENCASEMENT SHALL BE 24 INCHES LONG. NO EXTRA PAY ITEM.

### BLASTING

27. WHEN ALLOWABLE, BLASTING SHALL BE PERFORMED IN ACCORDANCE WITH THE ABOVE CRITERIA ESTABLISHED BY THE NATIONAL FIRE PROTECTION ASSOCIATION 312 TAC 313.5(C) (6).

- 28. BLASTING SEWER LINE EXCAVATION MUST BE DONE IN SUCH A MANNER AS TO MINIMIZE THE FRACTURING OF ROCK BEYOND THE REQUIRED EXCAVATION. THE CONTRACTOR SHALL CONSIDER THE ELEVATION OF THE EXISTING SANITARY SEWER MAIN IN RELATION TO THE BLASTING CHARGE AND RELATIVE DIRECTION OF EXISTING AND PROPOSED TRENCHES. BLASTING WITHIN SUCH AREAS SHALL BE ACCOMPLISHED ONLY BY QUALIFIED BLASTING CONTRACTORS WHO HOLD BLASTING LICENSES FROM A QUALIFIED AGENCY SUCH AS THE SAN ANTONIO FIRE DEPARTMENT IN BEXAR COUNTY. ANY DAMAGE TO EXISTING SANITARY SEWERS RESULTING FROM BLASTING SHALL BE REPAIRED AND RESTORED BY THE CONTRACTOR AT HIS OWN EXPENSE.
- 29. NO BLASTING SHALL BE PERFORMED WITHIN 75 FEET OF EXISTING UTILITIES.

### TESTING

- 30. ALL SEWER LINES MUST BE TESTED IN ACCORDANCE WITH THE FOLLOWING:
- A. 317.2(A)(5)(B); DEFLECTION TEST FOR FLEXIBLE AND SEMI-RIGID PIPE CONDUCTED AFTER FINAL BACKFILL HAS BEEN IN PLACED AT LEAST 30 DAYS.
- B. 317.2(A)(4)(A) & (B) OR SARA SPECIFICATIONS INFILTRATION AND OR EXFILTRATION AND OR LOW-PRESSURE AIR TEST.
- C. 313.5(C)(10)(C) OR SARA SPECIFICATIONS: ALL MANHOLES AND WET WELLS MUST BE TESTED SEPARATELY AND INDEPENDENTLY OF THE COLLECTION LINES.
- IN THE EVENT THAT TESTING REQUIREMENTS CONFLICT, THE LATEST TCEQ DESIGN CRITERIA SHALL BE USED.
- 31. SEWER LINES SHALL BE TESTED FROM MANHOLE TO MANHOLE.
- 32. SANITARY SEWER CONNECTIONS MADE DIRECTLY TO EXISTING MANHOLES WHICH REQUIRE PENETRATION INTO THE MANHOLE WILL BE CORE DRILLED. ANY DAMAGE TO EXISTING MANHOLE WILL BE REPLACED AT CONTRACTOR'S EXPENSE AND WILL REQUIRE SUCCESSFUL TESTING OF THE EXISTING MANHOLE IN ACCORDANCE WITH THE SARA SPECIFICATIONS. THEY MUST HAVE A PROTECTIVE COATING WITH SEWPERCOAT, RAVEN 405, SAUEREISEN 210, SPRAY WALL, OR APPROVED EQUIVALENT BY THE ENGINEER, COATING WILL BE MINIMUM OF 200 MILS THICKNESS DEPENDING ON EXISTING CONDITIONS, TO PREVENT INFRASTRUCTURE INFILTRATION, FOLLOW MANUFACTURER'S RECOMMENDATION ON PROTECTIVE COATING.
- 33. AFTER CONSTRUCTION, TESTING WILL BE DONE BY PAN/TILT TV CAMERA BY THE CONTRACTOR AND OBSERVED BY THE INSPECTOR, WASTEWATER ENGINEERING PERSONNEL AND CONTRACTOR AS CAMERA IS RUN THROUGH THE LINES. PAN/TILT ALL 6" SERVICE LATERALS TO 6"X6" STUB-OUT. VIDEOS MUST INCLUDE SUBDIVISION NAME, MANHOLE NUMBER, SERVICE LATERAL STATION NUMBER, FLOW DIRECTION, LOCATION ANY ABNORMALITIES, SUCH AS BROKEN PIPE OR MISALIGNED, JOINT, GRAVEL, DIRT, MUST BE CLEANED OUT, REPLACE AT CONTRACTOR'S EXPENSE. NEW SEWER SYSTEM WILL BE FLOODED WITH H20 BEFORE BEING TV. ALL SEWER LINES MUST BE PRESSURE CLEANED TO INCLUDE SERVICE LATERALS 6" INCH TO STUB-OUT. ALL VIDEOS SHALL BE SUBMITTED IN DVD FORMAT WITH WRITTEN REPORTS.
- 34. A COPY OF ALL TESTING REPORTS INCLUDING BACKFILL COMPACTION TESTS SHALL BE FORWARDED TO THE SARA.
- A. DENSITY TEST WILL BE REQUIRED ON ALL SANITARY SEWER TRENCHES INCLUDING SERVICE LATERALS. SERVICE LATERALS TO BE CHOSEN RANDOMLY BY FIELD INSPECTOR. DENSITIES ON SERVICE LATERAL SHALL NOT EXCEED 25% OF TOTAL NUMBER OF SERVICE.

### **EXCAVATION**

- 35. CONTRACTOR AND/OR CONTRACTOR'S INDEPENDENTLY RETAINED EMPLOYEE OR STRUCTURAL DESIGN/GEOTECHNICAL/SAFETY/EQUIPMENT CONSULTANT, IF ANY, SHALL REVIEW THESE PLANS AND AVAILABLE GEOTECHNICAL INFORMATION AND THE ANTICIPATED INSTALLATION SITE(S) WITHIN THE PROJECT WORK AREA IN ORDER TO IMPLEMENT CONTRACTORS TRENCH EXCAVATION SAFETY PROTECTION SYSTEMS, PROGRAMS AND/OR PROCEDURES. THE CONTRACTORS IMPLEMENTATION OF THE SYSTEMS, PROGRAMS AND/OR PROCEDURES SHALL PROVIDE FOR ADEQUATE TRENCH EXCAVATION SAFETY PROTECTION THAT COMPLIES WITH AS A MINIMUM OSHA STANDARDS FOR TRENCH EXCAVATIONS. SPECIALLY, CONTRACTOR AND/OR CONTRACTORS INDEPENDENTLY RETAINED EMPLOYEE OR SAFETY CONSULTANT SHALL IMPLEMENT A TRENCH SAFETY PROGRAM IN ACCORDANCE WITHIN OSHA STANDARDS GOVERNING THE PRESENCE AND ACTIVITIES OF INDIVIDUALS WORKING IN AND AROUND TRENCH EXCAVATION.
- 36. CONTRACTOR IS RESPONSIBLE FOR REMOVAL OF ALL WASTE MATERIALS UPON PROJECT COMPLETION. THE CONTRACTOR SHALL NOT PERMANENTLY PLACE ANY WASTE MATERIALS IN THE 100 YEAR FLOODPLAIN WITHOUT AN APPROVED FLOODPLAIN PERMIT.
- 37. WATER JETTING THE BACKFILL WITHIN A STREET WILL NOT BE PERMITTED. SANITARY SEWER TRENCHES SUBJECT TO TRAFFIC SHALL CONFORM TO SARA SPECIFICATIONS.

### WATERLINE CROSSING

38. WHERE THE MINIMUM 9 FOOT SEPARATION DISTANCE BETWEEN SEWER LINES AND WATERLINES, MAINS CANNOT BE MAINTAINED. THE INSTALLATION OF SEWER LINES SHALL BE IN STRICT ACCORDANCE WITH THE TCEQ RULES (31 TAC 317.3 APPENDIX E), SDR 26 ASTM 150 PSI OR CONCRETE ENCASTMENT DUCT IRON.

### EROSION AND SEDIMENTATION

- 39. THE TCEQ AND THE ENVIRONMENTAL PROTECTION AGENCY (EPA) REQUIRE EROSION AND SEDIMENTATION CONTROL FOR CONSTRUCTION OF SEWER COLLECTION SYSTEMS. DEVELOPER OR AUTHORIZED REPRESENTATIVE SHALL PROVIDE EROSION AND SEDIMENTATION CONTROL AS NOTED ON THE PROJECTS PLAN AND PROFILE SHEETS.
- 40. ALL TEMPORARY EROSION AND SEDIMENTATION CONTROLS SHALL BE REMOVED BY THE CONTRACTOR AT FINAL ACCEPTANCE OF THE PROJECT BY THE SARA.

### SUPPLEMENTING

- 41. NO EXTRA PAYMENT SHALL BE ALLOWED FOR WORK CALLED FOR ON THE PLANS BUT NOT INCLUDED ON THE BID SCHEDULE. THIS INCIDENTAL WORK WILL BE REQUIRED AND SHALL BE INCLUDED UNDER PAY ITEM 10 WHICH IT RELATES TO.
- 42. UNLESS THE DEVELOPMENT IS PRIVATELY OWNED, THE DEVELOPER DEDICATES THE SANITARY SEWER MAIN AND MANHOLES TO THE SARA, UPON COMPLETION BY THE DEVELOPER AND FINAL ACCEPTANCE BY THE SARA. SARA WILL OWN AND MAINTAIN SAID SANITARY SEWER MAINS AND MANHOLES WHICH ARE LOCATED WITHIN THIS PARTICULAR SUBDIVISION.
- 43. WORK COMPLETED BY CONTRACTOR WHICH HAS NOT RECEIVED A WORK ORDER OR THE CONSENT OF THE SARA CONSTRUCTION INSPECTION DIVISION WILL BE SUBJECT TO REMOVAL AND REPLACEMENT BY AND AT THE EXPENSE OF THE CONTRACTOR

- 44. SARA IS NOT TO BE RESPONSIBLE FOR ANY ABNORMALITIES ON STUB OUT, INVERT, GRADE OR SLOPE FOR ANY EXISTING MANHOLE TIE IN OR SERVICE LATERAL TIE IN.
- 45. ENGINEER, DEVELOPER AND BUILDER, WILL HAVE PLUMBER AND CONTRACTOR WITH BID PRICE ON NEW INSTALLATION OF ALL 4" INCH SEWER SERVICE LATERALS TO COMPLY WITH TRENCH SAFETY (OSHA) SHORING PROTECTION ON ALL NEW INSTALLATION OF 4" INCH SEWER SERVICE LATERALS. SARA WILL NOT BE HELD RESPONSIBLE FOR ANY INJURIES OR DEATH CAUSED BY TRENCH FAILURE, OR A WRONG OR DAMAGE DONE TO A PERSON OR TO HIS PROPERTY. OSHA GOVERNING THE PRESENCE AND ACTIVITIES OF INDIVIDUALS WORKING IN AND AROUND TRENCH EXCAVATION.
- 46. ALL 4" INCH SEWER SERVICE LATERALS WILL BE HYDRAULIC TESTED AND OR LOW AIR PRESSURE TESTED. ALL 4" INCH SEWER SERVICE LATERALS WILL BE TELEVISED (TV) FROM 4" INCH CLEAN OUT AT OUTSIDE EACH RESIDENCE TO 6" X 6" CLEAN OUT. CONTRACTOR AND PLUMBER WILL SUBMIT REPORTS AND/OR VIDEOS TO SARA, WITH THE FOLLOWING INFORMATION: SUBDIVISION NAME, LOT NUMBER, BLOCK NUMBER, STATION NUMBER, STREET NAME AND ADDRESS OF EACH SEWER SERVICE LATERAL.

PLUMBER WILL BE PROVIDED PLAN/PROFILE BY ENGINEER/BUILDER. PLUMBER WILL WORK CLOSELY WITH THE SARA PROJECT INSPECTOR ON DAILY TESTING AND TELEVISION BY MAKING ARRANGEMENTS 48 HOURS IN ADVANCE. SEWER SERVICE LATERALS THAT HAVE NOT BEEN INSPECTED OR APPROVED AND/OR COVERED UP, WILL HAVE TO BE RE-DUG AT CONTRACTOR/PLUMBER EXPENSE AND RE-INSPECTED.

- A. A PROPERTY LINE CLEANOUT (6"x 6") SHALL BE INSTALLED FOR RESIDENTIAL SERVICES. CLEANOUTS IN THE SIDEWALK OR DRIVEWAY SHALL HAVE A CAST IRON BOOT. CLEANOUT NOT LOCATED IN A SIDEWALK OR DRIVEWAY SHALL BE LOCATED ON A REINFORCED CONCRETE PAD A MINIMUM OF TWELVE (12") INCHES BY TWELVE (12"). INCHES BY SIX (6") INCHES THICK. ALL PROPERTY LINE CLEANOUTS SHALL INCLUDE A LID WITH SEWER IN GREEN COLOR.
- 47. N1 FENCING: ANY AND ALL FENCING, INCLUDING ELECTRIC FENCE, WHETHER OR NOT IDENTIFIED ON THE PLANS, MUST BE MAINTAINED AT ALL TIMES. ANY AND ALL DAMAGES DIRECTLY ATTRIBUTED TO THE CONTRACTOR MUST BE REPLACED TO EQUAL OR BETTER CONDITIONS AT THE CONTRACTORS EXPENSE AND AS APPROVED BY THE PROJECT MANAGER. GAPS IN THE FENCING MUST BE PROVIDED AT ALL LOCATIONS WHERE THE SEWER LINE EASEMENT CROSSES FENCING. FENCING REQUIRED TO MAINTAIN LIVESTOCK MUST BE MAINTAINED AT ALL TIMES.
- 48. N2 DAMAGE TO ADJACENT LAND: THE CONTRACTOR MUST AVOID DAMAGE TO ADJACENT LAND OUTSIDE THE IDENTIFIED CONSTRUCTION LIMITS. ANY AND ALL CLAIMS DIRECTLY ATTRIBUTED TO THE CONTRACTOR RESULTING FROM HIS STRAYING BEYOND THE CONSTRUCTION LIMITS MUST BE SETTLED BY THE CONTRACTOR TO THE SATISFACTION OF THE ENGINEER WITH THE APPROPRIATE LANDOWNER
- 49. N3 PROPERTY OWNER ACCESS: THE CONTRACTOR MUST MAINTAIN ACCESS FOR PRIVATE INDIVIDUALS AT ALL TIMES. IF NORMAL ACCESS IS DAMAGED DURING CONSTRUCTION THE CONTRACTOR MUST REPLACE THE ACCESS TO EQUAL OR BETTER CONDITIONS AT THE CONTRACTORS EXPENSE, AS APPROVED BY THE ENGINEER.
- 50. N4 CONTRACTOR IS RESPONSIBLE FOR LOCATING AND PROTECTING ALL UTILITIES WHETHER OR NOT SHOWN ON THE PLANS. SHOULD THE CONTRACTOR DAMAGE ANY UTILITIES THE CONTRACTOR WILL BE RESPONSIBLE FOR ALL COSTS TO REPAIR THE UTILITIES TO THEIR ORIGINAL CONDITION. CONTRACTOR IS SOLELY RESPONSIBLE FOR LOST REVENUE, LOSSES ETC. CLAMED BY UTILITY COMPANIES DUE TO CONTRACTORS WORK. CONTRACTOR SHALL NOTIFY SARA AND IMPACTED UTILITY COMPANIES 48 HRS. PRIOR TO BEGINNING WORK. CONTRACTOR SHALL VERIFY THE LOCATION OF UTILITIES AND REPORT ANY DISCREPANCIES TO THE ENGINEER.
- 51. N5 CLEARING PERMANENT EASEMENTS: THE LIMITS OF BOTH THE EXISTING AND PARALLEL SEWER LINES PERMANENT EASEMENTS, AS DELINEATED IN THESE PLANS, MUST BE CLEARED IN ACCORDANCE WITH THE SPECIFICATION. THE CONTRACTOR MAY BE DIRECTED BY THE ENGINEER TO PROTECT AND AVOID CERTAIN TREES WITHIN THE LIMITS OF THE PERMANENT AND TEMPORARY CONSTRUCTION EASEMENTS. ALL BRUSH MUST BE REMOVED FROM SITE, NO BRUSH PILES TO REMAIN AFTER CONSTRUCTION. BURNING OF BRUSH OR TRASH WILL NOT BE ACCEPTABLE.
- 52. N7 CONTRACTOR SHALL PROVIDE APPROPRIATE SAFE ACCESS AND BARRICADE WORK AT ALL TIMES TO PROTECT THE PUBLIC. THIS INCLUDES SUBSTANTIAL BARRICADES AROUND ALL TRENCHES, BORE PITS, OPEN EXCAVATIONS, EQUIPMENT ETC. THE SITE MUST BE LEFT IN A SECURE SAFE CONDITION AT NIGHT. IT IS THE CONTRACTORS RESPONSIBILITY TO TAKE NECESSARY PRECAUTIONS TO PROTECT THE PUBLIC THROUGHOUT THE DURATION OF THE PROJECT.
- 53. N14 SHOULD CONTRACTOR SELECT A TRENCH EXCAVATION PROCEDURE THAT EXTENDS THE LIMITS OF SEEDING OR PAVING AND FINAL SITE PREPARATION (I.E. SLOPE BACK PROTECTION SYSTEM) HE WILL BE RESPONSIBLE FOR MEETING PLAN AND SPECIFICATION REQUIREMENTS TO THE NEW LIMITS AT NO ADDITIONAL COST TO SARA.
- 54. N16 WARNING: NOTE THAT CERTAIN PORTIONS OF THE PROJECT MAY PARALLEL AND /OR CROSS EXISTING UTILITIES.
  THE CONTRACTORS WILL BE REQUIRED TO PROTECT EXISTING UTILITIES. ADDITIONAL
  SUPPORTIVE SHORING MAY BE REQUIRED. IT IS SPECIFICALLY THE CONTRACTORS RESPONSIBILITY TO
  PROTECT HIS WORKERS, EXISTING UTILITIES, AND FINISHED WORK THROUGHOUT THE JOB.
- 55. N 17 OVERHEAD ELECTRIC, CITY PUBLIC SERVICE (CPS) AN APPROPRIATELY SAFE OVERHEAD CLEARANCE MUST BE MAINTAINED BETWEEN ALL EQUIPMENT AND PERSONNEL. THE CONTRACTOR SHALL NOTIFY CITY PUBLIC SERVICE AT 353-2700 AT LEAST 48 HOURS PRIOR TO ANY CONSTRUCTION IN THE VICINITY OF THE CPS OVERHEAD ELECTRIC LINE CONTRACTOR SHALL MAINTAIN CPS RECOMMENDED CLEARANCE REQUIREMENTS.
- 56. N 23 BYPASS PUMPING: THE CONTRACTOR IS RESPONSIBLE FOR ALL BYPASS PUMPING REQUIRED TO COMPLETE THE WORK. BYPASS PUMPS SHALL BE ADEQUATE TO HANDLE PEAK FLOW EVENTS DURING STORM EVENTS. CONTRACTOR SHALL HAVE STANDBY PUMPS AVAILABLE TO BYPASS FLOW IN CASE PRIMARY PUMP FAILS, CONTRACTOR WILL BE SOLELY RESPONSIBLE FOR ALL COSTS FOR CLEANUP OF AN UNAUTHORIZED DISCHARGE AND ANY ASSOCIATED FINES.
- 57. N26 CONTRACTOR SHALL BACKFILL ALL OPEN TRENCHES AT THE END OF THE DAY. CONTRACTOR SHALL NOT INSTALL MORE PIPE THAN CAN BE COVERED. NO OPEN TRENCHES WILL BE PERMITTED OVERNIGHT ALL END OF OPEN PIPE WILL BE PLUGGED OVER NIGHT.
- 58. N33 THE PROJECT AREA MAY BE SUBJECT TO ARCHEOLOGICAL MONITORING. SHOULD THE CONTRACTOR ENCOUNTER ANY ARCHEOLOGICAL DEPOSITS DURING CONSTRUCTION OPERATIONS, THE CONTRACTOR SHALL STOP ALL WORK IN THE AREA OF THE DEPOSITS AND IMMEDIATELY CALL THE PROJECT MANAGER.
- 59. N37 CONTRACTOR TO NOTE THAT PORTIONS OF THE CONSTRUCTION ARE WITHIN THE LIMITS OF THE 100 YEAR FLOODPLAIN. THE CONTRACTOR IS REQUIRED TO KEEP THE CHANNEL CLEAR OF POTENTIAL OBSTRUCTIONS TO FLOOD FLOWS. POTENTIAL OBSTRUCTIONS INCLUDE HEAVY CONSTRUCTION EQUIPMENT, TEMPORARY ROADS ACROSS CHANNEL, EXCAVATED MATERIAL, STOCKPILED DEBRIS, ETC. UNDER THREATENING WEATHER CONDITIONS WHERE FLOODING IS LIKELY, OBSTRUCTIONS SHALL BE IMMEDIATELY REMOVED BY THE CONTRACTOR AT NO ADDITIONAL COST TO SARA. THE CONTRACTOR ASSUMES ALL RISK FOR UNFINISHED WORK.

THIS DOCUMENT HAS BEEN PRODUCED FROM MATERIAL THAT WAS STORED AND/OR TRANSMITTED ELECTRONICALLY AND MAY HAVE BEEN INADVERTENTLY ALTERED. RELY ONLY ON FINAL HARDCOPY MATERIALS BEARING THE CONSULTANT'S ORIGINAL SIGNATURE AND SEAL

DESIGNED BY: INIT

DRAWN BY: INIT

CHECKED BY: INIT

APPROVED BY: INIT

APPROVED BY: INIT

APPROVED BY: INIT

DATE: MONTH,YEAR FILE: NAME



SAN ANTONIO RIVER AUTHORITY

100 E. GUENTHER STREET P.O. BOX 839980 SAN ANTONIO, TEXAS 78283-9980 PLAT NO. 22-11800056 10B NO. 314-51-01

JEFFREY W. MARTIN

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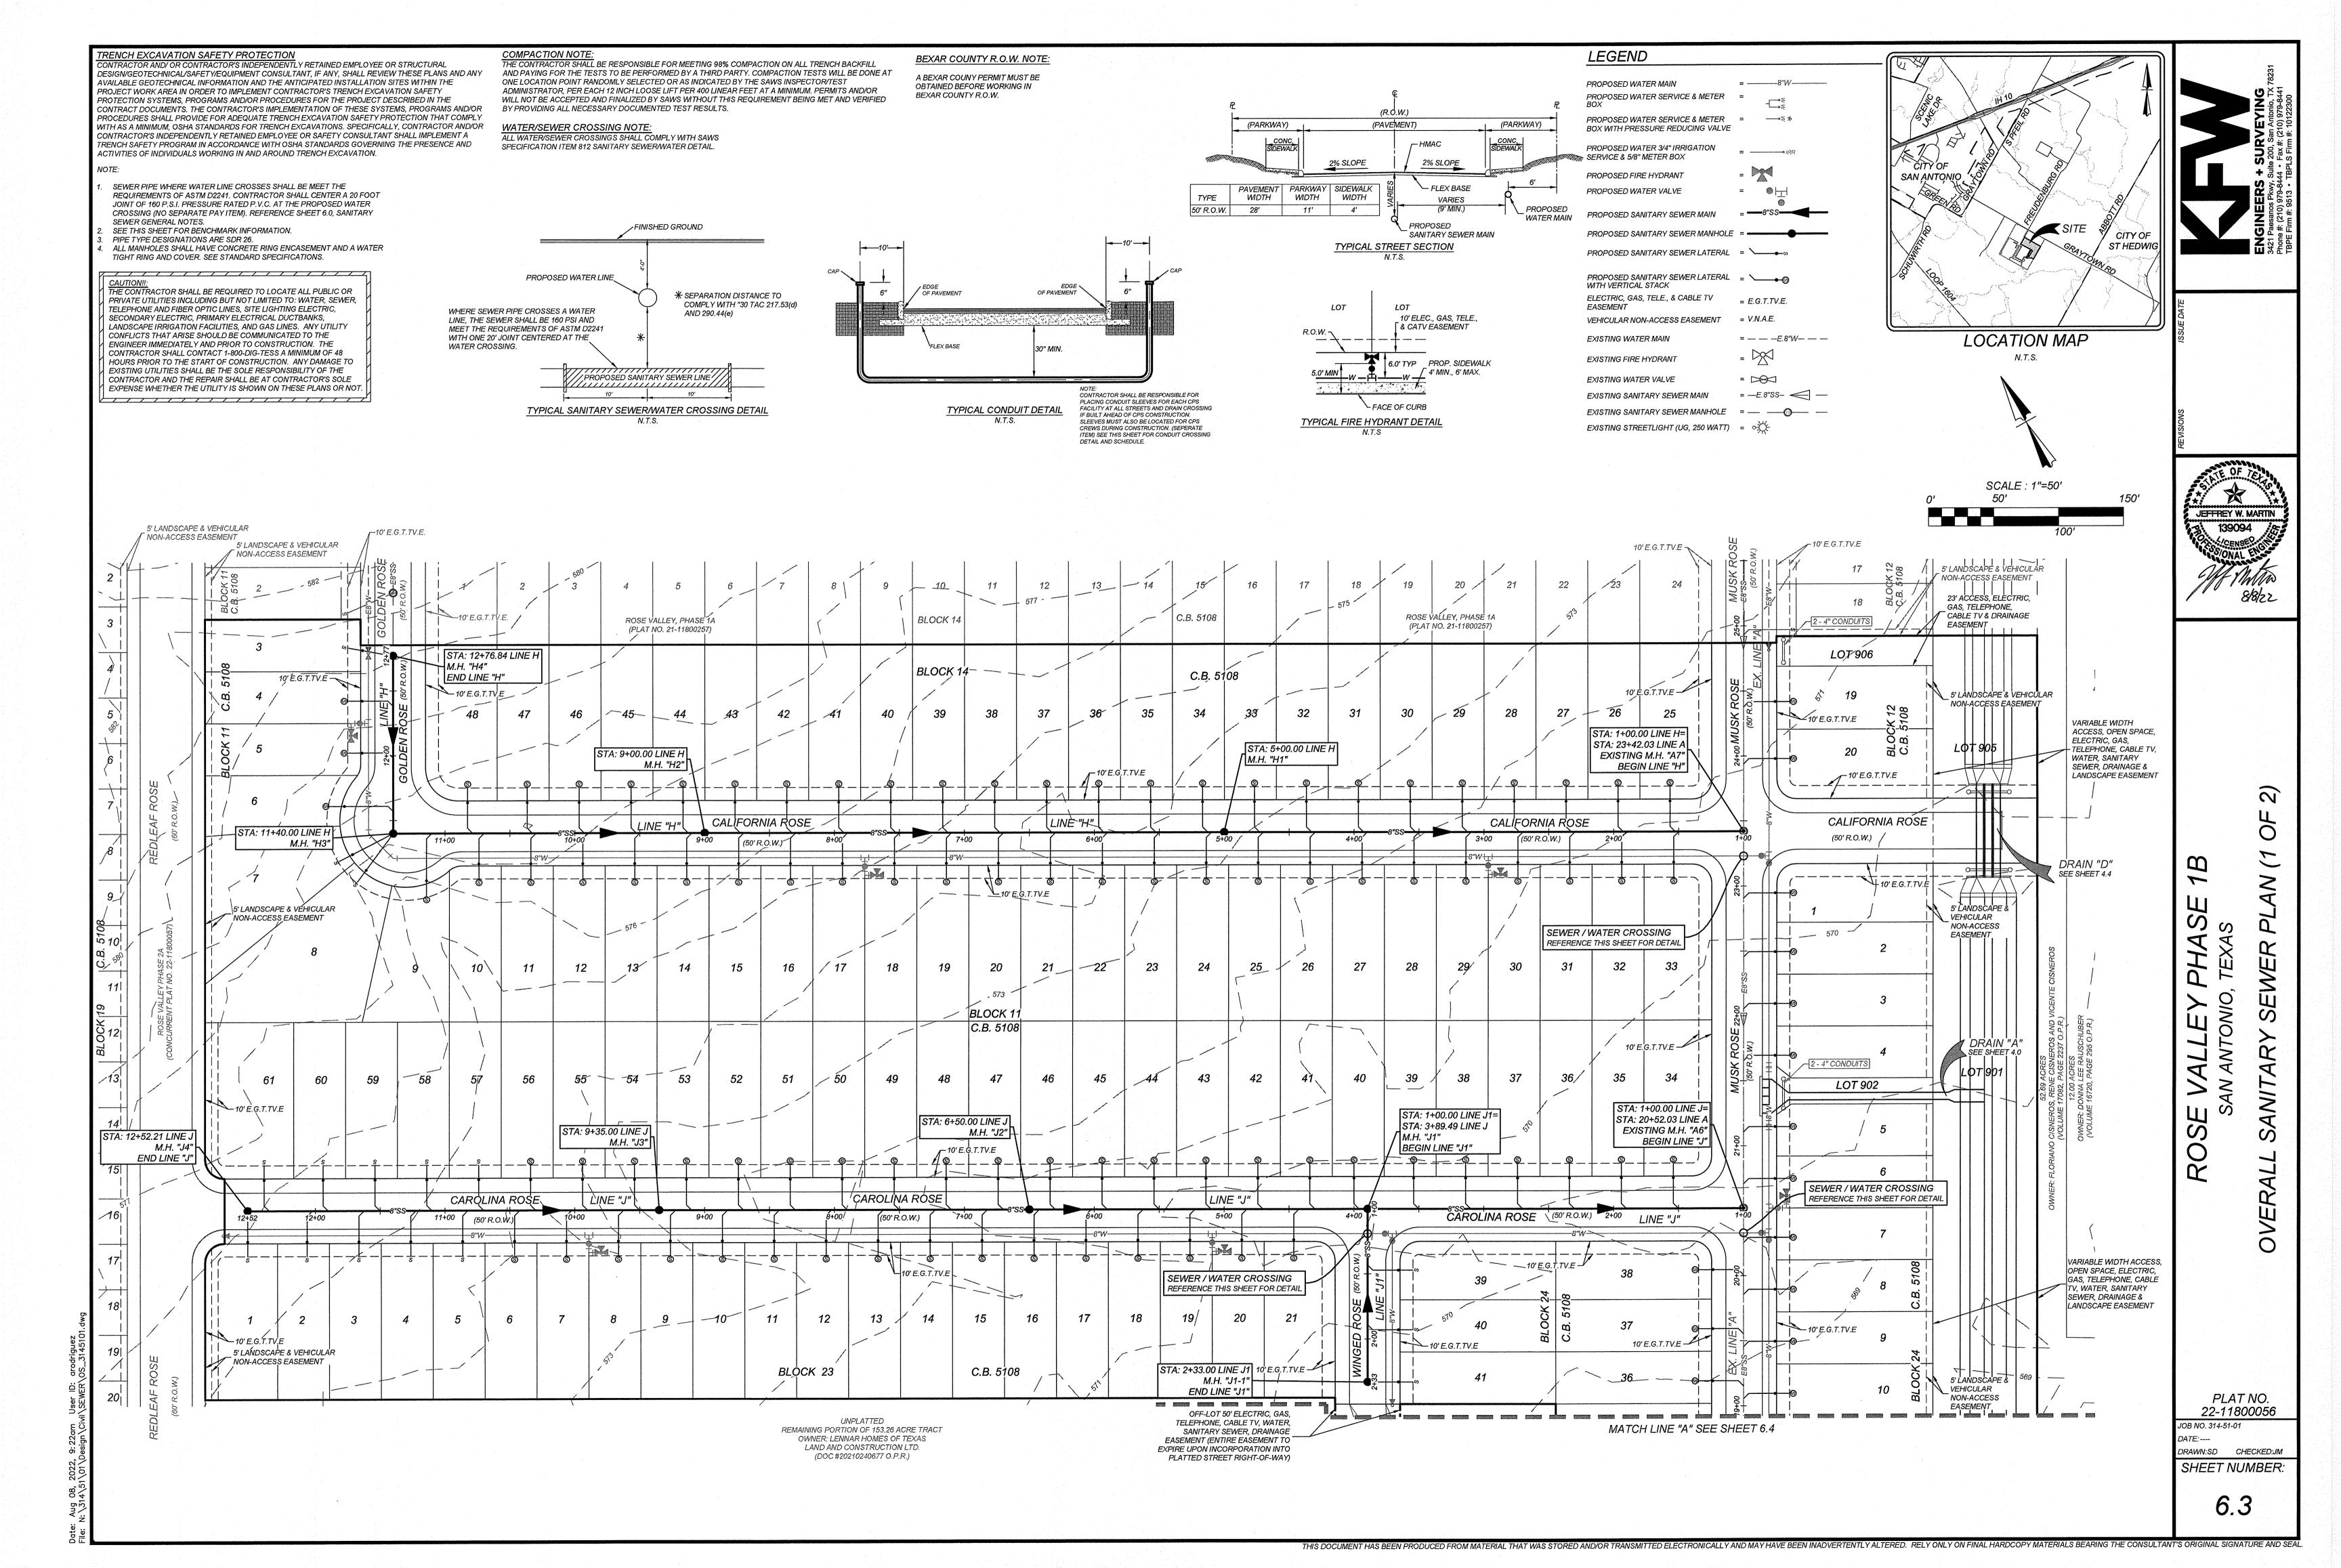
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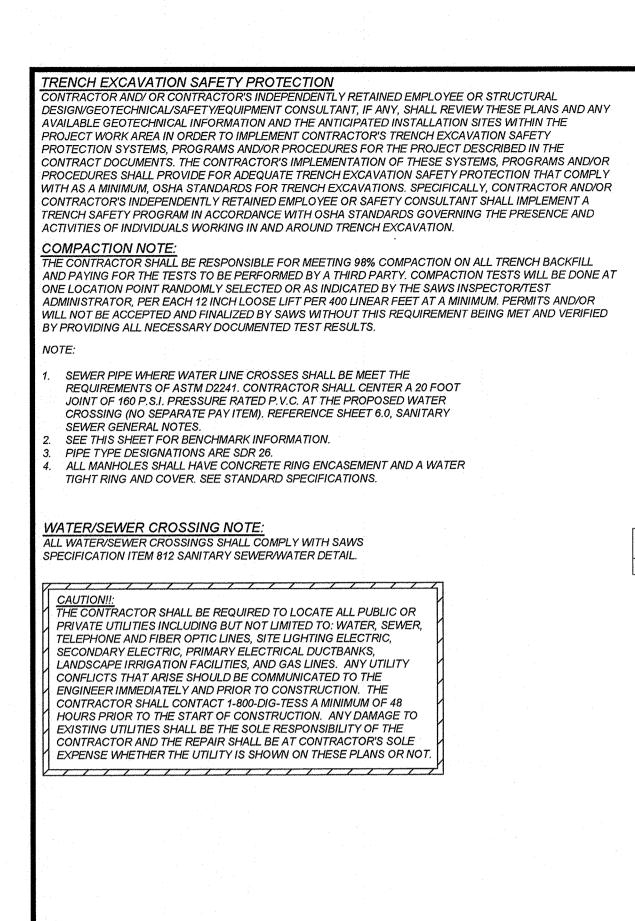
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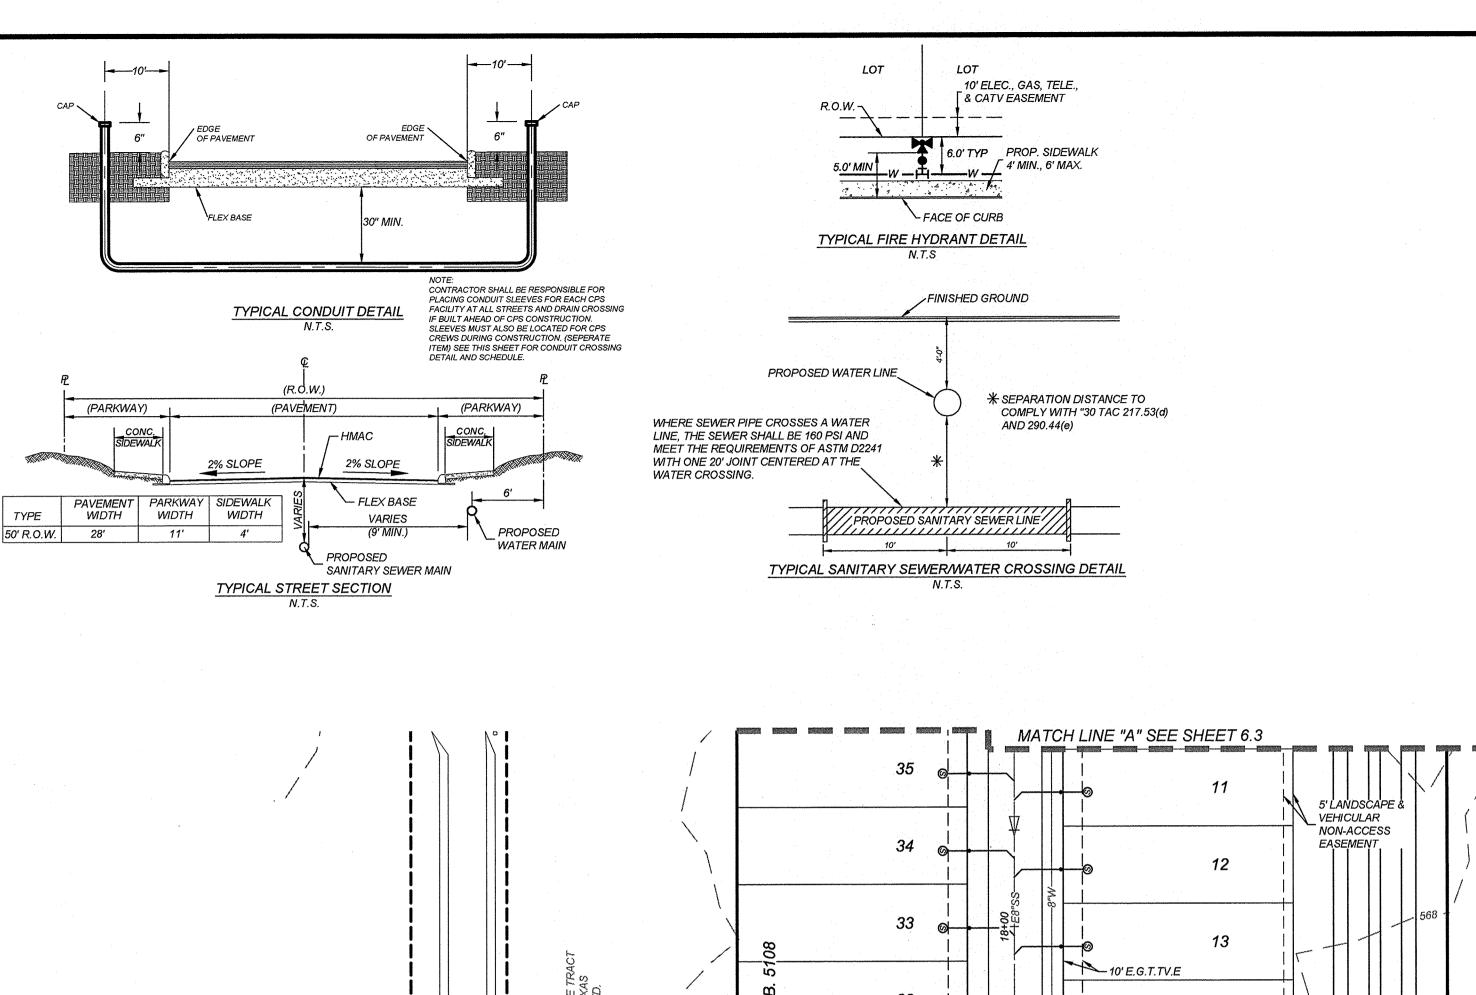
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STA: 16+52.03 LINE A EXISTING VENTED M.H. "A5"

26

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DRAIN "C" SEE SHEET 4.2-4.3

OFF-LOT 50' ELECTRIC, GAS,

VARIABLE WIDTH ACCESS, OPEN SPACE, ELECTRIC, GAS, TELEPHONE, CABLE TV, WATER, SANITARY

SEWER, DRAINAGE &


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LANDSCAPE EASEMENT

1% AC EFFECTIVE FLODPLAIN PER PANEL #48029C0435G, -DATED: SEPTEMBER 29, 2010

TELEPHONE, CABLE TV, WATER, SANITARY SEWER, DRAINAGE EASEMENT (ENTIRE EASEMENT TO EXPIRE UPON INCORPORATION INTO PLATTED STREET RIGHT-OF-WAY)



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VARIABLE WIDTH ACCESS,

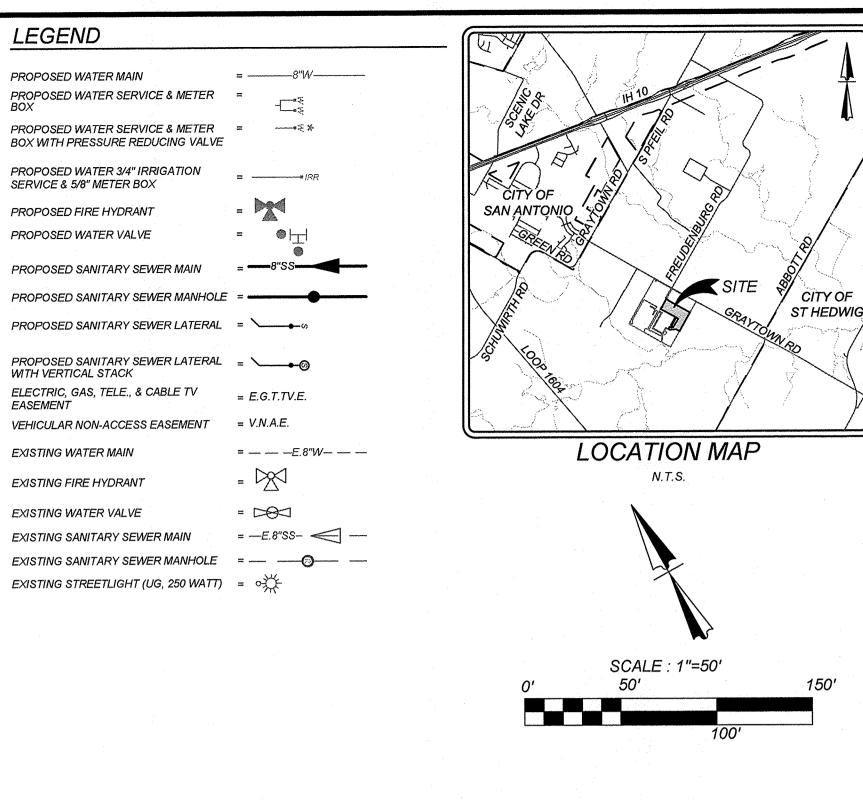OPEN SPACE, ELECTRIC, GAS, TELEPHONE, CABLE TV, WATER, SANITARY SEWER, DRAINAGE &

LANDSCAPE EASEMENT

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STA: 13+62.05 LINE

EXISTING M.H. "A4"

ROSE VALLEY PHASE 2A


(CONCURRENT PLAT NO. 22-11800057)

OFF-LOT VARIABLE WIDTH SANITARY
-SEWER EASEMENT

OFF-LOT VARIABLE WIDTH DRAINAGE EASEMENT VEHICULAR NON-ACCESS

FEMA 100 YR FLOODPLAIN

FIRM PANEL #48029C0435G -DATED: SEPTEMBER 29, 2010

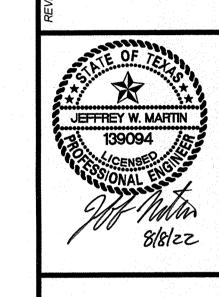

OSE VALLEY PHASE 1B SAN ANTONIO, TEXAS 2

SAN ANTONI OVERALL SANITARY S

PLAT NO. 22-11800056 No. 314-51-01

JOB NO. 314-51-01 DATE: ----DRAWN:SD CHECKED:JM

SHEET NUMBER:

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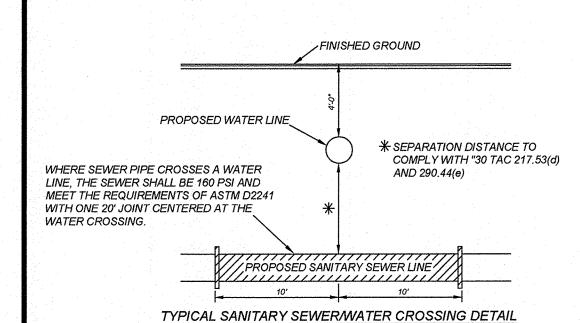
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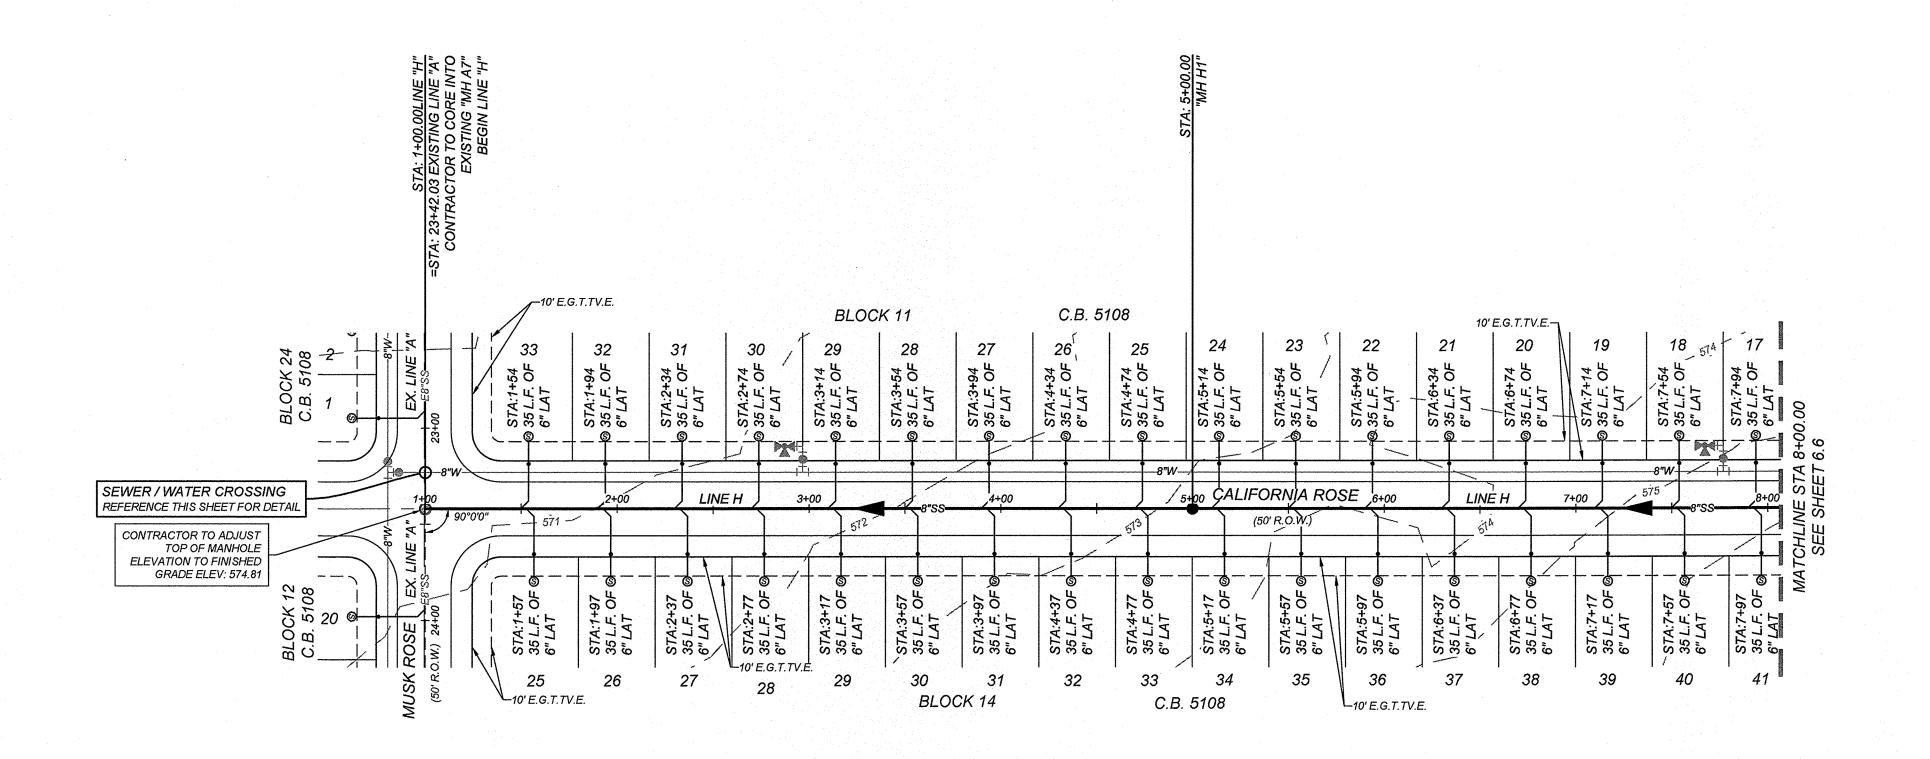
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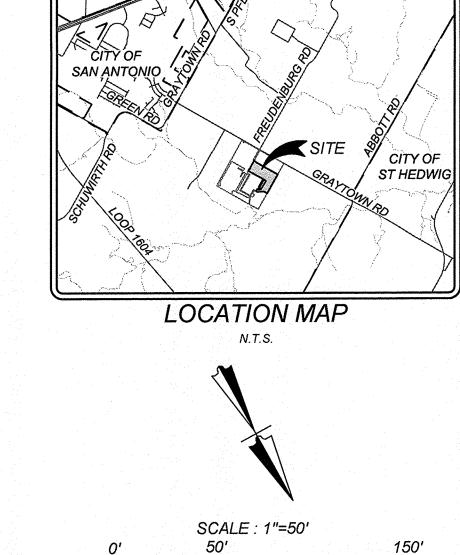
TRENCH EXCAVATION SAFETY PROTECTION
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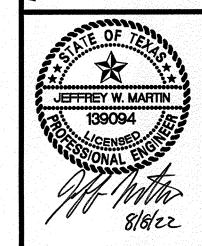
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- 3. SEE THIS SHEET FOR TYPICAL SANITARY SEWER / WATER CROSSING
- ALL MANHOLES SHALL HAVE CONCRETE RING ENCASEMENT AND A WATER TIGHT RING AND COVER. SEE SHEET 6.11 FOR DETAILS.
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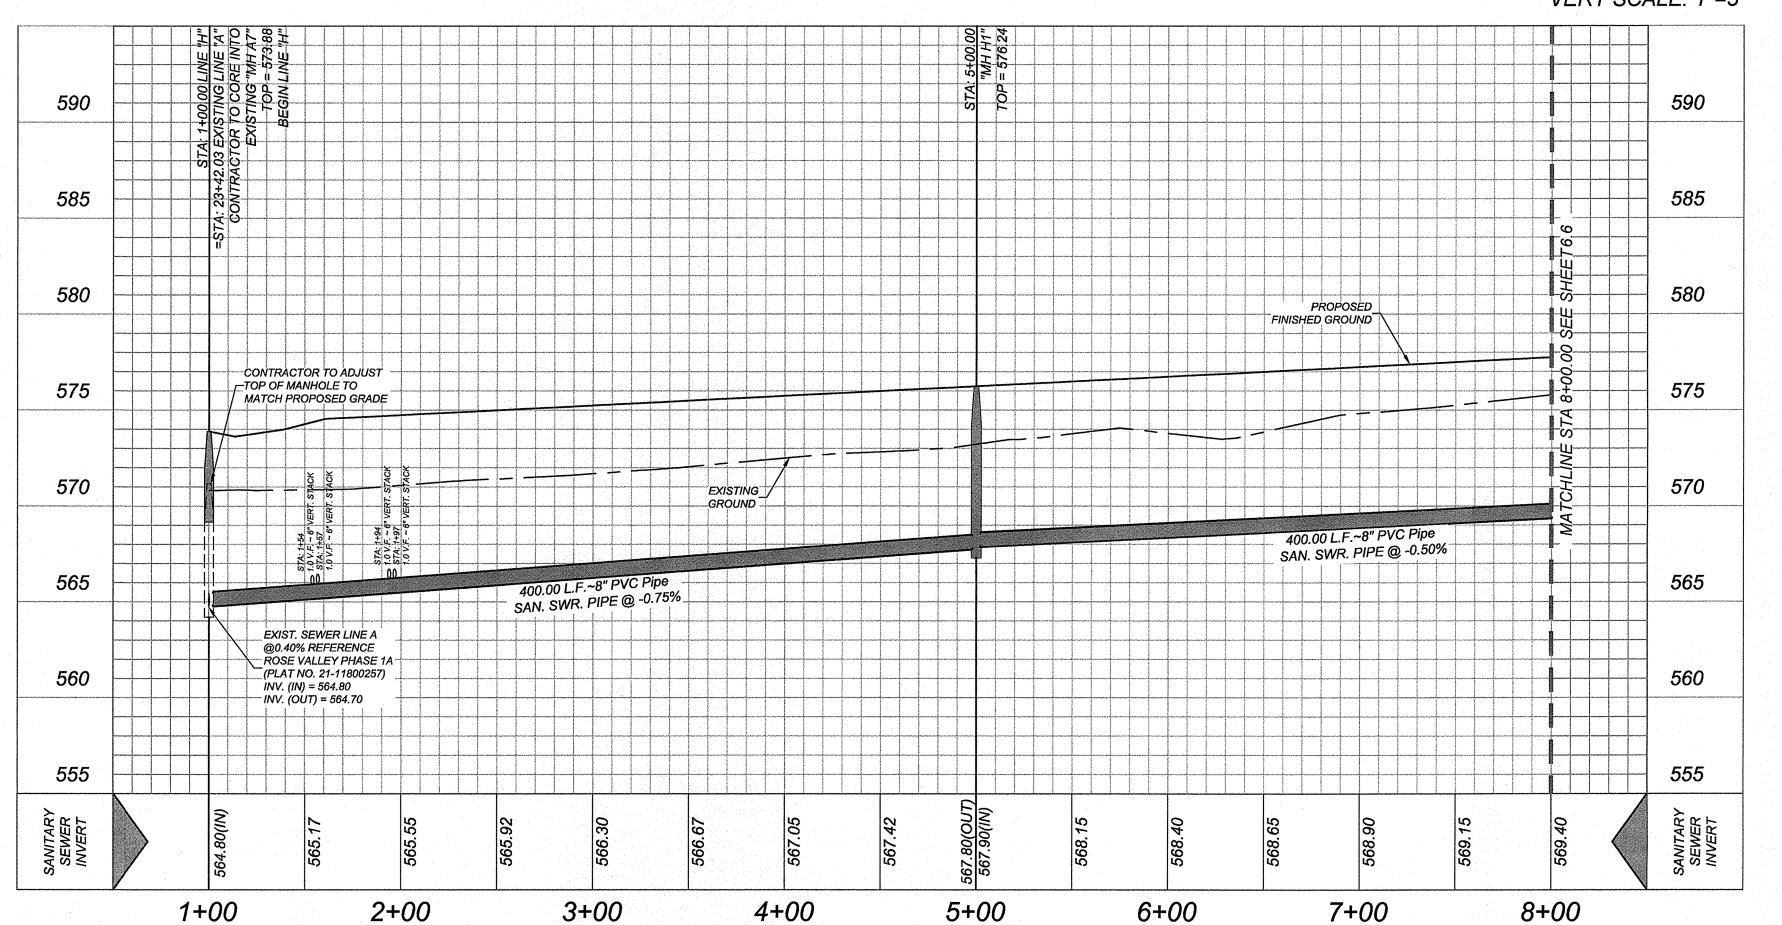


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LINE "H" STA: 1+00.00 - 8+00.00

HORZ SCALE: 1"=50' VERT SCALE: 1"=5"



PLAT NO. 22-11800056

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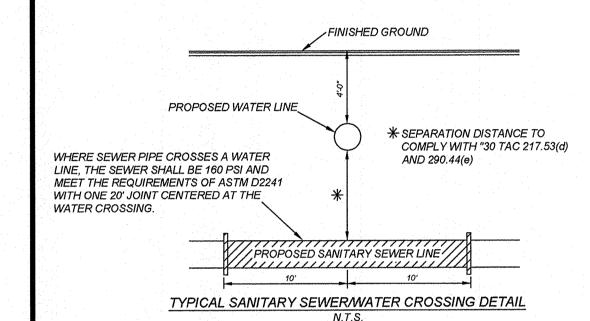
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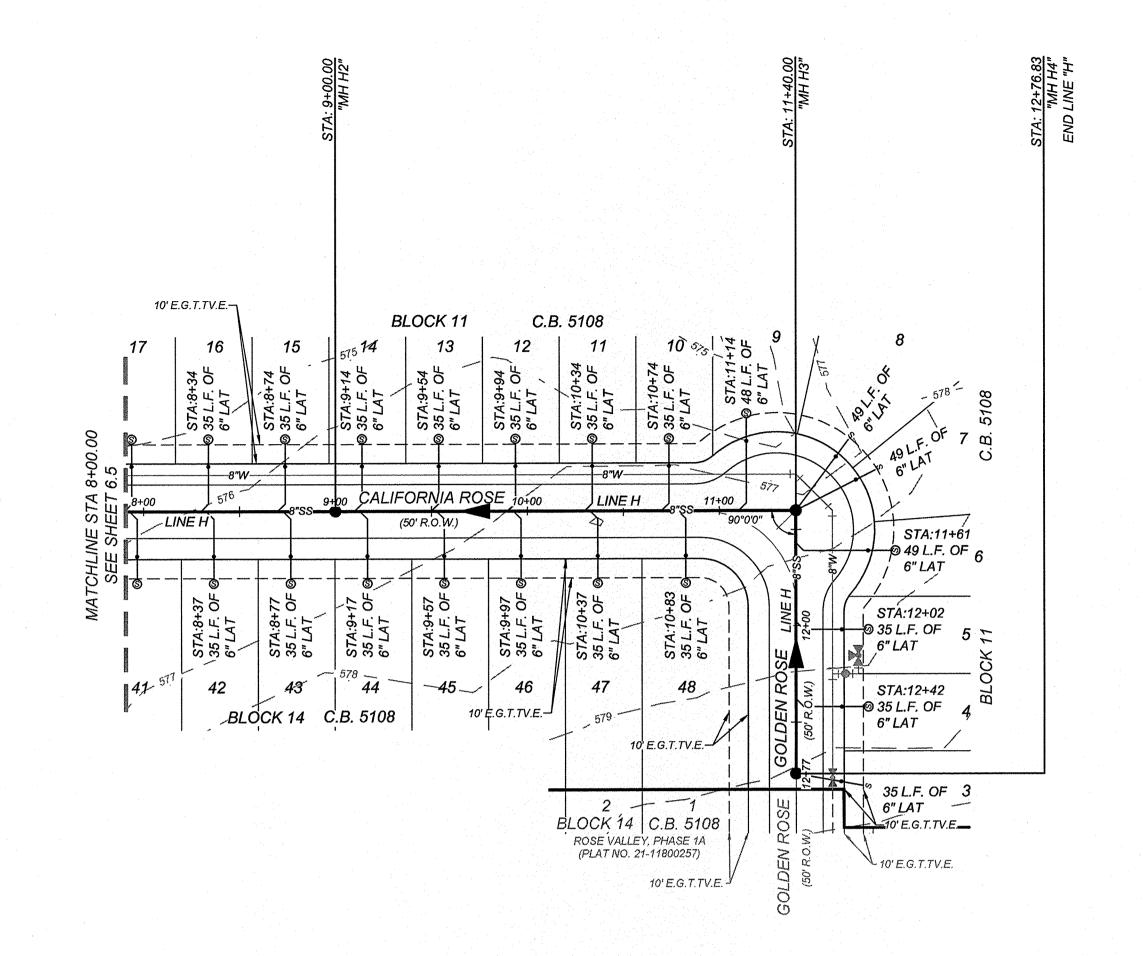
TRENCH EXCAVATION SAFETY PROTECTION
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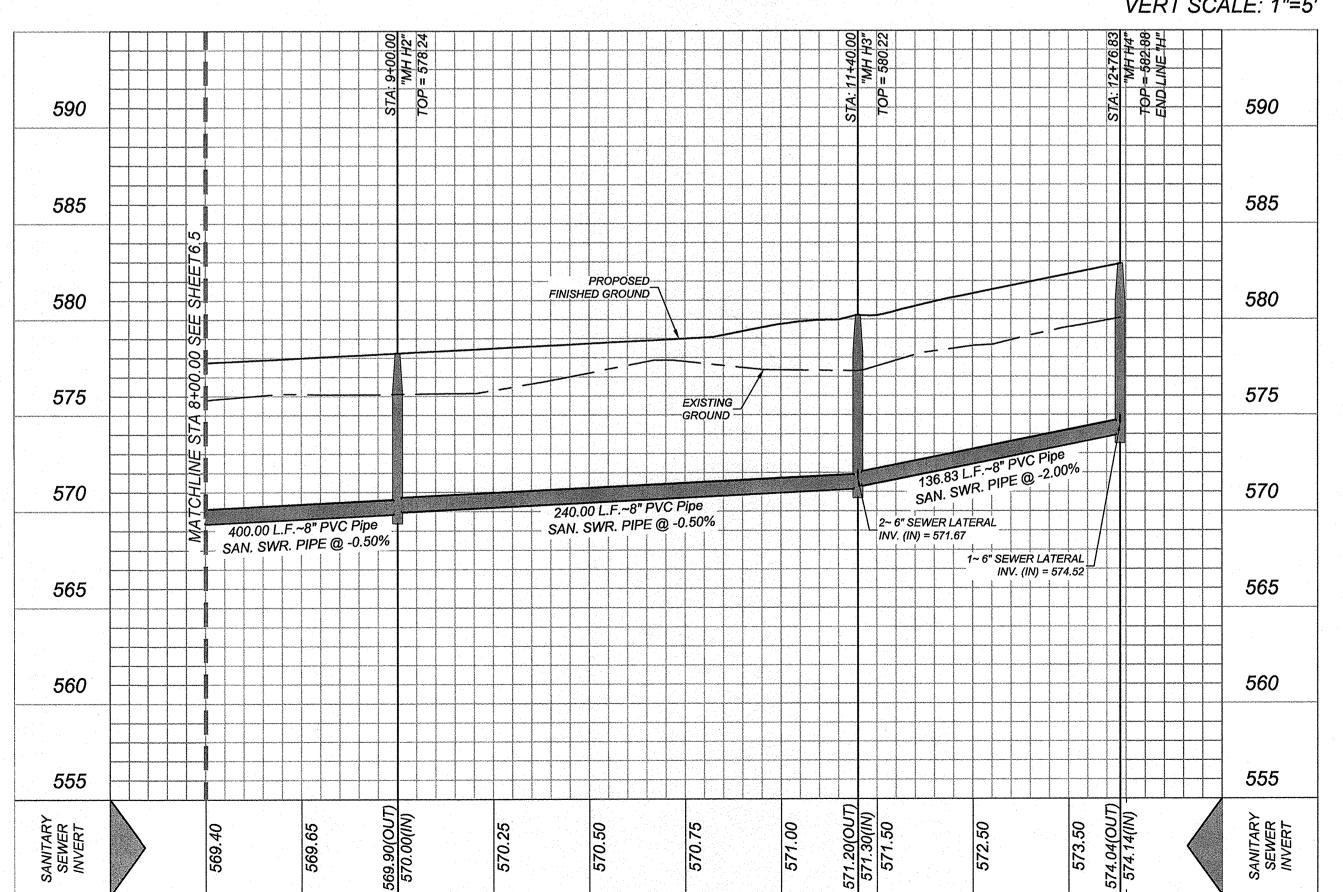


LINE "H" STA: 8+00.00 - END

HORZ SCALE: 1"=50' VERT SCALE: 1"=5"

12+80

12+00




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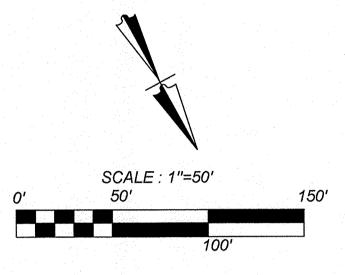
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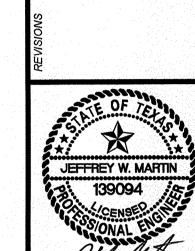
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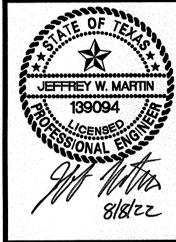
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**PHASE** VALLE ROSE S/

8+00. STA

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PLAT NO. 22-11800056

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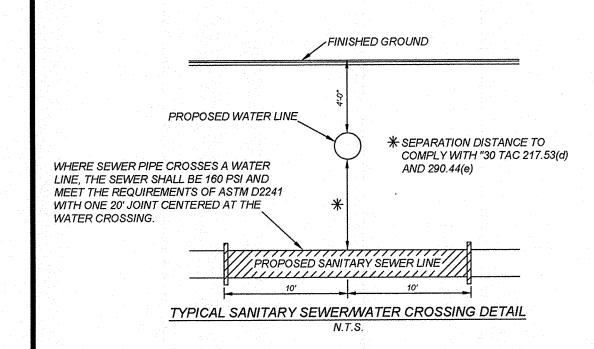
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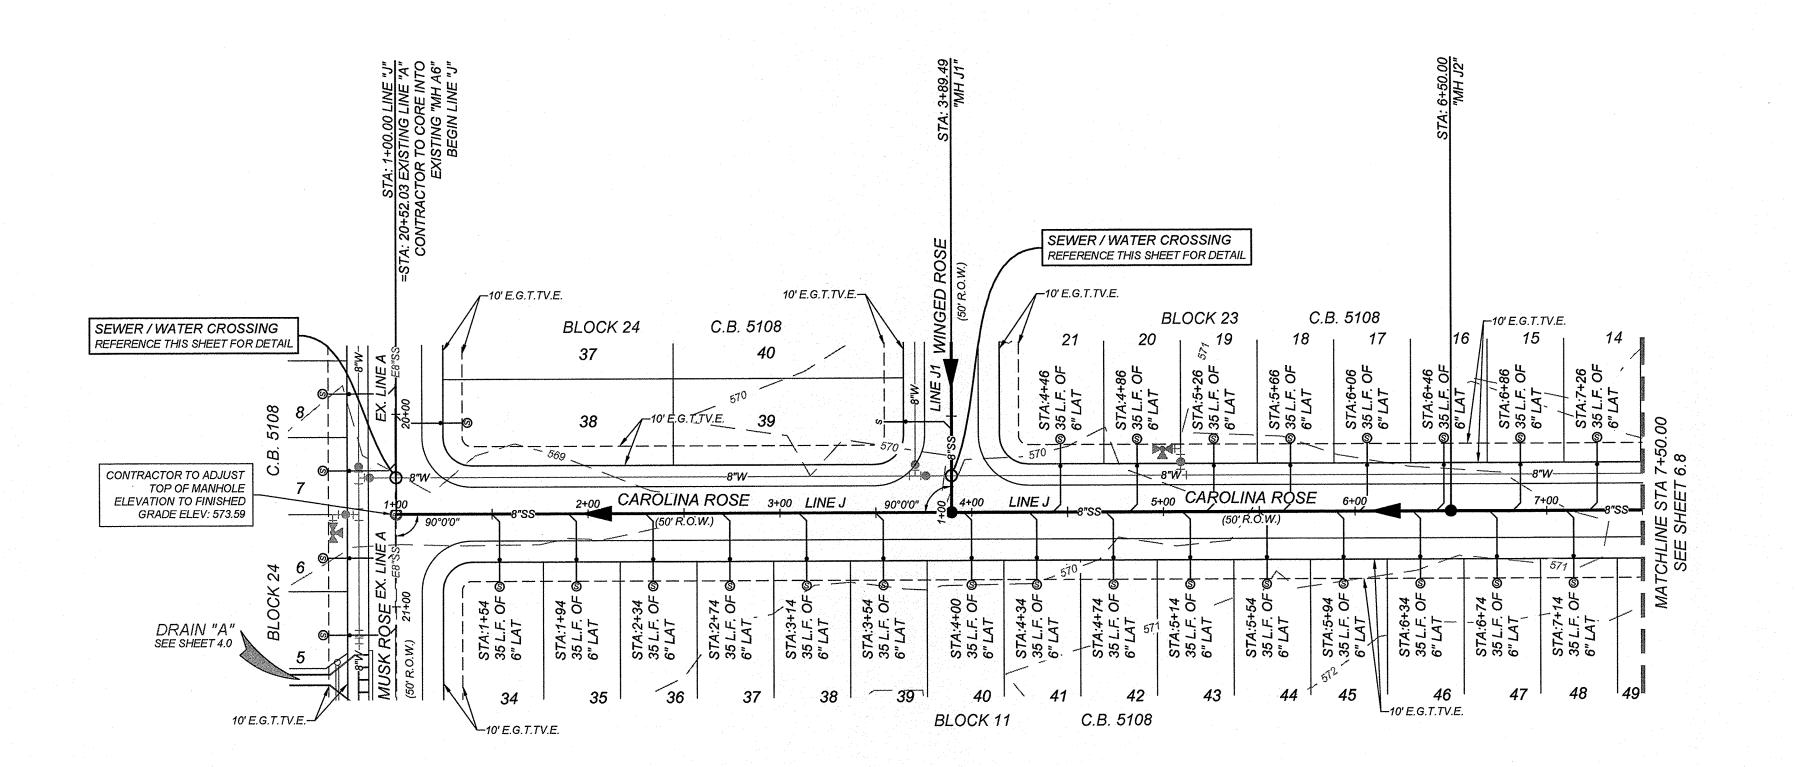
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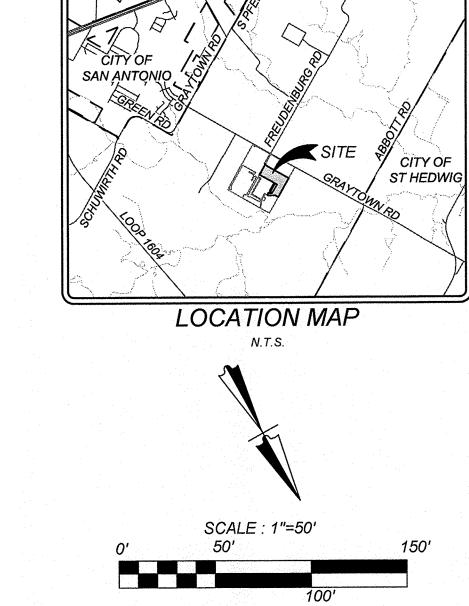
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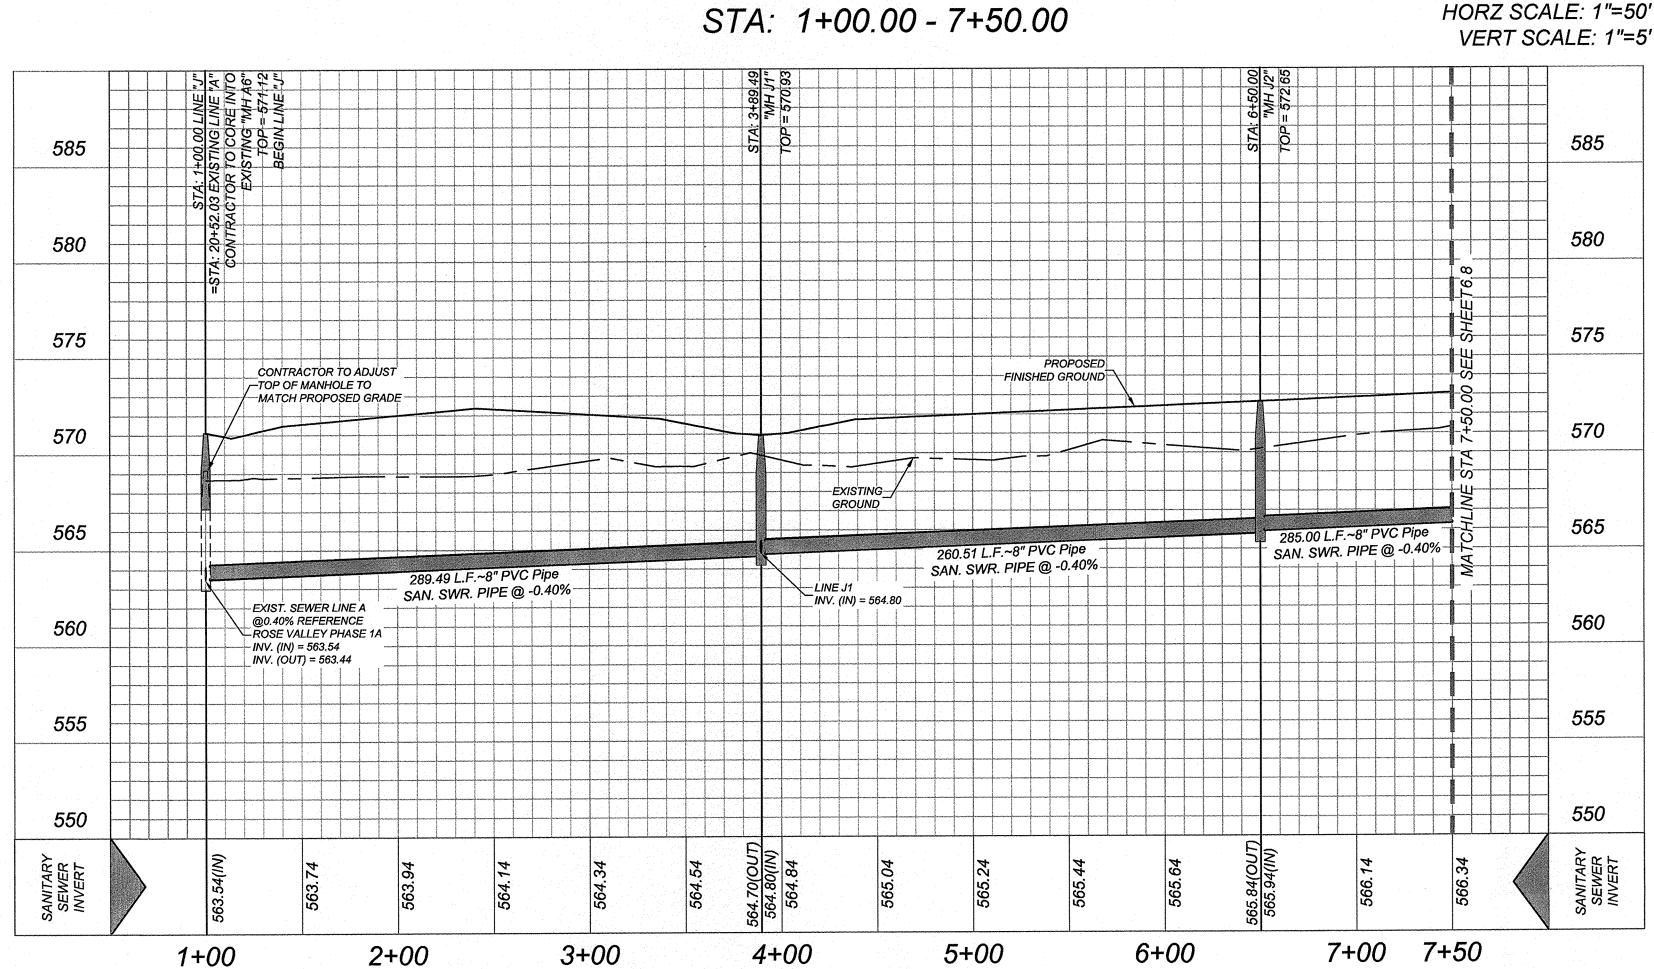
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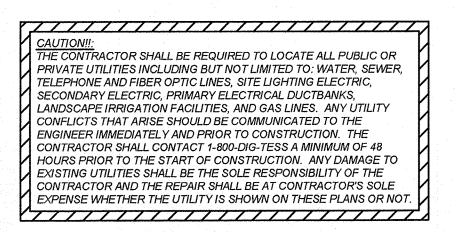
HORZ SCALE: 1"=50'

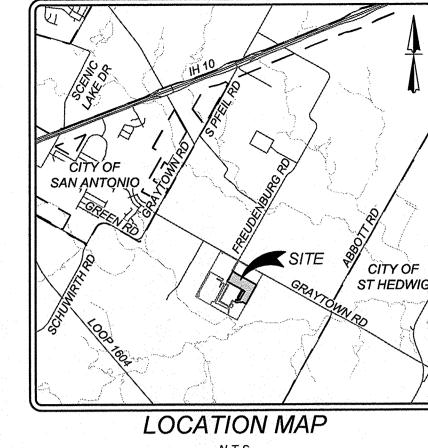

LINE "J"

PLAT NO. 22-11800056 JOB NO. 314-51-01 DRAWN:SD CHECKED:JM

SHEET NUMBER



TRENCH EXCAVATION SAFETY PROTECTION
CONTRACTOR AND/ OR CONTRACTOR'S INDEPENDENTLY RETAINED EMPLOYEE OR STRUCTURAL


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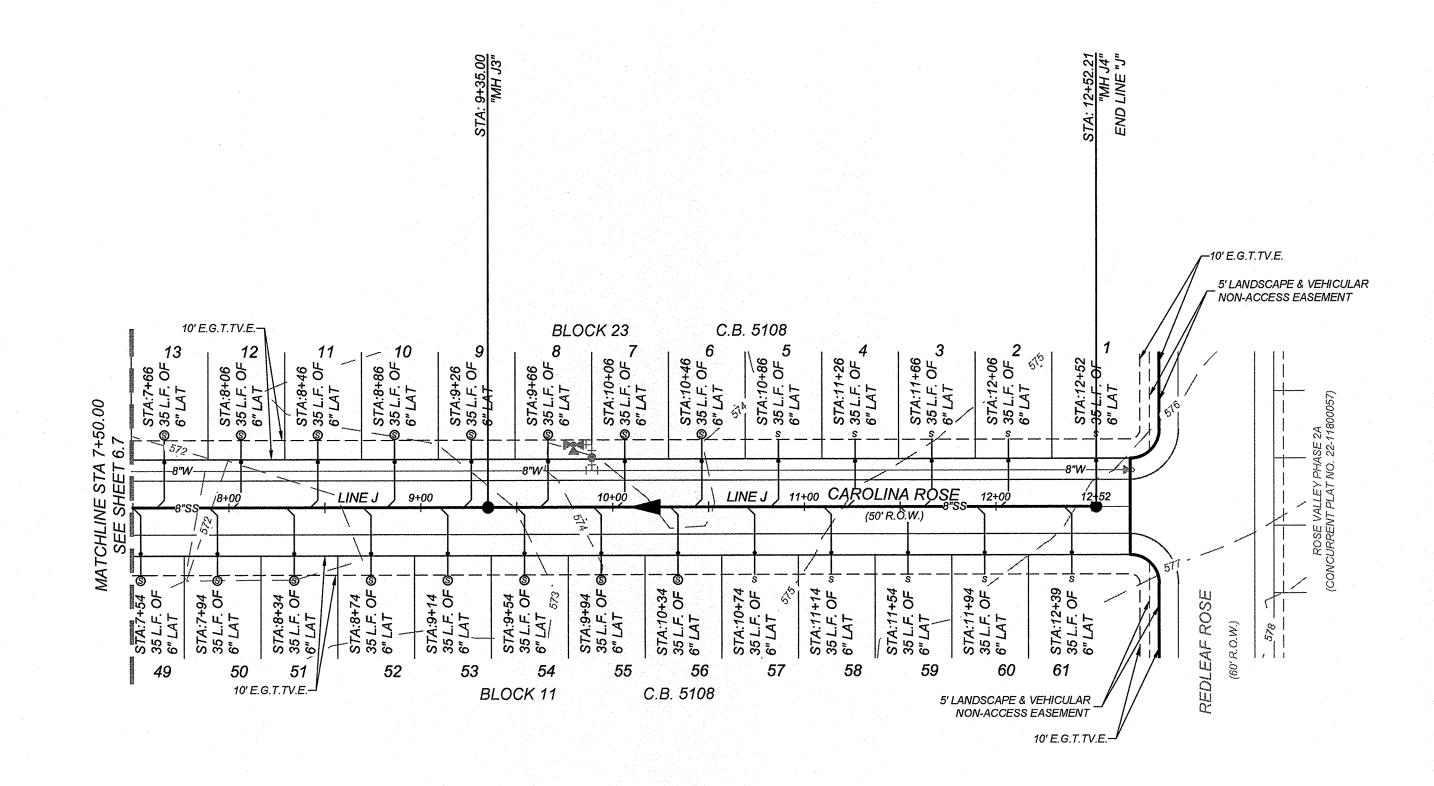
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 LATERAL CONNECTIONS MADE TO EXISTING INFRASTRUCTURE WILL NEED TO BE COMPLETED USING AN INSERTA TEE OR APPROVED EQUAL.






LINE "J" STA: 7+50.00 - END

HORZ SCALE: 1"=50"

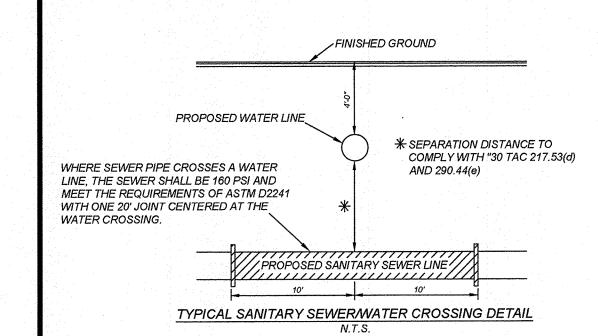12+00 12+52

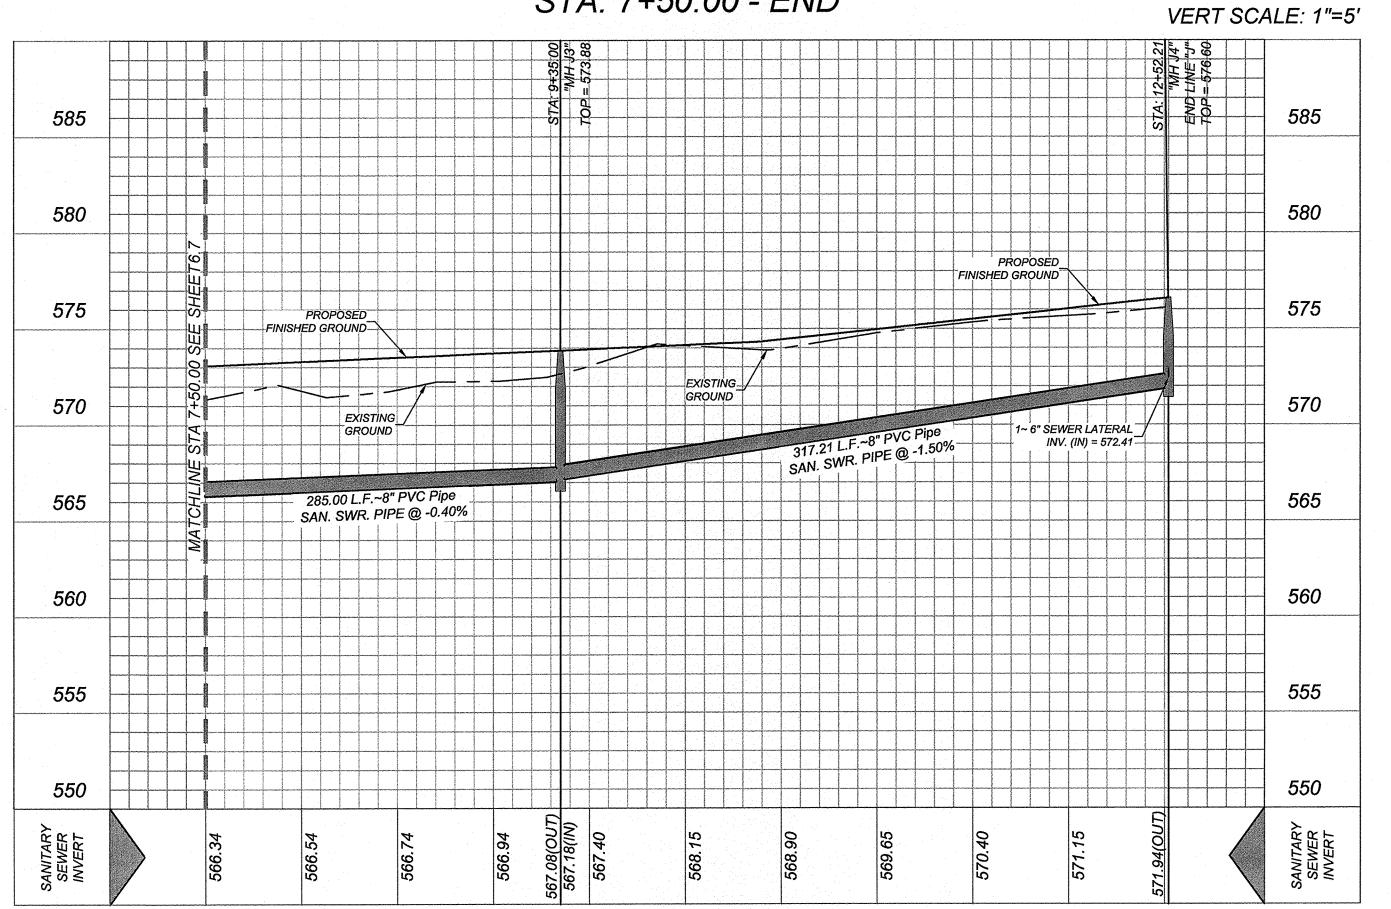



10+00


11+00

7+50 8+00

9+00

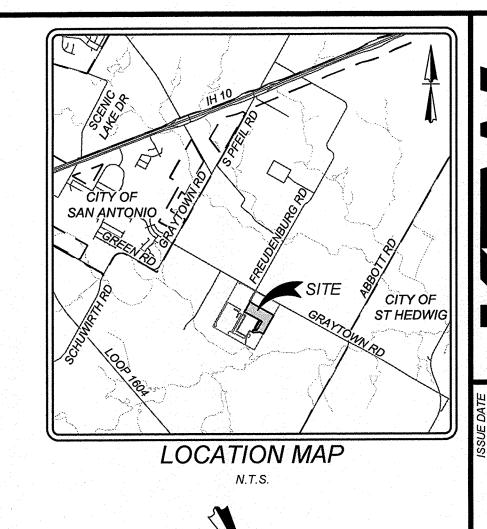

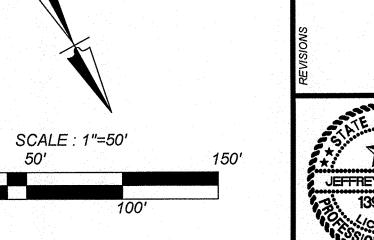

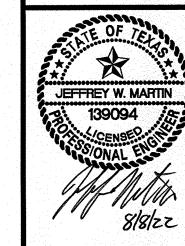

VALLE

PLAT NO. 22-11800056


DRAWN:SD CHECKED:JM SHEET NUMBER:


CAUTION!!: THE CONTRACTOR SHALL BE REQUIRED TO LOCATE ALL PUBLIC OR PRIVATE UTILITIES INCLUDING BUT NOT LIMITED TO: WATER, SEWER, TELEPHONE AND FIBER OPTIC LINES, SITE LIGHTING ELECTRIC, SECONDARY ELECTRIC, PRIMARY ELECTRICAL DUCTBANKS, LANDSCAPE IRRIGATION FACILITIES, AND GAS LINES. ANY UTILITY CONFLICTS THAT ARISE SHOULD BE COMMUNICATED TO THE ENGINEER IMMEDIATELY AND PRIOR TO CONSTRUCTION. THE CONTRACTOR SHALL CONTACT 1-800-DIG-TESS A MINIMUM OF 48 HOURS PRIOR TO THE START OF CONSTRUCTION. ANY DAMAGE TO EXISTING UTILITIES SHALL BE THE SOLE RESPONSIBILITY OF THE CONTRACTOR AND THE REPAIR SHALL BE AT CONTRACTOR'S SOLE EXPENSE WHETHER THE UTILITY IS SHOWN ON THESE PLANS OR NOT. 


TRENCH EXCAVATION SAFETY PROTECTION
CONTRACTOR AND/ OR CONTRACTOR'S INDEPENDENTLY RETAINED EMPLOYEE OR STRUCTURAL DESIGN/GEOTECHNICAL/SAFETY/EQUIPMENT CONSULTANT, IF ANY, SHALL REVIEW THESE PLANS AND ANY AVAILABLE GEOTECHNICAL INFORMATION AND THE ANTICIPATED INSTALLATION SITES WITHIN THE PROJECT WORK AREA IN ORDER TO IMPLEMENT CONTRACTOR'S TRENCH EXCAVATION SAFETY PROTECTION SYSTEMS, PROGRAMS AND/OR PROCEDURES FOR THE PROJECT DESCRIBED IN THE CONTRACT DOCUMENTS. THE CONTRACTOR'S IMPLEMENTATION OF THESE SYSTEMS, PROGRAMS AND/OR PROCEDURES SHALL PROVIDE FOR ADEQUATE TRENCH EXCAVATION SAFETY PROTECTION THAT COMPLY WITH AS A MINIMUM, OSHA STANDARDS FOR TRENCH EXCAVATIONS. SPECIFICALLY, CONTRACTOR AND/OR CONTRACTOR'S INDEPENDENTLY RETAINED EMPLOYEE OR SAFETY CONSULTANT SHALL IMPLEMENT A TRENCH SAFETY PROGRAM IN ACCORDANCE WITH OSHA STANDARDS GOVERNING THE PRESENCE AND ACTIVITIES OF INDIVIDUALS WORKING IN AND AROUND TRENCH EXCAVATION.

- 1. SEWER PIPE WHERE WATER LINE CROSSES SHALL BE MEET THE REQUIREMENTS OF ASTM D2241. CONTRACTOR SHALL CENTER A 20 FOOT JOINT OF 160 P.S.I. PRESSURE RATED P.V.C. AT THE PROPOSED WATER CROSSING (NO SEPARATE PAY ITEM). REFERENCE SHEET 6.1 - 6.2, SANITARY SEWER GENERAL NOTES, SARA CRITERIA FOR SEWER MAIN CONSTRUCTION IN THE VICINITY OF WATER MAINS.
- 2. PIPE TYPE DESIGNATIONS ARE SDR 26. 3. SEE THIS SHEET FOR TYPICAL SANITARY SEWER / WATER CROSSING
- 4. ALL MANHOLES SHALL HAVE CONCRETE RING ENCASEMENT AND A WATER
- TIGHT RING AND COVER. SEE SHEET 6.11 FOR DETAILS.

  5. NO 6" CLEANOUTS SHALL BE LOCATED UNDER DRIVEWAYS OR SIDEWALKS. 6. LATERAL CONNECTIONS MADE TO EXISTING INFRASTRUCTURE WILL NEED TO BE COMPLETED USING AN INSERTA TEE OR APPROVED EQUAL.

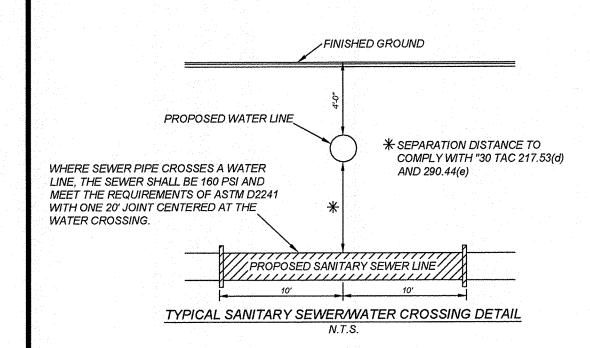

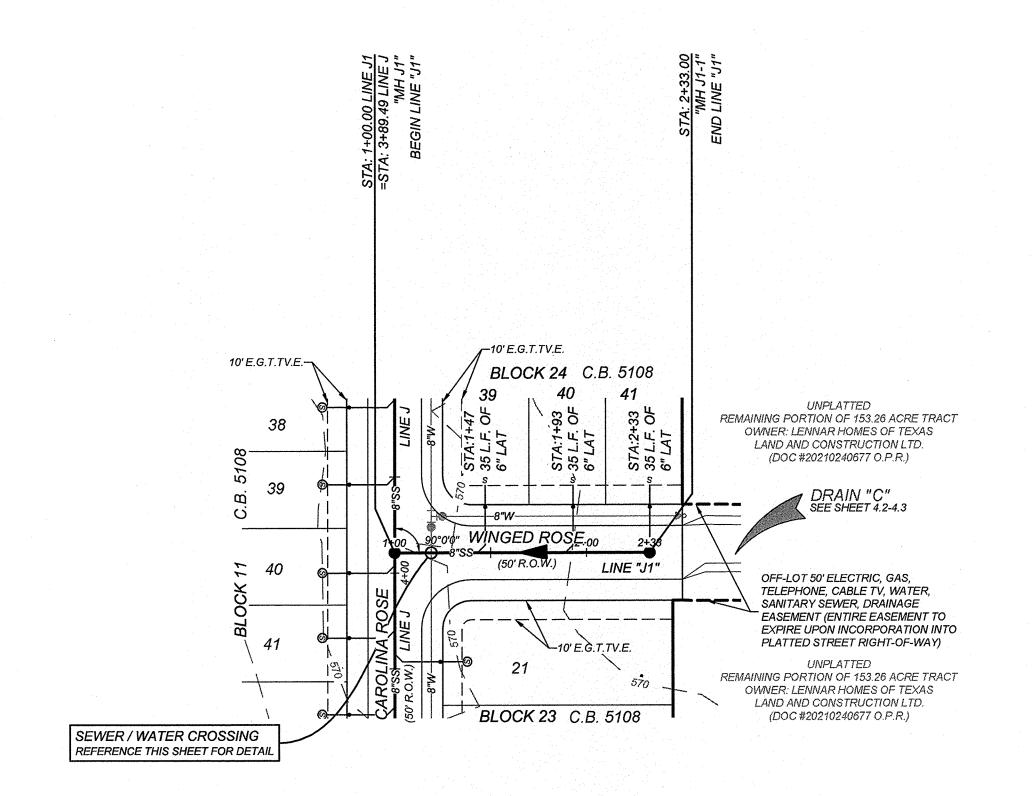


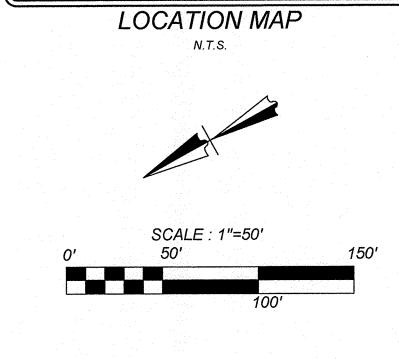

ST HEDWIC

LINE "J1" STA: 1+00.00 - END

HORZ SCALE: 1"=50' VERT SCALE: 1"=5"

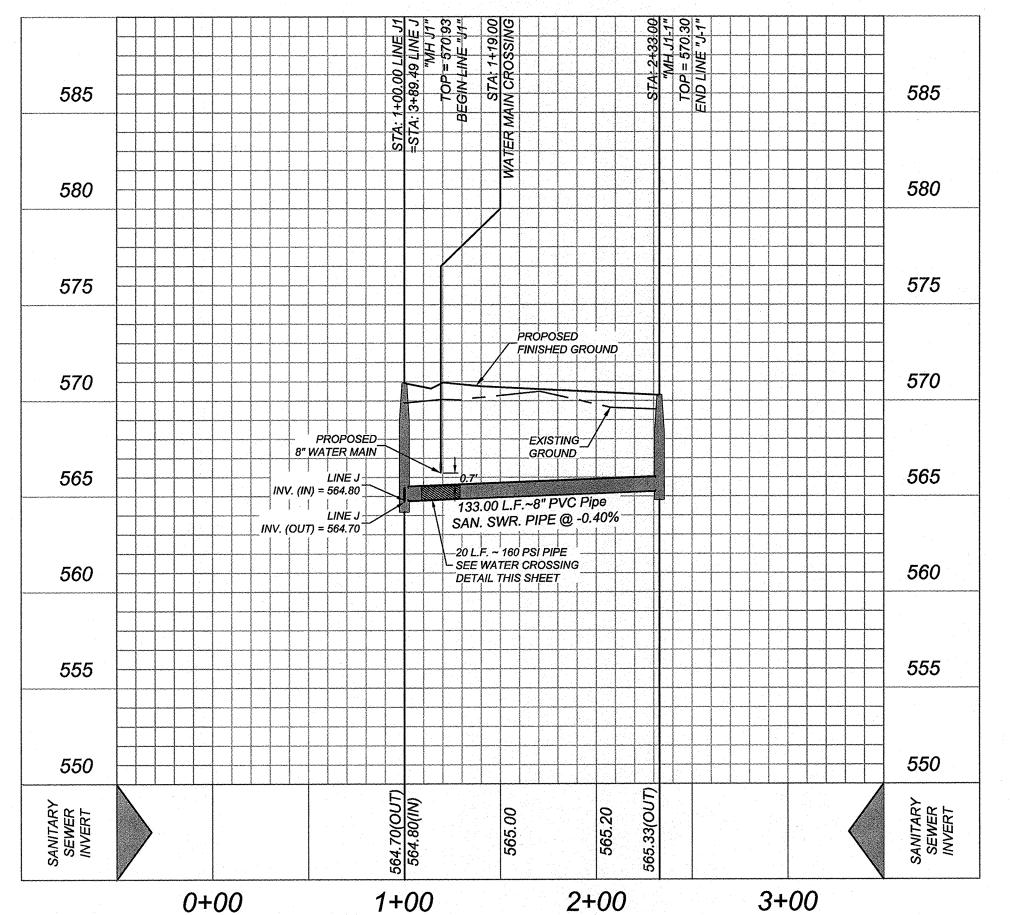



PLAT NO. 22-11800056 JOB NO. 314-51-01

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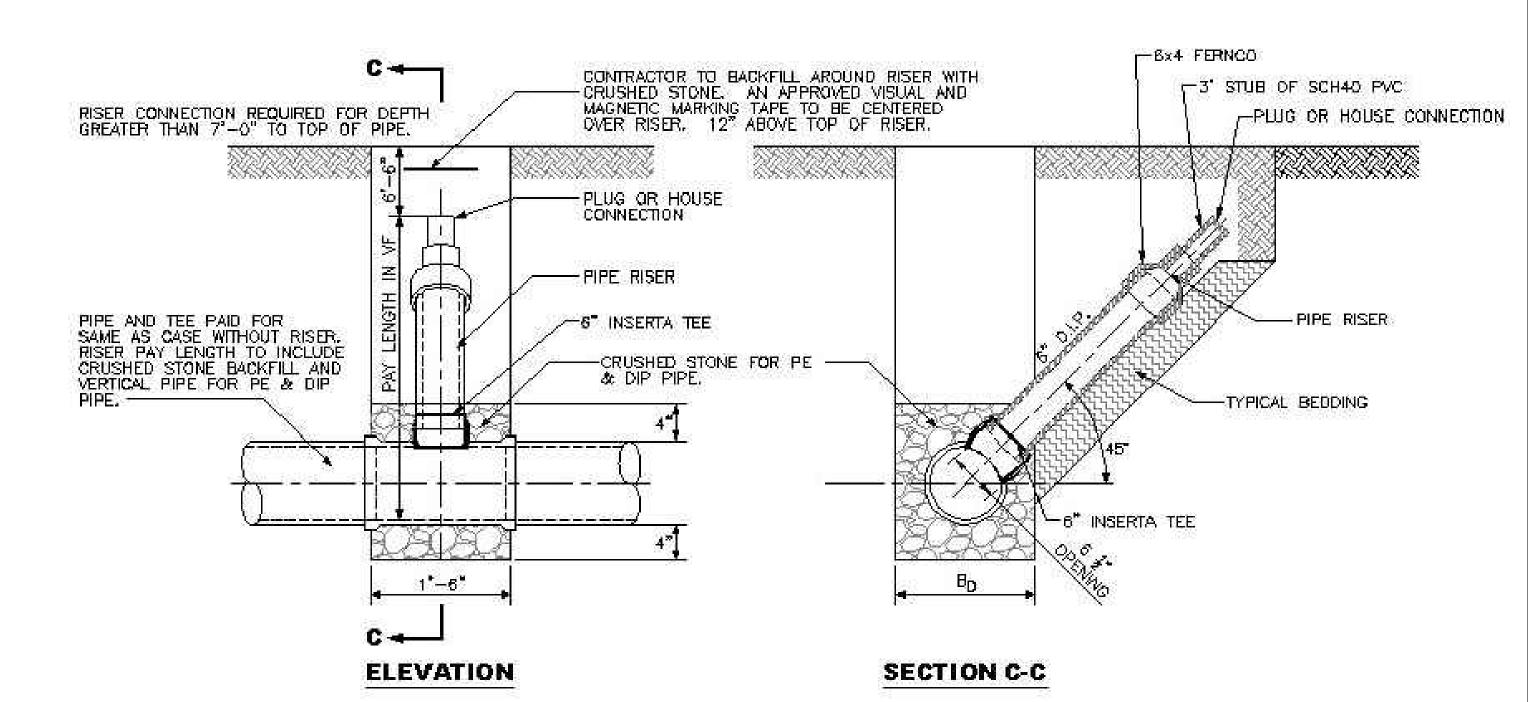
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## TYPICAL RISER FOR SERVICE CONNECTION USING INSERTA TEE

RISER CONNECTION REQUIRED FOR DEPTH GREATER THAN 7'-0" TO TOP OF PIPE

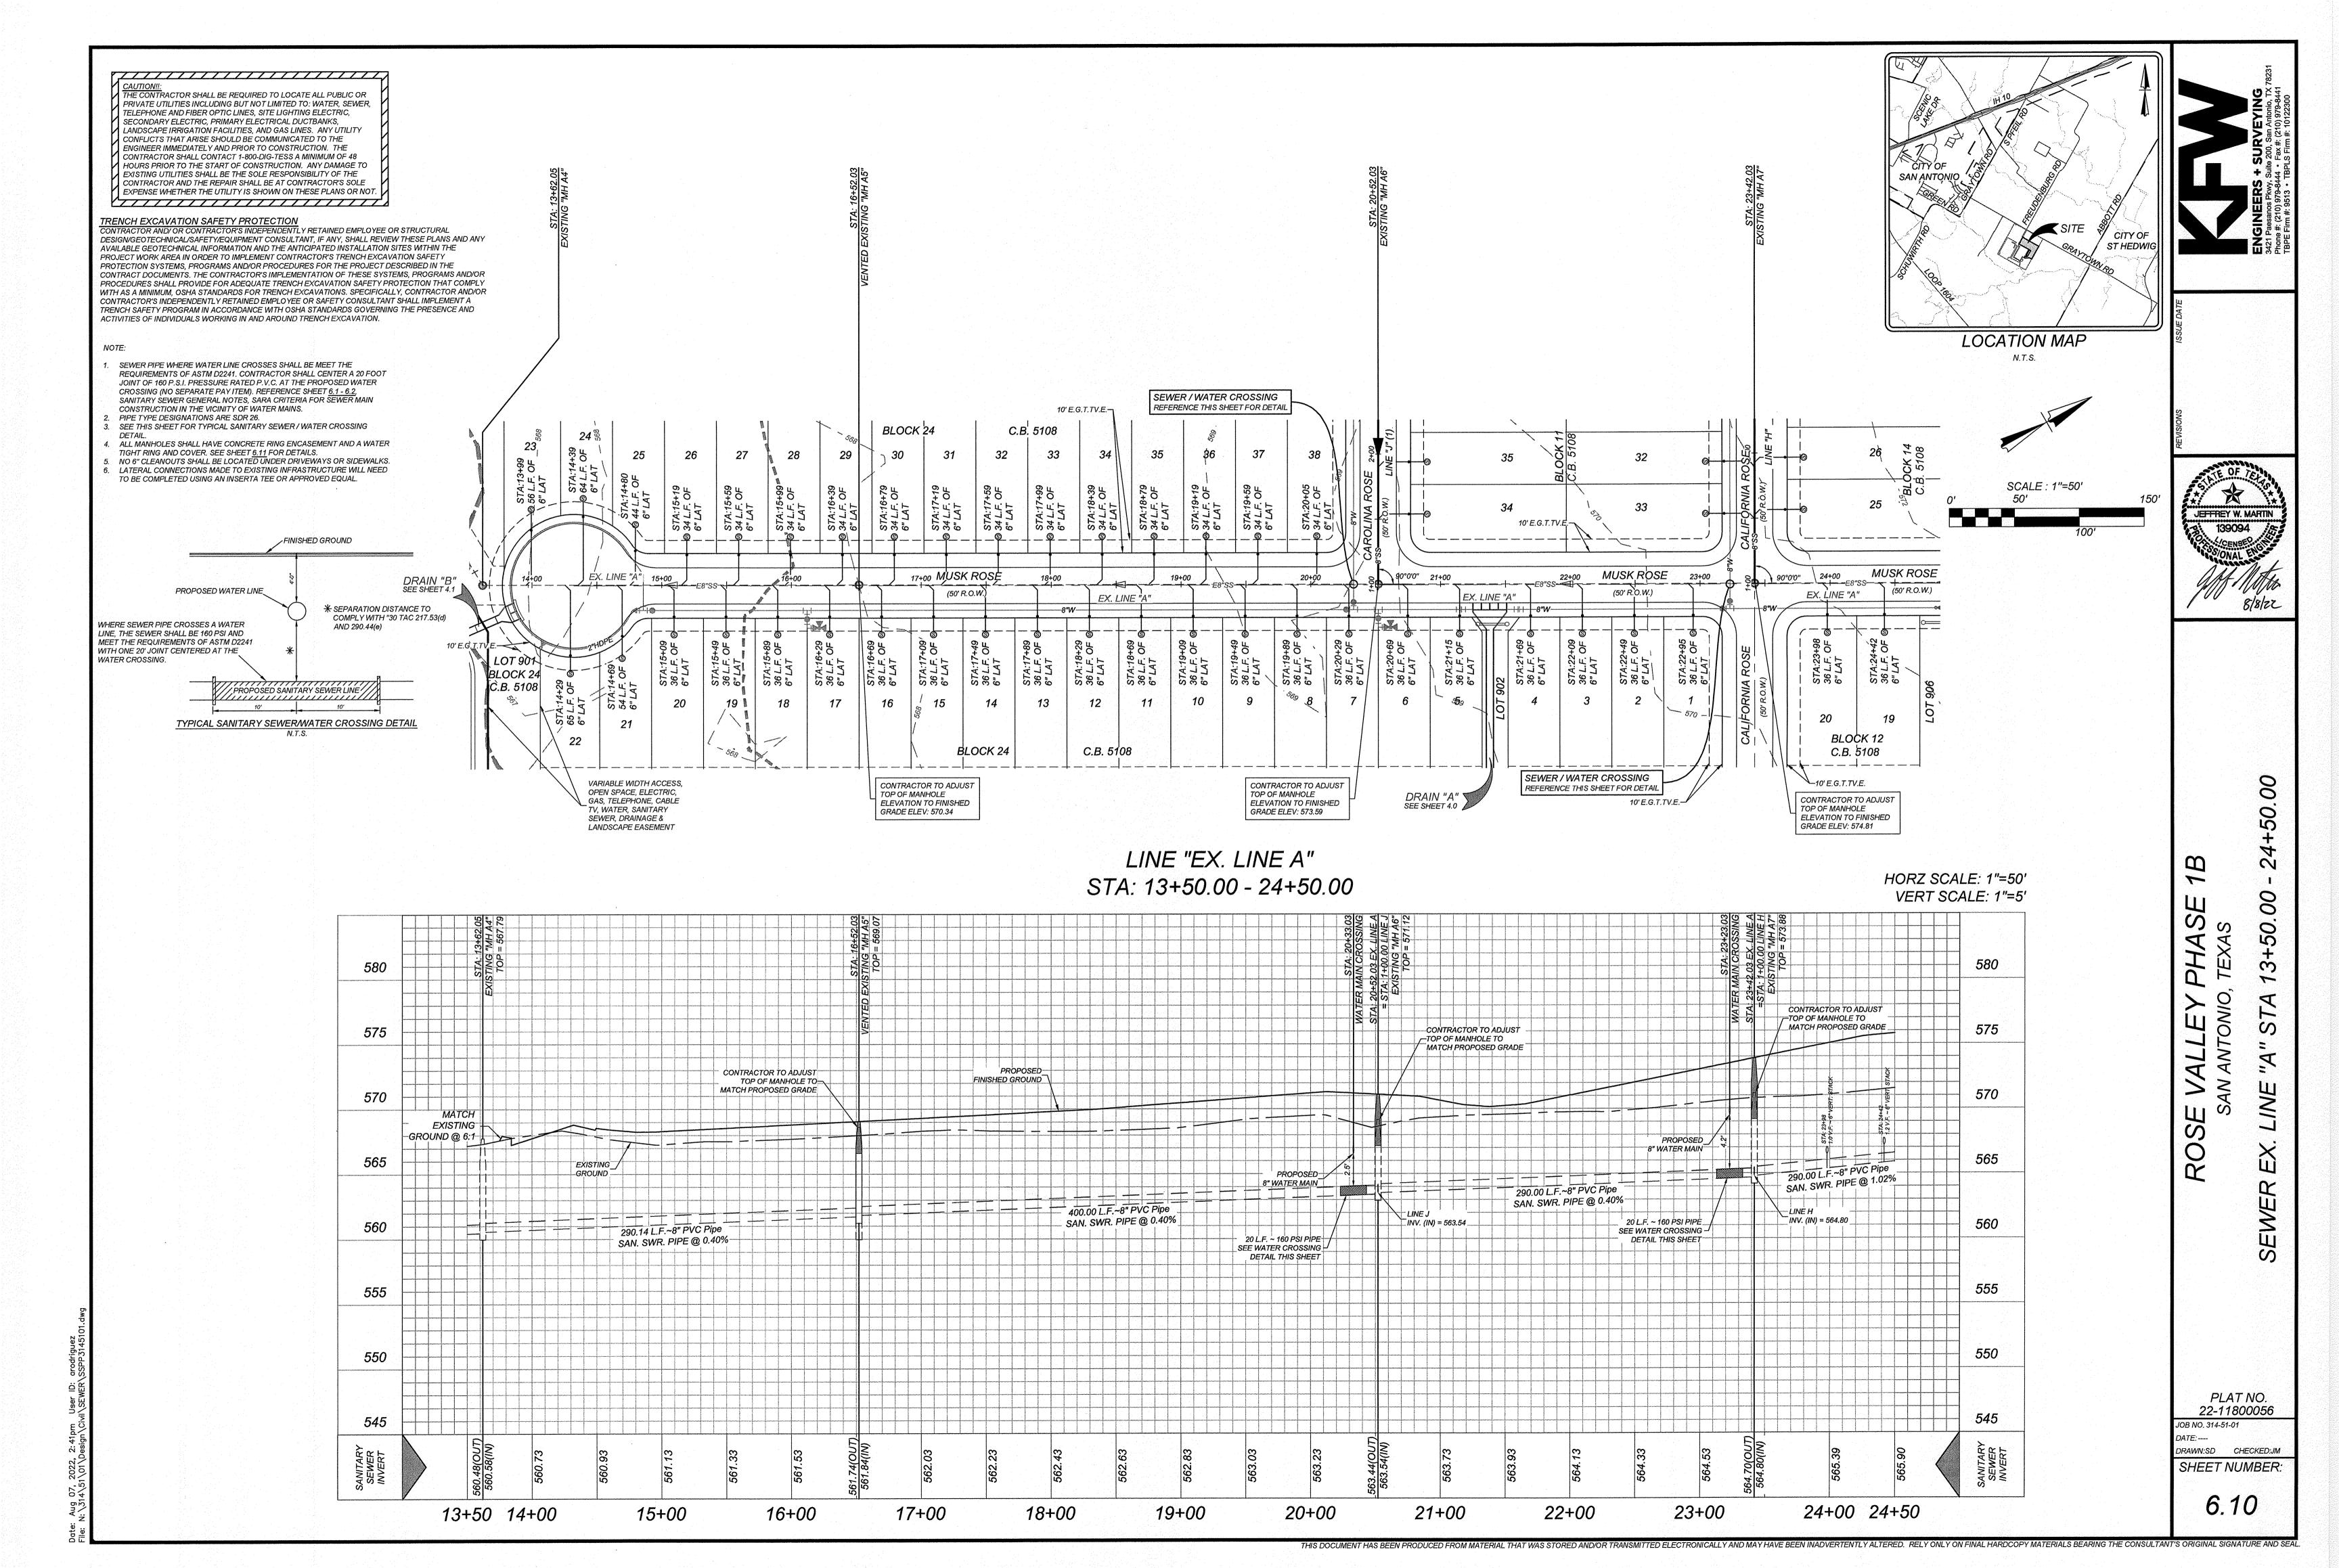


TYPICAL RISER FOR SERVICE CONNECTION USING INSERTA TEE

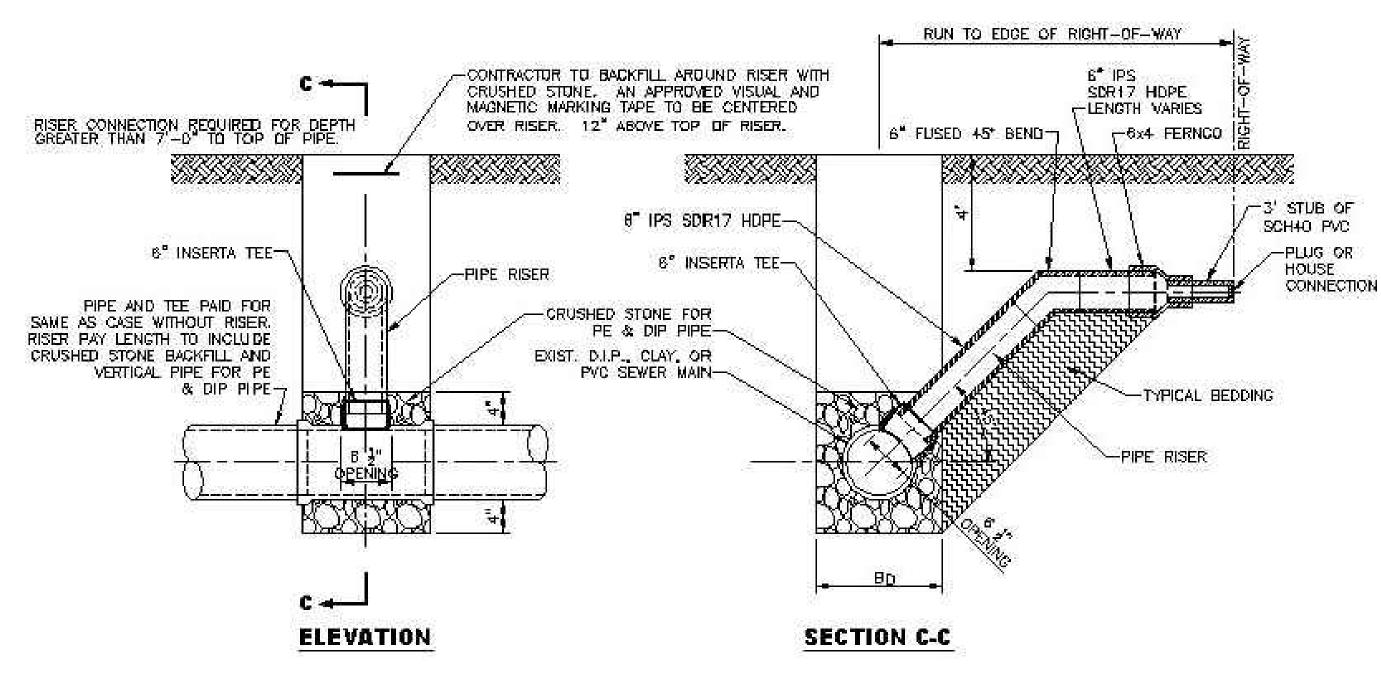N.T.S.

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ENGINEERS + SURVEY
3421 Paesanos Pkwy, Suite 200, San Anto
Phone #: (210) 979-8444 • Fax #: (210) 97
TBPE Firm #: 9513 • TBPLS Firm #: 1012

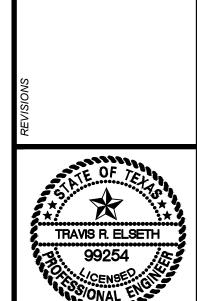


ROSE VALLEY PHASE 1B SAN ANTONIO, TEXAS

PLAT NO. 22-11800056 JOB NO. 314-51-01 DATE: ----DRAWN:SD CHECKED:JM SHEET NUMBER:

- ALL VALVES SHALL REMAIN CLOSED UNTIL MAINS HAVE BEEN DISINFECTED, FLUSHED. AND RELEASED FOR PUBLIC USE BY THE ENGINEER.
- EXISTING UTILITIES SHOWN ARE TAKEN FROM VARIOUS UTILITY COMPANY RECORDS. CONTRACTORS SHALL VERIFY THE EXACT LOCATION AND DEPTH OF ALL UNDERGROUND UTILITIES AND DRAINAGE STRUCTURES, WHETHER SHOWN ON THE PLANS OR NOT, PRIOR TO BEGINNING CONSTRUCTION. CONTRACTORS SHALL BE RESPONSIBLE FOR THE PROTECTION OF EXISTING UTILITIES AND DRAINAGE STRUCTURES DURING CONSTRUCTION.
- ALL EXCAVATION SHALL BE UNCLASSIFIED REGARDLESS OF MATERIAL ENCOUNTERED.
- 4. BIDDERS ARE NOTIFIED TO MAKE SUBSURFACE INVESTIGATIONS AS THEY DEEM NECESSARY. NO ADDITIONAL PAYMENT WILL BE MADE FOR WATER, SAND, GRAVEL OR OTHER UNSTABLE CONDITIONS ENCOUNTERED IN
- DETOUR OF TRAFFIC AROUND WORK ACTIVITIES, MAINTENANCE OF TRAFFIC CONTROL SIGNS, AND FLAGMEN ARE THE CONTRACTOR'S RESPONSIBILITY. NO SEPARATE PAYMENT WILL BE MADE.
- THE CONTRACTOR SHALL PROTECT ALL OPEN EXCAVATIONS AND EQUIPMENT FROM CHILDREN, PEDESTRIANS, AND VEHICLES IN THE AREA.
- 7. THE CONTRACTOR SHALL BE RESPONSIBLE FOR THE RESTORATION OF ALL FENCES IN THE WORK AREA TO THEIR ORIGINAL CONDITION PRIOR TO COMPLETION OF THE CONTRACT. THIS SHALL APPLY TO ALL FENCES IN THE WORK AREA WHETHER THEY ARE SHOWN ON THE PLANS OR NOT.
- CONTRACTOR SHALL PRESERVE ALL CONSTRUCTION STAKES, MARKS, ETC. ANY CONSTRUCTION STAKES, MARKS, ETC., DESTROYED OR REMOVED BY THE CONTRACTOR OR HIS EMPLOYEES SHALL BE REPLACED AT THE CONTRACTOR'S
- 9. THE CONTRACTOR SHALL CONFER WITH EACH INDIVIDUAL PROPERTY OWNER AS TO THE LOCATION OF EACH INDIVIDUAL METER BOX.
- 10. CONTRACTOR SHALL DISINFECT ALL NEW WATER MAINS BEFORE TYING INTO EXISTING WATER MAINS.
- 11. ALL VALVES SHALL BE PERMANENTLY MARKED BY THE USE OF A VALVE MARKER. NO SEPARATE PAY ITEM.
- 12. CONTRACTOR AND/OR CONTRACTOR'S INDEPENDENTLY RETAINED EMPLOYEE OR STRUCTURAL DESIGN/GEOTECHNICAL/SAFETY/EQUIPMENT CONSULTANT, IF ANY, SHALL REVIEW THESE PLANS AND AVAILABLE GEOTECHNICAL INFORMATION AND THE ANTICIPATED INSTALLATION SITES(S) WITHIN THE PROJECT WORK AREA IN ORDER TO IMPLEMENT CONTRACTOR'S TRENCH EXCAVATION SAFETY PROTECTION SYSTEMS, PROGRAMS AND/OR PROCEDURES FOR THE PROJECT DESCRIBED IN THE CONTRACT DOCUMENTS. THE CONTRACTOR'S IMPLEMENTATION OF THESE SYSTEMS, PROGRAMS AND/OR PROCEDURES SHALL PROVIDE FOR ADEQUATE TRENCH EXCAVATION SAFÉTY PROTECTION THAT COMPLY WITH AS A MINIMUM. OSHA STANDARDS FOR TRENCH EXCAVATIONS. SPECIFICALLY, CONTRACTOR AND/OR CONTRACTOR'S INDEPENDENTLY RETAINED EMPLOYEE OR SAFETY CONSULTANT SHALL IMPLEMENT A TRENCH SAFETY PROGRAM IN ACCORDANCE WITH OSHA STANDARDS GOVERNING THE PRESENCE AND ACTIVITIES OF INDIVIDUALS WORKING IN AND AROUND TRENCH EXCAVATION.
- 13. CONTRACTOR SHALL MAINTAIN FENCING FOR THE CONTAINMENT OF LIVESTOCK DURING CONSTRUCTION. ALL FENCES REMOVED FOR CONSTRUCTION SHALL BE REPLACED. ALL REQUIRED FENCING SHALL BE INCIDENTAL TO CONSTRUCTION AND NOT A SEPARATE PAY ITEM.
- 14. ALL DRIVEWAYS, INCLUDING DRAIN PIPES, CULVERTS AND HEADWALLS, DAMAGED DURING CONSTRUCTION SHALL BE REPAIRED BY THE CONTRACTOR TO EQUAL OR BETTER THAN PRECONSTRUCTION CONDITION. ASPHALT DRIVES ARE NOT ALLOWED TO BE CUT WITHOUT OWNERS PERMISSION. INSTALLATION OF WATER MAINS CROSSING CONCRETE DRIVES WILL BE BORED. ALL DRAIN PIPE, CULVERT AND HEADWALL REPAIR SHALL BE INCIDENTAL TO CONSTRUCTION AND NOT A SEPARATE PAY ITEM. DRIVEWAY PAVEMENT REPAIR SHALL BE PAID FOR AS PER ITEM NO. 02950, "CUTTING AND PATCHING ASPHALT PAVEMENT, ASPHALT DRIVES, CONCRETE DRIVES, OR GRAVEL ROADS AND DRIVES". PAYMENT FOR BORES UNDER CONCRETE DRIVES DRIVES SHALL BE PAID FOR AS PER ITEM 02445 "BORING AND CASING PIPE UNDER HIGHWAYS, RAILROADS, OR OTHER AREAS"
- 15. LOCATIONS OF COMBINATION AIR VALVES WHERE SHOWN ON PLANS ARE APPROXIMATE, FINAL LOCATIONS TO BE ADJUSTED IN FIELD AT TIME OF CONSTRUCTION AT THE DIRECTION OF THE ENGINEER.
- 16. ALL WORK SHALL BE SCHEDULED TO TAKE PLACE ON MONDAY THROUGH FRIDAY, DURING NORMAL WORK HOURS. CONTRACTOR SHALL NOTIFY ECSUD 48 HOURS PRIOR TO SERVICE SHUT OFF AFFECTING CUSTOMERS. SERVICE SHALL NOT BE SHUT OFF FOR MORE THAN EIGHT (8) HOURS AT A TIME.
- 17. THE CONTRACTOR SHALL IMMEDIATELY REPAIR OR REPLACE ANY PHYSICAL DAMAGE TO PROPERTY, INCLUDING, BUT NOT LIMITED TO, FENCES, PAVEMENT, DRIVEWAYS, LAWNS, CULVERTS, AND TREES, AT NO COST TO THE OWNER.
- 18. THE CONTRACTOR SHALL PROVIDE EROSION CONTROL AT ALL CULVERT, STREAM AND DRAINAGE SWALE CROSSINGS. EROSION CONTROL MEASURES SHALL INCLUDE AS A MINIMUM SILT FENCES. SILT FENCES SHALL BE INSTALLED PRIOR TO DISTURBANCE OF THE WORK AREAS AND SHALL REMAIN IN PLACE UNTIL FINAL STABILIZATION OF THE DISTURBED AREAS UPSTREAM. EROSION CONTROL SHALL BE COORDINATED WITH THE ENGINEER.
- 19. THE CONTRACTOR SHALL REMOVE AND REPLACE ANY MAILBOXES, TRAFFIC OR ROAD SIGNS ENCOUNTERED. NO SEPARATE PAY ITEM.
- 20. CONTRACTOR SHALL SUBMIT TO ENGINEER PROPOSED CONSTRUCTION SEQUENCE PRIOR TO BEGINNING CONSTRUCTION.
- 21. ALL FITTINGS ARE TO BE DUCTILE IRON, MECHANICAL JOINT TYPE, UNLESS OTHERWISE
- 22. ALL THRUST BLOCKS SHALL BE INSPECTED BY OWNER AND/OR ENGINEER PRIOR TO
- 23. ALL EXISTING VALVES SHOWN ON PLANS TO BE ABANDONED, SHALL HAVE BOXES REMOVED AND SHALL BE BACKFILLED ACCORDING TO SPECIFICATIONS. NO SEPARATE
- 24. CONTRACTOR SHALL CONTAIN ALL CONSTRUCTION AND STAGING WITHIN EXISTING UTILITY EASEMENTS, UNLESS OTHER ARRANGEMENTS ARE MADE WITH OWNER AND/OR TxDOT.
- 25. WHERE THE NEW WATER MAIN SHOWN ON THE PLANS REQUIRES CROSSING AN EXISTING WATER MAIN OR OTHER UTILITY, THE CONTRACTOR SHALL VERTICALLY DEFLECT THE PRO-POSED WATER MAIN. DEFLECTION SHALL BE IN ACCORDANCE WITH THE PIPE MANU-FACTURER'S RECOMMENDATIONS. FITTINGS ARE NOT PERMISSIBLE, UNLESS OTHERWISE SHOWN ON THE PLANS. NO SEPARATE PAY ITEM.
- WATER MAINS SHALL BE INSTALLED WITH 48" MINIMUM COVER OVER THE TOP OF THE PIPE, UNLESS OTHERWISE NOTED ON THE PLANS OR DIRECTED BY THE ENGINEER.
- 27. CONTRACTOR TO PROVIDE POSITIVE DRAINAGE AWAY FROM ALL CONCRETE FOUNDATIONS, VAULT BOXES AND OVERFLOW BOXES THROUGHOUT THE PROJECT SITE.
- 28. CONTRACTOR TO INSTALL DIRECT BURIAL ELECTRICALLY CONTINUOUS TRACER WIRE WITH ACCESS POINTS, ADJACENT TO ALL WATER MAINS. N.S.P.I.

# ROSE VALLEY PHASE 1B

## SAN ANTONIO, TEXAS WATER IMPROVEMENTS

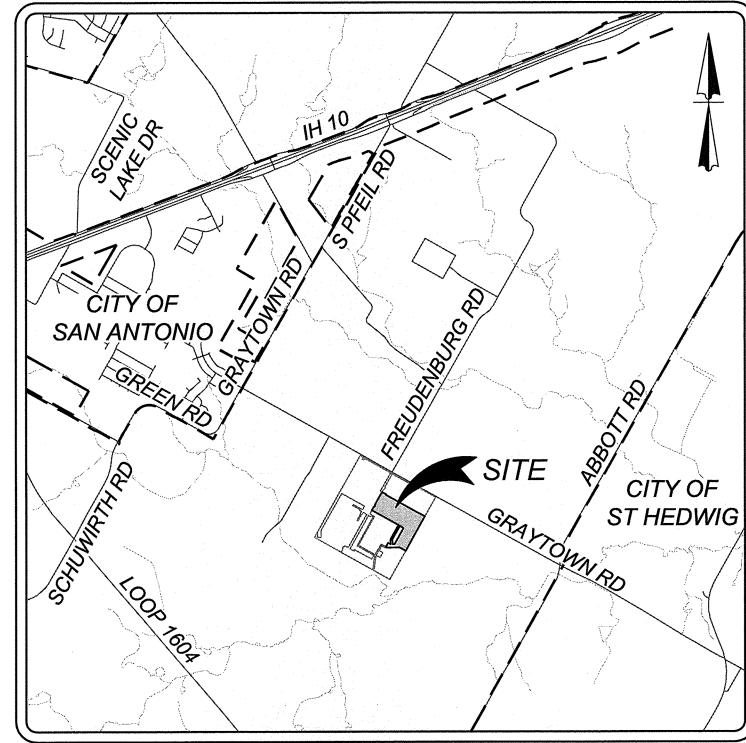

LOCATION MAP

N.T.S.

OWNER/DEVELOPER:

LENNAR HOMES OF TEXAS LAND & CONSTRUCTION LTD.

1922 DRY CREEK WAY, STE. 101

SAN ANTONIO, TX 78259

PHONE: (210) 403-6282





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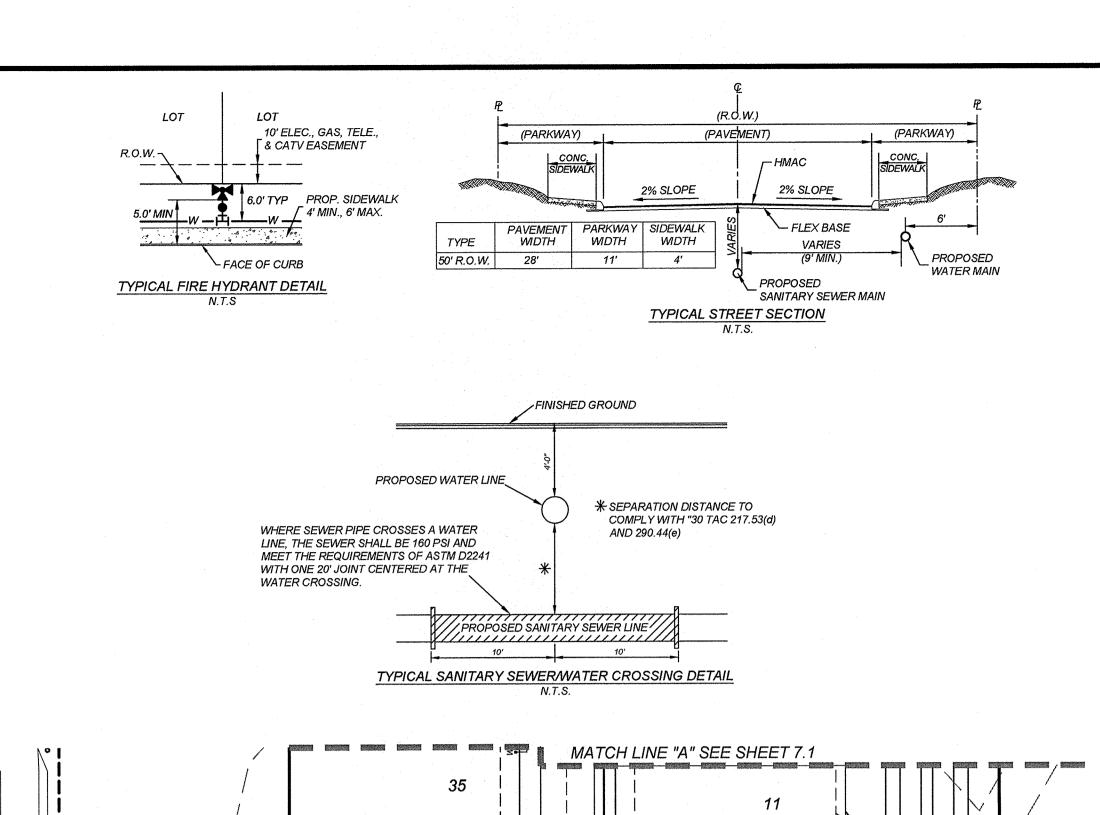
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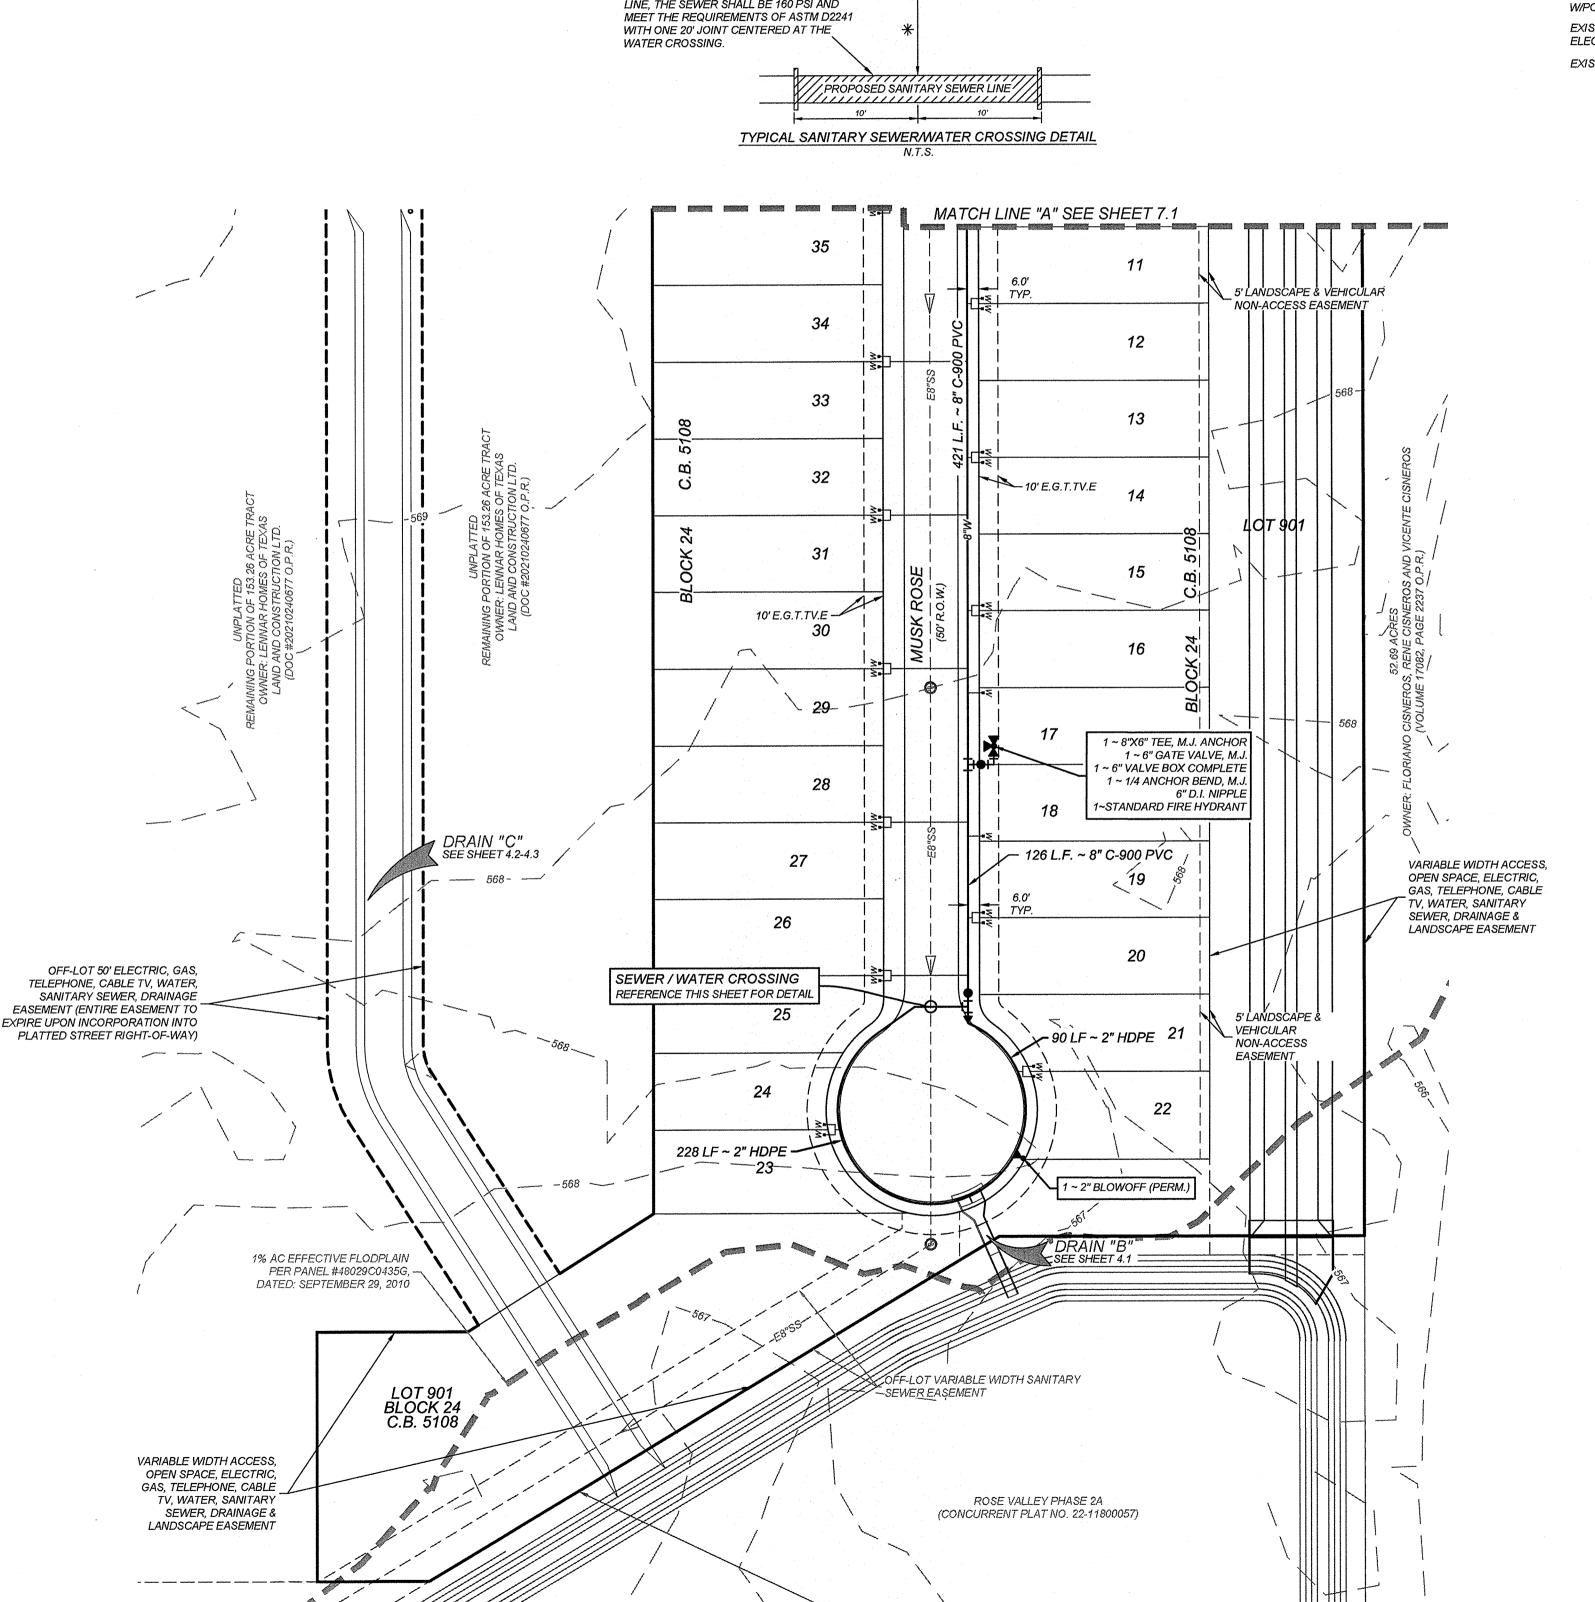
INDEX

INDLA				
DESCRIPTION	SHEET NO.			
WATER IMPROVEMENT COVER SHEET	7.0			
OVERALL WATER PLAN (1 OF 2)	7.1			
OVERALL WATER PLAN (2 OF 2)	7.2			
WATER IMPROVEMENT DETAIL SHEET	7.3			






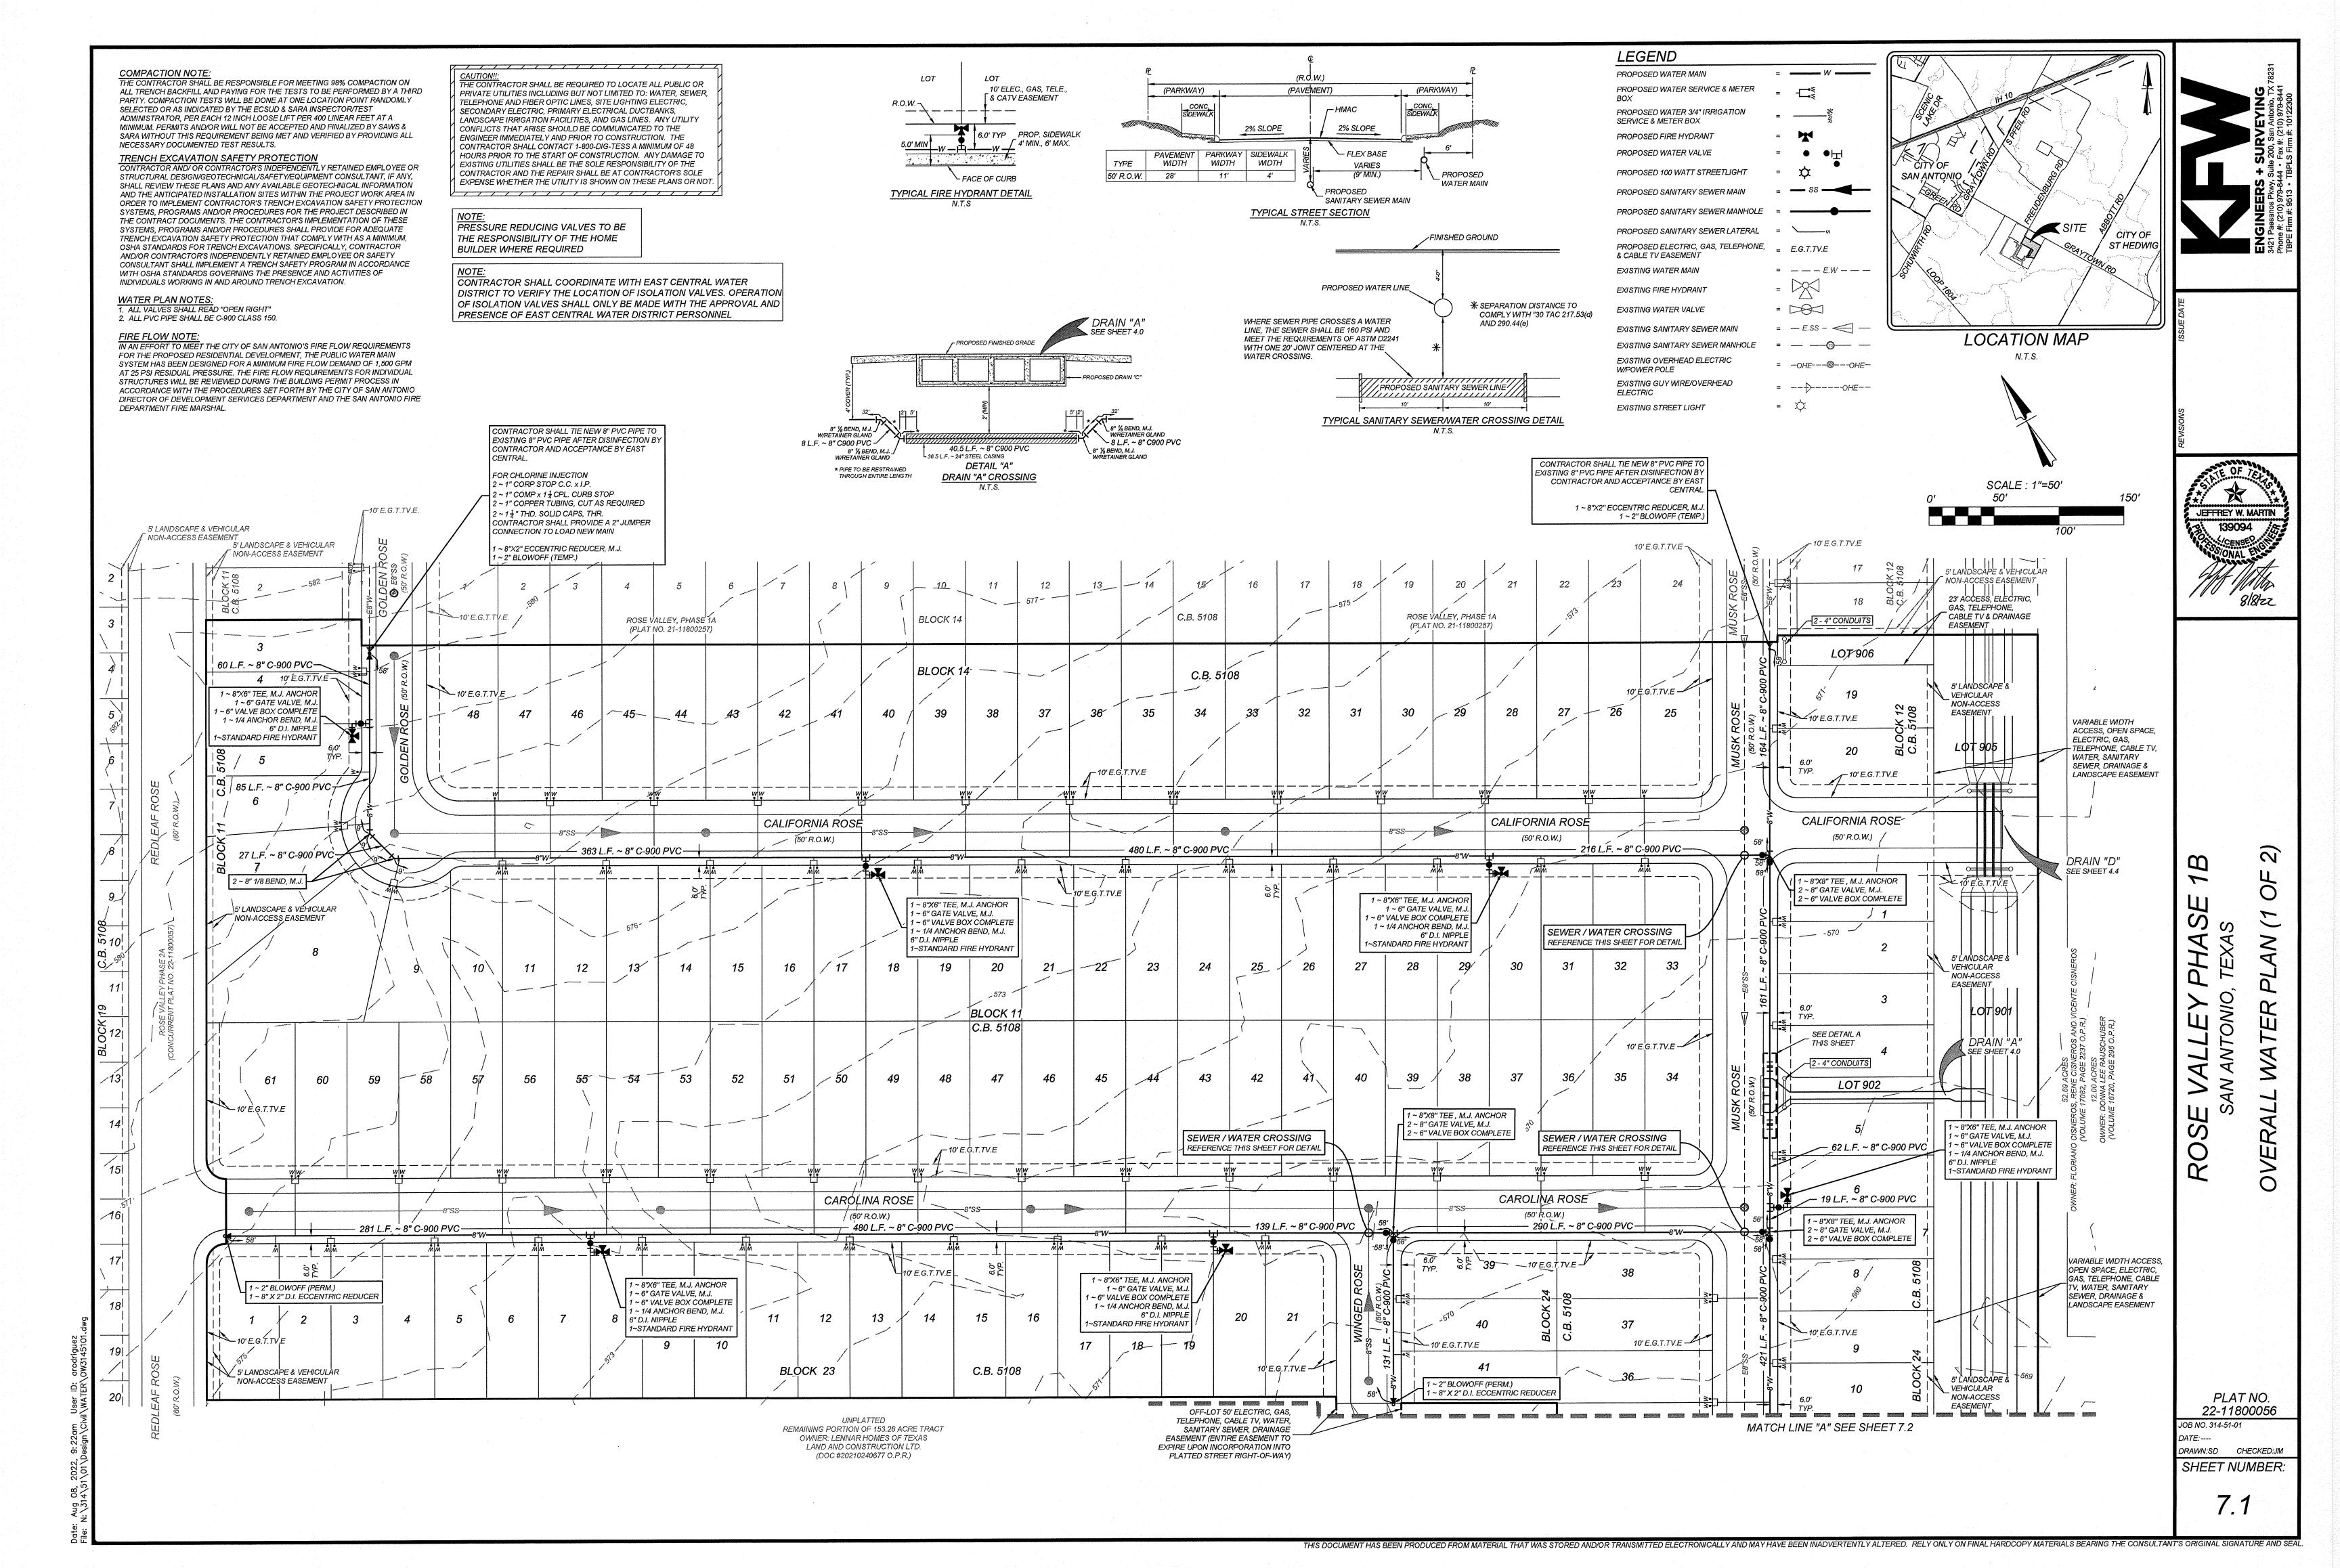

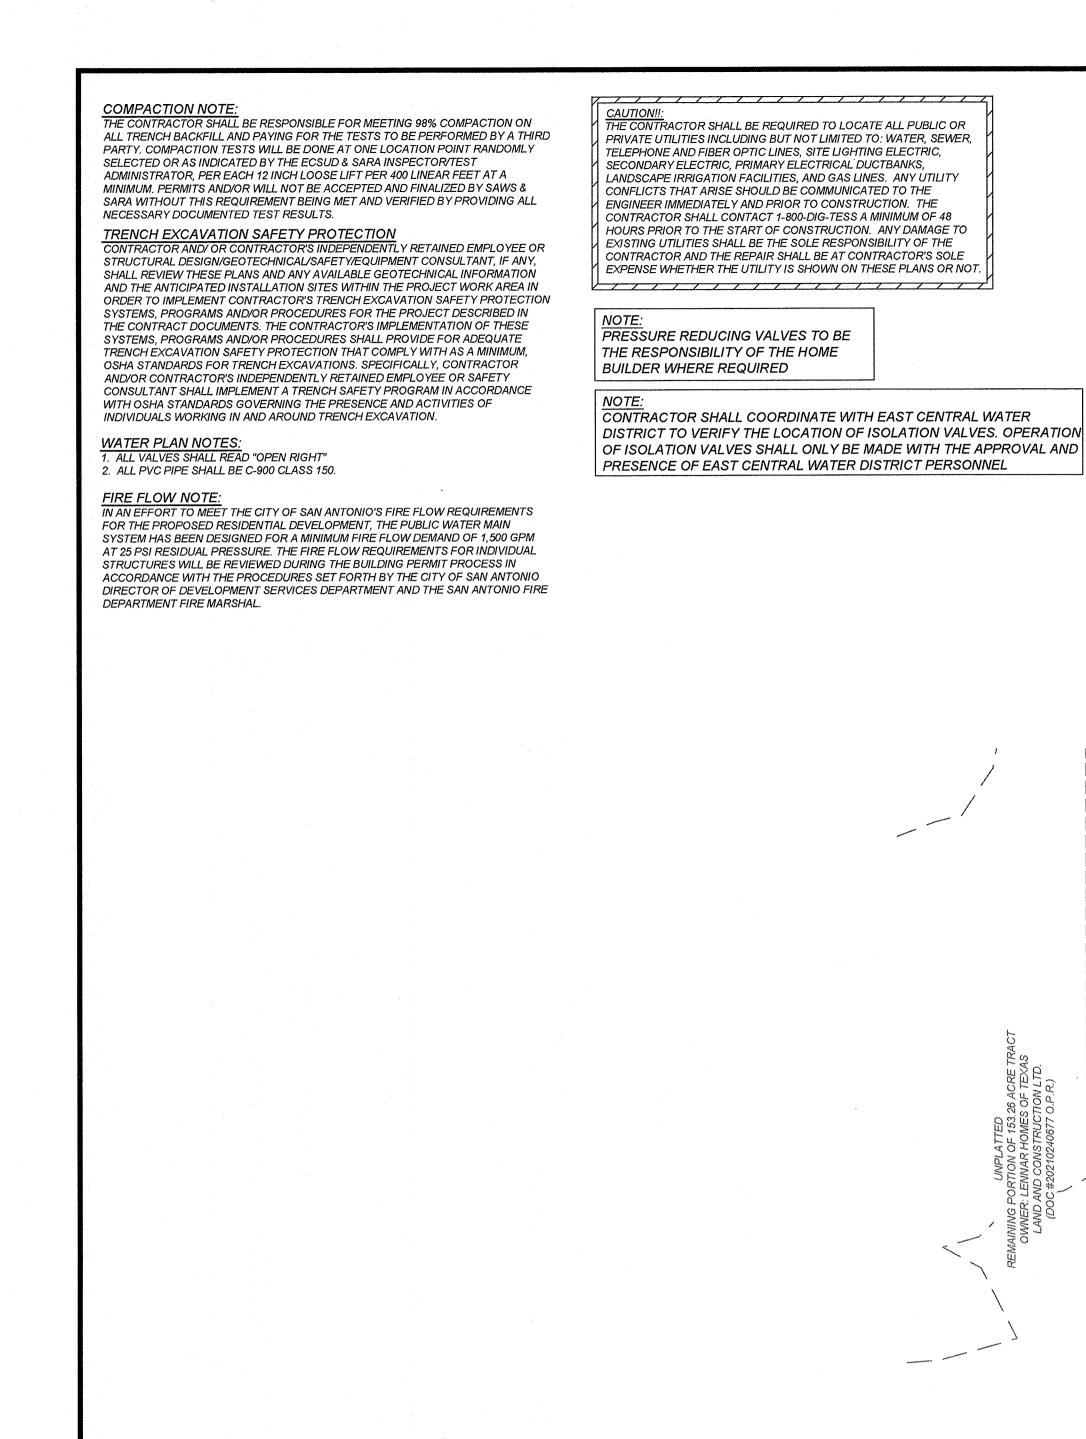



OFF-LOT VARIABLE WIDTH DRAINAGE EASEMENT

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150'

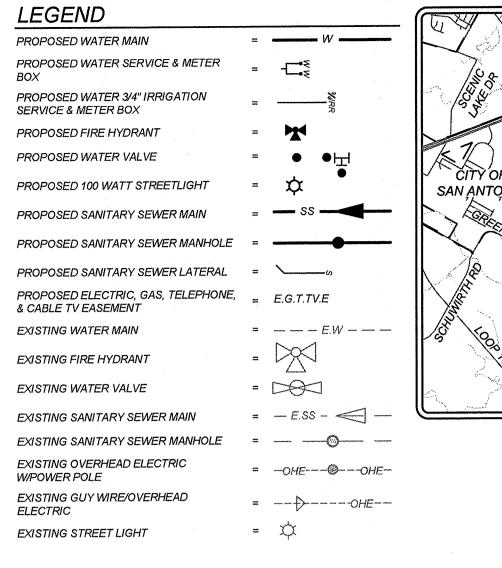
SAN ANTONIO, TEXAS

PLAT NO. 22-11800056 JOB NO. 314-51-01 DATE:----

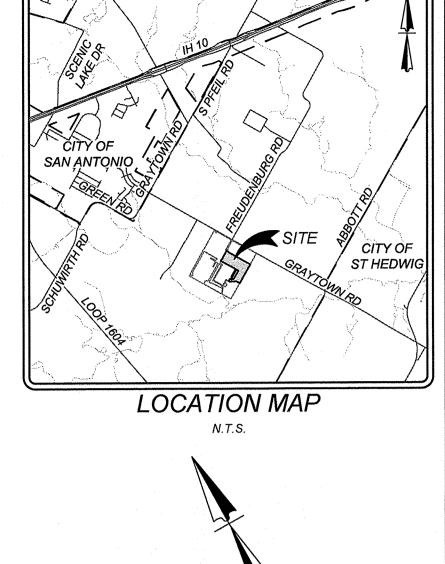DATE:---DRAWN:SD CHECKED:JM
SHEET NUMBER:

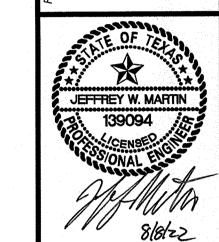72




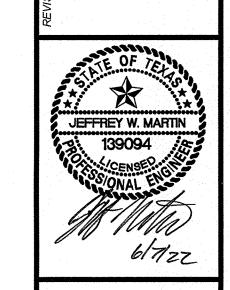

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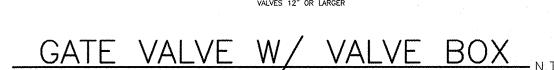
ROVEMEN


PLAT NO. 22-11800056 DRAWN:SD CHECKED:JM SHEET NUMBER:

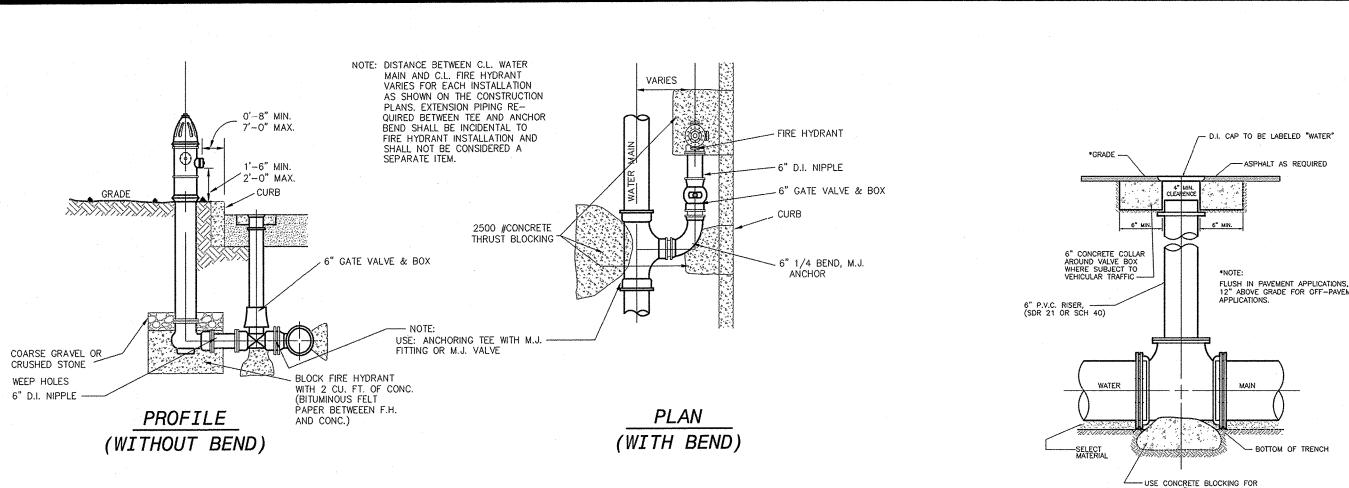

FIRE HYDRANT INSTALLATION N.T.S.

- MIN. 2" HOT MIXED HOT LAYED ASPHALT



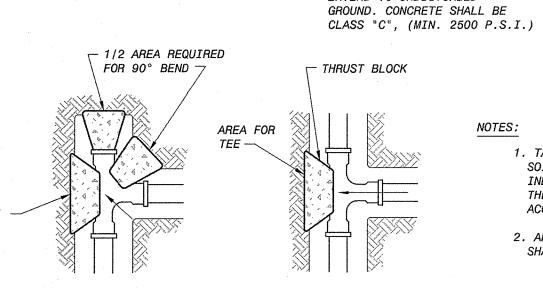

R.C. PIPE CONDUIT


SPECIAL ANTI-CORROSION -SAND EMBEDMENT WHERE REQUIRED.

1. TABLE IS BASED ON 3000#/SQ. FT. SOIL. IF CONDITIONS ARE FOUND TO INDICATE SOIL BEARING IS LESS, THE AREAS SHALL BE INCREASED ACCORDINGLY. 2. AREAS FOR PIPE LARGER THAN 18" SHALL BE CALCULATED.

MINIMUM THRUST BLOCK AREA REQUIRED (Y AND W)		
DIDC	WATER	PIPE
PIPE SIZE	TEE, DEAD END 90° BEND	45° AND 22 1/2° BENDS
4" & LESS	3 SQ. FEET	3 SQ. FEET
6"	4 SQ. FEET	3 SQ. FEET
8"	6 SQ. FEET	3 SQ. FEET
10"	9 SQ. FEET	5 SQ. FEET
12"	13 SQ. FEET	7 SQ. FEET
16"	23 SQ. FEET	12 SQ. FEET
18"	29 SQ. FEET	15 SQ. FEET


- 8" MINIMUM



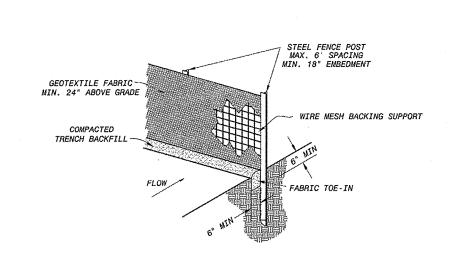


BACKFILL AND PATCH PAVEMENT N.T.S. TEMPORARY SILT FENCE N.T.S.


TEMPORARY ROCK BERM N.T.S.

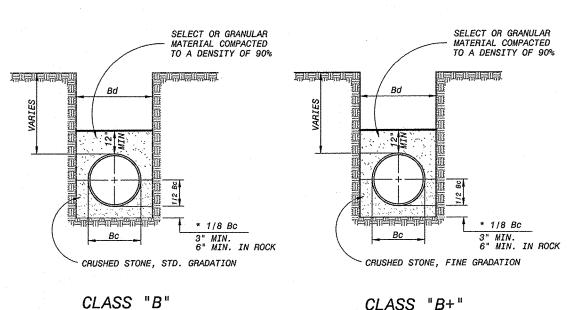




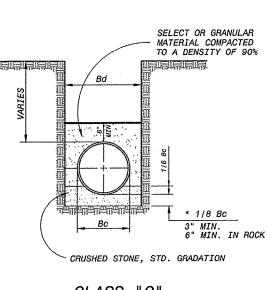

CLASS "C" BEDDING ANGLE 75°, L.F. I.5, E'=300

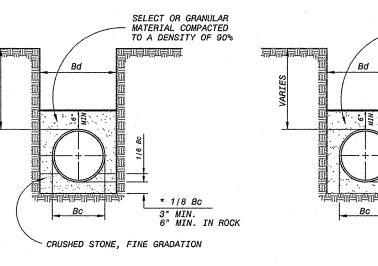

CLASS "C+" BEDDING ANGLE 75°, L.F. I.5, E'=300

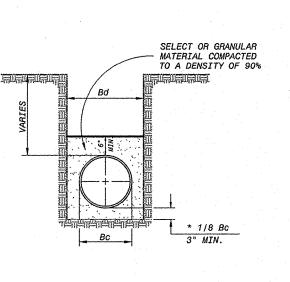


CLASS "D+" BEDDING ANGLE 30°, L.F. I.3, E'=200

EMBEDMENT FOR	WATER	CONDU	ITS				
		IN EARTH			IN ROCK		
TYPE OF PIPE	0'-8'	8'-16'	>161	0'-8'	8'-16'	>16	
ALL PVC WATER PIPE	C+	B+	B+	C+	B+	B+	
16" AND SMALLER DUCTILE IRON WATER PIPE	D+	С	В	С	С	В	

EMBEDMENT DETAILS N.T.S.

EMBEDMENT DIMENSIONS			
PIPE DIAMETER (INCHES)	KIND OF PIPE	EXTERNAL DIAMETER BC (INCHES)	TRENCH WIDTH Bd (INCHES)
0.11	21/2		
6" 6"	PVC DI	6.90	24
8"	PVC	9.05	25
8"	DI	9.05	25
10"	PVC	11.10	27
10"	DI	11.10	27
12"	PVC	13.20	29
12"	DI	13.20	29
16"	DI	17.40	33
18"	DI	19.50	36
20 <sup>u</sup>	DI	21.60	38

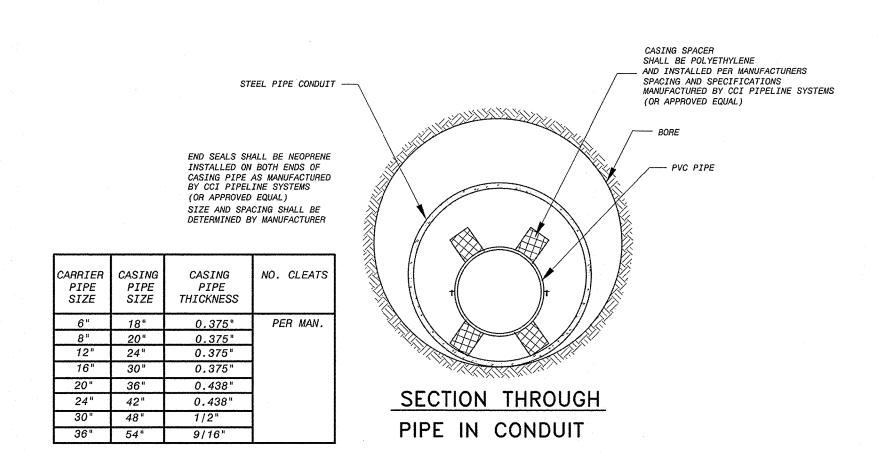

SELECT MATERIAL

SAND EMBEDMENT PLUG

TO EXTEND 4' INTO

INSTALLATION OF PIPE IN CONDUIT N.T.S.

AREA REQUIRED

FOR 90° BEND -


TOTAL AREA EQUALS AREA

REQUIRED FOR TEE

NOTE: THRUST BLOCKS SHALL EXTEND TO UNDISTURBED

THRUST BLOCK DETAILS N.T.S.

NOTE: ALINGNMENT AND GRADE OF CONDUIT WILL BE SPECIFIED ON THE CONSTRUCTION PLANS.

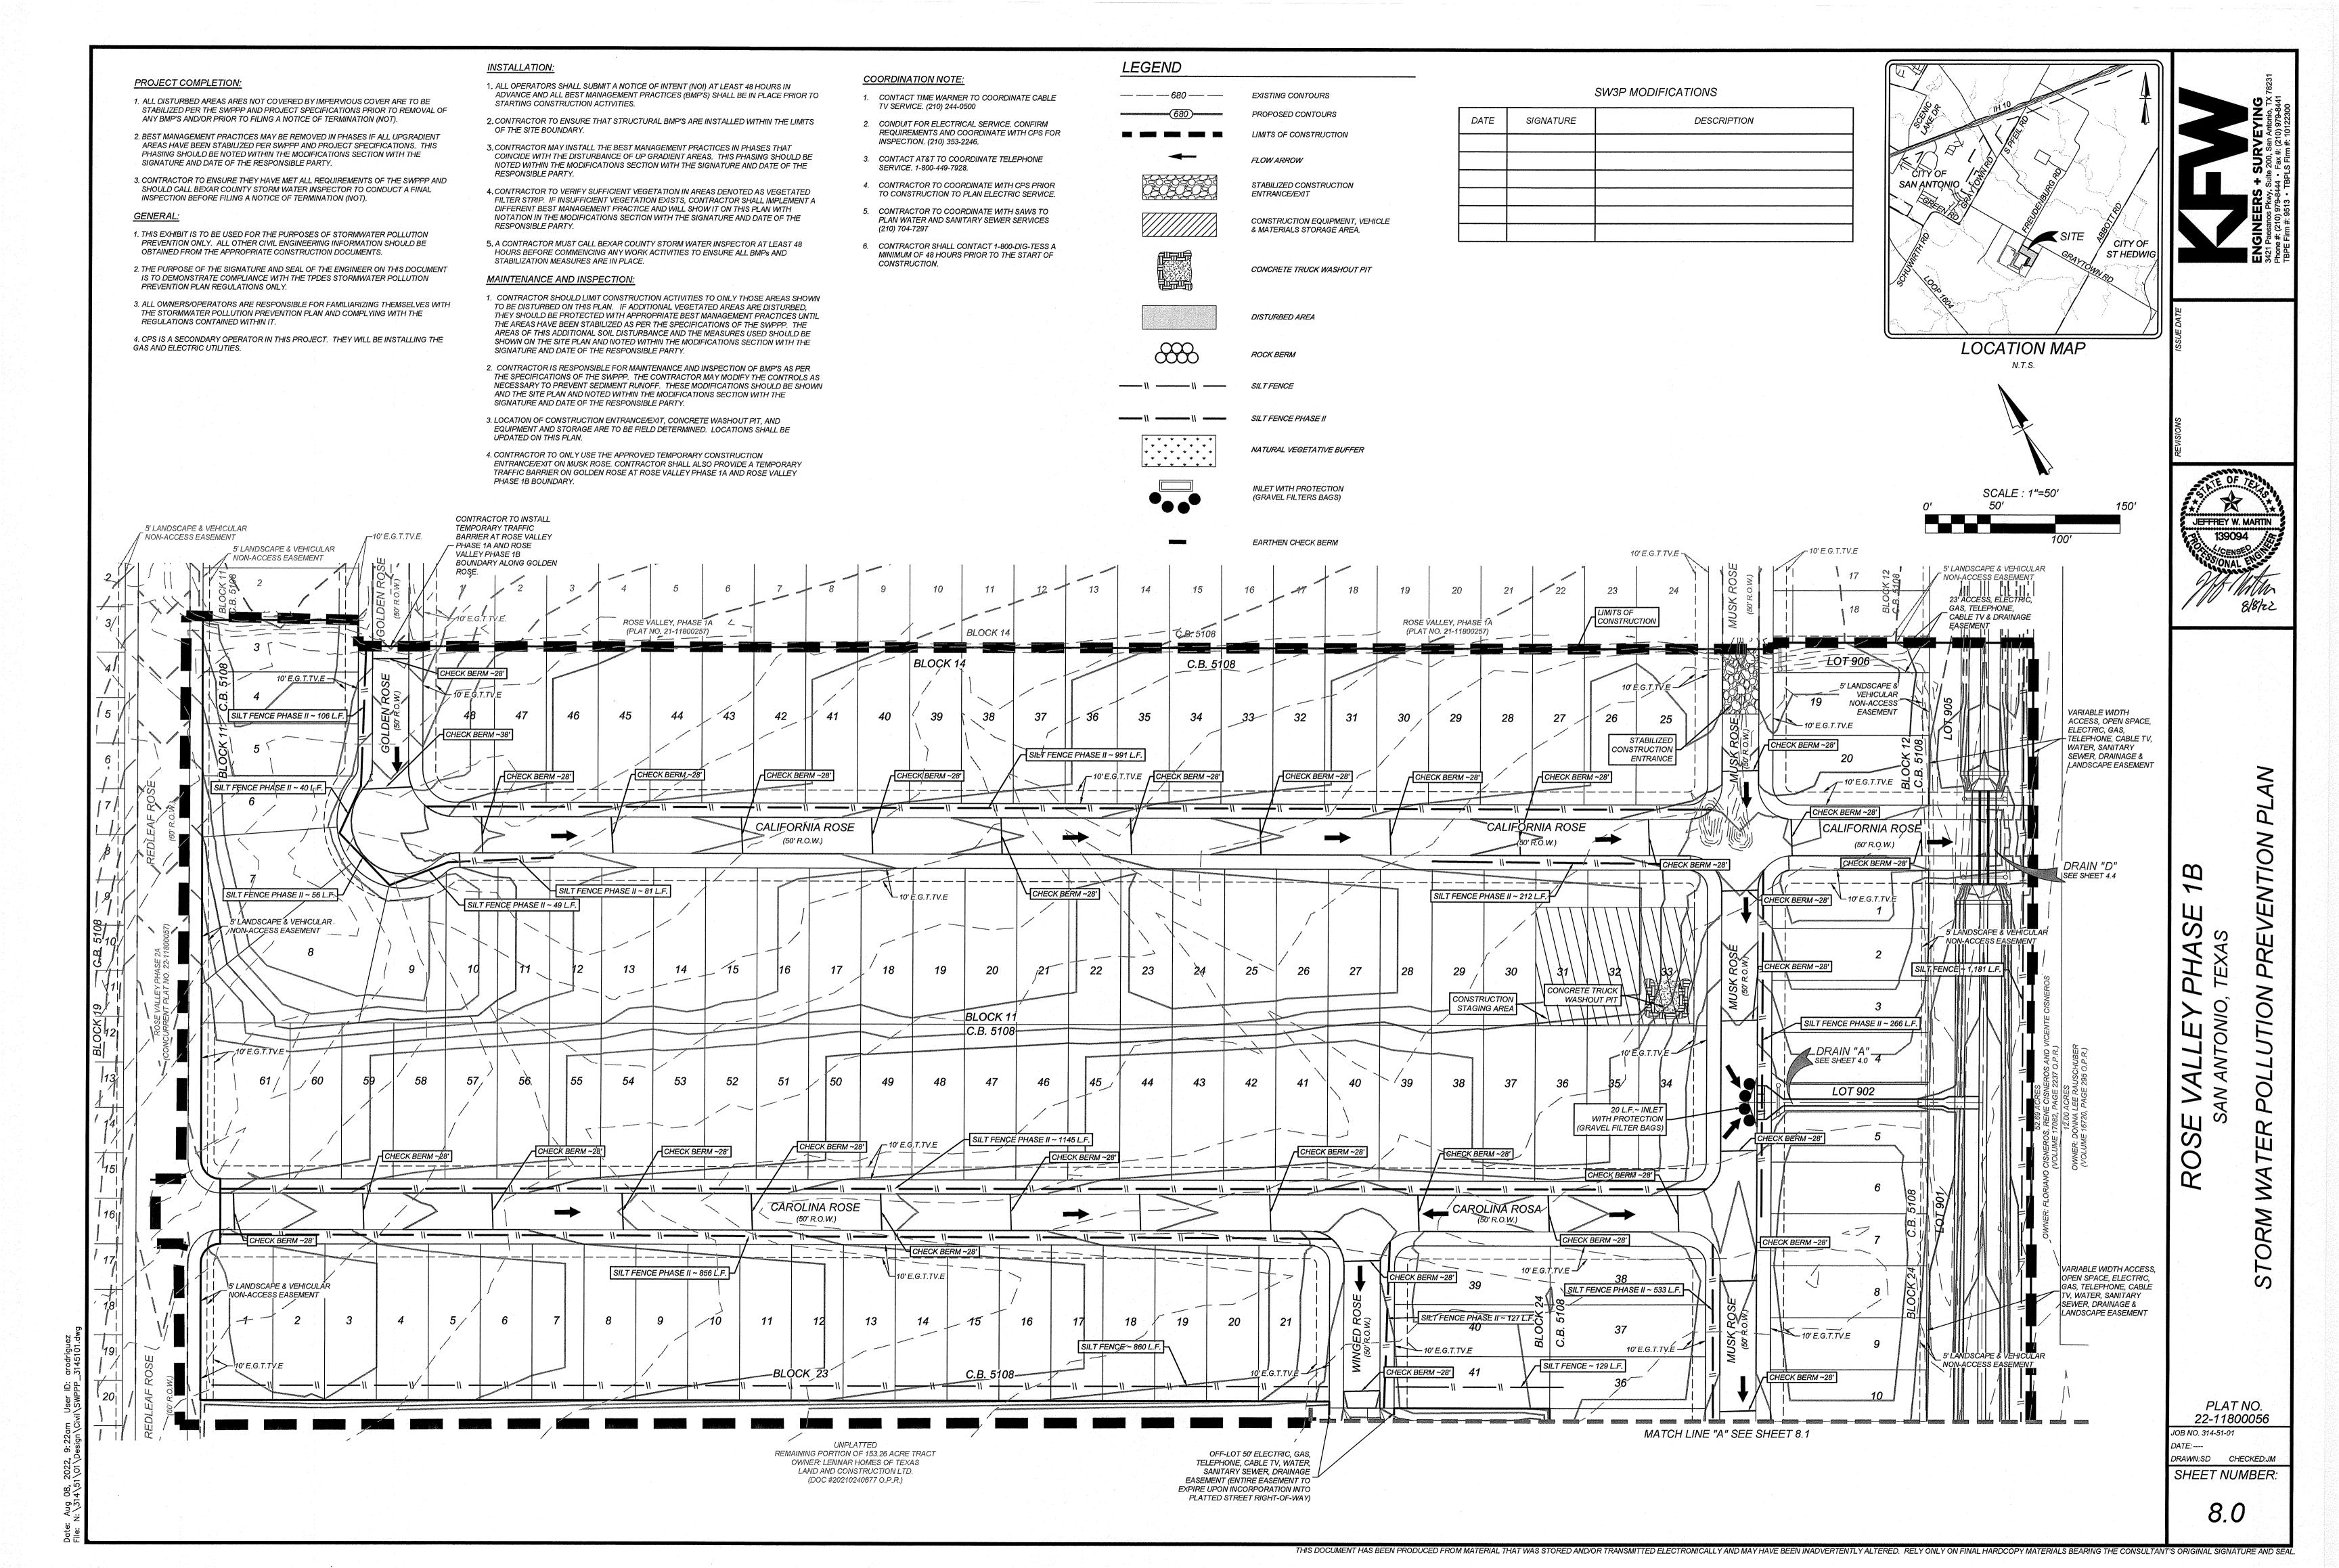

#### PROJECT COMPLETION:

- 1. ALL DISTURBED AREAS ARES NOT COVERED BY IMPERVIOUS COVER ARE TO BE STABILIZED PER THE SWPPP AND PROJECT SPECIFICATIONS PRIOR TO REMOVAL OF ANY BMP'S AND/OR PRIOR TO FILING A NOTICE OF TERMINATION (NOT).
- 2. BEST MANAGEMENT PRACTICES MAY BE REMOVED IN PHASES IF ALL UPGRADIENT AREAS HAVE BEEN STABILIZED PER SWPPP AND PROJECT SPECIFICATIONS. THIS PHASING SHOULD BE NOTED WITHIN THE MODIFICATIONS SECTION WITH THE SIGNATURE AND DATE OF THE RESPONSIBLE PARTY.
- 3. CONTRACTOR TO ENSURE THEY HAVE MET ALL REQUIREMENTS OF THE SWPPP AND SHOULD CALL BEXAR COUNTY STORM WATER INSPECTOR TO CONDUCT A FINAL INSPECTION BEFORE FILING A NOTICE OF TERMINATION (NOT).

- 1. THIS EXHIBIT IS TO BE USED FOR THE PURPOSES OF STORMWATER POLLUTION PREVENTION ONLY. ALL OTHER CIVIL ENGINEERING INFORMATION SHOULD BE OBTAINED FROM THE APPROPRIATE CONSTRUCTION DOCUMENTS.
- 2. THE PURPOSE OF THE SIGNATURE AND SEAL OF THE ENGINEER ON THIS DOCUMENT IS TO DEMONSTRATE COMPLIANCE WITH THE TPDES STORMWATER POLLUTION PREVENTION PLAN REGULATIONS ONLY.
- 3. ALL OWNERS/OPERATORS ARE RESPONSIBLE FOR FAMILIARIZING THEMSELVES WITH THE STORMWATER POLLUTION PREVENTION PLAN AND COMPLYING WITH THE REGULATIONS CONTAINED WITHIN IT.
- 4. CPS IS A SECONDARY OPERATOR IN THIS PROJECT. THEY WILL BE INSTALLING THE GAS AND ELECTRIC UTILITIES.

#### INSTALLATION:

- 1. ALL OPERATORS SHALL SUBMIT A NOTICE OF INTENT (NOI) AT LEAST 48 HOURS IN ADVANCE AND ALL BEST MANAGEMENT PRACTICES (BMP'S) SHALL BE IN PLACE PRIOR TO STARTING CONSTRUCTION ACTIVITIES.
- 2. CONTRACTOR TO ENSURE THAT STRUCTURAL BMP'S ARE INSTALLED WITHIN THE LIMITS OF THE SITE BOUNDARY.
- 3. CONTRACTOR MAY INSTALL THE BEST MANAGEMENT PRACTICES IN PHASES THAT COINCIDE WITH THE DISTURBANCE OF UP GRADIENT AREAS. THIS PHASING SHOULD BE NOTED WITHIN THE MODIFICATIONS SECTION WITH THE SIGNATURE AND DATE OF THE
- 4. CONTRACTOR TO VERIFY SUFFICIENT VEGETATION IN AREAS DENOTED AS VEGETATED FILTER STRIP. IF INSUFFICIENT VEGETATION EXISTS, CONTRACTOR SHALL IMPLEMENT A DIFFERENT BEST MANAGEMENT PRACTICE AND WILL SHOW IT ON THIS PLAN WITH NOTATION IN THE MODIFICATIONS SECTION WITH THE SIGNATURE AND DATE OF THE RESPONSIBLE PARTY.
- 5. A CONTRACTOR MUST CALL BEXAR COUNTY STORM WATER INSPECTOR AT LEAST 48 HOURS BEFORE COMMENCING ANY WORK ACTIVITIES TO ENSURE ALL BMPs AND STABILIZATION MEASURES ARE IN PLACE.

### MAINTENANCE AND INSPECTION:

- 1. CONTRACTOR SHOULD LIMIT CONSTRUCTION ACTIVITIES TO ONLY THOSE AREAS SHOWN TO BE DISTURBED ON THIS PLAN. IF ADDITIONAL VEGETATED AREAS ARE DISTURBED, THEY SHOULD BE PROTECTED WITH APPROPRIATE BEST MANAGEMENT PRACTICES UNTIL THE AREAS HAVE BEEN STABILIZED AS PER THE SPECIFICATIONS OF THE SWPPP. THE AREAS OF THIS ADDITIONAL SOIL DISTURBANCE AND THE MEASURES USED SHOULD BE SHOWN ON THE SITE PLAN AND NOTED WITHIN THE MODIFICATIONS SECTION WITH THE SIGNATURE AND DATE OF THE RESPONSIBLE PARTY.
- 2. CONTRACTOR IS RESPONSIBLE FOR MAINTENANCE AND INSPECTION OF BMP'S AS PER THE SPECIFICATIONS OF THE SWPPP. THE CONTRACTOR MAY MODIFY THE CONTROLS AS NECESSARY TO PREVENT SEDIMENT RUNOFF. THESE MODIFICATIONS SHOULD BE SHOWN AND THE SITE PLAN AND NOTED WITHIN THE MODIFICATIONS SECTION WITH THE SIGNATURE AND DATE OF THE RESPONSIBLE PARTY.
- 3. LOCATION OF CONSTRUCTION ENTRANCE/EXIT, CONCRETE WASHOUT PIT, AND EQUIPMENT AND STORAGE ARE TO BE FIELD DETERMINED. LOCATIONS SHALL BE UPDATED ON THIS PLAN.
- 4. CONTRACTOR TO ONLY USE THE APPROVED TEMPORARY CONSTRUCTION ENTRANCE/EXIT ON MUSK ROSE. CONTRACTOR SHALL ALSO PROVIDE A TEMPORARY TRAFFIC BARRIER ON GOLDEN ROSE AT ROSE VALLEY PHASE 1A AND ROSE VALLEY PHASE 1B BOUNDARY.

#### **COORDINATION NOTE:**

- 1. CONTACT TIME WARNER TO COORDINATE CABLE TV SERVICE. (210) 244-0500
- 2. CONDUIT FOR ELECTRICAL SERVICE, CONFIRM REQUIREMENTS AND COORDINATE WITH CPS FOR INSPECTION. (210) 353-2246.
- 3. CONTACT AT&T TO COORDINATE TELEPHONE

SERVICE. 1-800-449-7928.

- 4. CONTRACTOR TO COORDINATE WITH CPS PRIOR TO CONSTRUCTION TO PLAN ELECTRIC SERVICE.
- 5. CONTRACTOR TO COORDINATE WITH SAWS TO PLAN WATER AND SANITARY SEWER SERVICES
- 6. CONTRACTOR SHALL CONTACT 1-800-DIG-TESS A MINIMUM OF 48 HOURS PRIOR TO THE START OF CONSTRUCTION.

#### SW3P MODIFICATIONS

DATE	SIGNATURE	DESCRIPTION

SEE SHEET 4.5-4.6

VARIABLE WIDTH ACCESS.

OPEN SPACE, ELECTRIC, GAS. TELEPHONE. CABLE

TV, WATER, SANITARY

SEWER, DRAINAGE & LANDSCAPE EASEMENT

MATCH LINE "A" SEE SHEET 8.0

**∽ 10' E.G.T.TŲ́.E** 

CHECK BERM ~28'

CHECK BERM ~28'

OFF-LOT VARIABLE WIDTH SANITARY SEWER EASEMENT

ROSE VALLEY PHASE 2A (CONCURRENT PLAT# 22-11800057)

OFF-LOT VARIABLE WIDTH DRAINAGE EASEMENT

SILT FĘNCE PHASE II ~ 397 L.F.

SILT FENCE PHASE II ~ 66 L.F.

SILT FENCE PHASE II ~ 34 L.F.

SILT FENCE ~ 1,181 L.F.

SILT FENCE ~ 1,181 L.F.

VEHICULAR NON-ACCESS

34

SILT FENCE PHASE II ~ 533 L.F

15 L.F.~ INLET

WITH PROTECTION GRAVEL FILTER BAGS)

SILT FENCE PHASE II ~ 70 L.F

SILT FENCE PHASE II ~ 51 L.F.

SILT FENCE ~ 302 L.F.

TYPE 4 SACK

GABIONS

TYPE 4 SACK

DRAIN "C" SEE SHEET 4.2-4.3

TYPE 4 SACK

LOT 901 BLOCK 24 C.B. 5108

GABIONS

OFF-LOT 50' ELECTRIC, GAS,

1% AC EFFECTIVE FLODPLAIN PER PANEL #48029C0435G, -DATED: SEPTEMBER 29, 2010


VARIABLE WIDTH ACCESS. OPEN SPACE, ELECTRIC, GAS, TELEPHONE, CABLE TV, WATER, SANITARY SEWER, DRAINAGE & LANDSCAPE EASEMENT


TELEPHONE, CABLE TV, WATER, SANITARY SEWER, DRAINAGE


EASEMENT (ENTIRE EASEMENT TO EXPIRE UPON INCORPORATION INTO

PLATTED STREET RIGHT-OF-WAY)

GABIONS

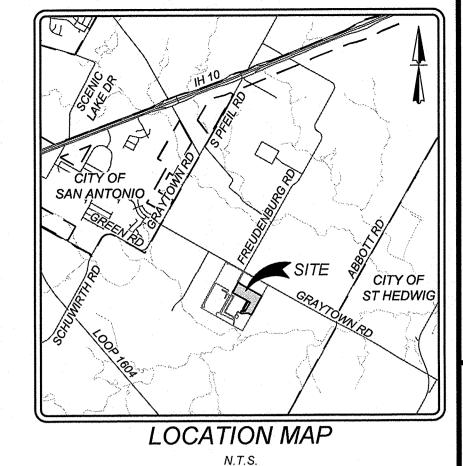

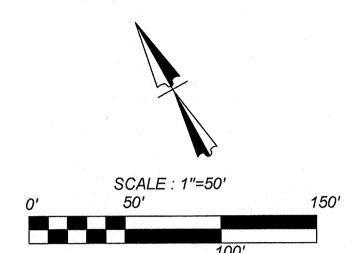

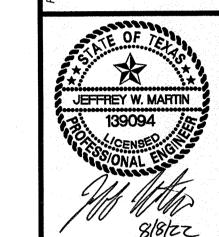


SS

EXISTING CONTOURS PROPOSED CONTOURS LIMITS OF CONSTRUCTION FLOW ARROW STABILIZED CONSTRUCTION ENTRANCE/EXIT CONSTRUCTION EQUIPMENT, VEHICLE & MATERIALS STORAGE AREA. CONCRETE TRUCK WASHOUT PIT

NATURAL VEGETATIVE BUFFER + + + + + INLET WITH PROTECTION


(GRAVEL FILTERS BAGS) EARTHEN CHECK BERM

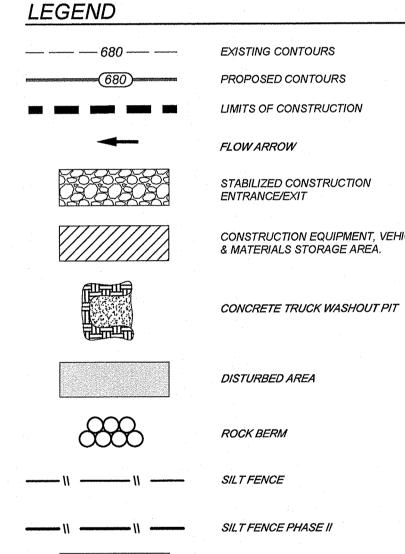



PLAT NO. 22-11800056 OB NO. 314-51-01

DRAWN:SD CHECKED:JM SHEET NUMBER:

THIS DOCUMENT HAS BEEN PRODUCED FROM MATERIAL THAT WAS STORED AND/OR TRANSMITTED ELECTRONICALLY AND MAY HAVE BEEN INADVERTENTLY ALTERED. RELY ONLY ON FINAL HARDCOPY MATERIALS BEARING THE CONSULTANT'S ORIGINAL SIGNATURE AND SEAL

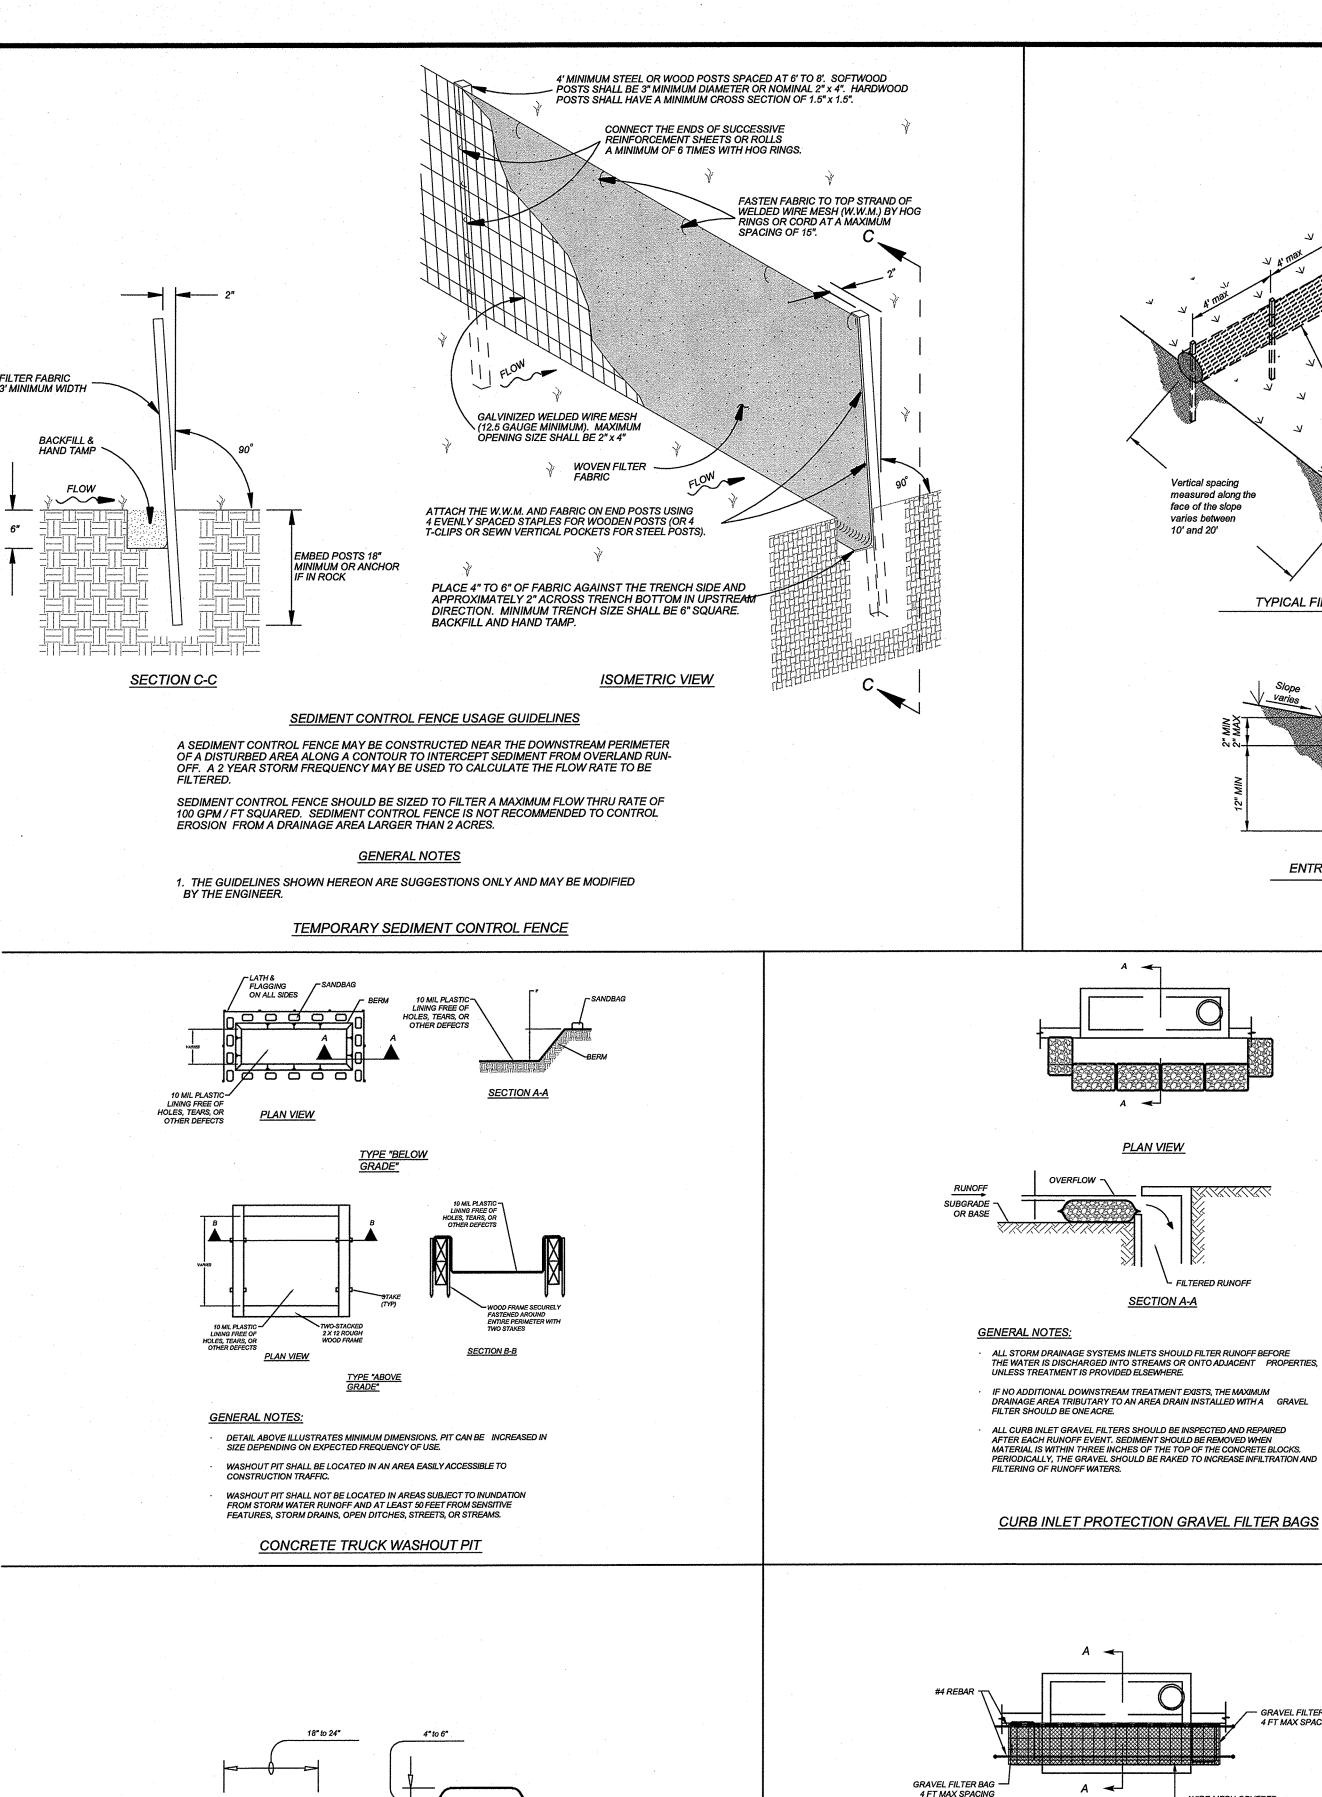

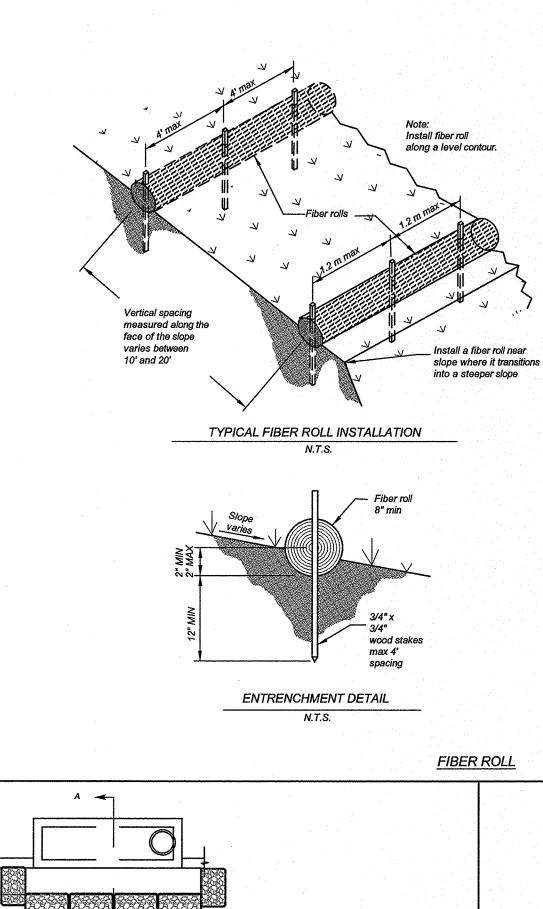

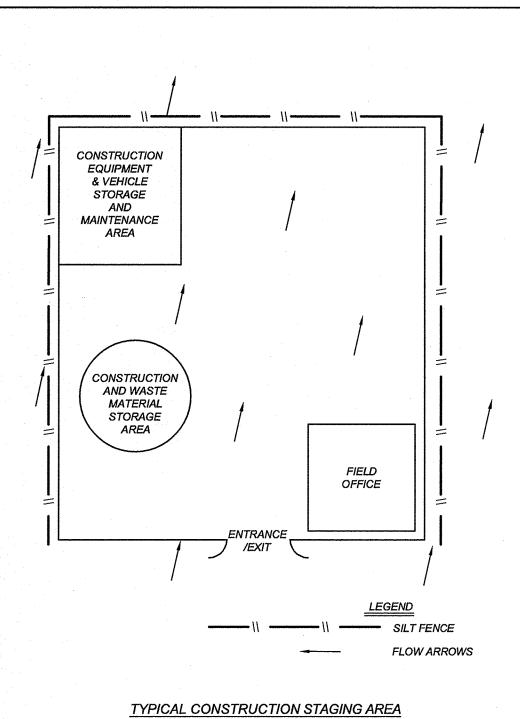

THE MATERIAL, INSTALLATION, INSPECTION, AND MAINTENANCE OF FIBER ROLLS WILL BE PER THE MANUFACTURE'S SPECIFICATIONS

AND SHALL ALSO COMPLY WITH THE TEXAS COMMISSION OF

may be compost, mulch, aspen wood fibers, chipped site vegetation,

agricultural rice or wheat straw, coconut fiber, 100% recyclable fibers, or

(2) Containment Mesh: Containment mesh should be 100% biodegradable,

photodegradable or recyclable such as burlap, twine, UV photodegradable

plastic, polyester, or similar material. When the fiber role will remain in place as part of a vegetative system use biodegradable or photodegradable mesh.

Slope inclination of 4:1 (H:V) or flatter: Fiber rolls should be placed at a

Slope inclination 2:1 (H:V) or greater: Fiber Rolls should be placed at a

Slope inclination between 4:1 and 2:1 (H:V): Fiber Rolls should be placed at a

(2) Turn the ends of the fiber roll up slope to prevent runoff from going around the

(4) Drive stakes at the end of each fiber roll and spaced 4 ft maximum on center.

(5) Use wood stakes with a nominal classification of 0.75 by 0.75 in. and minimum

(6) If more than one fiber roll is placed in a row, the rolls should be overlapped, not

(1) Inspect prior to forecast rain, daily during extended rain events, after rain events,

(3) If the fiber roll is used as a sediment capture device, or as an erosion control

periodically removed in order to maintain its effectiveness. Sediment should be

incorporated into earthwork on the site or disposed of at an appropriate location.

device to maintain sheet flows, sediment that accumulates behind the role must be

removed when the accumulation reaches one-half the designated sediment storage depth, usually one-half the distance between the top of the fiber roll and the adjacent ground surface. Sediment removed during maintenance may be

(3) Stake fiber rolls into a 2 to 4 in. deep trench with a width equal to the diameter of

BEST MANAGEMENT PRACTICES" AS NOTED BELOW.

For temporary installation recyclable mesh is recommended.

maximum interval of 15 ft. (a closer spacing is more effective).

maximum interval of 10 ft. (a closer spacing is more effective).

(2) Repair or replace split, torn, unraveling, or slumping fiber rolls.

(1) Locate fiber rolls on level contours spaced as follows:

similar materials.


maximum interval of 20 ft.


Inspection and Maintenance Guidelines:

the fiber roll.

ENVIRONMENTAL QUALITY CURRENT "TECHNICAL GUIDANCE ON

(1) Core material: Core material should be biodegradable or recyclable. Material

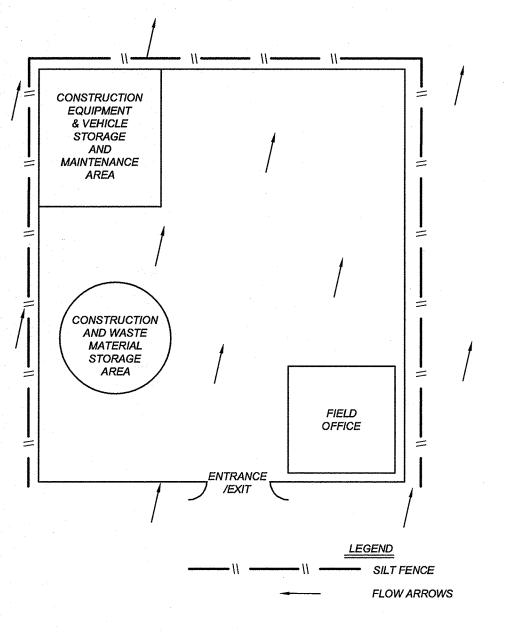

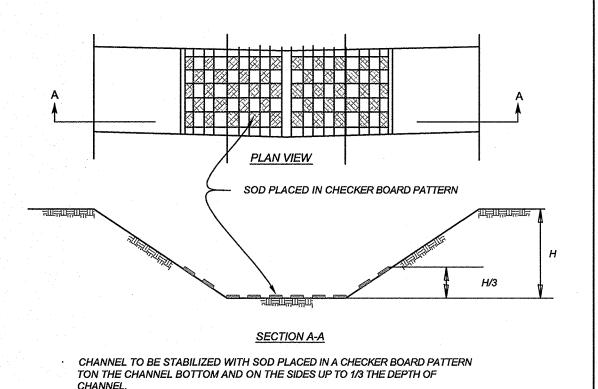

**CHANNEL LINING** 

### GEOTEXTILE, FABRIC CROSS-SECTION OF A CONSTRUCTION ENTRANCE/EXIT Installation: (North Carolina, 1993) (1) Avoid curves on public roads and steep slopes. Remove vegetation and other objectionable material from the foundation area. Grade crown foundation for positive drainage. (2) The minimum width of the entrance/exit should be 12 feet or the full width of exit roadway, whichever is greater. (3) The construction entrance should be at least 50 feet long. (4) If the slope toward the road exceeds 2%, construct a ridge, 6 to 8 inches high with 3:1 (H:V) side slopes, across the foundation approximately 15 feet from the entrance to divert runoff away from the public road.

(1) The aggregate should consist of 4 to 8 inch washed stone over a stable foundation as specified in the plan. (2) The aggregate should be placed with a minimum thickness of 8 inches. (3) The geotextile fabric should be designed specifically for use as a soil filtration media with an approximate weight of 6 oz/yd2, a mullen burst rating of 140 lb/in2, and an equivalent opening size greater than a number

(4) If a washing facility is required, a level area with a minimum of 4 inch diameter washed stone or commercial rack should be included in the plans. Divert wastewater to a sediment trap or basin.

AGGREGATE GEOTEXTILE FABRIC TO STABILIZE FOUNDATION

CONSTRUCTION ENTRANCE/EXIT

(7) Divert all surface runoff and drainage from the stone pad to a sediment trap or basin. (8) Install pipe under pad as needed to maintain proper public road drainage. (1) The entrance should be maintained in a condition, which will prevent tracking or flowing of sediment onto public

(6) Place stone to dimensions and grade shown on plans. Leave surface smooth and slope for drainage.


(5) Place geotextile fabric and grade foundation to improve stability, especially where wet conditions are anticipated.

rights-of-way. This may require periodic top dressing with additional stone as conditions demand and repair andlor cleanout of any measures used to trap sediment. (2) All sediment spilled, dropped, washed or tracked onto public rights-of-way should be removed immediately by contractor. (3) When necessary, wheels should be cleaned to remove sediment prior to entrance onto public right-of-way. (4) When washing is required, it should be done on an area stabilized with crushed stone that drains into an approved sediment trap or sediment basin.

(5) All sediment should be prevented from entering any storm drain, ditch or water course by using approved methods.

**CROSS SECTION** 

#### STABILIZED CONSTRUCTION ENTRANCE / EXIT

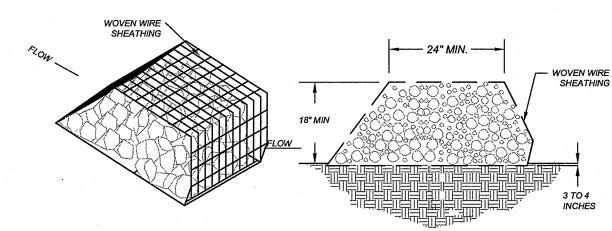

ISOMETRIC PLAN VIEW

1) The berm structure should be. secured with a woven wire sheathing having maximum opening of 1 neter or zo gauge garvanized and should be secured with shoat ning

(2) Clean, open graded 3- to 5-inch diameter rock should be used, except in areas where high velocities


or large volumes of flow are expected, where 5- to 8-inch diameter rocks may be used. (1) Lay out the woven wire sheathing perpendicular to the flow line. The sheathing should be 20 gauge woven wire mesh with 1 inch openings. (2) Berm should have a top width of 2 feet minimum with side slopes being 2:1 (H:V) or flatter.

(3) Place the rock along the sheathing as shown in the diagram Figure 1-28), to a height not less than (4) Wrap the wire sheathing around the rock and secure with tie wire so that the ends of the sheathing overlap at least 2 inches, airl the berm retains its shape when walked upon. (5) Berm should be built along the contour at zero percent grade or as near as possible. (6) The ends of the berm should be tied into existing upslope grade and the berm should be buried in a trench approximately 3 to 4 inches deep to prevent failure of the control.

Inspection and Maintenance Guidelines: (1) Inspection should be made weekly and after each rainfall by the responsible party. For installations in streambeds, additional daily inspections should be made. (2) Remove sediment and other debris when buildup reaches 6 inches and dispose of the accumulated silt in an approved manner that will not cause any additional siltation. (3) Repair any loose wire sheathing.

(4) The berm should be reshaped as needed during inspection. (5) The berm should be replaced when the structure ceases to function as intended due to silt accumulation among the rocks, washout, construction traffic damage, etc. (6) The rock berm should be left in place until all upstream areas are stabilized and accumulated silt

### ROCK BERM

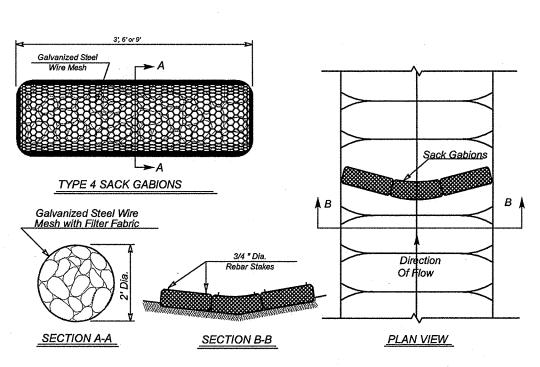

THE TOP OF THE SACK GABIONS SHOULD BE LEVEL AND ORIENTED PERPENDICULAR TO THE DIRECTION OF FLOW. FILTER FABRIC MATERIAL SHALL BE FASTENED TO WOVEN WIRE

FILTER FABRIC MATERIAL SHOULD MEET THE FOLLOWING

SPECIFICATIONS: RESISTANT TO ULTRAVIOLET LIGHT, FABRIC SHOULD BE NON-WOVEN GEOTEXTILE WITH MINIMUM WEIGHT OF 3. 200 POUNDS PER SQUARE INCH AND A FLOW THRU RATE OF 120 GALLONS PER MINUTE PER SQUARE FOOT OF FRONTAL AREA. STONE SIZE: ±4"-8" OPEN GRADED CRUSHED LIMESTONE.

INSPECT WEEKLY OR AFTER EACH RAINFALL EVENT AND REPAIR OR WHEN SILT REACHES A DEPTH OF 6 INCHES OR MORE ABOVE NATURAL GROUND, SILT SHALL BE REMOVED AND DISPOSED IN AN APPROVED MANNER THAT WILL NOT CONTRIBUTE TO RESILTATION. CONTAMINATED SEDIMENT MUST BE REMOVED AND DISPOSED OF


OFF-SITE IN ACCORDANCE WITH APPLICABLE REGULATIONS.

PLAT NO. 22-11800056 JOB NO. 314-51-01

1

DATE: ----DRAWN:SD CHECKED:JM SHEET NUMBER:

SECTION A-A **GENERAL NOTES:** THE FILTER BAG MATERIAL SHALL BE MADE OF POLYPROPYLENE, POLYETHYLENE OR POLYAMIDE WOVEN FABRIC, MIN UNIT WEIGHT OF 4 OUNCES/SY, MULLEN BURST STRENGTH EXCEEDING 300 PSI AND ULTRAVIOLET THE FILTER BAG SHALL BE FILLED WITH CLEAN, MEDIUM TO COARSE GRAVEL (0.31 GRAVEL FILTER BAG DETAIL

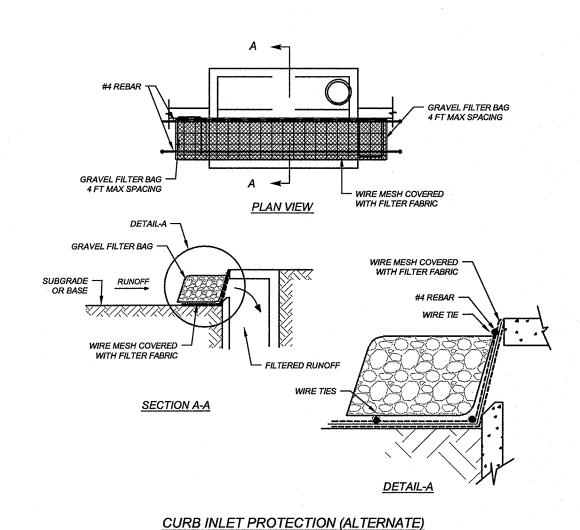

SECTION A-A

**TYPE 4 SACK GABIONS** 

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