

#### PROJECT LOCATION MAP

SCALE: N.T.S.

#### PROJECT BENCHMARK

#### LEGAL DESCRIPTION SOMERSET GROVE, UNIT 4

BEING A TOTAL OF 11.780 ACRE TRACT OF LAND INCLUSIVE OF A 0.428 ACRE RIGHT OF WAY DEDICATION TO THE CITY OF SAN ANTONIO OUT OF PART OF A 29.68 ACRE TRACT LOCATED IN OLD CITY LOTS (OCL) 19 AND 20, RANGE 4. DISTRICT 6 OF THE CITY TRACT OF SAN ANTONIO DE BEXAR, AS SURVEYED AND DIVIDED IN 1852, BEING A PORTION OF A CALLED 57.21 ACRE TRACT AND A CALLED 20.25 ACRE TRACT, BOTH DESCRIBED IN VOLUME 2631, PAGE 483, DEED

RECORDS, BEXAR COUNTY, TEXAS.

# SOMERSET GROVE UNIT 4

SAN ANTONIO, TEXAS CIVIL SITE CONSTRUCTION PLANS

LENNAR HOMES OF TEXAS LAND AND CONSTRUCTION, LTD 100 NE LOOP 410, SUITE 1155 SAN ANTONIO, TEXAS 78216

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C0.0		COVER SHEET
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C1.1		EROSION CONTROL DETAILS
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C2.1		GRADING PLAN (2 OF 2)
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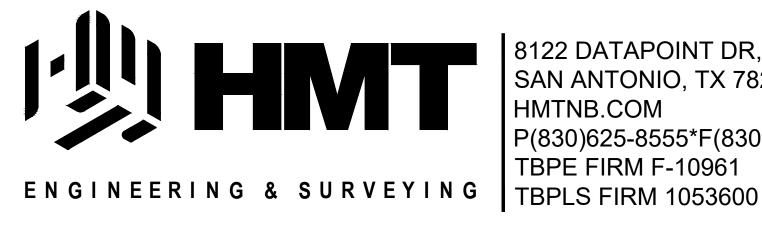
Sheet List Table

## **MARCH 2024**





### PREPARED BY:



8122 DATAPOINT DR, STE. 400 SAN ANTONIO, TX 78230 P(830)625-8555\*F(830)625-8556 **TBPE FIRM F-10961** 

#### NOTE TO CONTRACTOR:

BY THE ACT OF SUBMITTING A BID FOR THIS PROPOSED CONTRACT, THE BIDDER WARRANTS THAT THE BIDDER, AND ALL SUBCONTRACTORS AND MATERIAL SUPPLIERS HE INTENDS TO USE HAVE CAREFULLY AND THOROUGHLY REVIEWED THE DRAWINGS, SPECIFICATIONS AND ALL OTHER CONTRACT DOCUMENTS AND HAVE FOUND THEM COMPLETE AND FREE FROM ANY AMBIGUITIES AND SUFFICIENT FOR THE PURPOSE INTENDED. THE BIDDER FURTHER WARRANTS THAT TO THE BEST OF HIS OR HIS SUBCONTRACTORS' AND MATERIAL SUPPLIERS' KNOWLEDGE, ALL MATERIALS AND PRODUCTS SPECIFIED OR INDICATED HEREIN ARE ACCEPTABLE FOR ALL APPLICABLE CODES AND AUTHORITIES.

THE LOCATION OF ALL EXISTING UTILITIES SHOWN ON THESE PLANS HAS BEEN BASED UPON RECORD INFORMATION ONLY AND MAY NOT MATCH LOCATIONS AND/OR DEPTHS AS CONSTRUCTED. THE CONTRACTOR SHALL CONTACT EACH OF THE INDIVIDUAL UTILITIES FOR ASSISTANCE IN DETERMINING EXISTING UTILITY LOCATIONS AND DEPTHS PRIOR TO BEGINNING ANY CONSTRUCTION. CONTRACTOR SHALL FIELD VERIFY LOCATIONS OF ALL UTILITY CROSSINGS PRIOR TO BEGINNING ANY CONSTRUCTION.

1. ALL CONSTRUCTION SHALL CONFORM TO THE CITY OF SAN ANTONIO STANDARD SPECIFICATIONS FOR CONSTRUCTION JUNE 2008, OR LATEST.

2. NO EXTRA PAYMENT SHALL BE ALLOWED FOR WORK CALLED FOR ON THE PLANS, BUT NOT INCLUDED IN THE BID PROPOSAL. THIS INCIDENTAL WORK WILL BE REQUIRED AND SHALL BE INCLUDED IN THE PAY ITEM TO WHICH IT RELATES.

3. THE CONTRACTOR SHALL PROVIDE ACCESS FOR THE DELIVERY OF MAIL BY THE U.S. POSTAL

4. THE CONTRACTOR SHALL BE RESPONSIBLE FOR RESTORING TO ITS ORIGINAL OR BETTER CONDITION ANY DAMAGE DONE TO EXISTING FENCES, CONCRETE ISLANDS, STREET PAVING, CURBS, SHRUBS, BUSHES OR DRIVEWAYS. (NO SEPARATE PAY ITEM).

5. IT IS THE CONTRACTOR'S RESPONSIBILITY TO SEE THAT ALL SIGNS AND BARRICADES ARE PROPERLY INSTALLED AND MAINTAINED. ALL LOCATIONS AND DISTANCES WILL BE DECIDED UPON IN THE FIELD BY THE CONTRACTOR, USING THE "TEXAS MANUAL ON UNIFORM TRAFFIC CONTROL DEVICES". THE CITY'S CONSTRUCTION INSPECTOR AND TRAFFIC ENGINEERING REPRESENTATIVE WILL ONLY BE RESPONSIBLE TO INSPECT BARRICADES AND SIGNS. IF, IN THE OPINION OF THE TRAFFIC ENGINEERING REPRESENTATIVE AND THE CONSTRUCTION INSPECTOR, THE BARRICADES AND SIGNS DO NOT CONFORM TO ESTABLISHED STANDARDS OR ARE INCORRECTLY PLACED OR ARE INSUFFICIENT IN QUANTITY TO PROTECT THE GENERAL PUBLIC, THE CONSTRUCTION INSPECTOR SHALL HAVE THE OPTION TO STOP OPERATIONS UNTIL SUCH TIME AS THE CONDITIONS ARE CORRECTED.

6. IF THE NEED ARISES, ADDITIONAL BARRICADES AND DIRECTIONAL DEVICES MAY BE ORDERED BY THE TRAFFIC ENGINEERING REPRESENTATIVE AT THE CONTRACTOR'S EXPENSE.

7. DUE TO FEDERAL REGULATIONS TITLE 49, PART 192.171 C.P.S. MUST MAINTAIN ACCESS TO GAS VALVES AT ALL TIMES. THE CONTRACTOR MUST PROTECT AND WORK AROUND ANY GAS VALVES THAT ARE IN THE PROJECT AREA.

8. CONTRACTOR SHALL NOTIFY THE CITY INSPECTOR TWENTY FOUR (24) HOURS PRIOR TO BACKFILL OF ANY UTILITY TRENCHES TO SCHEDULE FOR DENSITY TEST AS REQUIRED.

9. CONTRACTOR SHALL PRESERVE ALL CONSTRUCTION STAKES, MARKS, ETC. IF ANY ARE DESTROYED OR REMOVED BY THE CONTRACTOR OR HIS EMPLOYEES. THEY SHALL BE REPLACED AT THE CONTRACTOR'S EXPENSE.

10. CONTRACTOR SHALL NOTIFY ALL UTILITY COMPANIES PRIOR TO CONSTRUCTION TO DETERMINE THE LOCATION OF EXISTING UTILITIES. CONTRACTOR SHALL NOTIFY THE FOLLOWING AT LEAST FORTY-EIGHT (48) HOURS PRIOR TO EXCAVATION OPERATION:

SAN ANTONIO WATER SYSTEM (SAWS) BEXAR METROPOLITAN WATER DISTRICT (BEXAR MET) 354-6538 / 357-5741 COSA DRAINAGE 207-8048

207-7720 / 207-7765 COSA SIGNAL OPERATIONS TEXAS STATE WIDE ONE CALL LOCATOR 1-800-344-8377 --CITY PUBLIC SERVICE ENERGY TIME WARNER

— AT&T - MCI

11. THE EXISTENCE AND LOCATION OF UNDERGROUND UTILITIES INDICATED ON THE PLANS ARE TAKEN FROM AVAILABLE RECORDS AND ARE NOT GUARANTEED, BUT SHALL BE INVESTIGATED AND VERIFIED BY THE CONTRACTOR BEFORE STARTING WORK. THE CONTRACTOR SHALL BE HELD RESPONSIBLE FOR ANY DAMAGE TO AND FOR THE MAINTENANCE AND PROTECTION OF THE EXISTING UTILITIES EVEN IF THEY ARE NOT SHOWN ON THE PLANS. LOCATION AND DEPTH OF EXISTING UTILITIES SHOWN HERE ARE APPROXIMATE ONLY. ACTUAL LOCATIONS AND DEPTHS MUST BE VERIFIED BY THE CONTRACTOR PRIOR TO CONSTRUCTION AND HE SHALL BE RESPONSIBLE FOR PROTECTION OF SAME DURING CONSTRUCTION.

12. ALL WASTE MATERIAL SHALL BECOME PROPERTY OF THE CONTRACTOR AND SHALL BE HIS SOLE REPONSIBILITY TO DISPOSE OF THIS MATERIAL OFF THE LIMITS OF THE PROJECT. NO WASTE MATE-RIAL SHALL BE PLACED IN EXISTING LOWS THAT WILL BLOCK OR ALTER FLOW LIMITS OF EXISTING ARTIFICIAL OR NATURAL DRAINAGE.

13. THE CONTRACTOR SHALL NOT PLACE ANY WASTE MATERIAL IN THE 100-YEAR FLOOD PLAIN WITHOUT FIRST OBTAINING AN APPROVED FLOOD PLAIN DEVELOPMENT PERMIT.

14. THE CONTRACTOR SHALL MAINTAIN ALL ADJOINING STREETS AND TRAVELED ROUTES FREE FROM SPILLED AND / OR TRACKED CONSTRUCTION MATERIALS AND / OR DEBRIS.

15. IF THE CONTRACTOR ENCOUNTERS ANY ARCHAEOLOGICAL DEPOSITS DURING CONSTRUCTION OPERATIONS, THE CONTRACTOR MUST STOP EXCAVATION IMMEDIATELY, CONTACT THE CITY INSPECTOR, AND CALL THE CITY HISTORIC PRESERVATION OFFICE AT 207-7306 OR 207-3327 FOR AN ARCHAEOLOGICAL INVESTIGATION. THE CONTRACTOR CANNOT BEGIN EXCAVATION AGAIN WITHOUT

WRITTEN PERMISSION FROM THE CITY. IF MORE THAN THREE (3) DAYS ARE REQUIRED FOR INVESTIGATION (NOT INCLUDING HOLIDAY AND WEEKENDS) AND IF THE CONTRACTOR IS UNABLE TO WORK IN OTHER AREAS, THEN THE CONTRACTOR WILL BE ALLOWED TO NEGOTIATE FOR ADDITIONAL CONSTRUCTION TIME UPON WRITTEN REQUEST WITHIN TEN (10) DAYS AFTER THE FIRST NOTICE TO THE CITY OF ARCHAEOLOGICAL INVESTIGATION FOR EACH EVENT. IF THE TIME REQUIRED FOR INVESTIGATION IS LESS THAN OR EQUAL TO THREE (3) DAYS FOR EACH EVENT, CONTRACT DURATION WILL NOT BE EXTENDED.

16. IF SUSPECTED CONTAMINATION IS ENCOUNTERED DURING CONSTRUCTION OPERATIONS, C.O.S.A. SHALL BE NOTIFIED IMMEDIATELY WHEN CONTAMINATED SOILS AND / OR GROUNDWATER ARE ENCOUNTERED AT LOCATIONS NOT IDENTIFIED IN THE PLANS. THE NOTIFICATION SHOULD INCLUDE THE STATION NUMBER, TYPE OF CONTAMINATED MEDIA, EVIDENCE OF CONTAMINATION AND MEASURES TAKEN TO CONTAIN THE CONTAMINATED MEDIA AND PREVENT PUBLIC ACCESS. THE CONTAMINATED SOIL AND / OR GROUNDWATER SHALL NOT BE REMOVED FROM THE LOCATION WITHOUT PRIOR C.O.S.A. APPROVAL. THE CONTRACTOR MUST STOP THE EXCAVATION IMMEDIATELY AND CONTACT THE C.O.S.A. INSPECTOR. THE CONTRACTOR CANNOT BEGIN EXCAVATION ACTIVITIES WITHOUT WRITTEN PERMISSION FROM THE CITY.

17. CONTRACTOR IS TO INCLUDE A MAILBOX POST BLOCKOUT FOR VACANT LOTS AND ALL RESIDENCES WHICH DO NOT HAVE MAILBOXES AT THE CURB. BLOCKOUTS ARE PROVIDED FOR FUTURE USE BY THE POST OFFICE.

18. CONTRACTOR SHALL NOT REMOVE OR ADJUST ANY VIA FACILITIES. THE CONTRACTOR MUST CONTACT VIA FOURTEEN DAYS PRIOR, FOR THE REMOVAL OF BENCHES, STOP POLES OR ANY OTHER VIA FACILITIES THAT MAY BE PRESENT. PLEASE PROVIDE THIRTY DAYS PRIOR NOTICE FOR SHELTER REMOVAL (TELEPHONE NOS: (210) 362-2155 OR (210) 362-2096). THE CONTRACTOR WILL BE LIABLE FOR ANY DAMAGES TO VIA FACILITIES NOT REMOVED BY VIA. THE CONTRACTOR IS REQUIRED TO REPLACE ALL FLATWORK REMOVED OR DAMAGED IN THE COURSE OF EXECUTING THE CONTRACT UNLESS OTHERWISE NOTED BY VIA. THE CONTRACTOR WILL BE RESPONSIBLE FOR PROTECTING VIA FACILITIES IF ADJACENT TO WORK AREA.

### **ACCESSIBILITY REQUIREMENTS**

1. THE CONTRACTOR SHALL PROVIDE AND MAINTAIN VEHICULAR AND PEDESTRIAN ACCESS AT ALL TIMES TO LOCAL RESIDENCES AND BUSINESSES.

WHEN THE WORK REQUIRES THE EXCAVATION OF THE STREET AND THE REMOVAL OF THE EXISTING DRIVEWAY APPROACHES AND SIDEWALKS, THE CONTRACTOR SHALL BE RESPONSIBLE FOR PROVIDING TEMPORARY ALL-WEATHER ACCESS TO THE BUSINESSES AND RESIDENCES. THE TEMPORARY DRIVEWAY APPROACHES SHALL BE CONSTRUCTED WITH FLEXIBLE BASE OR GRAVEL MATERIAL AT NO SEPARATE COST TO THE CITY.


3. PRIOR TO INITIATING THE CONSTRUCTION OF NEW DRIVEWAY APPROACHES, THE CONTRACTOR SHALL GIVE ADVANCE WARNING IN PERSON, OR IN WRITING, OF AT LEAST 48 HOURS TO EACH RESIDENCE THAT WILL BE IMMEDIATELY AFFECTED, SO THAT ALTERNATE PLANS MAY BE MADE BY THE RESIDENTS.

4. FOR BUSINESSES WITH MORE THAN ONE DRIVEWAY, AT LEAST ONE DRIVEWAY SHALL REMAIN OPEN WHILE THE OTHER NEW DRIVEWAY APPROACHES ARE CONSTRUCTED. FOR BUSINESSES WITH ONLY ONE DRIVEWAY, THE NEW DRIVEWAY APPROACH SHALL BE CONSTRUCTED IN HALF WIDTHS, UNLESS A TEMPORARY ASPHALT DRIVEWAY IS FIRST INSTALLED AT NO SEPARATE COST TO THE CITY.

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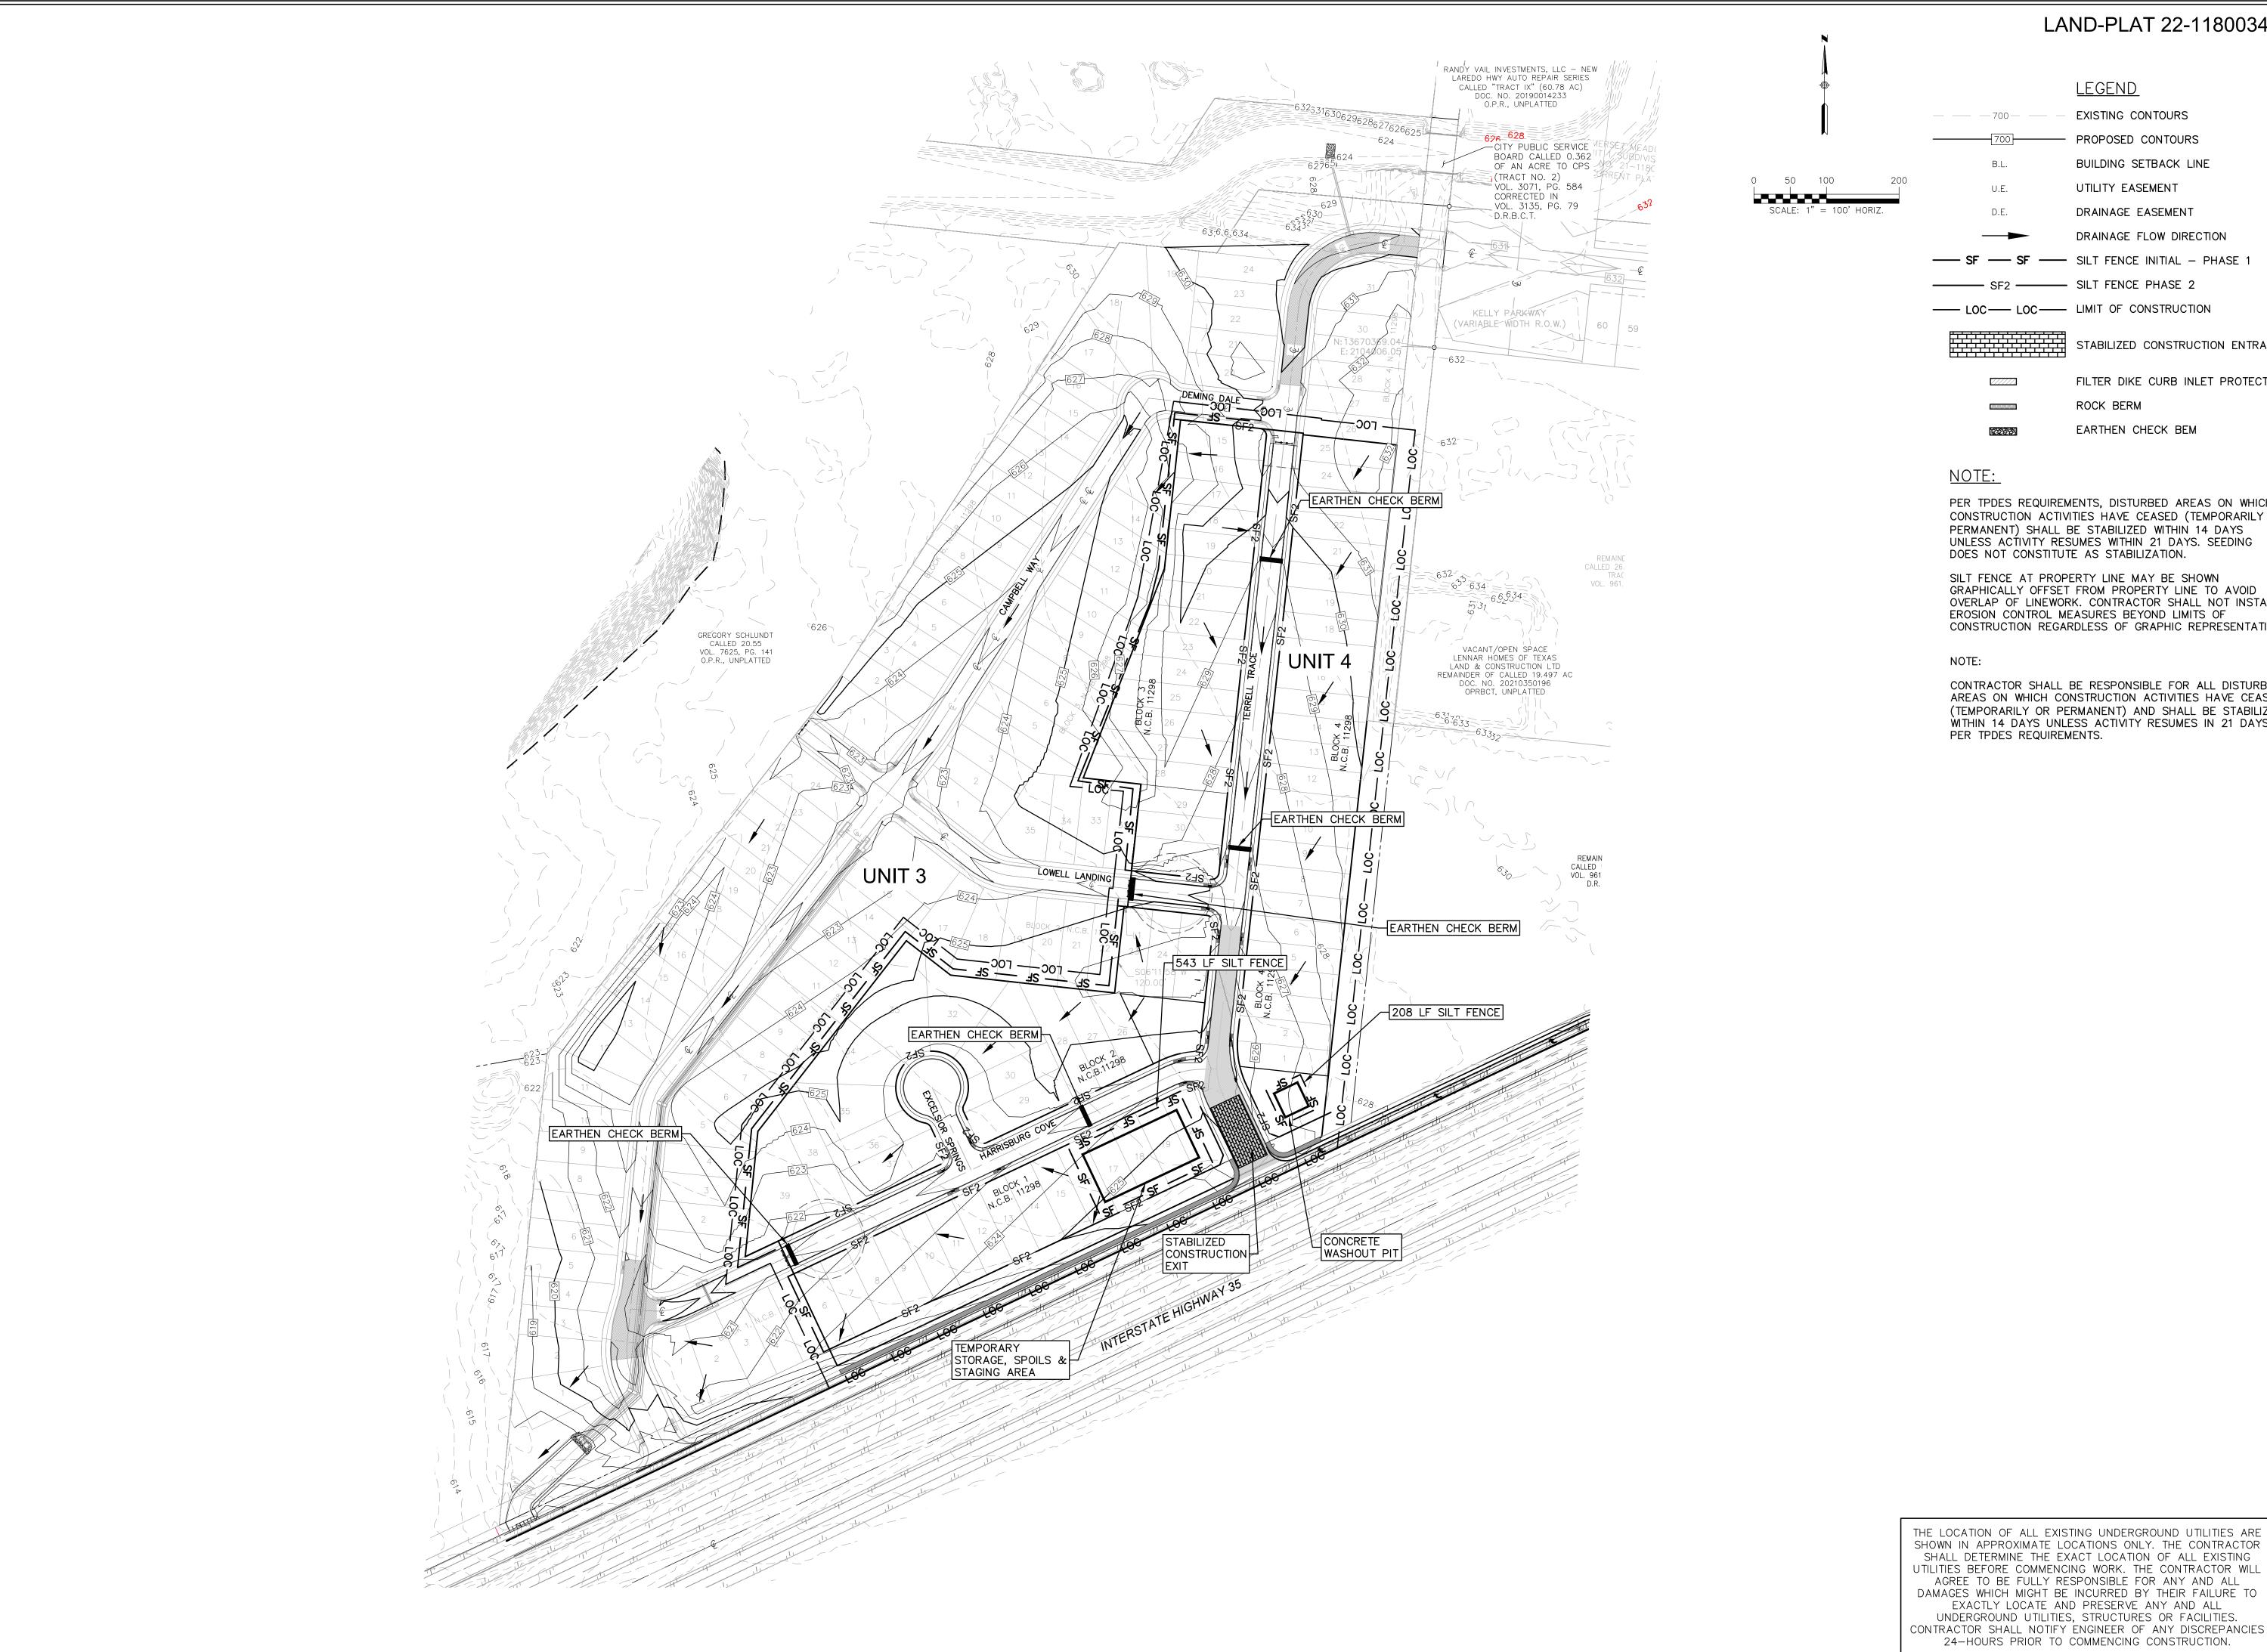
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DATE: MARCH 2024

DRAWN BY:

DESIGNED BY: MTA REVIEWED BY: FSP

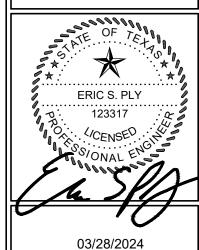HMT PROJECT NO.: 337.060



<u>LEGEND</u> - - - 700- - EXISTING CONTOURS

—— PROPOSED CONTOURS BUILDING SETBACK LINE UTILITY EASEMENT

DRAINAGE FLOW DIRECTION 

- SF2 - SILT FENCE PHASE 2 — LOC — LOC — LIMIT OF CONSTRUCTION

STABILIZED CONSTRUCTION ENTRANCE

FILTER DIKE CURB INLET PROTECTION ROCK BERM

EARTHEN CHECK BEM

PER TPDES REQUIREMENTS, DISTURBED AREAS ON WHICH CONSTRUCTION ACTIVITIES HAVE CEASED (TEMPORARILY OR PERMANENT) SHALL BE STABILIZED WITHIN 14 DAYS UNLESS ACTIVITY RESUMES WITHIN 21 DAYS. SEEDING DOES NOT CONSTITUTE AS STABILIZATION.

GRAPHICALLY OFFSET FROM PROPERTY LINE TO AVOID OVERLAP OF LINEWORK. CONTRACTOR SHALL NOT INSTALL EROSION CONTROL MEASURES BEYOND LIMITS OF CONSTRUCTION REGARDLESS OF GRAPHIC REPRESENTATION.

CONTRACTOR SHALL BE RESPONSIBLE FOR ALL DISTURBED AREAS ON WHICH CONSTRUCTION ACTIVITIES HAVE CEASED (TEMPORARILY OR PERMANENT) AND SHALL BE STABILIZED WITHIN 14 DAYS UNLESS ACTIVITY RESUMES IN 21 DAYS, PER TPDES REQUIREMENTS.

ERIC S. PLY 123317

03/28/2024

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MARCH 2024 DRAWN BY:

DESIGNED BY: MTA

REVIEWED BY: ESP

HMT PROJECT NO .: 337.060

#### CONCRETE WASHOUT AREAS

THE PURPOSE OF CONCRETE WASHOUT AREAS IS TO PREVENT OR REDUCE THE DISCHARGE OF POLLUTANTS TO STORMWATER FROM CONCRETE WASTE BY CONDUCTING WASHOUT OFFSITE, PERFORMING ONSITE WASHOUT IN A DESIGNATED AREA, AND TRAINING EMPLOYEES AND SUBCONTRACTORS.

THE FOLLOWING STEPS WILL HELP REDUCE STORMWATER POLLUTION FROM CONCRETE WASTES:

- INCORPORATE REQUIREMENTS FOR CONCRETE WASTE MANAGEMENT INTO MATERIAL
- SUPPLIER AND SUBCONTRACTOR AGREEMENTS.


   AVOID MIXING EXCESS AMOUNTS OF FRESH CONCRETE.
- PERFORM WASHOUT OF CONCRETE TRUCKS IN DESIGNATED AREAS ONLY.
   DO NOT WASH OUT CONCRETE TRUCKS INTO STORM DRAINS, OPEN DITCHES, STREETS. OR STREAMS.
- DO NOT ALLOW EXCESS CONCRETE TO BE DUMPED ONSITE, EXCEPT IN DESIGNATED AREAS.

#### FOR ONSITE WASHOUT:

- LOCATE WASHOUT AREA AT LEAST 50 FEET FROM SENSITIVE FEATURES, STORM DRAINS, OPEN DITCHES, OR WATER BODIES. DO NOT ALLOW RUNOFF FROM THIS AREA BY CONSTRUCTING A TEMPORARY PIT OR BERMED AREA LARGE ENOUGH FOR LIQUID AND SOLID WASTE.
- WASH OUT WASTES INTO THE TEMPORARY PIT WHERE THE CONCRETE CAN SET,
   BE BROKEN UP, AND THEN DISPOSED PROPERLY.

BELOW GRADE CONCRETE WASHOUT FACILITIES ARE TYPICAL. THESE CONSIST OF A LINED EXCAVATION SUFFICIENTLY LARGE TO HOLD EXPECTED VOLUME OF WASHOUT MATERIAL. ABOVE GRADE FACILITIES ARE USED IF EXCAVATION IS NOT PRACTICAL. TEMPORARY CONCRETE WASHOUT FACILITY (TYPE ABOVE GRADE) SHOULD BE CONSTRUCTED AS SHOWN ON THE DETAILS AT THE END OF THIS SECTION, WITH SUFFICIENT QUANTITY AND VOLUME TO CONTAIN ALL LIQUID AND CONCRETE WASTE GENERATED BY WASHOUT OPERATIONS. PLASTIC LINING MATERIAL SHOULD BE A MINIMUM OF 10 MIL IN POLYETHYLENE SHEETING AND SHOULD BE FREE OF HOLES, TEARS, OR OTHER DEFECTS THAT COMPROMISE THE IMPERMEABILITY OF THE MATERIAL.


WHEN TEMPORARY CONCRETE WASHOUT FACILITIES ARE NO LONGER REQUIRED FOR THE WORK, THE HARDENED CONCRETE SHOULD BE REMOVED AND DISPOSED OF. MATERIALS USED TO CONSTRUCT TEMPORARY CONCRETE WASHOUT FACILITIES SHOULD BE REMOVED FROM THE SITE OF THE WORK AND DISPOSED OF HOLES, DEPRESSIONS OR OTHER GROUND DISTURBANCE CAUSED BY THE REMOVAL OF THE TEMPORARY CONCRETE WASHOUT FACILITIES SHOULD BE BACKFILLED AND REPAIRED.

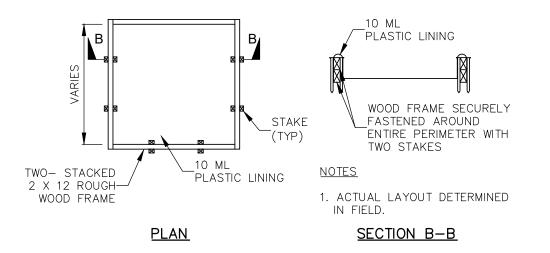


CONCRETE WASHOUT PIT DETAIL

TYPE "ABOVE GRADE"

NOT TO SCALE

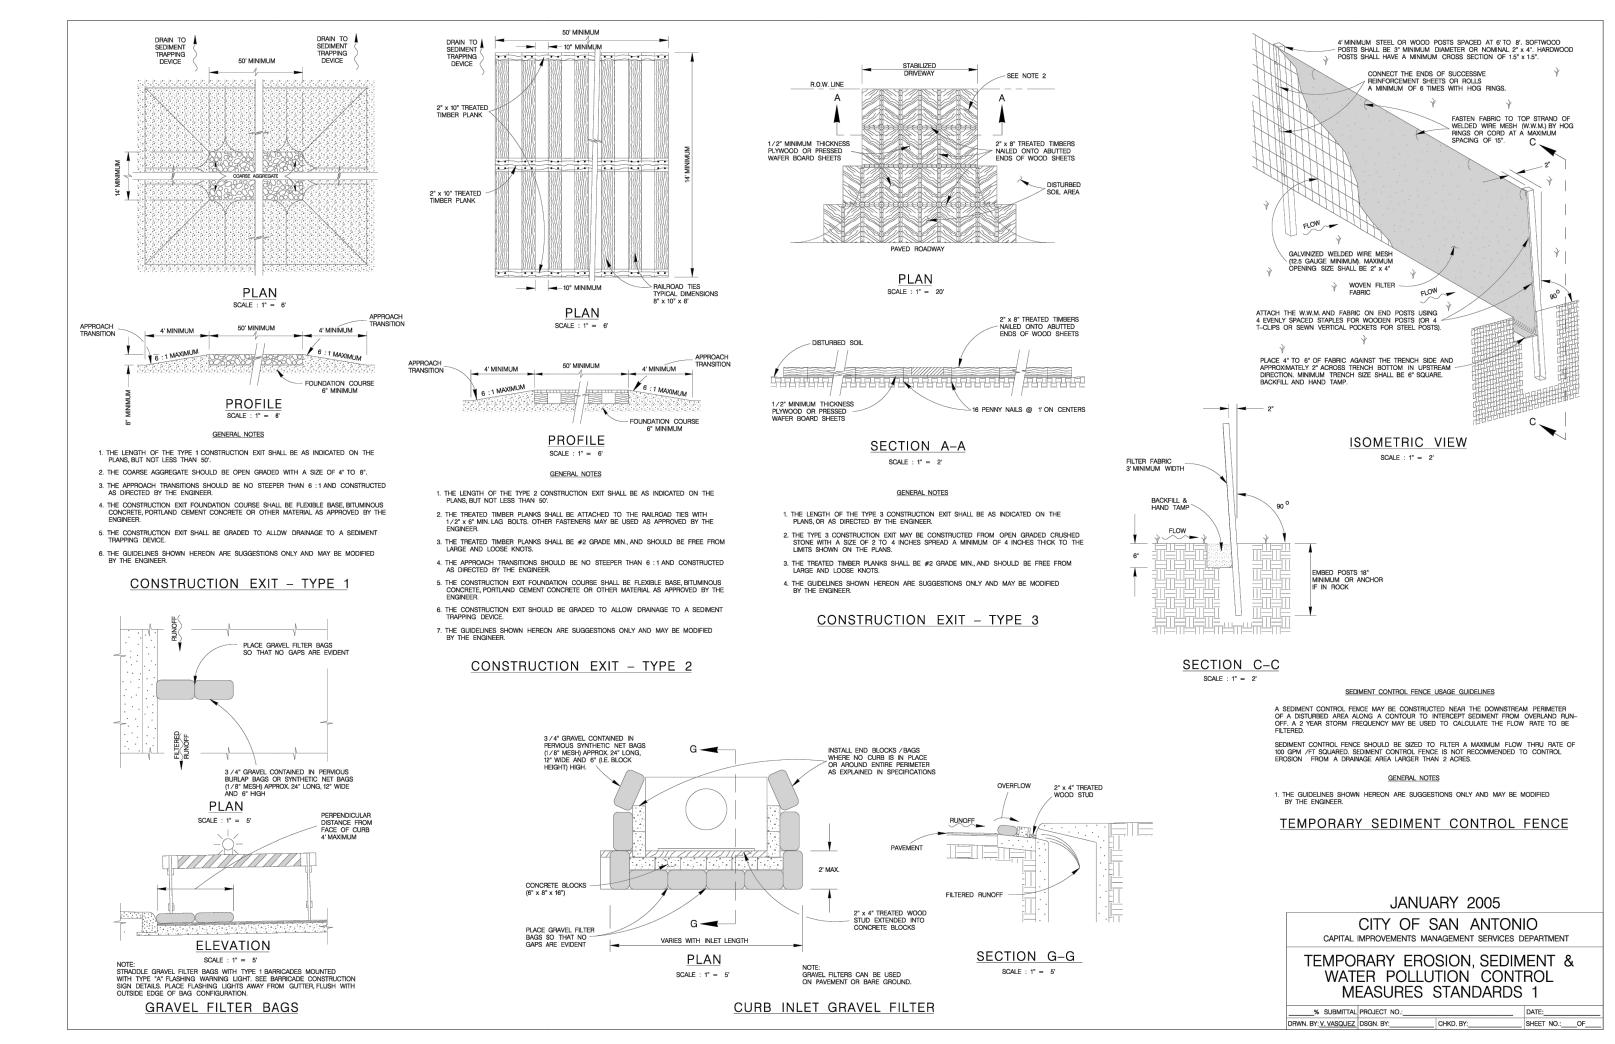

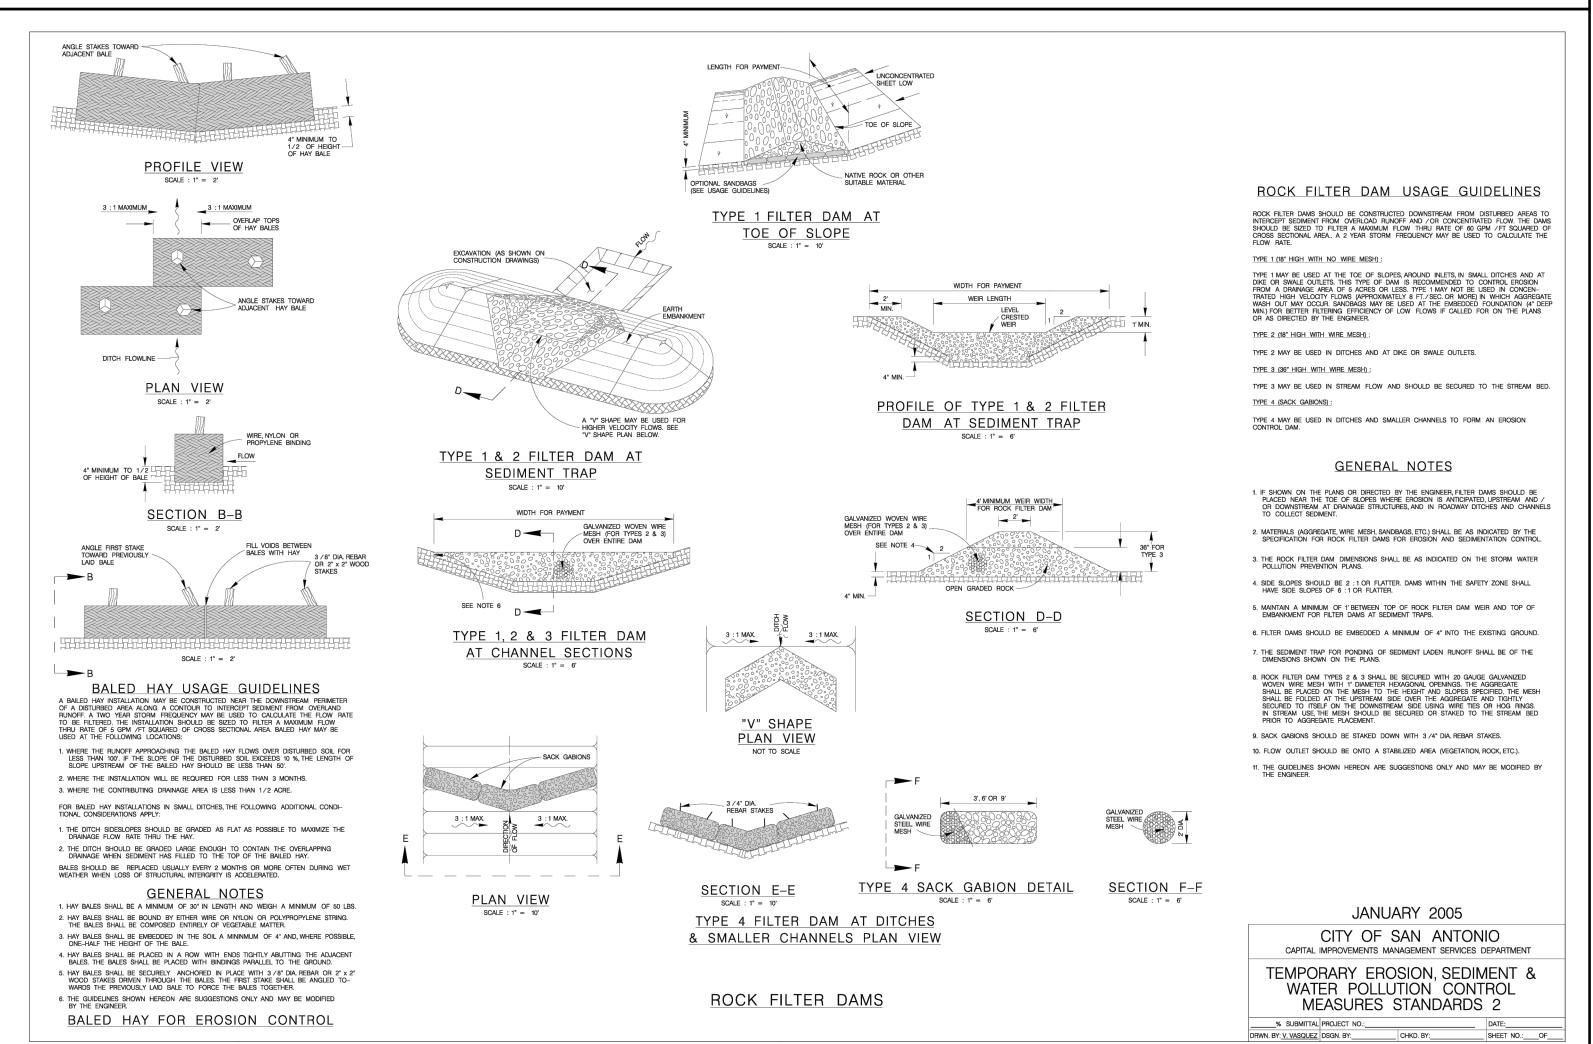

### LAND-PLAT 22-11800345

PROPOSED CONTOURS

B.L. BUILDING SETBACK LINE

U.E. UTILITY EASEMENT

DRAINAGE EASEMENT

DRAINAGE FLOW DIRECTION

SF — SF — SILT FENCE

LOC — LOC — LIMIT OF CONSTRUCTION

STABILIZED CONSTRUCTION

ENTRANCE

FILTER DIKE CURB INLET

PROTECTION

ROCK BERM

#### SEQUENCE OF CONSTRUCTION

- 1. INSTALL EROSION CONTROLS PER APPROVED PLAN.
- 2. TEMPORARY CONTROLS TO BE INSPECTED AND MAINTAINED WEEKLY AND PRIOR TO ANTICIPATED RAINFALL EVENTS, AND AFTER RAINFALL EVENTS, AS NEEDED. CONTRACTOR/OWNER SHALL PROVIDE A CONTACT NAME AND NUMBER FOR EROSION CONTROL ISSUES.
- 3. CONDUCT DEMOLITION ACTIVITIES, IF APPLICABLE.
- 4. CONSTRUCT DRAINAGE IMPROVEMENTS, IF APPLICABLE.
- 5. CONSTRUCT CURB INLET PROTECTION AT THE TIME OF CURB INLET INSTALLATION.
- 6. CONSTRUCT DEVELOPMENT PER APPROVED PLANS.
- 7. INSTALL STREETSCAPE AND/OR LANDSCAPING IMPROVEMENTS.
- 8. CONTRACTOR TO VEGETATE ANY DISTURBED AREAS ONCE FINAL GRADING IS COMPLETE, AND ESTABLISH A MIN OF 70% VEGETATION PRIOR TO COMPLETION. PER TPDES REQUIREMENTS, DISTURBED AREAS ON WHICH CONSTRUCTION ACTIVITIES HAVE CEASED (TEMPORARILY OR PERMANENTLY) SHALL BE STABILIZED WITHIN 14 DAYS UNLESS ACTIVITY RESUMES WITHIN 21 DAYS. SEEDING DOES NOT CONSTITUTE AS STABILIZATION.
- 9. REMOVE ALL TEMPORARY EROSION CONTROL MEASURES.

#### JOTF:

CONTRACTOR SHALL BE RESPONSIBLE FOR ALL DISTURBED AREAS ON WHICH CONSTRUCTION ACTIVITIES HAVE CEASED (TEMPORARILY OR PERMANENT) AND SHALL BE STABILIZED WITHIN 14 DAYS UNLESS ACTIVITY RESUMES IN 21 DAYS, PER TPDES REQUIREMENTS.

THE LOCATION OF ALL EXISTING UNDERGROUND UTILITIES ARE

SHOWN IN APPROXIMATE LOCATIONS ONLY. THE CONTRACTOR

SHALL DETERMINE THE EXACT LOCATION OF ALL EXISTING

JTILITIES BEFORE COMMENCING WORK. THE CONTRACTOR WILL

AGREE TO BE FULLY RESPONSIBLE FOR ANY AND ALL


DAMAGES WHICH MIGHT BE INCURRED BY THEIR FAILURE TO

EXACTLY LOCATE AND PRESERVE ANY AND ALL

UNDERGROUND UTILITIES, STRUCTURES OR FACILITIES.
CONTRACTOR SHALL NOTIFY ENGINEER OF ANY DISCREPANCIES
24—HOURS PRIOR TO COMMENCING CONSTRUCTION.

NEW BRAUNFELS, TX TBPE FIRM F-10961 TBPLS FIRM 1053600

EN GINEERING & SURVEY

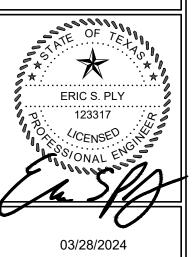

ROL E, UNIT 4

EROSION CONTROL
DETAILS
OMERSET GROVE, UN
SAN ANTONIO, TEXAS

NO. REVISION DESCRIPTION REVISION DATE

DATE: MARCH 2024


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03/28/2024

WHEN POSSIBLE, CONTRACTOR SHALL PHASE GRADING SO AS TO EXPOSE THE MINIMUM AMOUNT OF AREA TO SOIL EROSION FOR THE SHORTEST PERIOD OF TIME.

SCALE: 1" = 60"

<u>LEGEND</u>

EXISTING CONTOURS ---- PROPOSED CONTOURS

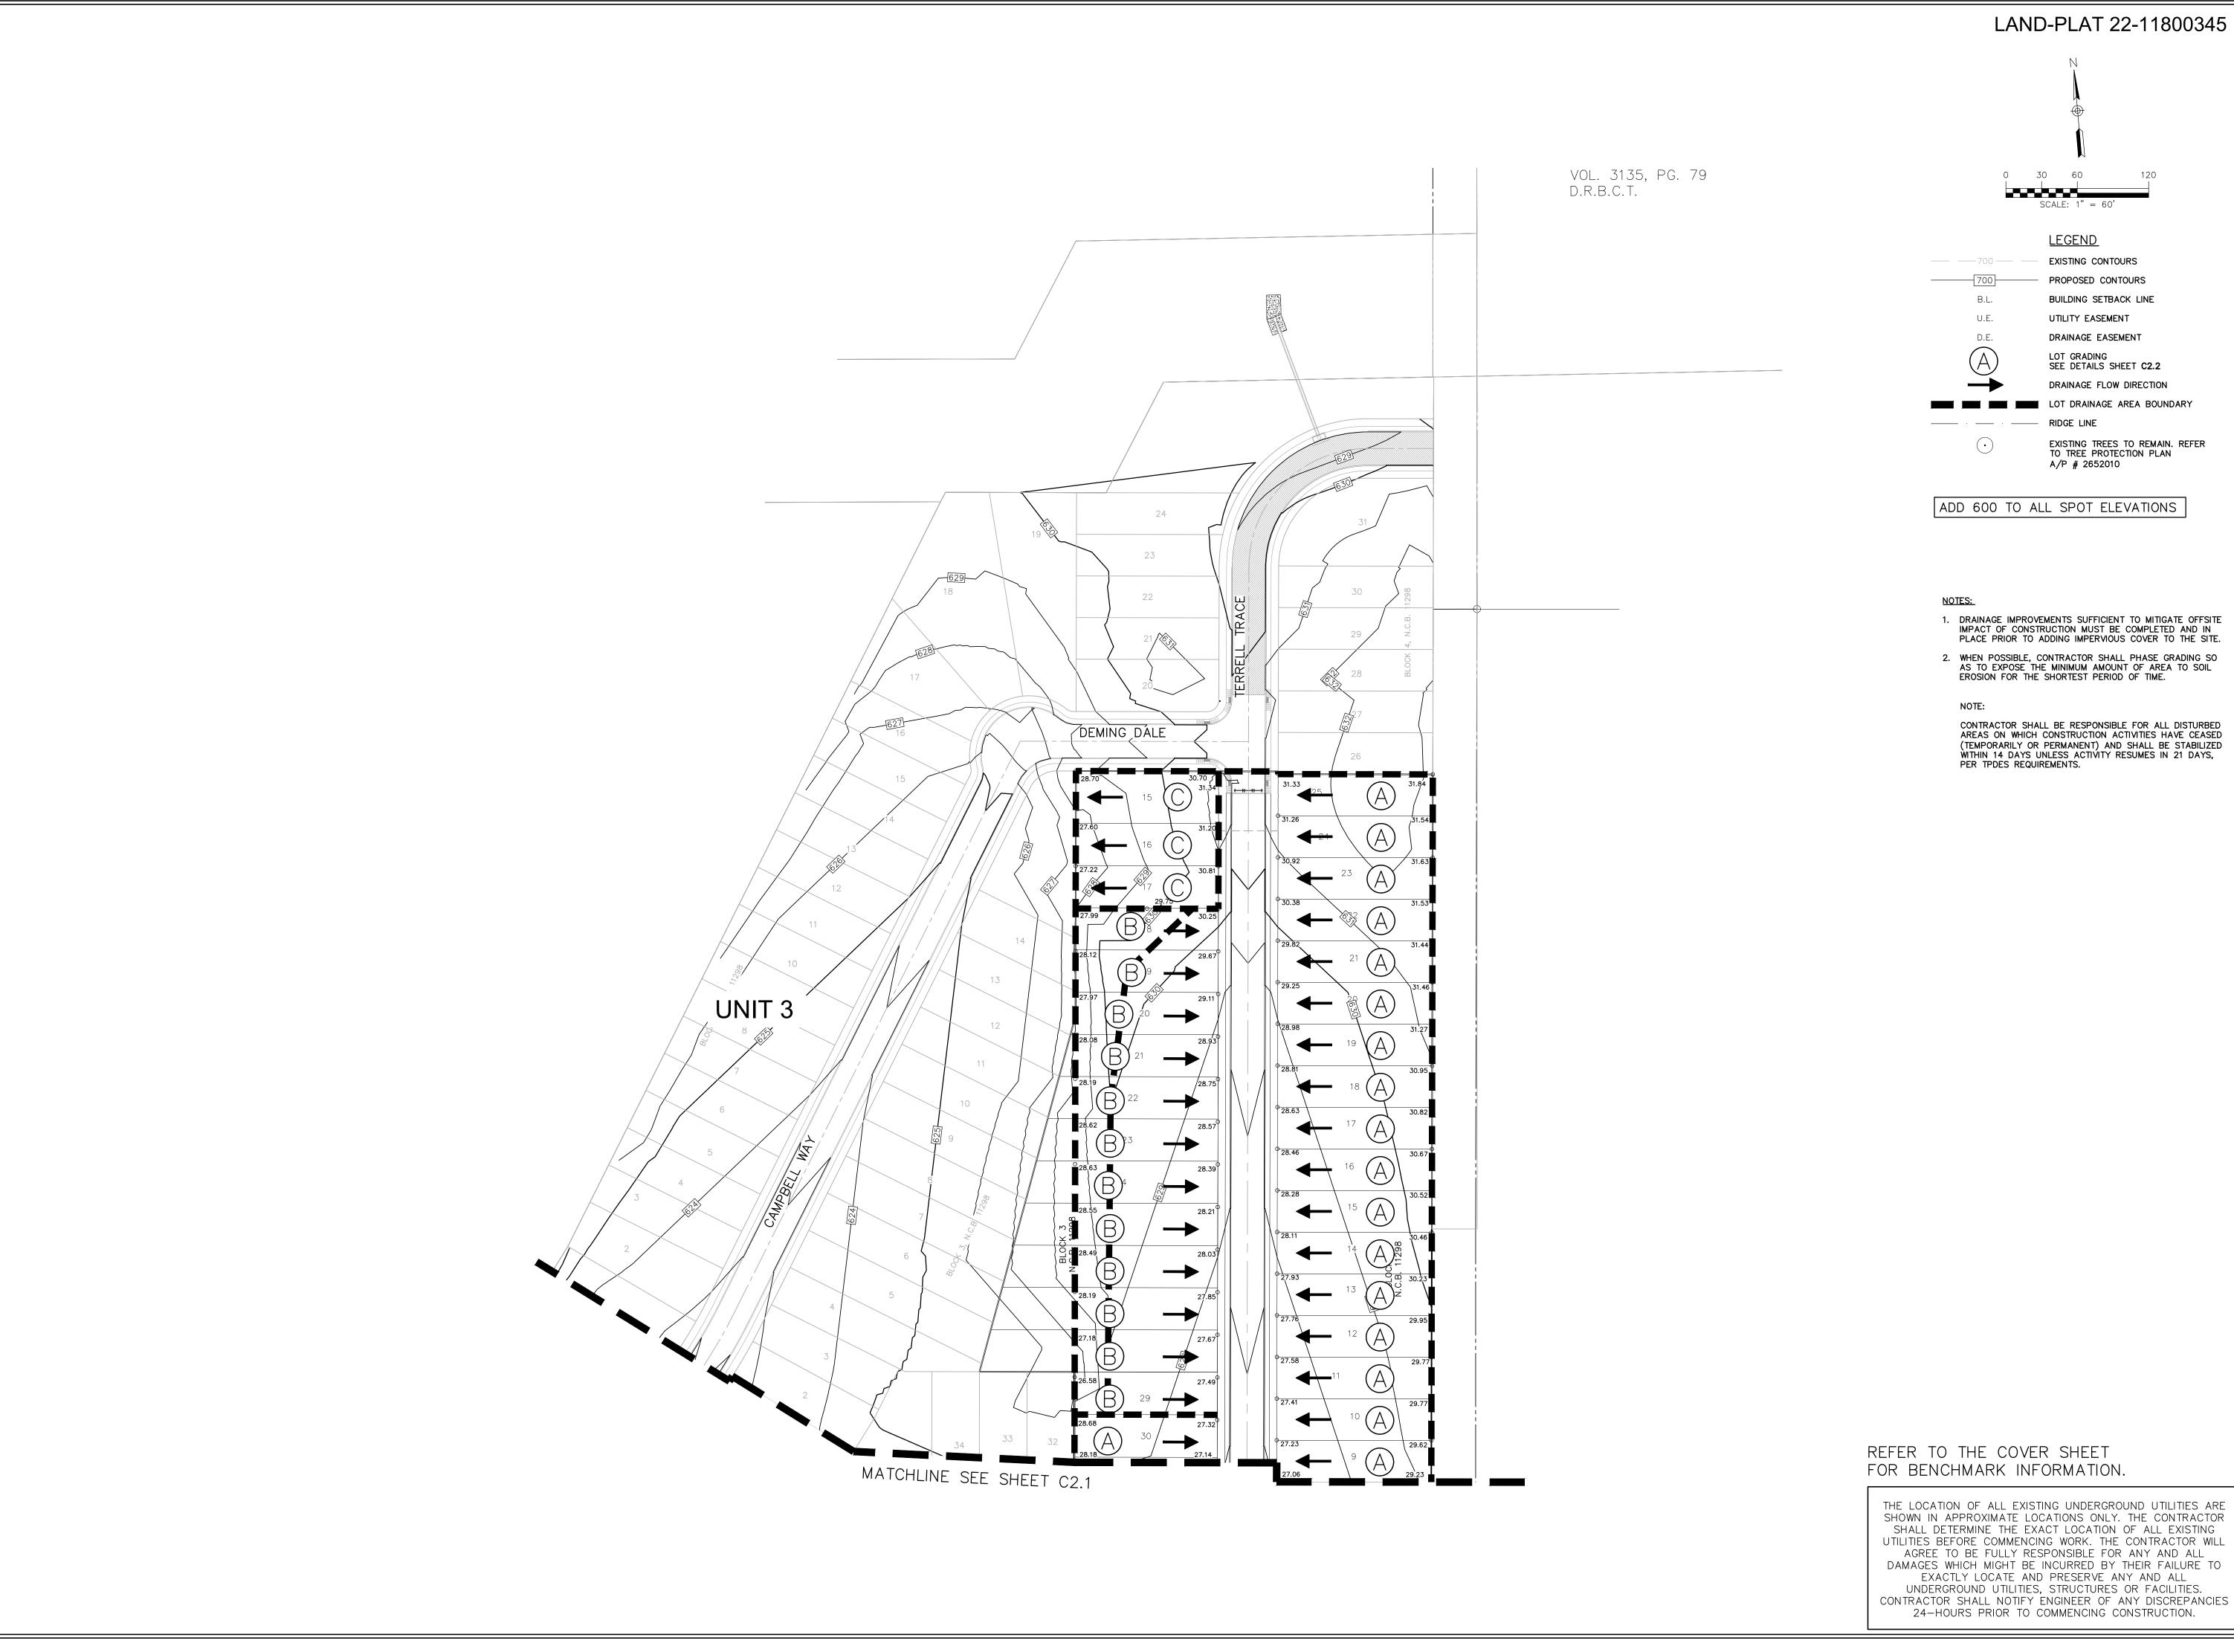UTILITY EASEMENT

DRAINAGE EASEMENT

SEE DETAILS SHEET C2.2 DRAINAGE FLOW DIRECTION

LOT DRAINAGE AREA BOUNDARY

A/P # 2652010

EXISTING TREES TO REMAIN. REFER TO TREE PROTECTION PLAN

---- RIDGE LINE

BUILDING SETBACK LINE

CONTRACTOR SHALL BE RESPONSIBLE FOR ALL DISTURBED AREAS ON WHICH CONSTRUCTION ACTIVITIES HAVE CEASED (TEMPORARILY OR PERMANENT) AND SHALL BE STABILIZED WITHIN 14 DAYS UNLESS ACTIVITY RESUMES IN 21 DAYS, PER TPDES REQUIREMENTS.

**OF** 

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TONIO, GRADING

MARCH 2024 DRAWN BY:


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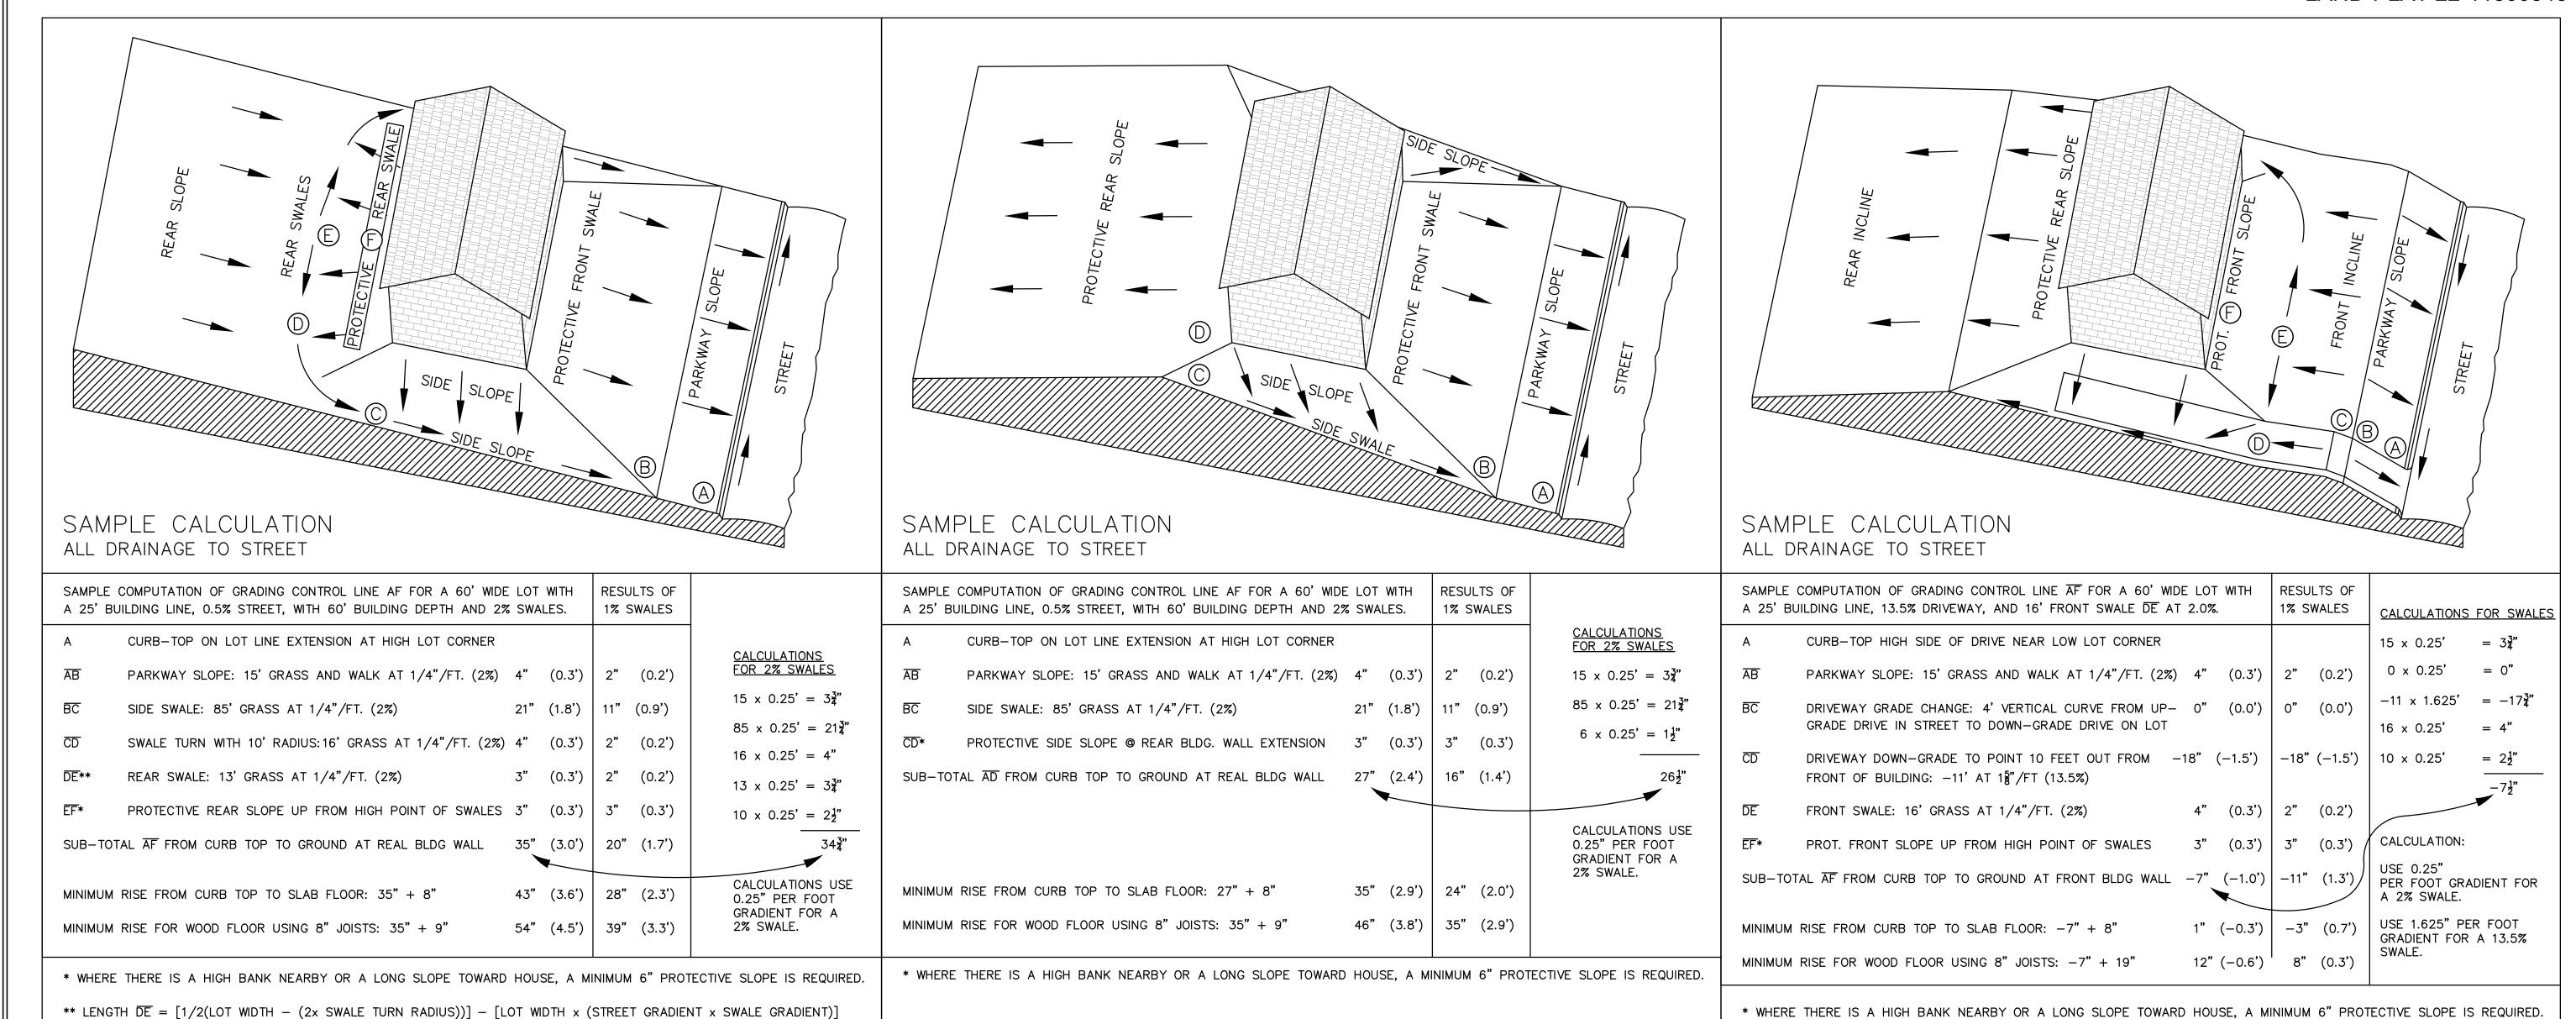
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MARCH 2024

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HMT PROJECT NO .:

337.060



LOT TYPE (A)

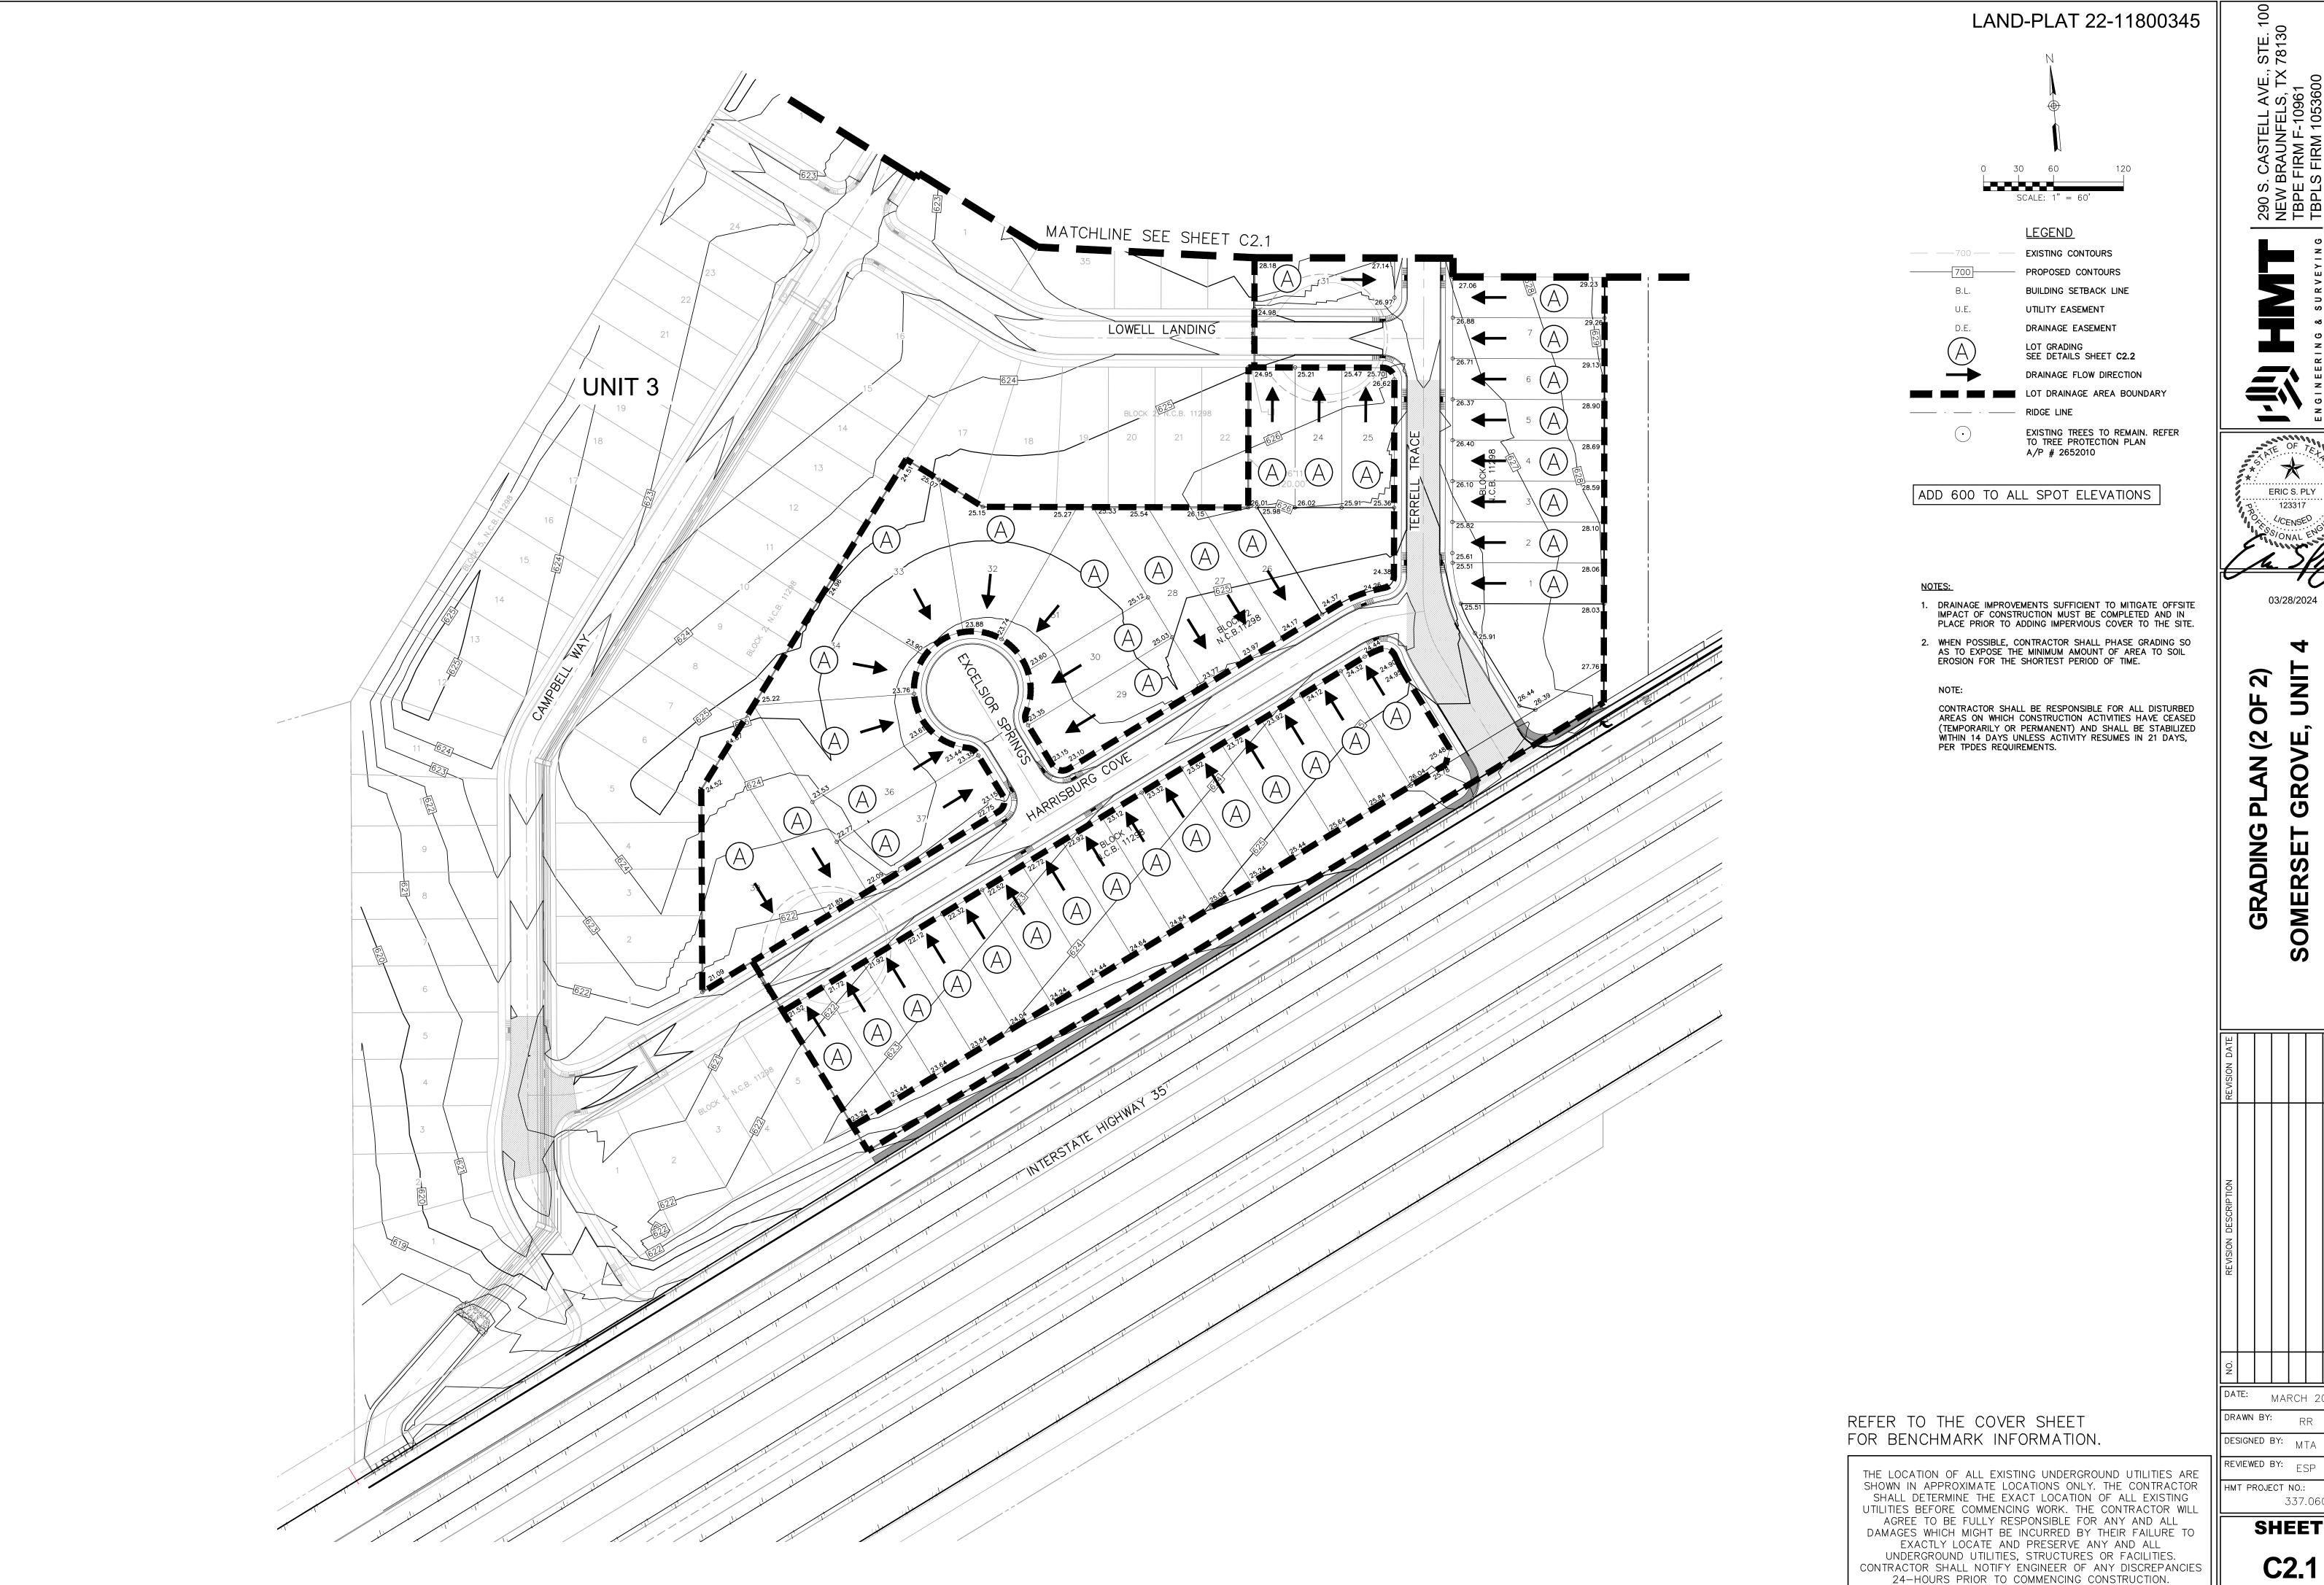LOT TYPE ®

LOT TYPE ©

#### GENERAL SPECIFICATIONS FOR SITE PREPARATION

GENERAL DESCRIPTION THIS ITEM SHALL CONSIST OF ALL CLEARING AND PREPARATION OF LAND TO BE FILLED, FILLING OF THE LAND, SPREADING, COMPACTION TESTING AND INSPECTION OF THE FILL, AND ALL SUBSIDIARY WORK NECESSARY TO COMPLETE THE GRADING OF THE CUT AND FILL AREAS TO CONFORM WITH THE LINES, GRADES AND SLOPES AS SHOWN ON THE APPROVED PLANS.

SCARIFYING THE AREA TO BE FILLED ALL ORGANIC MATTER SHALL BE REMOVED FROM THE SURFACE UPON WHICH THE FILL IS TO BE PLACED, AND SURFACE SHALL BE DISKED OR SCARIFIED TO A MINIMUM DEPTH OF SIX INCHES (6"), ALL SURFACE RUTS OR OTHER UNEVEN FEATURES WILL BE LEVELED PRIOR TO FIELD DENSITY TESTING.

FOLLOWING THE CLEARING AND DISKING OR SCARIFYING OF THE FILL AREA, IT SHALL BE BLADED UNTIL IT IS UNIFORM AND FREE FROM LARGE CLODS. THE AREA SHALL BE BROUGHT TO ADEQUATE MOISTURE CONTENT AND COMPACTED (TYPICALLY) TO NOT LESS THAN NINETY PERCENT (90%) OF MAXIMUM DENSITY IN ACCORDANCE WITH THE CURRENT ASTM D 1557 COMPACTION PROCEDURE, OR 95% OF MAXIMUM DENSITY IN ACCORDANCE WITH THE THD-TEX-113-E COMPACTION PROCEDURE. ALL AREAS EXCEEDING (6") SIX INCHES IN DEPTH, MUST MEET WITH FHA/HUD HANDBOOK 4140.30 SPECIFICATIONS FOR LAND DEVELOPMENTS ON

THE MATERIALS USED SHALL BE FREE FROM ORGANIC MATTER AND OTHER DELETERIOUS SUBSTANCES, SUCH AS TREES, BRUSH AND RUBBISH.

#### DEPTH AND MIXING OF FILL LAYERS

CONTROLLED EARTHWORK, DATASHEET 79G.

THE SELECTED FILL MATERIAL SHALL BE PLACED IN LEVEL, UNIFORM LAYERS WHICH, WHEN COMPACTED, SHALL HAVE A DENSITY CONFORMING TO THE STIPULATED ABOVE. EACH LAYER SHALL BE THOROUGHLY MIXED DURING THE SPREADING TO ENSURE UNIFORMITY OF MATERIAL IN EACH LAYER. COMPACTED LAYER THICKNESS MAY VARY DEPENDING ON THE COMAPCTION EQUIPMENT OF THE DEMONSTRATED CAPABILITY.

WHEN FILL MATERIAL INCLUDES ROCK, THE MAXIMUM ROCK SIZE SHALL BE AS APPROVED BY THE GEOTECHNICAL ENGINEER. NO LARGE ROCKS SHALL BE ALLOWED TO NEST AND ALL VOIDS MUST BE FILLED WITH SMALL STONES OR SOIL AND ADEQUATELY COMPACTED.

COMPACTION OF FILL LAYER COMPACTION EQUIPMENT SHALL BE CAPABLE OF COMPACTING THE FILL TO THE SPECIFIED DENSITY. COMPACTION SHALL BE ACCOMPLISHED WHILE THE FILL MATERIAL IS AT OR NEAR THE APPROPRIATE MOISTURE CONTENT. COMPACTION OF EACH LAYER SHALL BE CONTINUOUS OVER THE ENTIRE STRUCTURAL AREA (BENEATH PROPOSED STRUCTURES).

THE FACES OF FILL SLOPES SHALL BE COMPACTED. COMPACTING OPERATIONS SHALL BE CONTINUED UNTIL THE SLOPE FACES ARE STABLE BUT NOT TO DENSE FOR PLANTING ON THE SLOPES. COMPACTION OF THE SLOPE FACE MAY BE DONE PROGRESSIVELY IN INCREMENTS OF THREE TO FIVE FEET (3' TO 5') IN FILL HEIGHT AS THIS FILL PROGRESSES OR AFTER THE FILL HAS BEEN BROUGHT TO ITS TOTAL HEIGHT

FIELD DENSITY TESTS SHALL BE PERFORMED ON ALL LAYERS OF FILL WHEN THE FILL IS BEING PLACED AS DIRECTED BY THE GEOTECHNICAL ENGINEER. THE MAXIMUM FILL HEIGHT BETWEEN DENSITY TESTING SHALL BE TWELVE INCHES (12"). ALL TESTING SHALL BE REQUESTED BY THE CONTRACTOR TO MEET THE CONTRACTOR'S CONSTRUCTION SCHEDULE. NOTIFICATION BY THE CONTRACTOR TO CONDUCT TESTS SHALL BE AT LEAST THE DAY BEFORE. THIS NOTIFICATION SHALL INCLUDE THE FILL AREA LOCATION (LOT AND BLOCK), THE LIFT OR HEIGHT OF FILL AND APPROXIMATED DESIRED TIME OF TESTING. WHEN THESE TEST INDICATE THAT THE DENSITY OF ANY LAYER OF FILL OR PORTION THEREOF IS BELOW THE REQUIRED DENSITY, THE PARTICULAR LAYER OR PORTION SHALL BE REWORKED AND RETESTED AT THE EXPENSE OF THE CONTRACTOR UNLESS THE CONTRACTOR CAN SHOW EVIDENCE THAT CIRCUMSTANCES BEYOND HIS CONTROL REQUIRED THE RETESTING. GENERALLY, THE SPECIFIC TESTING WILL BE AS FOLLOWS AND CONDUCTED BY A GEO-TECHNICAL

1. THE LAND TO BE FILLED (PREPARED SUBGRADE) SHALL BE PREPARED AND TESTED AT A FREQUENCY AS DETERMINED BY THE GEOTECHNICAL ENGINEER. 2. THE FIRST LIFT OF COMPACTED FILL (GENERALLY 8-12 IN.) SHALL BE TESTED AS DETERMINED BY THE GEOTECHNICAL ENGINEER. ANY AREAS SUPPORTING THE PROPOSED STRUCTURES REQUIRING FILL SHALL BE TESTED FOR DENSITY COMPLIANCE.


3. FILLS SHALL BE TESTED AT A MAXIMUM OF EACH TWELVE INCHES (12") OF FILL. 4. TEST RESULTS WILL BE PROVIDED BY THE FIELD TECHNICIAN TO THE CONTRACTOR WHEN POSSIBLE: HOWEVER, ALL TEST RESULTS ARE TO BE REVIEWED BY THE GEOTECHNICAL ENGINEER FOR COMPLIANCE. THE ENGINEER WILL NOTIFY THE CONTRACTOR OF ALL TEST RESULTS.

CUT/FILL LOTS AREÁS INVOLVING CUT ON THE PORTION AND FILL ON ANOTHER PORTION OF A SPECIFIC LOT SHALL BE PREPARED TO A MINIMUM DEPTH OF 6 IN., AND WILL BE THE SAME MATERIAL CLASSIFICATION AT THE SAME COMPACTION AND MOISTURE CONTENT. FIELD DENSITY TESTS SHALL BE REQUIRED ON EACH CUT/FILL LOT FOR THE PURPOSE OF DETERMINING UNIFORMITY OF THE AREA SUPPORTING THE PROPOSED STRUCTURES.

HUD 79-G HUD 79-G REQUIREMENT FOR FILL MATERIAL OF 6 INCHES AND MORE WILL BE CONDUCTED. ALL CUT AREAS WILL ALSO MEET THE REQUIREMENTS FOR HUD 79-G COMPACTION TESTING. IN ADDITION, ENGINEERS MUST PROVIDE VERIFICATION OF ALL AREAS WHICH DO NOT REQUIRE HUD 79-G. AFTER SITE GRADING IS COMPLETED, GEO-TECHNICAL ENGINEER SHALL PROVIDE THE CONTRACTOR AND OWNER A 79-G LETTER.

#### FINISHED FLOOR ELEVATIONS

THE ELEVATION OF THE LOWEST FLOOR SHALL BE AT LEAST 10 INCHES ABOVE THE FINISHED GRADE OF THE SURROUNDING GROUND, WHICH SHALL BE SLOPED IN A FASHION SO AS TO DIRECT STORMWATER AWAY FROM THE STRUCTURE. PROPERTIES ADJACENT TO STORMWATER CONVEYANCE STRUCTURES MUST HAVE FLOOR SLAB ELEVATION OR BOTTOM OF FLOOR JOISTS A MINIMUM OF ONE FOOT ABOVE THE 100-YEAR WATER FLOW ELEVATION IN THE STRUCTURE. DRIVEWAYS SERVING HOUSES ON THE DOWNHILL SIDE OF THE STREET SHALL HAVE A PROPERLY SIZED CROSS SWALE PREVENTING RUNOFF FROM ENTERING THE GARAGE.

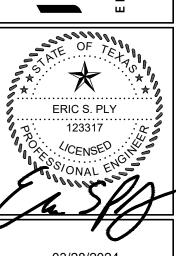


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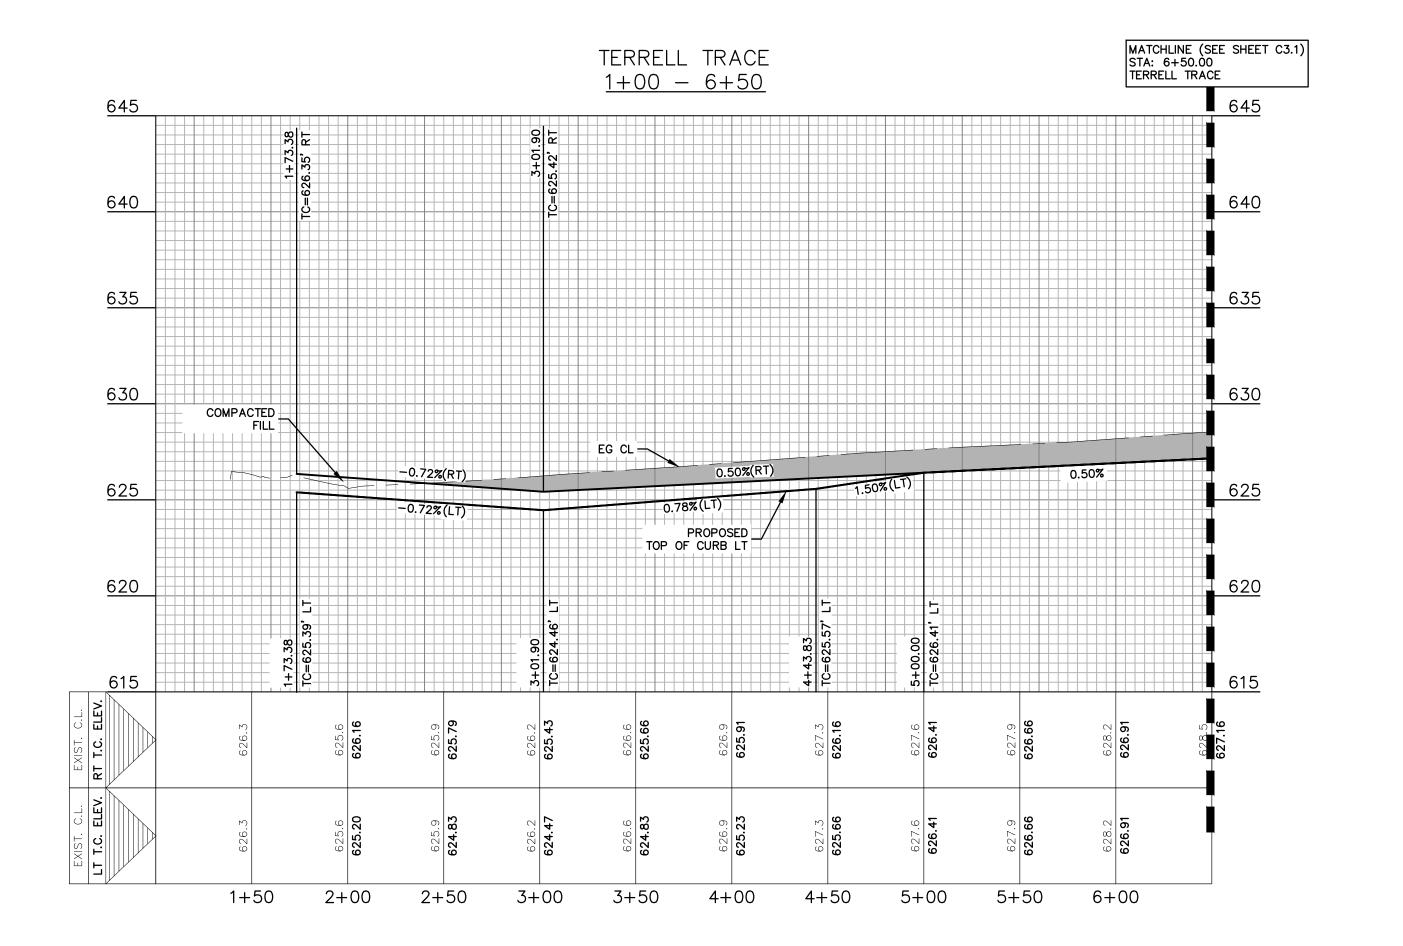
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MARCH 2024 DRAWN BY:

DESIGNED BY: MTA REVIEWED BY: ESP

HMT PROJECT NO.: 337.060



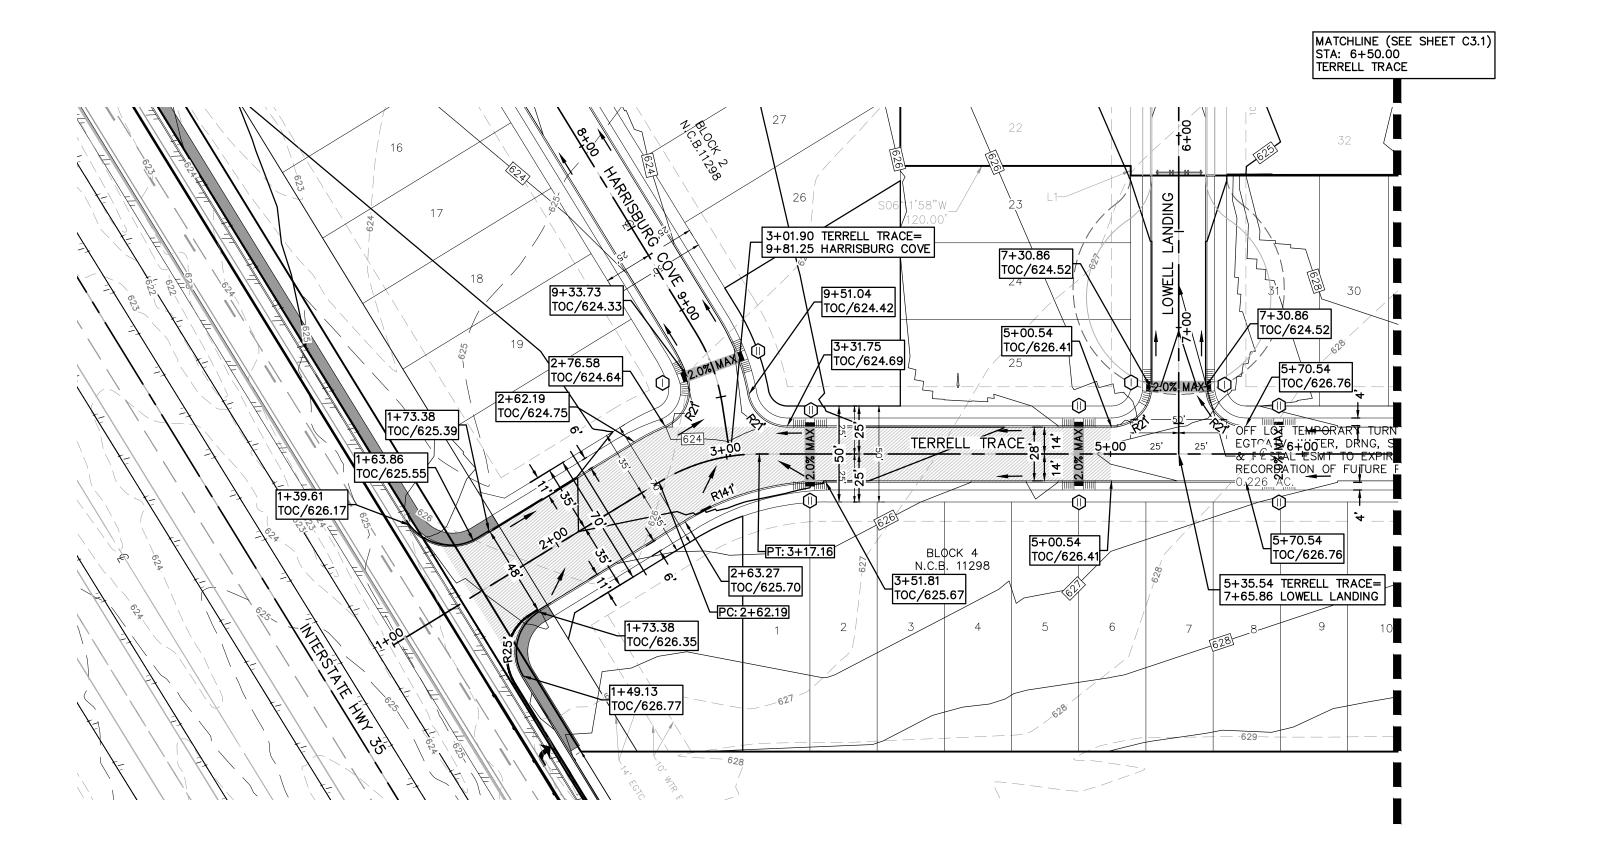

<u>LEGEND</u> EXISTING CONTOURS PROPOSED CONTOURS B.L. BUILDING SETBACK LINE UTILITY EASEMENT U.E. D.E. DRAINAGE EASEMENT A.D.A. RAMP

SCALE: 1" = 5' VERT. FLOW ARROW WASHOUT CROWN AREAS SPILL CURB EXISTING GROUND LEFT (EG LT) EXISTING GROUND RIGHT (EG RT) EXISTING GROUND CENTER (EG CTR)

ACCESSIBLE CROSSING AREA CONTRACTOR TO ENSURE MAX 2% 2.0% MAX CROSS SLOPE IN THESE AREAS SIDEWALK RAMP TYPE
TO BE CONSTRUCTED AT TIME OF

STREET CONSTRUCTION

PROPOSED TOP OF CURB (PR TC)


(SEE DETAIL SHEET C3.7) SIDEWALK TO BE CONSTRUCTED BY SITE DEVELOPMENT CONTRACTOR

#### <u>NOTES</u>

- 1. IN WASHOUT CROWN AREAS, THE CURB ON THE HIGH SIDE OF THE STREET SHOULD BE SPILL CURB AS DESIGNATED ON THE PLANS.
- 2. CONTRACTOR TO CONSTRUCT SIDEWALK RAMPS WITH STREETS.
- 3. CONTRACTOR TO ENSURE POSITIVE DRAINAGE AWAY FROM STREET STUB OUT ENDS SO THAT NO "PONDING" OF WATER OCCURS.

ST 787

290 S. CASTELL / NEW BRAUNFELS TBPE FIRM F-109 TBPLS FIRM 1053

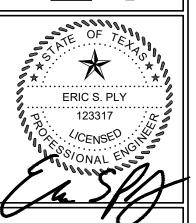

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MARCH 2024

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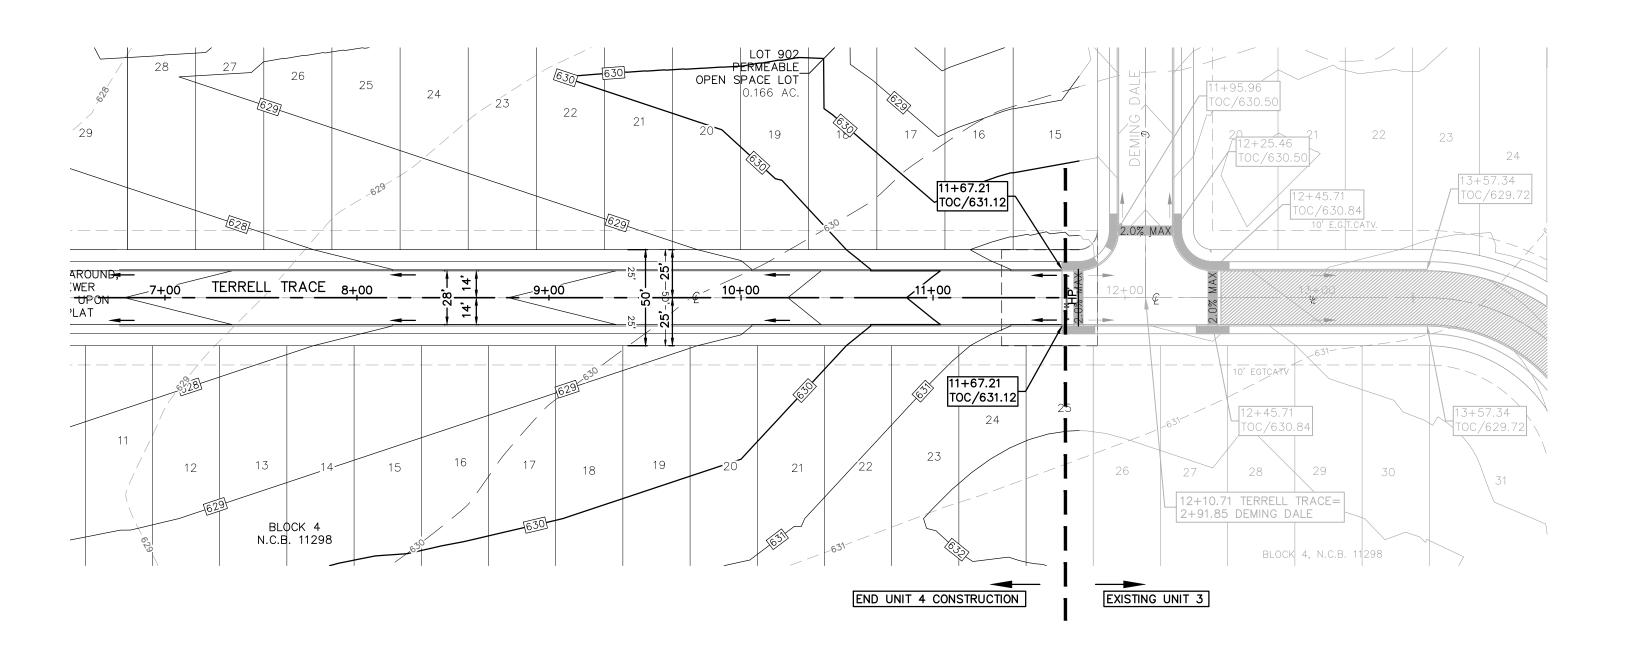
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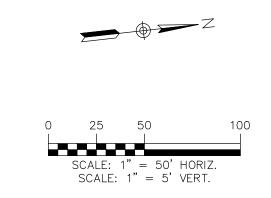
REVIEWED BY: ESP

HMT PROJECT NO .:

THE LOCATION OF ALL EXISTING UNDERGROUND UTILITIES ARE SHOWN IN APPROXIMATE LOCATIONS ONLY. THE CONTRACTOR SHALL DETERMINE THE EXACT LOCATION OF ALL EXISTING UTILITIES BEFORE COMMENCING WORK. THE CONTRACTOR WILL AGREE TO BE FULLY RESPONSIBLE FOR ANY AND ALL DAMAGES WHICH MIGHT BE INCURRED BY THEIR FAILURE TO EXACTLY LOCATE AND PRESERVE ANY AND ALL UNDERGROUND UTILITIES, STRUCTURES OR FACILITIES.

CONTRACTOR SHALL NOTIFY ENGINEER OF ANY DISCREPANCIES 24-HOURS PRIOR TO COMMENCING CONSTRUCTION.





<u>LEGEND</u> EXISTING CONTOURS PROPOSED CONTOURS B.L. BUILDING SETBACK LINE U.E. UTILITY EASEMENT D.E. DRAINAGE EASEMENT A.D.A. RAMP FLOW ARROW

WASHOUT CROWN AREAS

SPILL CURB EXISTING GROUND LEFT (EG LT) EXISTING GROUND RIGHT (EG RT)

PROPOSED TOP OF CURB (PR TC) ACCESSIBLE CROSSING AREA CONTRACTOR TO ENSURE MAX 2% 2.0% MAX CROSS SLOPE IN THESE AREAS

> SIDEWALK RAMP TYPE
> TO BE CONSTRUCTED AT TIME OF STREET CONSTRUCTION (SEE DETAIL SHEET C3.7)

SIDEWALK TO BE CONSTRUCTED BY SITE DEVELOPMENT CONTRACTOR

EXISTING GROUND CENTER (EG CTR)

#### <u>NOTES</u>


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AVE., S, TX 1961 53600

290 S. CASTELL / NEW BRAUNFELS TBPE FIRM F-109 TBPLS FIRM 1053

03/28/2024


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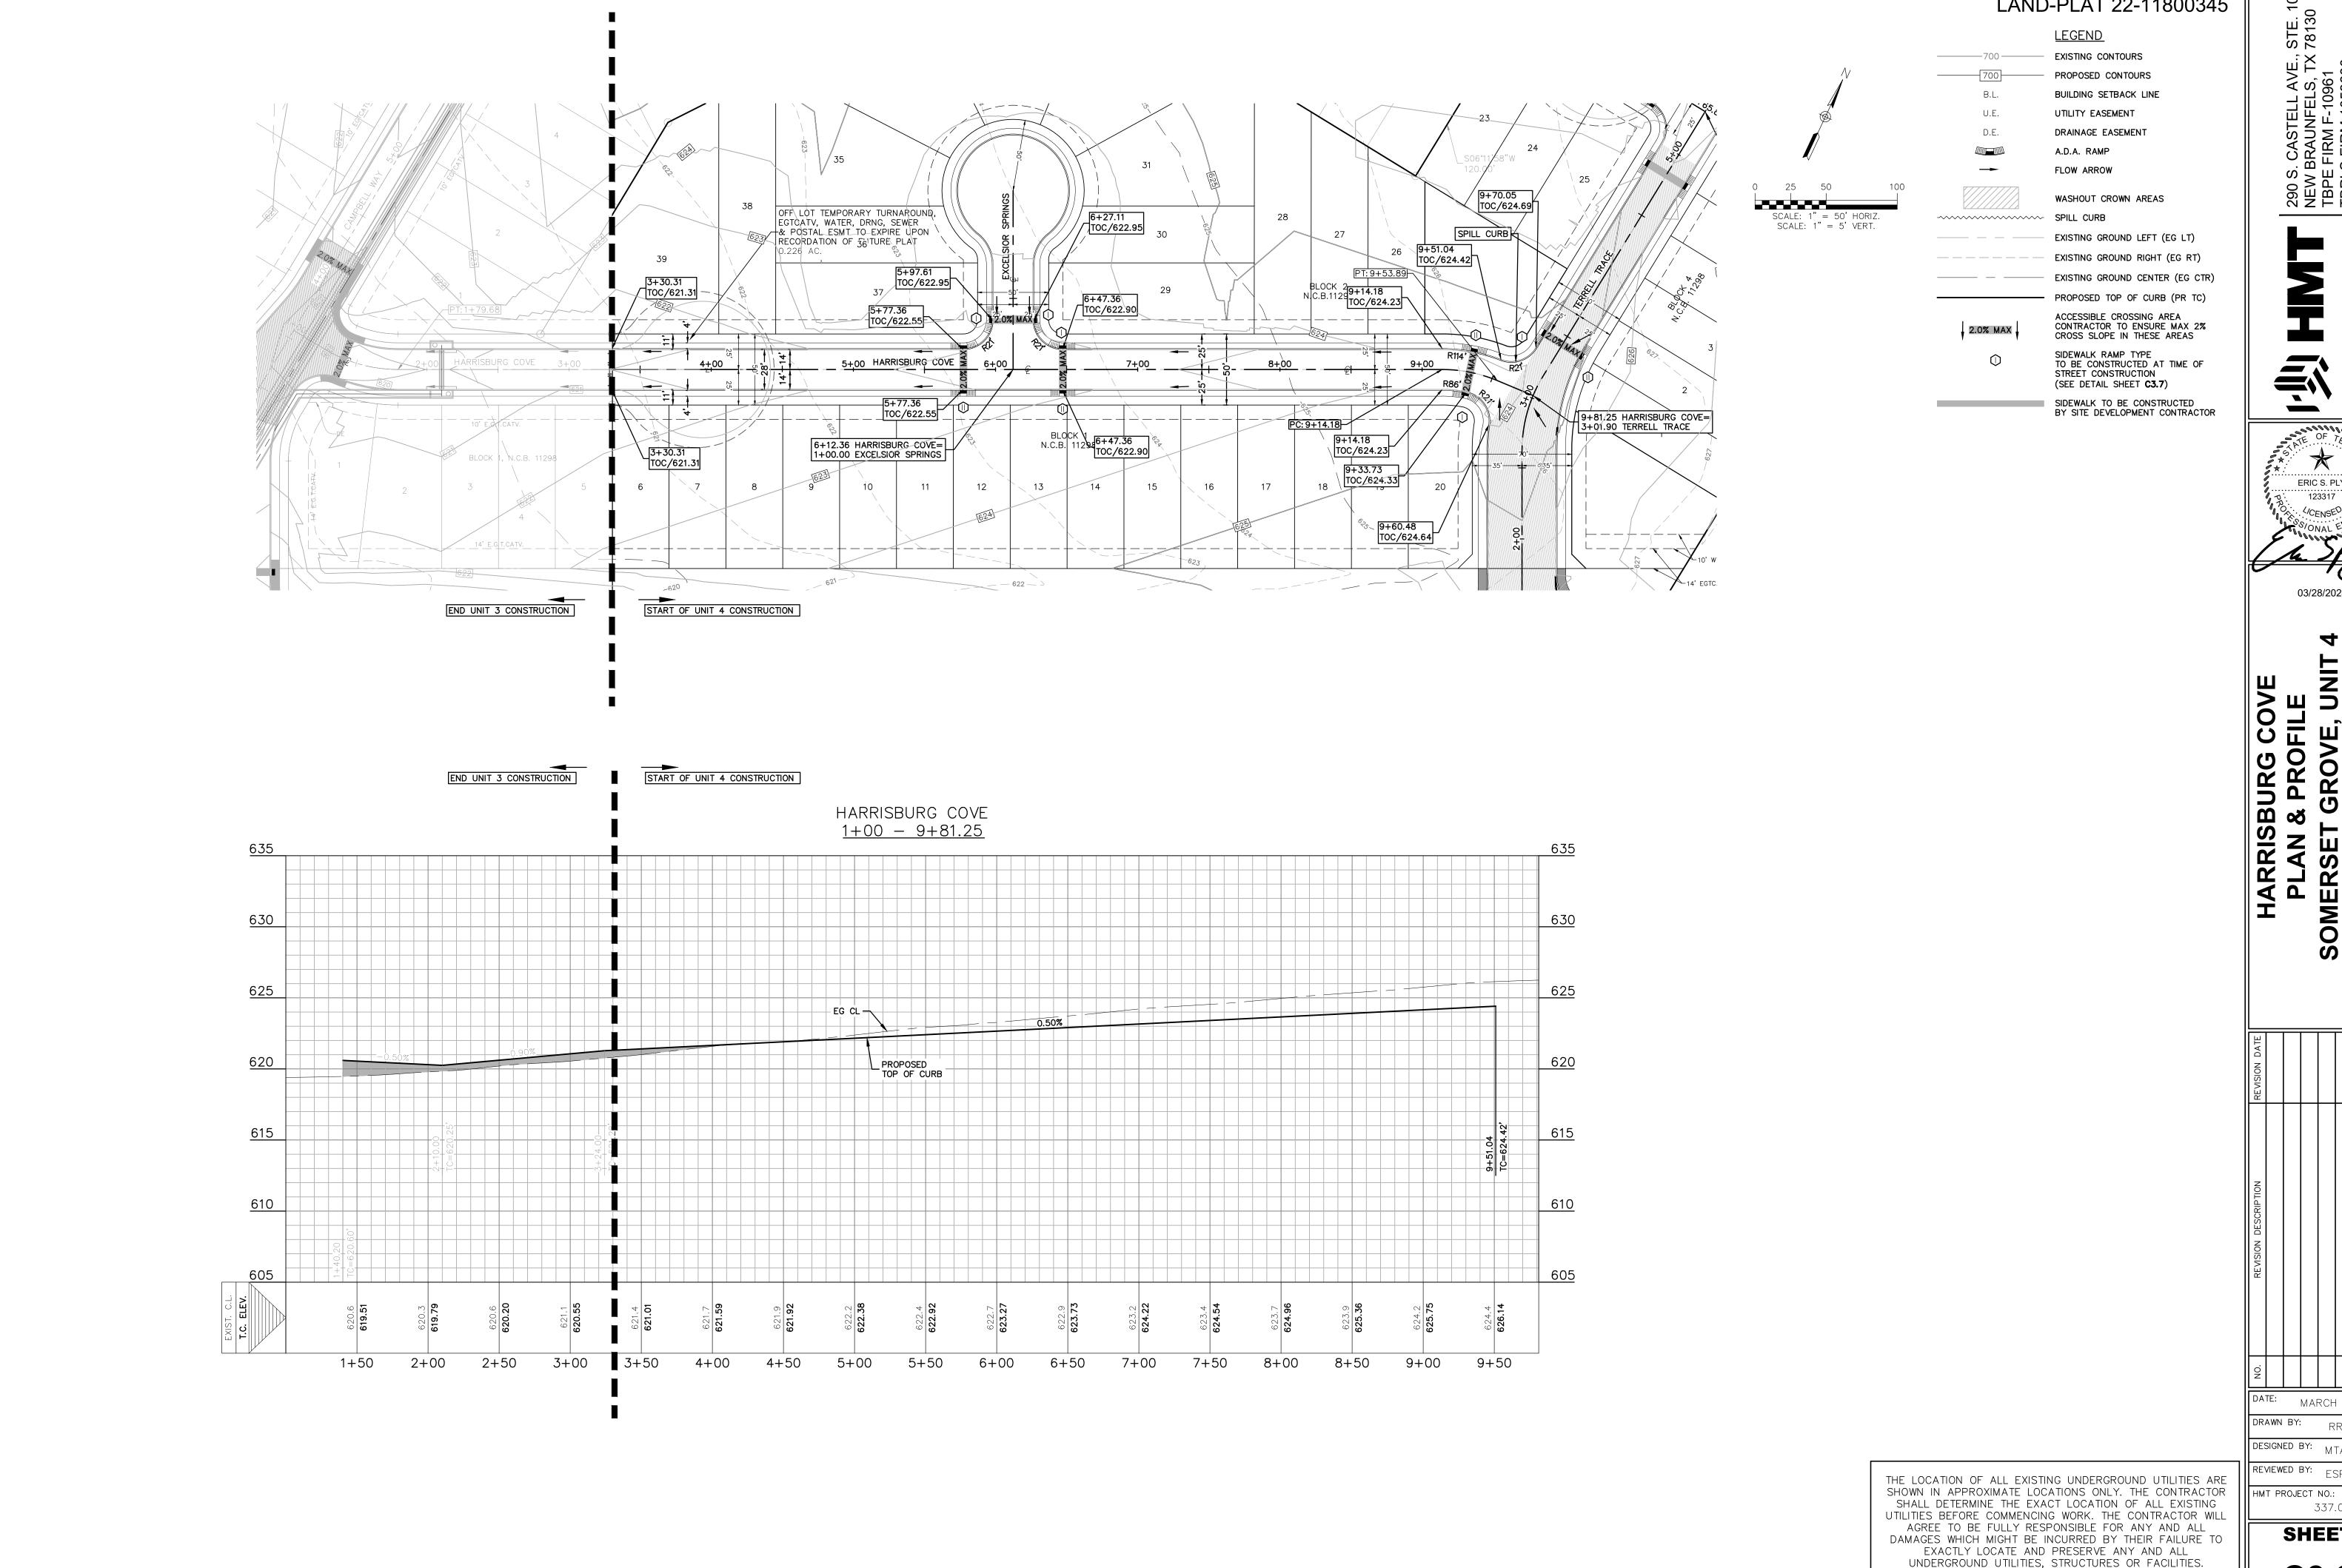
MARCH 2024 DRAWN BY:

DESIGNED BY: MTA

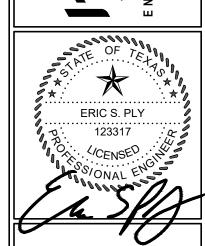REVIEWED BY: ESP

HMT PROJECT NO.: 337.060



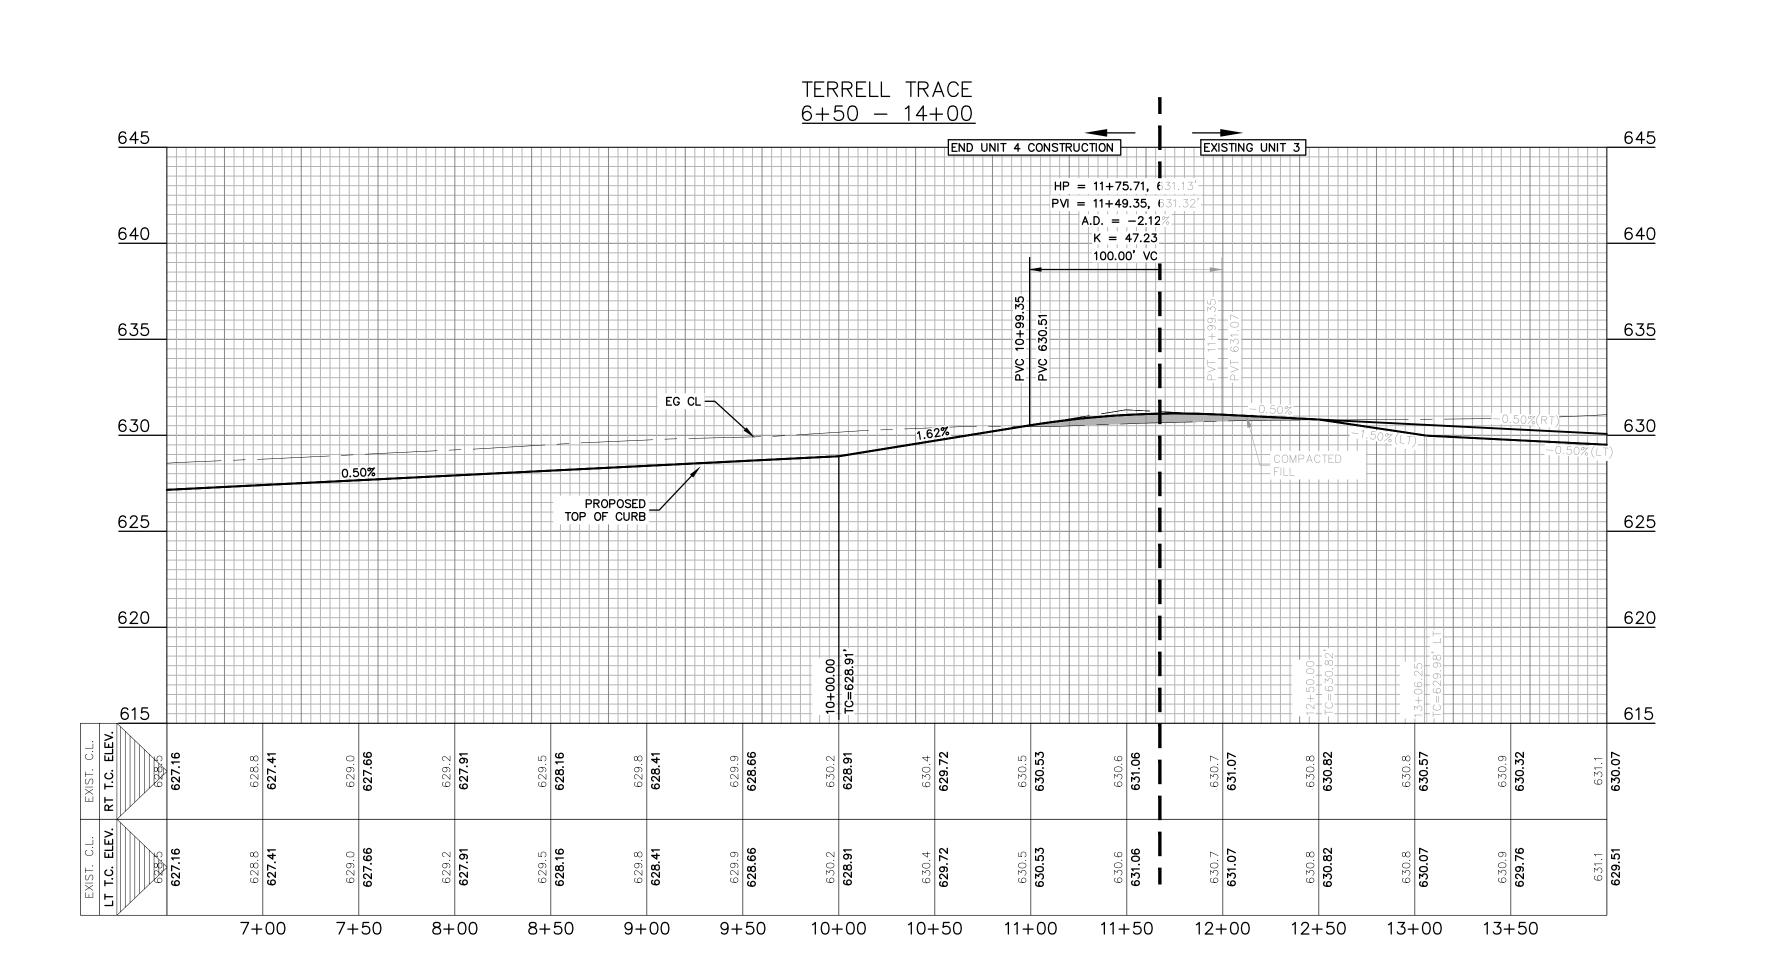

<u>LEGEND</u> EXISTING CONTOURS PROPOSED CONTOURS BUILDING SETBACK LINE UTILITY EASEMENT DRAINAGE EASEMENT A.D.A. RAMP FLOW ARROW

WASHOUT CROWN AREAS SPILL CURB EXISTING GROUND LEFT (EG LT) EXISTING GROUND RIGHT (EG RT)

EXISTING GROUND CENTER (EG CTR) PROPOSED TOP OF CURB (PR TC) ACCESSIBLE CROSSING AREA CONTRACTOR TO ENSURE MAX 2% CROSS SLOPE IN THESE AREAS

SIDEWALK RAMP TYPE
TO BE CONSTRUCTED AT TIME OF
STREET CONSTRUCTION (SEE DETAIL SHEET C3.7)

SIDEWALK TO BE CONSTRUCTED
BY SITE DEVELOPMENT CONTRACTOR

STE. 100 78130

290 S. CASTELL AVE., S NEW BRAUNFELS, TX 7 TBPE FIRM F-10961 TBPLS FIRM 1053600

ERIC S. PLY 123317

03/28/2024

HARRISBURG COVE PLAN & PROFILE OMERSET GROVE, UNIT 0

DATE: MARCH 2024 DRAWN BY:


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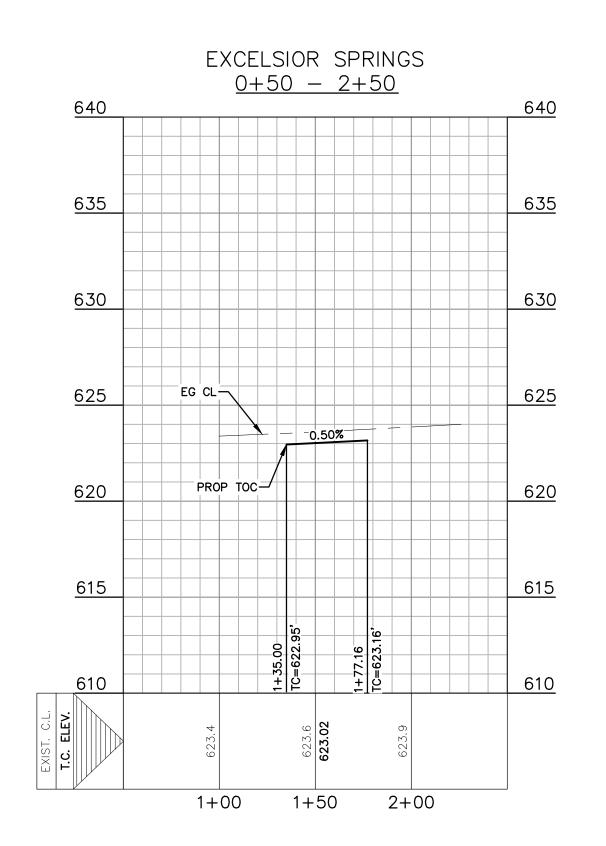
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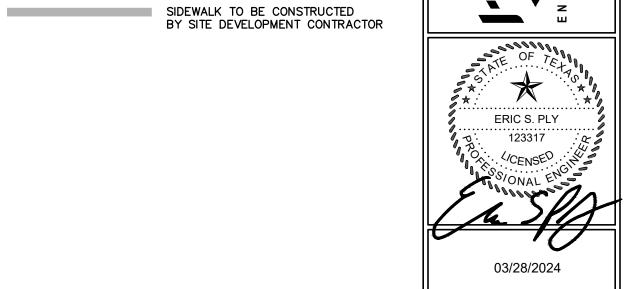
CONTRACTOR SHALL NOTIFY ENGINEER OF ANY DISCREPANCIES 24-HOURS PRIOR TO COMMENCING CONSTRUCTION.





(SEE DETAIL SHEET C3.7)

<u>LEGEND</u> EXISTING CONTOURS PROPOSED CONTOURS B.L. BUILDING SETBACK LINE U.E. UTILITY EASEMENT D.E. DRAINAGE EASEMENT A.D.A. RAMP FLOW ARROW WASHOUT CROWN AREAS SCALE: 1" = 50' HORIZ. SCALE: 1" = 5' VERT. SPILL CURB EXISTING GROUND LEFT (EG LT) EXISTING GROUND RIGHT (EG RT) EXISTING GROUND CENTER (EG CTR) PROPOSED TOP OF CURB (PR TC) ACCESSIBLE CROSSING AREA CONTRACTOR TO ENSURE MAX 2% CROSS SLOPE IN THESE AREAS 2.0% MAX SIDEWALK RAMP TYPE
TO BE CONSTRUCTED AT TIME OF
STREET CONSTRUCTION

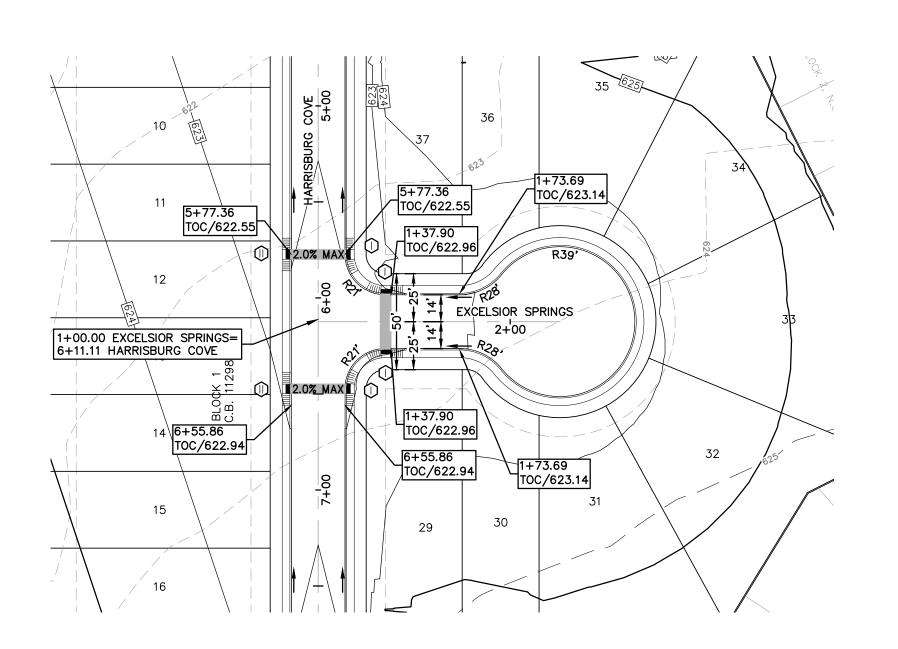

STE. 100 78130

290 S. CASTELL AVE., S NEW BRAUNFELS, TX 7 TBPE FIRM F-10961 TBPLS FIRM 1053600

EXCELSIOR SPRINGS
PLAN & PROFILE
SOMERSET GROVE, UNIT
SAN ANTONIO, TEXAS

REVISION DATE

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S.

NO.

REVISION DESCRIPTION

REVISION DATE:

MARCH 2024

DRAWN BY: RR

DESIGNED BY: MTA

REVIEWED BY: ESP

HMT PROJECT NO.:
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THE LOCATION OF ALL EXISTING UNDERGROUND UTILITIES ARE SHOWN IN APPROXIMATE LOCATIONS ONLY. THE CONTRACTOR

SHALL DETERMINE THE EXACT LOCATION OF ALL EXISTING


UTILITIES BEFORE COMMENCING WORK. THE CONTRACTOR WILL AGREE TO BE FULLY RESPONSIBLE FOR ANY AND ALL


DAMAGES WHICH MIGHT BE INCURRED BY THEIR FAILURE TO EXACTLY LOCATE AND PRESERVE ANY AND ALL UNDERGROUND UTILITIES, STRUCTURES OR FACILITIES.

CONTRACTOR SHALL NOTIFY ENGINEER OF ANY DISCREPANCIES 24—HOURS PRIOR TO COMMENCING CONSTRUCTION.

SHEET

C3.3

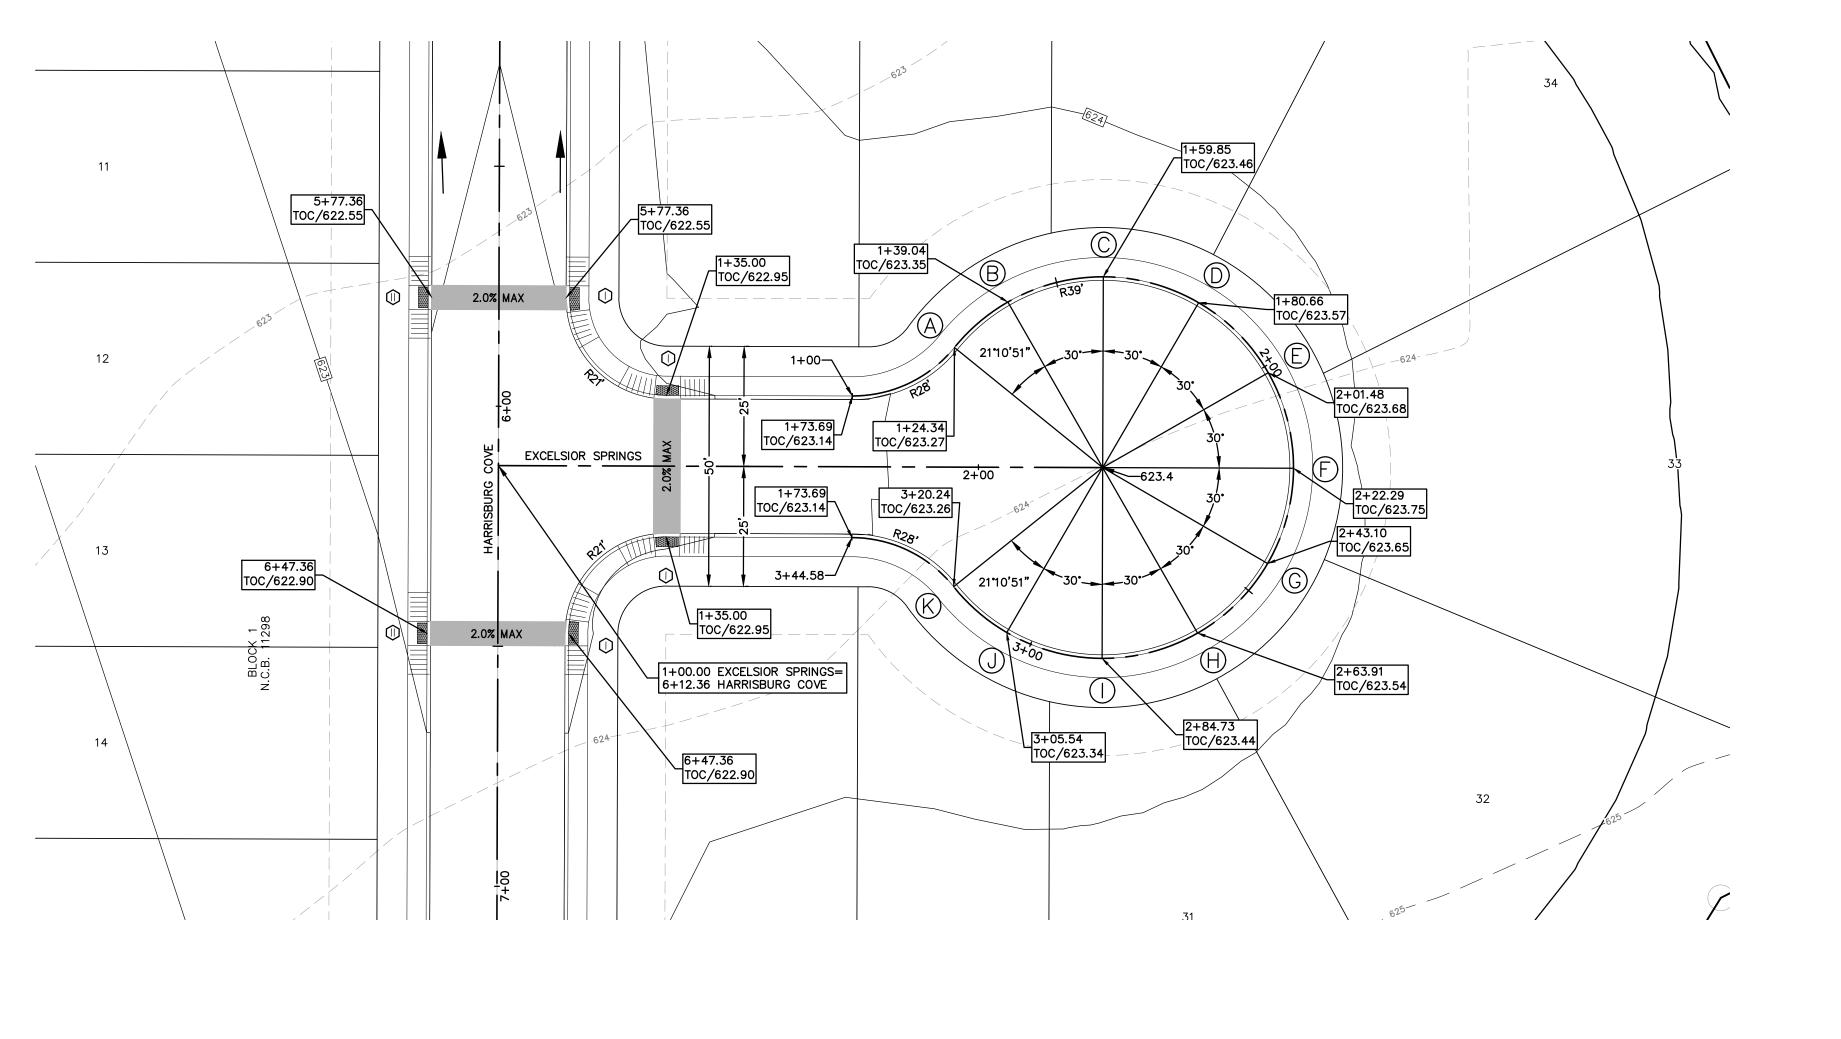

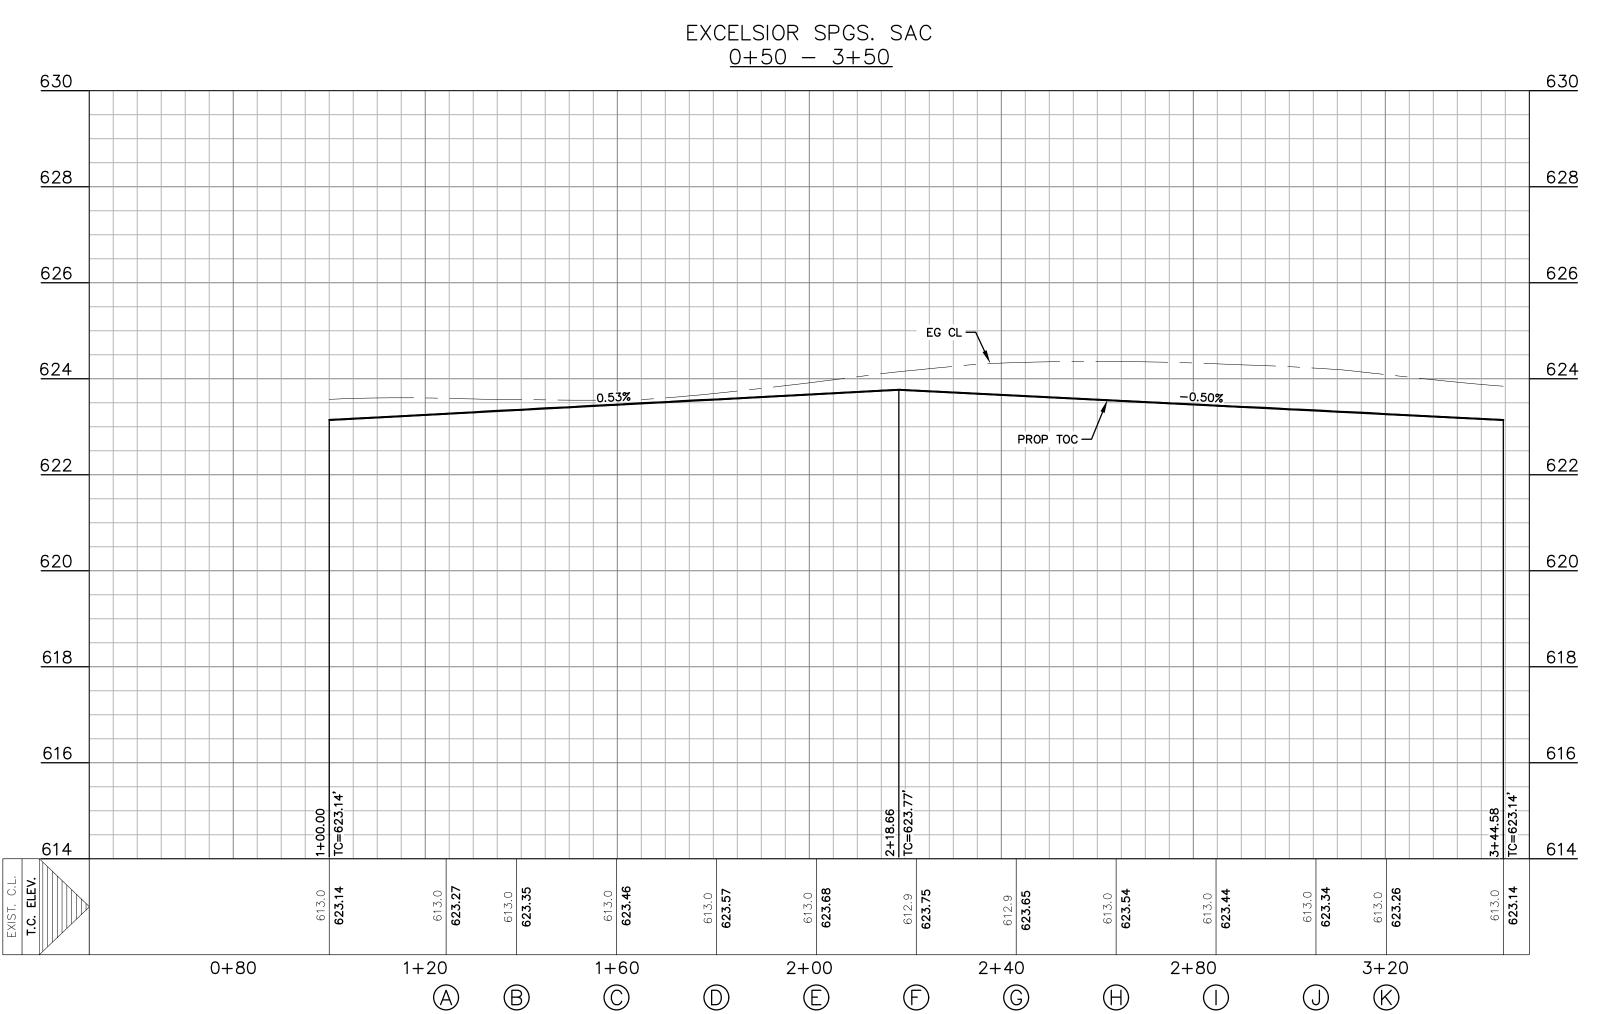

<u>LEGEND</u> EXISTING CONTOURS PROPOSED CONTOURS BUILDING SETBACK LINE U.E. UTILITY EASEMENT D.E. DRAINAGE EASEMENT A.D.A. RAMP FLOW ARROW WASHOUT CROWN AREAS

SCALE: 1" = 20' HORIZ SCALE: 1" = 2' VERT.

SPILL CURB EXISTING GROUND LEFT (EG LT) EXISTING GROUND RIGHT (EG RT) EXISTING GROUND CENTER (EG CTR) PROPOSED TOP OF CURB (PR TC)

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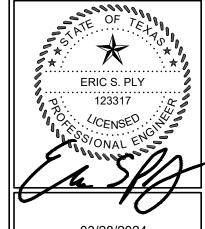
2.0% MAX

ACCESSIBLE CROSSING AREA CONTRACTOR TO ENSURE MAX 2% CROSS SLOPE IN THESE AREAS

SIDEWALK RAMP TYPE TO BE CONSTRUCTED AT TIME OF STREET CONSTRUCTION (SEE DETAIL SHEET C3.7)

SIDEWALK TO BE CONSTRUCTED BY SITE DEVELOPMENT CONTRACTOR 290 S. CASTELL AVE., S NEW BRAUNFELS, TX 7 TBPE FIRM F-10961 TBPLS FIRM 1053600

STE. 100 78130



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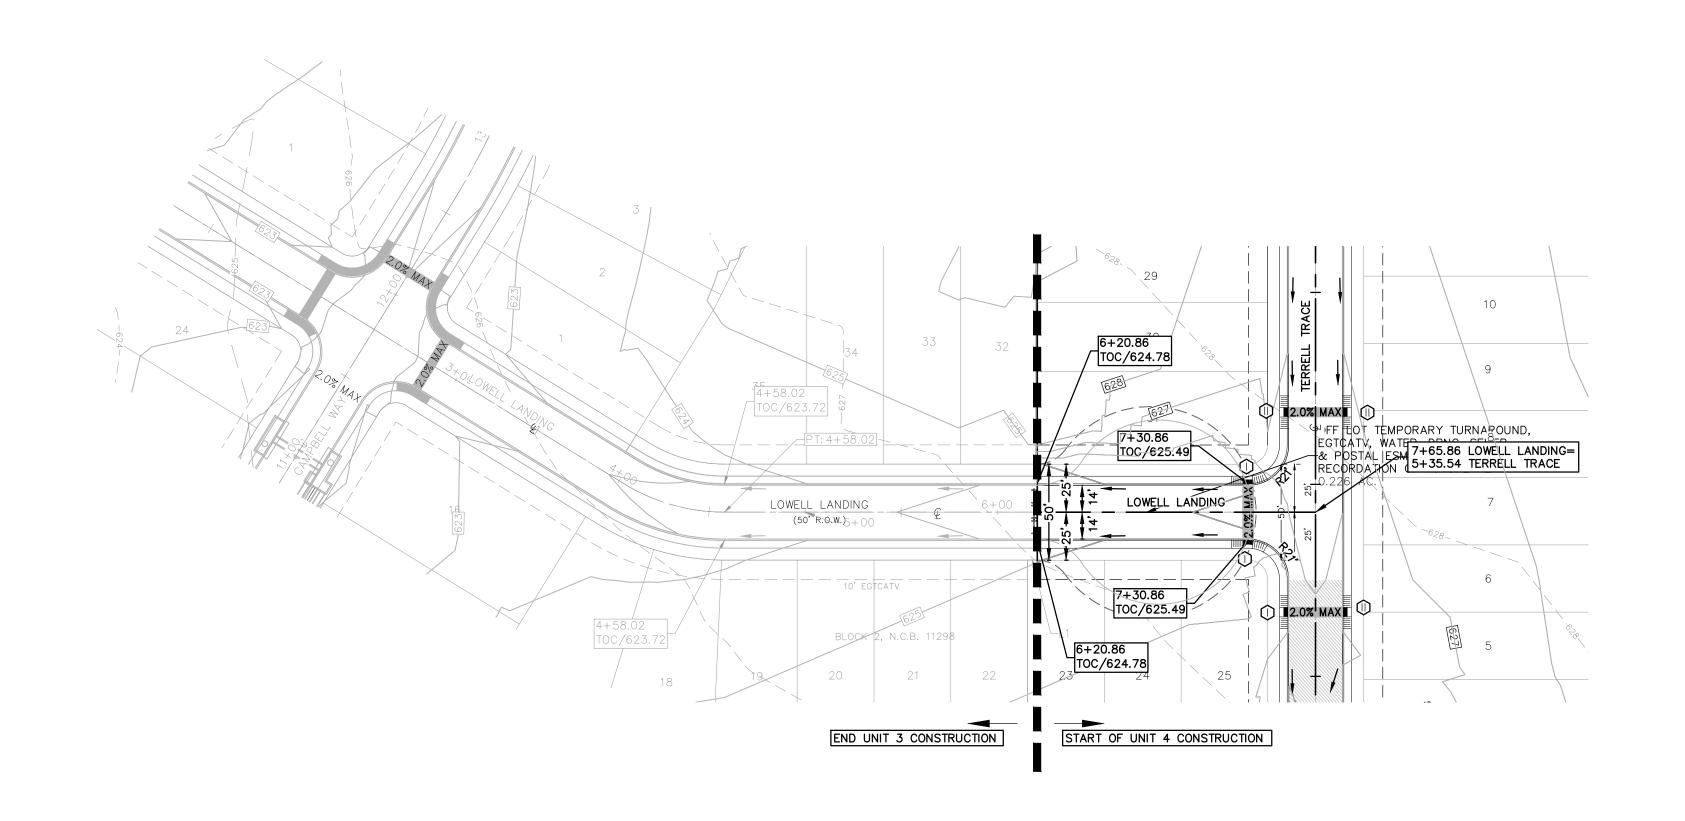
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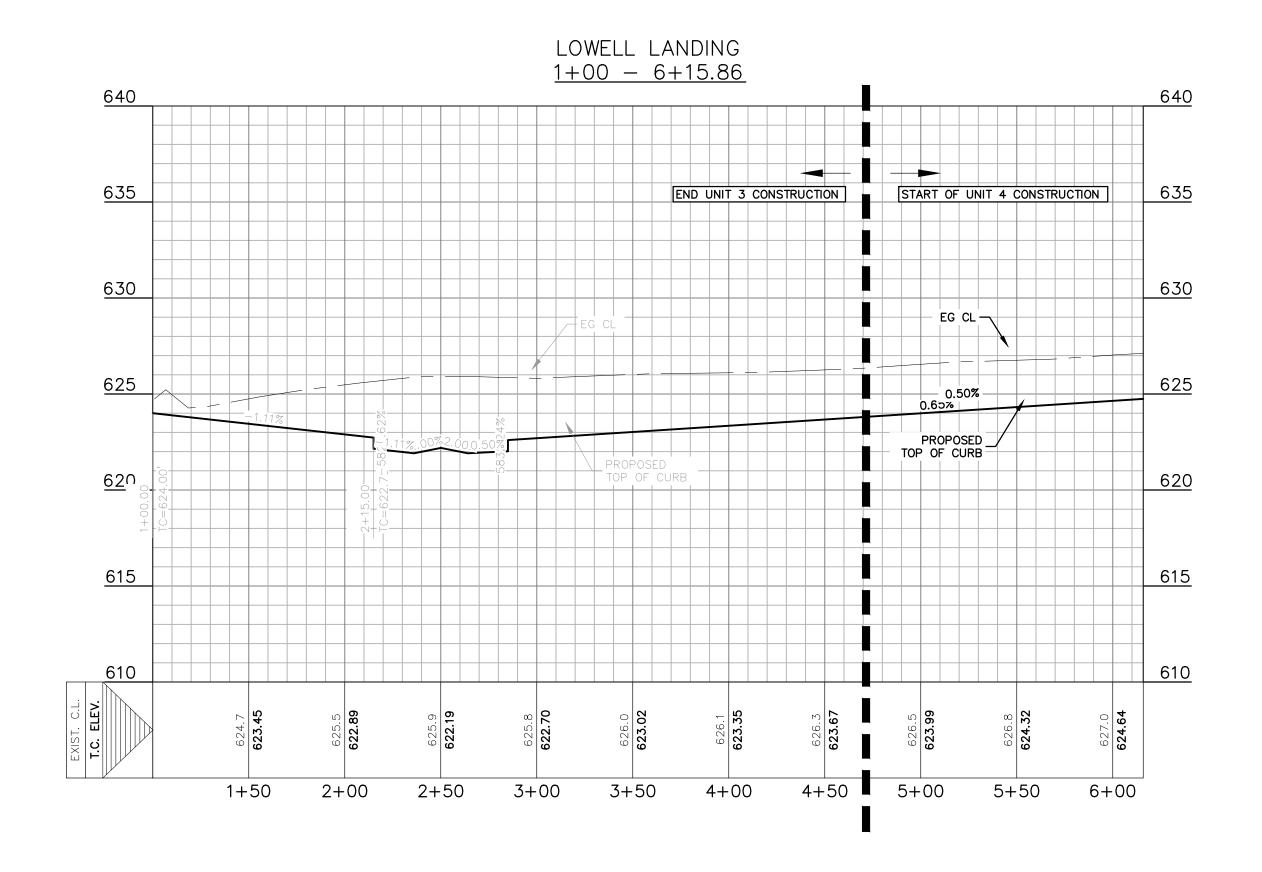
MARCH 2024 DRAWN BY:

DESIGNED BY: MTA

REVIEWED BY: ESP

HMT PROJECT NO .: 337.060





SCALE: 1" = 50' HORIZSCALE: 1" = 5' VERT.

<u>LEGEND</u> EXISTING CONTOURS PROPOSED CONTOURS B.L. BUILDING SETBACK LINE U.E. UTILITY EASEMENT D.E. DRAINAGE EASEMENT A.D.A. RAMP FLOW ARROW

> WASHOUT CROWN AREAS SPILL CURB EXISTING GROUND LEFT (EG LT)

EXISTING GROUND RIGHT (EG RT) EXISTING GROUND CENTER (EG CTR) PROPOSED TOP OF CURB (PR TC)


ACCESSIBLE CROSSING AREA CONTRACTOR TO ENSURE MAX 2% CROSS SLOPE IN THESE AREAS 2.0% MAX SIDEWALK RAMP TYPE
TO BE CONSTRUCTED AT TIME OF
STREET CONSTRUCTION

(SEE DETAIL SHEET C3.7) SIDEWALK TO BE CONSTRUCTED
BY SITE DEVELOPMENT CONTRACTOR

#### <u>NOTES</u>

- IN WASHOUT CROWN AREAS, THE CURB ON THE HIGH SIDE OF THE STREET SHOULD BE SPILL CURB AS DESIGNATED ON THE PLANS.
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STE. 100 78130 290 S. CASTELL AVE., S NEW BRAUNFELS, TX 7 TBPE FIRM F-10961 TBPLS FIRM 1053600

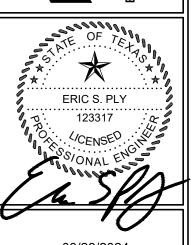

03/28/2024

LANDING GROVE, UN LOWEL PLAN

0

MARCH 2024

DRAWN BY: DESIGNED BY: MTA REVIEWED BY: ESP

THE LOCATION OF ALL EXISTING UNDERGROUND UTILITIES ARE SHOWN IN APPROXIMATE LOCATIONS ONLY. THE CONTRACTOR HMT PROJECT NO .: SHALL DETERMINE THE EXACT LOCATION OF ALL EXISTING

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290 S. CASTELL / NEW BRAUNFELS TBPE FIRM F-109 TBPLS FIRM 1053

ERIC S. PLY 123317


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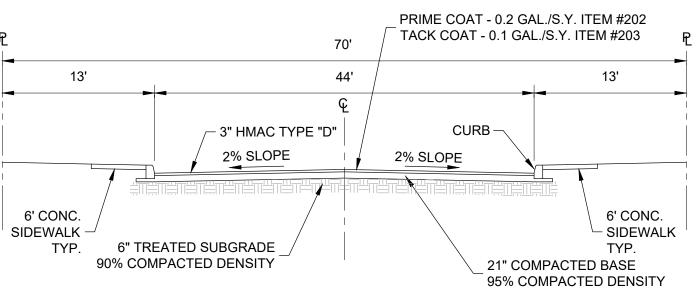
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NEW PAVEMENT TO EXISTING

NOT TO SCALE



# LOCAL TYPE A WITHOUT BUS TRAFFIC TYPICAL STREET CROSS SECTION (28' PAVEMENT) NOT TO SCALE

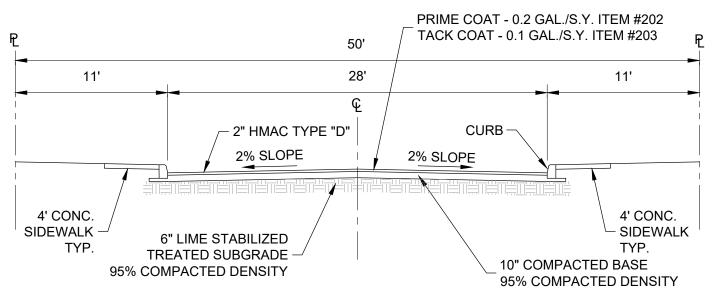

## COLLECTOR TYPICAL STREET CROSS SECTION (44' PAVEMENT) NOT TO SCALE

FLEXIBLE PAVEMENTS

PAVEMENT MATERIAL

TYPE "D" HMAC

CRUSHED LIMESTONE FLEXIBLE BASE, IN. 10"

COMPACTED SUBGRADE

LIME SUBGRADE

ACTUAL STRUCTURAL NUMBER

2.28

### FROM PAGES 15-16 OF GEOTECHNICAL STUDY PERFORMED BY AMIT BAKANE DATED MAY 18, 2020

THE GEOTECHINCAL ENGINEER, OR THEIR APPOINTED REPRESENTATIVE, SHALL OBSERVE PROOF-ROLLING OF THE SUBGRADE SOIL. REFER TO GEOTECHNICAL ENGINEERING REPORT WHEN SUBGRADE IS FOUND TO BE NON-COMPRESSIBLE OR WHEN COMPACTION CANNOT BE ACHIEVED.

FLEXIBLE PAVEMENTS	
PAVEMENT MATERIAL	
TYPE "D" HMAC	3"
CRUSHED LIMESTONE FLEXIBLE BASE, IN.	21"
COMPACTED SUBGRADE	-
LIME SUBGRADE	6"
ACTUAL STRUCTURAL NUMBER	4.26

FROM PAGES 15-16 OF GEOTECHNICAL STUDY PERFORMED
BY AMIT BAKANE DATED MAY 18, 2020


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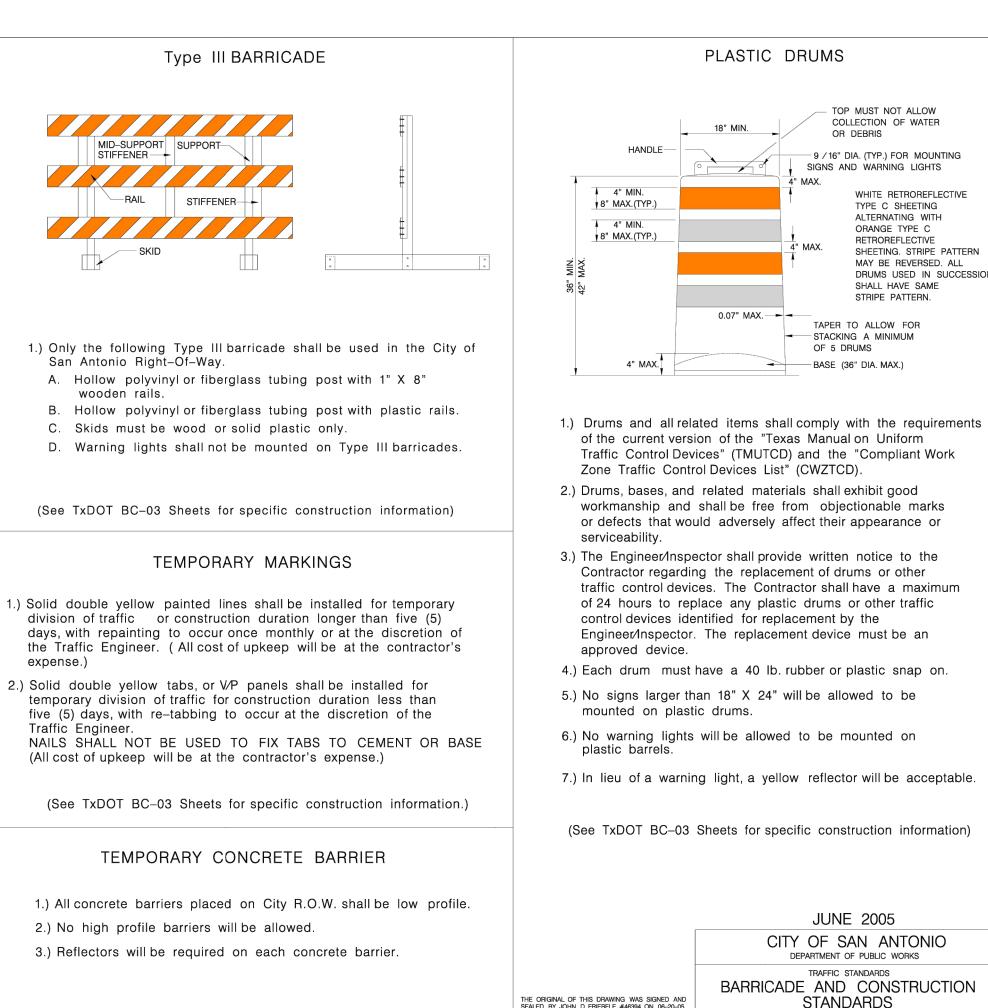
SHEET 3 OF 4

DRWN, BY: A.F.G. DSGN, BY: E.N.M. CHKD, BY: J.D.F./E.N.M. SHEET NO.: OF

% SUBMITTAL PROJECT NO.:\_\_\_\_\_

NOTE: PER CODE, THE COLLECTOR PAVEMENT DESIGN REQUIREMENTS ARE ONLY TO MEET THOSE OF A LOCAL A WITH BUS TRAFFIC. THE COLLECTOR SECTION WAS USED TO TRANSITION FROM A MINOR ARTERIAL TO A LOCAL A, BUT WILL NOT HANDLE THE ESAL LOADING OF A TYPICAL COLLECTOR.



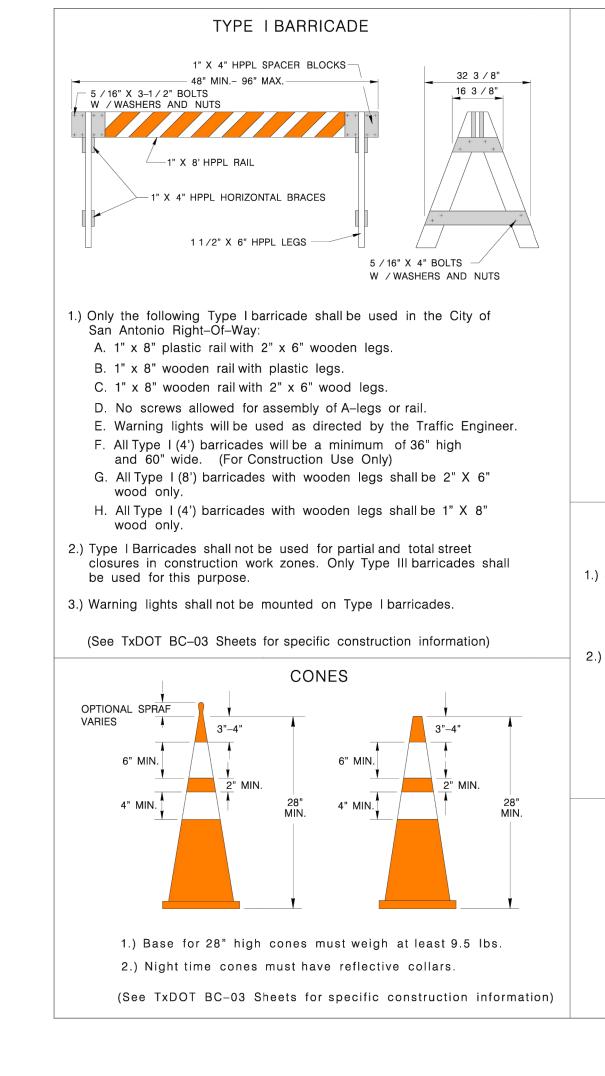

(See TxDOT BC-03 Sheets for specific construction information)


UMS

TOP MUST NOT ALLOW
COLLECTION OF WATER
OR DEBRIS

99/16" DIA. (TYP.) FOR MOUNTING
BIGINS AND WARNING LIGHTS

AX.

WHITE RETROREFLECTIVE
TYPE C SHEETING
ALTERNATING WITH
ORANGE TYPE C
RETROREFLECTIVE
INDIANAL STRIPE PATTERN
MAY BE REVERSED. ALL
DRUMS USED IN SUCCESSION
SHALL HAVE SAME
STRIPE PATTERN.

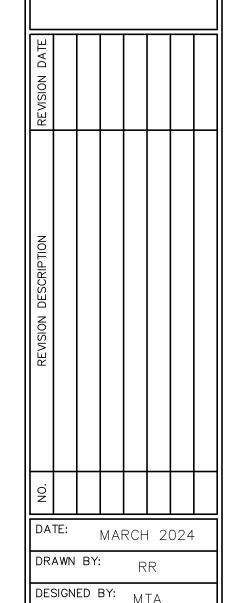

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REVIEWED BY: ESP

HMT PROJECT NO.:

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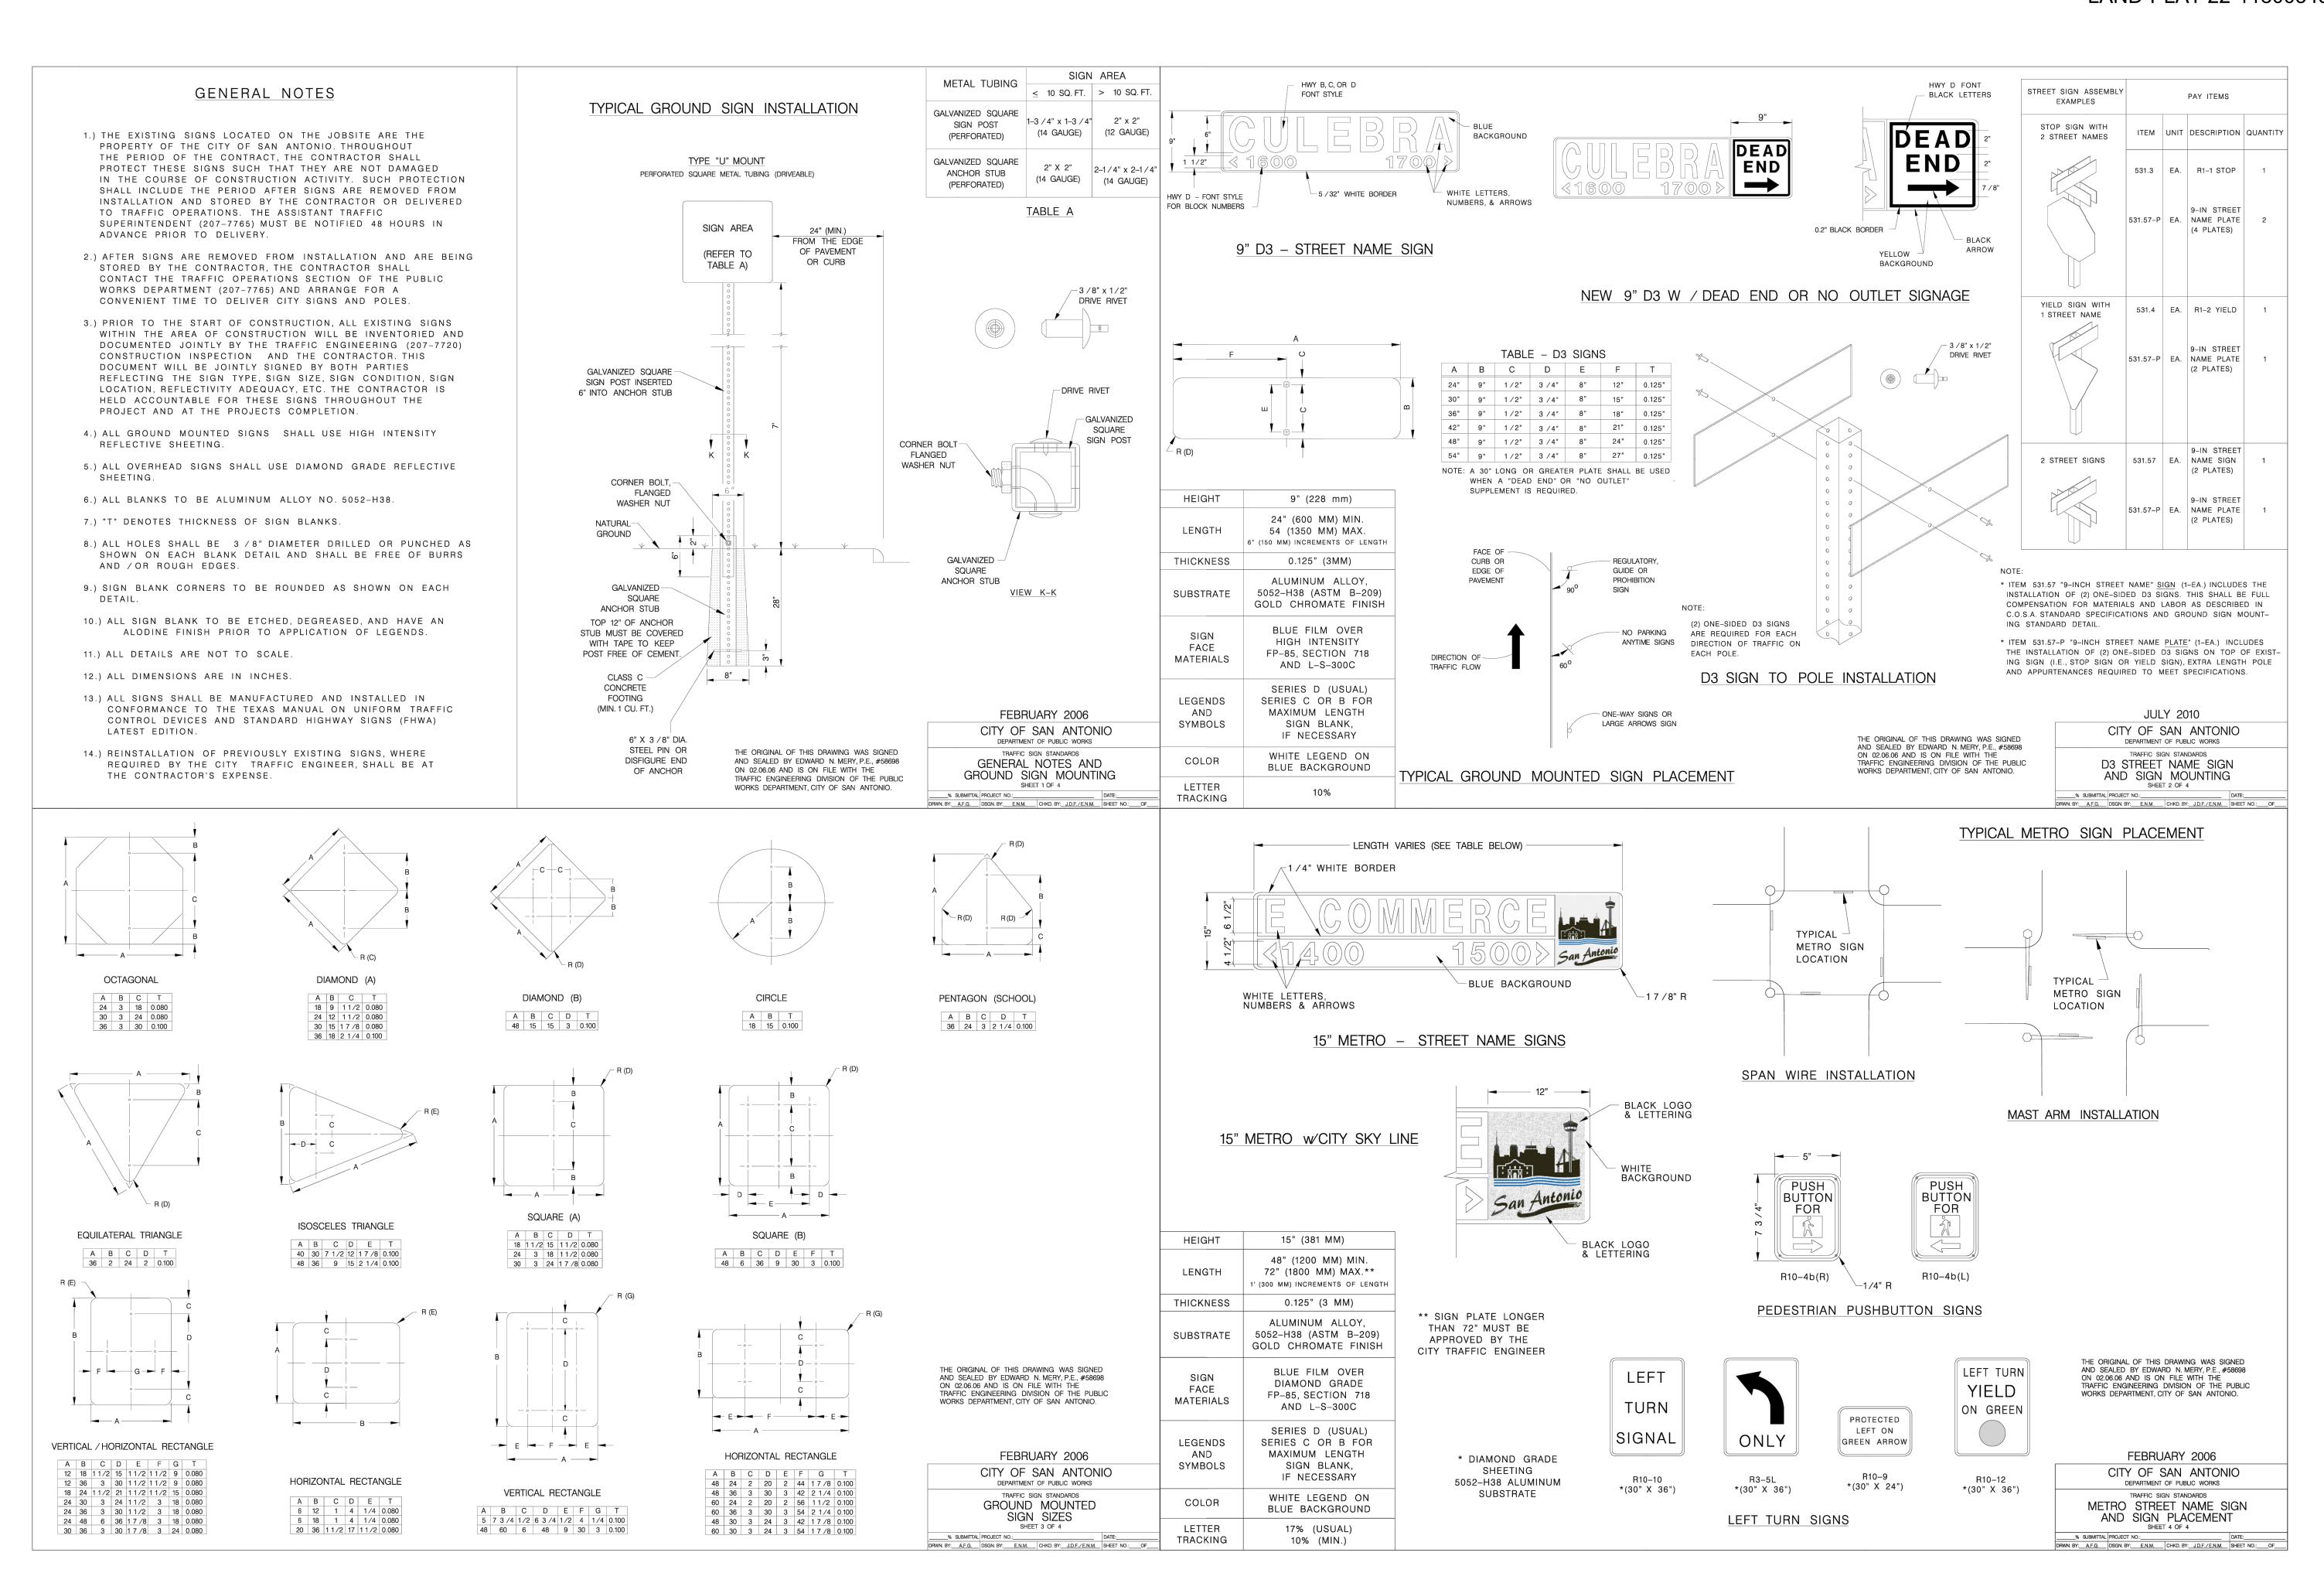
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MARCH 2024

DESIGNED BY: MTA


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C3.7



290 S. CASTELL AVE., STE. 100 NEW BRAUNFELS, TX 78130 TBPE FIRM F-10961 TBPLS FIRM 1053600

ENGINEERING & SURVEYING TBI

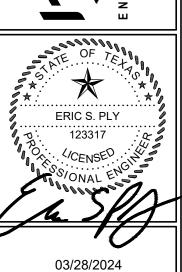

STREET DETAILS
(3 OF 3)
SOMERSET GROVE, UNIT 4
SAN ANTONIO, TEXAS

NO. REVISION DESCRIPTION REVISION DATE: MARCH 2024

DATE: MARCH 2024


DRAWN BY: RR

DESIGNED BY: MTA

REVIEWED BY: ESP

HMT PROJECT NO.: 337.060

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SIGNAGE NOTES
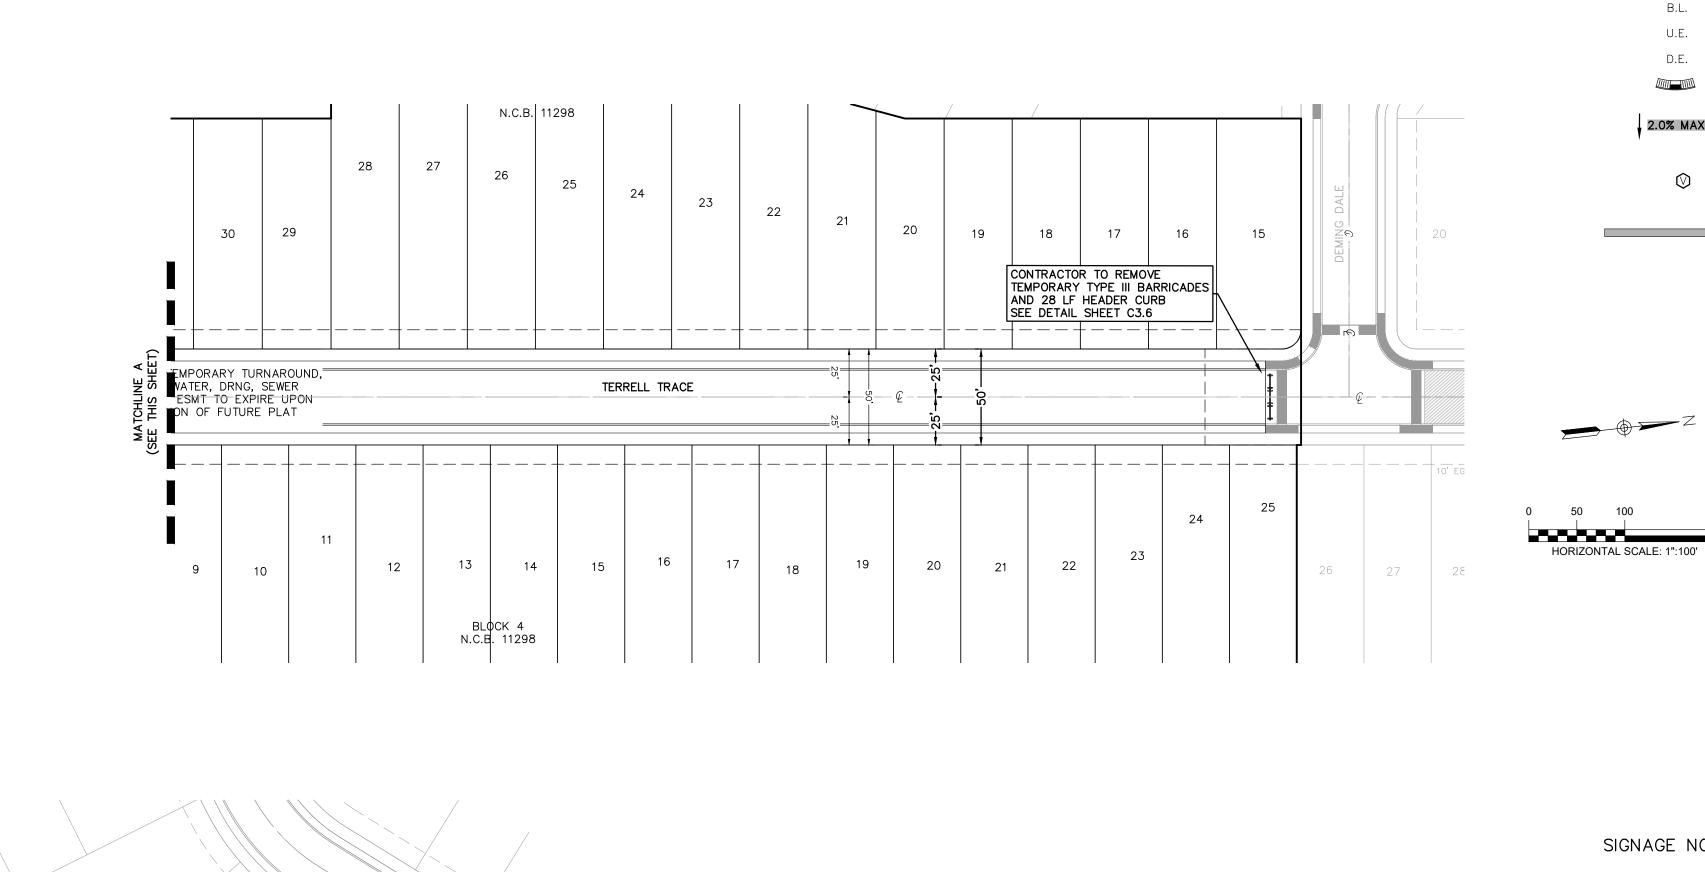
#### INSTALLATION

THE CONTRACTOR SHALL FURNISH AND INSTALL ALL REGULATORY, WARNING AND STREET NAME SIGNS AND SIGN MOUNTS IN ACCORDANCE WITH APPROVED ENGINEERING PLANS.

LAND-PLAT 22-11800345

BUILDING SETBACK LINE

UTILITY EASEMENT

A.D.A. RAMP

DRAINAGE EASEMENT

ACCESSIBLE CROSSING AREA CONTRACTOR TO ENSURE MAX 2% CROSS SLOPE IN THESE AREAS

SIDEWALK RAMP TYPE
TO BE CONSTRUCTED AT TIME OF
STREET CONSTRUCTION

SIDEWALK TO BE CONSTRUCTED BY SITE DEVELOPMENT CONTRACTOR

(SEE DETAIL SHEET C3.7)

<u>LEGEND</u>

#### <u>MOUNTING</u>

THE WEDGE ANCHOR STEEL SYSTEM AND THIN-WALLED TUBING POST SHALL BE USED FOR SIGNS WITH UP TO 10 SQUARE FEET OF SIGN AREA. MATERIALS AND INSTALLATION SHOULD FOLLOW THE TEXAS DEPARTMENT OF TRANSPORTATION (TXDOT) TRAFFIC STANDARDS SMD (GEN) - 08 AND SMD (TWT) - 08.

THE TRIANGULAR SLIP BASE SYSTEM AND 10 BWG TUBING POST SHALL BE USED FOR SIGNS THAT HAVE 10 TO 16 SQUARE FEET OF SIGN AREA. MATERIALS AND INSTALLATION SHOULD FOLLOW THE TXDOT TRAFFIC STANDARDS SMD (GEN) - 08 AND SMD (SLIP-1-3)-08.

OBJECT MARKERS MATERIALS AND INSTALLATION SHOULD FOLLOW THE TXDOT TRAFFIC STANDARDS D & OM (1 - 5) - 10.

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ERIC S. PLY 123317

03/28/2024

STE. 100 78130

MARCH 2024 DRAWN BY:

DESIGNED BY: MTA

REVIEWED BY: ESP

HMT PROJECT NO.: 337.060

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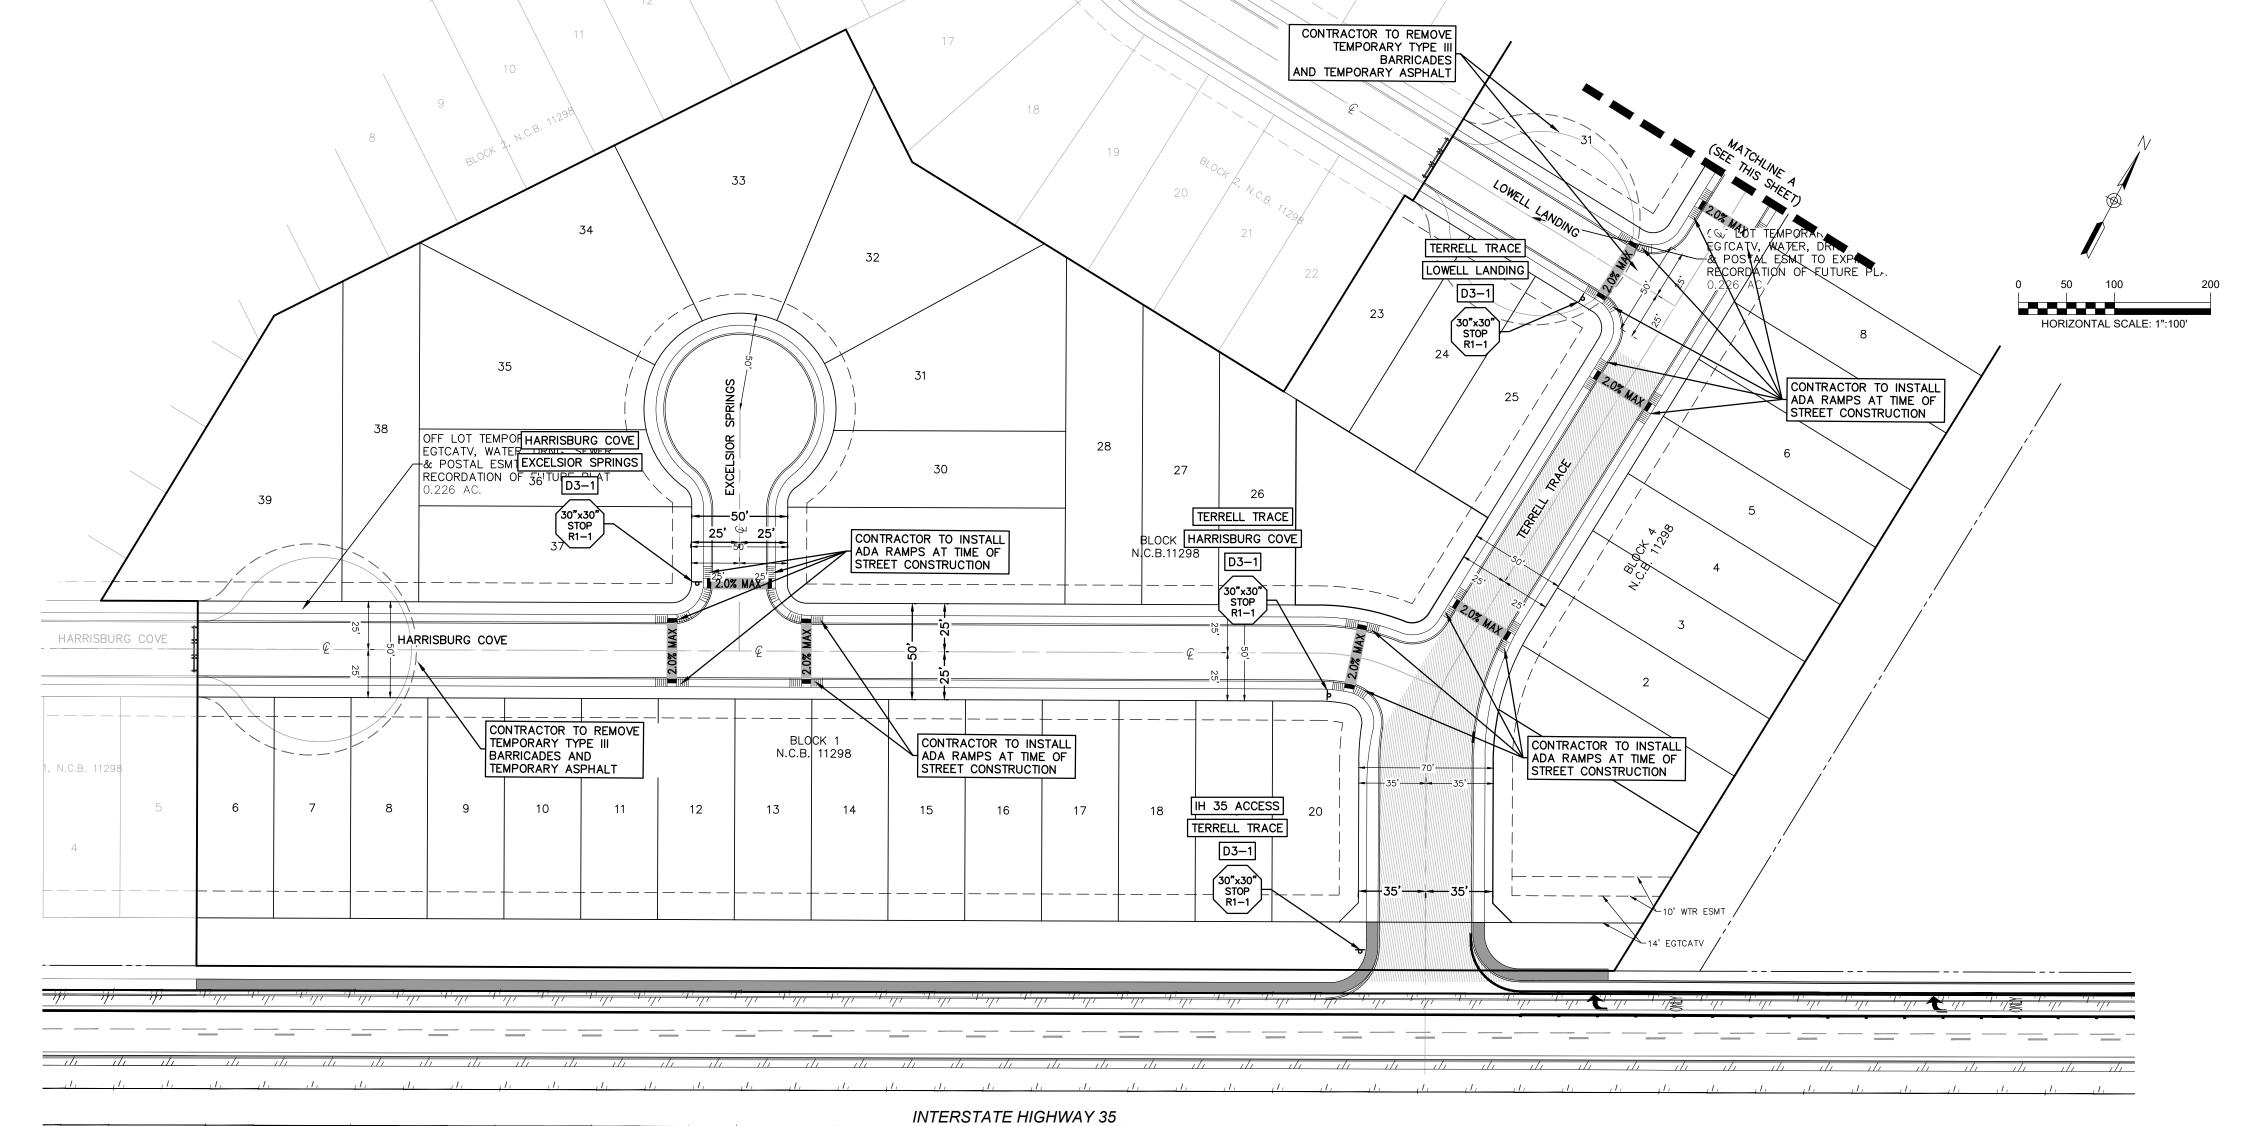
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DAMAGES WHICH MIGHT BE INCURRED BY THEIR FAILURE TO



TRENCH EXCAVATION SAFETY PROTECTION

CONTRACTOR AND/OR CONTRACTOR'S INDEPENDENTLY RETAINED EMPLOYEE OR STRUCTURAL

DESIGN/GEOTECHNICAL/SAFETY/EQUIPMENT CONSULTANT, IF ANY, SHALL REVIEW THESE PLANS AND AVAILABLE GEOTECHNICAL INFORMATION AND THE ANTICIPATED INSTALLATION SITE(S) WITHIN THE

PROJECT WORK AREA IN ORDER TO IMPLEMENT CONTRACTOR'S TRENCH EXCAVATION SAFETY

PROTECTION SYSTEMS, PROGRAMS AND/OR PROCEDURES FOR THE PROJECT DESCRIBED IN THE

CONTRACT DOCUMENTS. THE CONTRACTORS IMPLEMENTATION OF THESE SYSTEMS, PROGRAMS

AND/OR PROCEDURES SHALL PROVIDE FOR ADEQUATE TRENCH EXCAVATION SAFETY PROTECTION

THAT COMPLY WITH AS A MINIMUM, OSHA STANDARDS FOR TRENCH EXCAVATIONS. SPECIFICALLY, CONTRACTOR AND/OR CONTRACTOR'S INDEPENDENTLY RETAINED EMPLOYEE OR SAFETY CONSULTANT

SHALL IMPLEMENT A TRENCH SAFETY PROGRAM IN ACCORDANCE WITH OSHA STANDARDS GOVERNING

THE PRESENCE AND ACTIVITIES OF INDIVIDUALS WORKING IN AND AROUND TRENCH EXCAVATIONS.

THE LOCATION OF ALL EXISTING UNDERGROUND UTILITIES ARE

SHOWN IN APPROXIMATE LOCATIONS ONLY. THE CONTRACTOR

SHALL DETERMINE THE EXACT LOCATION OF ALL EXISTING

UTILITIES BEFORE COMMENCING WORK. THE CONTRACTOR WILL


AGREE TO BE FULLY RESPONSIBLE FOR ANY AND ALL

DAMAGES WHICH MIGHT BE INCURRED BY THEIR FAILURE TO EXACTLY LOCATE AND PRESERVE ANY AND ALL


UNDERGROUND UTILITIES, STRUCTURES OR FACILITIES.

LOCATION MAP

#### THIS IS NOT A CPS DESIGN. SEE CPS DESIGN PLAN FOR ACTUAL DETAILS

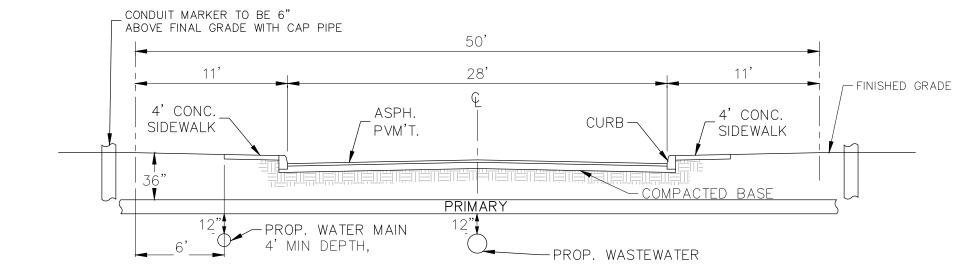

#### LAND-PLAT 22-11800345

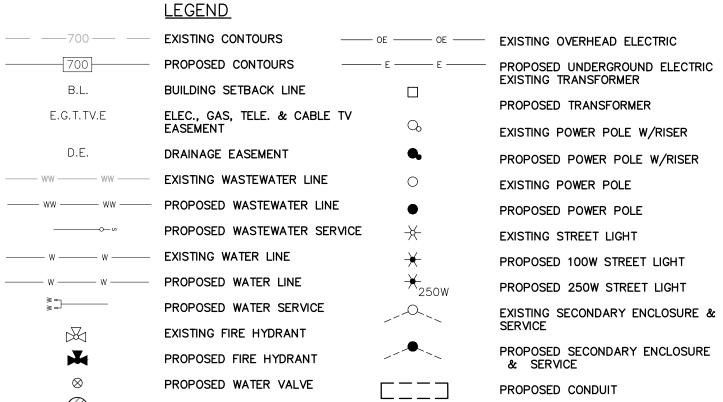

#### DRY UTILITY NOTES:

- 1. OVERALL UTILITY PLAIN IS PROVIDED AS A LOCATION REFERENCE FOR THE PURPOSE OF DRY UTILITY TRENCHING, CONDUIT PLACEMENT AND TRANSFORMER / ENCLOSURE PAD INSTALLATION. CONTRACTOR SHALL REFER TO APPROPRIATE UTILITY PROVIDER CONSTRUCTION PLANS FOR DRY UTILITY CONTRSUCTION.
- 2. TELEPHONE AND CABLE LINES GO IN JOINT TRENCH WITH CPS ENERGY.
- 3. CONDUITS WILL BE REQUIRED FOR CPS ENERGY UTILITY CROSSINGS WHEN STREET OR DRAIN CONSTRUCTION PRECEDES UTILITY INSTALLATION. CONDUIT FOR CROSSINGS AS FOLLOWS: ELECTRIC CROSSINGS - SCHEDULE 80 "GRAY" \*
- 4. CONDUITS WILL BE REQUIRED FOR UNDERGROUND TELEPHONE AND CABLE T.V. IF ABOVE APPLIES. CONDUIT FOR CROSSINGS AS FOLLOWS: PRIMARY - 4" SCHEDULE 40 "GRAY" \*\* SECONDARY - 4" SCHEDULE 40 "GRAY" \*\*
- \* CHANGES TO SCHEDULE AND COLOR MAY BE ALLOWED WITH CPS APPROVAL.
- ALLOWED WITH AT&T AND SPECTRUM APPROVAL.

REFER TO THE COVER SHEET FOR BENCHMARK INFORMATION.

THE LOCATION OF ALL EXISTING UNDERGROUND UTILITIES ARE SHOWN IN APPROXIMATE LOCATIONS ONLY. THE CONTRACTOR

SHALL DETERMINE THE EXACT LOCATION OF ALL EXISTING

#### PRIVATE CONDUIT NOTES:

1. CONTRACTOR TO COORDINATE WITH OWNER PRIOR TO CONSTRUCTION. 2. PRIVATE CONDUIT SHALL BE "WHITE" SCHEDULE 40 PVC CONDUIT WITH

ERIC S. PLY 123317

S. CASTEL BRAUNFE E FIRM F-1 S FIRM 10

03/28/2024

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GAS CROSSINGS - SCHEDULE 80 "GRAY" \*

5. DRY UTILITY CONDUIT TO EXTEND 2' OUTSIDE OF

\*\* CHANGES TO SCHEDULE AND COLOR MAY BE

90° SWEEPS TO 6" ABOVE GRADE WITH CAP PIPE.

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MARCH 2024


DRAWN BY: DESIGNED BY: MTA

REVIEWED BY: ESP HMT PROJECT NO .:


SHEET

337.060

UTILITIES BEFORE COMMENCING WORK. THE CONTRACTOR WILL AGREE TO BE FULLY RESPONSIBLE FOR ANY AND ALL DAMAGES WHICH MIGHT BE INCURRED BY THEIR FAILURE TO EXACTLY LOCATE AND PRESERVE ANY AND ALL UNDERGROUND UTILITIES, STRUCTURES OR FACILITIES. CONTRACTOR SHALL NOTIFY ENGINEER OF ANY DISCREPANCIES 24-HOURS PRIOR TO COMMENCING CONSTRUCTION.

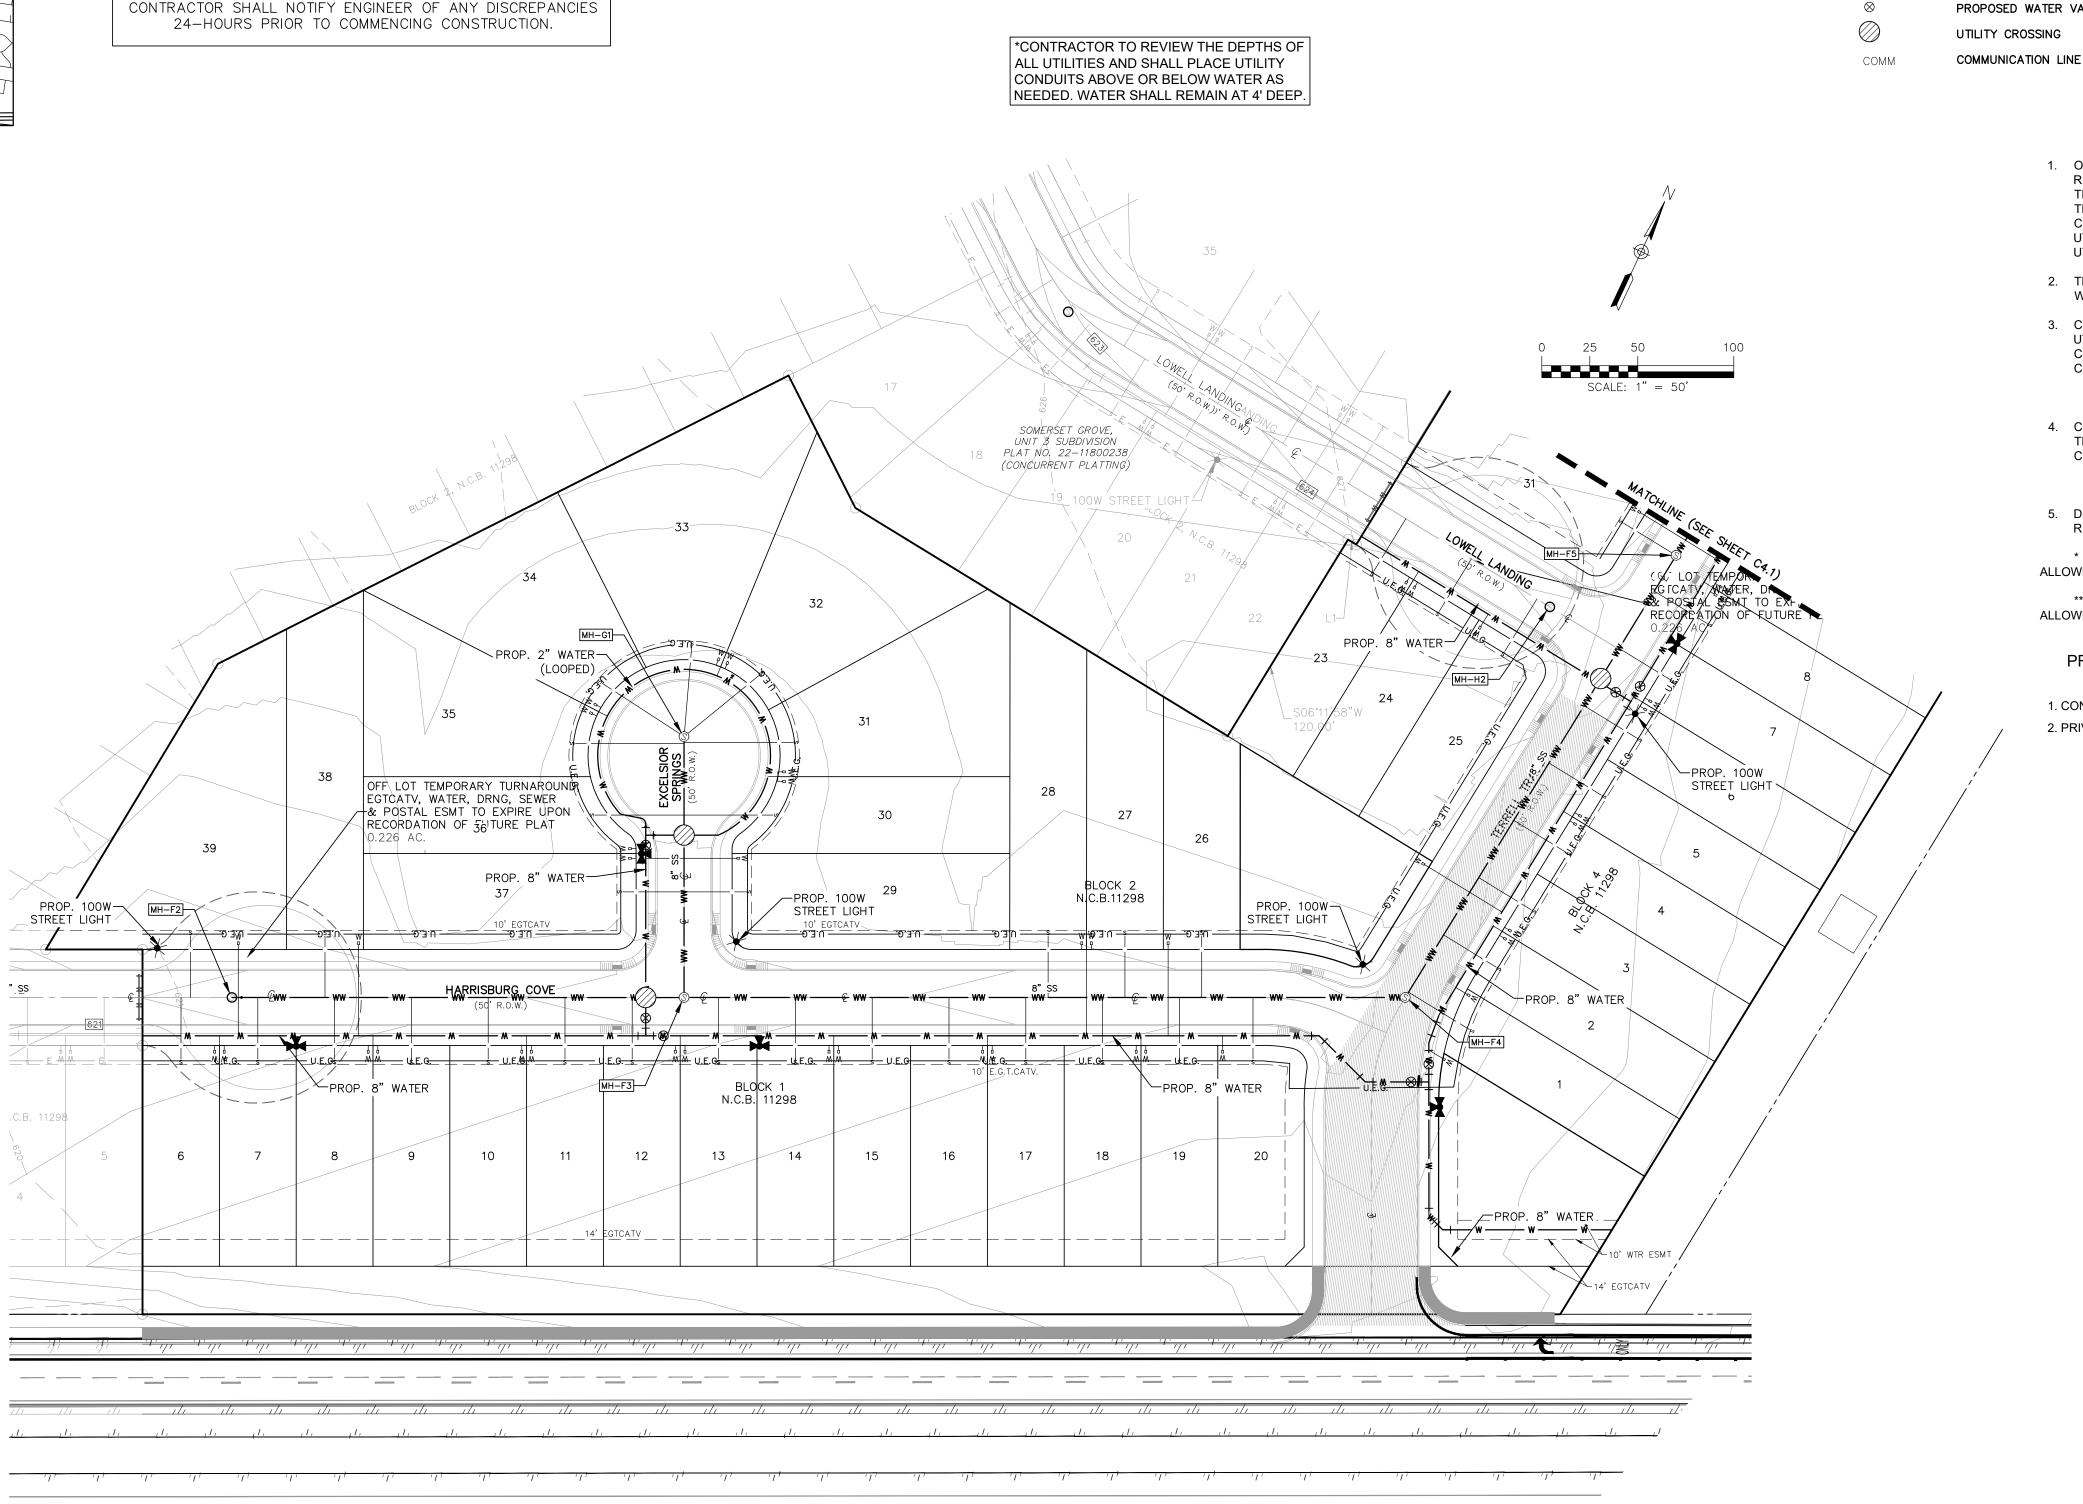


INTERSTATE HIGHWAY 35

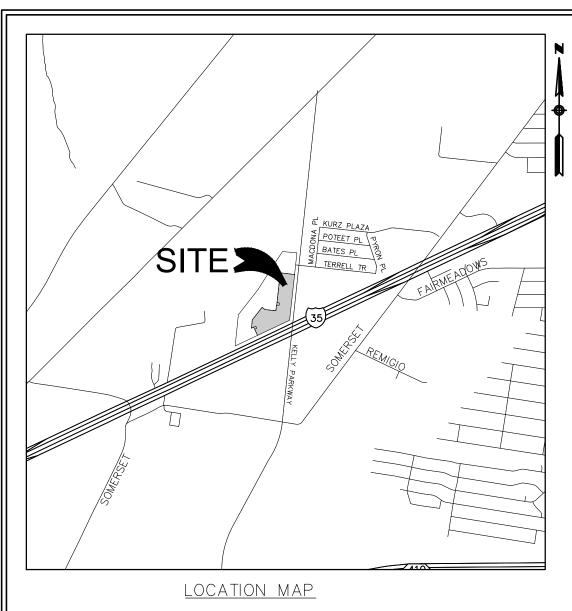

TRENCH EXCAVATION SAFETY PROTECTION CONTRACTOR AND/OR CONTRACTOR'S INDEPENDENTLY RETAINED EMPLOYEE OR STRUCTURAL DESIGN/GEOTECHNICAL/SAFETY/EQUIPMENT CONSULTANT, IF ANY, SHALL REVIEW THESE PLANS AND AVAILABLE GEOTECHNICAL INFORMATION AND THE ANTICIPATED INSTALLATION SITE(S) WITHIN THE PROJECT WORK AREA IN ORDER TO IMPLEMENT CONTRACTOR'S TRENCH EXCAVATION SAFETY PROTECTION SYSTEMS, PROGRAMS AND/OR PROCEDURES FOR THE PROJECT DESCRIBED IN THE CONTRACT DOCUMENTS. THE CONTRACTORS IMPLEMENTATION OF THESE SYSTEMS, PROGRAMS AND/OR PROCEDURES SHALL PROVIDE FOR ADEQUATE TRENCH EXCAVATION SAFETY PROTECTION THAT COMPLY WITH AS A MINIMUM, OSHA STANDARDS FOR TRENCH EXCAVATIONS. SPECIFICALLY, CONTRACTOR AND/OR CONTRACTOR'S INDEPENDENTLY RETAINED EMPLOYEE OR SAFETY CONSULTANT SHALL IMPLEMENT A TRENCH SAFETY PROGRAM IN ACCORDANCE WITH OSHA STANDARDS GOVERNING THE PRESENCE AND ACTIVITIES OF INDIVIDUALS WORKING IN AND AROUND TRENCH EXCAVATIONS.


> THE LOCATION OF ALL EXISTING UNDERGROUND UTILITIES ARE SHOWN IN APPROXIMATE LOCATIONS ONLY. THE CONTRACTOR SHALL DETERMINE THE EXACT LOCATION OF ALL EXISTING UTILITIES BEFORE COMMENCING WORK. THE CONTRACTOR WILL AGREE TO BE FULLY RESPONSIBLE FOR ANY AND ALL DAMAGES WHICH MIGHT BE INCURRED BY THEIR FAILURE TO EXACTLY LOCATE AND PRESERVE ANY AND ALL UNDERGROUND UTILITIES, STRUCTURES OR FACILITIES. CONTRACTOR SHALL NOTIFY ENGINEER OF ANY DISCREPANCIES 24-HOURS PRIOR TO COMMENCING CONSTRUCTION.

#### THIS IS NOT A CPS DESIGN. SEE CPS DESIGN PLAN FOR ACTUAL DETAILS

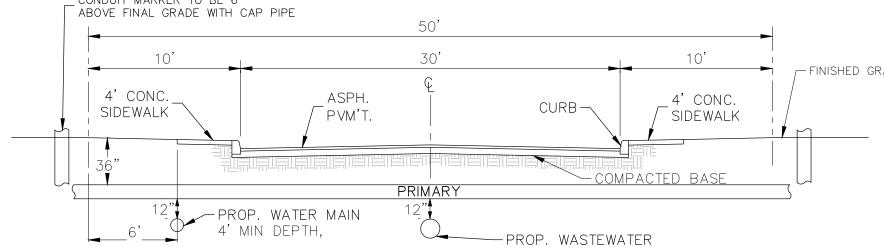

NEEDED. WATER SHALL REMAIN AT 4' DEEP.

SOMERSET GROVE, UNIT 3 SUBDIVISION PLAT NO. 22—11800238 (CONCURRENT PLATTING)

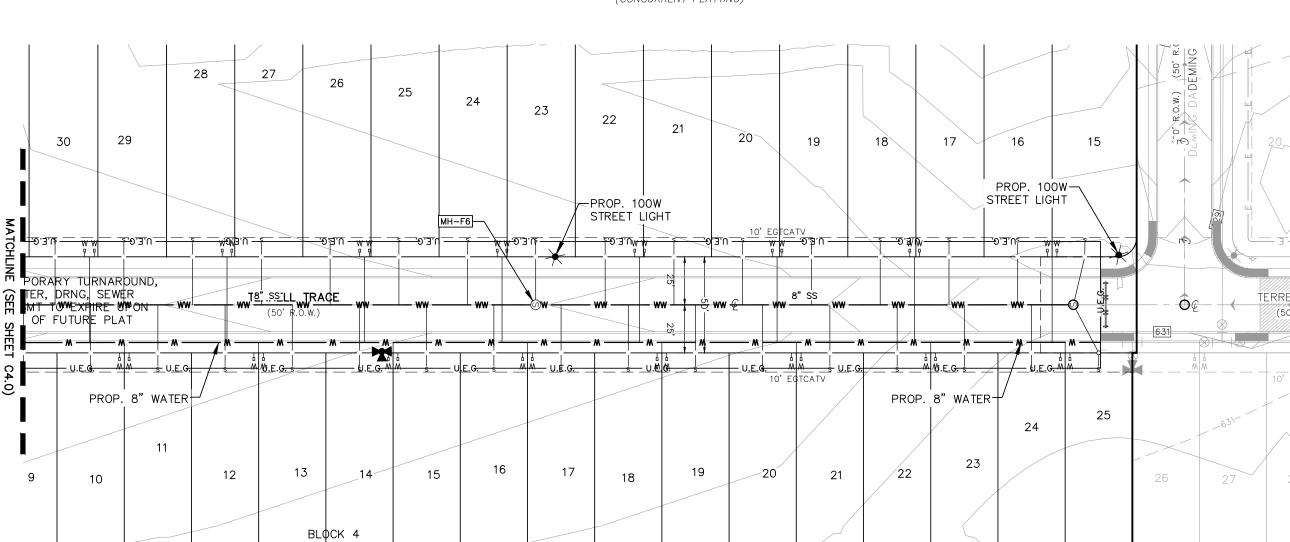

#### LAND-PLAT 22-11800345

<u>LEGEND</u> EXISTING CONTOURS ---- OE ----- EXISTING OVERHEAD ELECTRIC PROPOSED CONTOURS PROPOSED UNDERGROUND ELECTRIC EXISTING TRANSFORMER B.L. BUILDING SETBACK LINE PROPOSED TRANSFORMER ELEC., GAS, TELE. & CABLE TV E.G.T.TV.E EASEMENT EXISTING POWER POLE W/RISER D.E. DRAINAGE EASEMENT PROPOSED POWER POLE W/RISER EXISTING WASTEWATER LINE EXISTING POWER POLE ---- ww ----- PROPOSED WASTEWATER LINE PROPOSED POWER POLE PROPOSED WASTEWATER SERVICE EXISTING STREET LIGHT EXISTING WATER LINE \_\_\_\_\_ w \_\_\_\_ w \_\_\_\_ PROPOSED 100W STREET LIGHT PROPOSED WATER LINE \_\_\_\_\_ w \_\_\_\_ w \_\_\_\_ PROPOSED 250W STREET LIGHT PROPOSED WATER SERVICE EXISTING SECONDARY ENCLOSURE & SERVICE EXISTING FIRE HYDRANT PROPOSED SECONDARY ENCLOSURE PROPOSED FIRE HYDRANT & SERVICE PROPOSED WATER VALVE PROPOSED CONDUIT

#### DRY UTILITY NOTES:

UTILITY CROSSING

COMM

COMMUNICATION LINE

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290 S. CASTELL / NEW BRAUNFELS TBPE FIRM F-109 TBPLS FIRM 1053

ERIC S. PLY

123317

03/28/2024

YOU

DRAWN BY: REFER TO THE COVER SHEET

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CONTRACTOR SHALL NOTIFY ENGINEER OF ANY DISCREPANCIES 24-HOURS PRIOR TO COMMENCING CONSTRUCTION.

FOR BENCHMARK INFORMATION.

SHEET

DESIGNED BY: MTA

REVIEWED BY: ESP

HMT PROJECT NO .:

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MARCH 2024

CONDUIT MARKER TO BE 6" - FINISHED GRADE

> \*CONTRACTOR TO REVIEW THE DEPTHS OF ALL UTILITIES AND SHALL PLACE UTILITY CONDUITS ABOVE OR BELOW WATER AS

SCALE: 1" = 50