


GENERAL INFORMATION	
GENERAL NOTES	
1.	ALL CONSTRUCTION SHALL CONFORM TO THE CITY OF SAN ANTONIO STANDARD SPECIFICATIONS FOR CONSTRUCTION JUNE 2008, OR LATEST.
2.	NO EXTRA PAYMENT SHALL BE ALLOWED FOR WORK CALLED FOR ON THE PLANS, BUT NOT INCLUDED IN THE BID PROPOSAL. THIS INCIDENTAL WORK WILL BE REQUIRED AND SHALL BE INCLUDED IN THE PAY ITEM TO WHICH IT RELATES.
3.	THE CONTRACTOR SHALL PROVIDE ACCESS FOR THE DELIVERY OF MAIL BY THE U.S. POSTAL SERVICE. 4. THE CONTRACTOR SHALL BE RESPONSIBLE FOR RESTORING TO ITS ORIGINAL OR BETTER CONDITION ANY DAMAGE DONE TO EXISTING FENCES, CONCRETE ISLANDS, STREET PAVING, CURBS, SHRUBS, BUSHES OR DRIVEWAYS. (NO SEPARATE PAY ITEM).
4.	IT IS THE CONTRACTOR'S RESPONSIBILITY TO SEE THAT ALL SIGNS AND BARRICADES ARE PROPERLY INSTALLED AND MAINTAINED. ALL LOCATIONS AND DISTANCES WILL BE DECIDED UPON IN THE FIELD BY THE CONTRACTOR, USING THE "TEXAS MANUAL ON UNIFORM TRAFFIC CONTROL DEVICES". THE CITY'S CONSTRUCTION INSPECTOR AND TRAFFIC ENGINEERING REPRESENTATIVE WILL ONLY BE RESPONSIBLE TO INSPECT BARRICADES AND SIGNS. IF, IN THE OPINION OF THE TRAFFIC ENGINEERING REPRESENTATIVE AND THE CONSTRUCTION INSPECTOR, THE BARRICADES AND SIGNS DO NOT CONFORM TO ESTABLISHED STANDARDS OR ARE INCORRECTLY PLACED OR ARE INSUFFICIENT IN QUANTITY TO PROTECT THE GENERAL PUBLIC, THE CONSTRUCTION INSPECTOR SHALL HAVE THE OPTION TO STOP OPERATIONS UNTIL SUCH TIME AS THE CONDITIONS ARE CORRECTED.
5.	IF THE NEED ARISES, ADDITIONAL BARRICADES AND DIRECTIONAL DEVICES MAY BE ORDERED BY THE TRAFFIC ENGINEERING REPRESENTATIVE AT THE CONTRACTOR'S EXPENSE.
6.	DUE TO FEDERAL REGULATIONS TITLE 49, PART 192.171 C.P.S. MUST MAINTAIN ACCESS TO GAS VALVES AT ALL TIMES. THE CONTRACTOR MUST PROTECT AND WORK AROUND ANY GAS VALVES THAT ARE IN THE PROJECT AREA.
7.	CONTRACTOR SHALL NOTIFY THE CITY INSPECTOR TWENTY FOUR (24) HOURS PRIOR TO BACKFILL OF ANY UTILITY TRENCHES TO SCHEDULE FOR DENSITY TEST AS REQUIRED.
8.	CONTRACTOR SHALL PRESERVE ALL CONSTRUCTION STAKES, MARKS, ETC. IF ANY ARE DESTROYED OR REMOVED BY THE CONTRACTOR OR HIS EMPLOYEES, THEY SHALL BE REPLACED AT THE CONTRACTOR'S EXPENSE.
9.	CONTRACTOR SHALL NOTIFY ALL UTILITY COMPANIES PRIOR TO CONSTRUCTION TO DETERMINE THE LOCATION OF EXISTING UTILITIES. CONTRACTOR SHALL NOTIFY THE FOLLOWING AT LEAST FORTY-EIGHT (48) HOURS PRIOR TO EXCAVATION OPERATION: <div><div>SAN ANTONIO WATER SYSTEM (SAWS)</div><div>233-3010</div><div>BEXAR METROPOLITAN WATER DISTRICT (BEXAR MET)</div><div>354-6538 / 357-5741</div><div>COSA DRAINAGE</div><div>207-8048</div><div>COSA SIGNAL OPERATIONS</div><div>207-7720 / 207-7765</div><div>TEXAS STATE WIDE ONE CALL LOCATOR</div><div>1-800-344-8377</div><div>CITY PUBLIC SERVICE ENERGY - TIME WARNER - AT&T - MCI</div></div>
10.	THE EXISTENCE AND LOCATION OF UNDERGROUND UTILITIES INDICATED ON THE PLANS ARE TAKEN FROM AVAILABLE RECORDS AND ARE NOT GUARANTEED, BUT SHALL BE INVESTIGATED AND VERIFIED BY THE CONTRACTOR BEFORE STARTING WORK. THE CONTRACTOR SHALL BE HELD RESPONSIBLE FOR ANY DAMAGE TO AND FOR THE MAINTENANCE AND PROTECTION OF THE EXISTING UTILITIES EVEN IF THEY ARE NOT SHOWN ON THE PLANS. LOCATION AND DEPTH OF EXISTING UTILITIES SHOWN HERE ARE APPROXIMATE ONLY. ACTUAL LOCATIONS AND DEPTHS MUST BE VERIFIED BY THE CONTRACTOR PRIOR TO CONSTRUCTION AND HE SHALL BE RESPONSIBLE FOR PROTECTION OF SAME DURING CONSTRUCTION.
11.	ALL WASTE MATERIAL SHALL BECOME PROPERTY OF THE CONTRACTOR AND SHALL BE HIS SOLE RESPONSIBILITY TO DISPOSE OF THIS MATERIAL OFF THE LIMITS OF THE PROJECT. NO WASTE MATERIAL SHALL BE PLACED IN EXISTING LOWS THAT WILL BLOCK OR ALTER FLOW LIMITS OF EXISTING ARTIFICIAL OR NATURAL DRAINAGE.
12.	THE CONTRACTOR SHALL NOT PLACE ANY WASTE MATERIAL IN THE 100-YEAR FLOOD PLAIN WITHOUT FIRST OBTAINING AN APPROVED FLOOD PLAIN DEVELOPMENT PERMIT.
13.	THE CONTRACTOR SHALL MAINTAIN ALL ADJOINING STREETS AND TRAVELED ROUTES FREE FROM SPILLED AND / OR TRACKED CONSTRUCTION MATERIALS AND / OR DEBRIS.
14.	IF THE CONTRACTOR ENCOUNTERS ANY ARCHAEOLOGICAL DEPOSITS DURING CONSTRUCTION OPERATIONS, THE CONTRACTOR MUST STOP EXCAVATION IMMEDIATELY, CONTACT THE CITY INSPECTOR, AND CALL THE CITY HISTORIC PRESERVATION OFFICE AT 207-7306 OR 207-3327 FOR AN ARCHAEOLOGICAL INVESTIGATION. THE CONTRACTOR CANNOT BEGIN EXCAVATION AGAIN WITHOUT WRITTEN PERMISSION FROM THE CITY. IF MORE THAN THREE (3) DAYS ARE REQUIRED FOR INVESTIGATION AND WORKING HOLIDAY AND WEEKENDS) AND IF THE CONTRACTOR IS UNABLE TO WORK IN OTHER AREAS, THEN THE CONTRACTOR WILL BE ALLOWED TO NEGOTIATE FOR ADDITIONAL CONSTRUCTION TIME UPON WRITTEN REQUEST WITHIN TEN (10) DAYS AFTER THE FIRST NOTICE TO THE CITY OF ARCHAEOLOGICAL INVESTIGATION FOR EACH EVENT. IF THE TIME REQUIRED FOR INVESTIGATION IS LESS THAN OR EQUAL TO THREE (3) DAYS FOR EACH EVENT, CONTRACT DURATION WILL NOT BE EXTENDED.
15.	IF SUSPECTED CONTAMINATION IS ENCOUNTERED DURING CONSTRUCTION OPERATIONS, C.O.S.A. SHALL BE NOTIFIED IMMEDIATELY WHEN CONTAMINATED SOILS AND / OR GROUNDWATER ARE ENCOUNTERED AT LOCATIONS NOT IDENTIFIED IN THE PLANS. THE NOTIFICATION SHOULD INCLUDE THE STATION NUMBER, TYPE OF CONTAMINATED MEDIA, EVIDENCE OF CONTAMINATION AND MEASURES TAKEN TO CONTAIN THE CONTAMINATED MEDIA AND PREVENT PUBLIC ACCESS. THE CONTAMINATED SOIL AND / OR GROUNDWATER SHALL NOT BE REMOVED FROM THE LOCATION WITHOUT PRIOR C.O.S.A. APPROVAL. THE CONTRACTOR MUST STOP THE EXCAVATION IMMEDIATELY AND CONTACT THE C.O.S.A. INSPECTOR. THE CONTRACTOR CANNOT BEGIN EXCAVATION ACTIVITIES WITHOUT WRITTEN PERMISSION FROM THE CITY.
16.	CONTRACTOR IS TO INCLUDE A MAILBOX POST BLOCKOUT FOR VACANT LOTS AND ALL RESIDENCES WHICH DO NOT HAVE MAILBOXES AT THE CURB. BLOCKOUTS ARE PROVIDED FOR FUTURE USE BY THE POST OFFICE.
17.	CONTRACTOR SHALL NOT REMOVE OR ADJUST ANY VIA FACILITIES. THE CONTRACTOR MUST CONTACT VIA FOURTEEN DAYS PRIOR, THE REMOVAL OF BENCHES, STOP POLES OR ANY OTHER VIA FACILITIES THAT MAY BE PRESENT. PLEASE PROVIDE THIRTY DAYS PRIOR NOTICE FOR SHELTER REMOVAL (TELEPHONE NOS. (210) 362-2155 OR (210) 362-2096). THE CONTRACTOR WILL BE LIABLE FOR ANY DAMAGES TO VIA FACILITIES NOT REMOVED BY VIA. THE CONTRACTOR IS REQUIRED TO REMOVE OR DAMAGED IN THE COURSE OF EXECUTING THE CONTRACT UNLESS OTHERWISE NOTED BY VIA. THE CONTRACTOR WILL BE RESPONSIBLE FOR PROTECTING VIA FACILITIES IF ADJACENT TO WORK AREA.
TREE PROTECTION AND PRESERVATION GENERAL NOTES	
1.	NO UTILITY OR STREET EXCAVATION WORK SHALL BEGIN IN AREAS WHERE TREE PRESERVATION AND TREATMENT MEASURES HAVE NOT BEEN COMPLETED AND APPROVED.
2.	TREE PROTECTION FENCING SHALL BE REQUIRED. TREE PROTECTION FENCING SHALL BE INSTALLED, MAINTAINED AND REPAIRED BY THE CONTRACTOR DURING SITE CONSTRUCTION. DURING CONSTRUCTION ACTIVITY, AT LEAST A SIX-INCH LAYER OF COARSE MULCH SHALL BE PLACED AND MAINTAINED OVER THE ROOT PROTECTION ZONE (NO SEPARATE PAY ITEM).
3.	THE CONTRACTOR SHALL AVOID CUTTING ROOTS LARGER THAN ONE INCH IN DIAMETER WHEN EXCAVATING NEAR EXISTING TREES. EXCAVATION IN THE VICINITY OF TREES SHALL PROCEED WITH CAUTION. THE CONTRACTOR SHALL CONTACT THE CITY INSPECTOR FOR GUIDANCE.
4.	ROOTS WILL BE CUT WITH A ROCK SAW OR BY HAND, NOT BY AN EXCAVATOR OR OTHER ROAD CONSTRUCTION EQUIPMENT.
5.	ALL CURB AND SIDEWALK WORK SHALL USE ALTERNATIVE CONSTRUCTION METHODS TO MINIMIZE EXTENSIVE ROOT DAMAGE TO TREES (REFER TO DETAILS).
6.	EXPOSED ROOTS SHALL BE COVERED AT THE END OF THE DAY USING TECHNIQUES SUCH AS COVERING WITH SOIL, MULCH, OR WET BURLAP.
7.	NO EQUIPMENT, VEHICLES OR MATERIALS SHALL OPERATE OR BE STORED WITHIN THE ROOT PROTECTION ZONE OF ANY TREE NEAR THE PROJECT. ROOT PROTECTION ZONE IS 1 FOOT OF RADIUS PER INCH OF TREES DIAMETER. A 10-INCH DIAMETER TREE WOULD HAVE A 10 FOOT RADIUS ROOT PROTECTION ZONE AROUND THE TREE. ROOTS OR BRANCHES IN CONFLICT WITH THE CONSTRUCTION SHALL BE CUT CLEANLY ACCORDING TO PROPER PRUNING METHODS. OAK WOUNDS SHALL BE PAINTED OVER WITHIN 30 MINUTES TO PREVENT OAK WILT.
8.	SAPPLINGS, SHRUBS OR BUSHES TO BE CLEARED FROM THE PROTECTED ROOT ZONE AREA OF A LARGE TREE SHALL BE REMOVED BY HAND AS DESIGNATED BY THE INSPECTOR.
9.	NO WIRES, NAILS OR OTHER MATERIAL MAY BE ATTACHED TO PROTECTED TREES.
10.	TREES, TREE LIMBS, BUSHES AND SHRUBS LOCATED IN THE CITY STREET OR ALLEY RIGHT-OF-WAY OR PERMANENT EASEMENTS WHICH INTERFERE WITH PROPOSED CONSTRUCTION ACTIVITIES SHALL BE PROPERLY PRUNED FOLLOWING THE ANSI A-300 STANDARDS FOR PRUNING. ALL TREE PRUNING SHALL BE COMPLETED BY A CITY OF SAN ANTONIO TREE MAINTENANCE LICENSED CONTRACTOR (ARTICLE 21-171, CITY CODE) ONLY AFTER APPROVAL FROM THE CAPITAL PROJECTS MANAGEMENT THROUGH THE INSPECTOR.
11.	NO EXCESSIVE TREE TRIMMING WILL BE PERMITTED.
12.	ALL DEBRIS GENERATED BY THE PRUNING AND TRIMMING OF THE TREES AND / OR BUSHES SHALL BECOME THE PROPERTY OF THE CONTRACTOR AND SHALL BE DISPOSED OF PROPERLY (NO SEPARATE PAY ITEM).
13.	TREES MUST BE MAINTAINED IN GOOD HEALTH THROUGHOUT THE CONSTRUCTION PROCESS. MAINTENANCE MAY INCLUDE, BUT NOT LIMITED TO: WATERING THE ROOT PROTECTION ZONE, WASHING FOULAGE, FERTILIZATION, PRUNING, ADDITIONAL MULCH APPLICATIONS AND OTHER MAINTENANCE AS NEEDED ON THE PROJECT.
14.	ANY TREE REMOVAL SHALL BE APPROVED BY THE CITY ARBORIST. (207-0278).
15.	TREES WHICH ARE DAMAGED OR LOST DUE TO THE CONTRACTOR'S NEGLIGENCE DURING CONSTRUCTION SHALL BE MITIGATED TO THE CITY'S SATISFACTION.
16.	TREE PLANTING FOR MITIGATION OR ENHANCEMENT: ALL PLANTED TREES SHALL BE MAINTAINED IN A HEALTHY CONDITION AT ALL TIMES. THIS INCLUDES IRRIGATION, FERTILIZING, PRUNING AND OTHER MAINTENANCE AS NEEDED ON THE PROJECT. TREES THAT DIE WITHIN TWELVE (12) MONTHS SHALL BE REPLACED WITH A TREE OF EQUAL SIZE AND SPECIES.
ACCESSIBILITY REQUIREMENTS	
1.	THE CONTRACTOR SHALL PROVIDE AND MAINTAIN VEHICULAR AND PEDESTRIAN ACCESS AT ALL TIMES TO LOCAL RESIDENCES AND BUSINESSES.
2.	WHEN THE WORK REQUIRES THE EXCAVATION OF THE STREET AND THE REMOVAL OF THE EXISTING DRIVEWAY APPROACHES AND SIDEWALKS, THE CONTRACTOR SHALL BE RESPONSIBLE FOR PROVIDING TEMPORARY ALL-WEATHER ACCESS TO THE BUSINESSES AND RESIDENCES. THE TEMPORARY DRIVEWAY APPROACHES SHALL BE CONSTRUCTED WITH FLEXIBLE BASE OR GRAVEL MATERIAL AT NO SEPARATE COST TO THE CITY.
3.	PRIOR TO INITIATING THE CONSTRUCTION OF NEW DRIVEWAY APPROACHES, THE CONTRACTOR SHALL GIVE ADVANCE WARNING IN PERSON, OR IN WRITING, OF AT LEAST 48 HOURS TO EACH RESIDENCE THAT WILL BE IMMEDIATELY AFFECTED, SO THAT ALTERNATE PLANS MAY BE MADE BY THE RESIDENTS.
4.	FOR BUSINESSES WITH MORE THAN ONE DRIVEWAY AT LEAST ONE DRIVEWAY SHALL REMAIN OPEN WHILE THE OTHER NEW DRIVEWAY APPROACHES ARE BEING CONSTRUCTED. FOR RESIDENCES WITH ONLY ONE DRIVEWAY, THE NEW DRIVEWAY APPROACH SHALL BE CONSTRUCTED IN HALF WIDTHS, UNLESS A TEMPORARY ASPHALT DRIVEWAY IS FIRST INSTALLED AT NO SEPARATE COST TO THE CITY.

SOUTHEAST MEADOWS UNIT 3

BEXAR COUNTY, TX

STREET, DRAINAGE, WATER, SANITARY SEWER, AND UTILITY IMPROVEMENTS

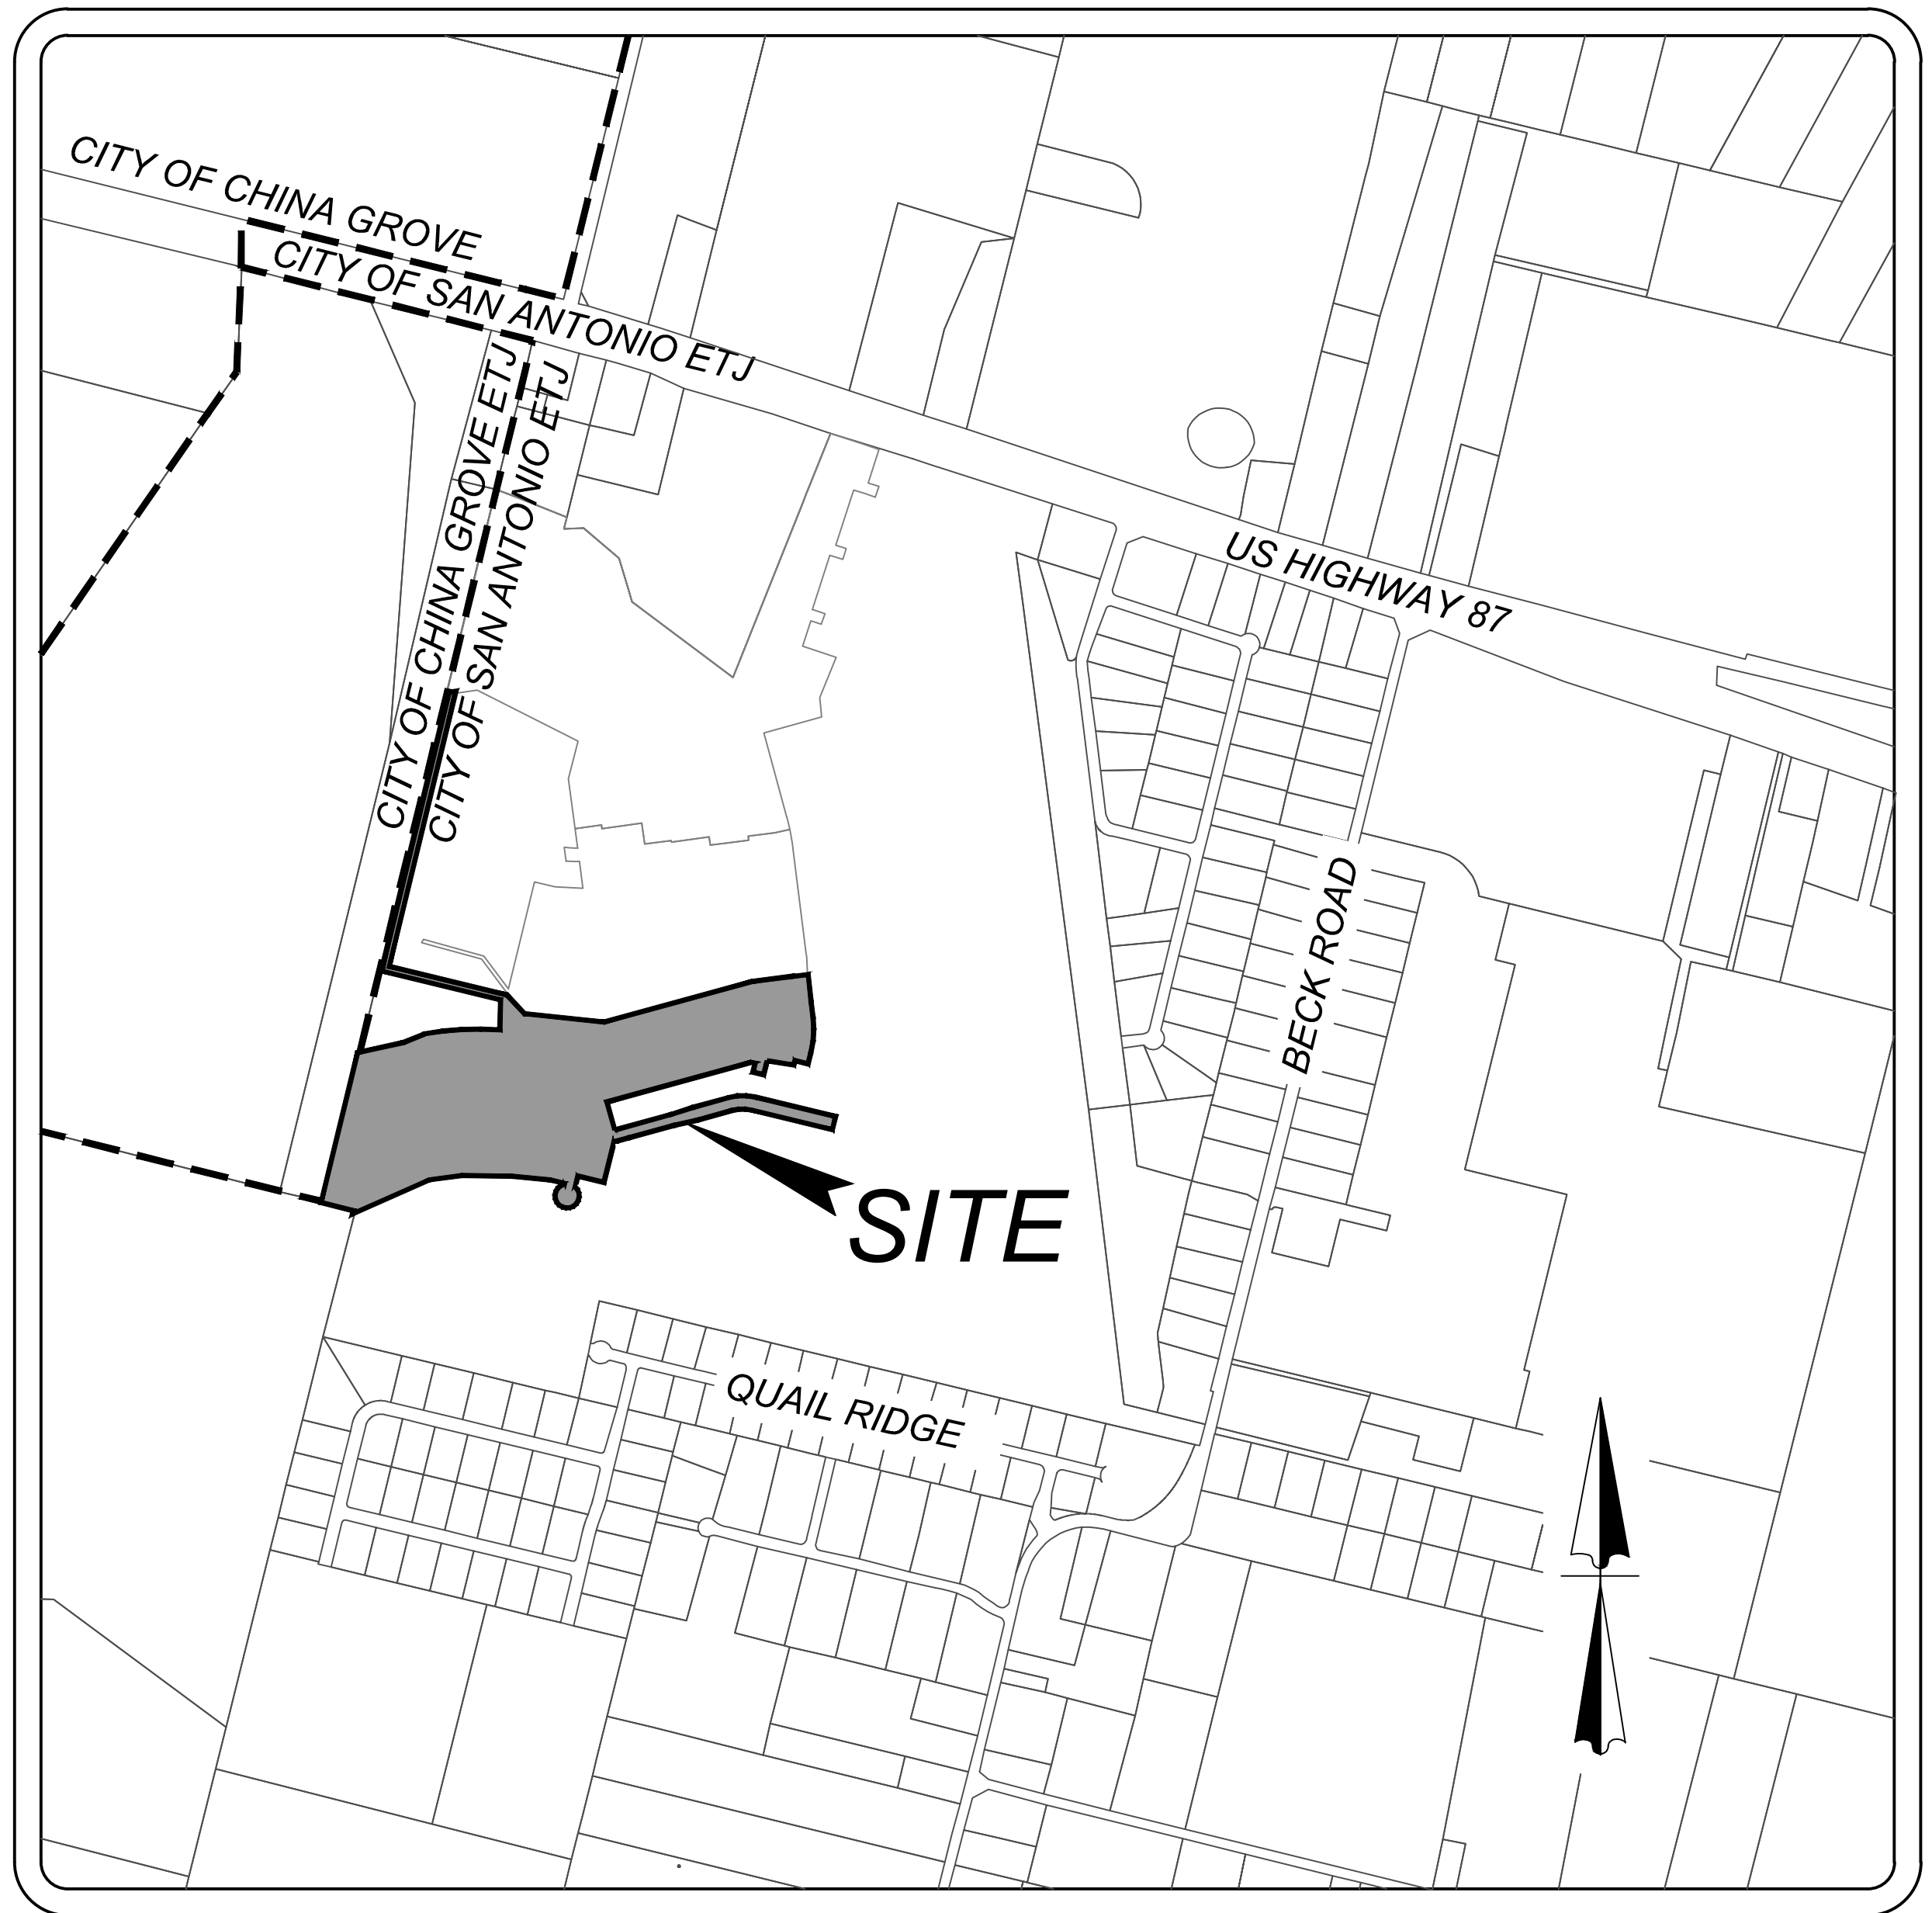

LOCATION MAP

NOT-TO-SCALE

OWNER/DEVELOPER
MEH HOLDING COMPANY LTD
5210 THOUSAND OAKS, SUITE 1318
SAN ANTONIO, TX 78233


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<div>PRELIMINARY</div> <div>FOR</div> <div>SOUTHEAST MEADOWS UNIT 3</div> <div>PLAT# 23-11800440</div> <div>SAN ANTONIO BEXAR COUNTY TEXAS</div> <div>Colliers</div> <div>Engineering & Design</div> <div>SAN ANTONIO (KFW) 3421 Paesanos Parkway San Antonio, TX 78231 Phone: 210.979.8444 COLLIERS ENGINEERING & DESIGN, INC. TBP&S Form# 1-1409 TBP&S Form# 10194550</div> <div>SCALE: AS SHOWN DATE: 07/20/2023 DRAWN BY: SD CHECKED BY: SC</div> <div>PROJECT NUMBER: 205-43-07 DRAWING NAME: CV2054307</div> <div>SHEET TITLE: COVER SHEET</div> <div>SHEET NUMBER: 0.0</div>	

NOTE: DO NOT SCALE DRAWINGS FOR CONSTRUCTION.

TRENCH EXCAVATION SAFETY PROTECTION
CONTRACTOR AND/OR CONTRACTOR'S INDEPENDENTLY RETAINED EMPLOYEE OR STRUCTURAL DESIGN/GEOTECHNICAL/SAFETY/EQUIPMENT CONSULTANT, IF ANY, SHALL REVIEW THESE PLANS AND ANY AVAILABLE GEOTECHNICAL INFORMATION AND THE ANTICIPATED INSTALLATION SITES WITHIN THE PROJECT WORK AREA IN ORDER TO IMPLEMENT CONTRACTOR'S TRENCH EXCAVATION SAFETY PROTECTION SYSTEMS, PROGRAMS AND/OR PROCEDURES FOR THE PROJECT DESCRIBED IN THE CONTRACT DOCUMENTS. THE CONTRACTOR'S IMPLEMENTATION OF THESE SYSTEMS, PROGRAMS AND/OR PROCEDURES SHALL PROVIDE FOR ADEQUATE TRENCH EXCAVATION SAFETY PROTECTION THAT COMPLY WITH AS A MINIMUM, OSHA STANDARDS FOR TRENCH EXCAVATIONS. SPECIFICALLY, CONTRACTOR AND/OR CONTRACTOR'S INDEPENDENTLY RETAINED EMPLOYEE OR SAFETY CONSULTANT SHALL IMPLEMENT A TRENCH SAFETY PROGRAM IN ACCORDANCE WITH OSHA STANDARDS GOVERNING THE PRESENCE AND ACTIVITIES OF INDIVIDUALS WORKING IN AND AROUND TRENCH EXCAVATION.

COMPACTION NOTE:
THE CONTRACTOR SHALL BE RESPONSIBLE FOR MEETING 98% COMPACTION ON ALL TRENCH BACKFILL AND PAYING FOR THE TESTS TO BE PERFORMED BY A THIRD PARTY. COMPACTION TESTS WILL BE DONE AT ONE LOCATION POINT RANDOMLY SELECTED OR AS INDICATED BY THE SAWS INSPECTOR/TEST ADMINISTRATOR, PER EACH 12 INCH LOOSE LIFT PER 400 LINEAR FEET AT A MINIMUM. PERMITS AND/OR WILL NOT BE ACCEPTED AND FINALIZED BY SAWS WITHOUT THIS REQUIREMENT BEING MET AND VERIFIED BY PROVIDING ALL NECESSARY DOCUMENTED TEST RESULTS.



DRY UTILITY CONDUIT NOTE:
CONDUIT LOCATIONS SHOWN ON PLAN ARE FOR GEOGRAPHICAL PURPOSES ONLY AND ARE APPROXIMATE. CONTRACTOR TO INSTALL PROPOSED CONDUITS IN ACCORDANCE WITH DRY UTILITY PURVEYOR'S SPECIFICATIONS. CONTRACTOR TO VERIFY THE CONDUIT LOCATIONS AND SIZES BASED ON THE DRY UTILITY PURVEYOR'S PLAN.

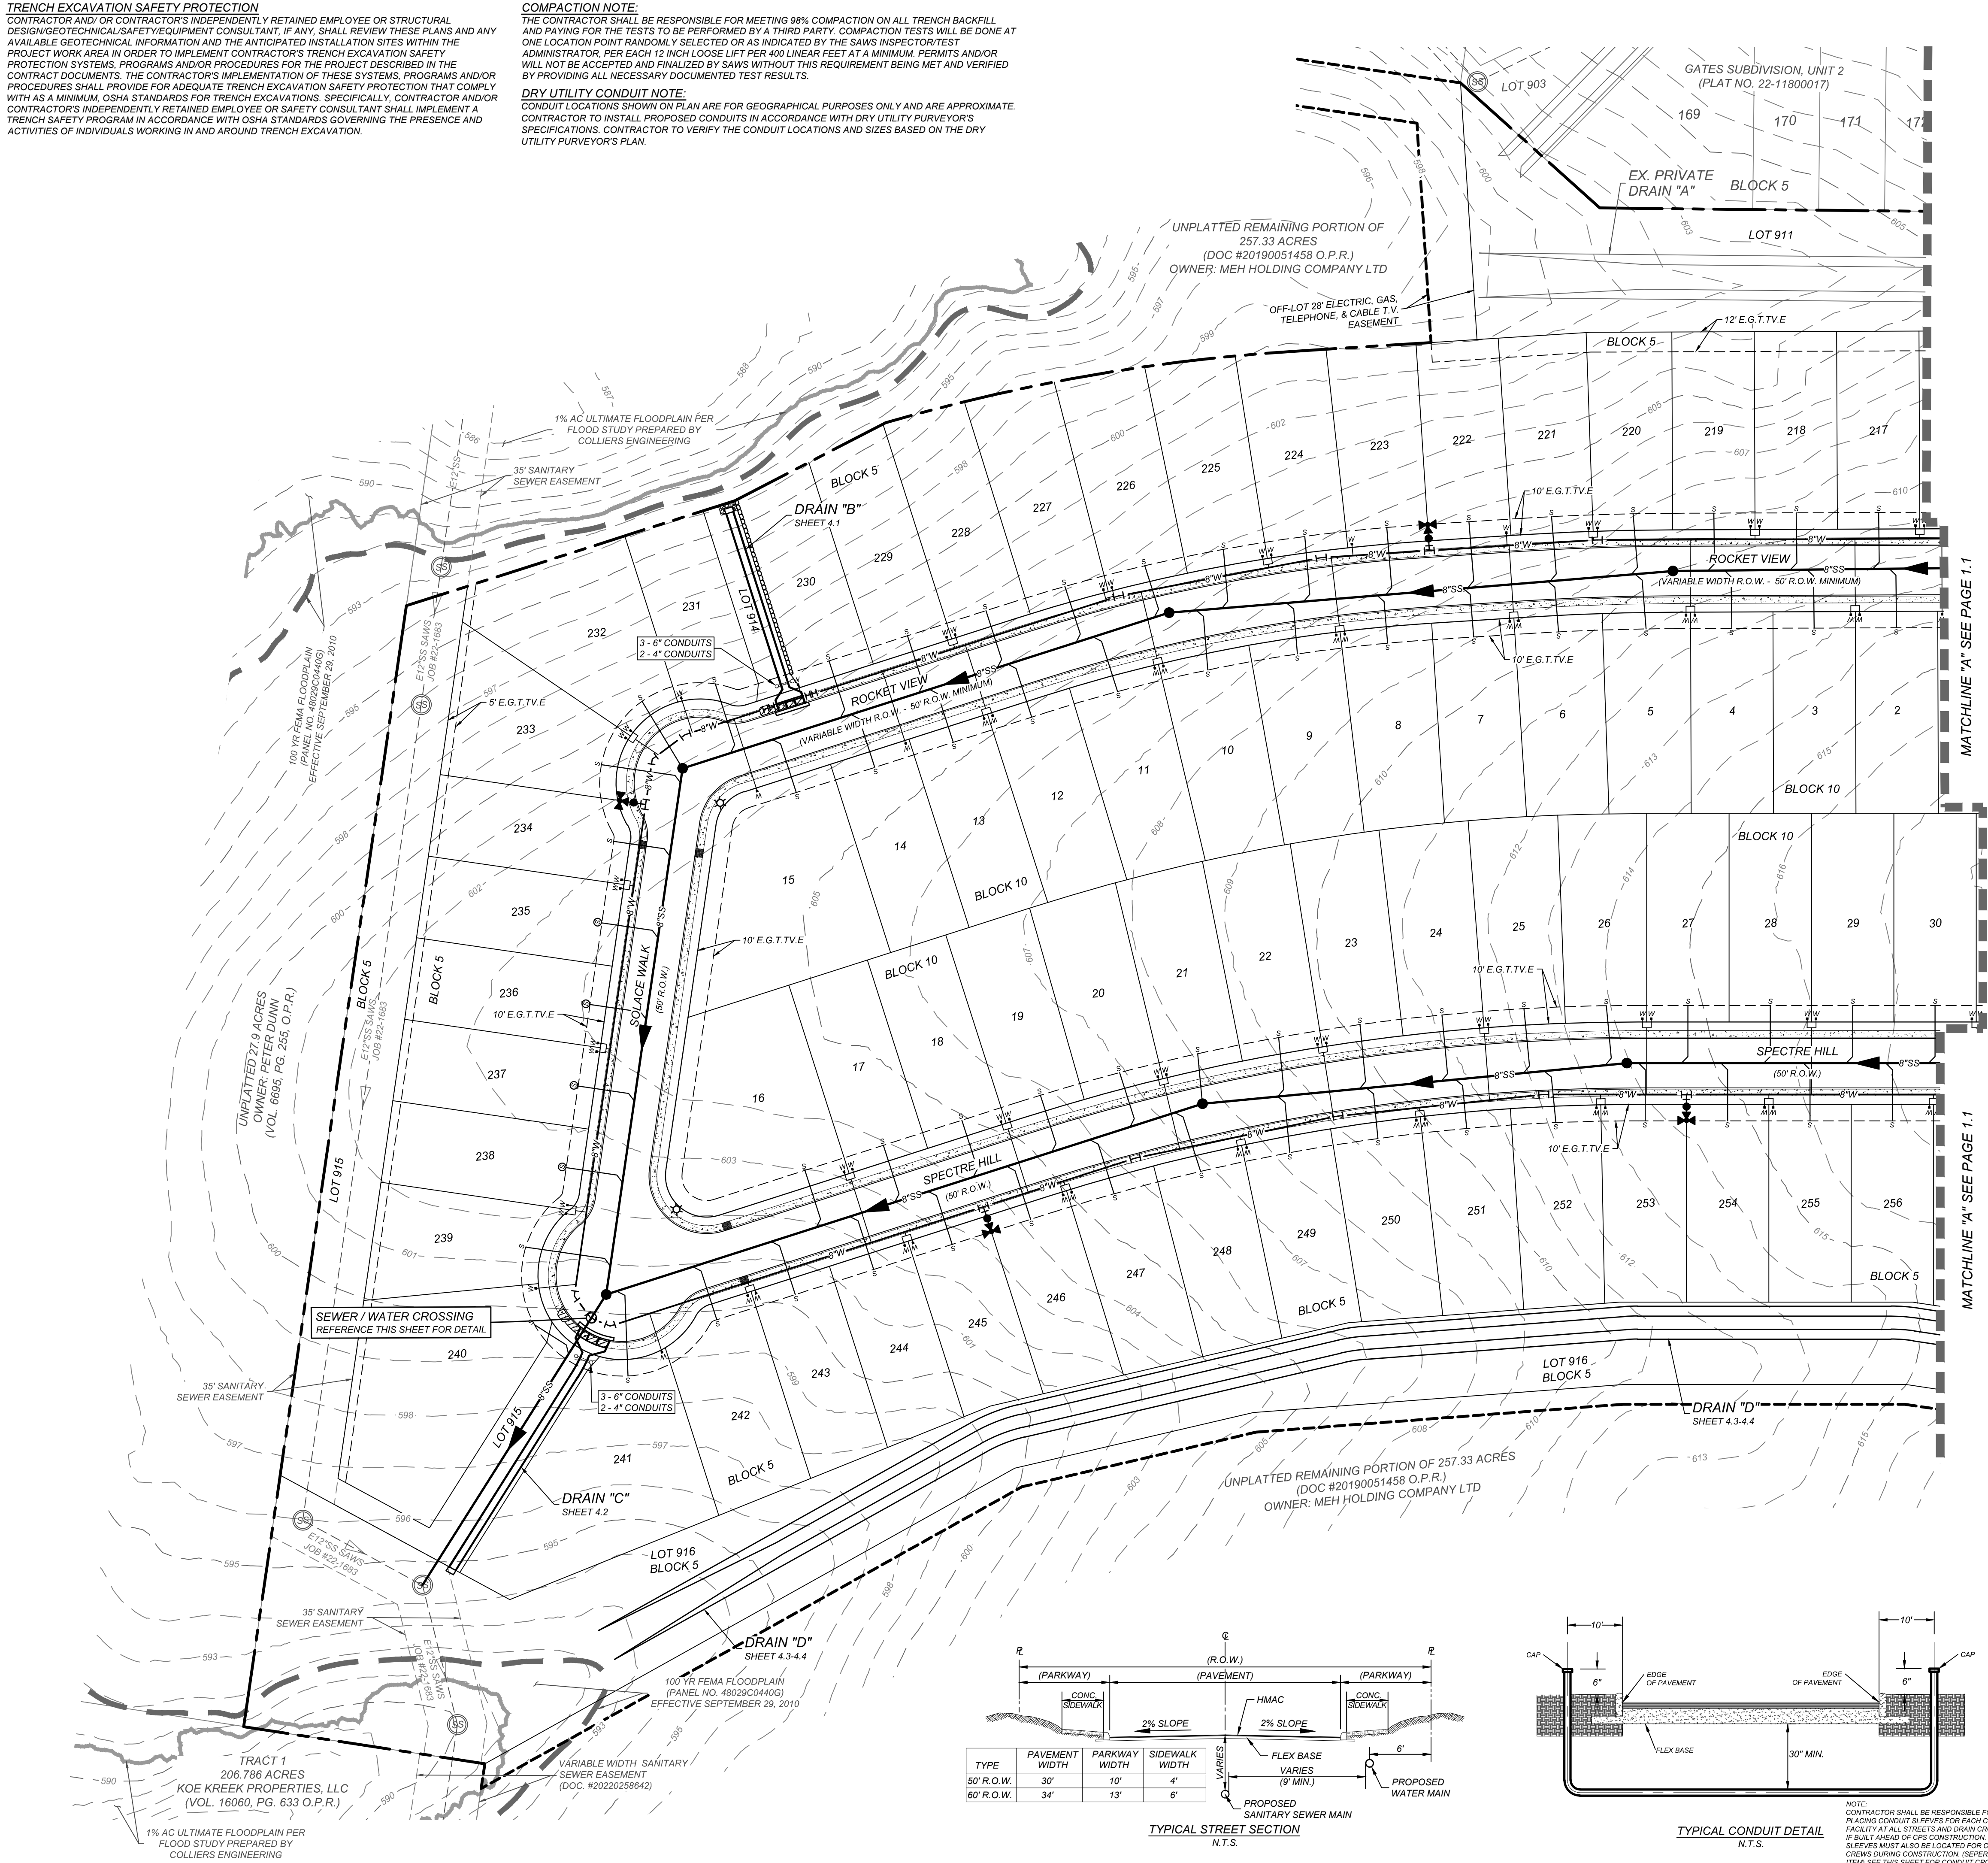


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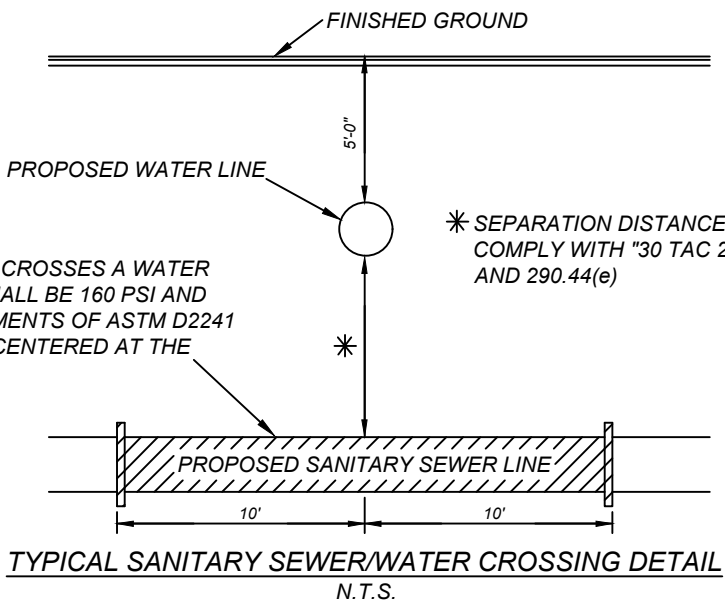
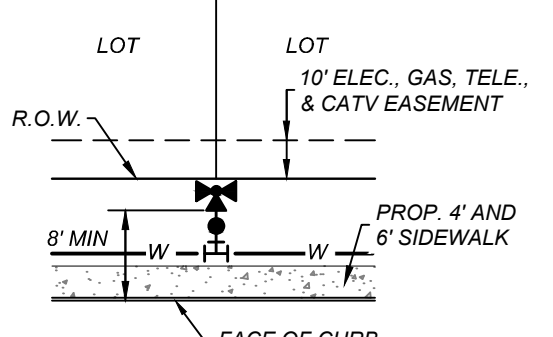


LOCATION MAP
NOT-TO-SCALE

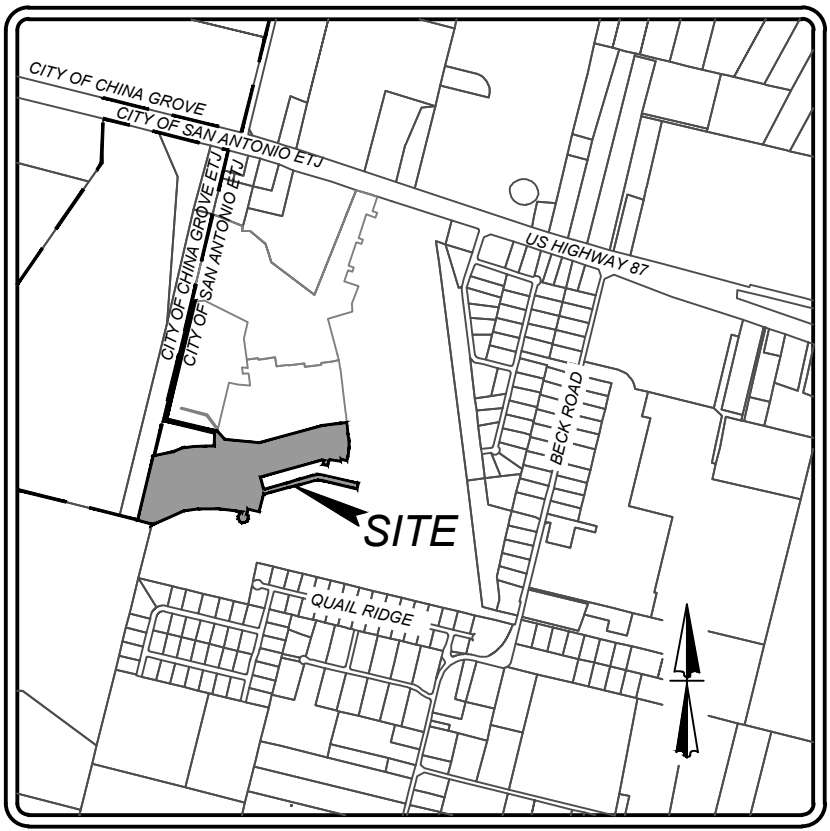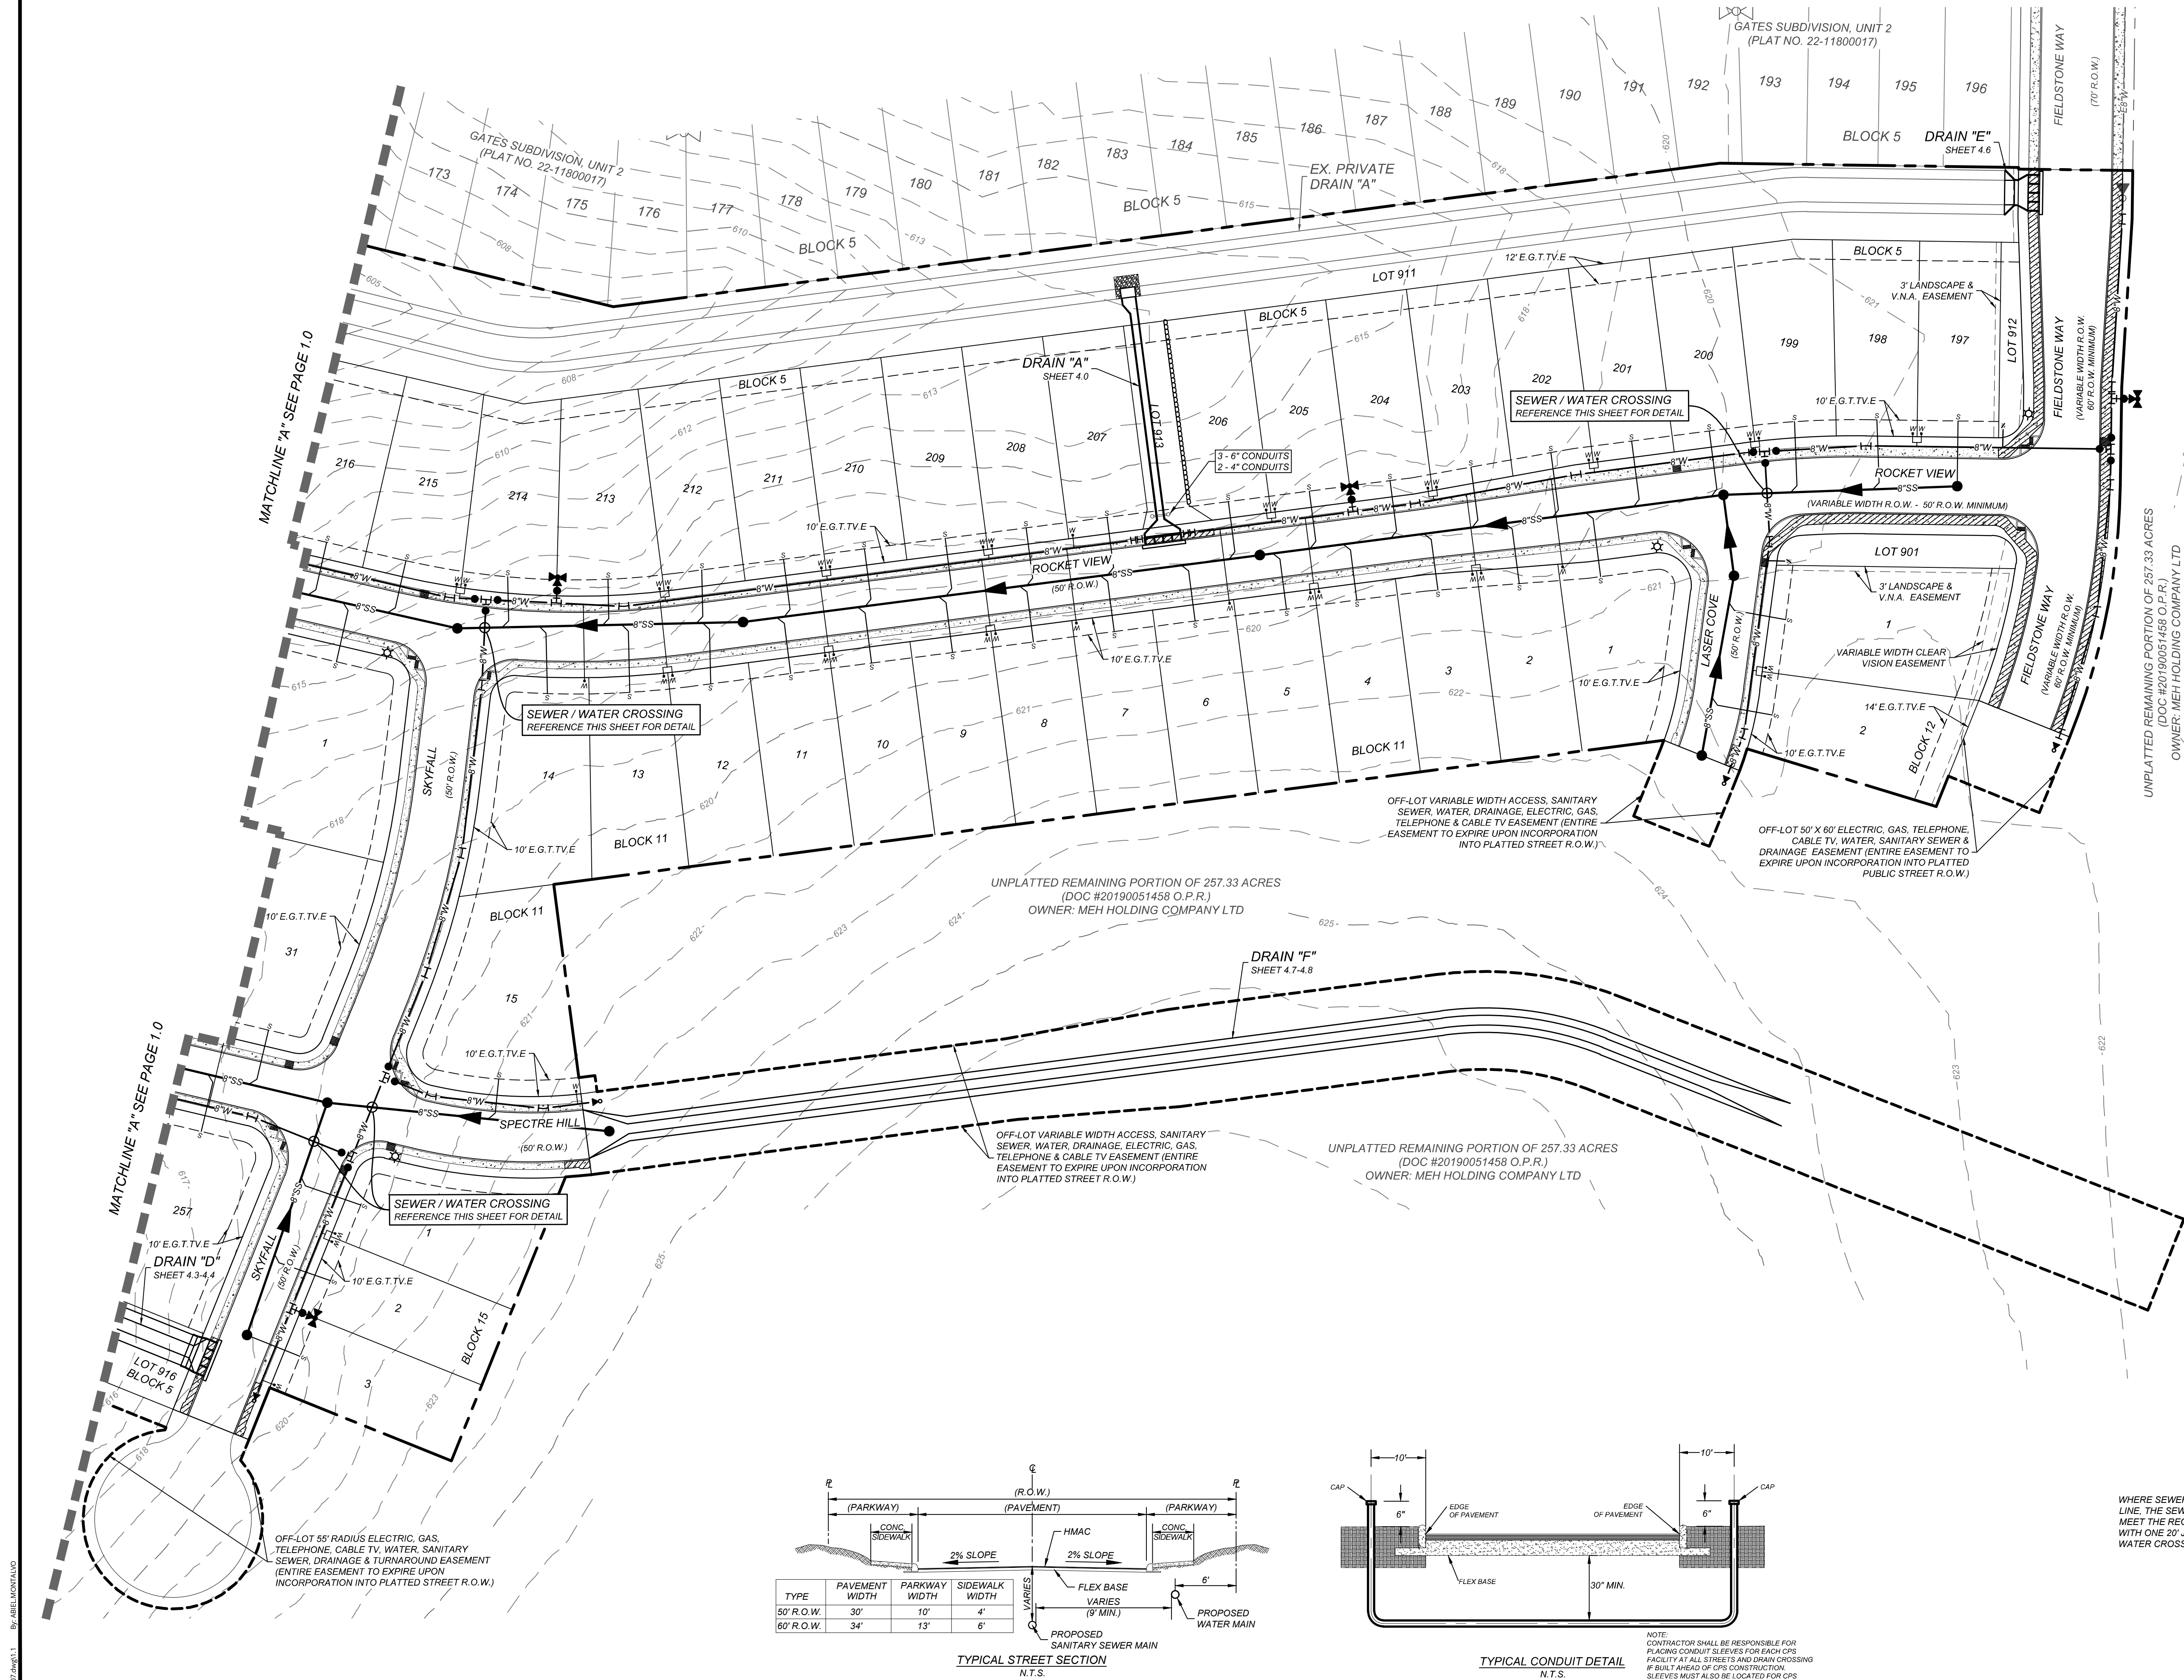



LEGEND

- PROPOSED WATER MAIN
- PROPOSED WATER SERVICE & METER BOX
- PROPOSED WATER 3/4" IRRIGATION SERVICE & METER BOX
- PROPOSED FIRE HYDRANT
- PROPOSED WATER VALVE
- PROPOSED 100 WATT STREETLIGHT
- PROPOSED 250 WATT STREETLIGHT
- PROPOSED SANITARY SEWER MAIN
- PROPOSED SANITARY SEWER MANHOLE
- PROPOSED SANITARY SEWER LATERAL
- PROPOSED ELECTRIC, GAS, TELEPHONE, & CABLE TV EASEMENT
- VEHICULAR NON-ACCESS EASEMENT
- EXISTING WATER MAIN
- EXISTING FIRE HYDRANT
- EXISTING WATER VALVE
- EXISTING SANITARY SEWER MAIN
- EXISTING SANITARY SEWER MANHOLE
- EXISTING OVERHEAD ELECTRIC W/POWER POLE
- EXISTING GUY WIRE/OVERHEAD ELECTRIC
- EXISTING 100 WATT STREET LIGHT
- EXISTING 250 WATT STREET LIGHT

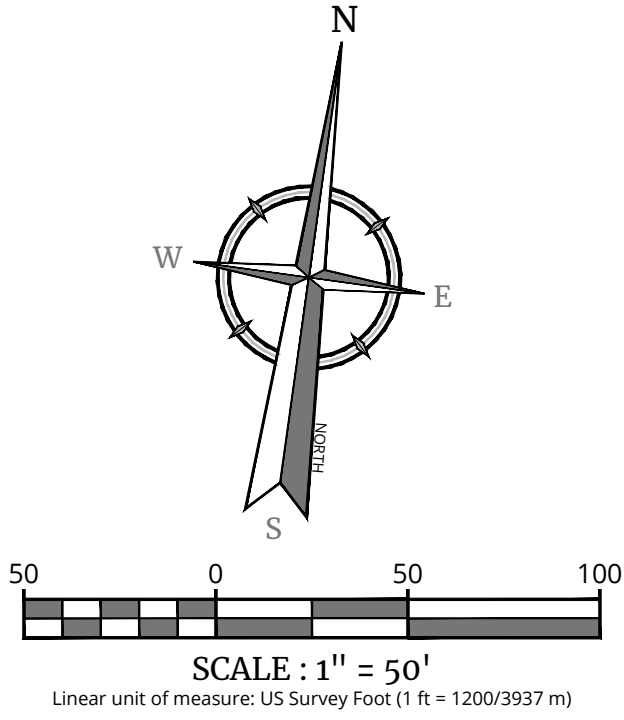

WHERE SEWER PIPE CROSSES A WATER LINE, THE SEWER SHALL BE 180 PSI AND MEET THE REQUIREMENTS OF ASTM D2241 WITH ONE 20" JOINT CENTERED AT THE WATER CROSSING.

* SEPARATION DISTANCE TO COMPLY WITH "30 TAC 217.53(d) AND 290.44(b)

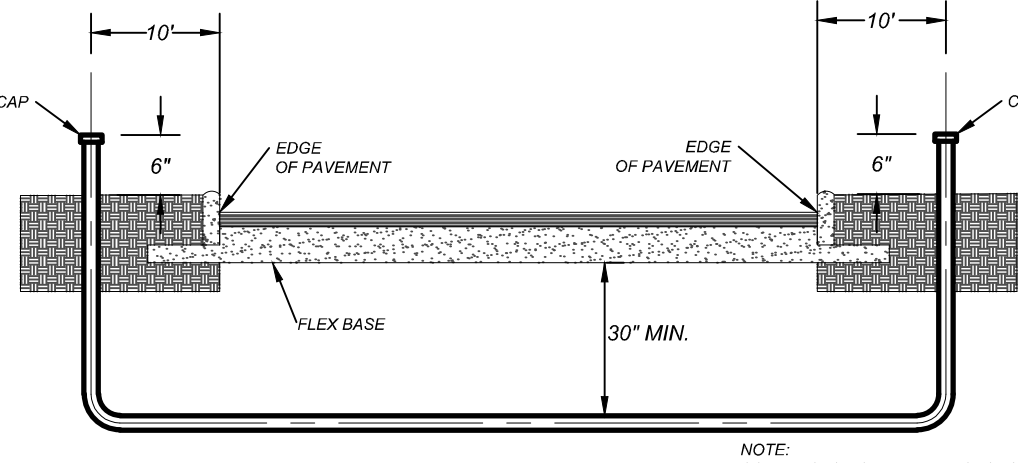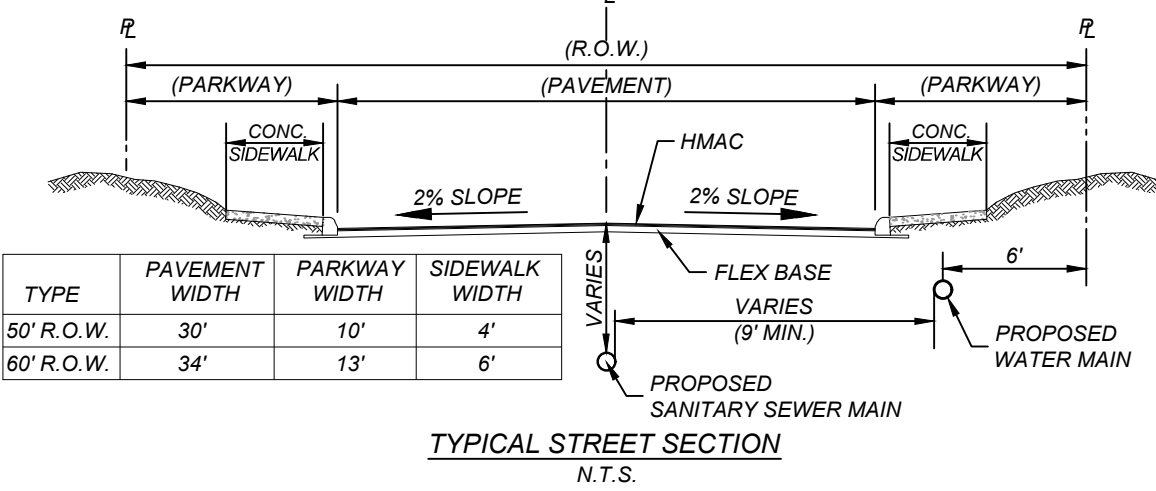

NOTE: CONTRACTOR SHALL BE RESPONSIBLE FOR PLACING CONDUIT SLEEVES FOR EACH CFS FACILITY AT ALL STREETS AND DRAIN CROSSING IF BUILT AHEAD OF CFS CONSTRUCTION. SLEEVES MUST ALSO BE LOCATED FOR CFS CREWS DURING CONSTRUCTION. (SEPARATE ITEM) SEE THIS SHEET FOR CONDUIT CROSSING DETAIL AND SCHEDULE.

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Formerly Known as **KFW**

811

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STATE OF TEXAS

JEFFREY W. MARTIN

139094

PROFESSIONAL ENGINEER

4/17/24

PRELIMINARY

FOR

SOUTHEAST

MEADOWS UNIT 3

PLAT# 23-11800440

SAN ANTONIO
BEXAR COUNTY
TEXAS

Colliers

Engineering & Design

SAN ANTONIO (KFW)
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COLLIERS ENGINEERING & DESIGN, INC.
TBP'S Form # 1-1409
TBP'S Form # 10194550



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AS SHOWN	07/20/2023	SD	SC

PROJECT NUMBER:	DRAWING NUMBER:
205-43-07	0102054307

SHEET TITLE: OVERALL UTILITY PLAN

SHEET NUMBER: 1.1

NOTE: DO NOT SCALE DRAWINGS FOR CONSTRUCTION.

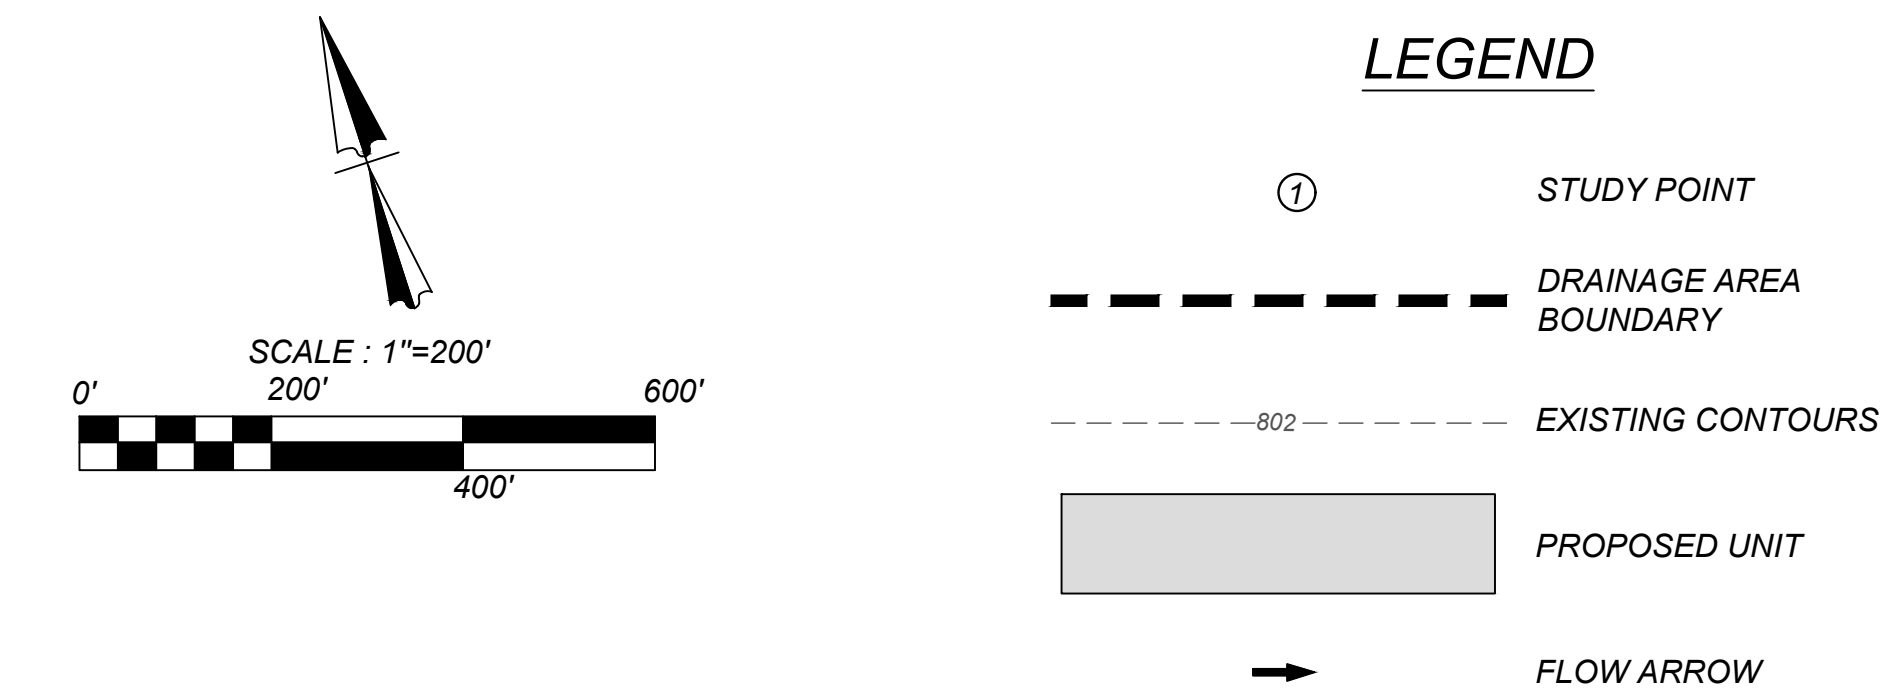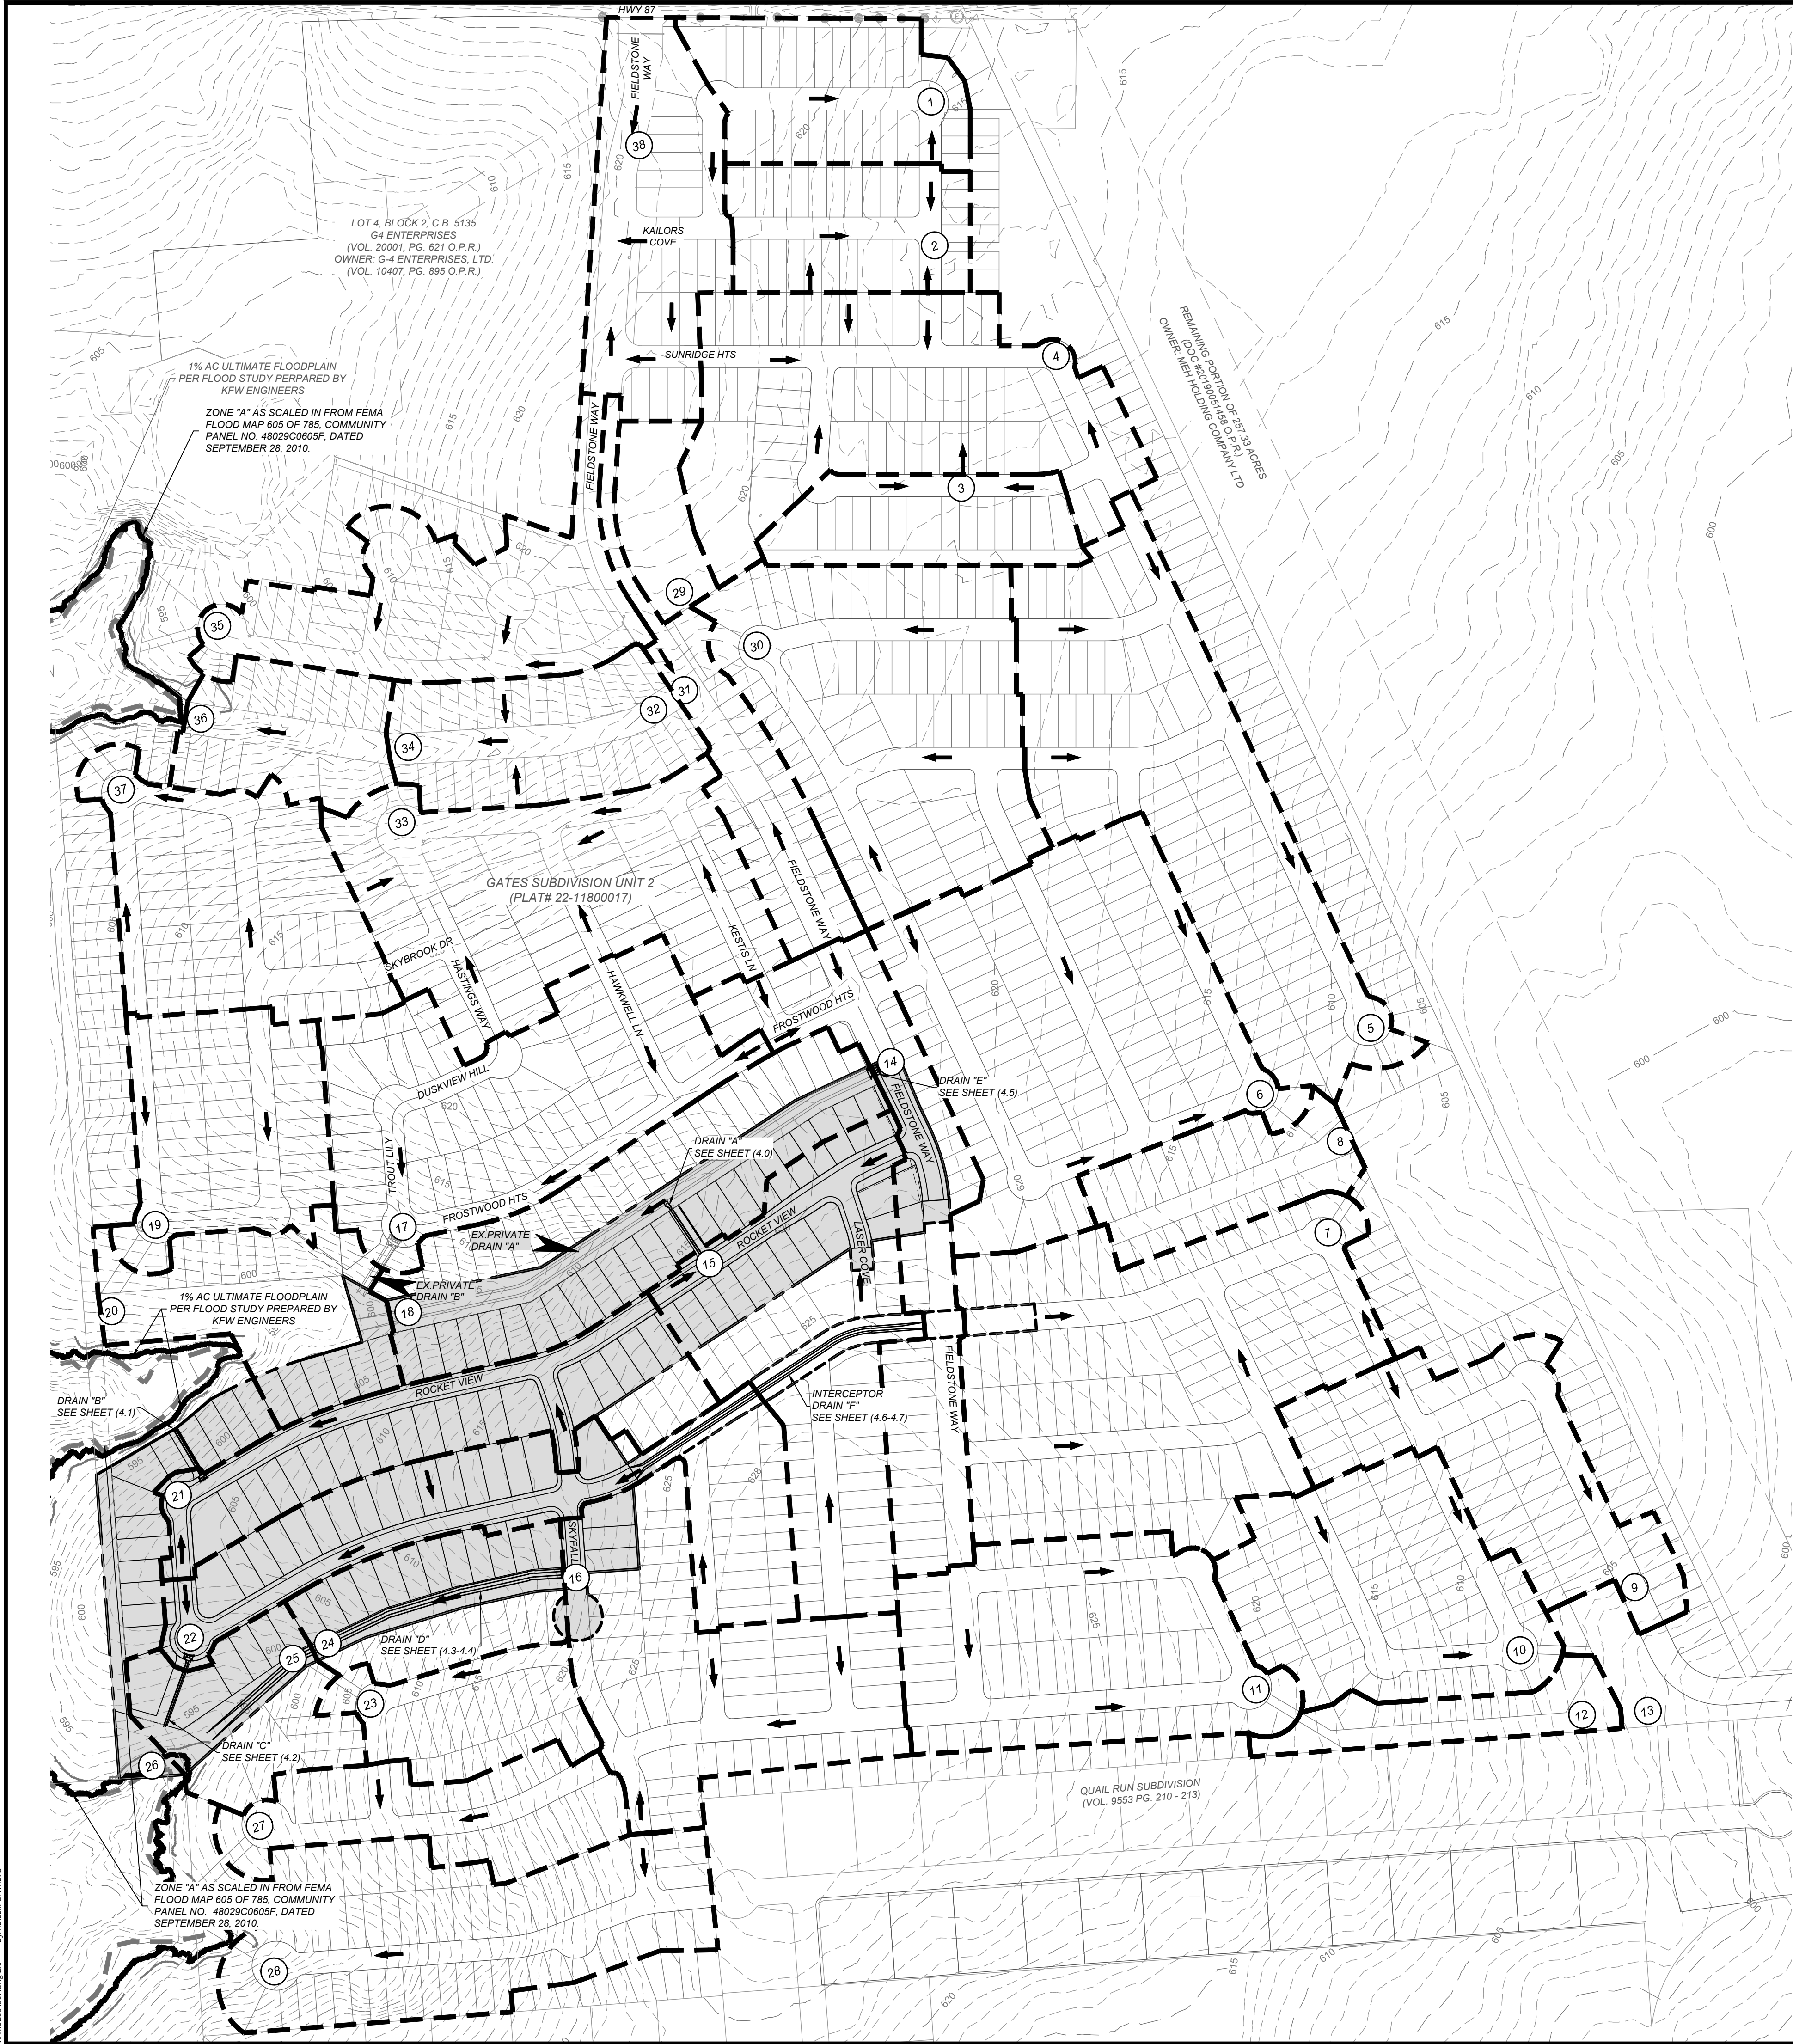

Ultimate Conditions:																			
Study Point	AREA	(Acres)	C	Tovrl (min)		Tsc (min)	Tch (min)	Ttot (min)	I5 (in/hr)	I25 (in/hr)	I100 (in/hr)	Q5 (ft3/s)	Q25 (ft3/s)	Q100 (ft3/s)					
1	A-1	4.22	0.75	10.00		3	1	14	5.42	7.53	9.39	17.16	23.82	29.72					
2	A-2	3.59	0.75	10.00		3	1	14	5.42	7.53	9.39	14.60	20.26	25.28					
3	A-3	3.09	0.75	10.00		4	0	14	5.42	7.53	9.39	12.57	17.44	21.76					
4	PT. 3 + A-4	12.73	0.76	10.00	CARRYOVER FROM PT. 3	4	1	15	5.24	7.24	9.03	50.79	70.17	87.49					
	A-4	9.64	0.77																
5	A-5	10.98	0.75	10.00		4	3	17	4.91	6.76	8.42	40.40	55.69	69.33					
6	A-6	11.92	0.75	10.00		6	2	18	4.76	6.56	8.16	42.59	58.64	72.96					
7	A-7	13.01	0.75	10.00		8	2	20	4.51	6.21	7.71	44.05	60.55	75.26					
8	PT. 6 + A-8	14.94	0.75	10.00	CARRYOVER FROM PT. 4	8	0	18	4.76	6.56	8.16	53.38	73.49	91.45					
	A-8	3.02	0.75																
9	A-9	5.89	0.75	10.00		4	2	16	5.06	6.99	8.71	22.37	30.87	38.46					
10	A-10	7.12	0.75	10.00		5	1	16	5.06	6.99	8.71	27.04	37.32	46.49					
11	A-11	8.06	0.75	10.00		5	1	16	5.06	6.99	8.71	30.61	42.24	52.63					
12	PT. 11 + A-12	10.04	0.75	10.00	CARRYOVER FROM PT. 9	6	3	19	4.63	6.37	7.93	34.89	48.00	59.69					
	A-12	1.98	0.75																
13	PT. 10+ PT. 11	17.16	0.75	10.00	CARRYOVER FROM PT. 10	9	0	19	4.63	6.37	7.93	59.64	82.04	102.02					
14	A-14	6.12	0.84	10.00		6	2	18	4.76	6.56	8.16	24.42	33.62	41.83					
15	A-15	8.15	0.75	14.00		3	3	20	4.51	6.21	7.71	27.60	37.93	47.15					
16	A-16	8.04	0.75	14.00		3	2	19	4.63	6.37	7.93	27.94	38.44	47.80					
17	A-17	9.00	0.75	10.00		4	0	14	5.42	7.53	9.39	36.60	50.80	63.38					
18	PT. 14+ PT. 15 + A-18	22.15	0.77	10.00	CARRYOVER FROM PT. 12	8	3	21	4.40	6.05	7.52	75.53	103.75	128.90					
	A-18	7.88	0.75																
19	A-19	5.12	0.75	10.00		4	0	14	5.42	7.53	9.39	20.82	28.90	36.05					
20	PT. 17 + PT. 18 + PT. 19 + A-20	40.76	0.75	10.00	CARRYOVER FROM PT. 16	11	2	23	4.21	5.77	7.17	128.63	176.49	219.12					
	A-20	4.49	0.75																
21	A-21	5.80	0.75	14.00		1	3	18	4.76	6.56	8.16	20.72	28.53	35.50					
22	A-22	7.29	0.75	14.00		3	4	21	4.40	6.05	7.52	24.08	33.08	41.10					
23	A-23	2.88	0.75	10.00		4	1	15	5.24	7.24	9.03	11.32	15.64	19.50					
24	PT. 16 + A-24	11.69	0.75	10.00	CARRYOVER FROM PT. 14	9	2	21	4.40	6.05	7.52	38.62	53.05	65.90					
	A-24	3.65	0.75																
25	PT. 23 + PT. 24	14.57	0.75	10.00	CARRYOVER FROM PT. 22	11	0	21	4.40	6.05	7.52	48.13	66.11	82.14					
26	PT. 22 + PT. 25 + A-26	25.23	0.75	10.00	CARRYOVER FROM PT. 23	11	1	22	4.30	5.91	7.34	81.42	111.77	138.81					
	A-26	3.37	0.75																
27	A-27	4.00	0.75	10.00		5	3	18	4.76	6.56	8.16	14.29	19.68	24.48					
28	A-28	8.13	0.75	10.00		4	2	16	5.06	6.99	8.71	30.88	42.61	53.09					
29	A-29	1.61	0.91	14.00		2	0	16	5.06	6.99	8.71	7.42	10.24	12.76					
30	A-30	9.92	0.75	10.00		6	1	17	4.91	6.76	8.42	36.50	50.31	62.64					
31	PT. 29 + A-31	5.04	0.87	10.00		3	2	15	5.24	7.24	9.03	22.96	31.73	39.56					
	A-31	3.43	0.85																
32	PT. 30 + PT. 31	14.96	0.84	10.00	CARRYOVER FROM PT. 29	6	1	17	4.91	6.76	8.42	61.65	84.97	105.79					
33	A-33	9.17	0.75	10.00		4	1	15	5.24	7.24	9.03	36.04	49.79	62.09					
34	PT. 32 + PT. 34	19.29	0.78	10.00	CARRYOVER FROM PT. 30	7	2	19	4.63	6.37	7.93	69.83	96.06	119.46					
	A-34	4.33	0.75																
35	A-35	6.30	0.75	10.00		3	3	16	5.06	6.99	8.71	23.93	33.02	41.14					
36	PT. 33 + PT. 34 + A-36	31.52	0.77	10.00	CARRYOVER FROM PT. 32	9	1	20	4.51	6.21	7.71	109.44	150.44	186.99					
	A-36	3.06	0.75																
37	A-37	6.62	0.75	10.00		6	1	17	4.91	6.76	8.42	24.36	33.58	41.80					
38	A-38	5.49	0.75	10.00		3	1	14	5.42	7.53	9.39	22.33	30.99	38.66					
39	A-40	69.37	0.80	20.00		7	5	32	3.56	4.87	6.04	197.74	270.81	335.78					

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ALL STATES REQUIRE NOTIFICATION OF EXCAVATORS, DESIGNERS, OR ANY PERSON PREPARING TO DISTURB THE EARTH'S SURFACE ANYWHERE IN ANY STATE.
FOR STATE SPECIFIC DIRECT PHONE NUMBERS VISIT: WWW.CALL811.COM

PRELIMINARY

FOR

SOUTHEAST MEADOWS UNIT 3

PLAT# 23-11800440

SAN ANTONIO BEXAR COUNTY TEXAS

Engineering & Design

SAN ANTONIO (KFW)
3421 Paesanos Parkway
San Antonio, TX 78231
Phone: 210.979.8444
COLLIERS ENGINEERING & DESIGN, INC.
TBPB License #14009
TBPES Permit # 10194550

SCALE: AS SHOWN DATE: 07/20/2023 DRAWN BY: SD CHECKED BY: SC

PROJECT NUMBER: 205-43-07 DRAWING NAME: MD2054307



SHEET TITLE: MASTER DRAINAGE PLAN

SHEET NUMBER: 2.0


1. ELEVATION SHOWN ON FOUNDATION IS FOR FINISHED FLOOR.
2. CONTRACTOR SHALL PROVIDE OWNER ALL NECESSARY DENSITY TESTS FOR FILL LOTS AS REQUIRED BY HUD SPECIFICATIONS.
3. OWNER'S LOTS SHALL BE CONFORM TO THE APPROVED SUBDIVISION PLAT TO CONFIRM ALL BUILDING SETBACKS PERMITTED TO ANY FOUNDATION WORK.
4. AS SOON AS PRACTICAL HOME BUILDER SHALL ESTABLISH VEGETATION (HYDROMULCH, SEEDING, SODDING, ETC.) TO PREVENT EROSION FROM OCCURRING.
5. CONTRACTOR SHALL CONTACT ENGINEER REGARDING ANY QUESTIONS ON THE INTENT OF THIS PLAN.
6. POSITIVE DRAINAGE SHALL BE MAINTAINED ON ALL SURFACE AREAS WITHIN THE SCOPE OF THIS PROJECT. DRAINAGE SHALL BE DIRECTED AWAY FROM ALL BUILDING FOUNDATIONS AND AWAY FROM PROPERTY LINES. DRAINAGE SHALL BE BASED ON THE GREET RAINFALL TO THE MASTER DRAINAGE PLAN FOR THE PROJECT. CONTRACTOR SHOULD TAKE PRECAUTIONS NOT TO ALLOW PONDING OF WATER.
7. ALL ELEVATIONS AND CONTOURS SHOWN ON THIS GRADING PLAN REFLECT FINISHED GRADES. THE THICKNESS OF CURBS, EMBANKMENTS, AND SIDEWALKS MUST BE SUBTRACTED TO OBTAIN SUBGRADE ELEVATIONS.
8. GRADING PLAN IS INTENDED FOR USE IN LOT GRADING ONLY. CONTRACTOR SHOULD REFER TO CONSTRUCTION DRAWINGS FOR ALL OTHER GRADES, INCLUDING, BUT NOT LIMITED TO, CHALK, ROADS, AND DETENTION BASINS.
9. CONTRACTOR SHALL ENSURE POSITIVE DRAINAGE ALL SWALES.

BEXAR COUNTY R.O.W. NOTE

A BEXAR COUNTY PERMIT
MUST BE OBTAINED BEFORE
WORKING IN BEXAR COUNTY
R.O.W.

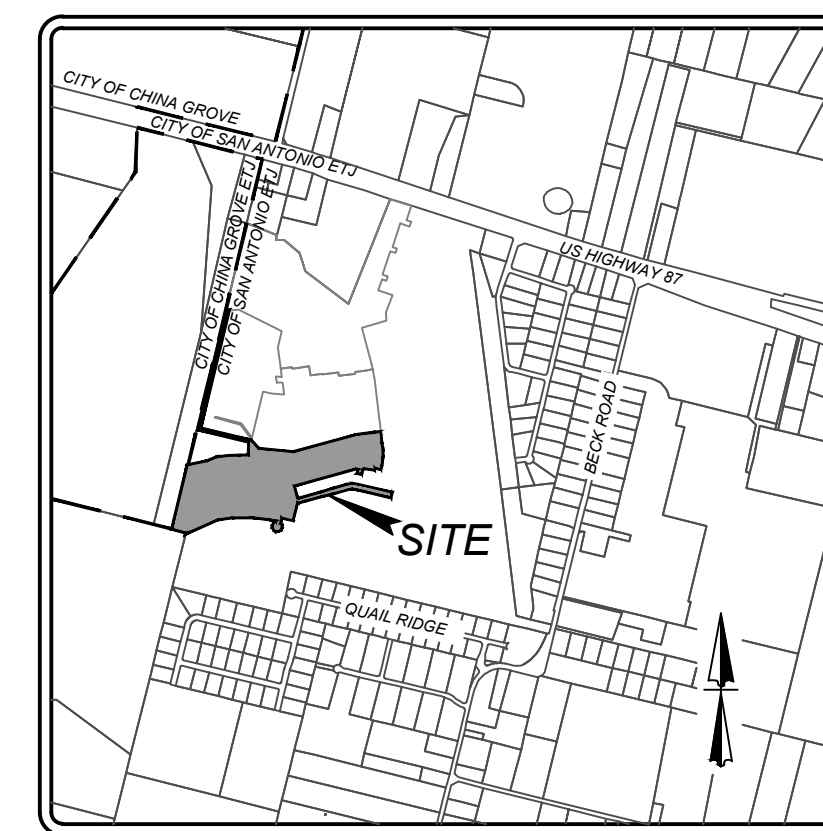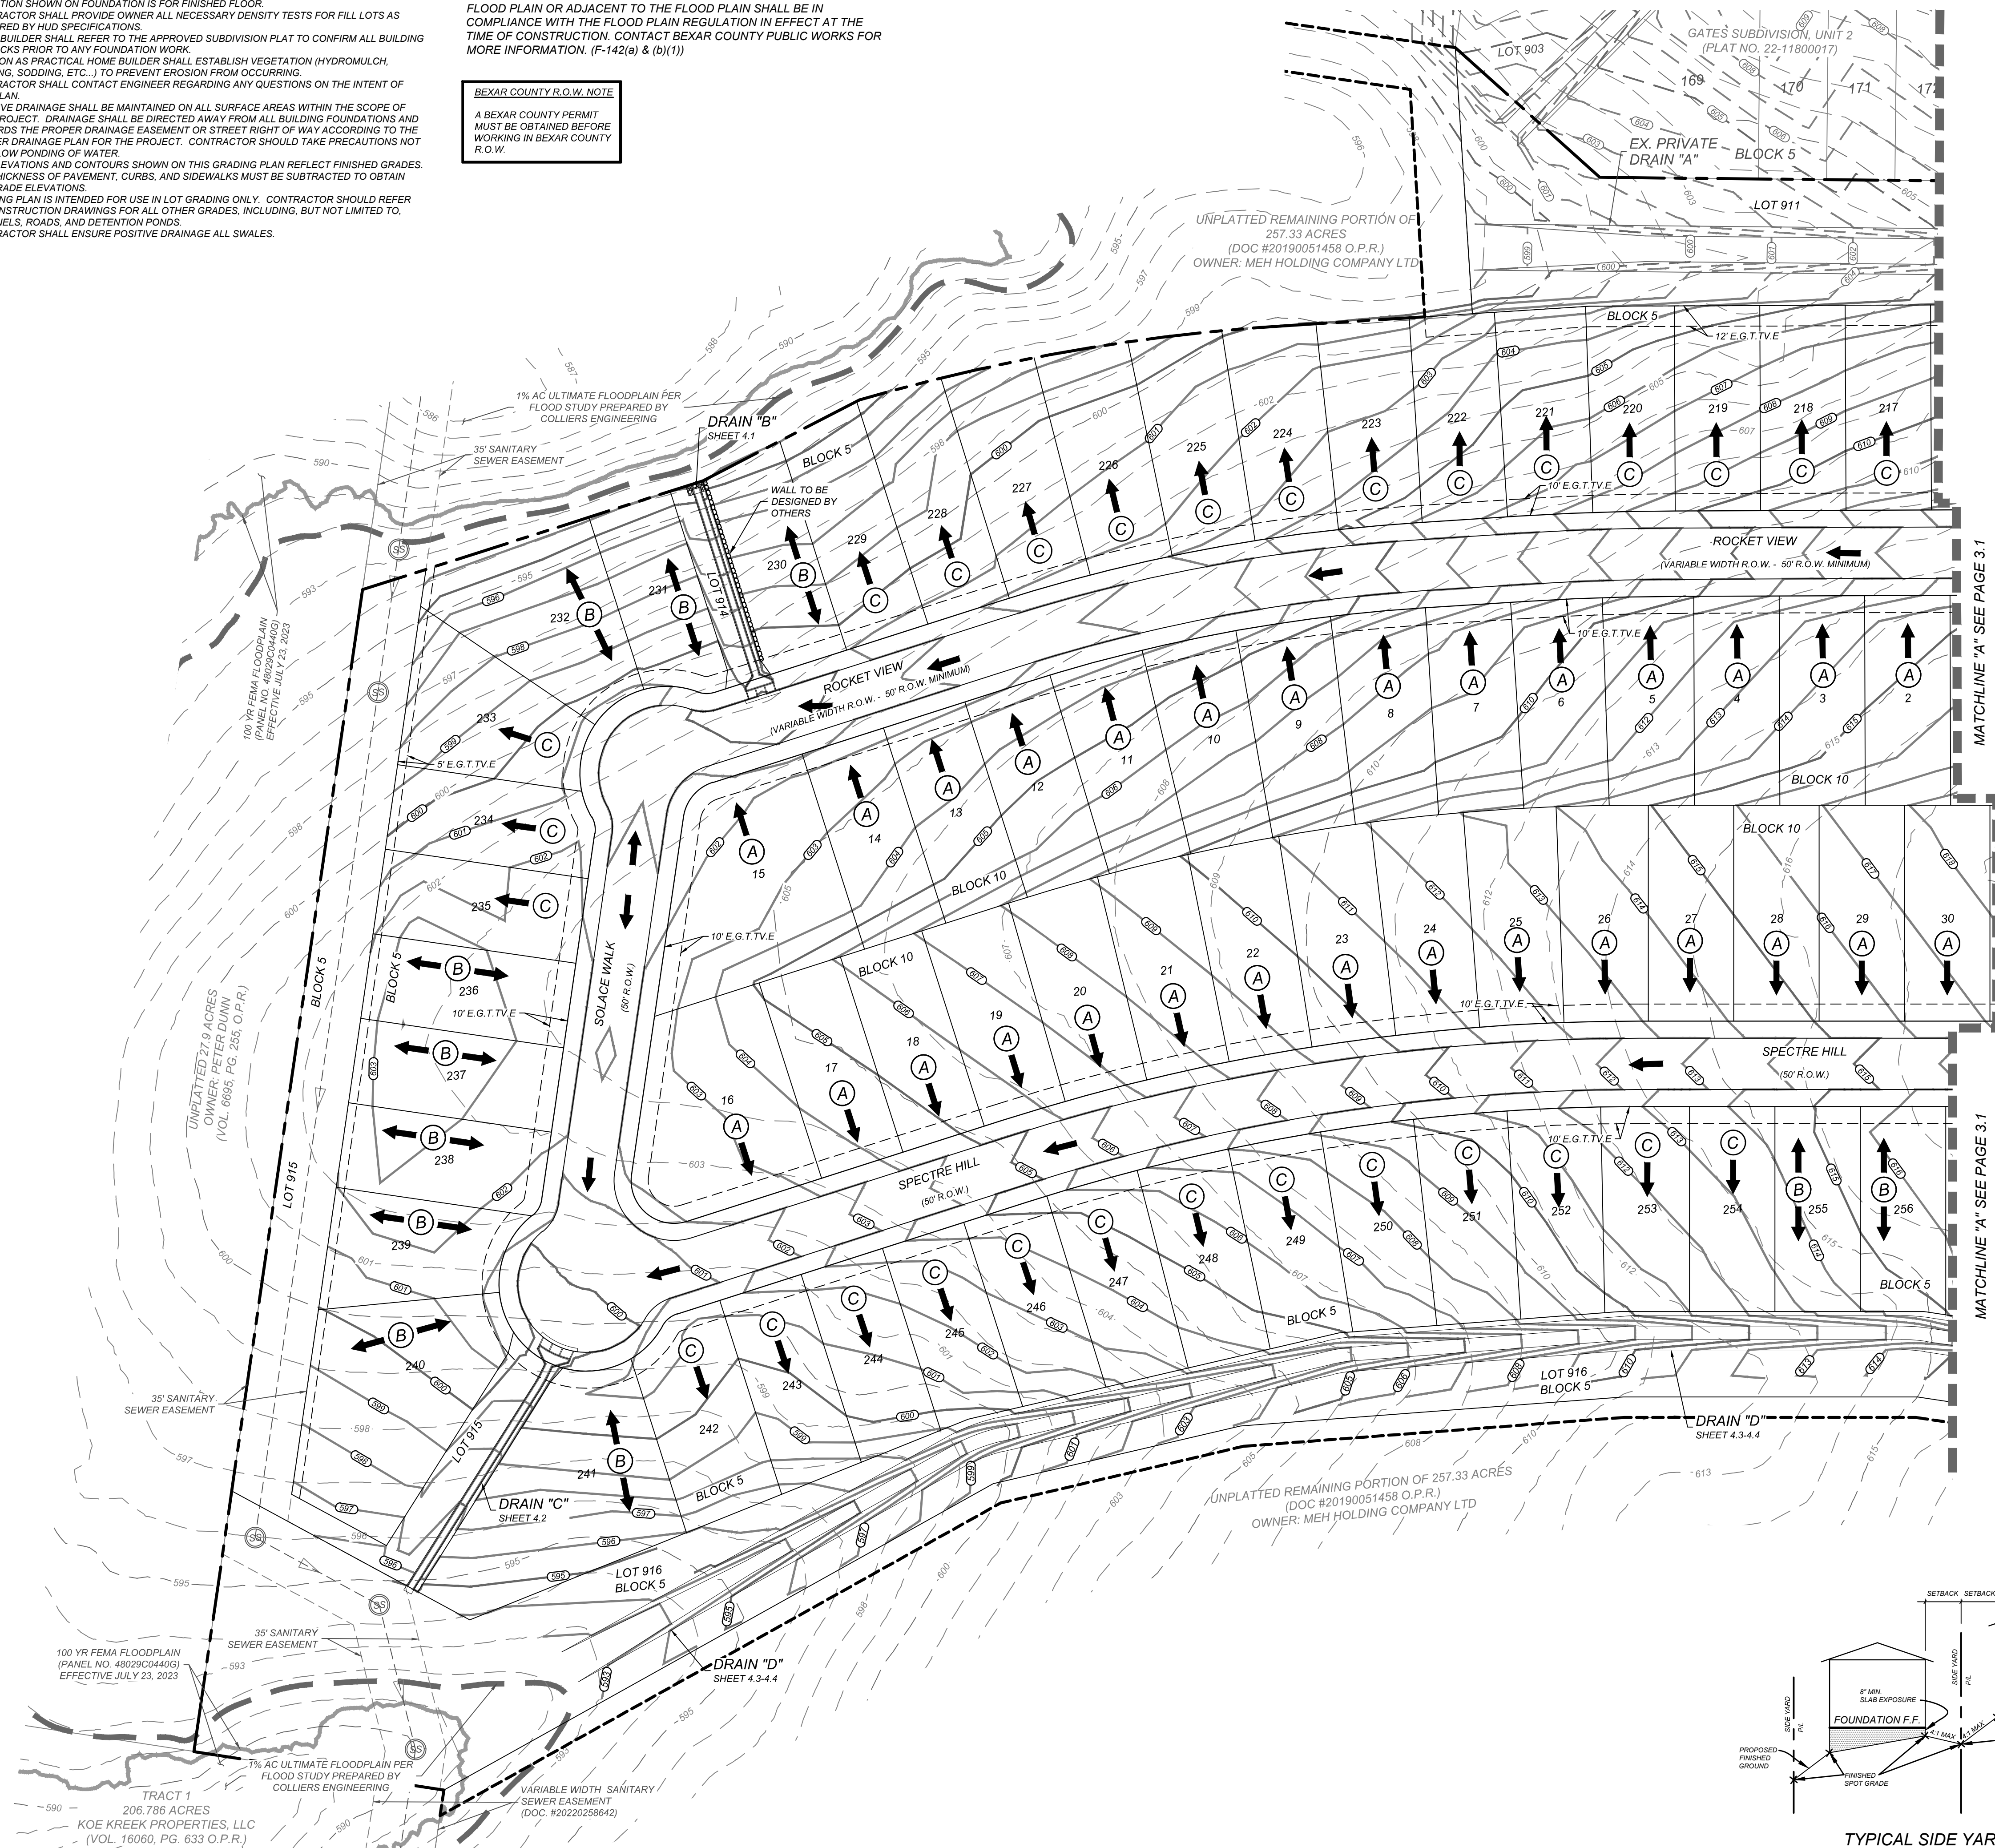


LOCATION MAP
NOT-TO-SCALE

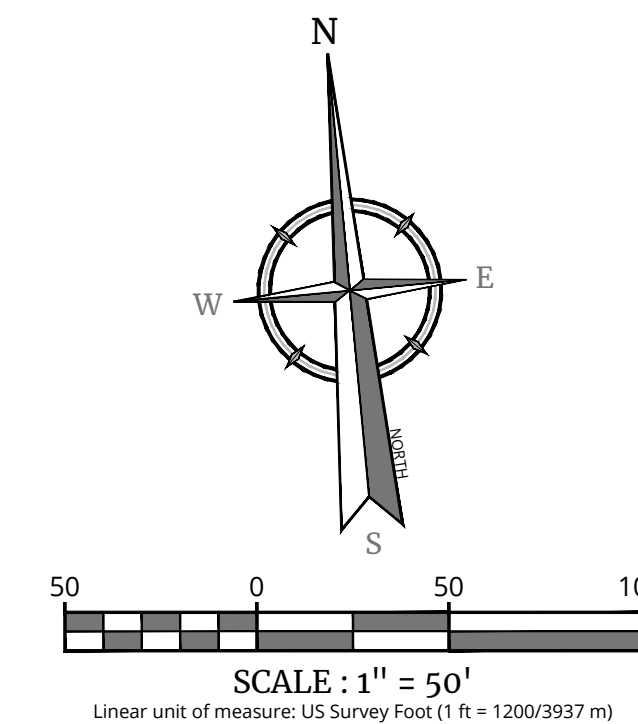

E, G, T, & TV. E. = GAS, ELECTRIC, TELEPHONE
CABLE T.V. EASEMENT

- = FLOW ARROW
 (A) = LOT GRADE TYPE

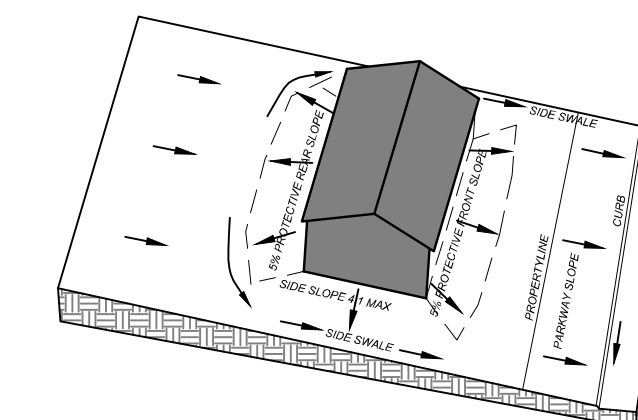

The diagram illustrates the grading for a Type 'A' lot. It shows a cross-section with the following features and slopes:

- REAR PROTECTIVE SLOPE:** 5.0% (MIN)
- FRONT PROTECTIVE SLOPE:** 5.0% (MIN)
- DRIVEWAY:** 1% (MIN), 14% (MAX)
- PARKWAY:** 2% (MAX)
- CURB:** 2% (MAX)
- W/ASH FLOOR:** 8" THICK (MIN)
- FLOWLINE SIDE SWALE:** 1% (MIN), 14% (MAX)
- 1% (MAX):** Slope on the left side of the lot.
- 5':** Two horizontal dimensions indicating the width of the driveway and the distance from the driveway to the rear protective slope.

TYPE 'A' LOT GRADING


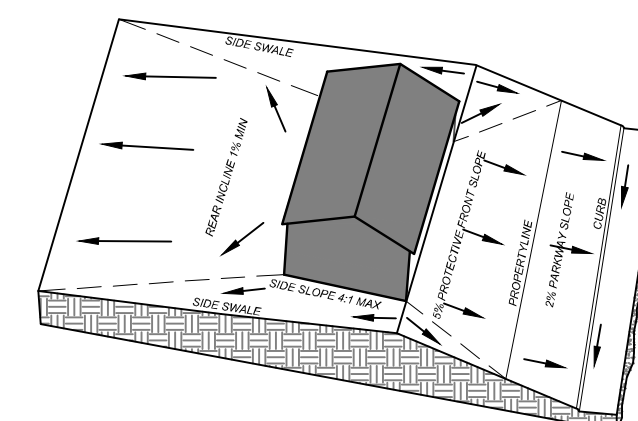



Diagram illustrating a typical cross-section of a road with various slopes and elevations:

- REAR INCLINE 1% (MIN)
- FINISH FLOOR 8" THICK (MIN.)
- FRONT PROTECTIVE SLOPE (5.0% MIN)
- DRIVEWAY 1% (MIN.) 14% (MAX.)
- PARKWAY SIDE SLOPE (2%)
- CURB
- FLOWLINE SIDE SWALE 1% (MIN.) 14% (MAX.)
- 5'

TYPE 'B' LOT GRADING

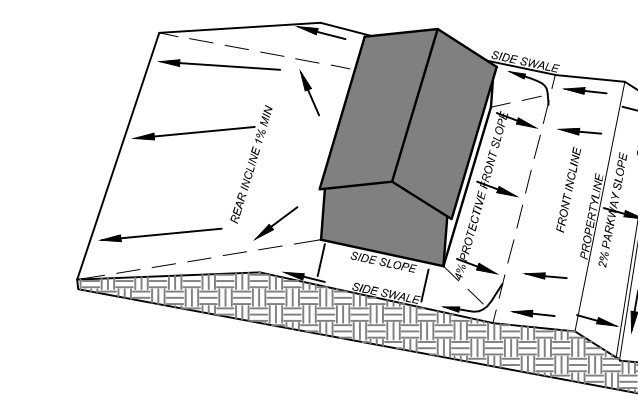

TYPE 'C' LOT GRADING

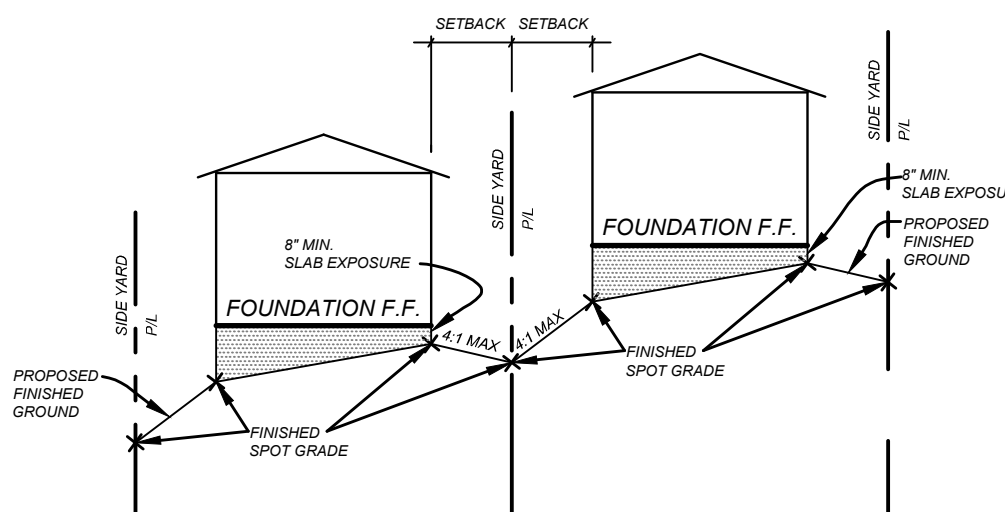





TYPICAL SIDE YARD GRADING
N.T.S.

[illegible]

NOTE: DO NOT SCALE DRAWINGS FOR CONSTRUCTION

1. ELEVATION SHOWN ON FOUNDATION IS FOR FINISHED FLOOR.
2. CONTRACTOR SHALL PROVIDE OWNER ALL NECESSARY DENSITY TESTS FOR FILL LOTS AS REQUIRED BY HUD SPECIFICATIONS.
3. OWNER BEARER SHALL REFER TO THE APPROVED SUBDIVISION PLAN TO CONFIRM ALL BUILDING SETBACKS RETURN TO ANY FOUNDATION WORK.
4. AS SOON AS PRACTICAL HOME BUILDER SHALL ESTABLISH VEGETATION (HYDRONMULCH, SEEDING, SODDING, ETC.) TO PREVENT EROSION FROM OCCURRING.
5. CONTRACTOR SHALL CONTACT ENGINEER REGARDING ANY QUESTIONS ON THE INTENT OF THIS PLAN.
6. POSITIVE DRAINAGE SHALL BE MAINTAINED ON ALL SURFACE AREAS WITHIN THE SCOPE OF THIS PROJECT. DRAINAGE SHALL BE DIRECTED AWAY FROM ALL BUILDING FOUNDATIONS AND EXISTING DRIVE PROPERTIES. CONTRACTOR SHALL HAVE THE RIGHT OF WAY ACCORDING TO THE MASTER DRAINAGE PLAN FOR THE PROJECT. CONTRACTOR SHOULD TAKE PRECAUTIONS NOT TO ALLOW PONDING OF WATER.
7. FINISH GRADES AND ELEVATIONS SHOWN ON THIS GRADING PLAN REFLECT FINISHED GRADES. THE THICKNESS OF PAVEMENT, CURBS, AND SIDEWALKS MUST BE SUBTRACTED TO OBTAIN SUBGRADE ELEVATIONS.
8. GRADING PLAN IS INTENDED FOR USE IN LOT GRADING ONLY. CONTRACTOR SHOULD REFER TO CONSTRUCTION DRAWINGS FOR ALL OTHER GRADES, INCLUDING, BUT NOT LIMITED TO, CHANNELS, ROADS, AND DETENTION PONDS.
9. CONTRACTOR SHALL ENSURE POSITIVE DRAINAGE ON ALL SWALES.

BEXAR COUNTY R.O.W. NOTE
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R.O.W.

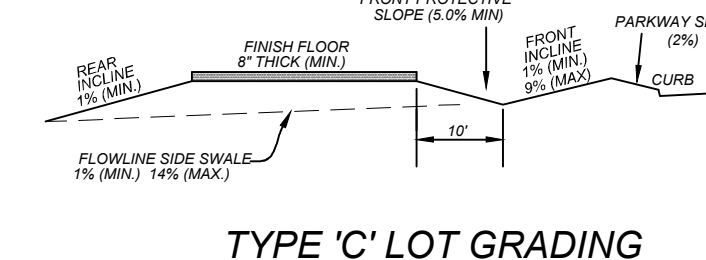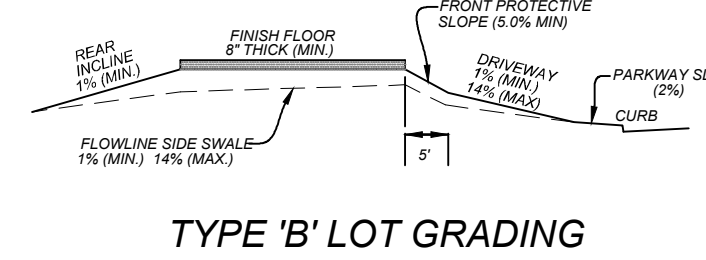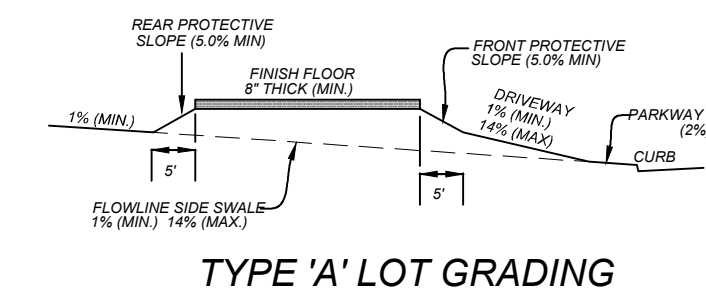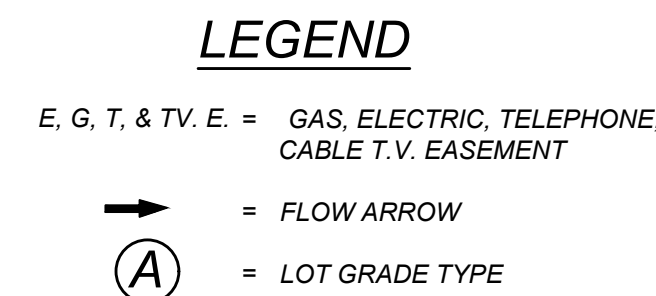

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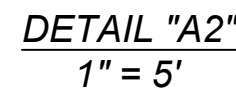
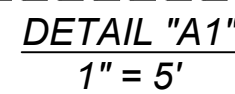
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FOR
SOUTHEAST
MEADOWS UNIT 3
PLAT# 23-11800440

SHEET NUMBER: 3.1

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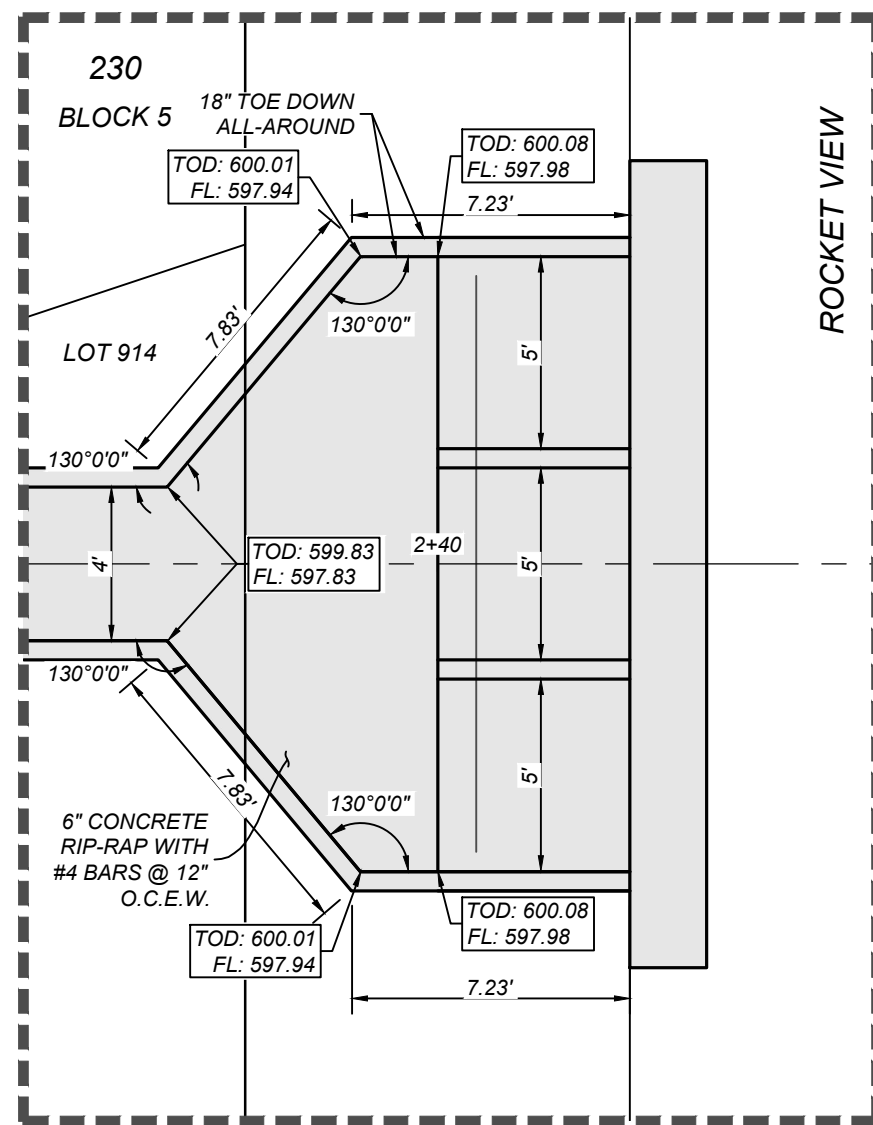
NOTE: DO NOT SCALE DRAWINGS FOR CONSTRUCTION

TRENCH EXCAVATION SAFETY PROTECTION


CONTRACTOR AND/OR CONTRACTOR'S INDEPENDENTLY RETAINED EMPLOYEE OR STRUCTURAL DESIGN/GEOTECHNICAL/SAFETY/EQUIPMENT CONSULTANT, IF ANY, SHALL REVIEW THESE PLANS AND AVAILABLE GEOTECHNICAL INFORMATION AND THE ANTICIPATED INSTALLATION SITES WITHIN THE PROJECT WORK AREA IN ORDER TO IMPLEMENT CONTRACTOR'S TRENCH EXCAVATION SAFETY PROTECTION SYSTEMS, PROGRAMS AND/OR PROCEDURES. THE CONTRACTOR'S IMPLEMENTATION OF THESE SYSTEMS, PROGRAMS AND/OR PROCEDURES SHALL PROVIDE FOR ADEQUATE TRENCH EXCAVATION SAFETY PROTECTION THAT COMPLIES WITH AS A MINIMUM, OSHA STANDARDS FOR TRENCH EXCAVATIONS. SPECIFICALLY, CONTRACTOR AND/OR CONTRACTOR'S INDEPENDENTLY RETAINED EMPLOYEE OR SAFETY CONSULTANT SHALL IMPLEMENT A TRENCH SAFETY PROGRAM IN ACCORDANCE WITH OSHA STANDARDS GOVERNING THE PRESENCE AND ACTIVITIES OF INDIVIDUALS WORKING IN AND AROUND TRENCH EXCAVATION.

CAUTION!!


THE CONTRACTOR SHALL BE REQUIRED TO LOCATE ALL PUBLIC OR PRIVATE UTILITIES INCLUDING BUT NOT LIMITED TO: WATER, SEWER, TELEPHONE AND FIBER OPTIC LINES, SITE LIGHTING ELECTRIC, SECONDARY ELECTRIC, PRIMARY ELECTRICAL DUCTBANKS, LANDSCAPE IRRIGATION FACILITIES, AND GAS LINES. ANY UTILITY CONFLICTS THAT ARISE SHOULD BE COMMUNICATED TO THE ENGINEER IMMEDIATELY AND PRIOR TO CONSTRUCTION. THE CONTRACTOR SHALL CONTACT 1-800-DIG-TESS A MINIMUM OF 48 HOURS PRIOR TO THE START OF CONSTRUCTION. ANY DAMAGE TO EXISTING UTILITIES SHALL BE THE SOLE RESPONSIBILITY OF THE CONTRACTOR AND THE REPAIR SHALL BE AT CONTRACTOR'S SOLE EXPENSE WHETHER THE UTILITY IS SHOWN ON THESE PLANS OR NOT.



DETAIL "B1"
1" = 5'

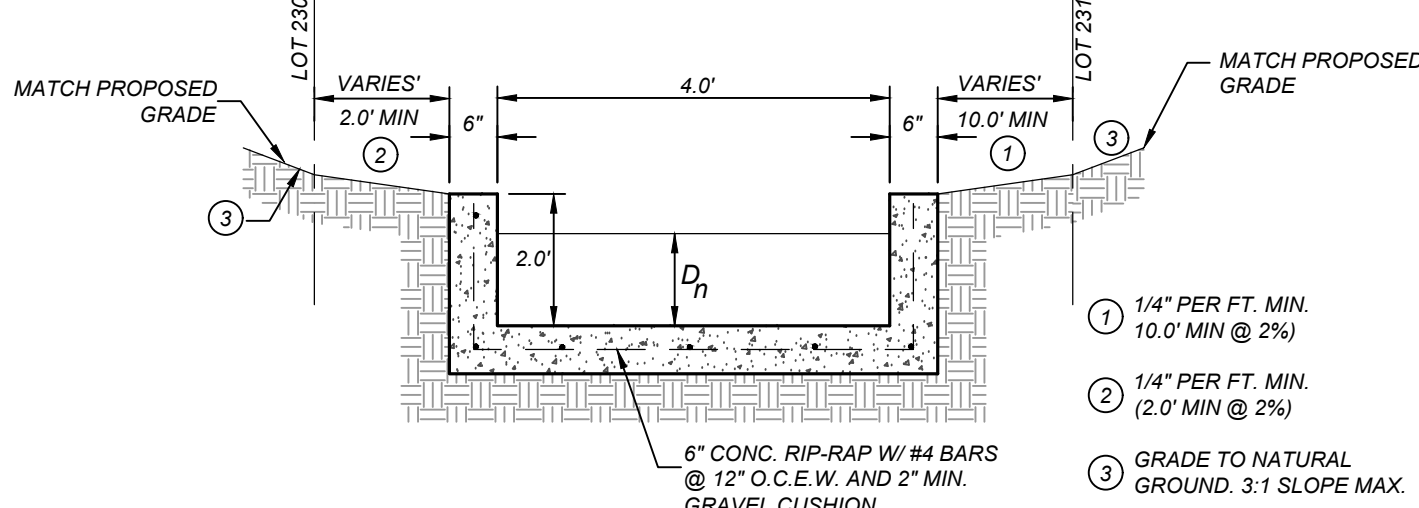

SECTION "B1-B1"
STA. 1+36.00 - STA. 2+32.97
N.T.S.

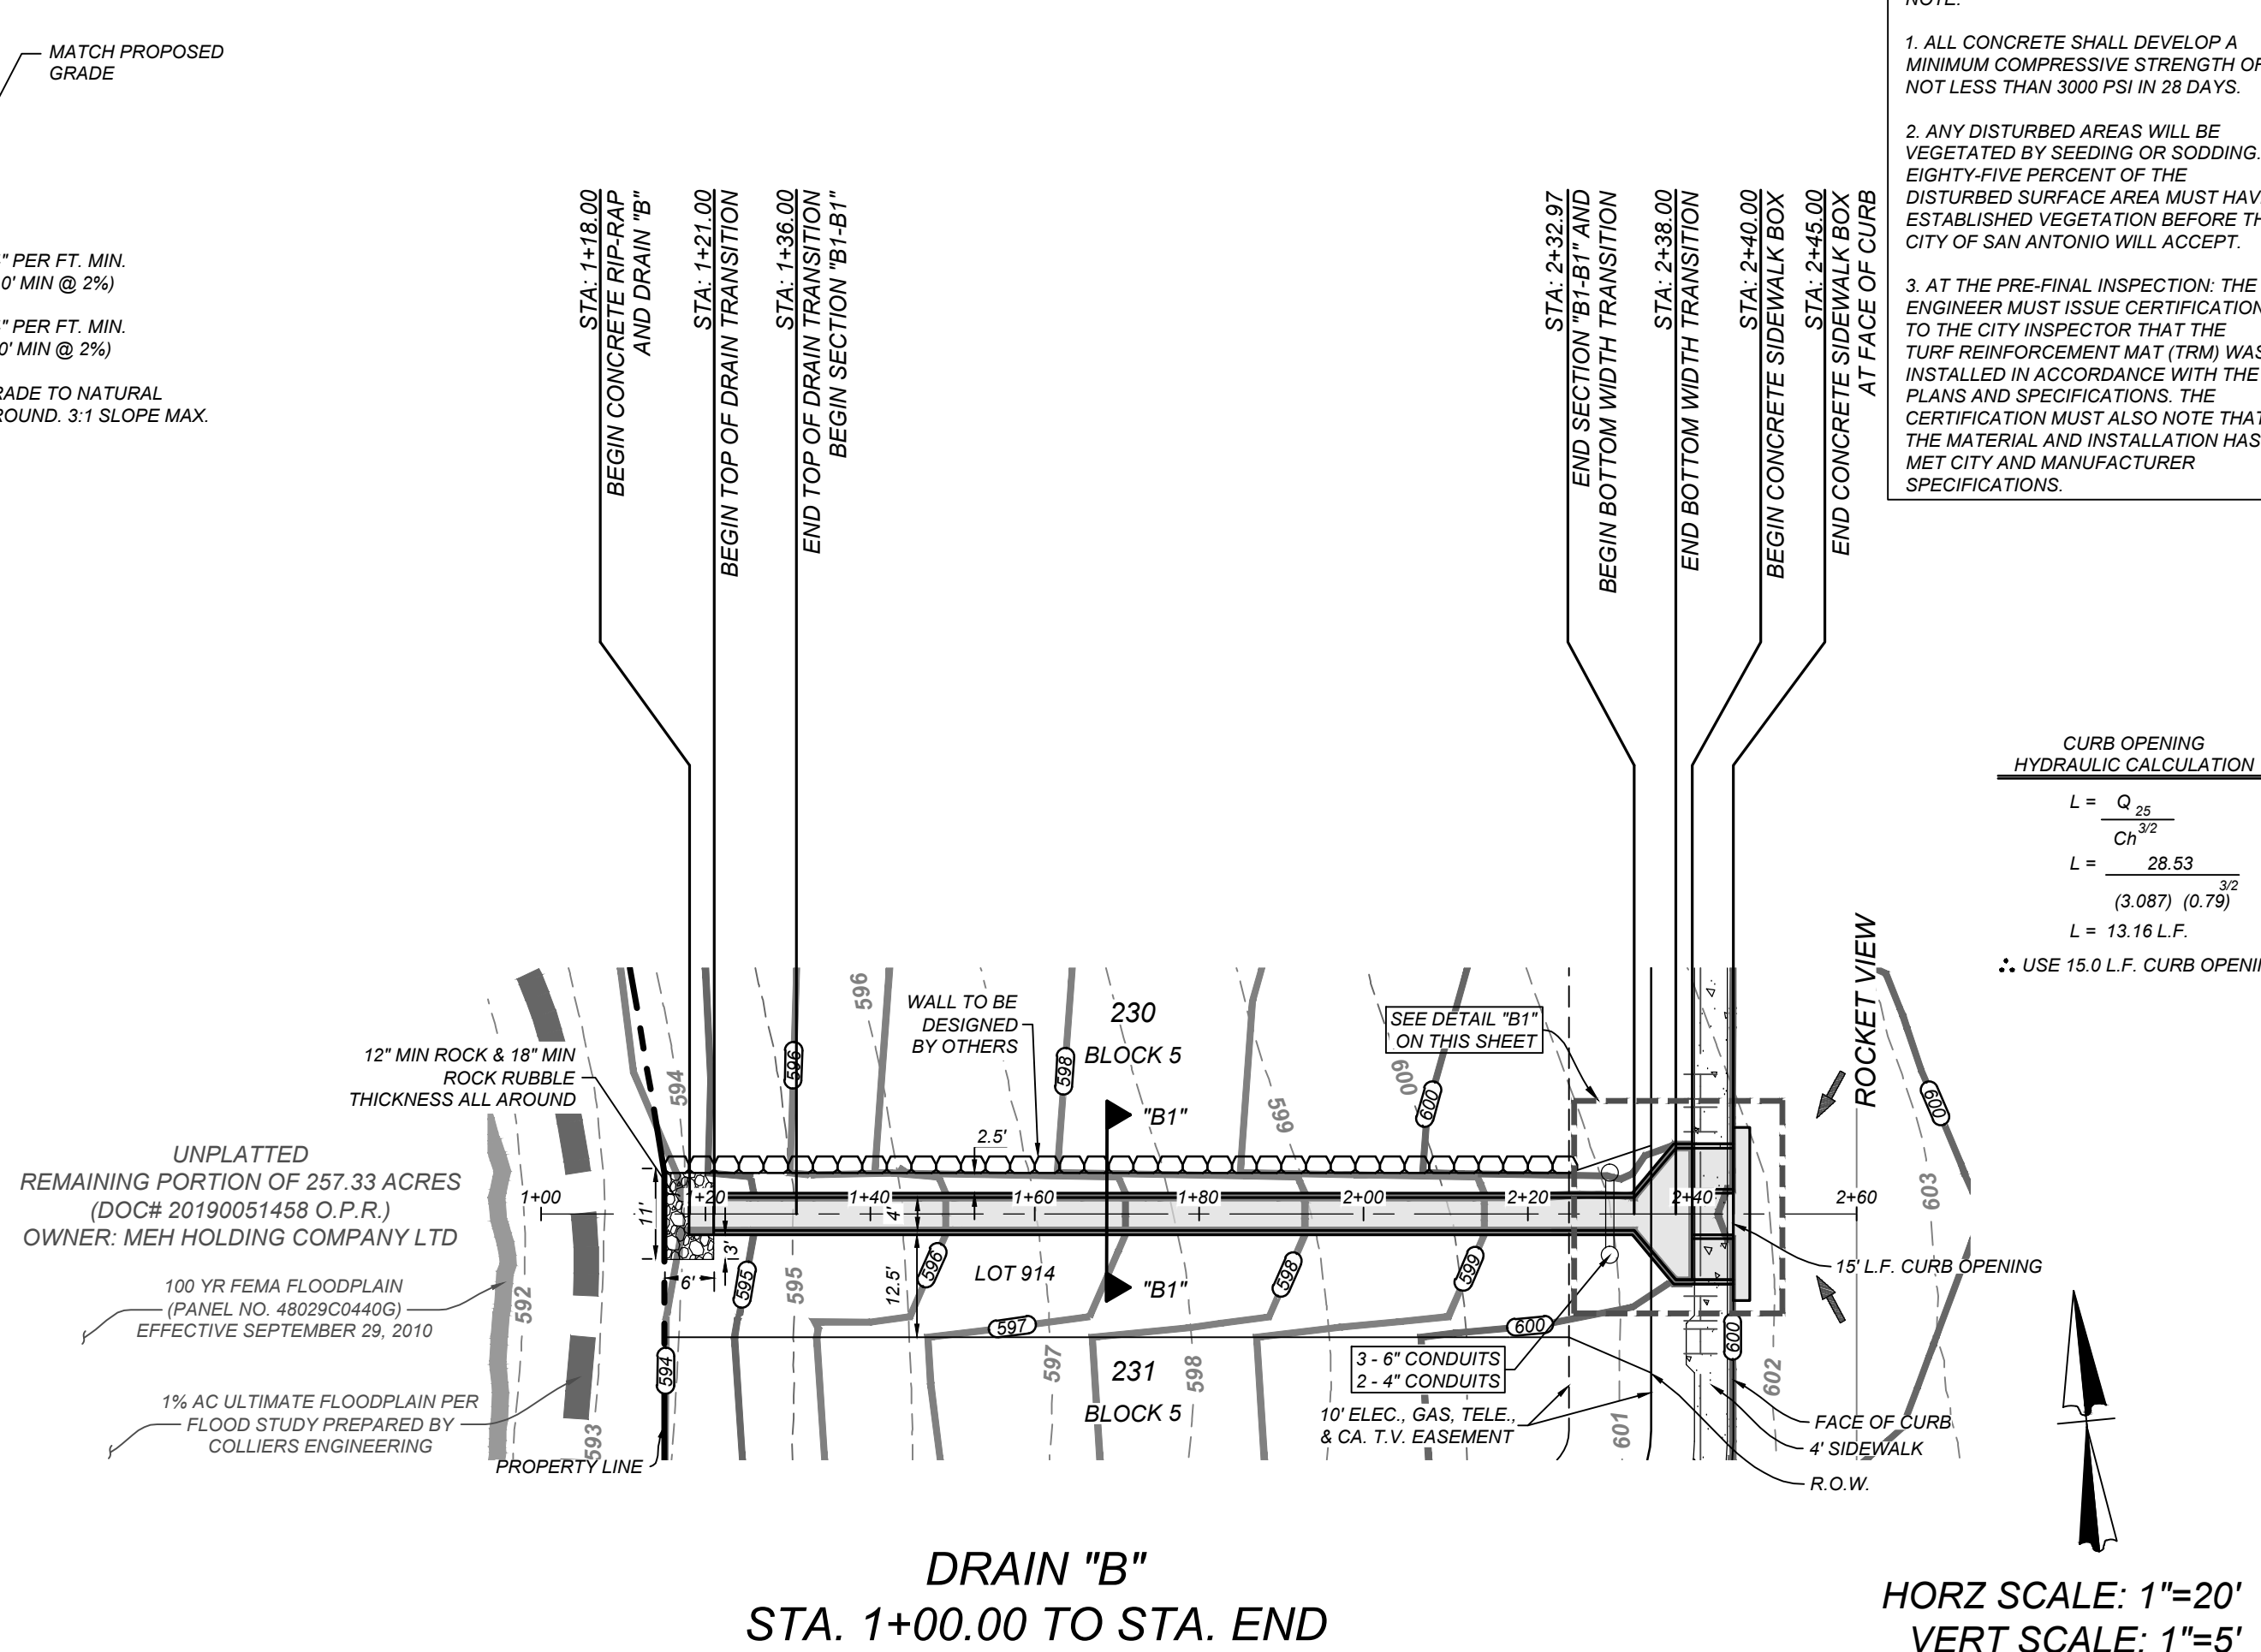


NOTE:

1. ALL CONCRETE SHALL DEVELOP A MINIMUM COMPRESSIVE STRENGTH OF NOT LESS THAN 3000 PSI IN 28 DAYS.
2. ANY DISTURBED AREAS WILL BE VEGETATED BY SEEDING OR SODDING. EIGHTY-FIVE PERCENT OF THE DISTURBED SURFACE AREA MUST HAVE ESTABLISHED VEGETATION BEFORE THE CITY OF SAN ANTONIO WILL ACCEPT.
3. AT THE PRE-FINAL INSPECTION: THE ENGINEER MUST ISSUE CERTIFICATION TO THE CITY INSPECTOR THAT THE TURF REINFORCEMENT MAT (TRM) WAS INSTALLED IN ACCORDANCE WITH THE PLANS AND SPECIFICATIONS. THE CERTIFICATION MUST ALSO NOTE THAT THE MATERIAL AND INSTALLATION HAS MET CITY AND MANUFACTURER SPECIFICATIONS.


CURB OPENING
HYDRAULIC CALCULATION

$$L = \frac{Q_{25}}{C_1^{3/2}}$$
$$L = \frac{26.53}{(3.087)^{3/2}}$$
$$L = 13.16 \text{ L.F.}$$


USE 15.0 L.F. CURB OPENING

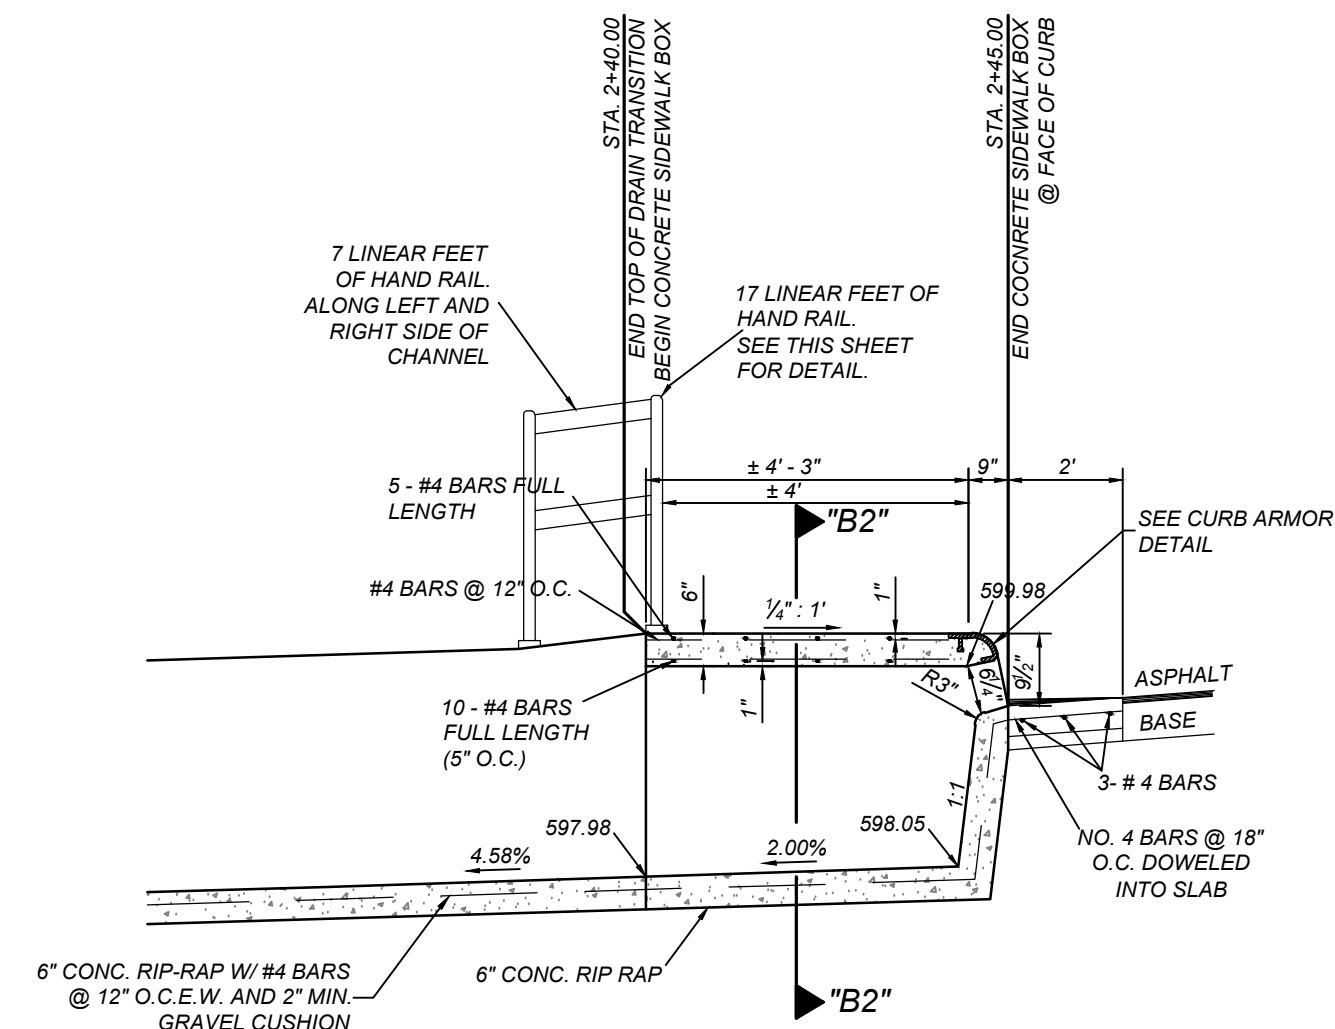


SIDEWALK BOX DETAIL
N.T.S.

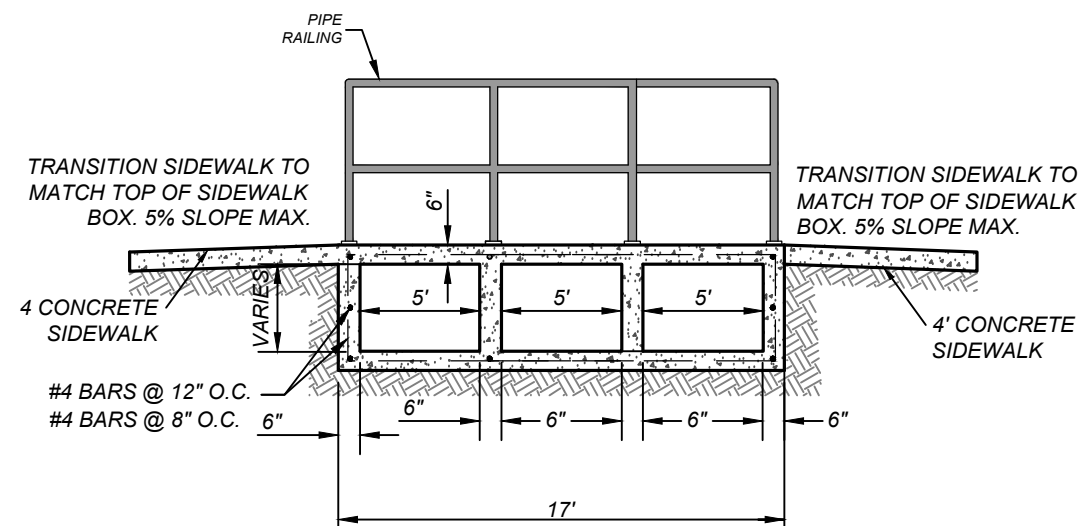


SECTION "B2-B2"
N.T.S.

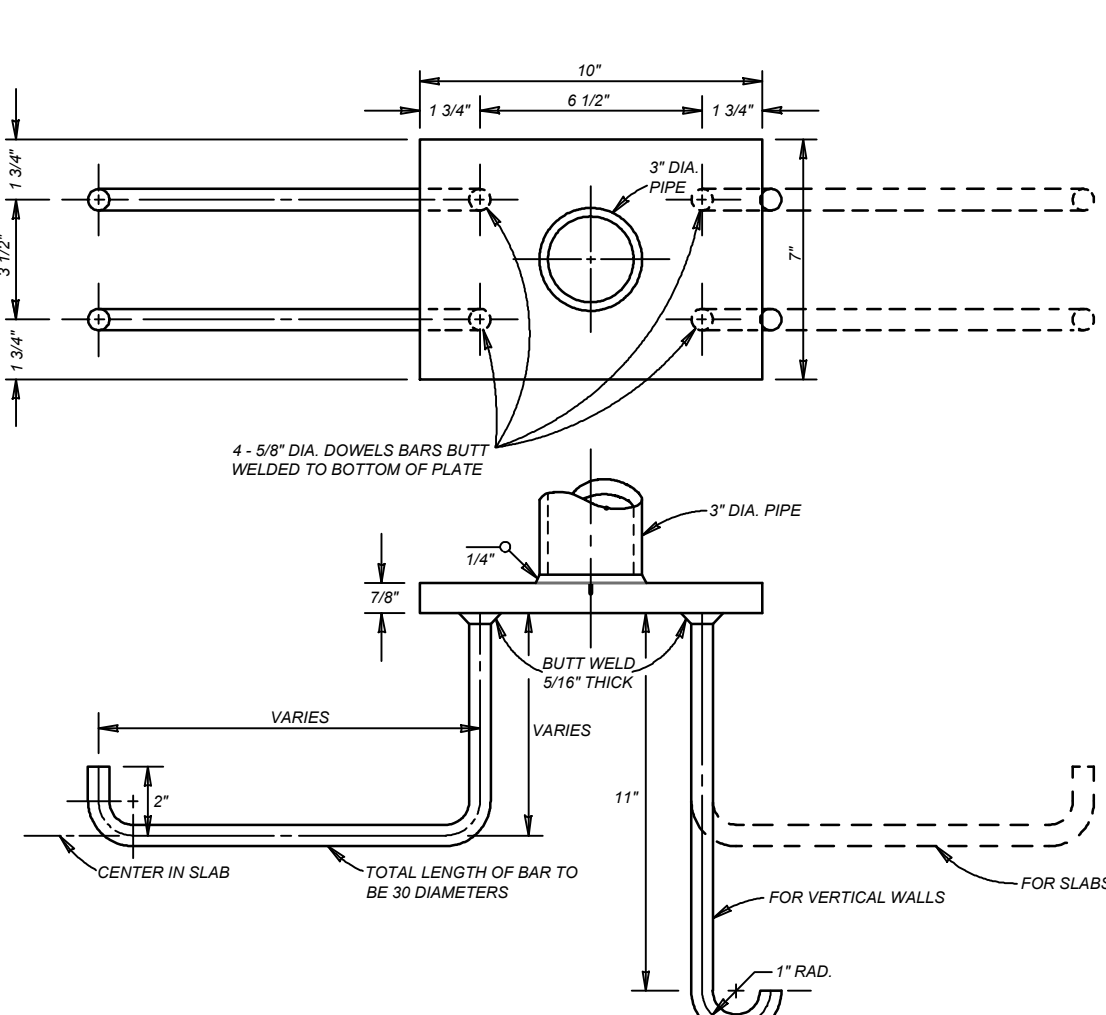

PIPE ANCHORAGE DETAILS
N.T.S.

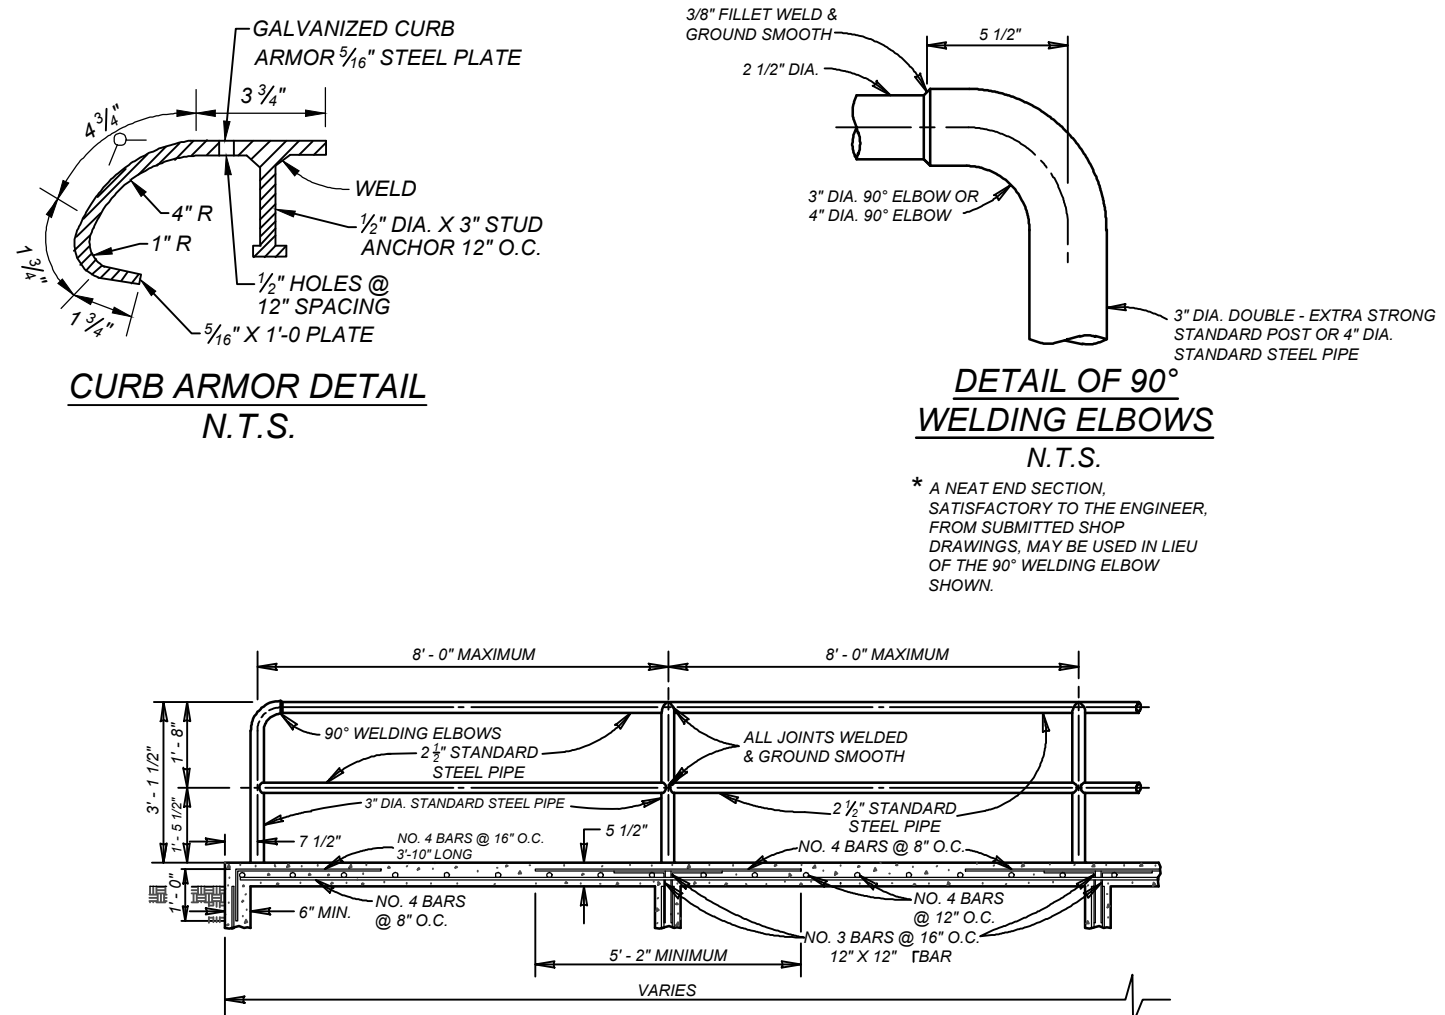

TYPICAL SIDEWALK BRIDGE &
SIDEWALK PIPE RAILING SECTION
N.T.S.

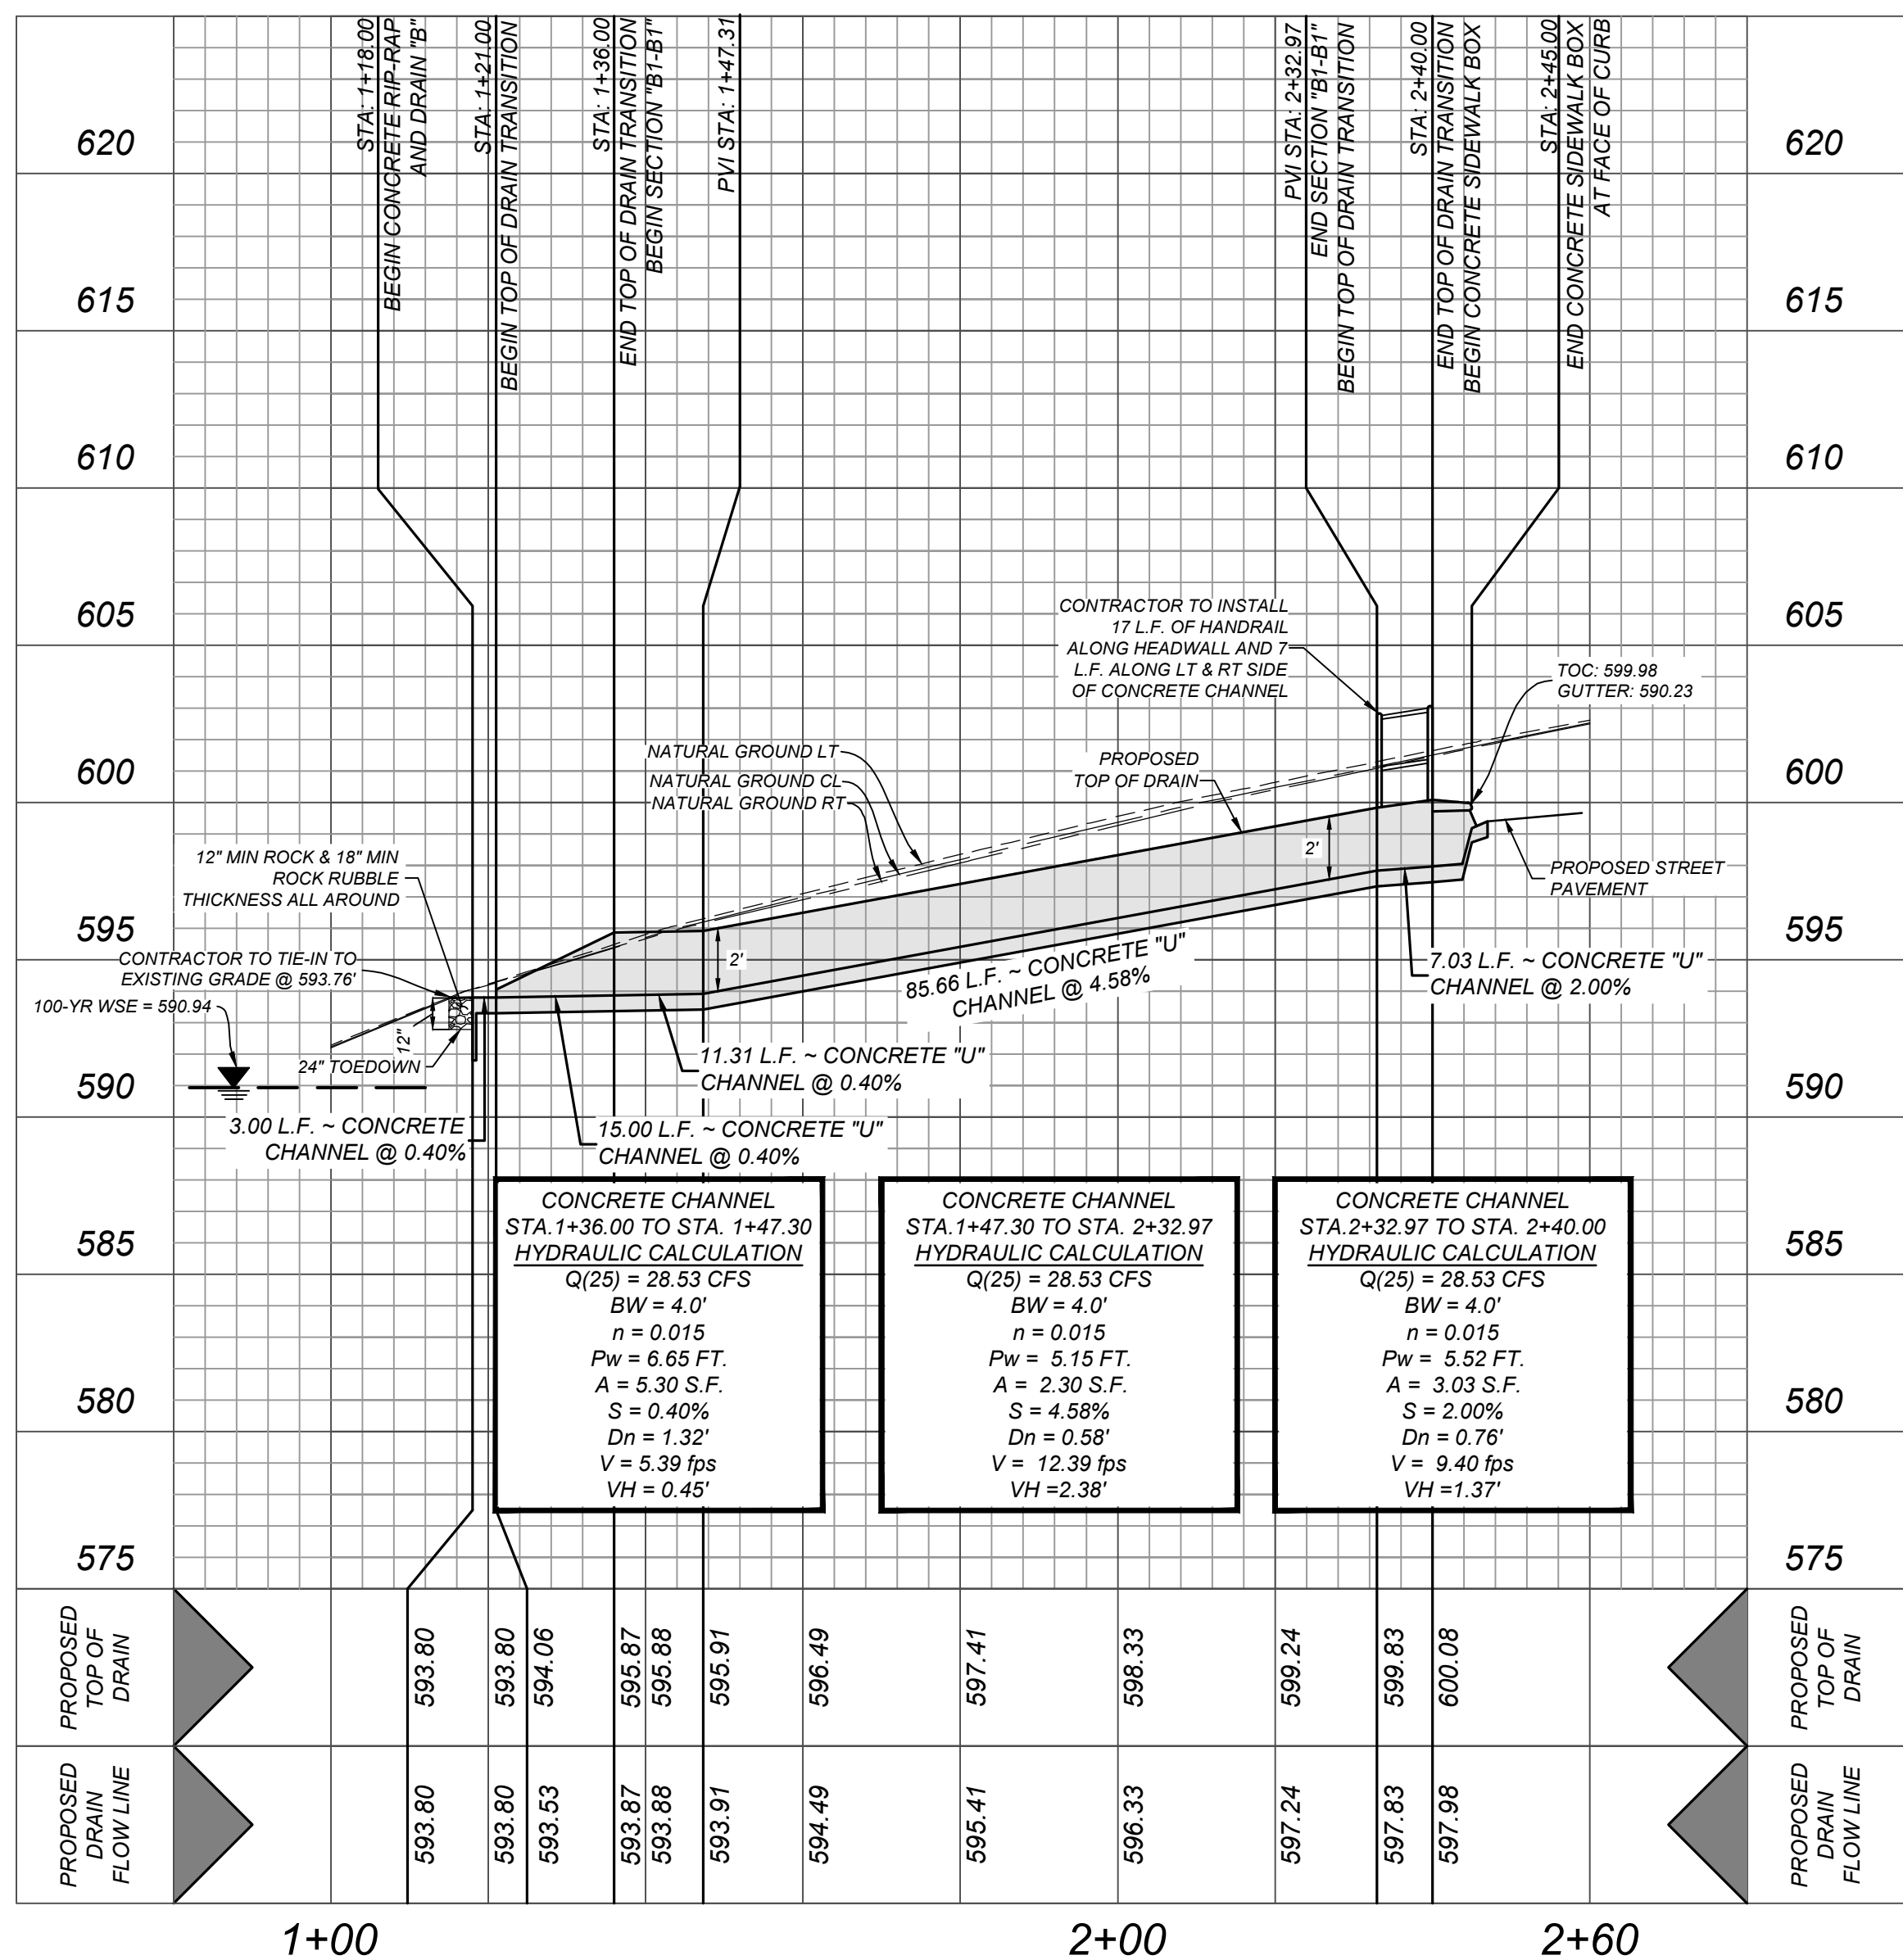

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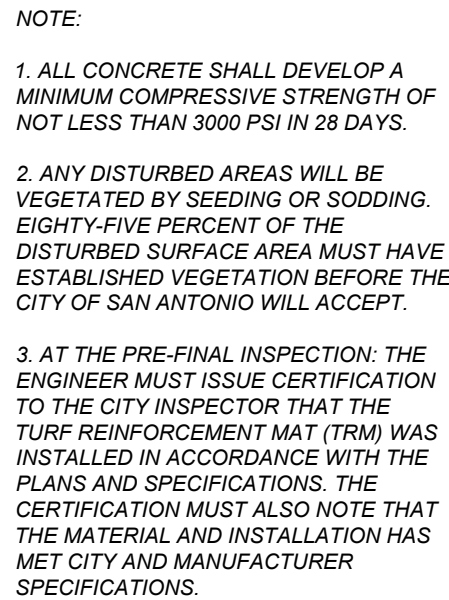
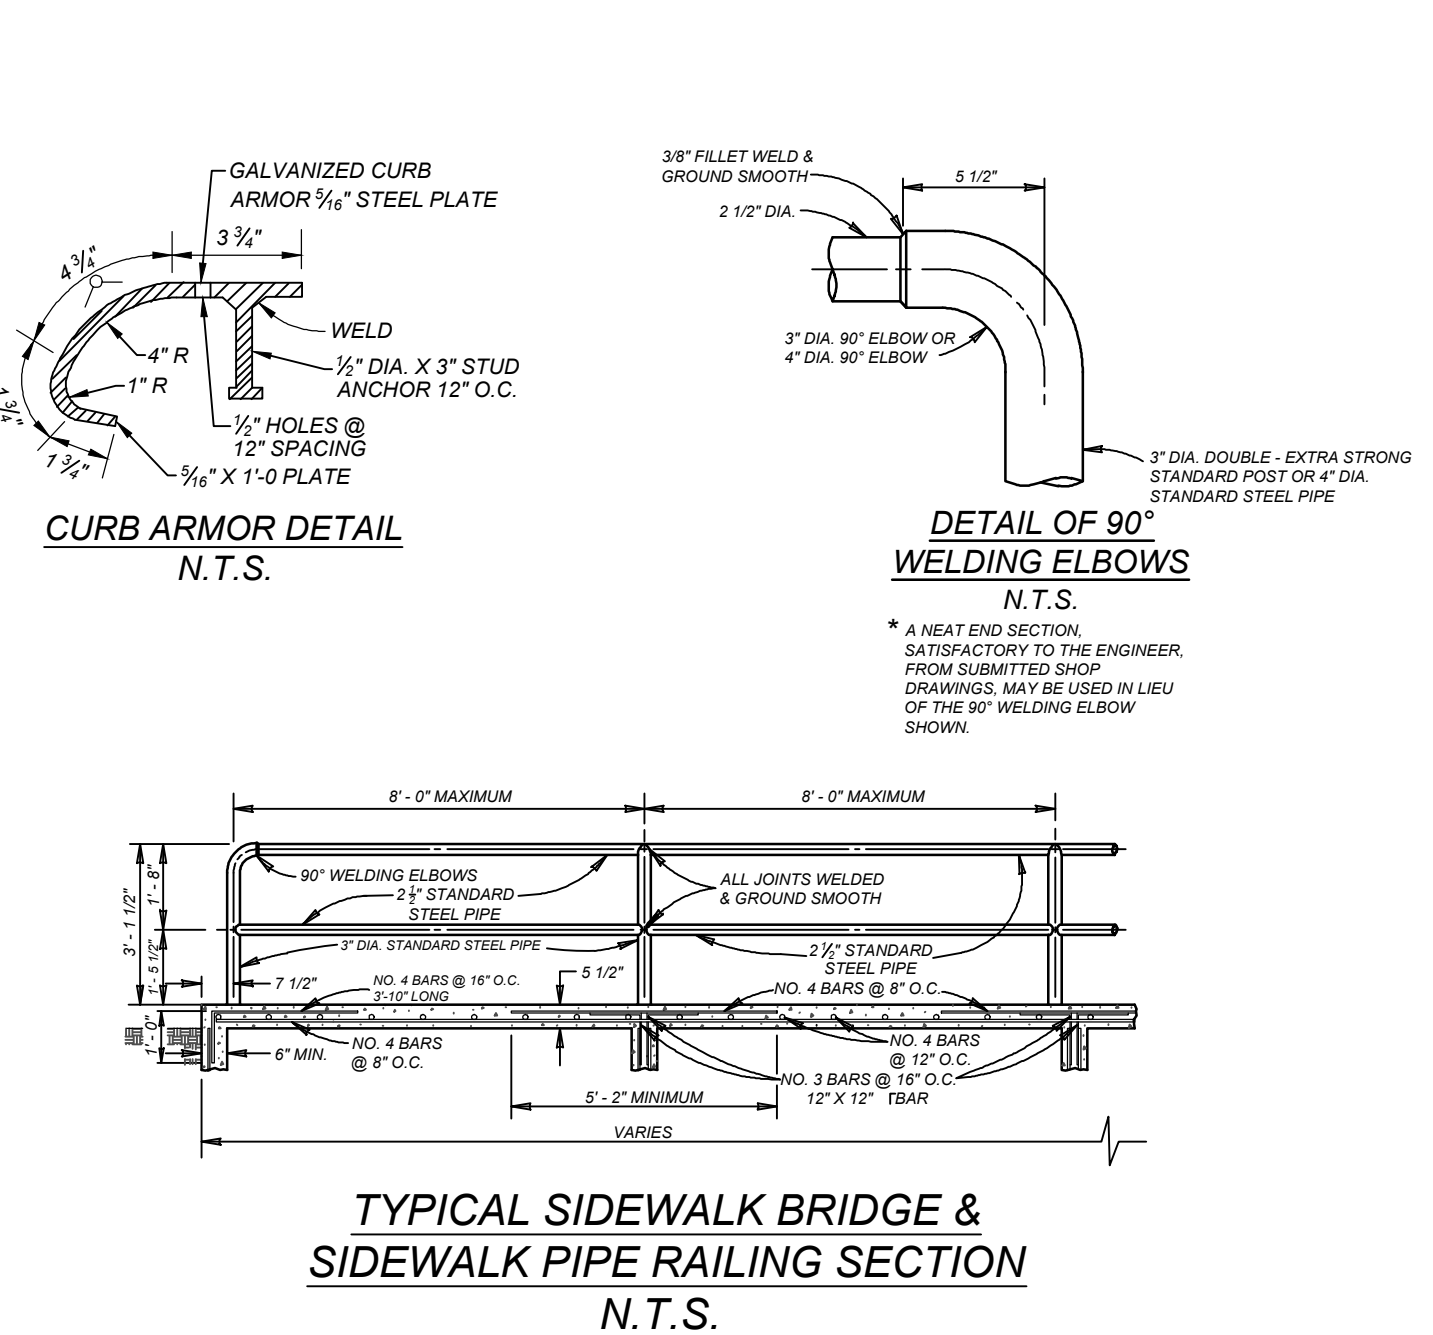
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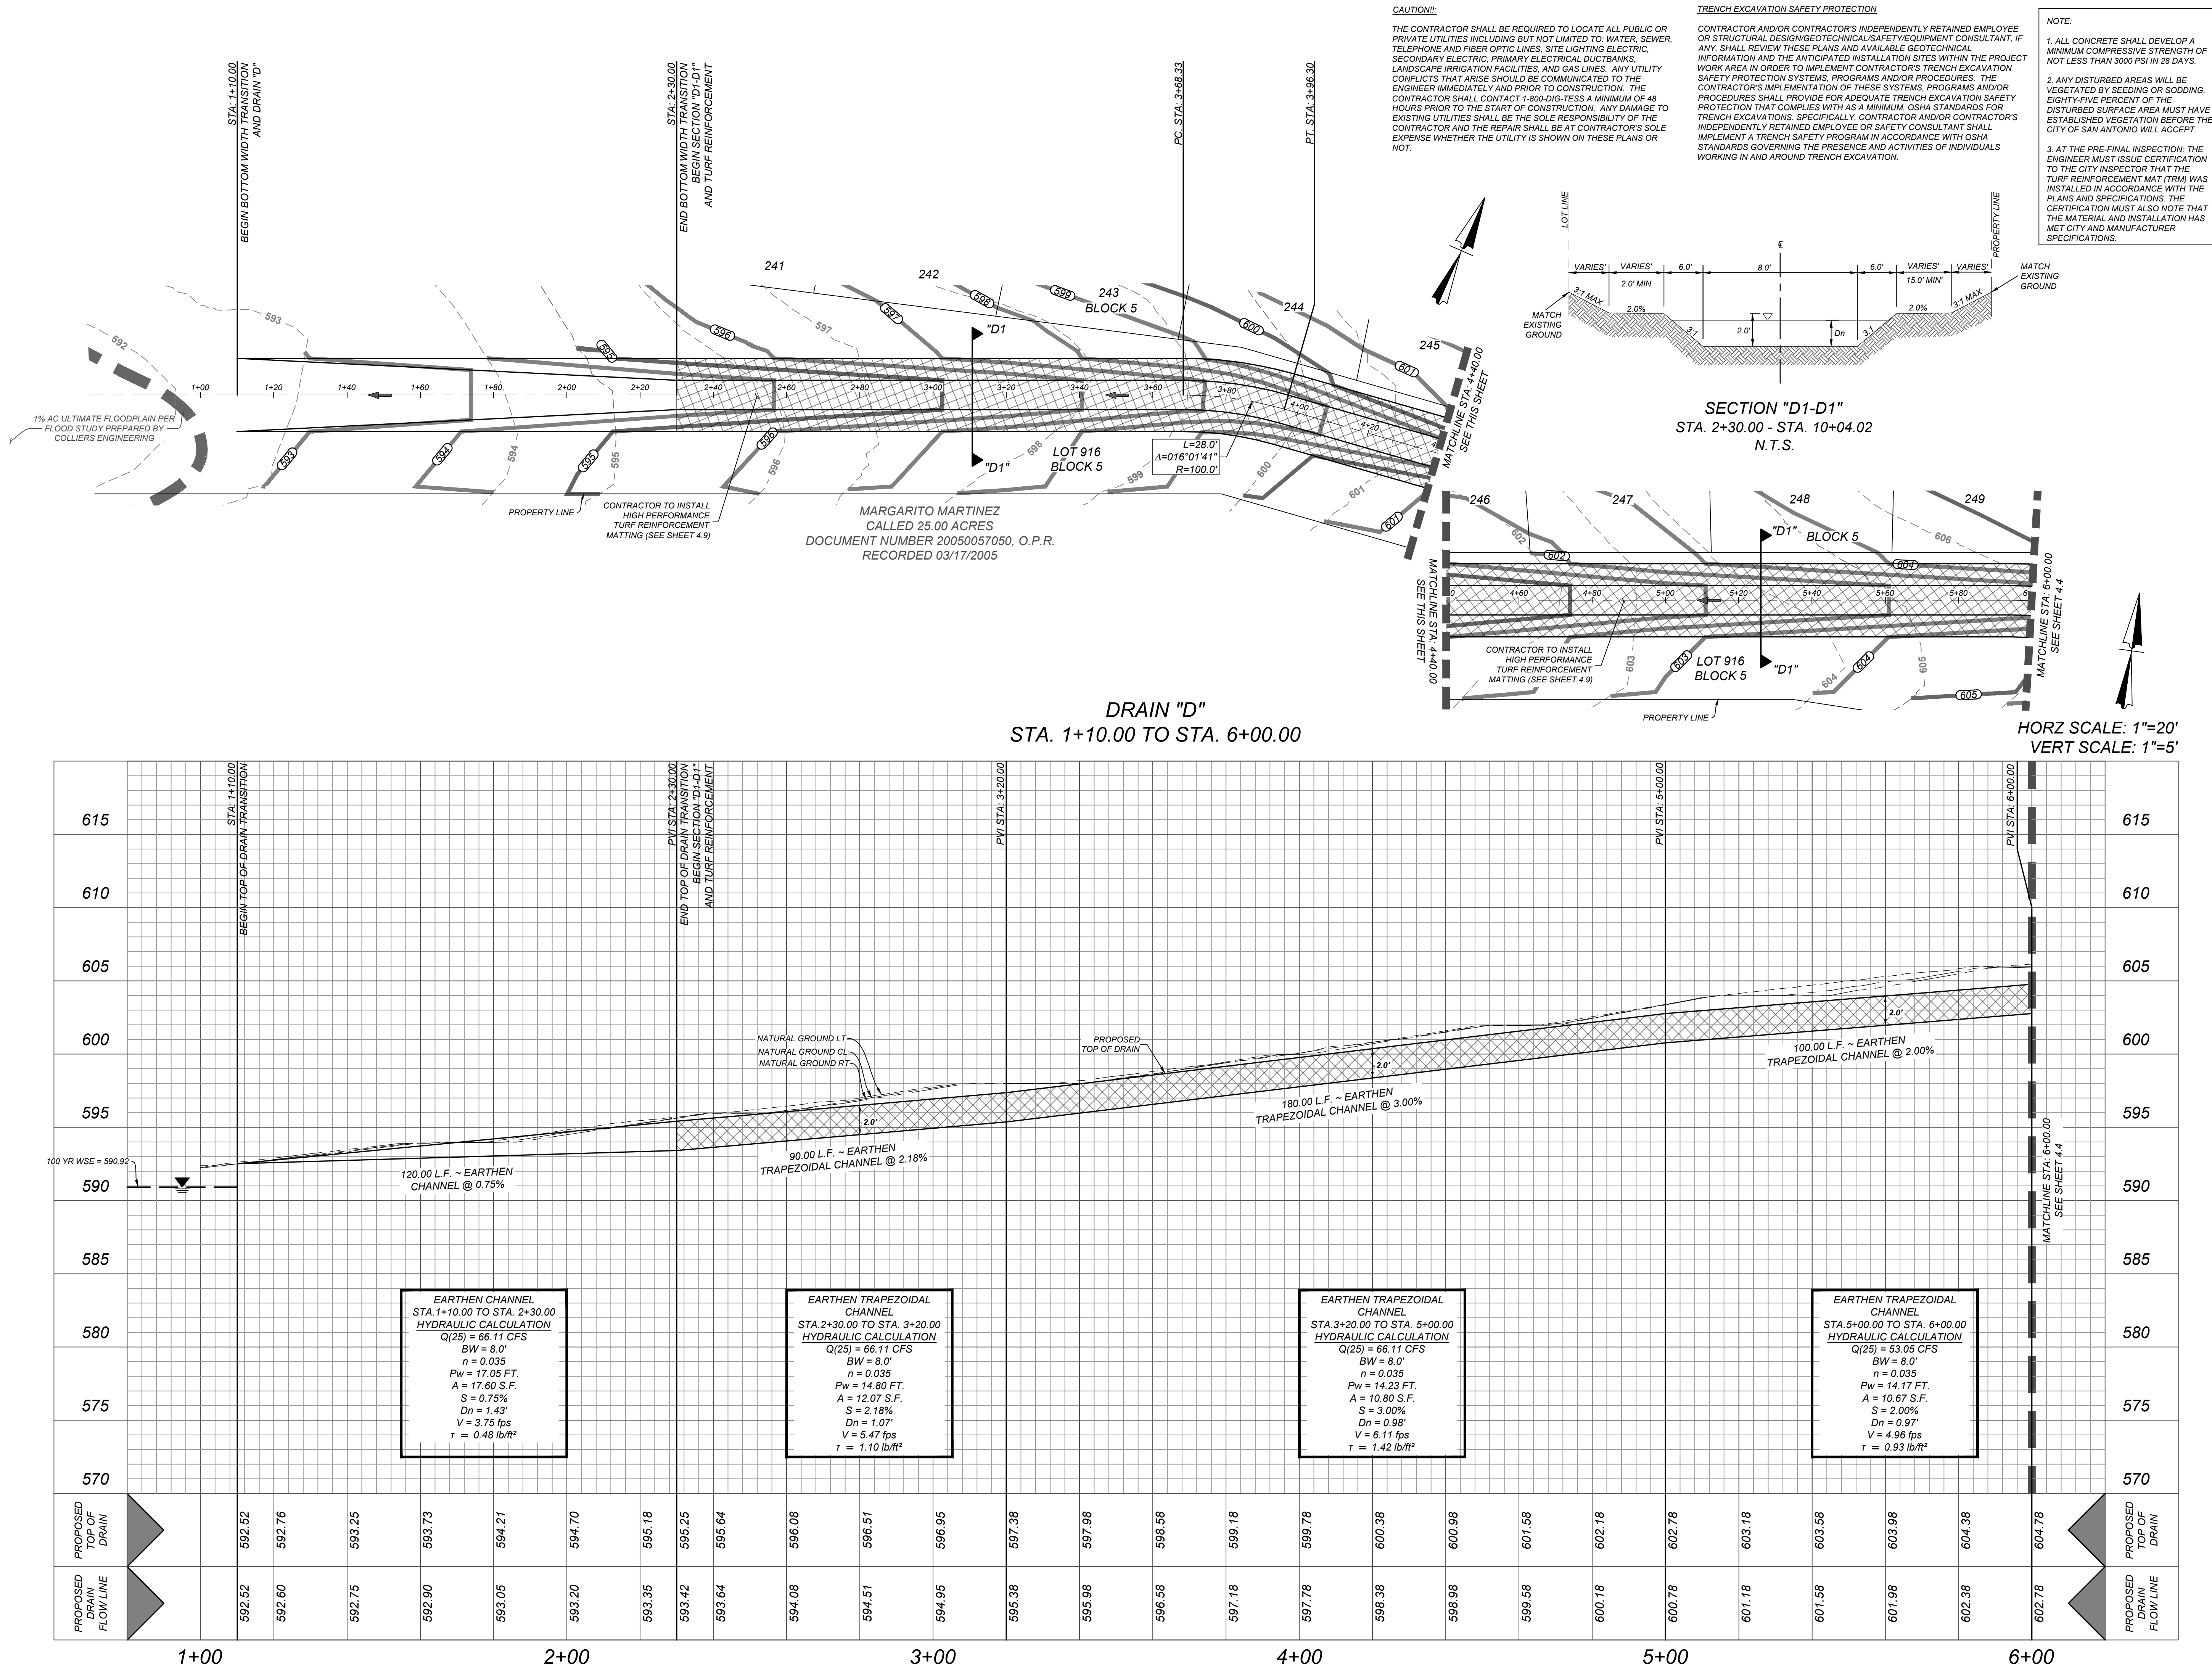
CONTRACTOR AND/OR CONTRACTOR'S INDEPENDENTLY RETAINED EMPLOYEE OR STRUCTURAL DESIGN/GEOTECHNICAL/SAFETY/EQUIPMENT CONSULTANT, IF ANY, SHALL REVIEW THESE PLANS AND AVAILABLE GEOTECHNICAL INFORMATION AND REPORT THEREON TO THE SITES WITHIN THE PROJECT WORK AREA IN ORDER TO IMPLEMENT CONTRACTOR'S TRENCH EXCAVATION SAFETY PROTECTION SYSTEMS, PROGRAMS AND/OR PROCEDURES. THE CONTRACTOR'S IMPLEMENTATION OF THESE SYSTEMS, PROGRAMS AND/OR PROCEDURES SHALL PROVIDE FOR ADEQUATE TRENCH EXCAVATION SAFETY PROTECTION THAT COMPLIES WITH AS A MINIMUM, OSHA STANDARDS FOR TRENCH EXCAVATIONS. SPECIFICALLY, CONTRACTOR AND/OR CONTRACTOR'S INDEPENDENTLY RETAINED EMPLOYEE OR SAFETY CONSULTANT SHALL COMPLY WITH TRENCH EXCAVATION SAFETY PROTECTION REQUIREMENTS AND STANDARDS GOVERNING THE PRESENCE AND ACTIVITIES OF INDIVIDUALS WORKING IN AND AROUND TRENCH EXCAVATION.

CAUTION!!



NOTE: DO NOT SCALE DRAWINGS FOR CONSTRUCTION

\\drain\dwg\2025\07 - CE\DWG\3 - By: SOPHIA NILSSON



TRENCH EXCAVATION SAFETY PROTECTION




CONTRACTOR AND/OR CONTRACTOR'S INDEPENDENTLY RETAINED EMPLOYEE OR STRUCTURAL DESIGN/GEOTECHNICAL/SAFETY/EQUIPMENT CONSULTANT, IF ANY, SHALL REVIEW THESE PLANS AND AVAILABLE GEOTECHNICAL INFORMATION AND THE ANTICIPATED INSTALLATION SITES WITHIN THE PROJECT WORK AREA IN ORDER TO IMPLEMENT CONTRACTOR'S TRENCH EXCAVATION SAFETY PROTECTION SYSTEMS, PROGRAMS AND/OR PROCEDURES. THE CONTRACTOR'S IMPLEMENTATION OF THESE SYSTEMS, PROGRAMS AND/OR PROCEDURES SHALL PROVIDE FOR ADEQUATE TRENCH EXCAVATION SAFETY PROTECTION THAT COMPLIES WITH AS A MINIMUM, OSHA STANDARDS FOR TRENCH EXCAVATIONS. SPECIFICALLY, CONTRACTOR AND/OR CONTRACTOR'S INDEPENDENTLY RETAINED EMPLOYEE OR SAFETY CONSULTANT SHALL IMPLEMENT A TRENCH SAFETY PROGRAM IN ACCORDANCE WITH OSHA STANDARDS GOVERNING THE PRESENCE AND ACTIVITIES OF INDIVIDUALS WORKING IN AND AROUND TRENCH EXCAVATION.

CAUTION!!!

THE CONTRACTOR SHALL BE REQUIRED TO LOCATE ALL PUBLIC OR PRIVATE UTILITIES INCLUDING BUT NOT LIMITED TO: WATER, SEWER, TELEPHONE AND FIBER OPTIC LINES, SITE LIGHTING ELECTRIC, SECONDARY ELECTRIC, PRIMARY ELECTRICAL DUCTBANKS, LANDSCAPE IRRIGATION FACILITIES, AND GAS LINES. ANY UTILITY CONFLICTS THAT ARISE SHOULD BE COMMUNICATED TO THE ENGINEER IMMEDIATELY AND PRIOR TO CONSTRUCTION. THE CONTRACTOR SHALL CONTACT 1-800-DIG-TESS A MINIMUM OF 48 HOURS PRIOR TO THE START OF CONSTRUCTION. ANY DAMAGE TO EXISTING UTILITIES SHALL BE THE SOLE RESPONSIBILITY OF THE CONTRACTOR AND THE REPAIR SHALL BE AT CONTRACTOR'S SOLE EXPENSE WHETHER THE UTILITY IS SHOWN ON THESE PLANS OR NOT.

CHANNEL LINING:

AREA'S EXCEEDING CITY OF SAN ANTONIO PERMISSIBLE SHEAR STRESS WILL BE REINFORCED WITH PROPOSED TURF REINFORCEMENT MAT (TRM) AS APPROVED BY CITY OF SAN ANTONIO STANDARD SPECIFICATIONS UNDER CONSTRUCTION ITEM 554.

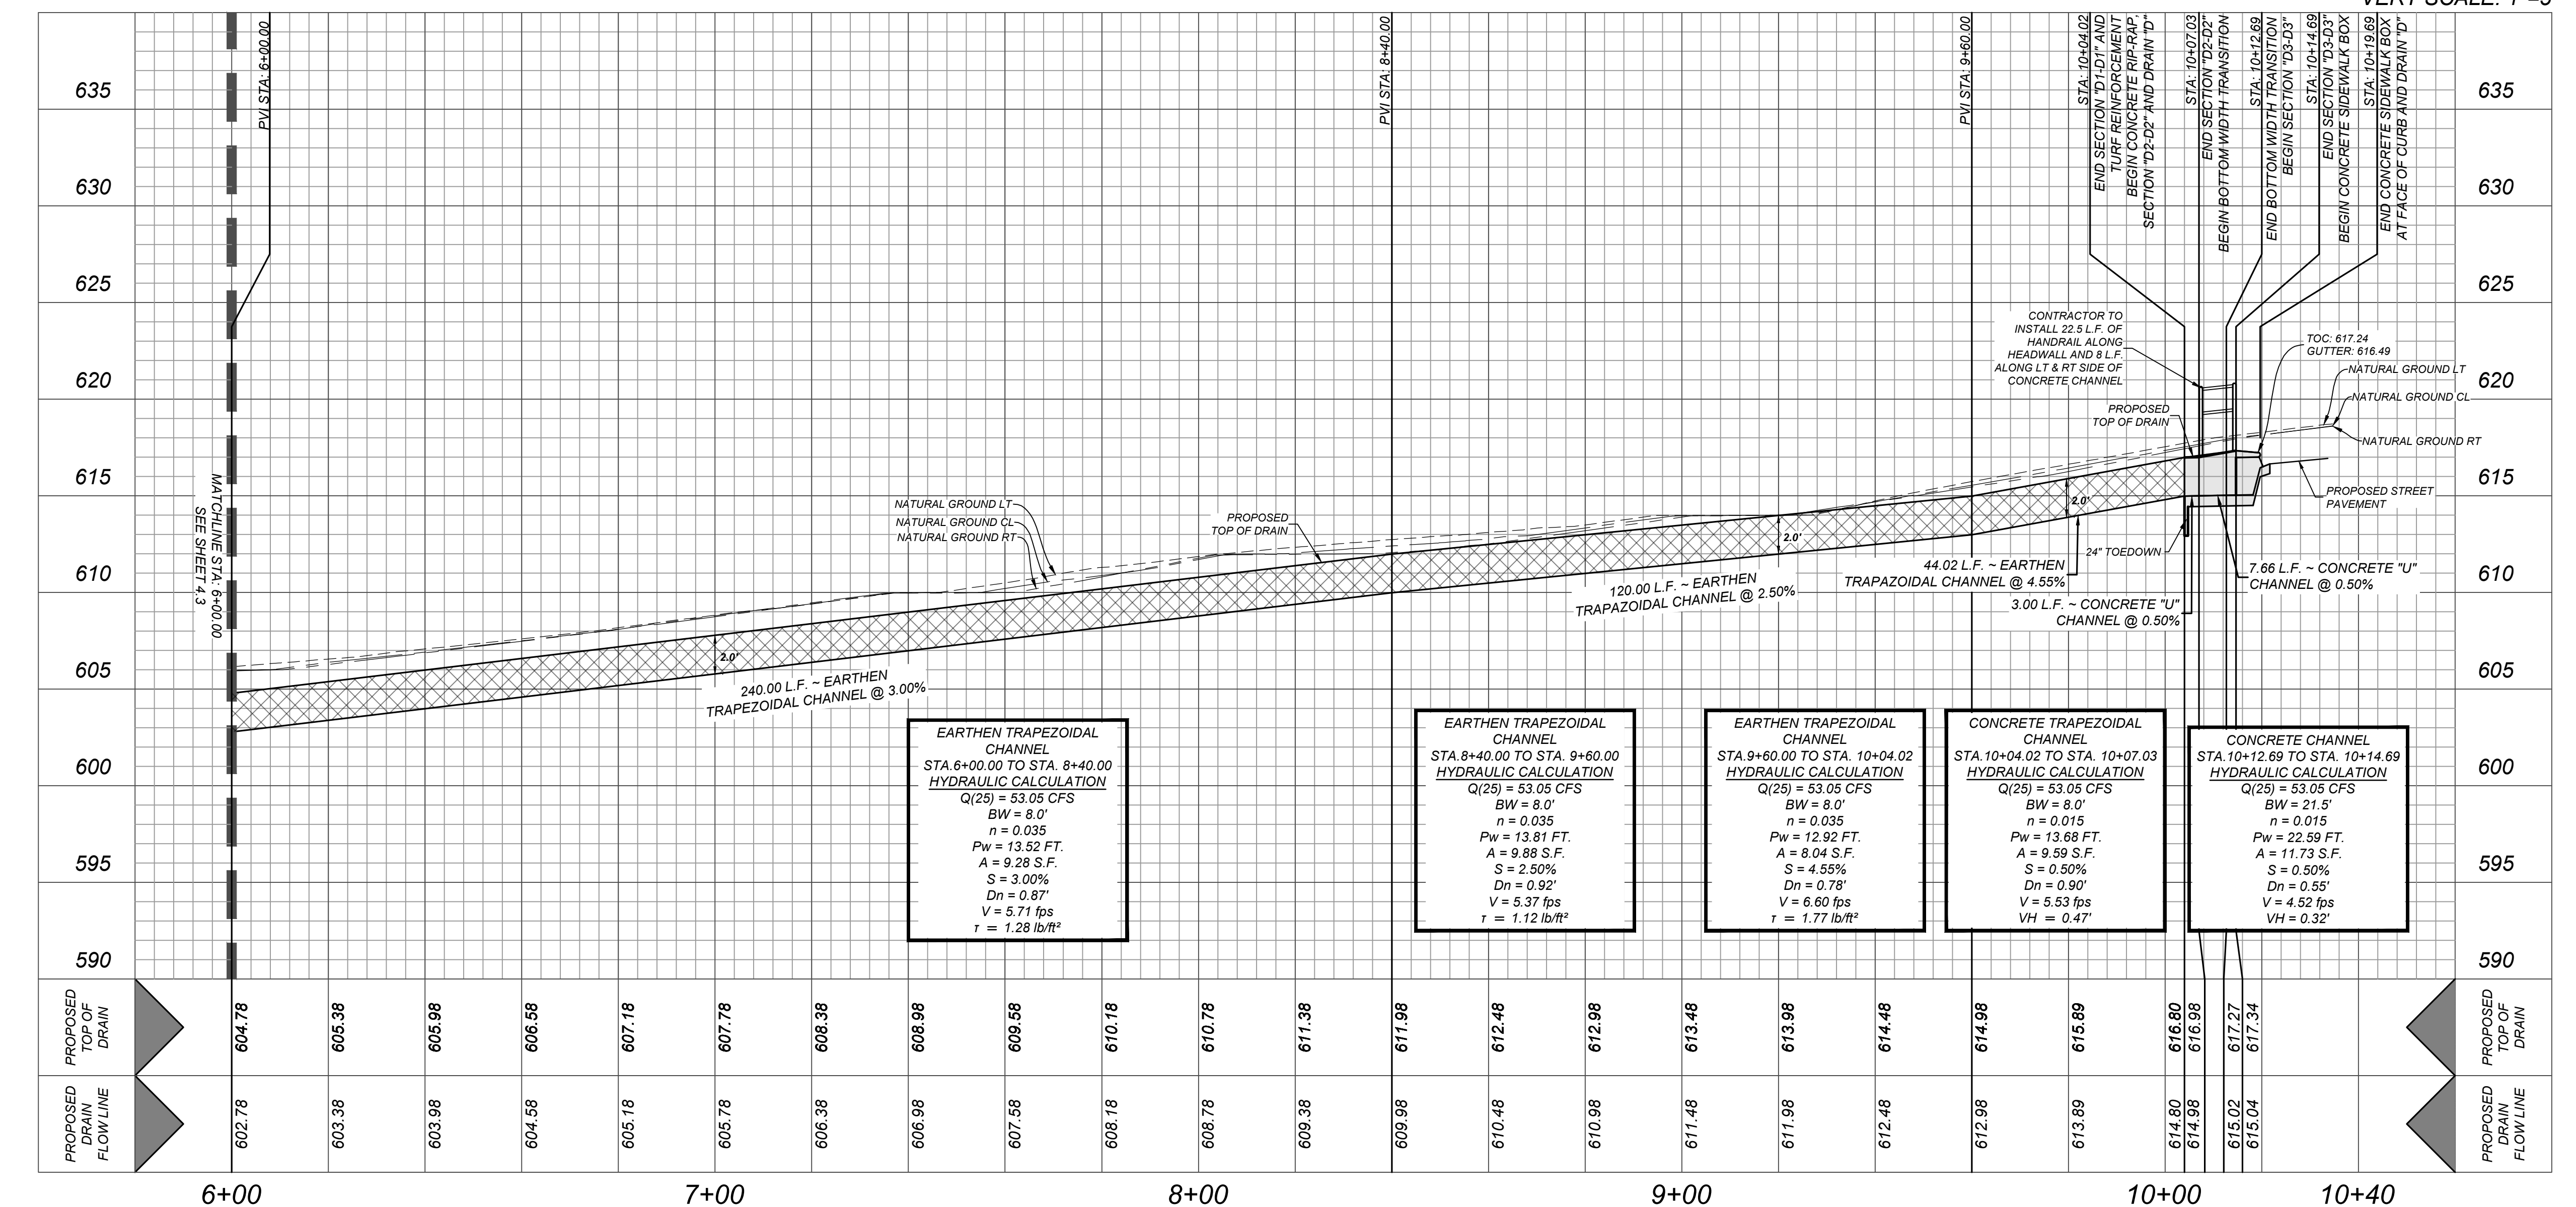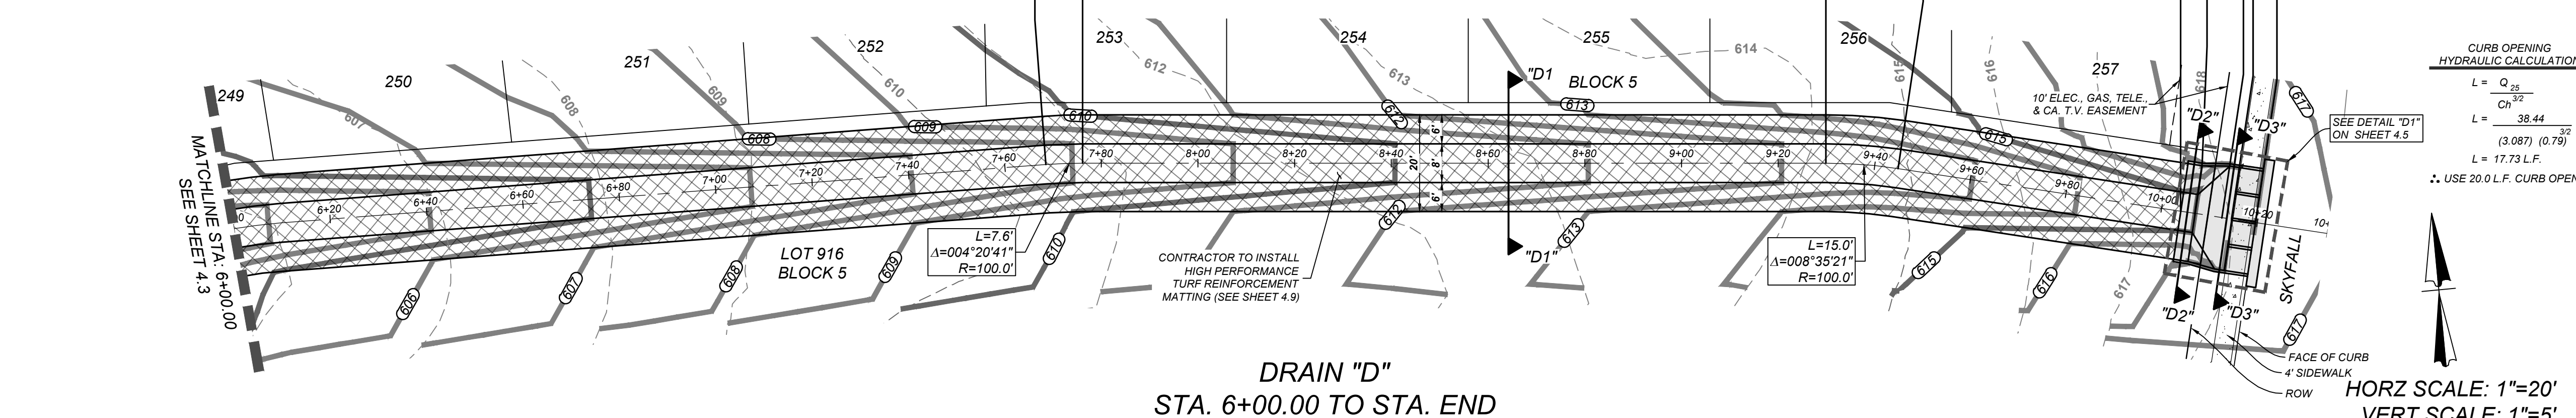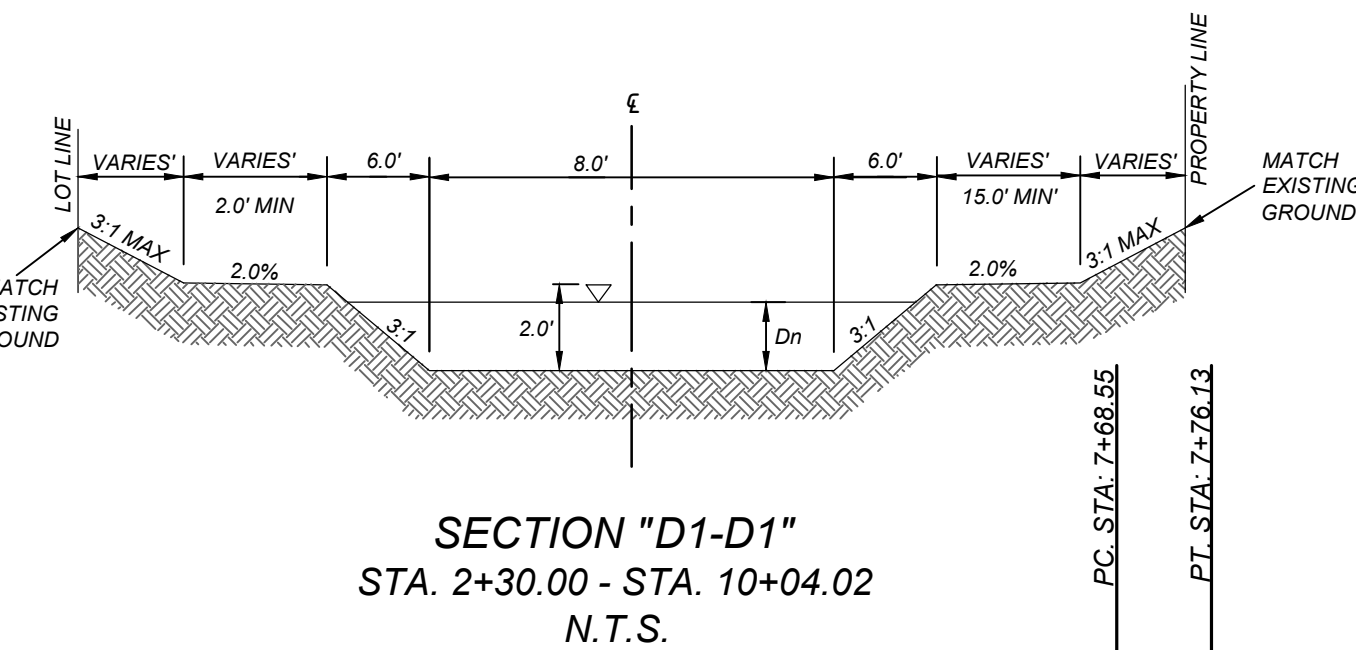

NOTE:
1. ALL CONCRETE SHALL DEVELOP A MINIMUM COMPRESSIVE STRENGTH OF NOT LESS THAN 3000 PSI IN 28 DAYS.
2. ANY DISTURBED AREAS WILL BE VEGETATED BY SEEDING OR SODDING. EIGHTY-FIVE PERCENT OF THE DISTURBED SURFACE AREA MUST HAVE ESTABLISHED VEGETATION BEFORE THE CITY OF SAN ANTONIO WILL ACCEPT.
3. AT THE PRE-FINAL INSPECTION: THE ENGINEER MUST ISSUE CERTIFICATION TO THE CITY INSPECTOR THAT THE TURF REINFORCEMENT MAT (TRM) WAS INSTALLED IN ACCORDANCE WITH THE PLANS AND SPECIFICATIONS. THE CERTIFICATION MUST ALSO NOTE THAT THE MATERIAL AND INSTALLATION HAS MET CITY AND MANUFACTURER SPECIFICATIONS.

CURB OPENING
HYDRAULIC CALCULATION
 $L = \frac{Q_{25}}{Cn^{1.49}}$
 $L = \frac{38.44}{(3.087)^{1.49}}$
 $L = 17.73 \text{ L.F.}$
.. USE 20.0 L.F. CURB OPENING

HORZ SCALE: 1"=20'
VERT SCALE: 1"=5'



Engineering
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6/28/24

PRELIMINARY

FOR
SOUTHEAST
MEADOWS UNIT 3
PLAT# 23-11800440

SAN ANTONIO
BEXAR COUNTY
TEXAS

Colliers
Engineering
& Design
SAN ANTONIO (KFW)
3421 Paesanos
Parkway
San Antonio, TX 78231
Phone: 210.979.8444
COLLIERS ENGINEERING & DESIGN, INC.
TBP# FPM# 151-0409
TBP#S FPM# 10194550




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DATE: 07/20/2023
DRAWN BY: SD
CHECKED BY: SC
PROJECT NUMBER: 205-43-07
DRAWING NAME: DR2054307 - CE

SHEET TITLE:
DRAIN "D" PLAN &
PROFILE (2 OF 3)

SHEET NUMBER:
4.4

NOTE: DO NOT SCALE DRAWINGS FOR CONSTRUCTION.

CONTRACTOR AND/OR CONTRACTOR'S INDEPENDENTLY RETAINED EMPLOYEE OR STRUCTURAL DESIGN/GEOTECHNICAL/SAFETY/EQUIPMENT CONSULTANT, IF ANY, SHALL REVIEW THESE PLANS AND AVAILABLE GEOTECHNICAL INFORMATION AND THE ANTICIPATED INSTALLATION SITES WITHIN THE PROJECT AREA TO DETERMINE THE APPROPRIATE TRENCH EXCAVATION SAFETY PROTECTION SYSTEMS, PROGRAMS AND/OR PROCEDURES. THE CONTRACTOR'S IMPLEMENTATION OF THESE SYSTEMS, PROGRAMS AND/OR PROCEDURES SHALL PROVIDE FOR ADEQUATE TRENCH EXCAVATION SAFETY PROTECTION THAT COMPLIES WITH AS A MINIMUM, OSHA STANDARDS FOR TRENCH EXCAVATIONS. SPECIFICALLY, CONTRACTOR AND/OR CONTRACTOR'S INDEPENDENTLY RETAINED EMPLOYEE OR SAFETY CONSULTANT SHALL IMPLEMENT A TRENCH SAFETY PROGRAM IN ACCORDANCE WITH OSHA STANDARDS GOVERNING THE PRESENCE AND ACTIVITIES OF INDIVIDUALS WORKING IN AND AROUND TRENCH EXCAVATION.

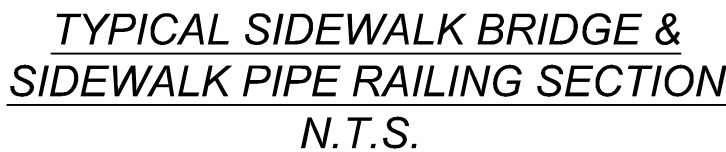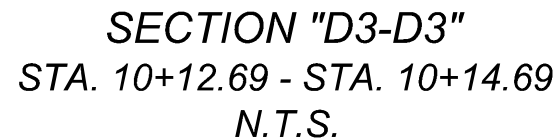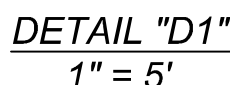

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REV	DATE	DRAWN BY	DESCRIPTION
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FOR
SOUTHEAST
MEADOWS UNIT 3
PLAT# 23-11800440

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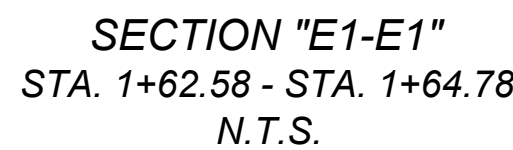
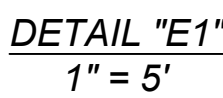
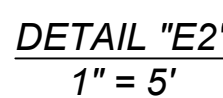
SCALE: AS SHOWN	DATE: 07/20/2023	DRAWN BY: SD	CHECKED BY: SC
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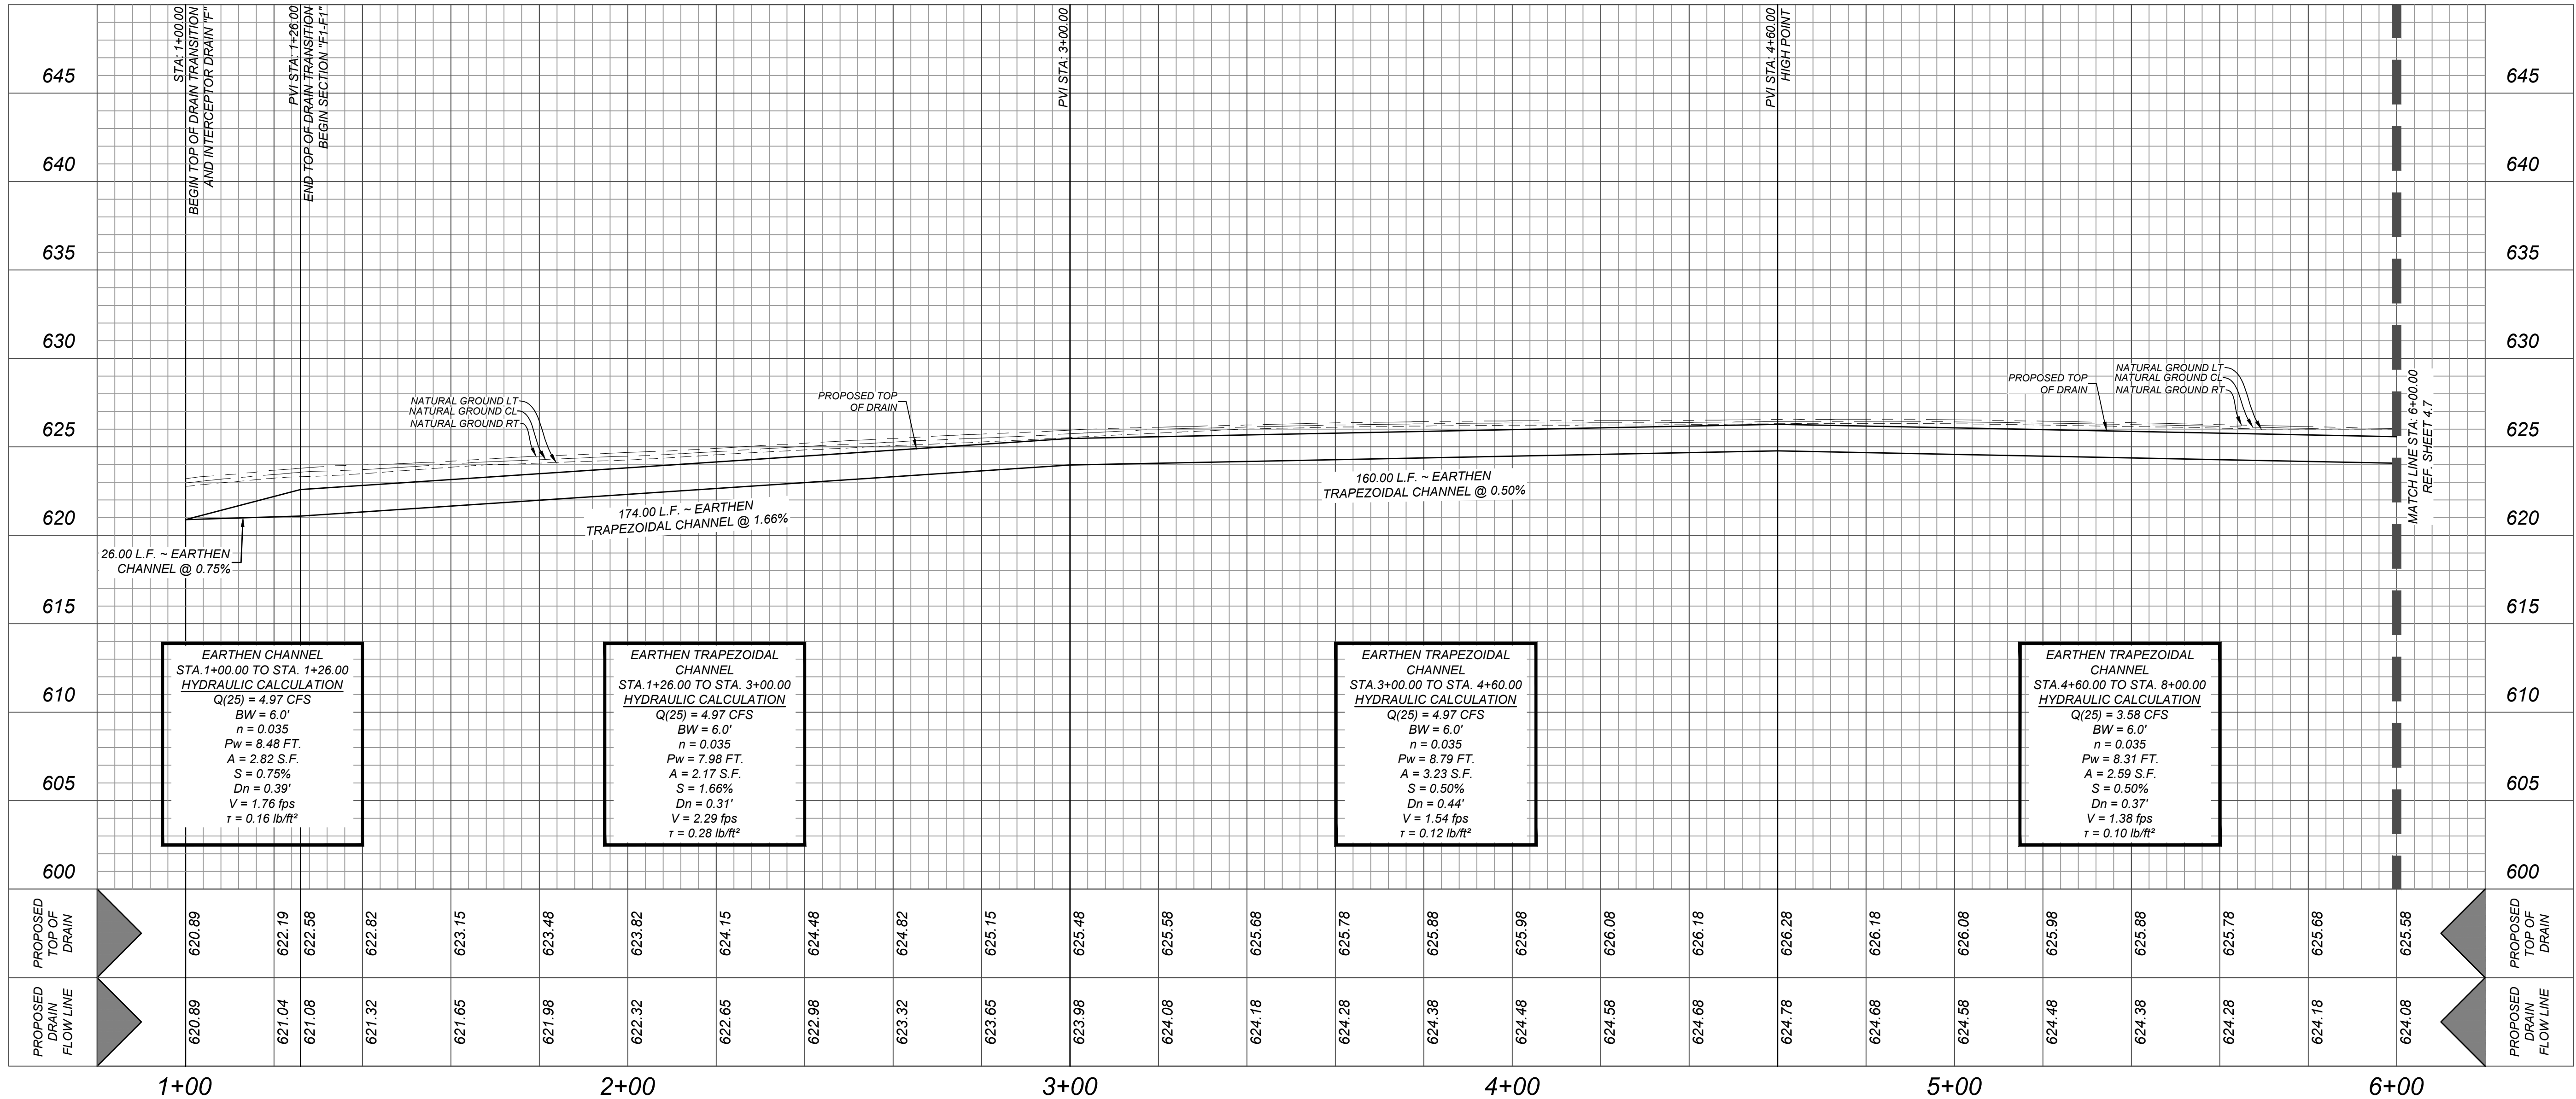
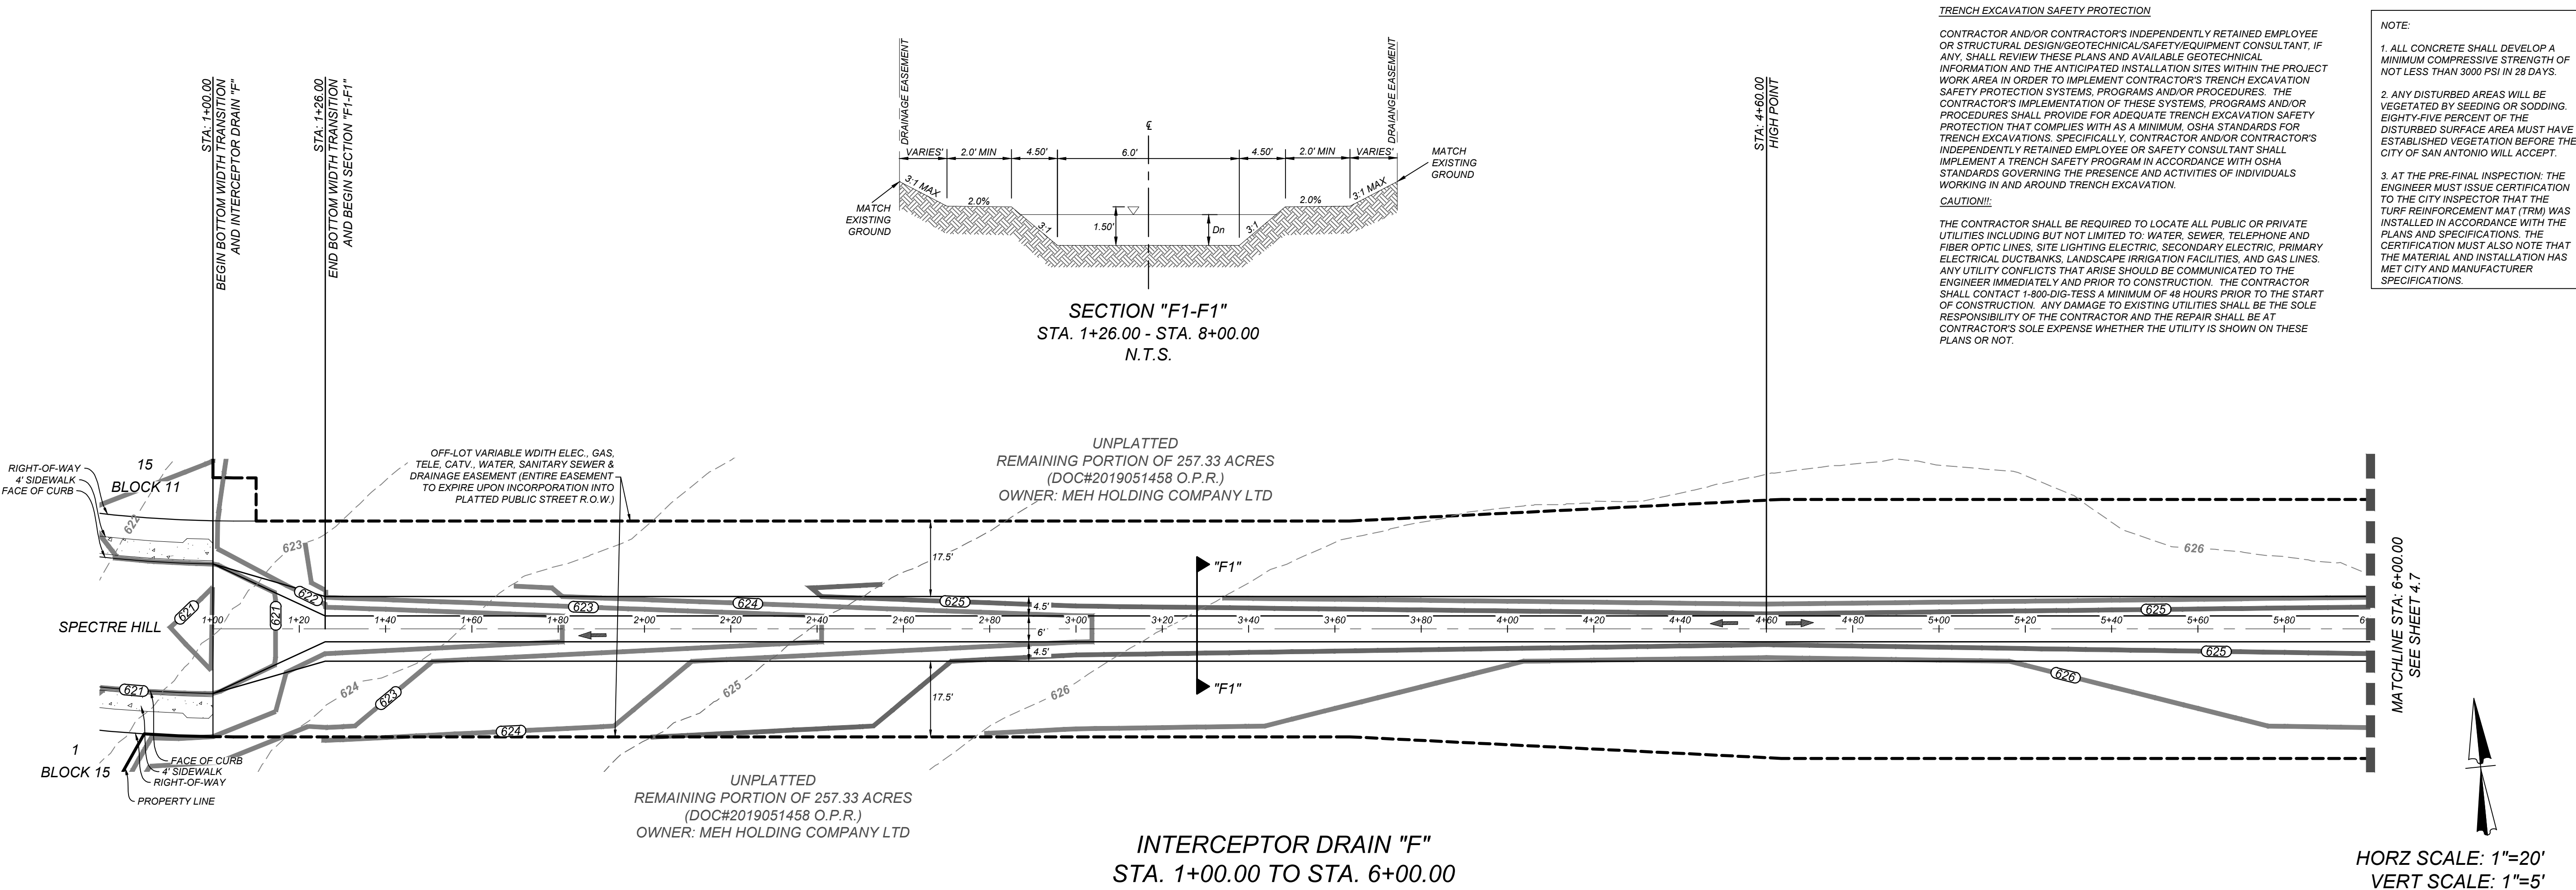
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NOTE: DO NOT SCALE DRAWINGS FOR CONSTRUCTION

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STATE OF TEXAS

JEFFREY W. MARTIN

139094

5/17/24

PRELIMINARY

FOR SOUTHEAST MEADOWS UNIT 3 PLAT# 23-11800440

SAN ANTONIO BEXAR COUNTY TEXAS

Colliers Engineering & Design

SAN ANTONIO (KFW)



3421 Paesanos Parkway
San Antonio, TX 78231
Phone: 210.979.8444
COLLIERS ENGINEERING & DESIGN, INC.
TBE's Form # 1-1600
TBE's Form # 10194550

SCALE: AS SHOWN DATE: 07/20/2023 DRAWN BY: SD CHECKED BY: SC


PROJECT NUMBER: 205-43-07 DRAWING NAME: DR2054307 - F

SHEET TITLE: INTERCEPTOR DRAIN "F" PLAN & PROFILE (1 OF 2)

SHEET NUMBER: 4.7

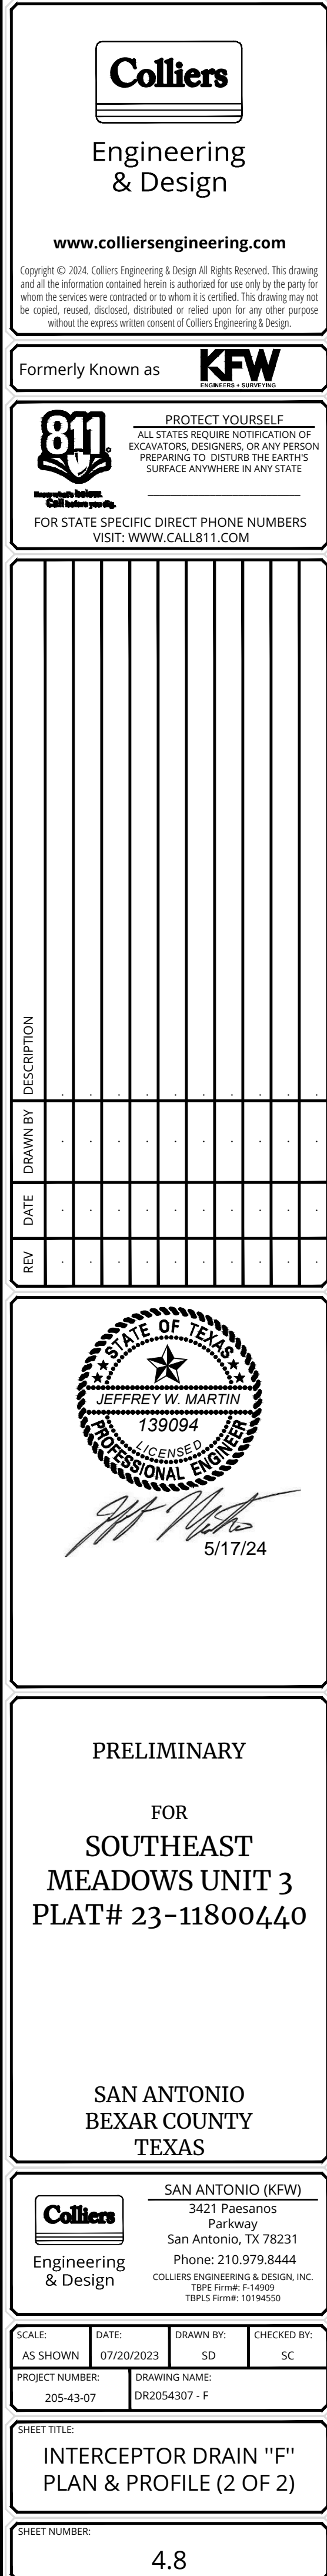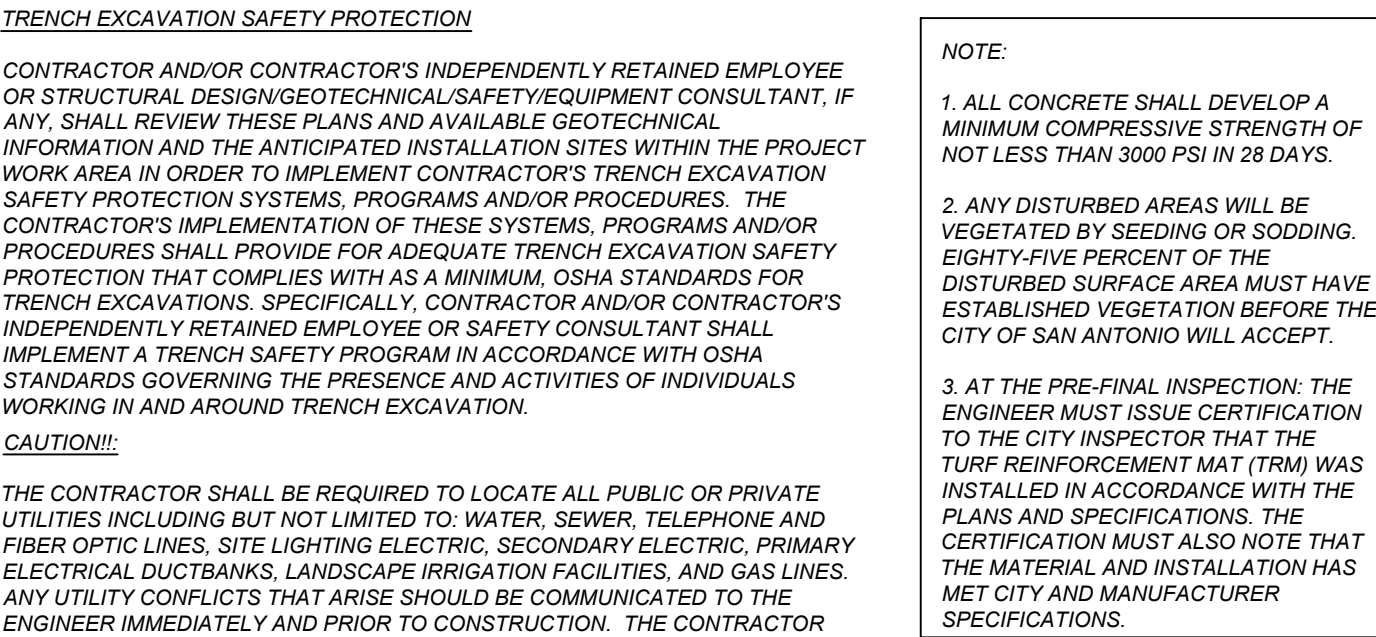

NOTE: DO NOT SCALE DRAWINGS FOR CONSTRUCTION

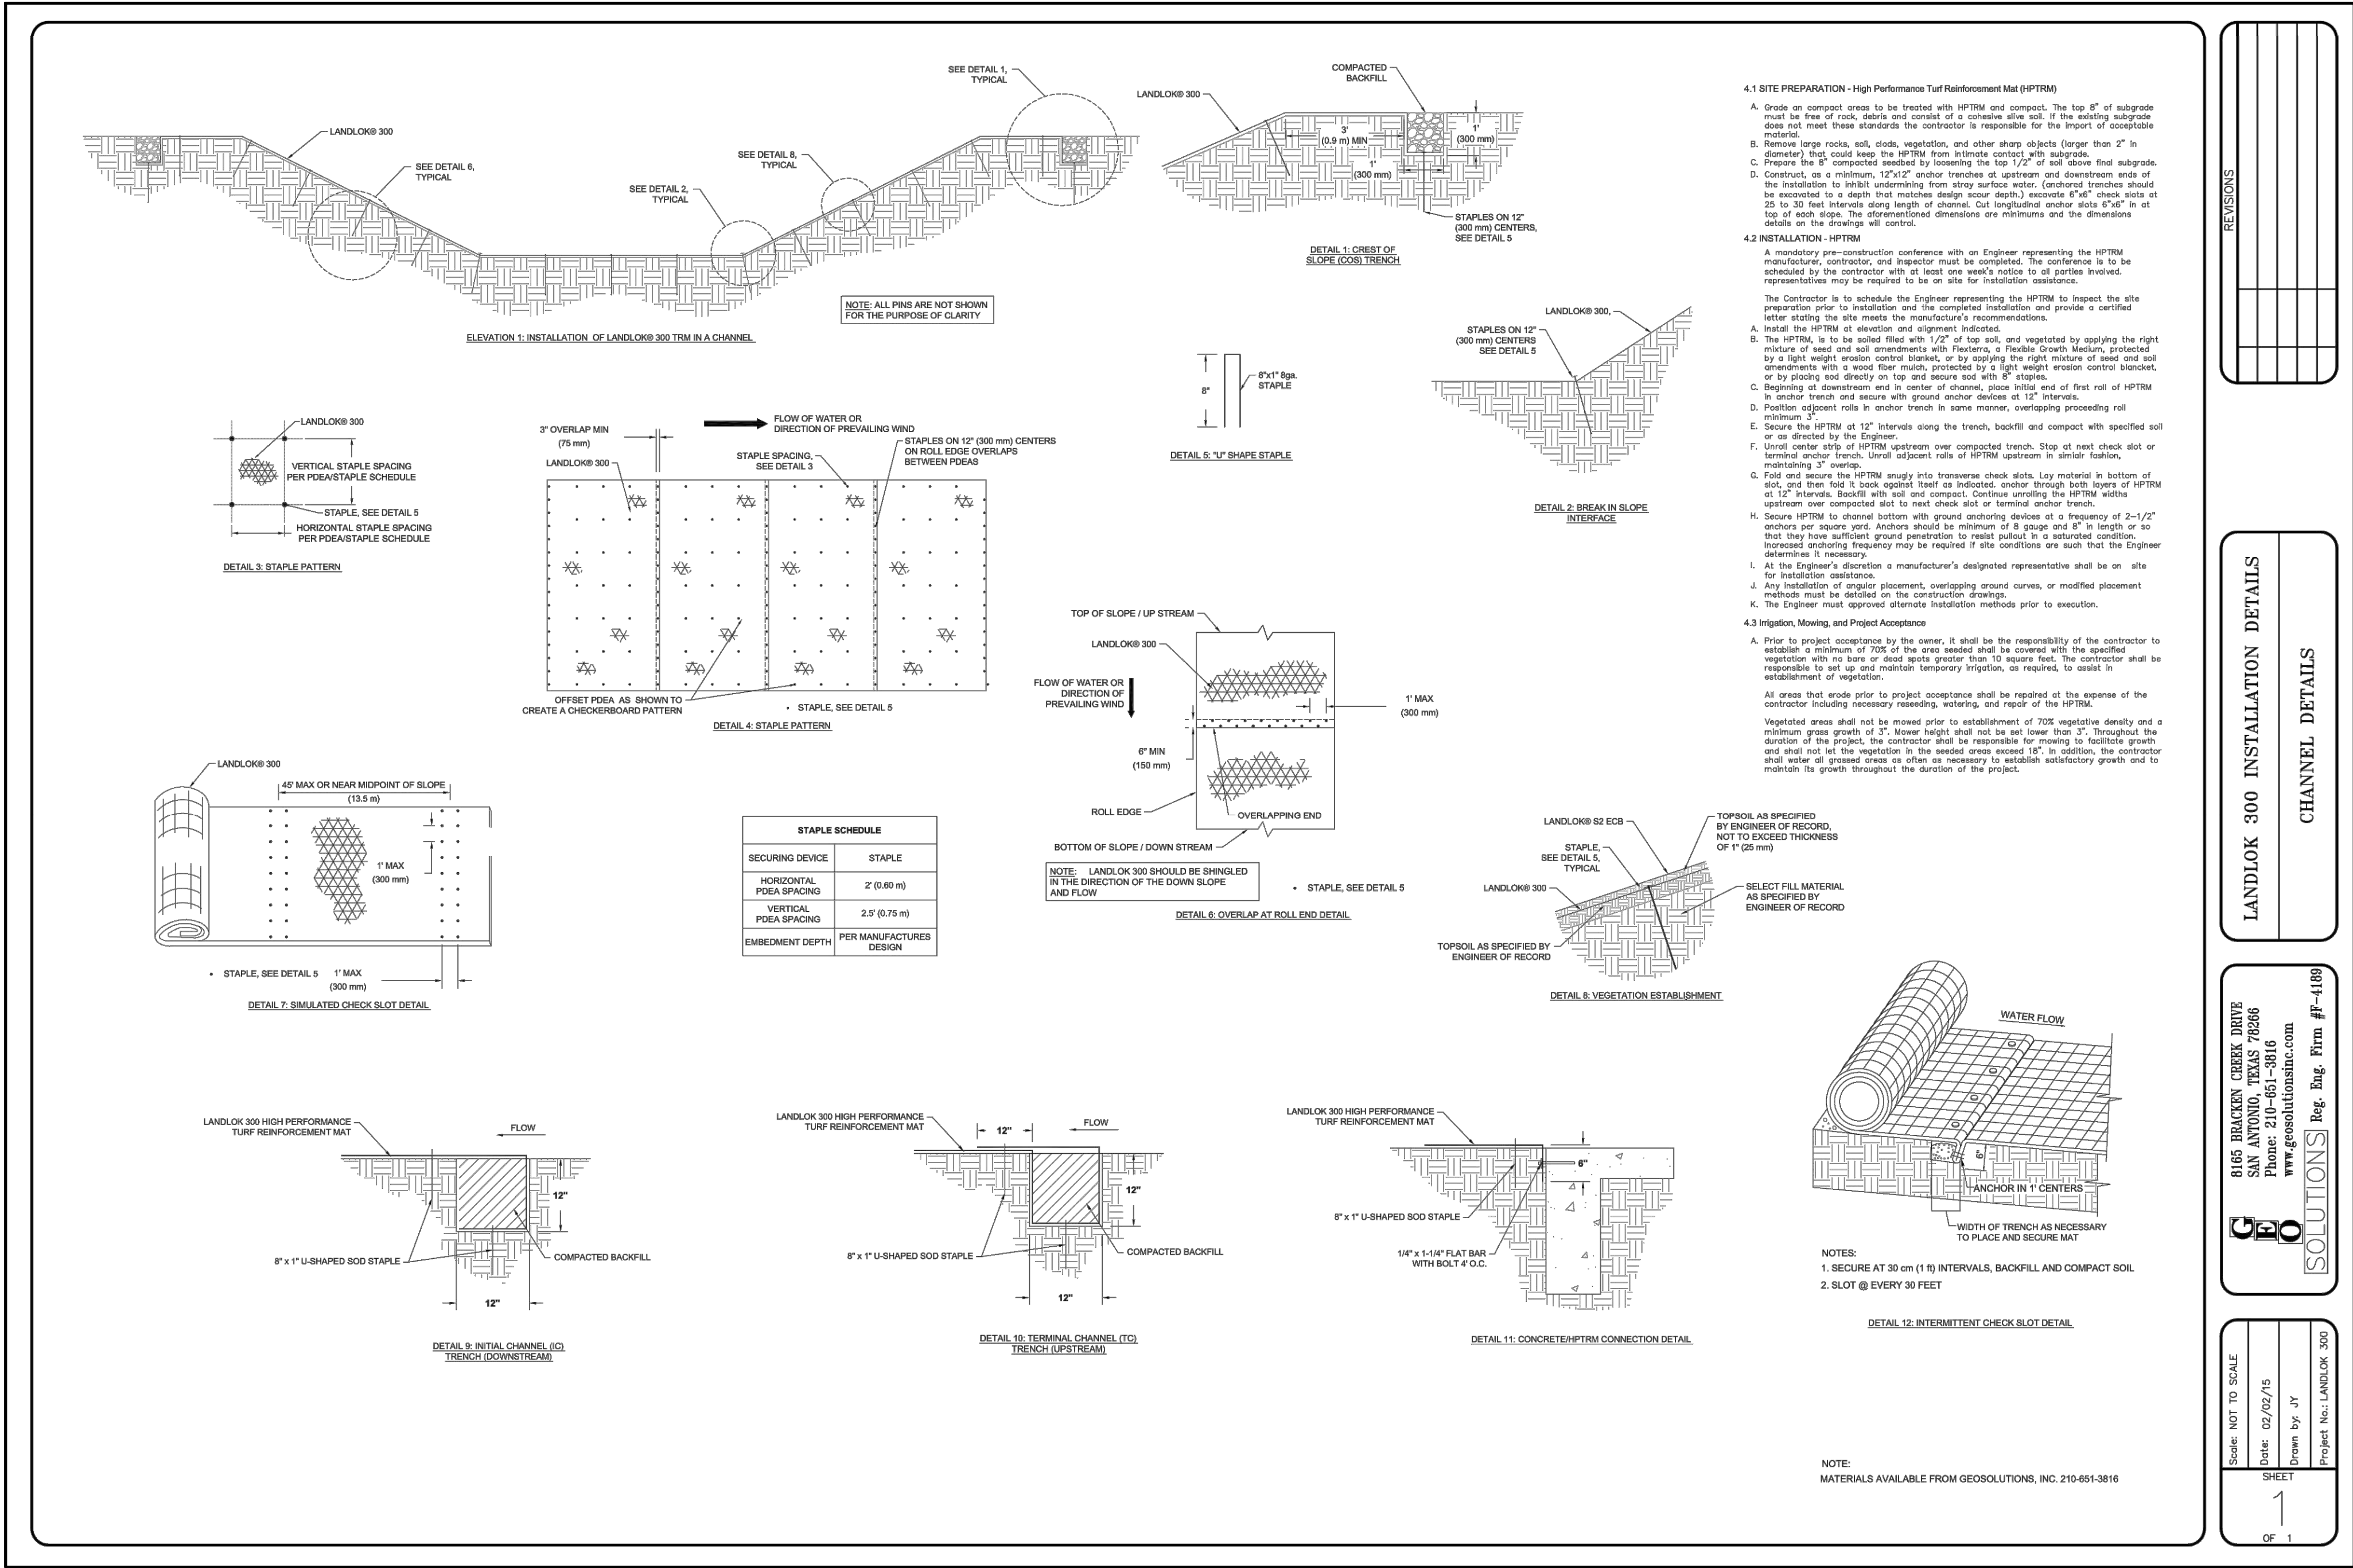

LANDLOK 300[®] high performance turf reinforcement mat (HPTRM) is a three-dimensional, lofty, woven polypropylene geotextile that is available in green or tan which is specially designed for erosion control applications on steep slopes and vegetated waterways. The matrix is composed of polypropylene monofilament yarns **featuring X3[®] technology** woven into a uniform configuration of resilient pyramid-like projections. The material exhibits very high interlock and reinforcement capacity with both soil and root systems, demonstrates superior UV resistance, and enhances seedling emergence.

LANDLOK 300[®] conforms to the property values listed below¹ and is manufactured at a Propex facility having achieved ISO 9001:2000 certification. Propex performs internal Manufacturing Quality Control (MQC) tests that have been accredited by The Geosynthetic Accreditation Institute - Laboratory Accreditation Program (GAI-LAP).

MARV ²			
PROPERTY	TEST METHOD	ENGLISH	METRIC
ORIGIN OF MATERIALS			
% U.S. Manufactured Inputs		100%	100%
% U.S. Manufactured		100%	100%
PHYSICAL			
Mass/Unit Area	ASTM D-6566	7.5 oz/yd ²	254.3 g/m ²
Thickness	ASTM D-6525	0.25 in	6.35 mm
Light Penetration (% Passing)	ASTM D-6567	50% (Max)	50%
Color	Visual	Green or Tan	
MECHANICAL			
Tensile Strength (Grab)	ASTM D-6818	2000 x 1800 lb/ft	29.2 x 26.3 kN/m
Elongation	ASTM D-6818	50% (max)	50% (max)
Resiliency	ASTM D-6524	70%	70%
Flexibility	ASTM D-6575	0.195 in-lb (avg)	10.8 mg-cm (avg)
ENDURANCE			
UV Resistance % Retained 3000 hrs	ASTM D-4355	90%	90%
PERFORMANCE			
Velocity ³ (Vegetated)	Large Scale	20 ft/sec	6.10 m/sec
Shear Stress ³ (Vegetated)	Large Scale	12 lb/ft ²	575 Pa
Manning's "n" ⁴ (Unvegetated)	Calculated	0.030	0.030
Seeding Emergence ⁴	ECTC Draft Method #4	-	-
ROLL SIZES		8.5 ft x 106 ft	2.6 m x 32.3 m

NOTES:
1. The property values listed are effective 04/2011 and are subject to change without notice.
2. MARV indicates minimum average roll value calculated as the typical minus two standard deviations. Statistically, it yields a 97.7% degree of confidence that any sample taken during quality assurance testing will exceed the value reported.
3. Maximum permissible velocity and shear stress has been obtained through vegetated testing programs featuring specific soil types, vegetation classes, flow conditions, and failure criteria. These conditions may not be relevant to every project nor are they replicated by other manufacturers. Please contact Propex for further information.
4. Calculated as typical values from large-scale flexible channel lining test programs with a flow depth of 6 to 12 inches.



Propex Operating Company, LLC - 6025 Lee Highway, Suite 425 - PO Box 22788 - Chattanooga, TN 37422
ph 423 899 0444 - ph 800 621 1273 - fax 423 899 7619

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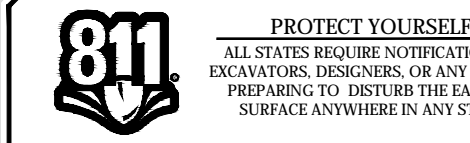
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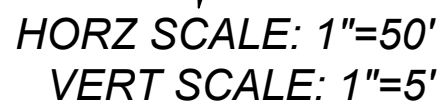
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UNPLATTED REMAINING
PORTION OF 257.33 ACRES
(DOC #20190051458 O.P.R.)
OWNER: MEH HOLDING
COMPANY LTD

A BEXAR COUNTY PERMIT
MUST BE OBTAINED BEFORE
WORKING IN BEXAR COUNTY
R.O.W.

	=	FLOW ARROW
	=	WASHOUT CROWN
E.G. T.V.T.E.	=	ELECTRIC, GAS, TELEPHONE & CABLE EASEMENT
V.N.A.E.	=	VEHICULAR NON-ACCESS EASEMENT
⊙	=	WHEEL CHAIR RAMPS SEE SHEET 5.7
①	=	WHEEL CHAIR RAMP TYPE I SEE SHEET 5.7
②	=	WHEEL CHAIR RAMP TYPE II SEE SHEET 5.7
S.D.W.C.R.	=	SINGLE DIRECTIONAL WHEEL CHAIR RAMP SEE SHEET 5.7
D.D.W.C.R.	=	DOUBLE DIRECTIONAL WHEEL CHAIR RAMP SEE SHEET 5.7
	=	SIDEWALK TO BE CONSTRUCTED BY DEVELOPER.
	=	SIDEWALK TO BE BUILT AT THE TIME OF HOME CONSTRUCTION
	=	TOP OF CURB ELEVATIONS
	=	PROPOSED DRIVEWAY LOCATIONS




Station	Top of Curb Right	Top of Curb Left
0+50		
1+00	622.29 (P.V.M.T.)	622.50 (P.V.M.T.)
	623.37	623.32
2+00	623.32	623.21
	622.21	622.21
3+00	621.21	621.21
	620.86	620.86
	619.85 (P.V.M.T.)	619.63 (P.V.M.T.)
	620.21	619.22 (P.V.M.T.)
4+00	619.21	618.63 (P.V.M.T.)
	619.03	619.03
	618.72	618.72
	618.34	618.34
5+00	617.97	617.97
	617.59	617.59
6+00	617.33	617.33
	617.02	617.22
	616.37	616.97
	616.24	616.84
	616.18	616.78
	616.37	616.97
	616.72	617.10
7+00	617.33	617.33
	617.48	617.48
8+00	617.85	617.85
	617.89	617.89
	617.56	617.56
9+00	617.18	617.18
9+50	616.81	616.81
	616.81	616.81

CONTRACTOR AND/OR CONTRACTOR'S INDEPENDENTLY RETAINED EMPLOYEE OR STRUCTURAL DESIGN/GEOTECHNICAL SAFETY/EQUIPMENT CONSULTANT, IF ANY, SHALL REVIEW THESE PLANS AND PROVIDE GEOTECHNICAL INFORMATION AND THE ANTICIPATED INSTALLATION SITES WITHIN THE PROJECT WORK AREA IN ORDER TO IMPLEMENT CONTRACTOR'S TRENCH EXCAVATION SAFETY PROTECTION SYSTEMS, PROGRAMS AND/OR PROCEDURES. THE CONTRACTOR'S IMPLEMENTATION OF THESE SYSTEMS, PROGRAMS AND/OR PROCEDURES SHALL PROVIDE FOR PROTECTING THE EXISTING EXCAVATION FROM COLLAPSE AND SHALL COMPLY WITH ALL OSHA STANDARDS FOR TRENCH EXCAVATIONS. SPECIFICALLY, CONTRACTOR AND/OR CONTRACTOR'S INDEPENDENTLY RETAINED EMPLOYEE OR SAFETY CONSULTANT SHALL IMPLEMENT A TRENCH SAFETY PROGRAM IN ACCORDANCE WITH OSHA STANDARDS GOVERNING THE PRESENCE AND ACTIVITIES OF INDIVIDUALS WORKING IN AND AROUND TRENCH EXCAVATION.

CAUTION! - THE CONTRACTOR SHALL BE REQUIRED TO LOCATE ALL PUBLIC OR PRIVATE UTILITIES INCLUDING BUT NOT LIMITED TO: WATER, SEWER, TELEPHONE AND FIBER OPTIC LINES, SITE EXISTING ELECTRICAL, TELEPHONE, ELECTRIC, PRIME MOVERS, AND ALL OTHER UTILITIES, LANDSCAPE IRRIGATION FACILITIES, AND GAS LINES. ANY UTILITY CONFLICTS THAT ARISE SHOULD BE COMMUNICATED TO THE ENGINEER IMMEDIATELY AND PRIOR TO CONSTRUCTION. THE CONTRACTOR SHALL CONTACT 1-800-DIG-TESS A MINIMUM OF 48 HOURS PRIOR TO THE START OF CONSTRUCTION AND ANY DAMAGE TO EXISTING UTILITIES SHALL BE THE SOLE RESPONSIBILITY OF THE CONTRACTOR AND THE REPAIR SHALL BE AT CONTRACTOR'S SOLE EXPENSE WHETHER THE UTILITY IS SHOWN ON THESE PLANS OR NOT.


A BEXAR COUNTY PERMIT
MUST BE OBTAINED BEFORE
WORKING IN BEXAR COUNTY
R.O.W.

	= FLOW ARROW
	= WASHOUT CROWN
E.G.T.V.E	= ELECTRIC, GAS, TELEPHONE & CABLE EASEMENT
V.N.A.E	= VEHICULAR NON-ACCESS EASEMENT
W.C.R.	= WHEELCHAIR RAMPS SEE SHEET 5.7
①	= WHEELCHAIR RAMP TYPE I SEE SHEET 5.7
②	= WHEELCHAIR RAMP TYPE II SEE SHEET 5.7
S.D.W.C.R.	= SINGLE DIRECTIONAL WHEEL CHAIR RAMP SEE SHEET 5.7
D.D.W.C.R.	= DOUBLE DIRECTIONAL WHEEL CHAIR RAMP SEE SHEET 5.7
	= SIDEWALK TO BE CONSTRUCTED BY DEVELOPER.
	= SIDEWALK TO BE BUILT AT THE TIME OF HOME CONSTRUCTION
	= TOP OF CURB ELEVATIONS
	= PROPOSED DRIVEWAY LOCATIONS

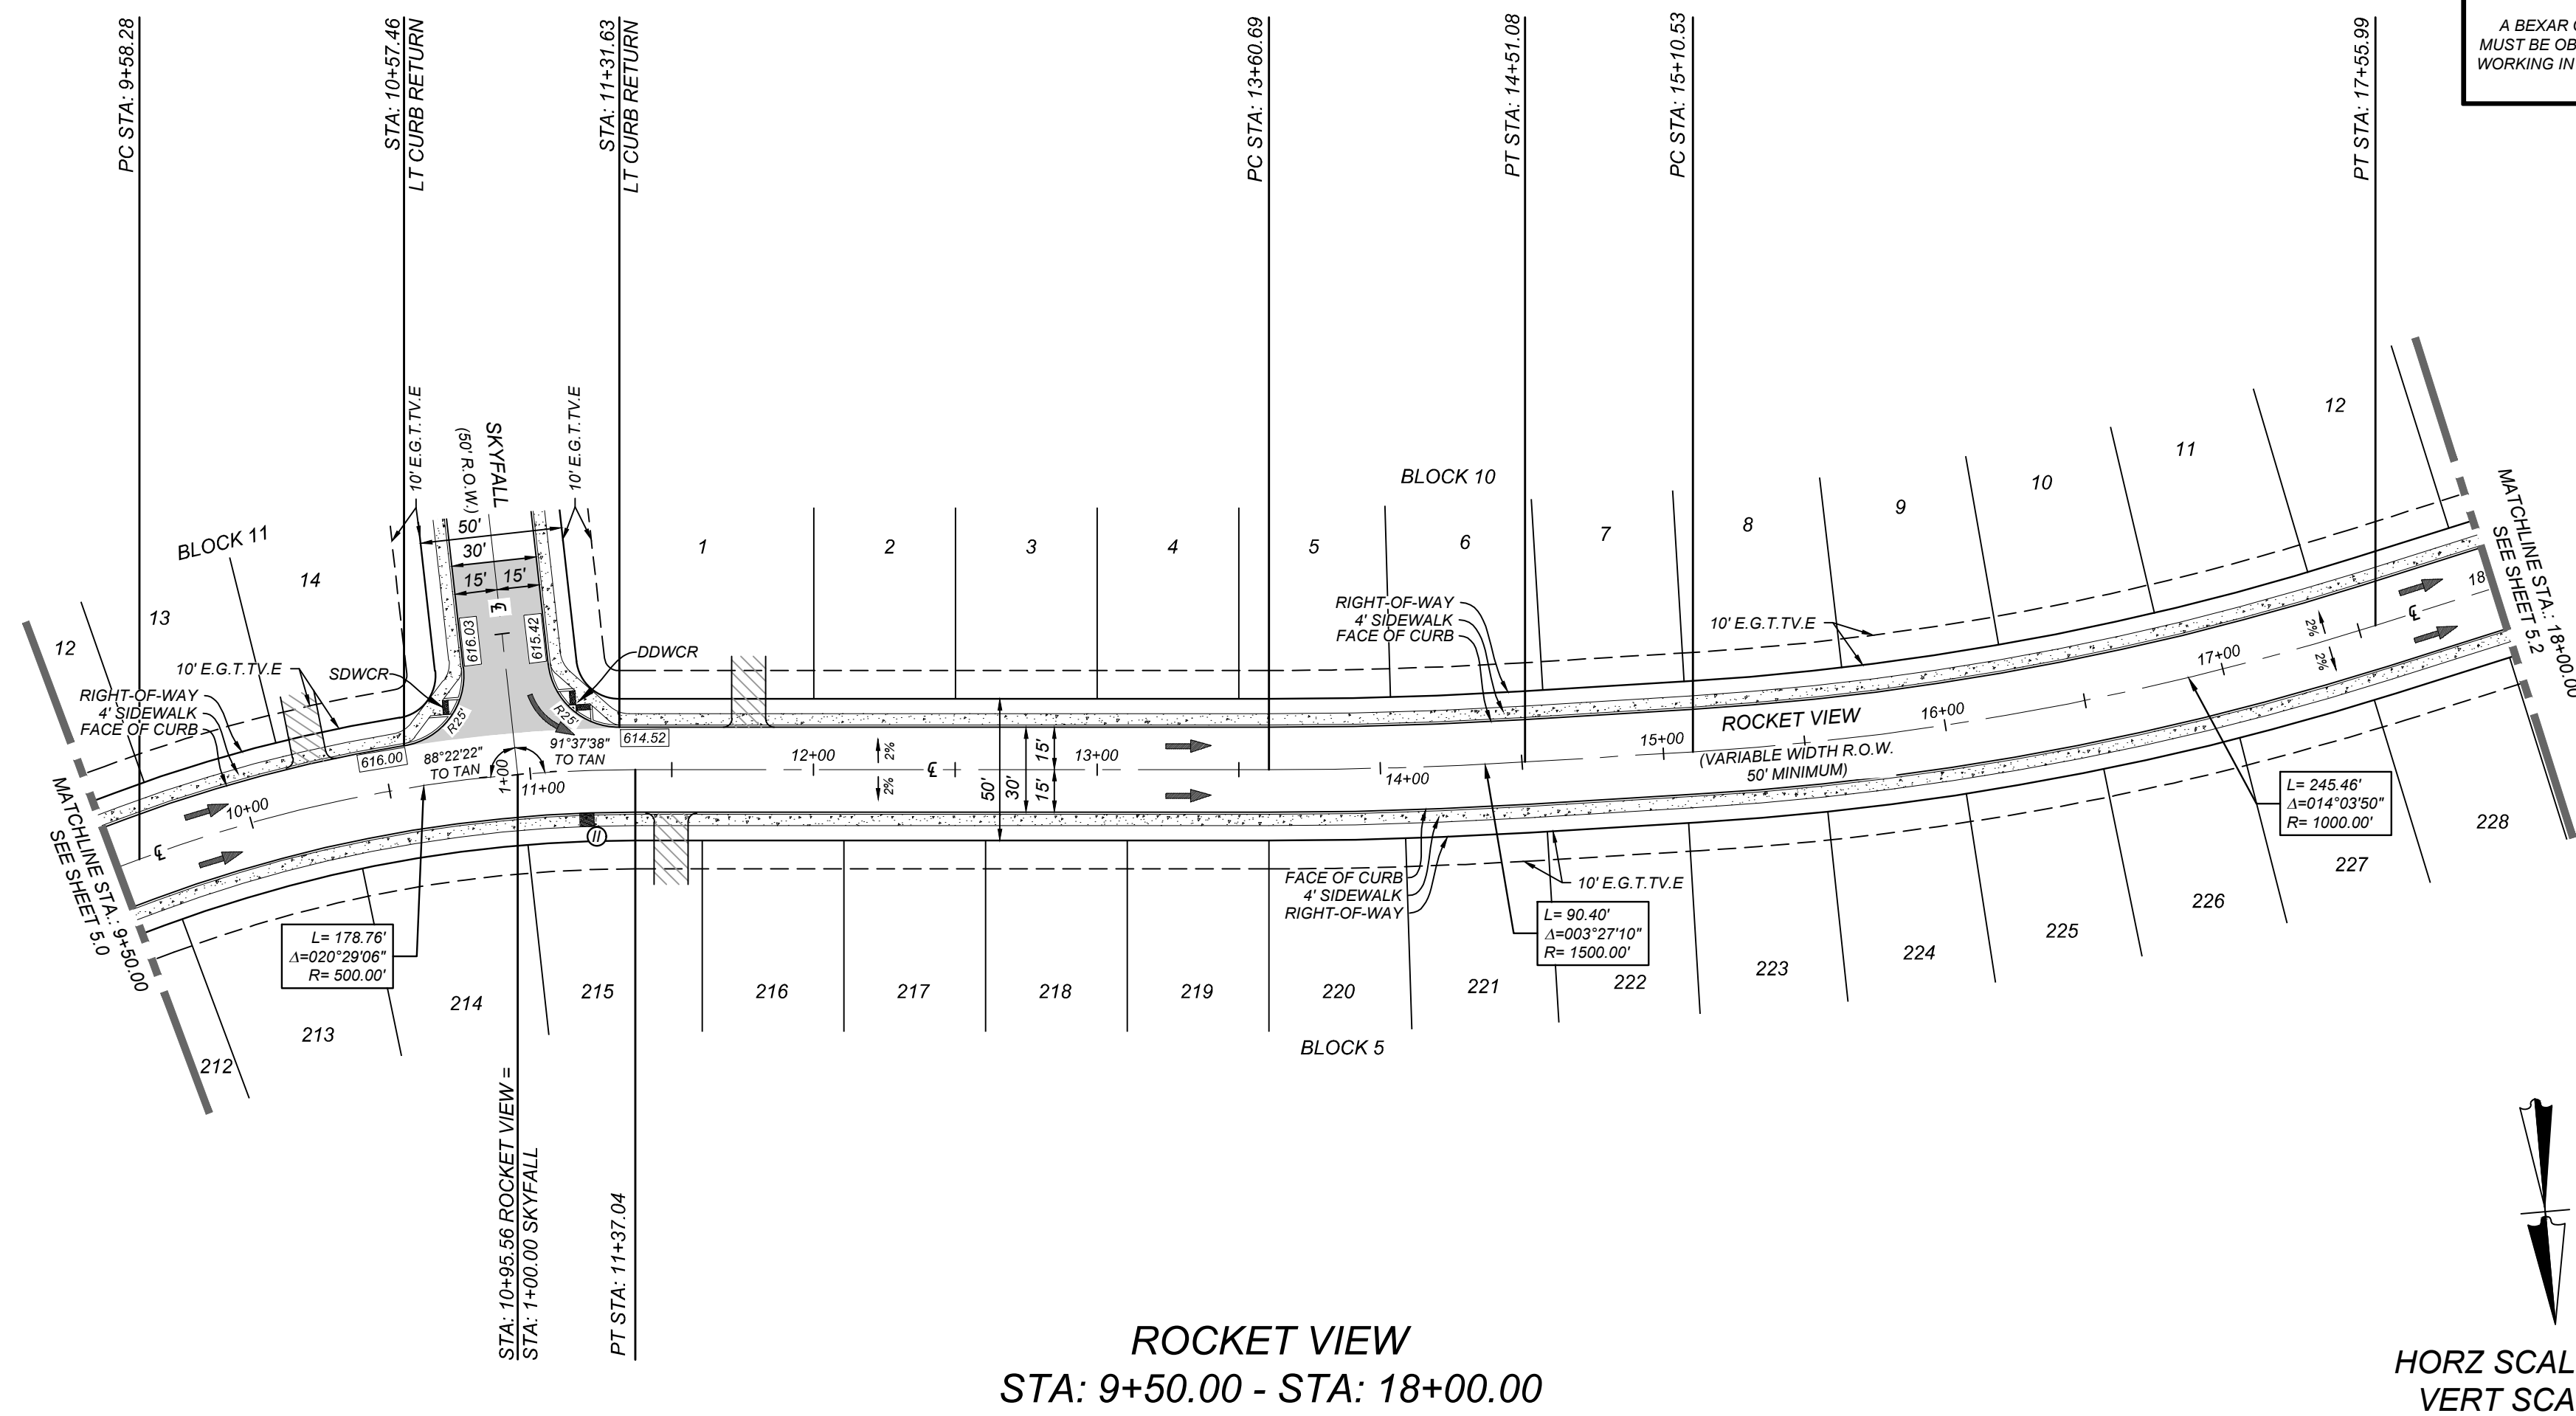

ROCKET VIEW
STA: 9+50.00 - STA: 18+00.00

HORZ SCALE: 1"=50'
VERT SCALE: 1"=5'

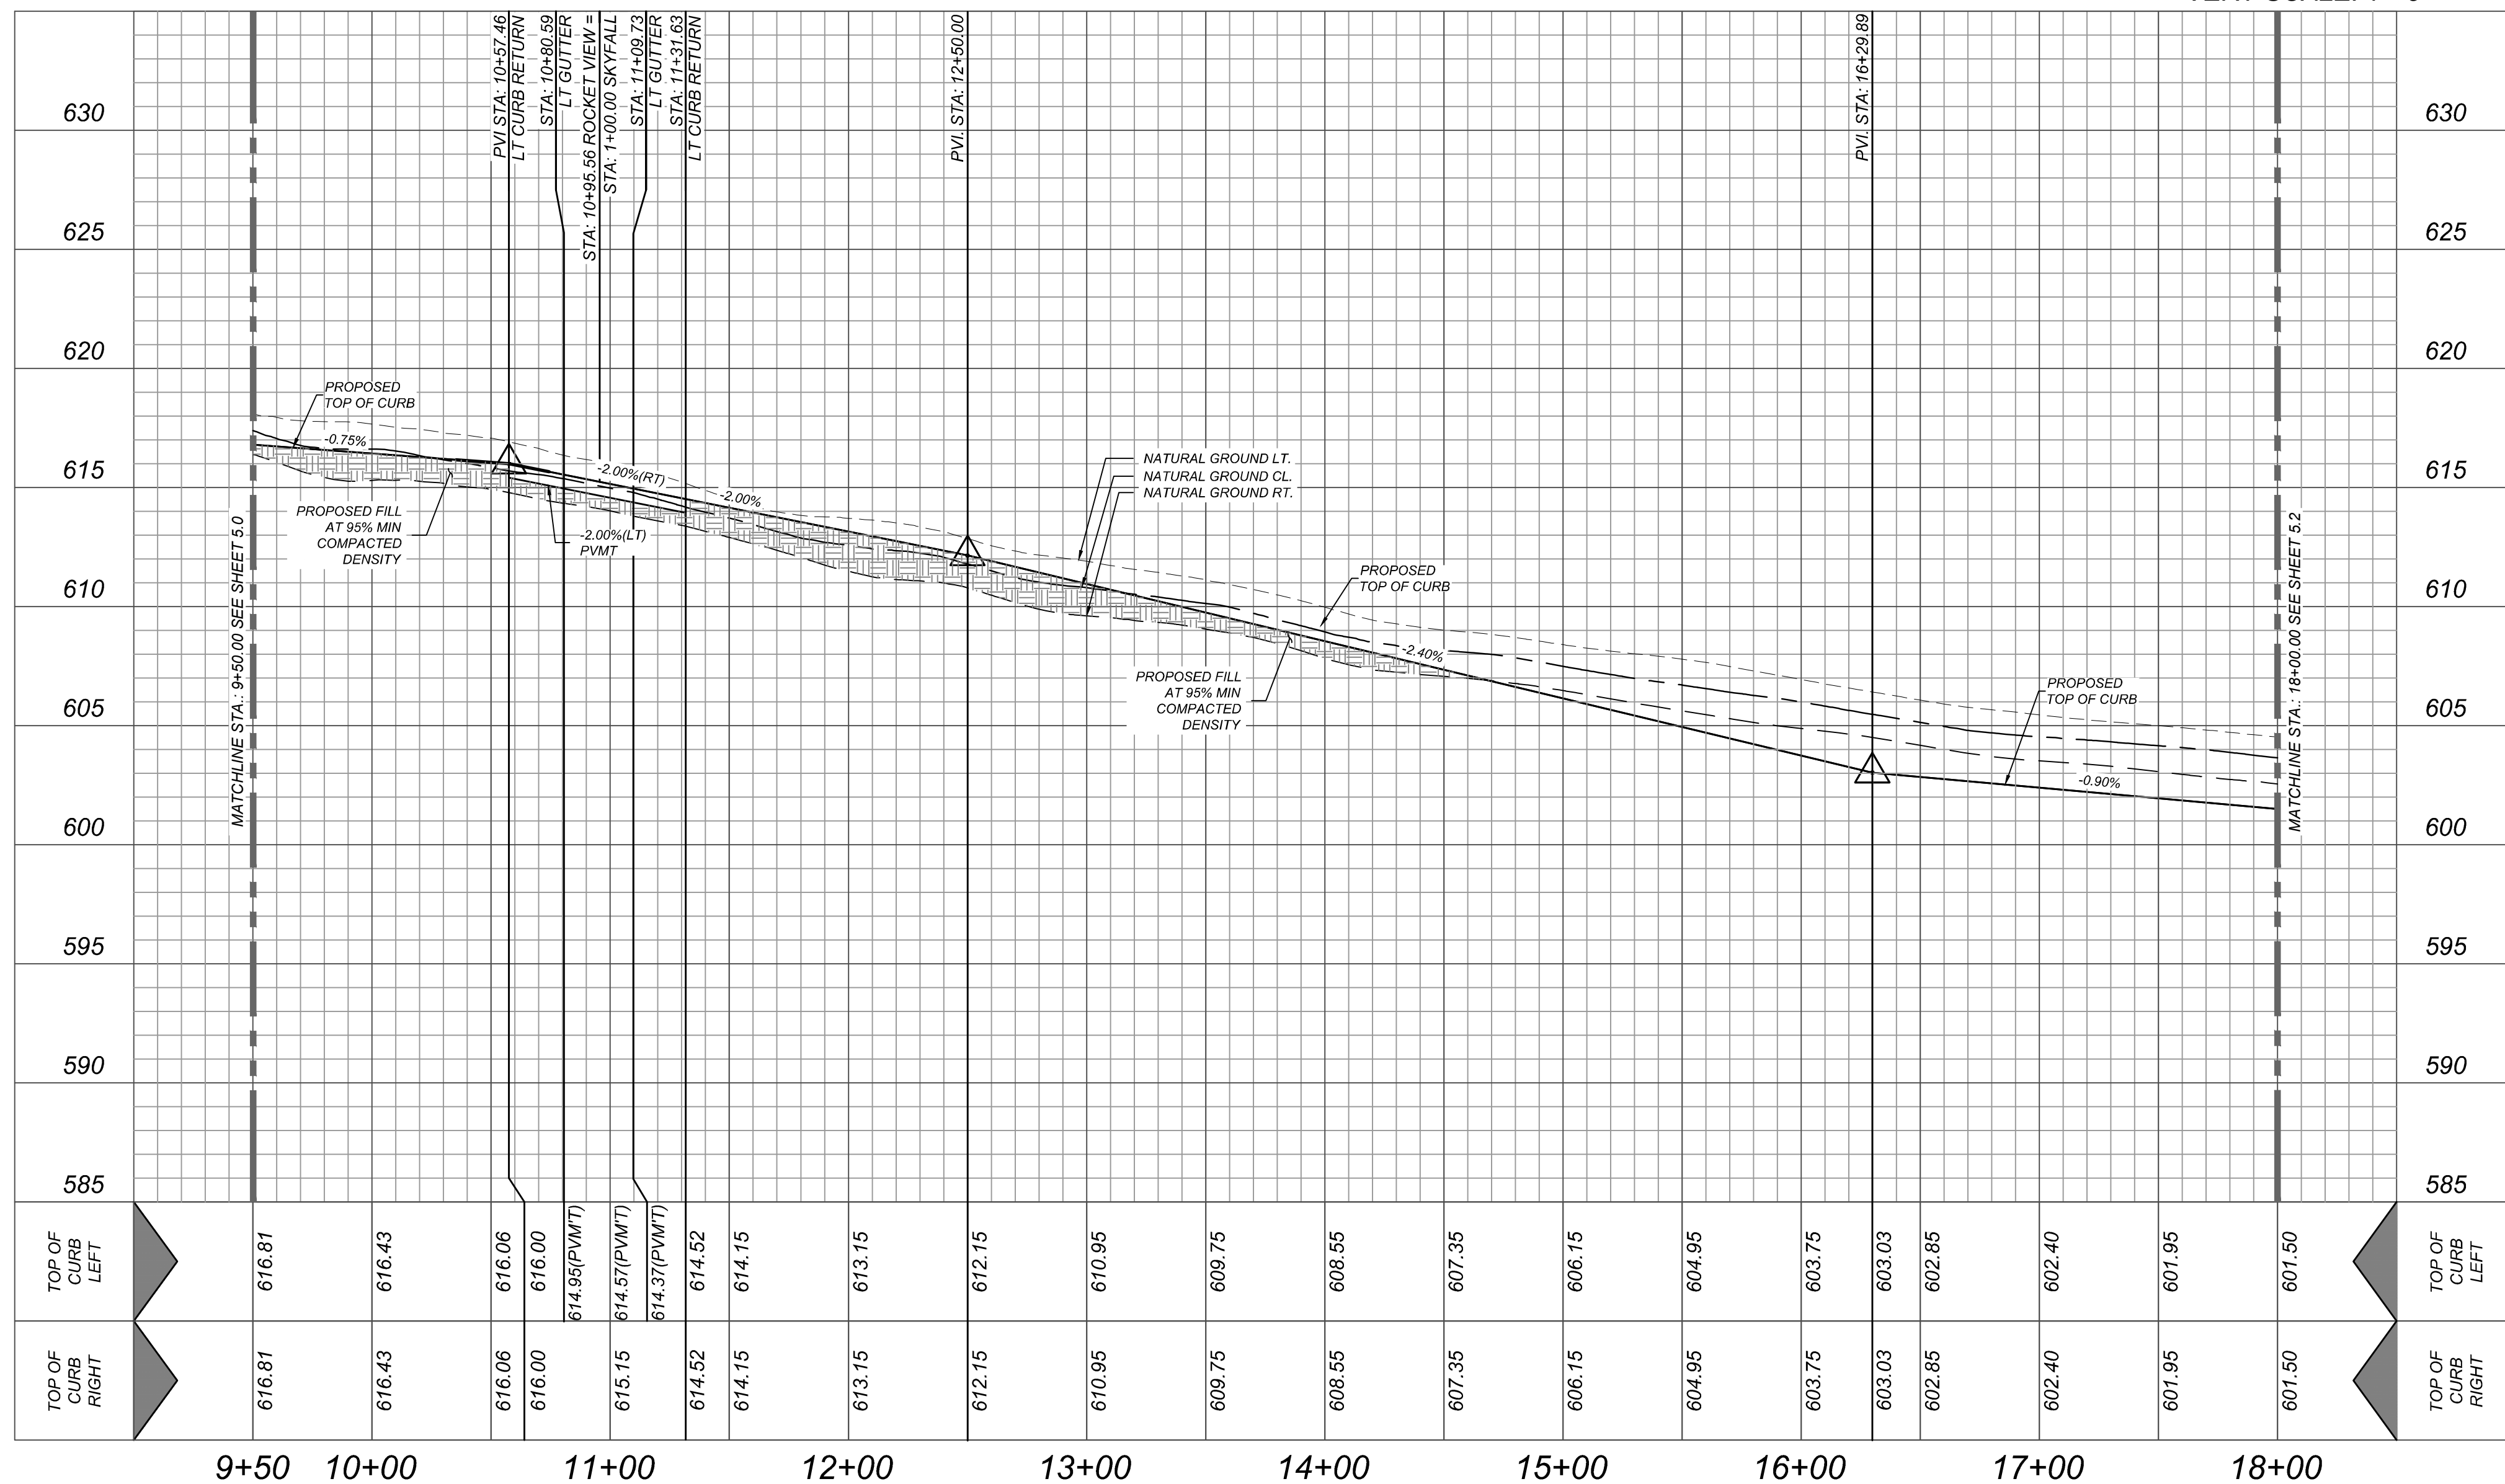

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Formerly Known as



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FOR STATE SPECIFIC DIRECT PHONE NUMBERS
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[illegible]

PRELIMINARY
FOR
SOUTHEAST
MEADOWS UNIT 3
PLAT# 23-11800440

SAN ANTONIO
BEXAR COUNTY
TEXAS



SAN ANTONIO (KFW)
3421 Paesanos
Parkway
San Antonio, TX 78231
Phone: 210.979.8444
COLLIERS ENGINEERING & DESIGN, INC.
TBPE Firm#: F-14909
TBPLS Firm#: 10194550

SCALE: AS SHOWN	DATE: 07/20/2023	DRAWN BY: SD	CHECKED BY: SC
PROJECT NUMBER: 205-43-07		DRAWING NAME: STPP2054307	

SHEET TITLE:


ROCKET VIEW
PLAN & PROFILE

SHEET NUMBER: 5.1

NOTE: DO NOT SCALE DRAWINGS FOR CONSTRUCTION.


CONTRACTOR AND/OR CONTRACTORS INDEPENDENTLY RETAINED EMPLOYEE OR STRUCTURAL DESIGN/GEOTECHNICAL/SAFETY/EQUIPMENT CONSULTANT, IF ANY, SHALL REVIEW THESE PLANS AND AVAILABLE GEOTECHNICAL INFORMATION AND THE ANTICIPATED INSTALLATION SITES WITHIN THE PROJECT WORK AREA IN ORDER TO IMPLEMENT CONTRACTOR'S TRENCH EXCAVATION SAFETY PROTECTION SYSTEMS, PROGRAMS AND/OR PROCEDURES. THE CONTRACTOR'S IMPLEMENTATION OF THESE SYSTEMS, PROGRAMS AND/OR PROCEDURES SHALL PROVIDE FOR PROTECTION OF EXCAVATION WORKERS AND PROTECTION OF THE PUBLIC WITH AS MINIMUM, OSHA STANDARDS FOR TRENCH EXCAVATIONS. SPECIFICALLY, CONTRACTOR AND/OR CONTRACTOR'S INDEPENDENTLY RETAINED EMPLOYEE OR SAFETY CONSULTANT SHALL IMPLEMENT A TRENCH SAFETY PROGRAM IN ACCORDANCE WITH OSHA STANDARDS GOVERNING THE PRESENCE AND ACTIVITIES OF INDIVIDUALS WORKING IN AND AROUND TRENCH EXCAVATION.

CAUTION: THE CONTRACTOR SHALL BE REQUIRED TO LOCATE ALL PUBLIC OR PRIVATE UTILITIES INCLUDING BUT NOT LIMITED TO: WATER, SEWER, TELEPHONE AND FIBER OPTIC LINES, SITE LIGHTING ELECTRIC, SECONDARY ELECTRIC, PRIMARY ELECTRICAL DUCTBANKS, LANDSCAPE IRRIGATION FACILITIES, AND GAS LINES. ANY UTILITY CONFLICTS THAT ARISE SHOULD BE COMMUNICATED TO THE ENGINEER IMMEDIATELY AND PRIOR TO CONSTRUCTION. THE CONTRACTOR SHALL CONTACT 1-800-DIG-TESS A MINIMUM OF 48 HOURS PRIOR TO THE START OF CONSTRUCTION. ANY DAMAGE TO EXISTING UTILITIES SHALL BE THE SOLE RESPONSIBILITY OF THE CONTRACTOR AND THE REPAIR SHALL BE AT CONTRACTOR'S SOLE EXPENSE WHETHER THE UTILITY IS SHOWN ON THESE PLANS OR NOT.

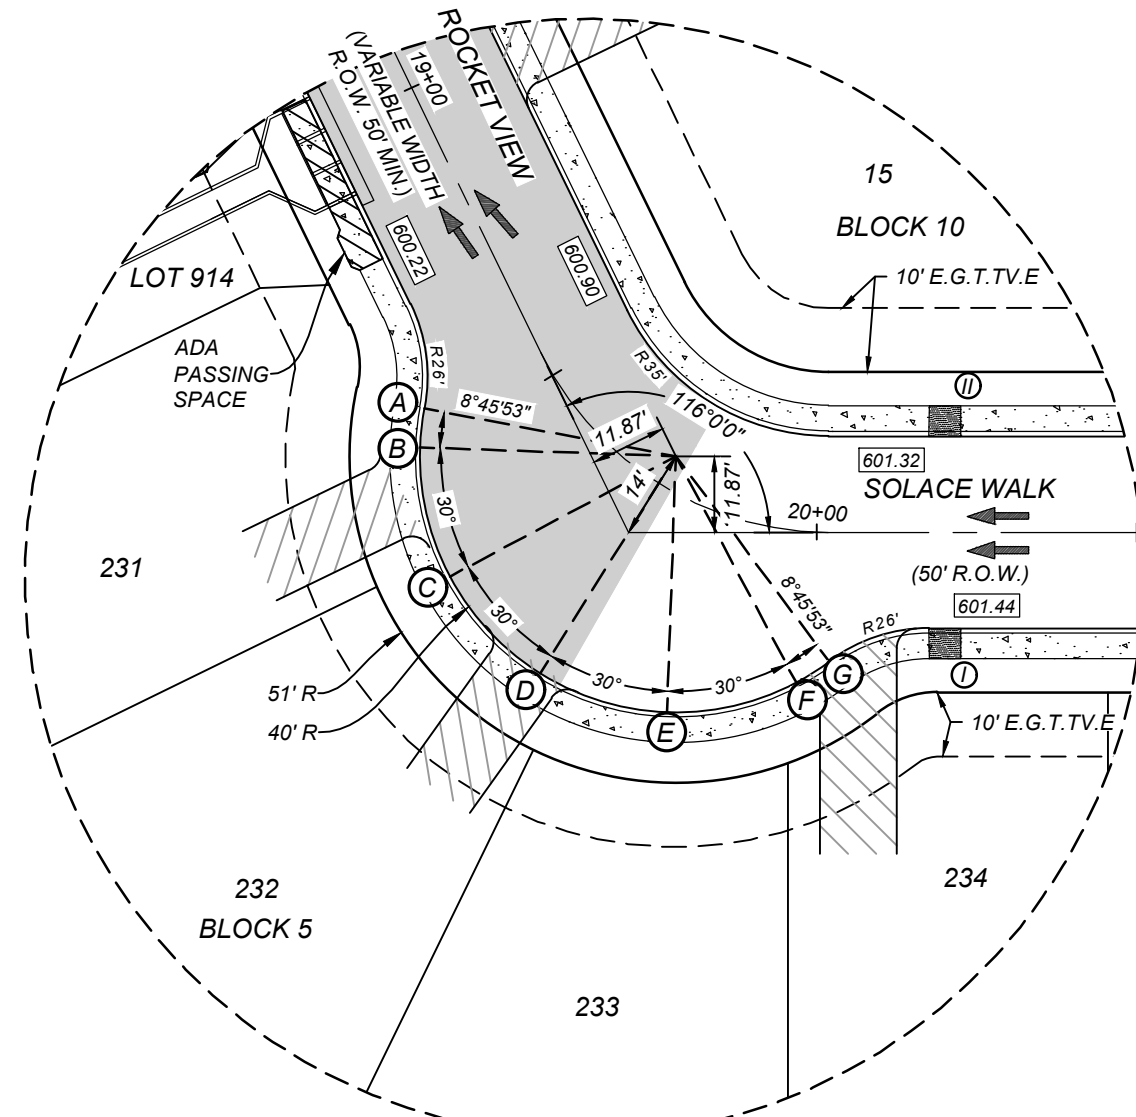


DETAIL - A
SCALE: 1"=30'

KNUCKLE ELEVATIONS	
STATION	TOP OF CURB ELEVATION
A	600.63
B	600.77
C	601.18
D	601.49
E	601.54
F	601.46
G	601.42

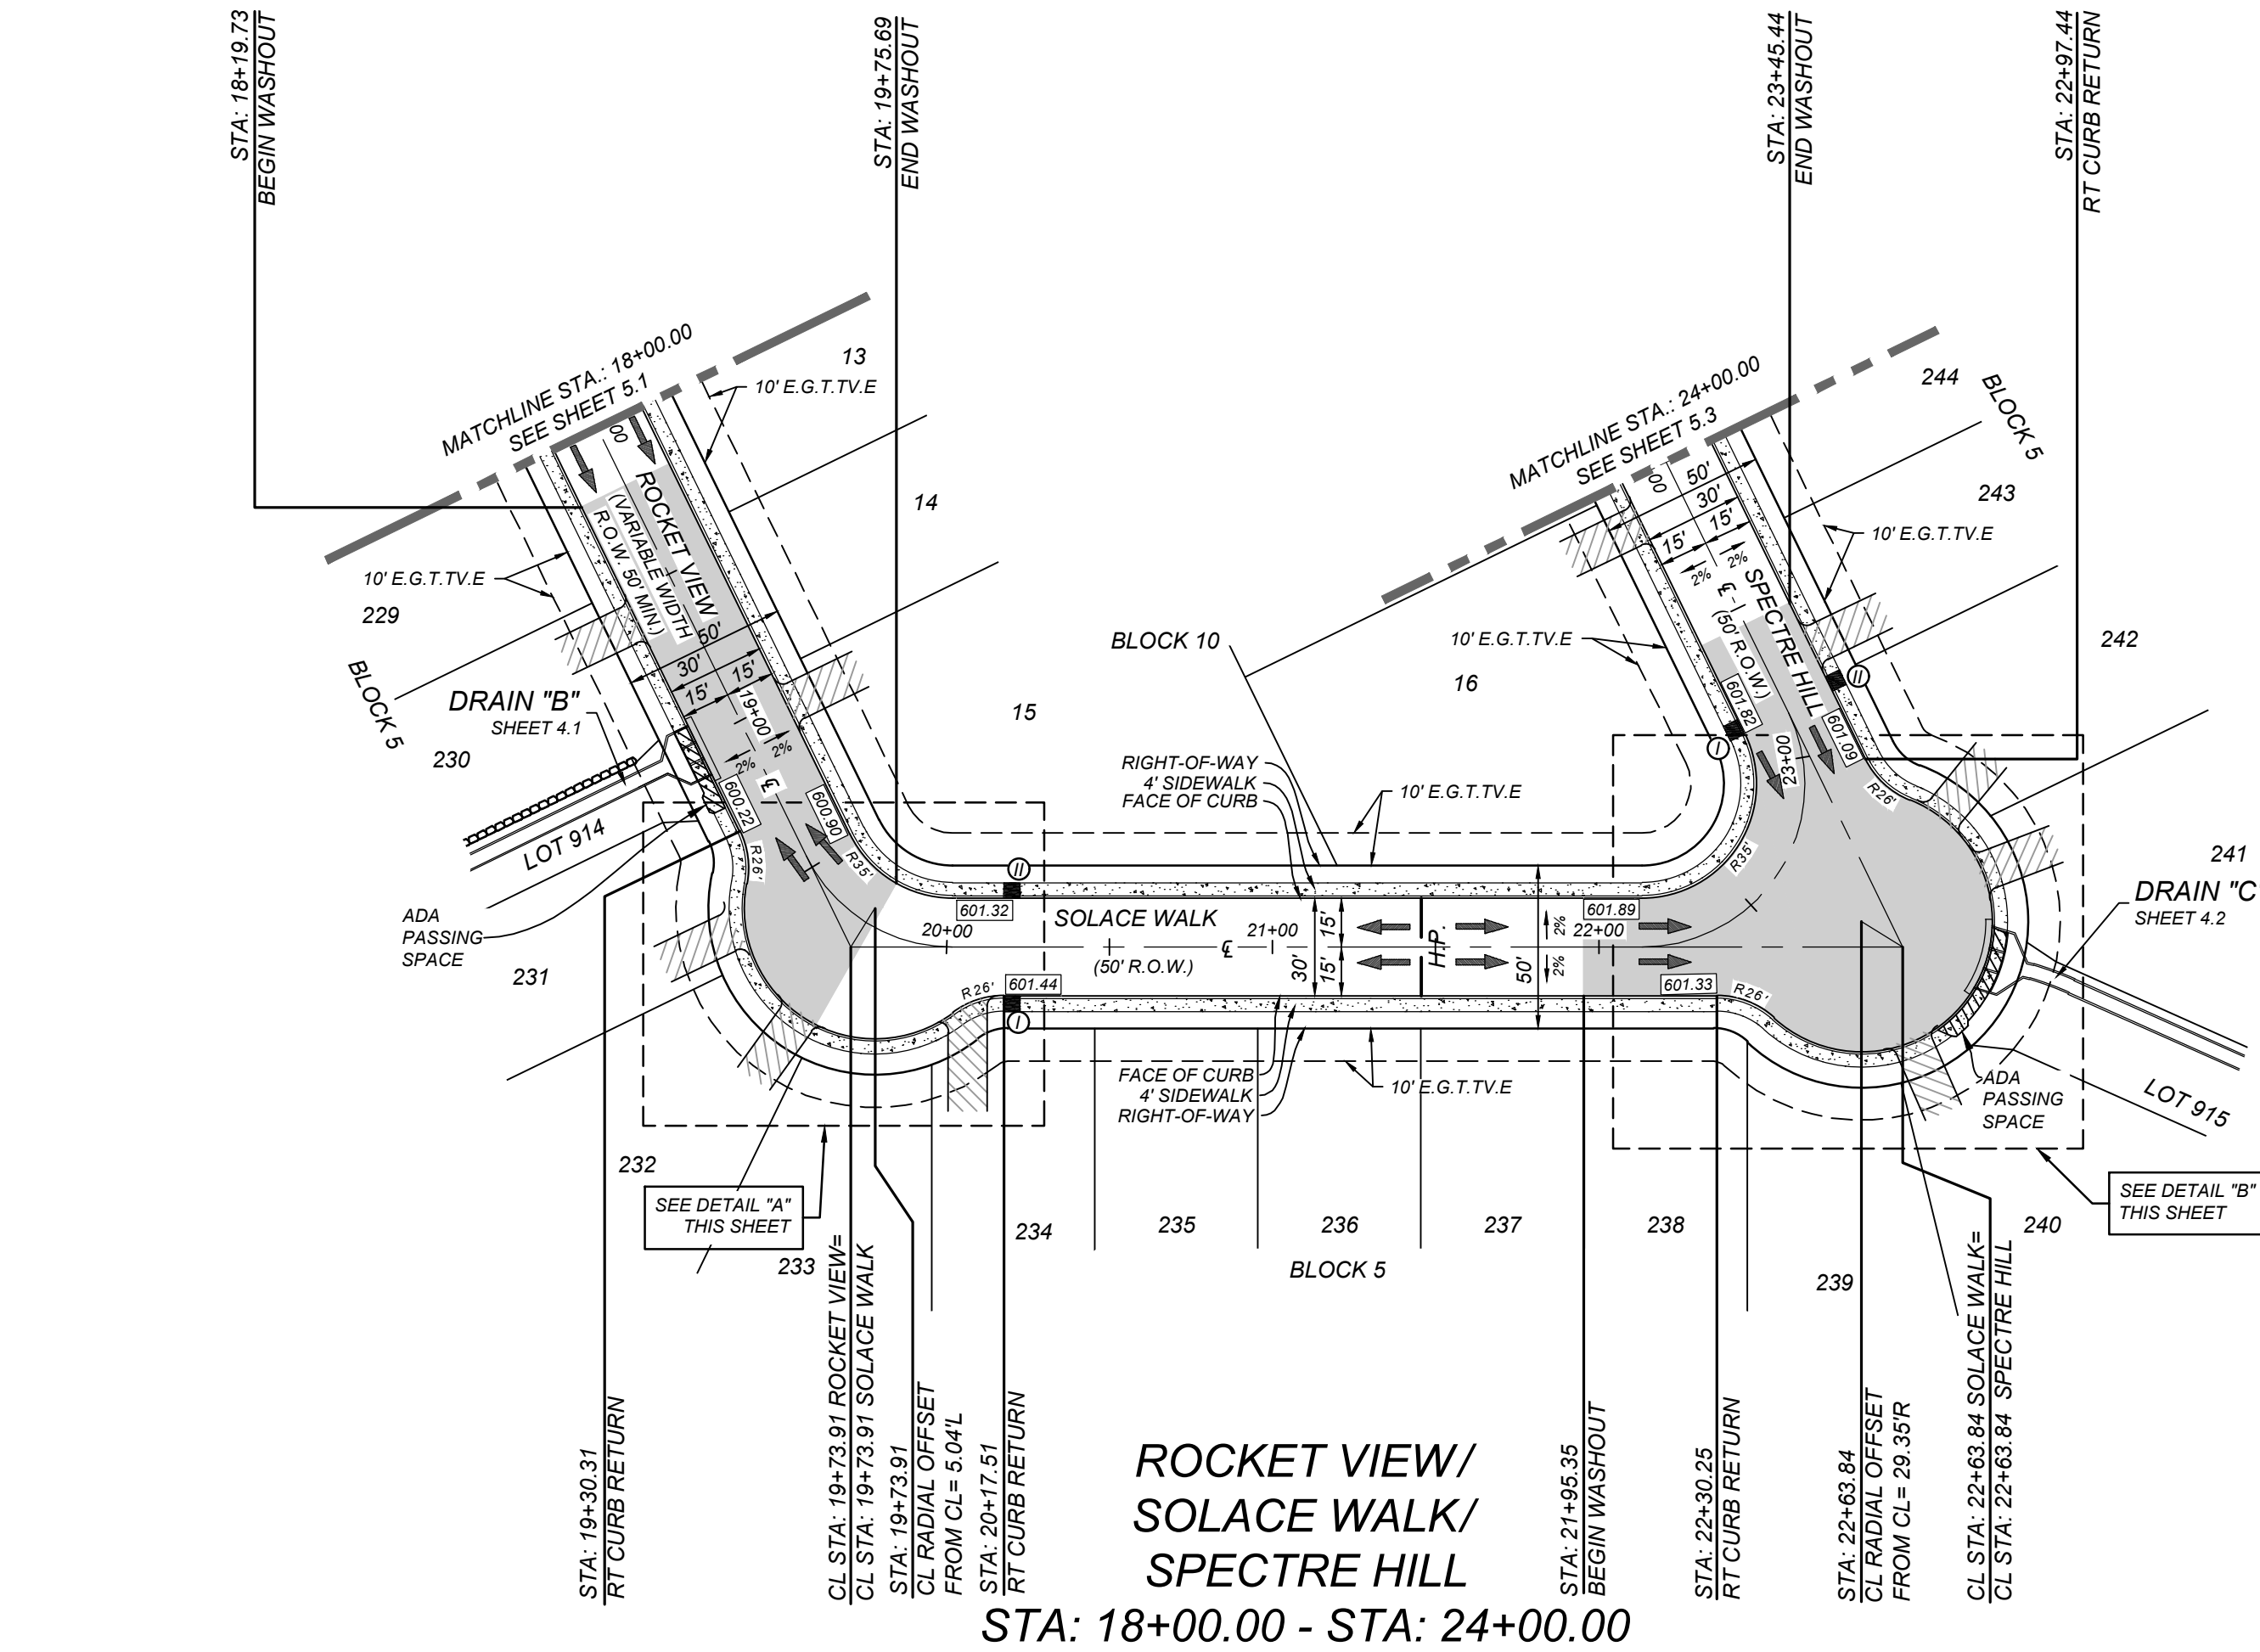

ROCKET VIEW/
SOLACE WALK/
SPECTRE HILL



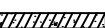
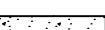
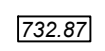

STA: 18+00.00 - STA: 24+00.00

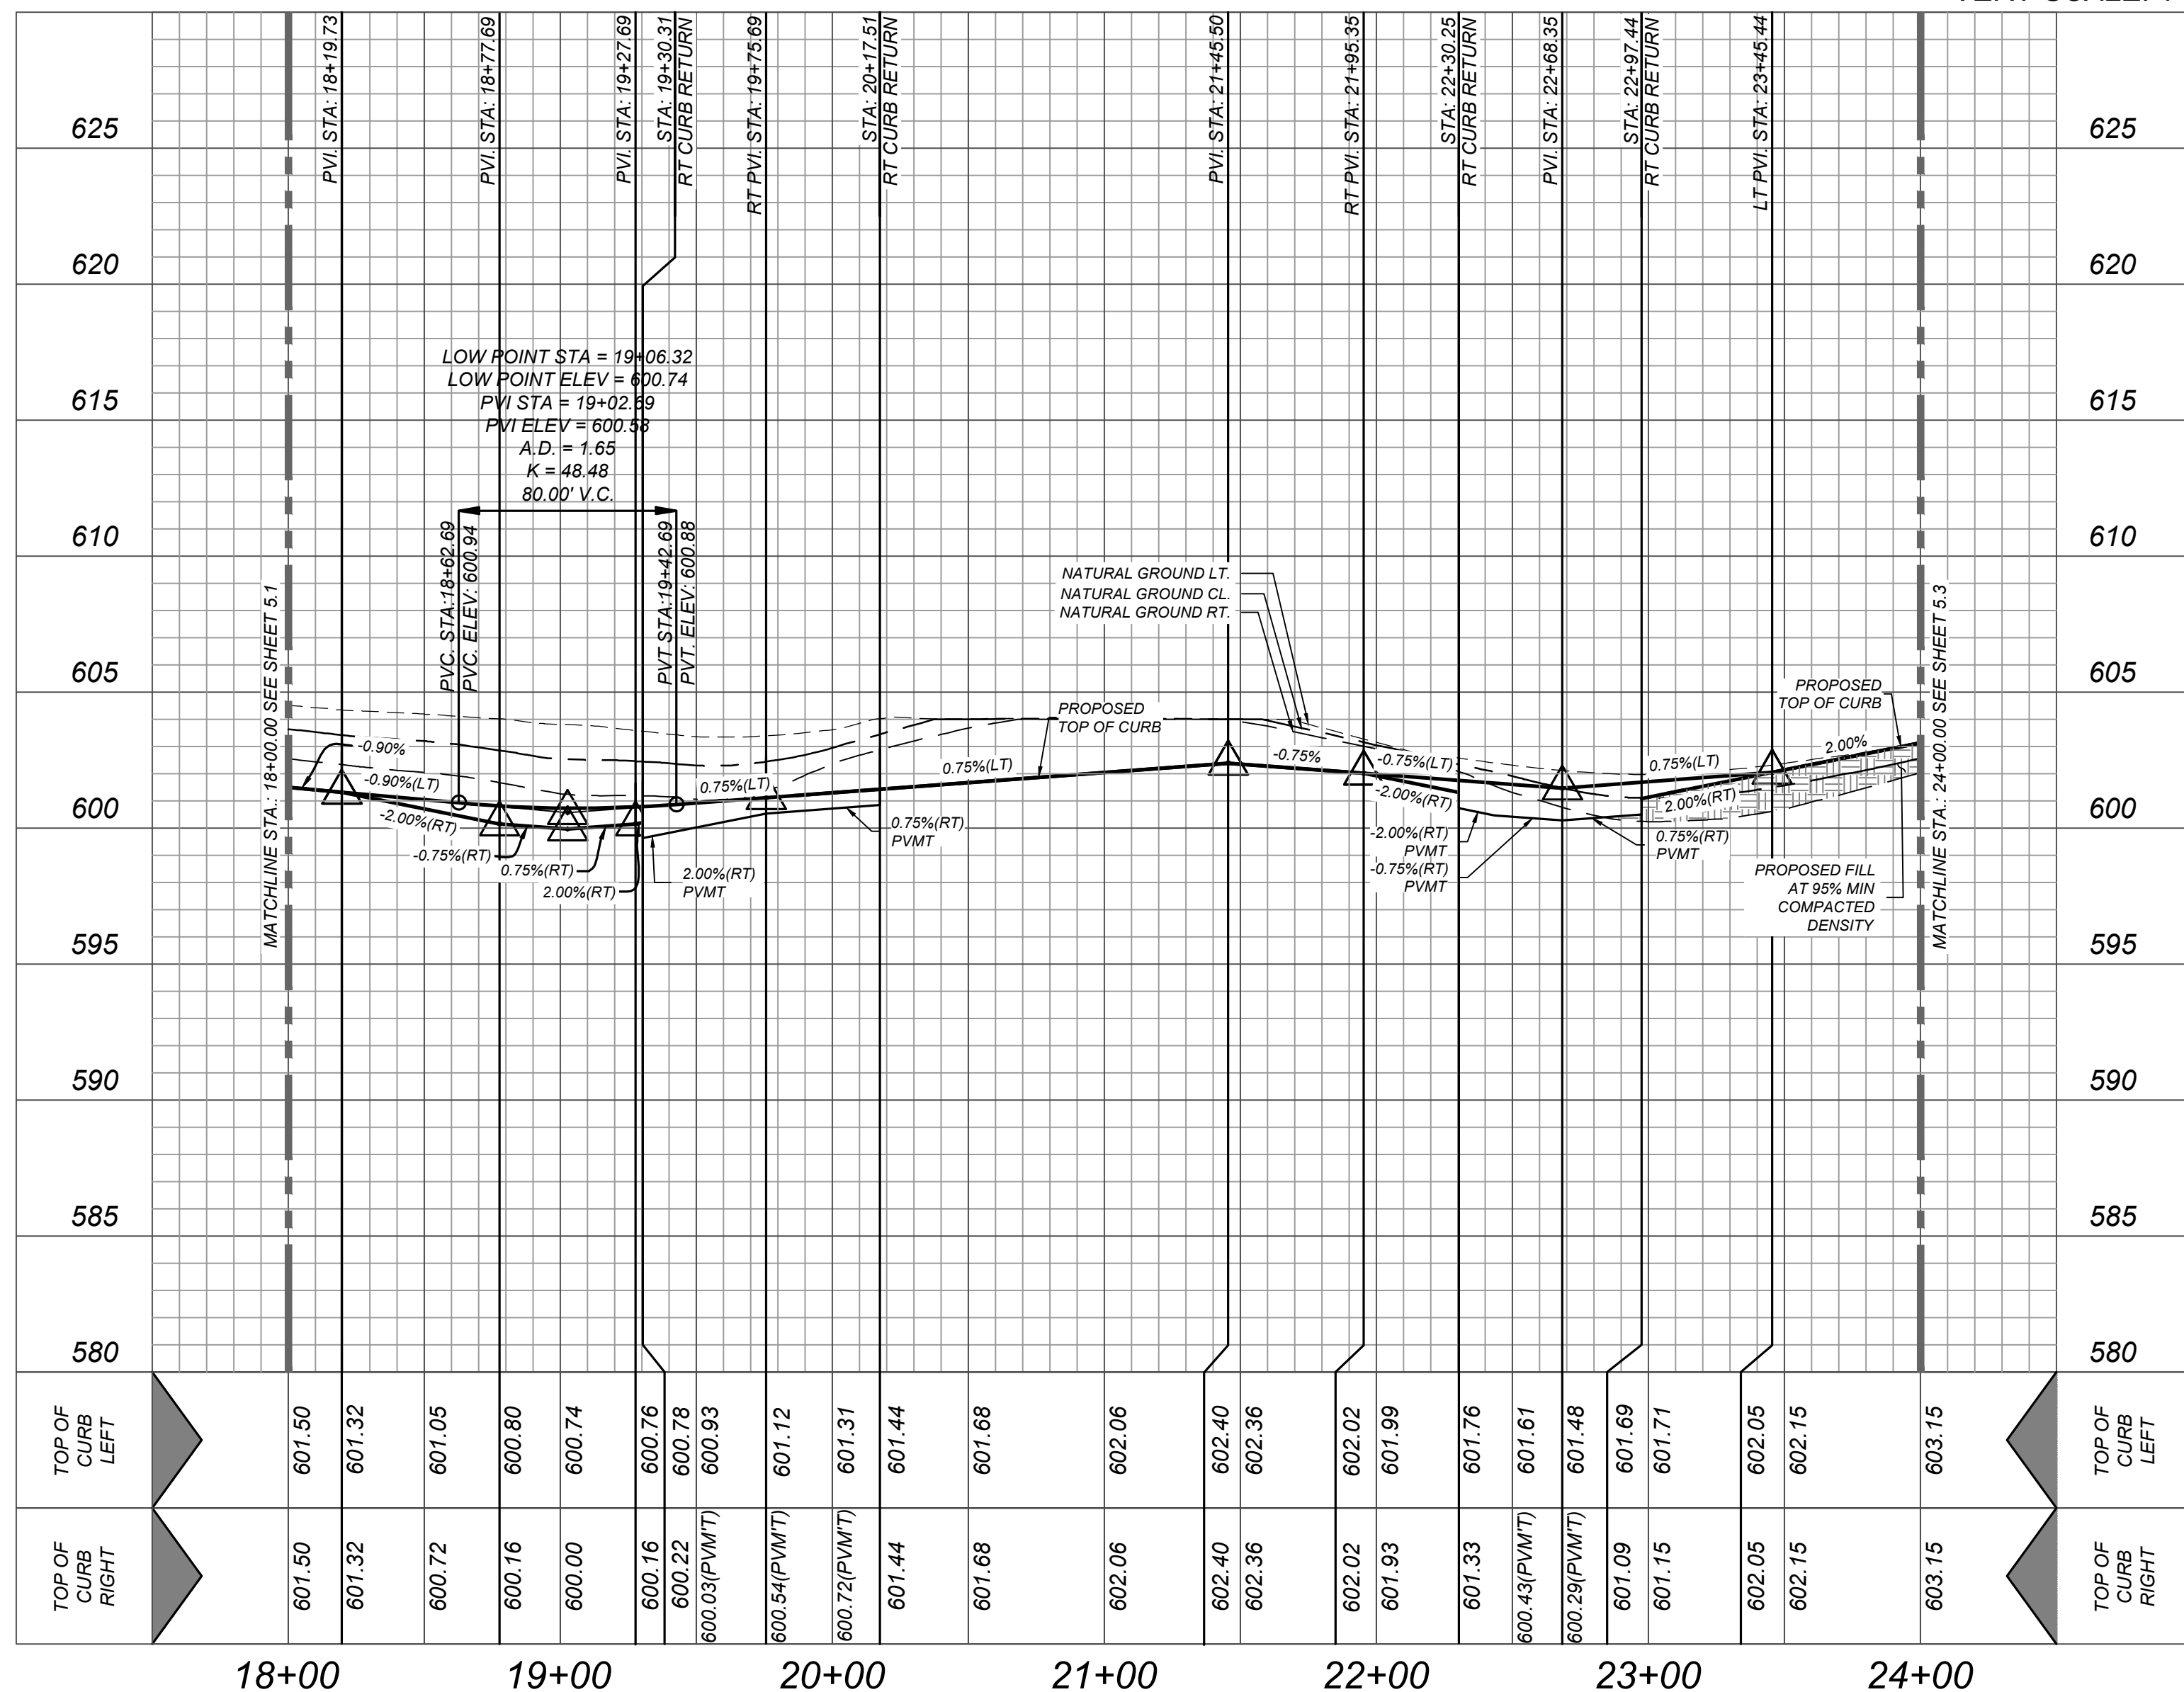


BEXAR COUNTY R.O.W. NOTE

A BEXAR COUNTY PERMIT
MUST BE OBTAINED BEFORE
WORKING IN BEXAR COUNTY
R.O.W.

LEGEND

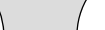- | | | |
|---|---|--|
|  | = | FLOW ARROW |
|  | = | WASHOUT CROWN |
| E.G.T.V.E. | = | ELECTRIC, GAS, TELEPHONE
& CABLE EASEMENT |
| V.N.A.E. | = | VEHICULAR NON-ACCESS EASEMENT |
| W.C.R. | = | WHEELCHAIR RAMPS
SEE SHEET 57 |
| ① | = | WHEELCHAIR RAMP TYPE I
SEE SHEET 57 |
| ② | = | WHEELCHAIR RAMP TYPE II
SEE SHEET 57 |
| S.D.W.C.R. | = | SINGLE DIRECTIONAL WHEEL CHAIR RAMP
SEE SHEET 57 |
| D.D.W.C.R. | = | DOUBLE DIRECTIONAL WHEEL CHAIR RAMP
SEE SHEET 57 |
|  | = | SIDEWALK TO BE CONSTRUCTED
BY DEVELOPER. |
|  | = | SIDEWALK TO BE BUILT AT THE TIME
OF HOME CONSTRUCTION |
|  | = | TOP OF CURB ELEVATIONS |
|  | = | PROPOSED DRIVEWAY LOCATIONS |

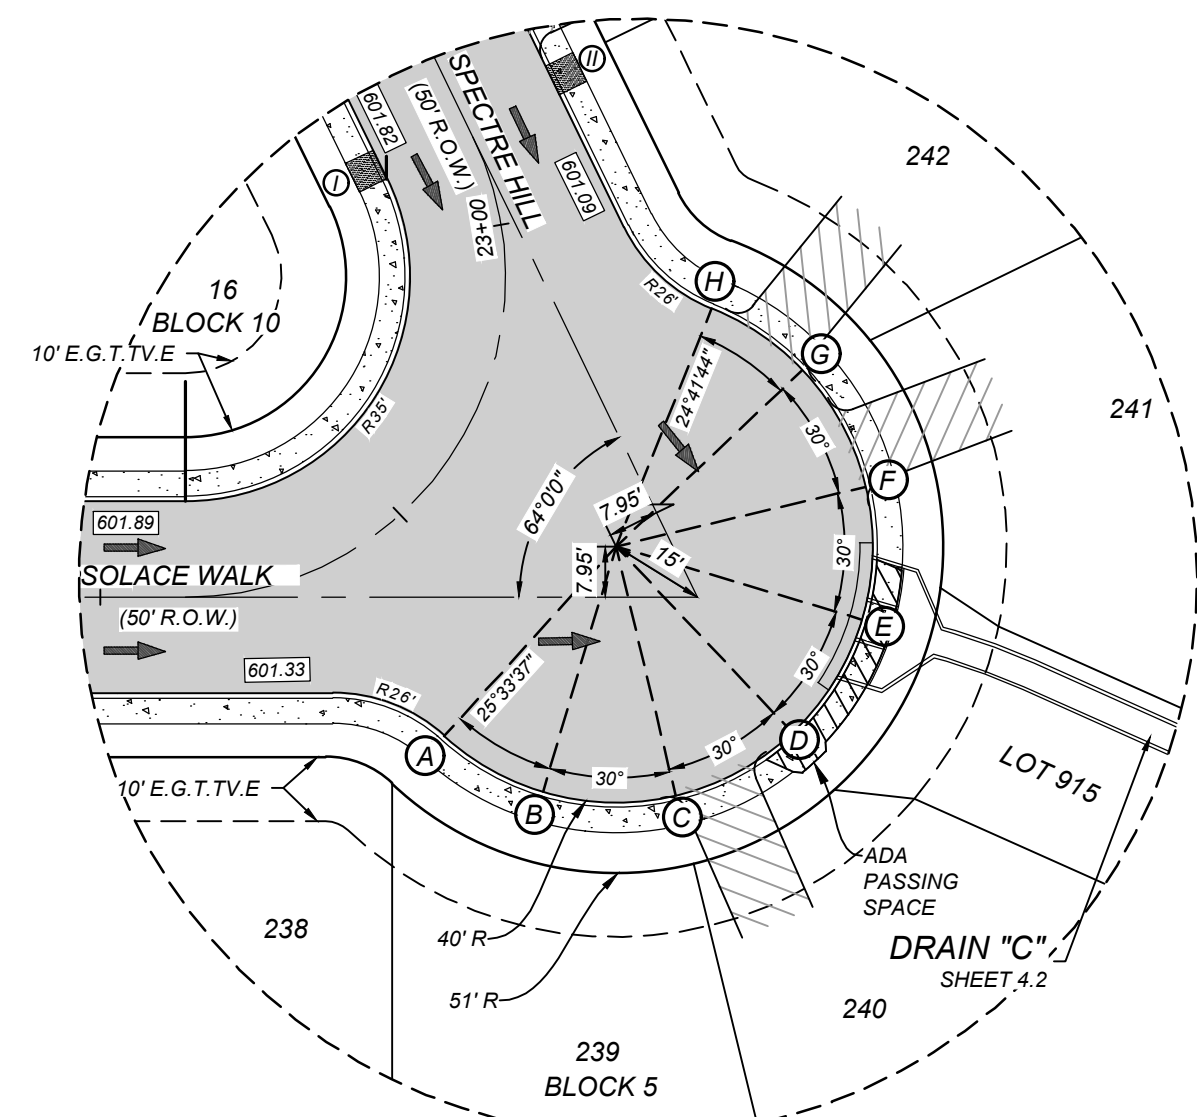

DETAIL - B
SCALE: 1"=30'

<div> <div> KNUCKLE ELEVATIONS </div> </div>	
STATION	TOP OF CURB ELEVATION
A	600.80
B	600.40
C	600.08
D	600.00
E	599.81
F	600.01
G	600.35
H	600.68

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formerly Known as

KFW



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STATE SPECIFIC DIRECT PHONE NUMBERS
VISIT: WWW.CALL811.COM

REV	DATE	DRAWN BY	DESCRIPTION
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6/28/24

RELIMINARY

FOR
SOUTHEAST
MEADOWS UNIT 3
LAT# 23-11800440

AN ANTONIO
EXAR COUNTY
TEXAS

Colliers

SAN ANTONIO (KFW)
3421 Paesanos
Parkway
San Antonio, TX 78231
Phone: 210.979.8444
LIERS ENGINEERING & DESIGN, INC.
TBPE Firm#: F-14909
TBPLS Firm#: 10194550

SCALE:	DATE:	DRAWN BY:	CHECKED BY:
AS SHOWN	07/20/2023	SD	SC
PROJECT NUMBER:		DRAWING NAME:	
205-43-07		STPP2054307	



SHEET TITLE:
ROCKET VIEW, SOLACE
WALK & SPECTRE HILL
PLAN & PROFILE







SHEET NUMBER: 5.2

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	= FLOW ARROW
	= WASHOUT CROWN
E.G. T.V.T.E.	= ELECTRIC, GAS, TELEPHONE & CABLE EASEMENT
V.N.A.E.	= VEHICULAR NON-ACCESS EASEMENT
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	= TOP OF CURB ELEVATIONS
	= PROPOSED DRIVEWAY LOCATIONS

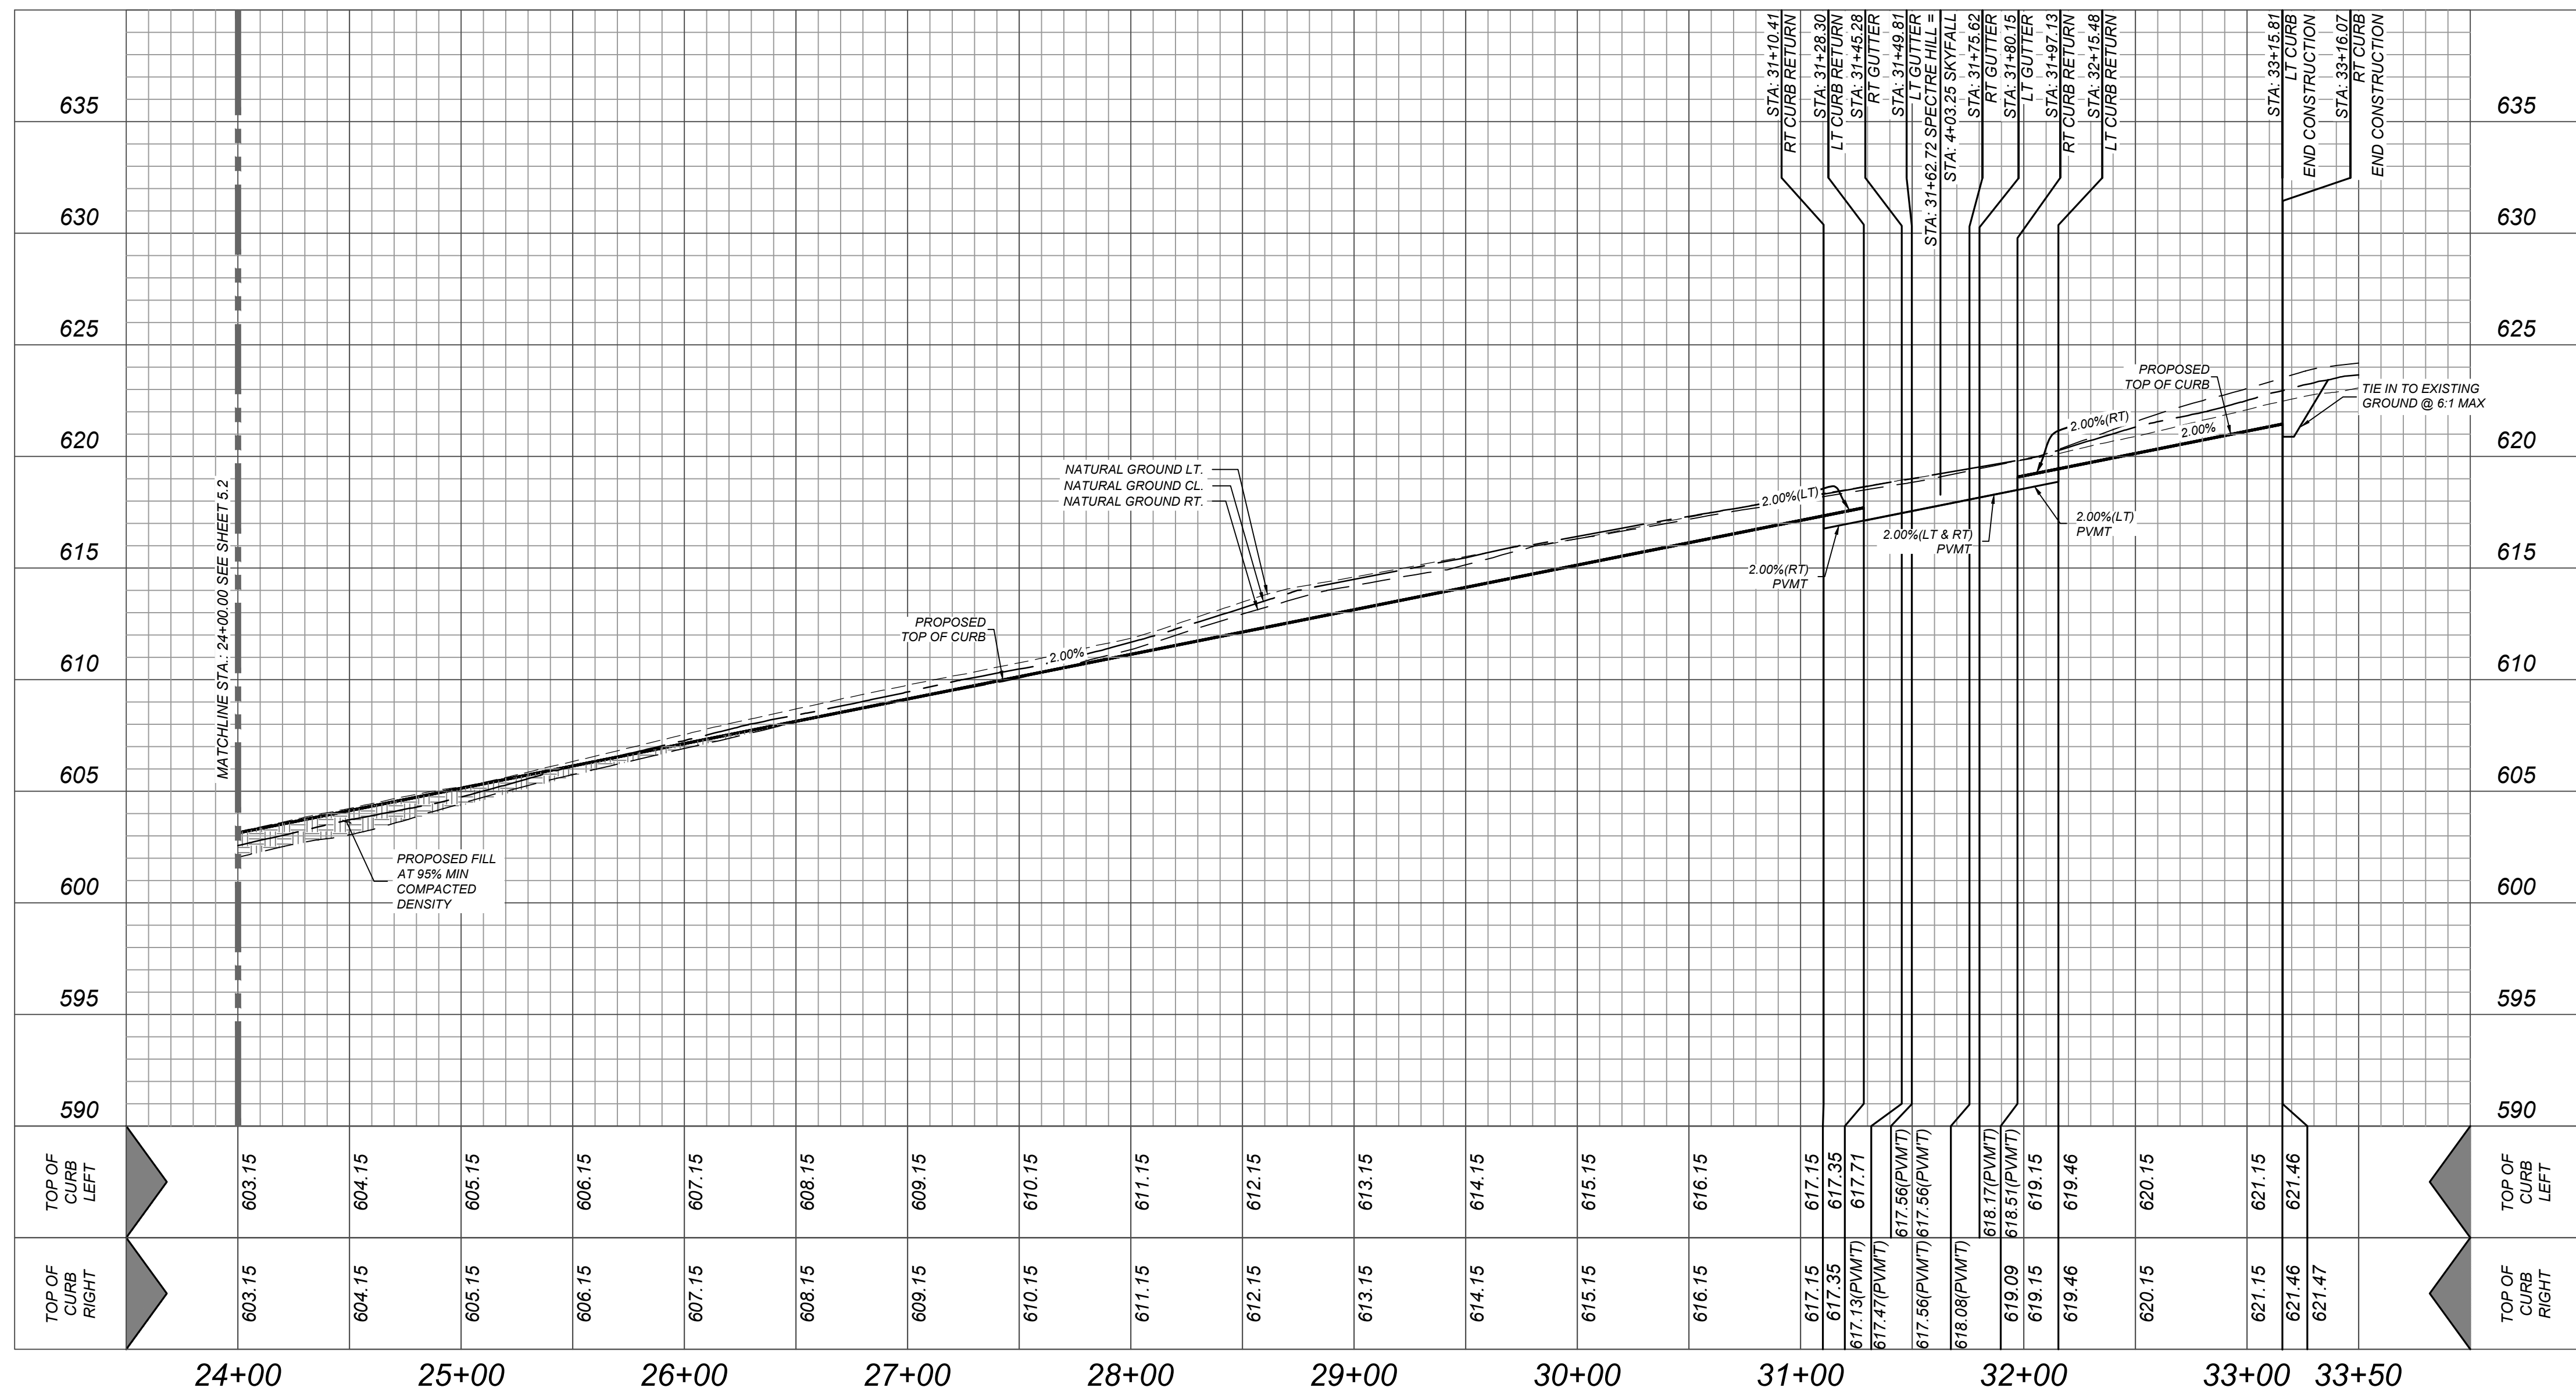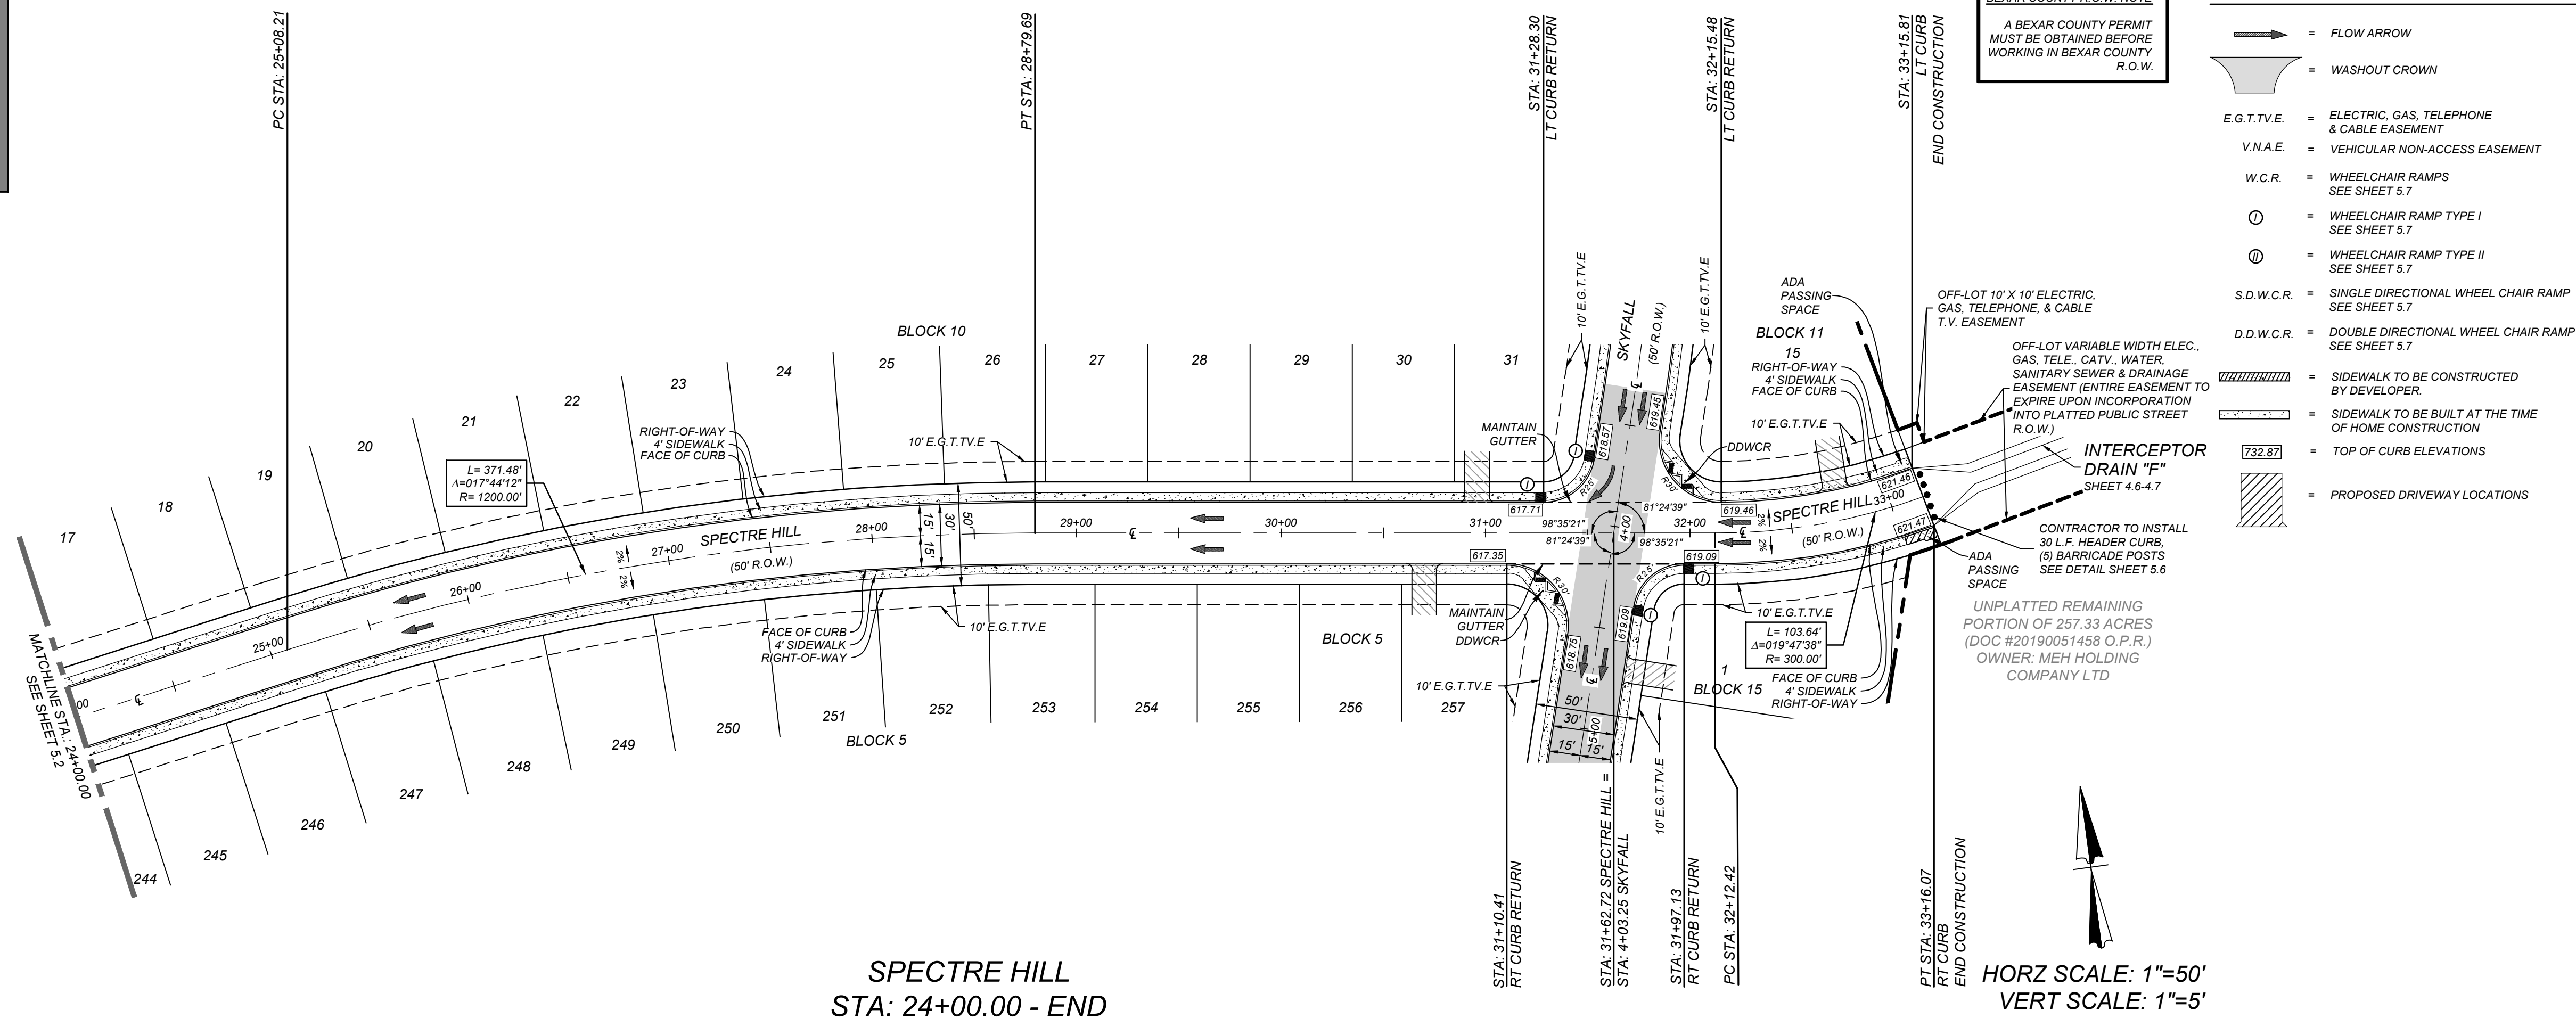A BEXAR COUNTY PERMIT
MUST BE OBTAINED BEFORE
WORKING IN BEXAR COUNTY
R.O.W.

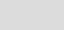Engineering & Design

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KFW
ENGINEERS + SURVEYORS

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EXCAVATORS, DESIGNERS, OR ANY PERSON
PREPARING TO DISTURB THE EARTH'S
SURFACE ANYWHERE IN ANY STATE

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VISIT: WWW.CALL811.COM

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98	11-11-11	1	1
99	11-11-11	1	1
100	11-11-11	1	1



FOR
SOUTHEAST
MEADOWS UNIT 3
PLAT# 23-11800440

Colliers
Engineering

SAN ANTONIO (KFW)
3421 Paesanos
Parkway
San Antonio, TX 78231
Phone: 210.979.8444
COLLIERS ENGINEERING & DESIGN, INC.
TBPE Firm#: F-14909
TBPLS Firm#: 10194550







SCALE: AS SHOWN	DATE: 07/20/2023	DRAWN BY: SD	CHECKED BY: SC
PROJECT NUMBER: 205-43-07		DRAWING NAME: STPP2054307	



53

NOTE: DO NOT SCALE DRAWINGS FOR CONSTRUCTION

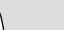CONTRACTOR AND/OR CONTRACTOR'S INDEPENDENTLY RETAINED EMPLOYEE OR STRUCTURAL DESIGN/GEOTECHNICAL SAFETY/EQUIPMENT CONSULTANT, IF ANY, SHALL REVIEW THESE PLANS AND SPECIFICATIONS FOR CONFORMANCE WITH ALL APPLICABLE CITY, STATE AND FEDERAL WITHIN THE PROJECT WORK AREA IN ORDER TO IMPLEMENT CONTRACTOR'S TRENCH EXCAVATION SAFETY PROTECTION SYSTEMS, PROGRAMS AND/OR PROCEDURES. THE CONTRACTOR'S IMPLEMENTATION OF THESE SYSTEMS, PROGRAMS AND/OR PROCEDURES SHALL PROVIDE FOR THE ADEQUATE PROTECTION OF ALL PERSONS AND PROPERTY. THE CONTRACTOR SHALL PROVIDE OSHA STANDARDS FOR TRENCH EXCAVATIONS. SPECIFICALLY, CONTRACTOR AND/OR CONTRACTOR'S INDEPENDENTLY RETAINED EMPLOYEE OR SAFETY CONSULTANT SHALL PROVIDE THE FOLLOWING INFORMATION TO THE CITY OF CHICAGO: (1) THE PRESENCE AND ACTIVITIES OF INDIVIDUALS WORKING IN AND AROUND TRENCH EXCAVATIONS;

A BEXAR COUNTY PERMIT
MUST BE OBTAINED BEFORE
WORKING IN BEXAR COUNTY
R.O.W.

	= FLOW ARROW
	= WASHOUT CROWN
E.G.T.V.E.	= ELECTRIC, GAS, TELEPHONE & CABLE SEAMANT
V.N.A.E.	= VEHICULAR NON-ACCESS SEAMANT
W.C.R.	= WHEEL CHAIR RAMPS SEE SHEET 5.7
①	= WHEEL CHAIR RAMP TYPE I SEE SHEET 5.7
②	= WHEEL CHAIR RAMP TYPE II SEE SHEET 5.7
S.D.W.C.R.	= SINGLE DIRECTIONAL WHEEL CHAIR RAMP SEE SHEET 5.7
D.D.W.C.R.	= DOUBLE DIRECTIONAL WHEEL CHAIR RAMP SEE SHEET 5.7
	= SIDEWALK TO BE CONSTRUCTED BY DEVELOPER
	= SIDEWALK TO BE BUILT AT THE TIME OF HOME CONSTRUCTION
	= TOP OF CURB ELEVATIONS
	= PROPOSED DRIVEWAY LOCATIONS

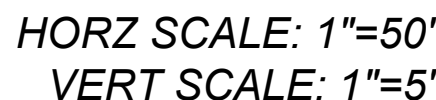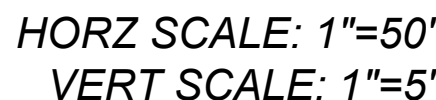

REV	DATE	DRAWN BY	DESCRIPTION
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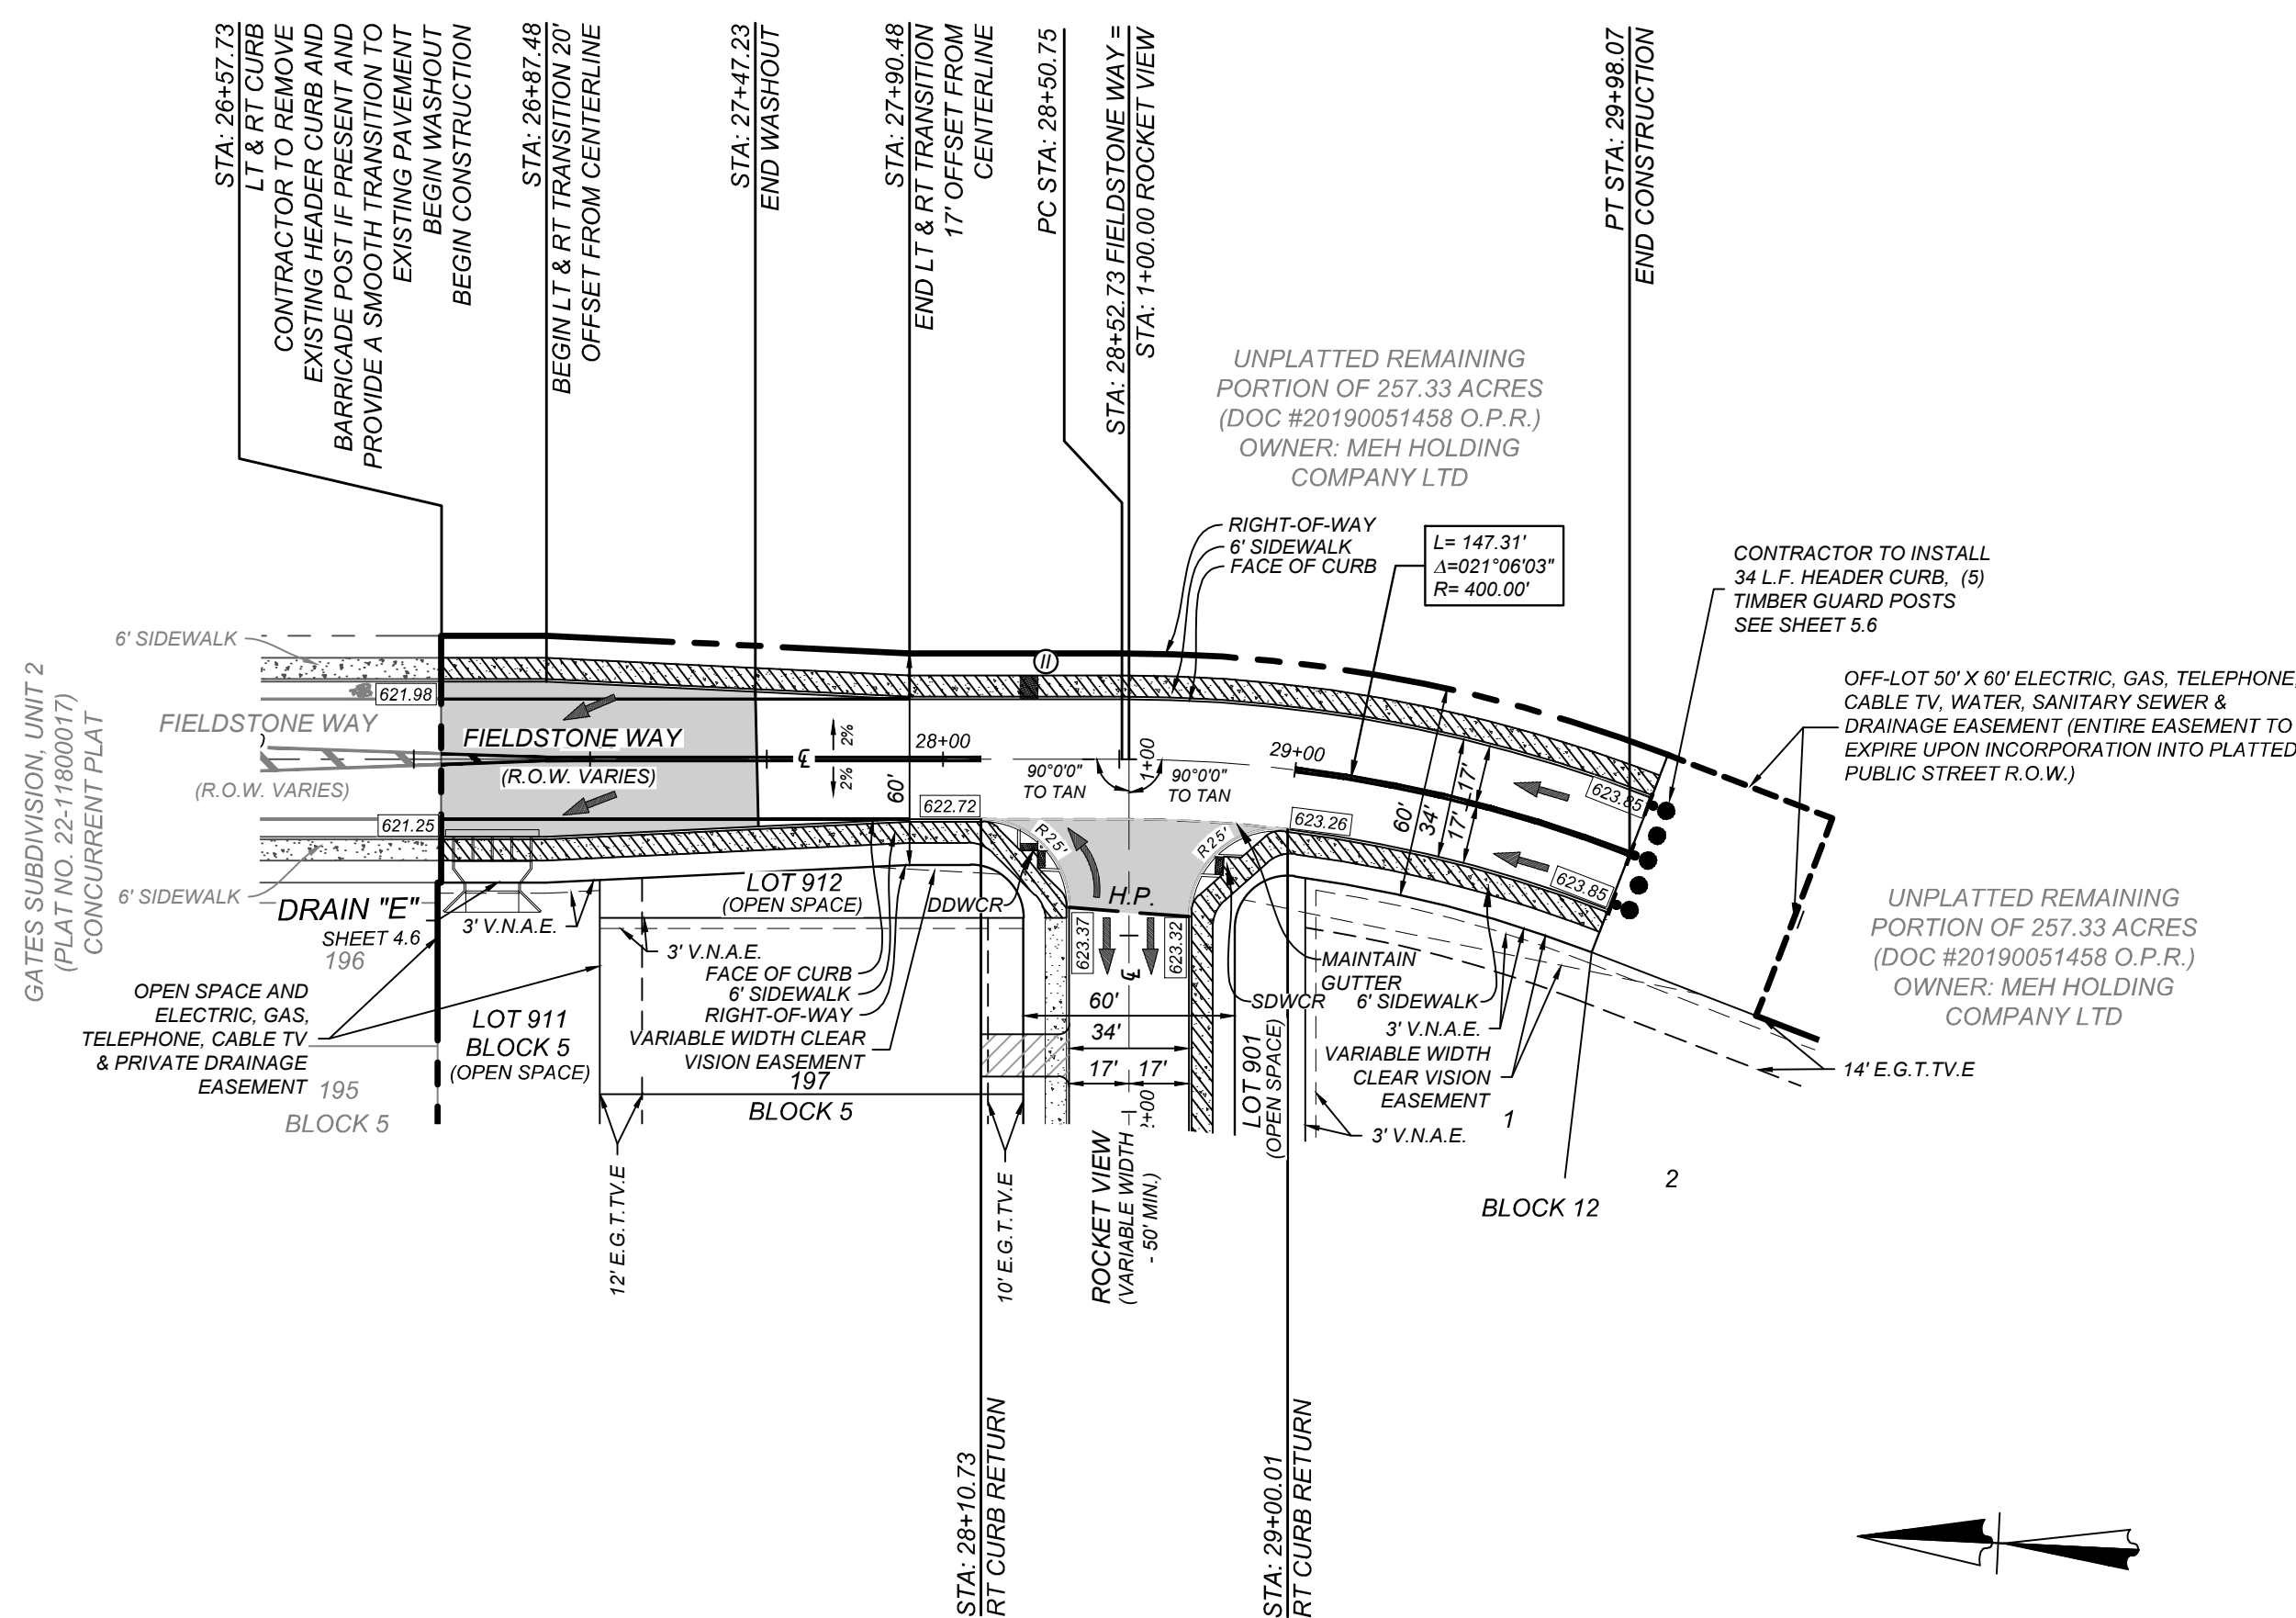


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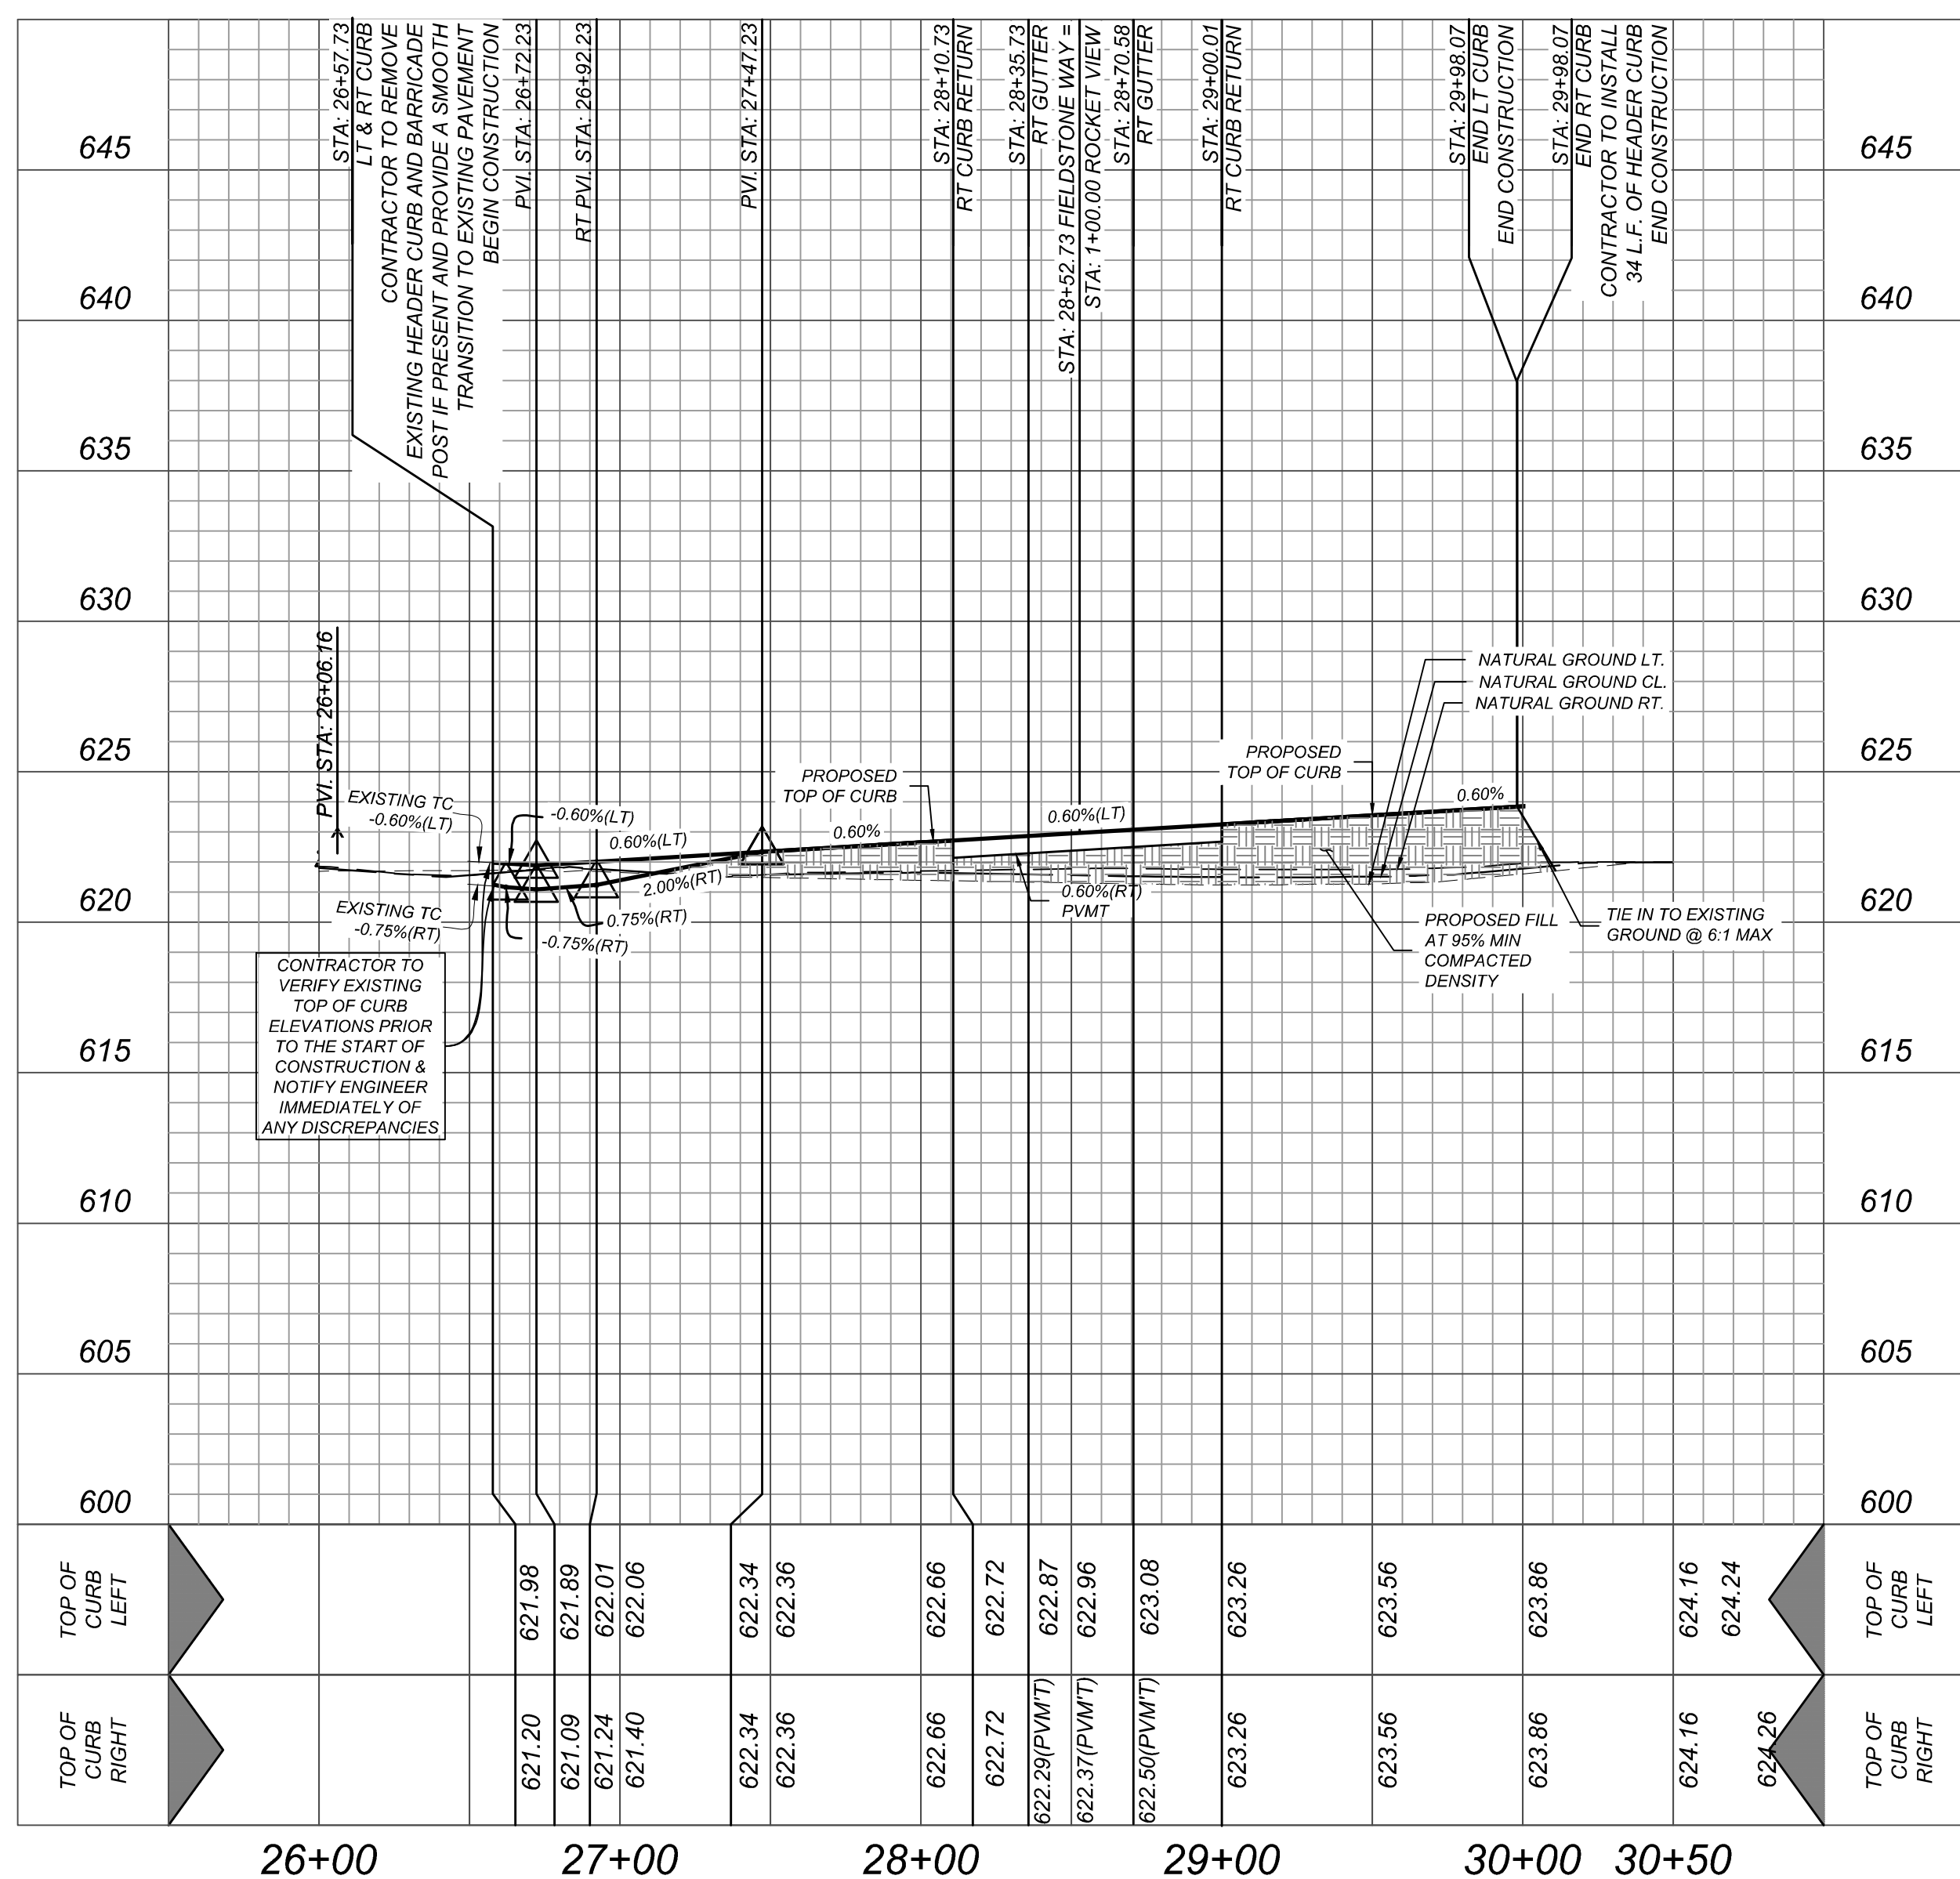
NOTE: DO NOT SCALE DRAWINGS FOR CONSTRUCTION

CONTRACTOR AND/OR CONTRACTOR'S INDEPENDENTLY RETAINED EMPLOYEE OR STRUCTURAL DESIGN/GEOTECHNICAL/SAFETY/EQUIPMENT CONSULTANT, IF ANY, SHALL REVIEW THESE PLANS AND AVAILABLE GEOTECHNICAL INFORMATION AND THE ANTICIPATED INSTALLATION SITES WITHIN THE PROJECT WORK AREA IN ORDER TO IMPLEMENT CONTRACTOR'S TRENCH EXCAVATION SAFETY PROTECTION SYSTEMS, PROGRAMS AND/OR PROCEDURES. THE CONTRACTOR'S IMPLEMENTATION OF THESE SYSTEMS, PROGRAMS AND/OR PROCEDURES SHALL PROVIDE FOR ADEQUATE TRENCH EXCAVATION SAFETY PROTECTION THAT COMPLIES WITH AS A MINIMUM, THE STANDARD PRACTICES FOR TRENCH EXCAVATION SAFETY PROTECTION. THE CONTRACTOR'S INDEPENDENTLY RETAINED EMPLOYEE OR SAFETY CONSULTANT SHALL IMPLEMENT A TRENCH SAFETY PROGRAM IN ACCORDANCE WITH OSHA STANDARDS GOVERNING THE PRESENCE AND ACTIVITIES OF INDIVIDUALS WORKING IN AND AROUND TRENCH EXCAVATION.

CAUTION!:
THE CONTRACTOR SHALL BE REQUIRED TO LOCATE ALL PUBLIC OR PRIVATE UTILITIES INCLUDING BUT NOT LIMITED TO: WATER, SEWER, TELEPHONE AND FIBER OPTIC LINES, SITE EXISTING ELECTRICAL SYSTEMS, GAS LINES, AND ALL OTHER UTILITIES, INCLUDING BUT NOT LIMITED TO LANDSCAPE IRRIGATION FACILITIES, AND GAS LINES. ANY UTILITY CONFLICTS THAT ARISE SHOULD BE COMMUNICATED TO THE ENGINEER IMMEDIATELY AND PRIOR TO CONSTRUCTION. THE CONTRACTOR SHALL CONTACT 1-800-DIG-TESS AT A MINIMUM OF 48 HOURS PRIOR TO THE STANDARD OF CONSTRUCTION. PRIMARY ELECTRICAL EXISTING UTILITIES SHALL BE THE SOLE RESPONSIBILITY OF THE CONTRACTOR AND THE REPAIR SHALL BE AT CONTRACTOR'S SOLE EXPENSE WHETHER THE UTILITY IS SHOWN ON THESE PLANS OR NOT.



HORZ SCALE: 1"=50'
VERT SCALE: 1"=5'



A BEXAR COUNTY PERMIT
MUST BE OBTAINED BEFORE
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R.O.W.

	=	FLOW ARROW
	=	WASHOUT CROWN
E.G.T.T.V.E.	=	ELECTRIC, GAS, TELEPHONE & CABLE EASEMENT
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	=	PROPOSED DRIVEWAY LOCATIONS

Engineering & Design

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KFW
ENGINEERS + SUPPLY

PROTECT YOURSELF

ALL STATES REQUIRE NOTIFICATION
EXCAVATORS, DESIGNERS, OR ANY OTHER
PREPARING TO DISTURB THE EARTH
SURFACE ANYWHERE IN ANY STATE


FOR STATE SPECIFIC DIRECT PHONE NUMB
VISIT: WWW.CALL811.COM

[illegible]

FOR

SOUTHEAST
MEADOWS UNIT 3
PLAT# 23-11800440

SAN ANTONIO
BEXAR COUNTY
TEXAS



Colliers
Engineering
& Design

SAN ANTONIO (KFW)
3421 Paesanos
Parkway
San Antonio, TX 78231
Phone: 210.979.8444
COLLIERS ENGINEERING & DESIGN,
TBPE Firm#: F-14909
TBPLS Firm#: 10194550

SCALE: AS SHOWN	DATE: 07/20/2023	DRAWN BY: SD	CHECKED BY: SC
PROJECT NUMBER: 205-43-07		DRAWING NAME: STPP2054307	

FIELDSTONE WAY
PLAN & PROFILE

SHEET NUMBER:

5.5

NOTE: DO NOT SCALE DRAWINGS FOR CONSTRUCTION

STREETS/STPP2054307.dwn/5.5 BY: ABIEL MONTALVO

[illegible]

SOUTHEAST
MEADOWS UNIT 3
PLAT# 23-11800440

Colliers
Engineering
& Design

SAN ANTONIO (KFW)
3421 Paesanos
Parkway
San Antonio, TX 78231
Phone: 210.979.8444

COLLIERS ENGINEERING & DESIGN, INC.
TBPB Firm#: F-14909
TBPBS Firm#: 10194550



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AS SHOWN	07/20/2023	SD	SC

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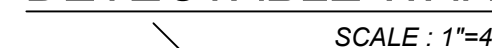
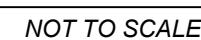
WHEELCHAIR RAMP
DETAIL SHEET

SHEET NUMBER:



NOTE: DO NOT SCALE DRAWINGS FOR CONSTRUCTION

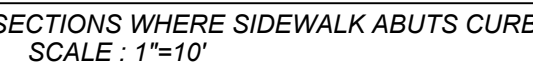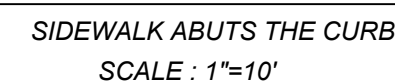

1. WHEN POSSIBLE SIDEWALKS SHOULD BE PLACED NEXT TO THE PROPERTY LINE, ALLOWING A MINIMUM OF 1 FOOT BUFFER. DEVIATION OF THE PATHWAY FROM A STRAIGHT LINE IS ENCOURAGED TO AVOID TREES OR OTHER OBSTRUCTIONS.
2. FOR LOCAL TYPE "A" STREETS, SIDEWALKS SHALL HAVE A MINIMUM UNOBSTRUCTED WIDTH OF 4' AND IF SEPARATED FROM THE CURB, THE SIDEWALK SHALL BE LOCATED A MINIMUM OF 3' FROM THE BACK OF CURB.
3. FOR OTHER THAN LOCAL TYPE "A" STREETS, SIDEWALKS SHALL HAVE A MINIMUM UNOBSTRUCTED WIDTH OF 4' AND SEPARATED A MINIMUM OF 3' FROM THE BACK OF CURB OR AS AN OPTION, THE SIDEWALK SHALL HAVE A MINIMUM WIDTH OF 6' WHEN LOCATED AT THE BACK OF CURB.
4. SIDEWALK RAMP LENGTHS PRESENTED IN TABLE 1 ARE GUIDELINES ONLY. SIDEWALK RAMP LENGTHS SHALL BE OF SUFFICIENT LENGTH TO MAINTAIN 8.33% (1:12) MAXIMUM SLOPE.
5. ALL CURB-RAMP OR LANDINGS ABUTTING THE CROSSWALK SHALL HAVE A DETECTABLE WARNING 24 INCHES DEEP (IN THE DIRECTION OF PEDESTRIAN TRAVEL) AND EXTENDING THE FULL WIDTH OF THE CURB RAMP OR LANDINGS. THE DETECTABLE WARNING SHALL CONSIST OF RAISED TRUNCATED DOMES, ALIGNED IN A GRID PATTERN WITH A DIAMETER OF A NOMINAL 0.9 INCHES (23 MM), A HEIGHT OF NOMINAL 0.2 INCHES (5 MM) AND A CENTER-TO-CENTER SPACING OF NOMINAL 2.35 INCHES (60 MM). THE DETECTABLE WARNING SURFACE SHALL BE PAVERS CONFORMING TO TxDOT STANDARD PED-05, PEDESTRIAN FACILITIES.
6. DETECTABLE WARNINGS SHALL CONTRAST VISUALLY WITH ADJOINING SURFACES, EITHER LIGHT-ON-DARK, OR DARK-ON-LIGHT. THE MATERIAL USED TO PROVIDE CONTRAST SHALL BE AN INTEGRAL PART OF THE WALKING SURFACE.
7. SIDEWALK RAMP TYPE V SHALL BE USED ONLY WHERE THERE IS SIGNIFICANT RESTRICTION WITHIN THE PARKWAY TO CONSTRUCT TYPE I OR TYPE III RAMPS.
8. CONSTRUCTION OF ALL WHEELCHAIR RAMPS TO BE INCLUDED UNDER ITEMS "500 - CONCRETE CURB, GUTTER AND CONCRETE CURB AND GUTTER" AND / OR "502 - CONCRETE SIDEWALKS": RAMP SURFACE SHALL BE BRUSH.
9. THESE DETAILS ARE FOR REFERENCE ONLY. ACTUAL LOCATIONS OF WHEELCHAIR RAMPS TO BE SHOWN ON CONSTRUCTION PLANS. CITY CONSTRUCTION INSPECTOR CAN ADJUST LOCATIONS FOR SAFETY OR
10. SIDEWALKS LESS THAN 5 FEET IN WIDTH SHALL BE PROVIDED WITH A PASSING SPACE AT A MAXIMUM
11. WHEELCHAIR RAMP SHALL BE CONSTRUCTED WITH 4" CLASS "A" CONCRETE AND 2" MINIMUM GRAVEL, CRUSHED ROCK OR FLEXIBLE BASE MATERIAL.
12. REINFORCING STEEL SHALL BE #3 BARS AT 18" O.C.E.W. OR 6" x 6" - W2.9 x W2.9 WIRE MESH.
13. SIDEWALK GRADES SHALL NOT EXCEED THE GRADE ESTABLISHED FOR THE ADJACENT ROADWAY, ANY SIDEWALK CONSTRUCTION THAT DEVIATES FROM THE NATURAL GRADE OF THE ROADWAY TO CREATE A GRADE STEEPER THAN THE EXISTING ROADWAY WILL REQUIRE RAMPS, HANDRAILS AND RESTING PLATFORMS TO BE CONSTRUCT IN ACCORDANCE WITH ADA AND TAS STANDARDS.
14. SIDEWALK CROSS GRADE SHALL HAVE A MAXIMUM SLOPE OF 2%. LANDINGS SHALL HAVE A MAXIMUM SLOPE OF 2% IN ANY DIRECTION.
15. THE CHANGE OF GRADE BETWEEN ADJACENT SURFACES SHALL BE LESS THAN 11%. THE CHANGE OF GRADE SHALL BE DEFINED AS THE ALGEBRAIC DIFFERENCE OF THE ADJACENT SURFACE SLOPES. IN THE CASE OF A CROSS SLOPE, THE MAXIMUM PERMITTED SLOPE IS THE 8.33% MAXIMUM SLOPE. THE ADJACENT PAVEMENT CROSS SLOPE SHALL BE LESS THAN 2.67% ((E: 8.33-(2.67)+1)). IN ADDITION, THE ADJACENT PAVEMENT CROSS SLOPE SHALL BE LESS THAN OR EQUAL TO 0.5%.
16. IF THE CHANGE OF GRADE BETWEEN ADJACENT SURFACES IS GREATER THAN OR EQUAL TO 11%, A LEVELING STRIP, 2 FEET IN LENGTH, SHALL BE PROVIDED TO TRANSITION THE ADJACENT SURFACES.
17. ADA COMPLIANCE IN ALTERATIONS INCLUDE ONLY THAT WORK WITHIN THE LIMITS, BOUNDARIES OR SCOPE OF A PLANNED PROJECT.



NOTE:
STAMPED CONCRETE TRUNCATED DOMES WILL NOT BE ALLOWED TO BE USED FOR DETECTABLE WARNING ON WHEELCHAIR RAMPS. CONTRACTOR MUST SUBMIT TRUNCATED DOME INFORMATION THAT IS TO BE USED ON WHEELCHAIR RAMPS TO THE PROJECT MANAGER FOR APPROVAL AT LEAST 30 DAYS PRIOR TO INSTALLATION

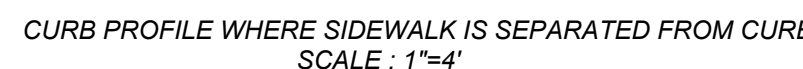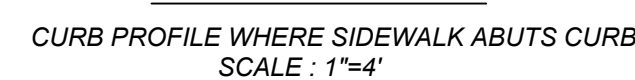

GUTTER SLOPE	SIDEWALK RAMP LENGTH (1:12)	
	LOW SIDE	HIGH SIDE
1%	5'-6"	7'-2"
2%	5'-0"	8'-4"
3%	4'-6"	10'-0"
4%	4'-2"	12'-6"
5%	3'-10"	16'-8"

CAPITAL IMPROVEMENTS MANAGEMENT SERVICES DEPARTMENT


WHEELCHAIR RAMP STANDARDS

_____ % SUBMITTAL	PROJECT NO.: _____		DATE: _____
DRWN. BY: V. VASQUEZ	DSGN. BY: _____	CHKD. BY: R.S. HOSSEINI, P.E.	SHEET NO.: _____ OF _____




DATE: _____
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DATE: _____
FILE: _____

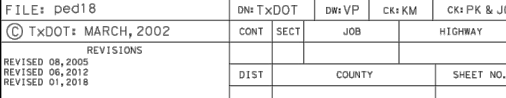

REV	DATE	DRAWN BY	DESCRIPTION
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FILE NO.	DATE	TIME	DATE	TIME	DATE	TIME
TXDOT: MARCH, 2002	CONT	SECT	JOB	HIGHWAY		
REVISED 08, 2005	<div> <div>REVISIONS</div> <div> <div>REVISED 06, 2012</div> <div>REVISED 07, 2018</div> </div> </div>					
DIST	COUNTY			SHEET NO.		

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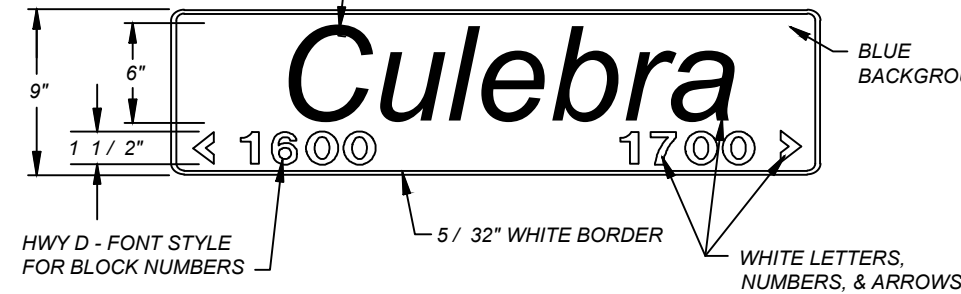
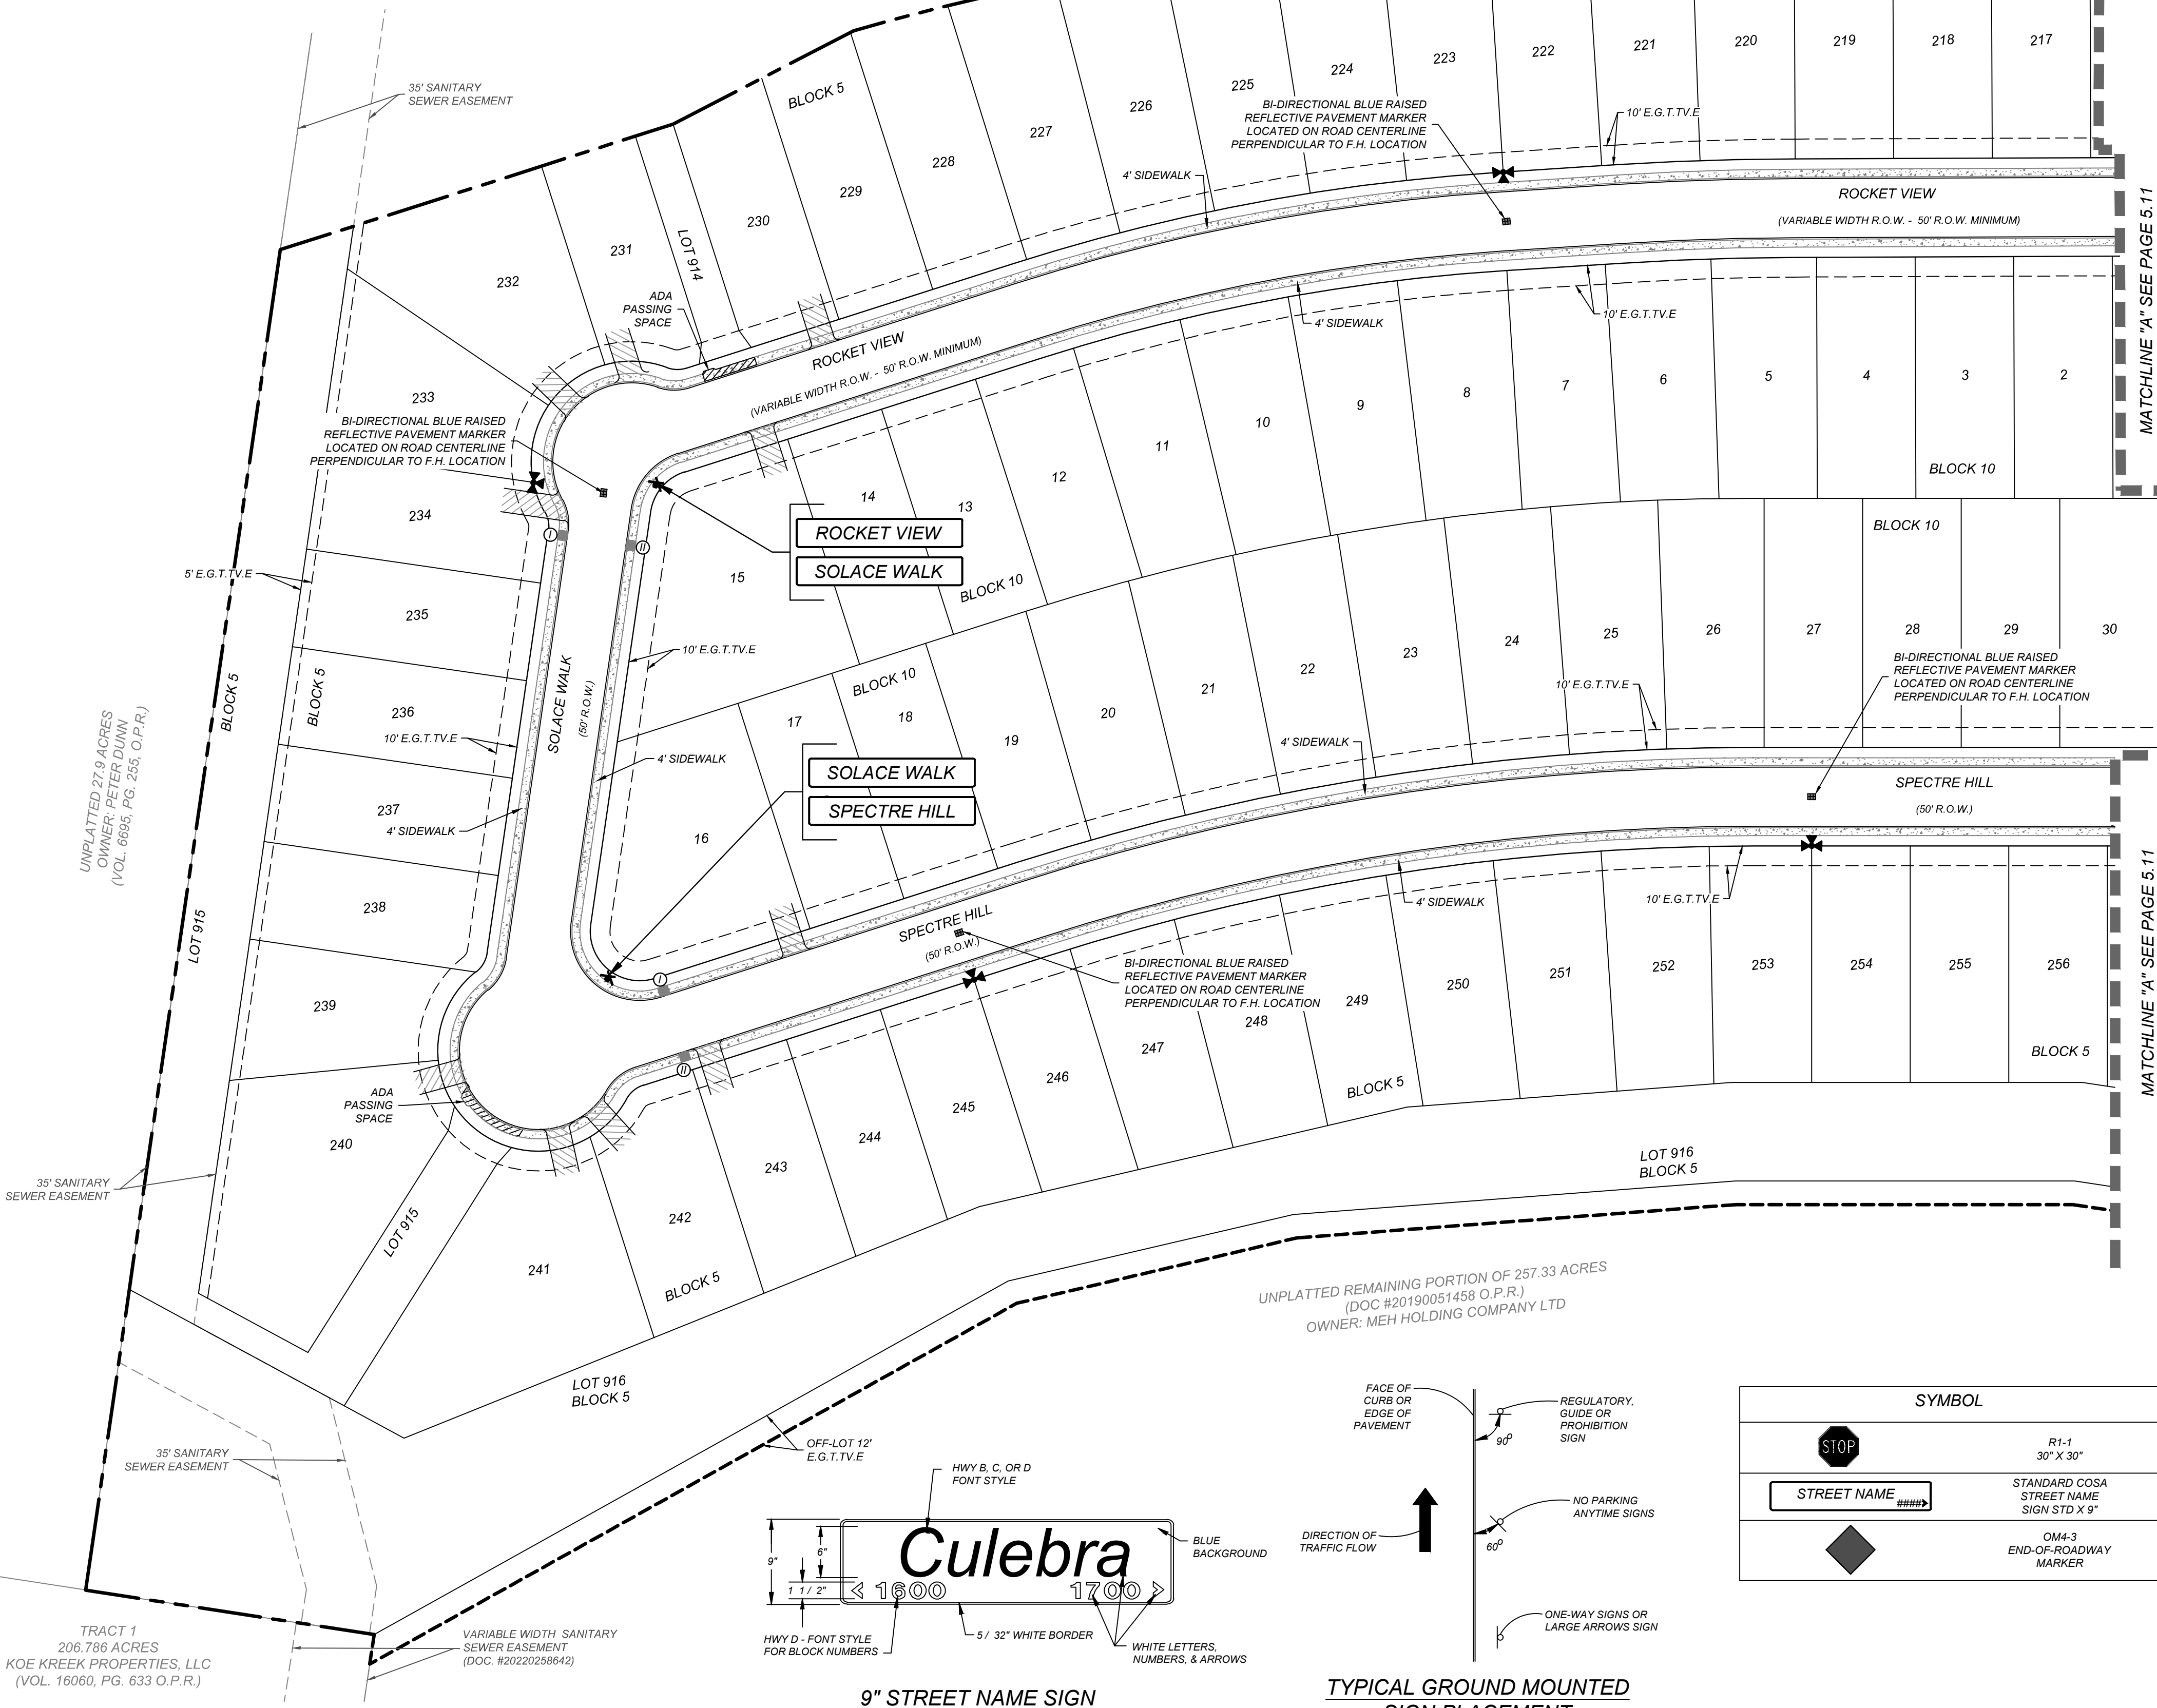
5.8

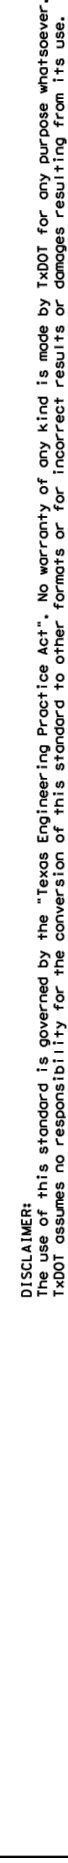NOTES:
1) WITHIN THE CITY'S EXTRATERRITORIAL JURISDICTION, STREET NAME SIGNS SHALL BE INSTALLED AT ALL INTERSECTIONS WITHIN AND ABUTTING THE SUBDIVISION. SUCH SIGNS SHALL BE MANUFACTURED AND INSTALLED BY THE SUBDIVIDER IN ACCORDANCE TO SPECIFICATIONS OF, AND SUBJECT TO PLAN REVIEWS AND INSPECTIONS BY THE COUNTY DEPARTMENT OF PUBLIC WORKS.
2) REGULATORY AND WARNING TRAFFIC SIGNS SHALL BE INSTALLED WITHIN AND ABUTTING THE SUBDIVISION IN ACCORDANCE WITH THE "TEXAS MANUAL ON UNIFORM TRAFFIC CONTROL DEVICES (TMUTCD)," AS REQUIRED BY THE CITY'S DEVELOPMENT SERVICES DEPARTMENT OR COUNTY'S DEPARTMENT OF PUBLIC WORKS. SUCH SIGNS SHALL BE MANUFACTURED AND INSTALLED BY THE SUBDIVIDER IN ACCORDANCE TO SPECIFICATIONS OF, AND SUBJECT TO PLAN REVIEWS AND INSPECTIONS BY THE CITY'S DEVELOPMENT SERVICES DEPARTMENT OR COUNTY'S DEPARTMENT OF PUBLIC WORKS. WARNING AND REGULATORY SIGNS SHALL NOT BE ACCEPTED BY THE CITY UNTIL THE STREET HAS BEEN ACCEPTED FOR MAINTENANCE BY THE CITY.

TRENCH EXCAVATION SAFETY PROTECTION
CONTRACTOR AND/OR CONTRACTOR'S INDEPENDENTLY RETAINED EMPLOYEE OR STRUCTURAL DESIGN/GEOTECHNICAL/SAFETY/EQUIPMENT CONSULTANT, IF ANY, SHALL REVIEW THESE PLANS AND ANY AVAILABLE GEOTECHNICAL INFORMATION AND THE ANTICIPATED INSTALLATION SITES WITHIN THE PROJECT WORK AREA IN ORDER TO IMPLEMENT CONTRACTOR'S TRENCH EXCAVATION SAFETY PROTECTION SYSTEMS, PROGRAMS AND/OR PROCEDURES FOR THE PROJECT DESCRIBED IN THE CONTRACT DOCUMENTS. THE CONTRACTOR'S IMPLEMENTATION OF THESE SYSTEMS, PROGRAMS AND/OR PROCEDURES SHALL PROVIDE FOR ADEQUATE TRENCH EXCAVATION SAFETY PROTECTION THAT COMPLY WITH AS A MINIMUM, OSHA STANDARDS FOR TRENCH EXCAVATIONS. SPECIFICALLY, CONTRACTOR AND/OR CONTRACTOR'S INDEPENDENTLY RETAINED EMPLOYEE OR SAFETY CONSULTANT SHALL IMPLEMENT A TRENCH SAFETY PROGRAM IN ACCORDANCE WITH OSHA STANDARDS GOVERNING THE PRESENCE AND ACTIVITIES OF INDIVIDUALS WORKING IN AND AROUND TRENCH EXCAVATION.


BEXAR COUNTY R.O.W. NOTE:
A BEXAR COUNTY PERMIT MUST BE OBTAINED BEFORE WORKING IN THE BEXAR COUNTY RIGHT OF WAY.

UNPLATTED REMAINING PORTION OF 257.33 ACRES
(DOC #20190051458 O.P.R.)
OWNER: MEH HOLDING COMPANY LTD




TYPICAL GROUND MOUNTED SIGN PLACEMENT

SYMBOL	ITEM NUMBER
	R1-1 30" X 30" 531.3
	STANDARD COSA STREET NAME SIGN STD X 9" 531.57
	OM4-3 END-OF-ROADWAY MARKER 531.56

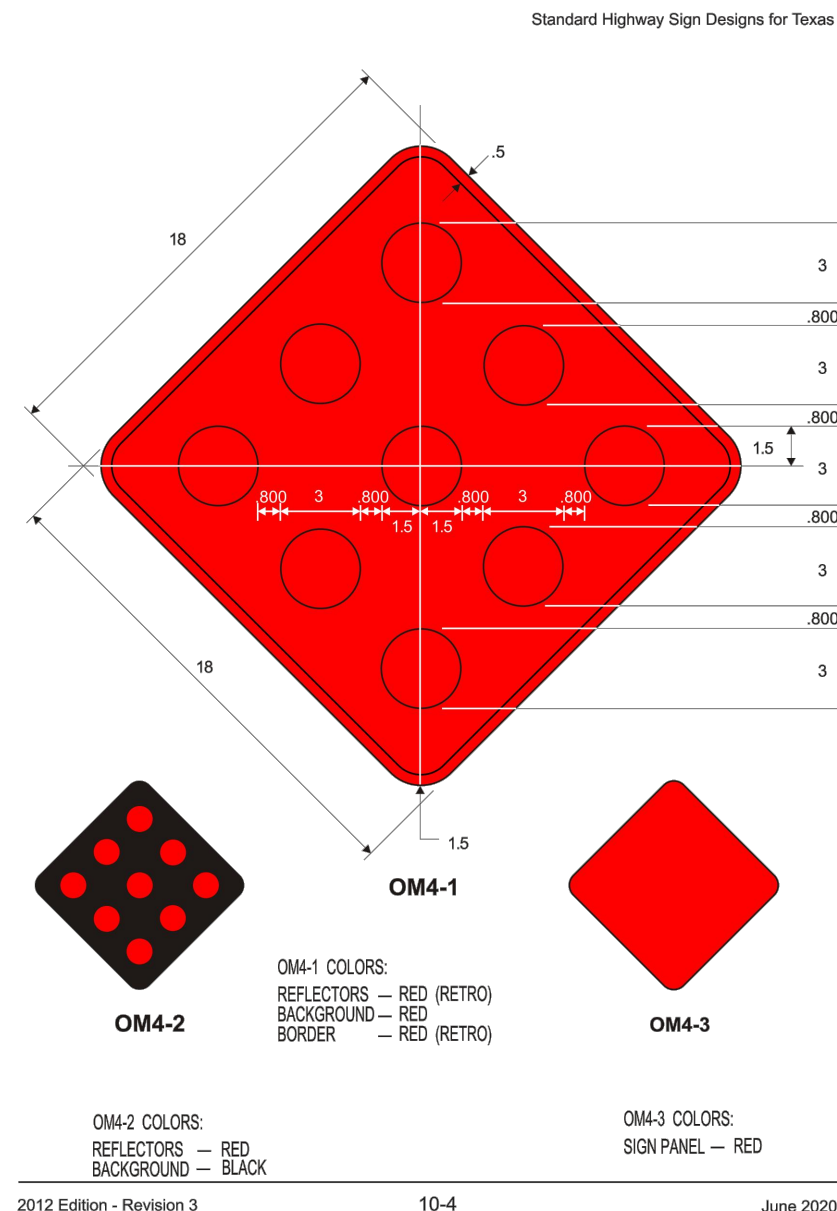

LOCATION MAP NOT-TO-SCALE

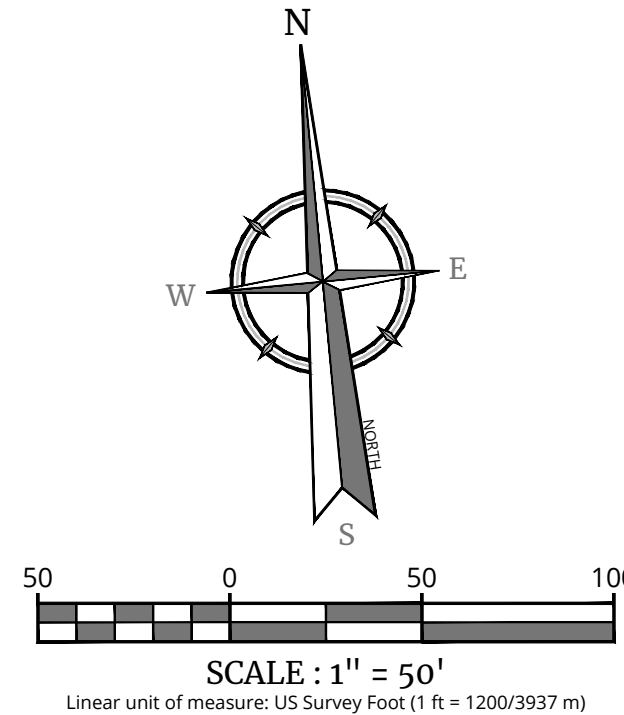

LEGEND

- C.B. = COUNTY BLOCK
- E.G.T.C.E. = GAS, ELECTRIC, TELEPHONE & CABLE EASEMENT
- V.N.A.E. = VEHICULAR NON-ACCESS EASEMENT
- II = WHEELCHAIR RAMP TYPE II SEE SHEET 5.7
- I = WHEELCHAIR RAMP TYPE I SEE SHEET 5.7
- SDWCR = SINGLE DIRECTIONAL WHEEL CHAIR RAMP SEE SHEET 5.7
- DDWCR = DOUBLE DIRECTIONAL WHEEL CHAIR RAMP SEE SHEET 5.7
- //// = SIDEWALK TO BE CONSTRUCTED BY DEVELOPER
- - - = SIDEWALK TO BE BUILT AT THE TIME OF HOME CONSTRUCTION
- /// = PROPOSED DRIVEWAY LOCATION

Engineering & Design

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FOR STATE SPECIFIC DIRECT PHONE NUMBERS VISIT: WWW.CALL811.COM

PRELIMINARY
FOR
SOUTHEAST MEADOWS UNIT 3
PLAT# 23-11800440

SAN ANTONIO
BEXAR COUNTY
TEXAS

SAN ANTONIO (KFW)
3421 Paesanos Parkway
San Antonio, TX 78231
Phone: 210.979.8444
COLLIERS ENGINEERING & DESIGN, INC.
TBE Form 11-14009
TBE'S Form: 10194500

SCALE: AS SHOWN

DATE: 07/20/2023

DRAWN BY: SD

CHECKED BY: SC

PROJECT NUMBER: 205-43-07

DRAWING NAME: TS2054307

TRAFFIC SIGNAGE AND PEDESTRIAN PLAN




SHEET NUMBER: 5.10

NOTE: DO NOT SCALE DRAWINGS FOR CONSTRUCTION.

NOTES:
1) WITHIN THE CITY'S EXTRATERRITORIAL JURISDICTION, STREET NAME SIGNS SHALL BE INSTALLED AT ALL INTERSECTIONS WITHIN AND ABUTTING THE SUBDIVISION. SUCH SIGNS SHALL BE MANUFACTURED AND INSTALLED BY THE SUBDIVIDER IN ACCORDANCE TO SPECIFICATIONS OF, AND SUBJECT TO PLAN REVIEWS AND INSPECTIONS BY THE COUNTY DEPARTMENT OF PUBLIC WORKS.
2) REGULATORY AND WARNING TRAFFIC SIGNS SHALL BE INSTALLED WITHIN AND ABUTTING THE SUBDIVISION IN ACCORDANCE WITH THE "TEXAS MANUAL ON UNIFORM TRAFFIC CONTROL DEVICES (TMUTCD)," AS REQUIRED BY THE CITY'S DEVELOPMENT SERVICES DEPARTMENT OR COUNTY'S DEPARTMENT OF PUBLIC WORKS. SUCH SIGNS SHALL BE MANUFACTURED AND INSTALLED BY THE SUBDIVIDER IN ACCORDANCE TO SPECIFICATIONS OF, AND SUBJECT TO PLAN REVIEWS AND INSPECTIONS BY THE CITY'S DEVELOPMENT SERVICES DEPARTMENT OR COUNTY'S DEPARTMENT OF PUBLIC WORKS. WARNING AND REGULATORY SIGNS SHALL NOT BE ACCEPTED BY THE CITY UNTIL THE STREET HAS BEEN ACCEPTED FOR MAINTENANCE BY THE CITY.

TRENCH EXCAVATION SAFETY PROTECTION
CONTRACTOR AND/OR CONTRACTOR'S INDEPENDENTLY RETAINED EMPLOYEE OR STRUCTURAL DESIGN/GEOTECHNICAL/SAFETY/EQUIPMENT CONSULTANT, IF ANY, SHALL REVIEW THESE PLANS AND ANY AVAILABLE GEOTECHNICAL INFORMATION AND THE ANTICIPATED INSTALLATION SITES WITHIN THE PROJECT WORK AREA IN ORDER TO IMPLEMENT CONTRACTOR'S TRENCH EXCAVATION SAFETY PROTECTION SYSTEMS, PROGRAMS AND/OR PROCEDURES FOR THE PROJECT DESCRIBED IN THE CONTRACT DOCUMENTS. THE CONTRACTOR'S IMPLEMENTATION OF THESE SYSTEMS, PROGRAMS AND/OR PROCEDURES SHALL PROVIDE FOR ADEQUATE TRENCH EXCAVATION SAFETY PROTECTION THAT COMPLY WITH AS A MINIMUM, OSHA STANDARDS FOR TRENCH EXCAVATIONS. SPECIFICALLY, CONTRACTOR AND/OR CONTRACTOR'S INDEPENDENTLY RETAINED EMPLOYEE OR SAFETY CONSULTANT SHALL IMPLEMENT A TRENCH SAFETY PROGRAM IN ACCORDANCE WITH OSHA STANDARDS GOVERNING THE PRESENCE AND ACTIVITIES OF INDIVIDUALS WORKING IN AND AROUND TRENCH EXCAVATION.

BEXAR COUNTY R.O.W. NOTE:
A BEXAR COUNTY PERMIT MUST BE OBTAINED BEFORE WORKING IN THE BEXAR COUNTY RIGHT OF WAY.

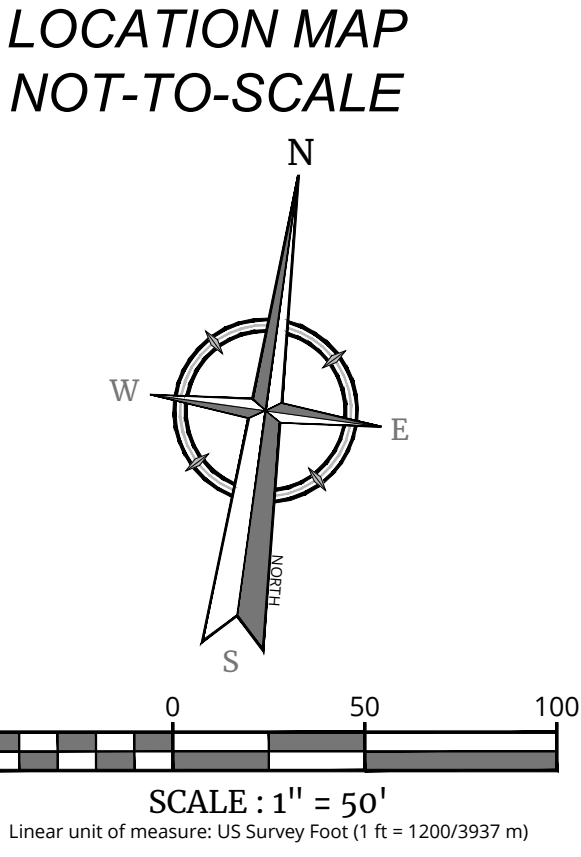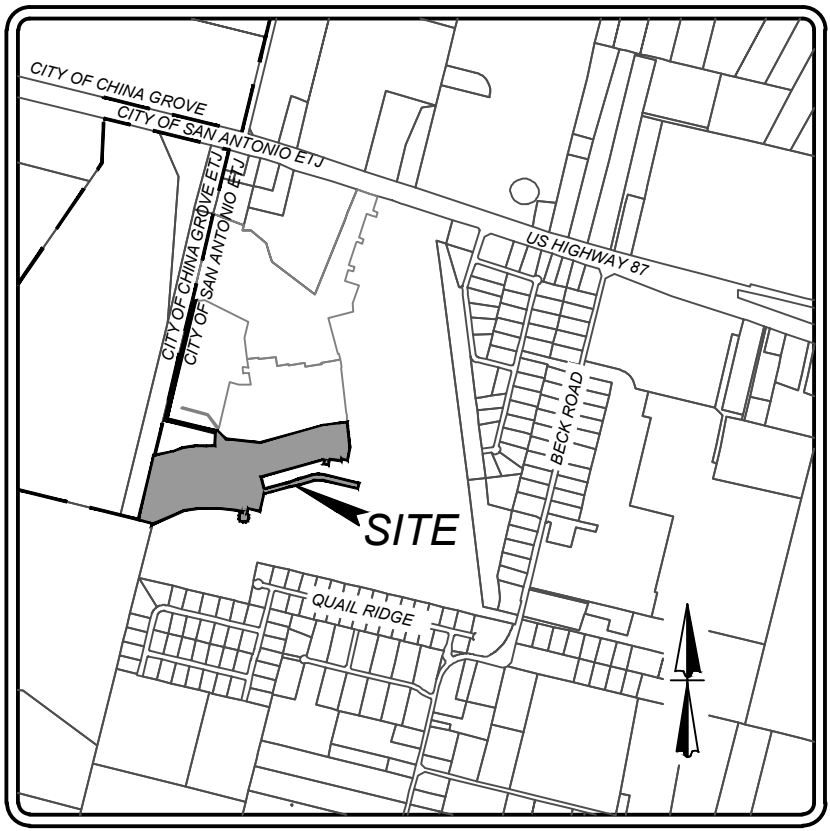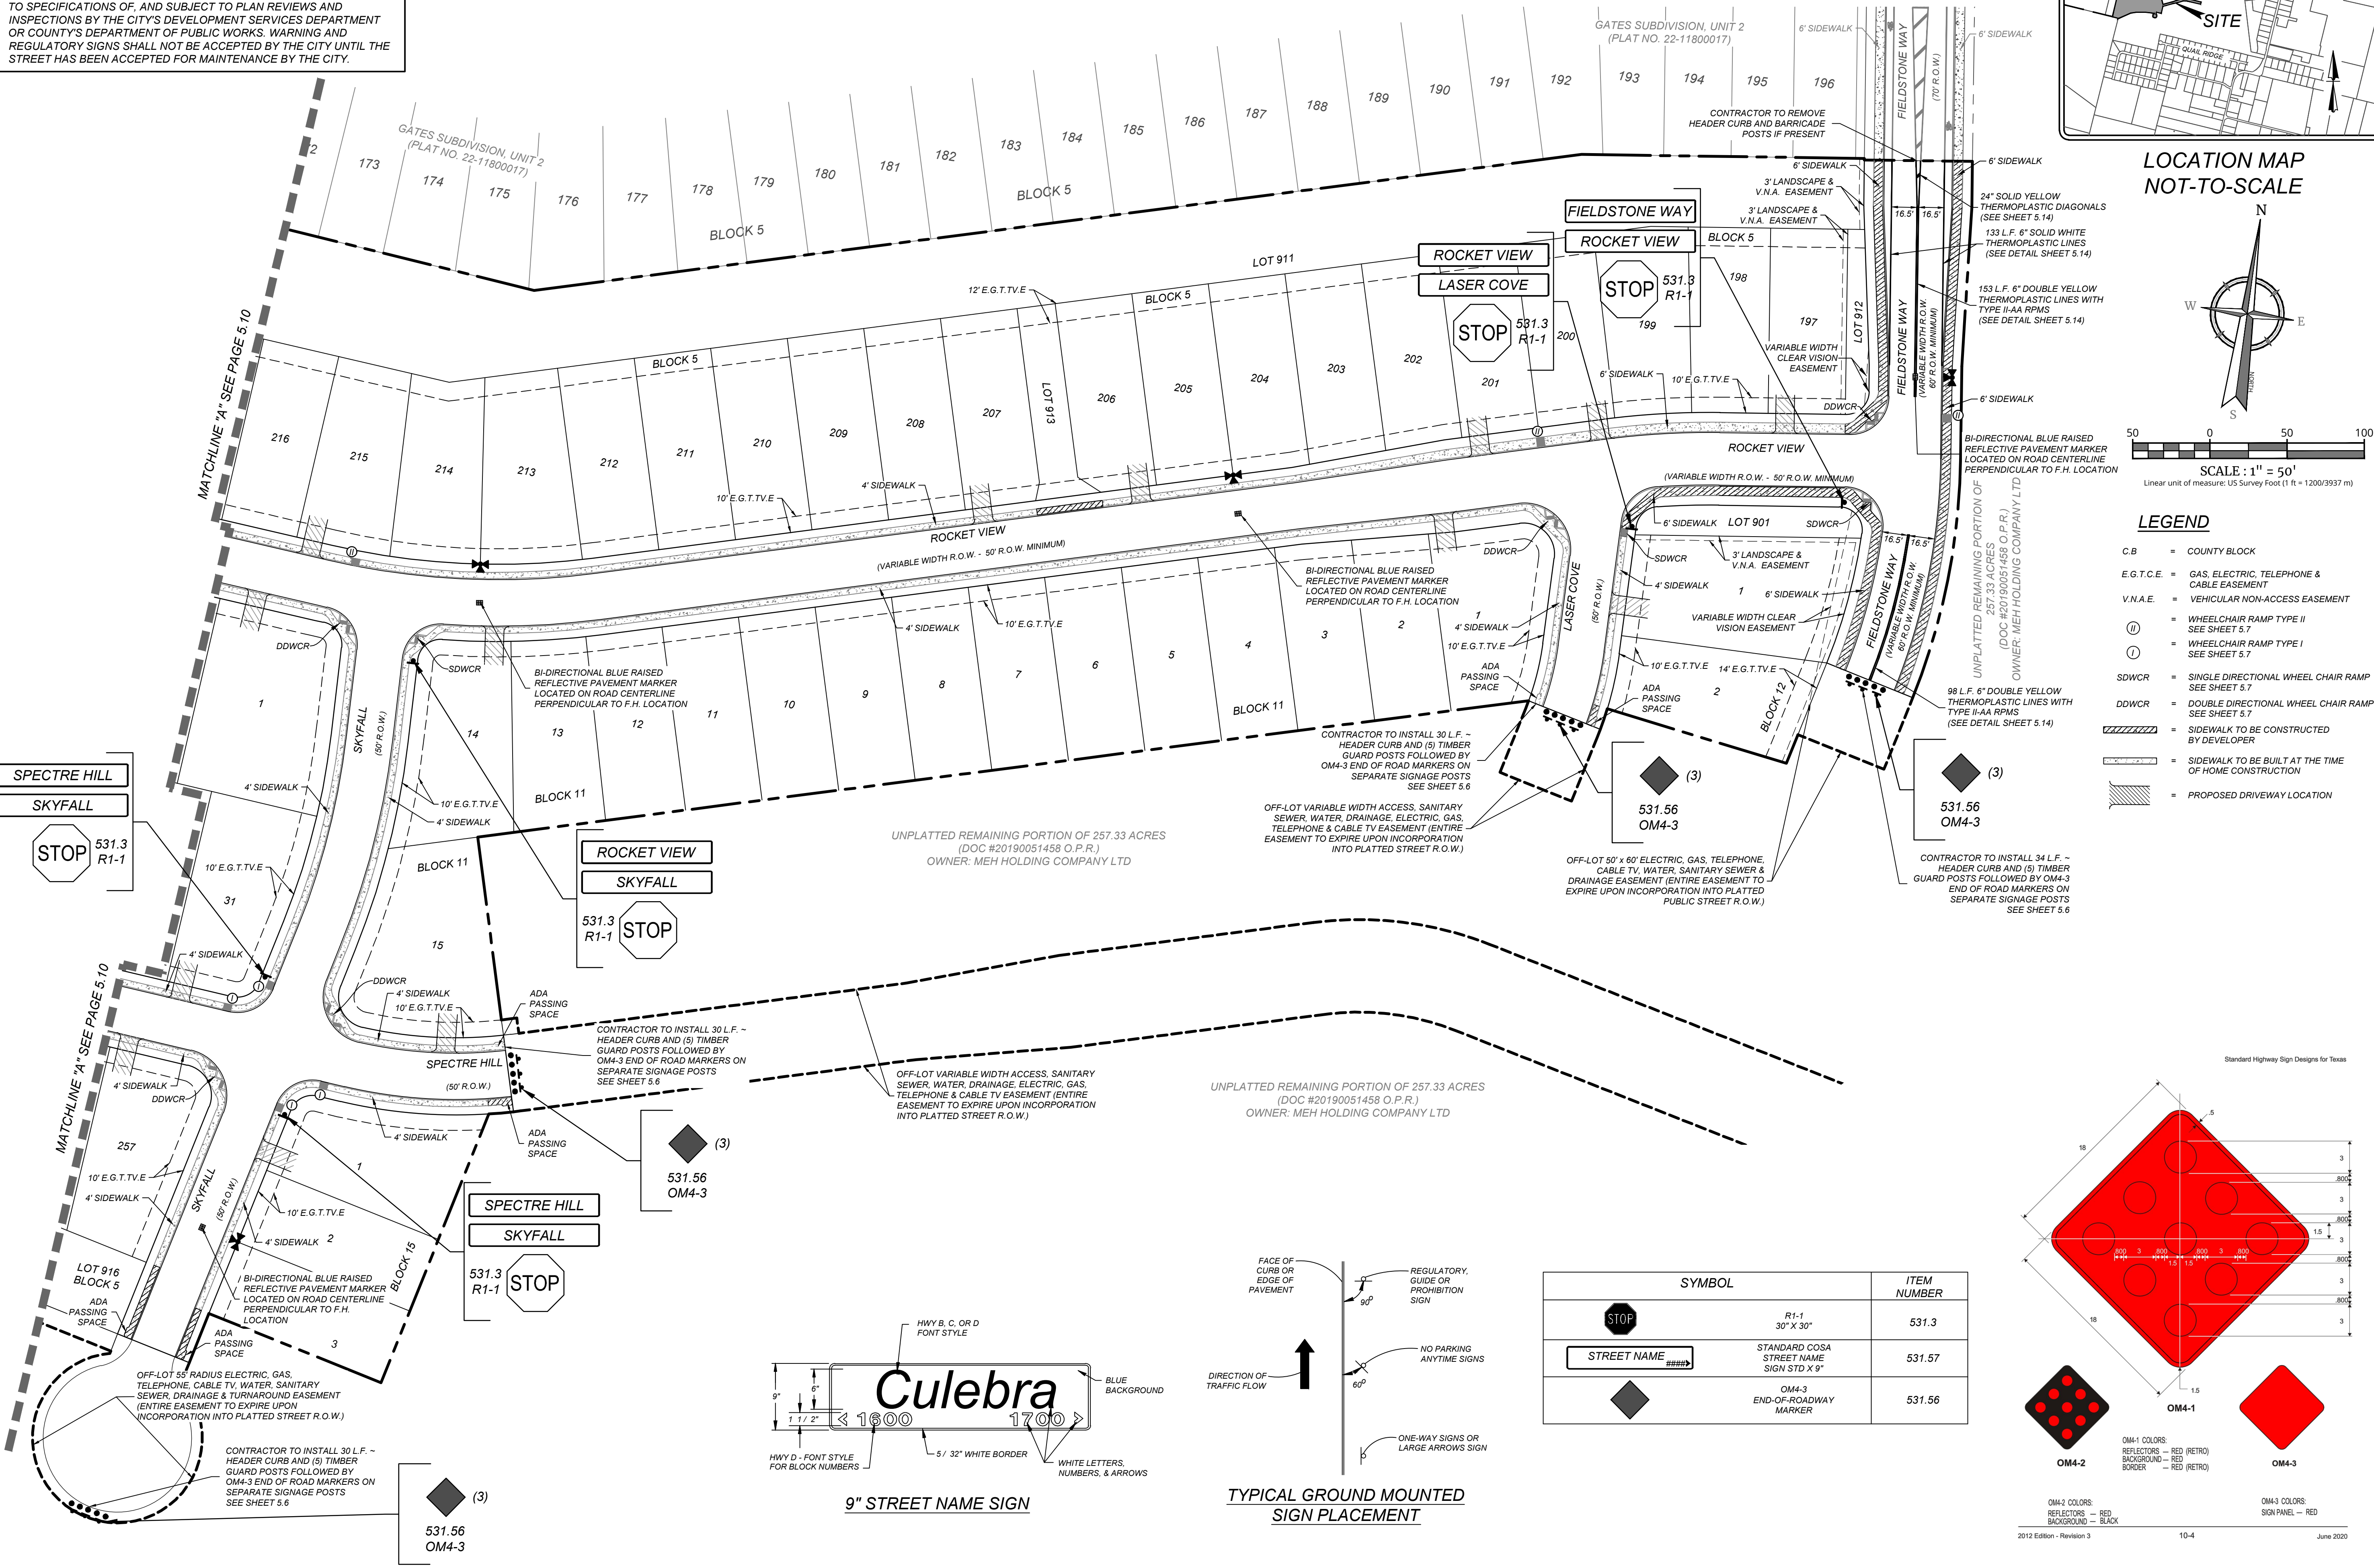

- LEGEND**
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STATE OF TEXAS

JEFFREY W. MARTIN

139094

LICENSED PROFESSIONAL ENGINEER

6/28/24

PRELIMINARY

FOR

SOUTHEAST MEADOWS UNIT 3

PLAT# 23-11800440

SAN ANTONIO BEXAR COUNTY TEXAS

Colliers

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SAN ANTONIO (KFW)
3421 Paesanos Parkway
San Antonio, TX 78231
Phone: 210.979.8444
COLLIERS ENGINEERING & DESIGN, INC.
TBE Form 1-1-009
TBE's Form 1-1014550




SCALE: AS SHOWN	DATE: 07/20/2023	DRAWN BY: SD	CHECKED BY: SC
PROJECT NUMBER: 205-43-07	DRAWING NUMBER: TS2054307		

SHEET TITLE: **TRAFFIC SIGNAGE AND PEDESTRIAN PLAN**

SHEET NUMBER: **5.11**

NOTE: DO NOT SCALE DRAWINGS FOR CONSTRUCTION.

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DESCRIPTION

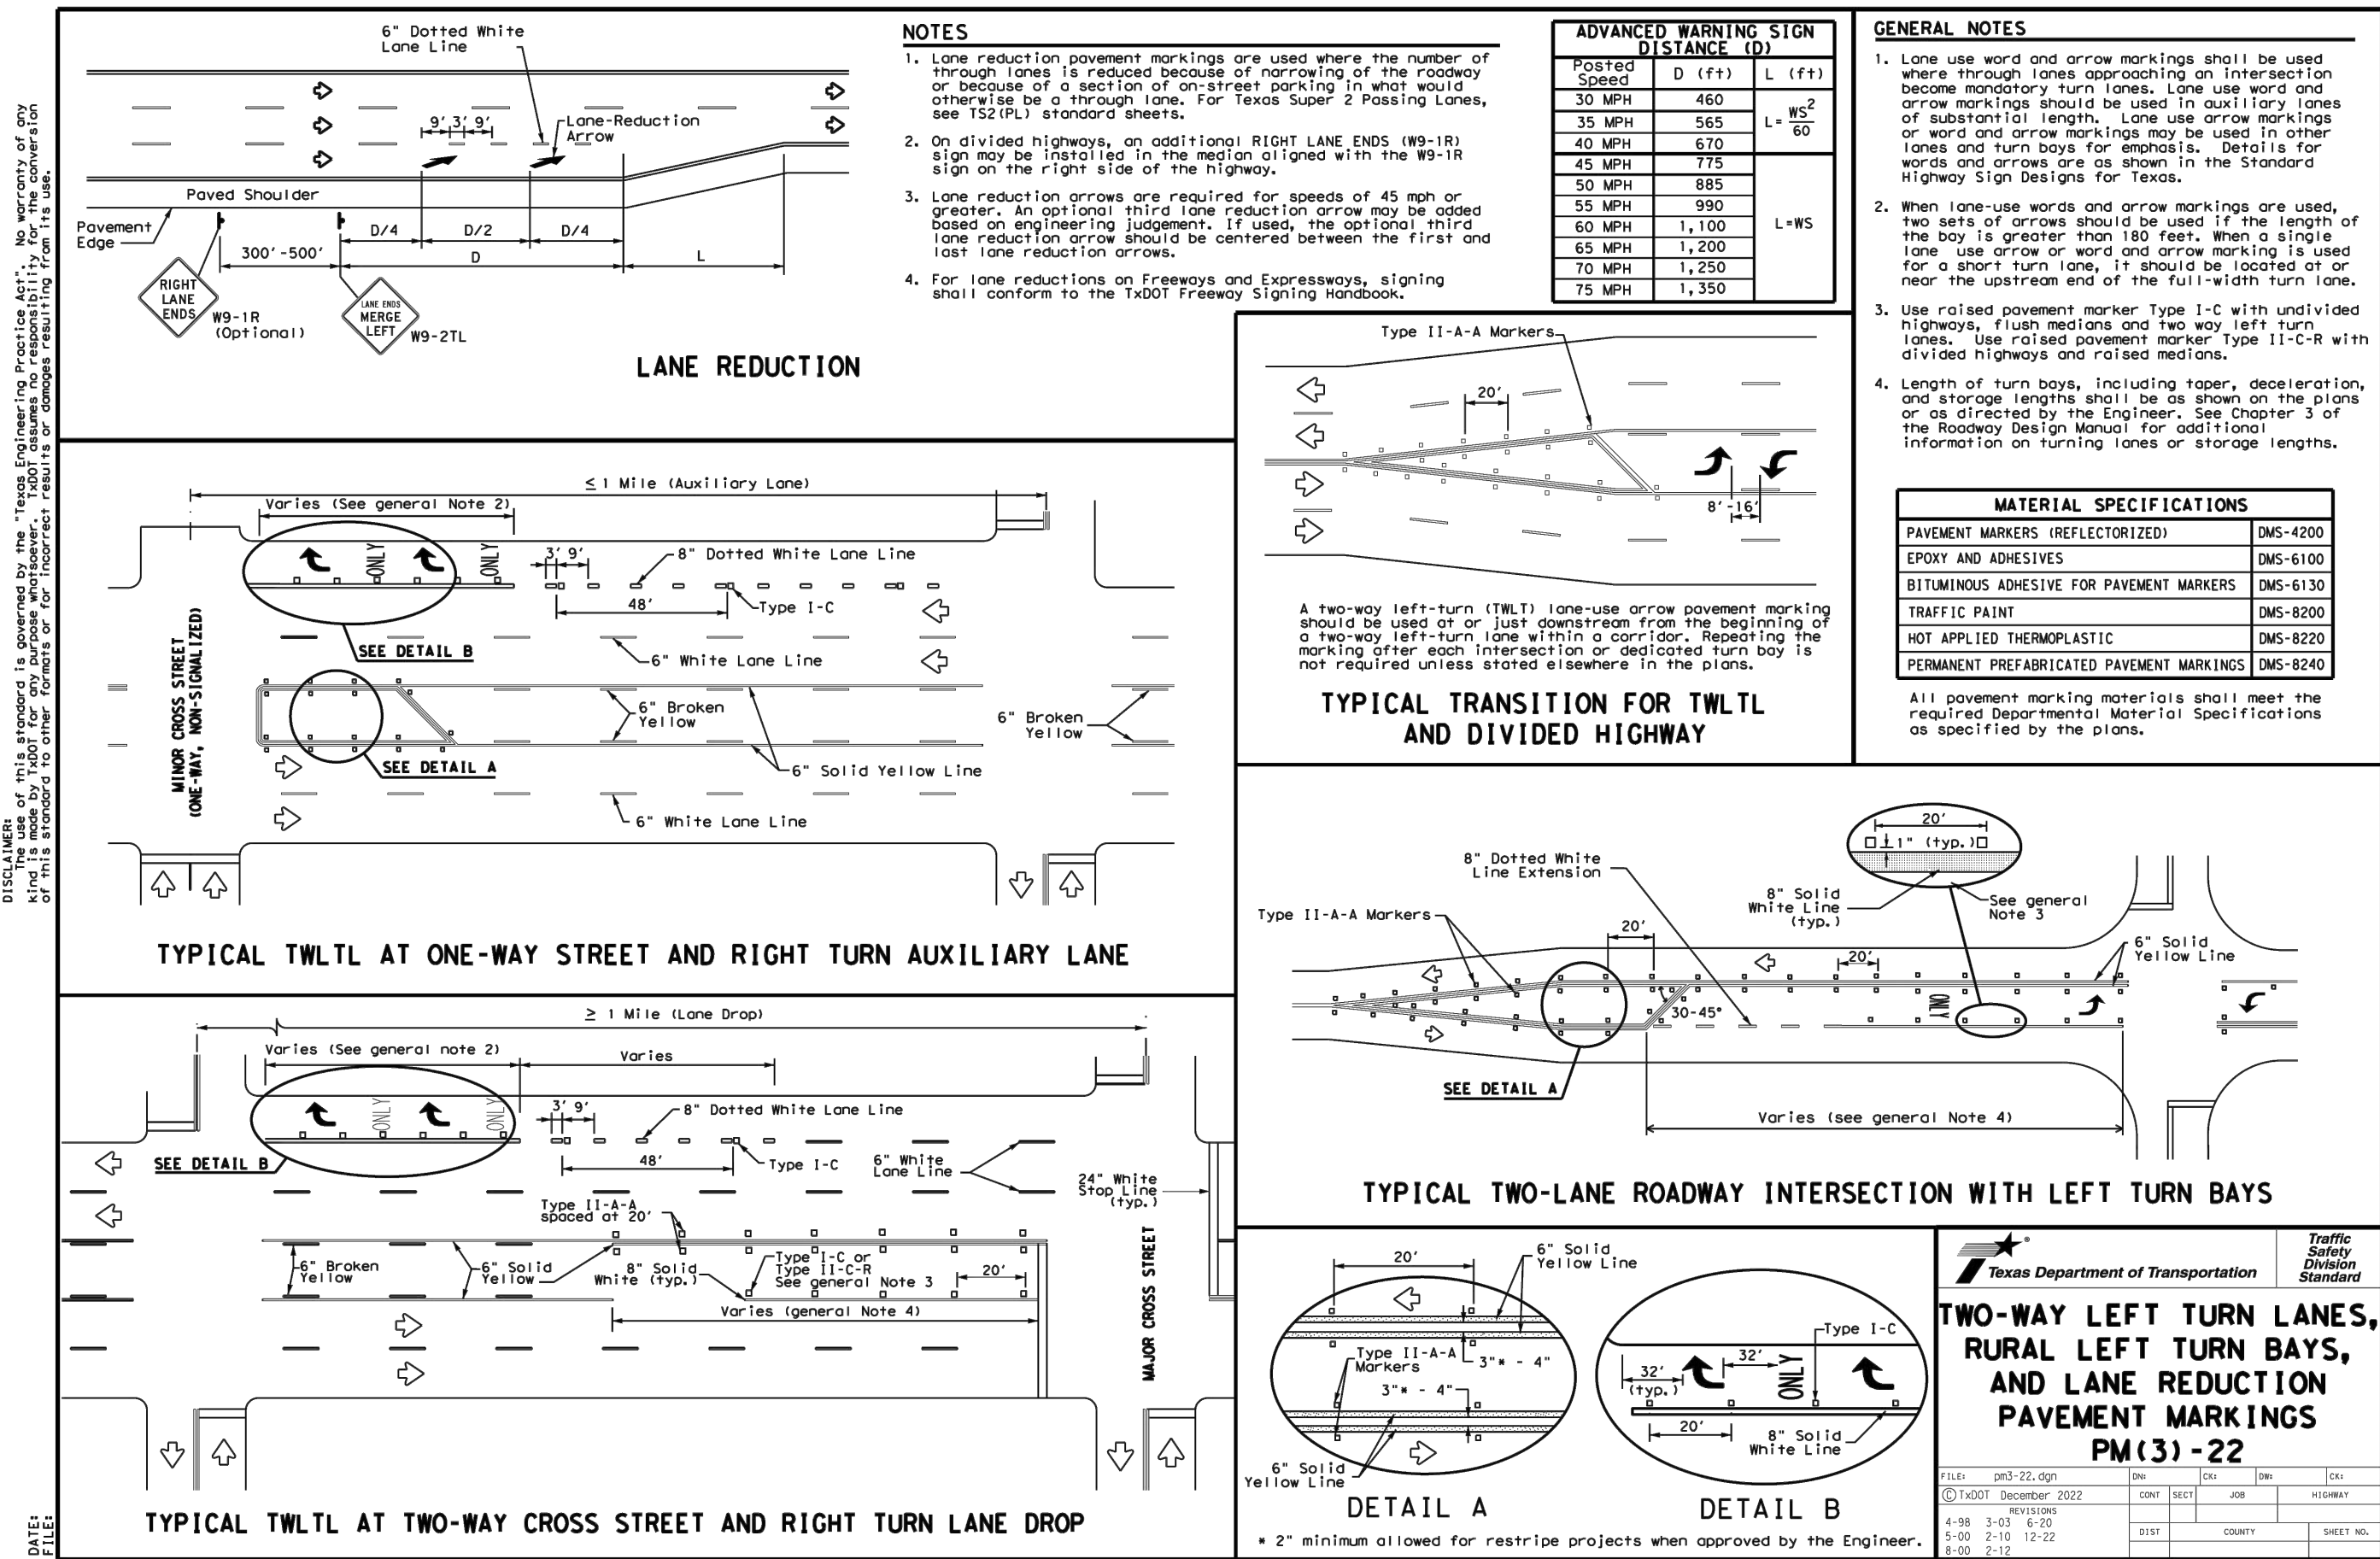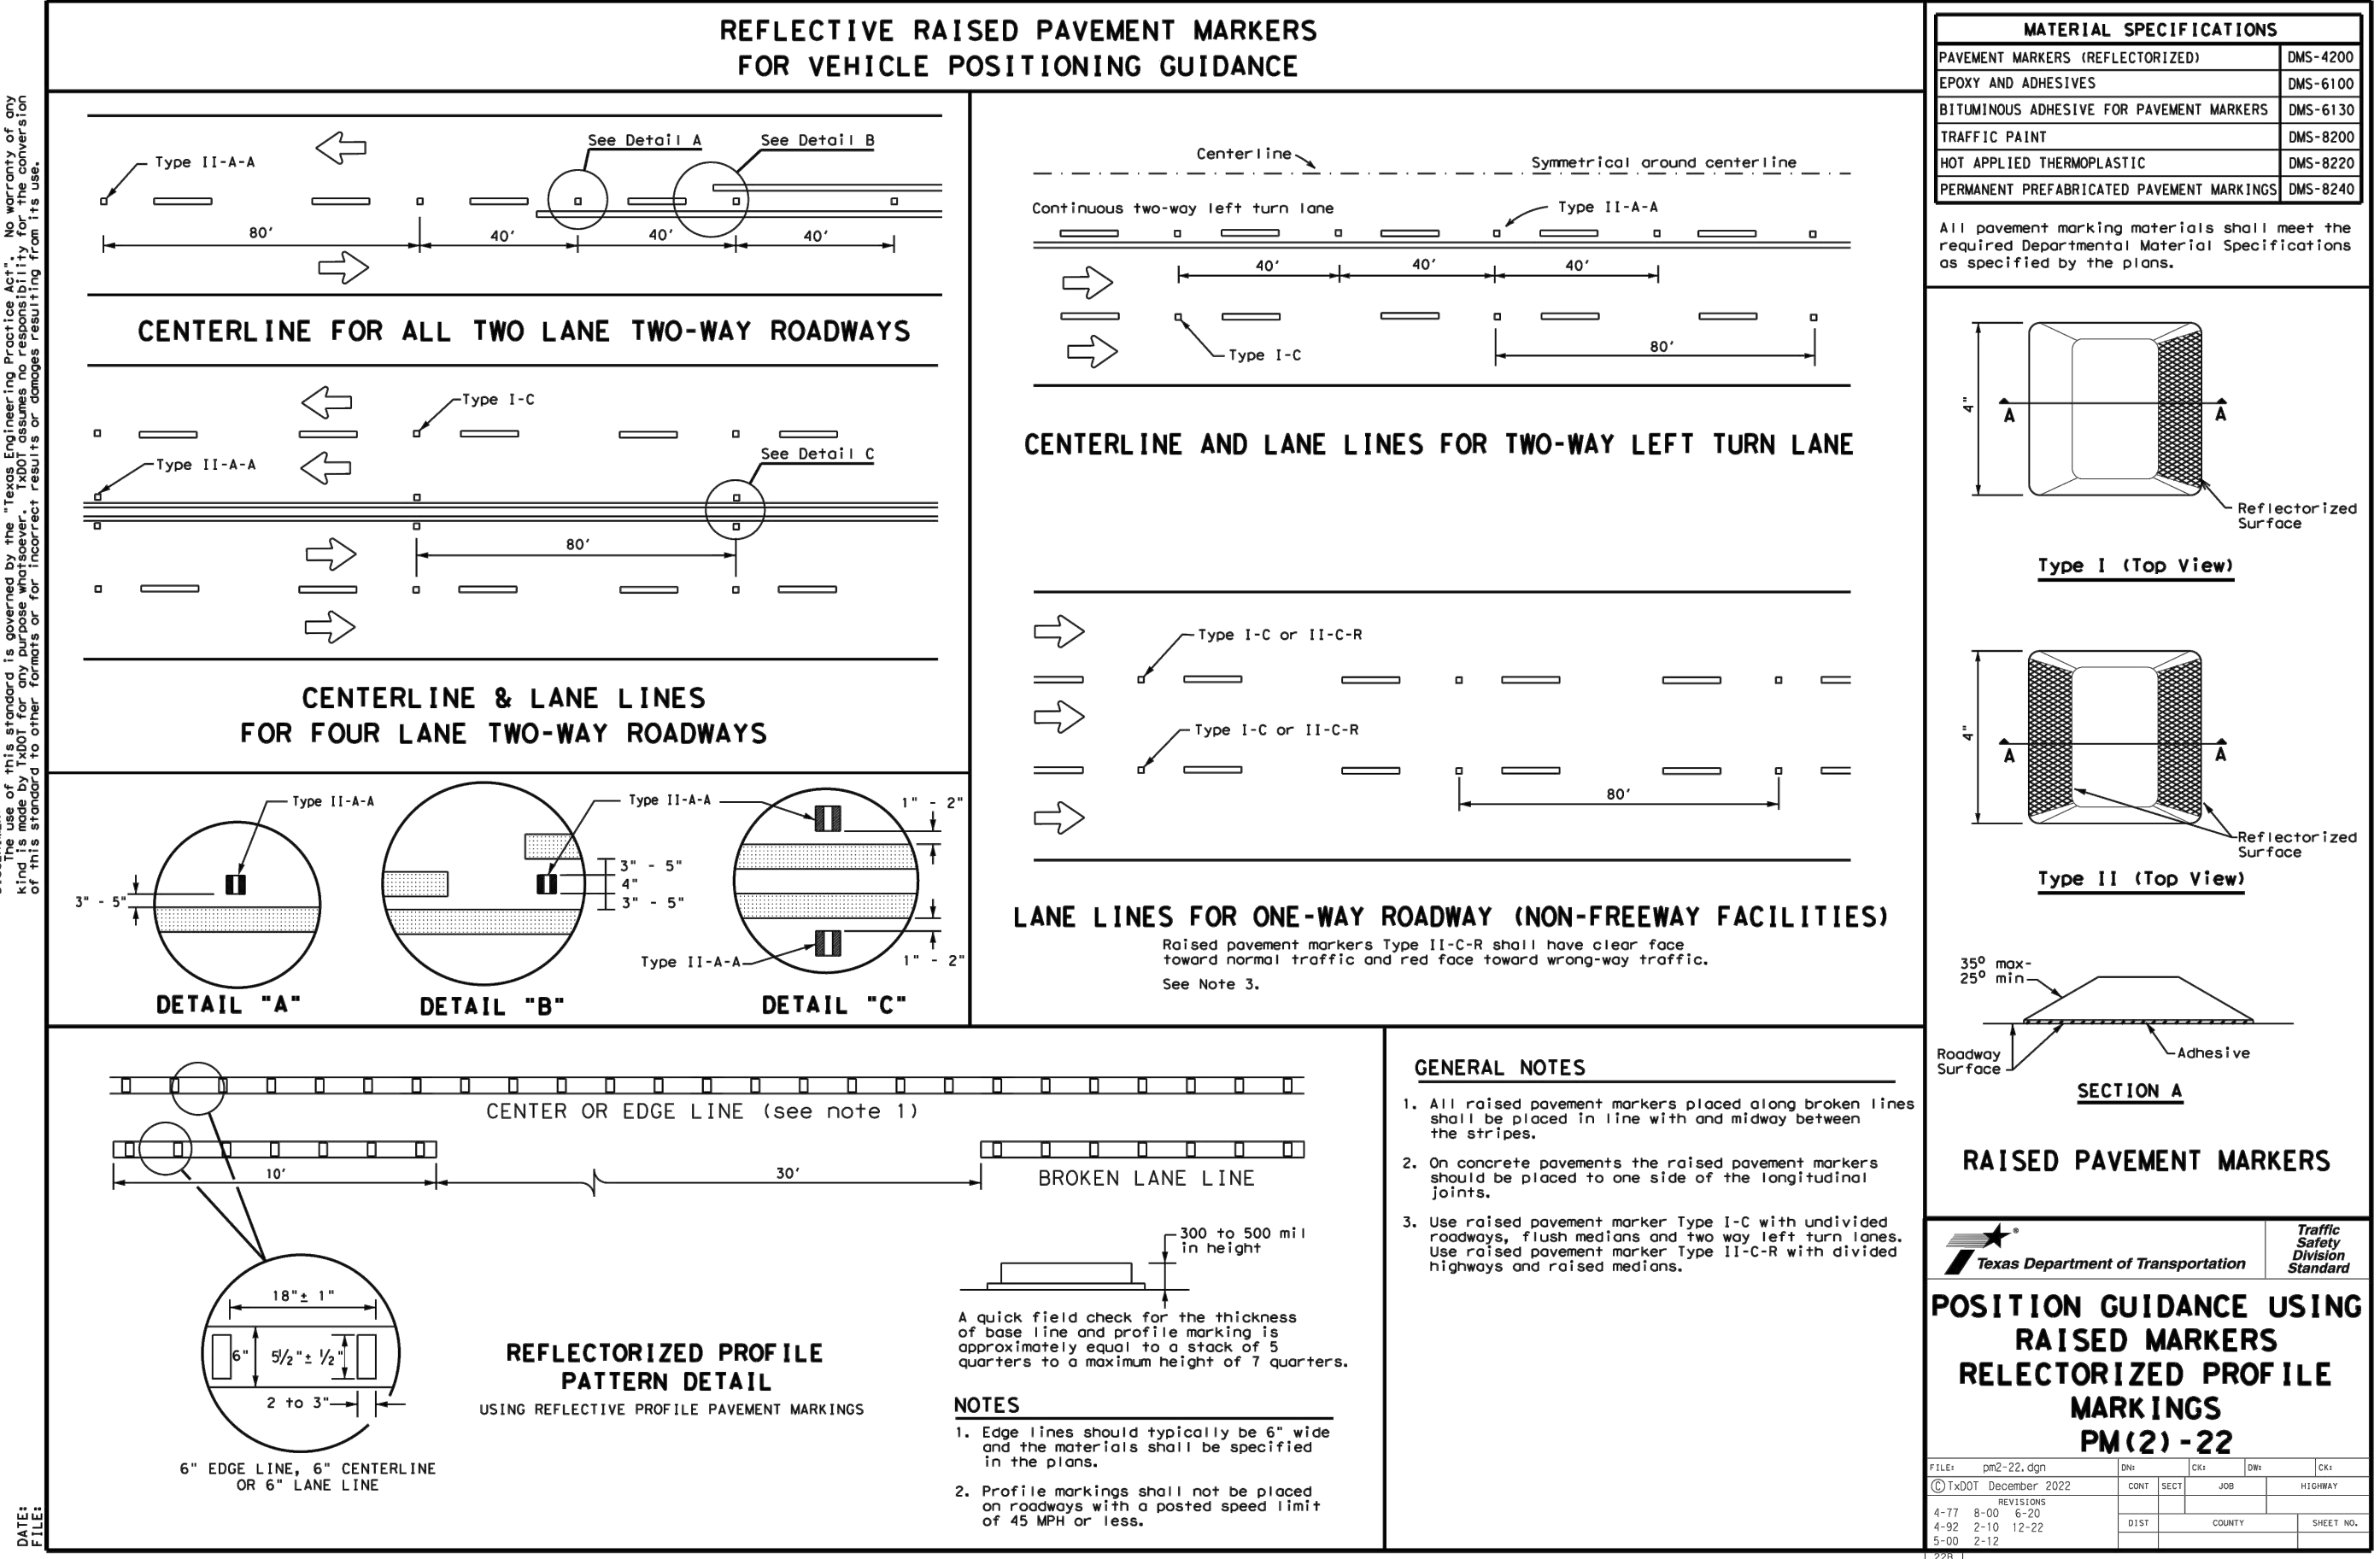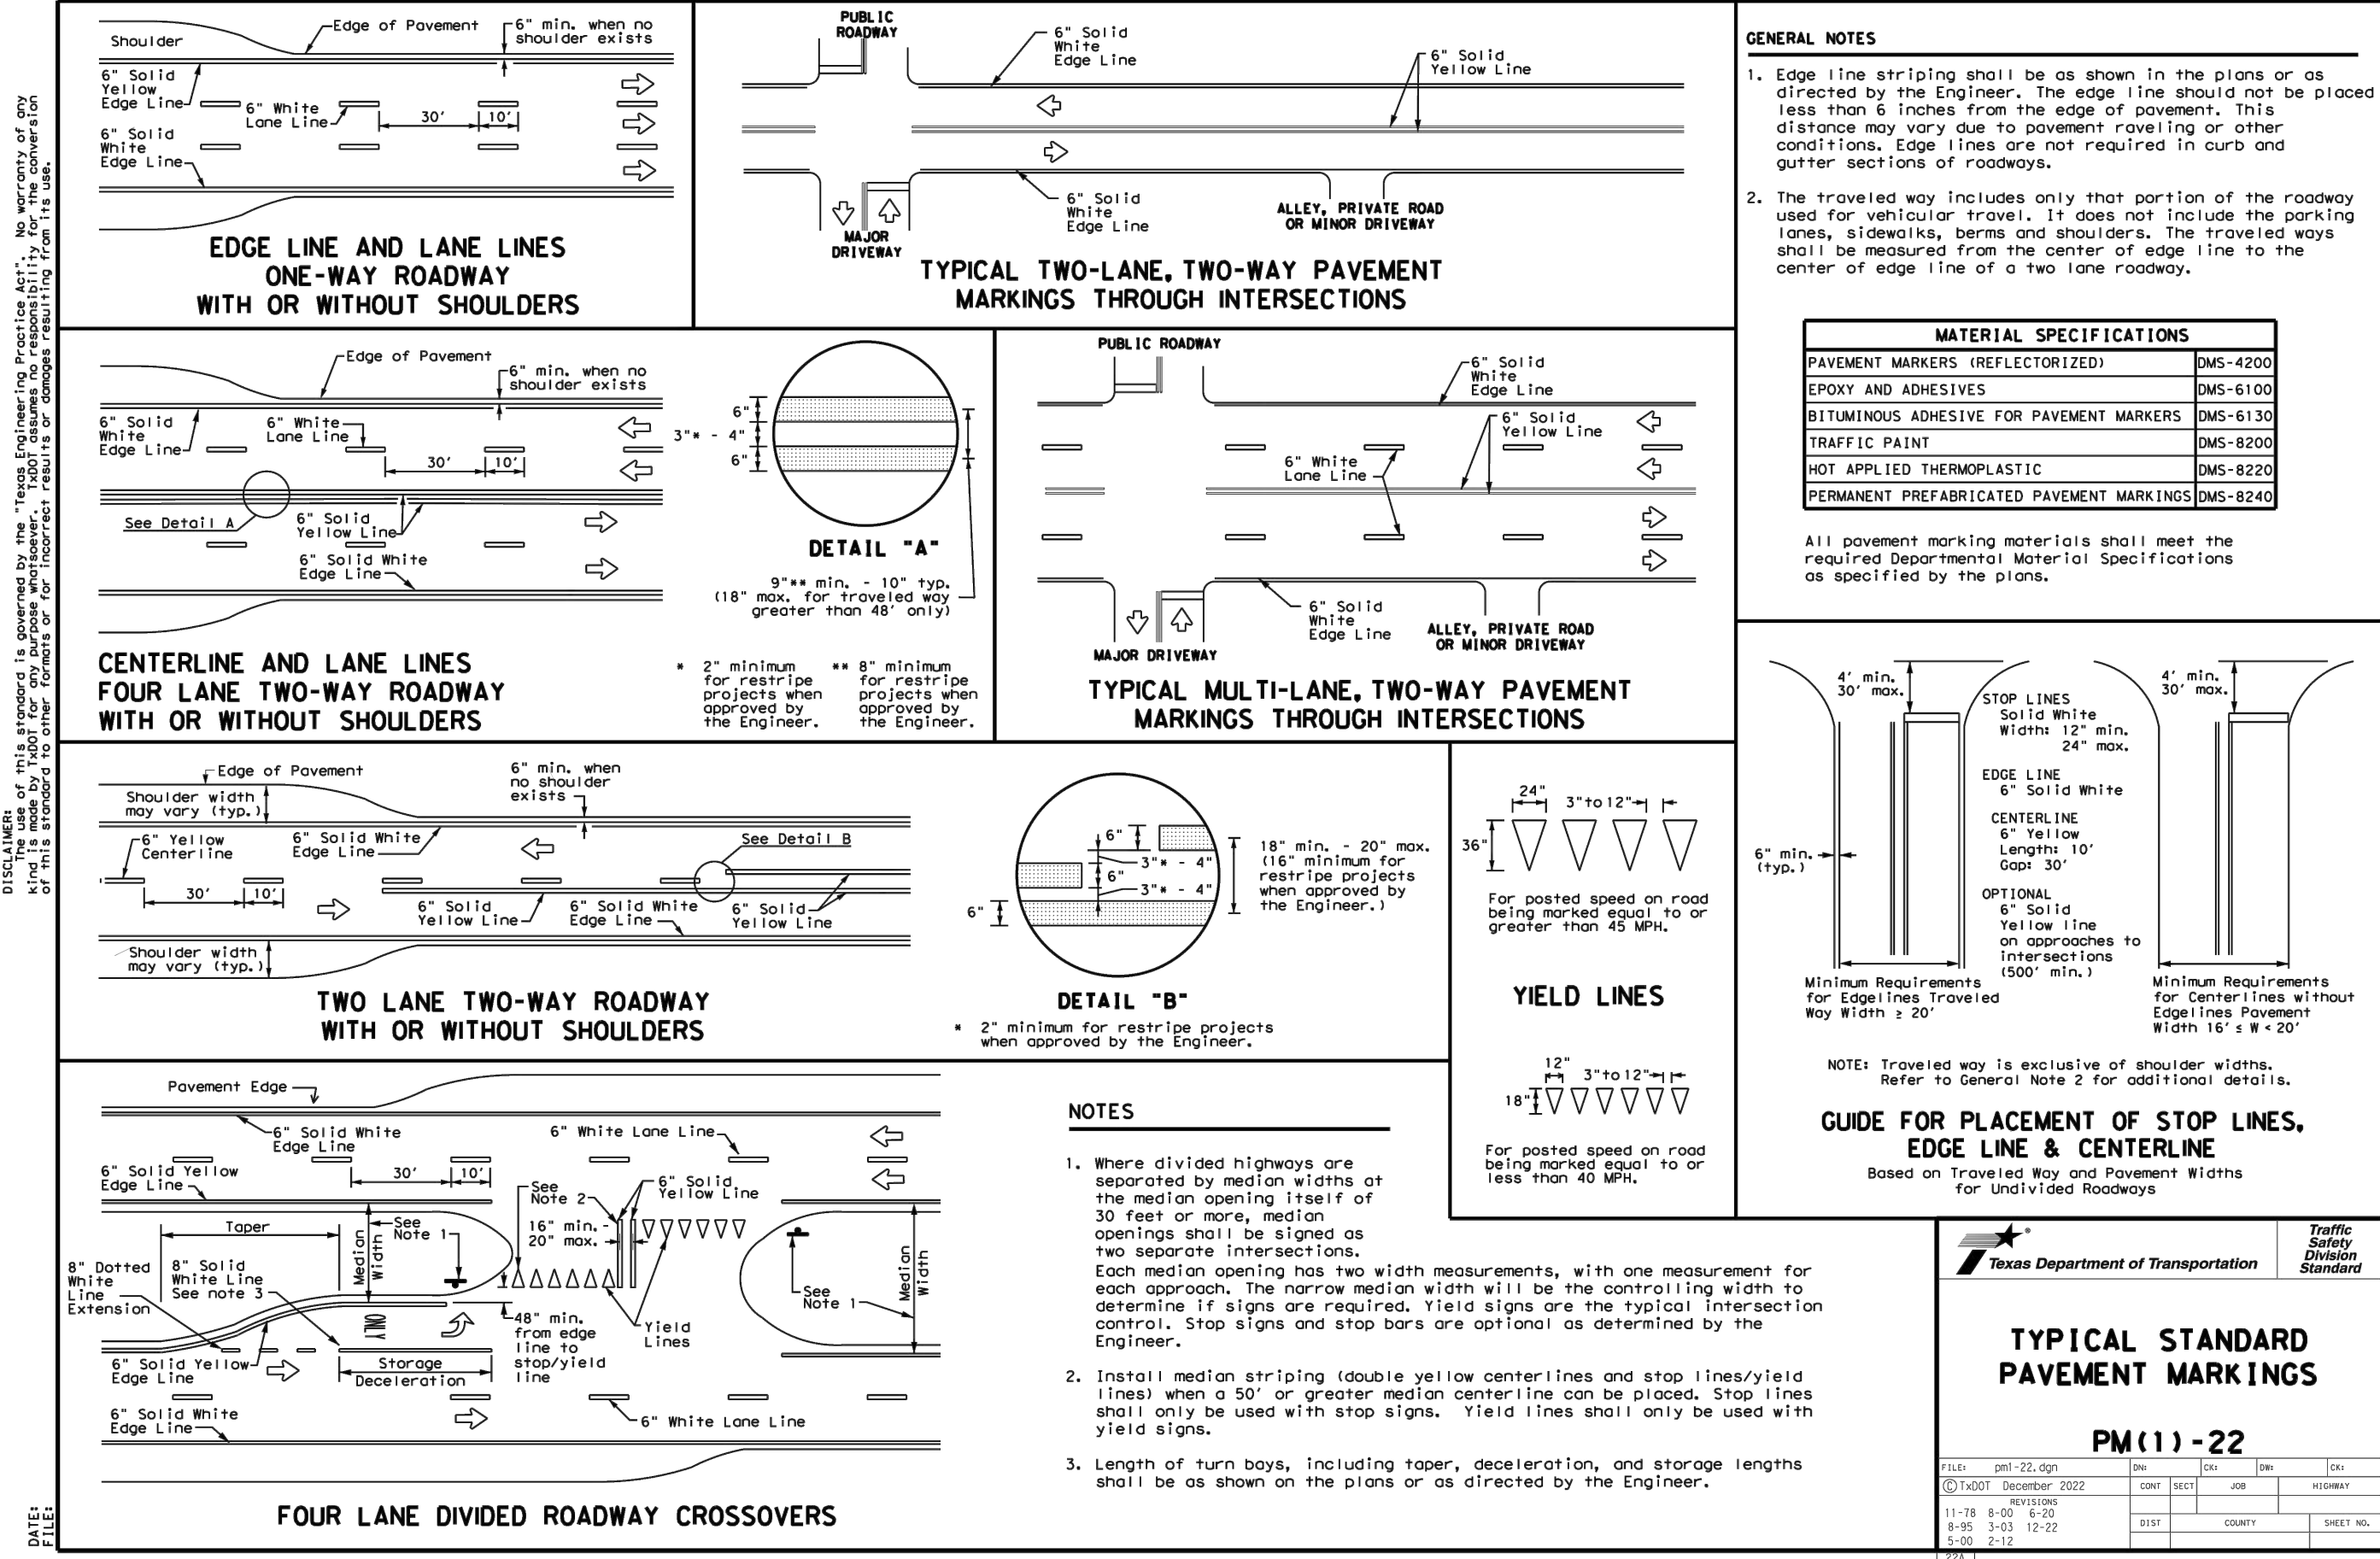DATE

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FOR SOUTHEAST MEADOWS UNIT 3 PLAT# 23-11800440

SAN ANTONIO BEXAR COUNTY TEXAS

Colliers Engineering & Design

SAN ANTONIO (KFW)

3421 Pecosas Parkway San Antonio, TX 78231 Phone: 210.979.8444 COLLIERS ENGINEERING & DESIGN, INC. TDEP Permit # 14009 TBPS Permit # 10194550

SCALE

DATE

DRAWN BY

CHECKED BY

PROJECT NUMBER

DRAWING NAME

SHEET TITLE

PAVEMENT MARKING DETAILS

SHEET NUMBER

5.14

NOTE: DO NOT SCALE DRAWINGS FOR CONSTRUCTION.

GENERAL INFORMATION

SAWS STANDARD GENERAL CONSTRUCTION NOTES
ASSOCIATED WITH 2021 SAWS STANDARD SPECS
Updated January 2022

General Section

1. All materials and construction procedures within the scope of this contract shall be approved by the San Antonio Water System (SAWS) and comply with the Plans, Specifications, General Conditions and with the following as applicable:

A. Current Texas Commission on Environmental Quality (TCEQ) "Design Criteria for Domestic Wastewater System", Texas Administrative Code (TAC) Title 30 Part 1 Chapter 217 and "Public Drinking Water", TAC Title 30 Part 1 Chapter 290.

B. Current TxDOT "Standard Specifications for Construction of Highways, Streets and Drainage".

C. Current "San Antonio Water System Standard Specifications for Water and Sanitary Sewer Construction".

D. Current City of San Antonio "Standard Specifications for Public Works Construction".

E. Current City of San Antonio "Utility Excavation Criteria Manual" (UECM).

2. The contractor shall not proceed with any pipe installation work until they obtain a copy of the approved Counter Permit or General Construction Permit (GCP) from the consultant and has been notified by SAWS Construction Inspection Division to proceed with the work and has arranged a meeting with the inspector and consultant for the work requirements. Work completed by the contractor without an approved Counter Permit and/or a GCP will be subject to removal and replacement at the expense of the contractors and/or the developer.

3. The Contractor shall obtain the SAWS Standard Details from the SAWS website, http://www.saws.org/business_center/specs. Unless otherwise noted within the design plans.

4. The Contractor is to make arrangements with the SAWS Construction Inspection Division at (210) 233-2973, on notification procedures that will be used to notify affected home residents and/or property owners 48 hours prior to beginning any work.

5. Location and depth of existing utilities and service laterals shown on the plans are understood to be approximate. Actual locations and depths must be field verified by the Contractor at least 1 week prior to construction. It shall be the Contractor's responsibility to locate utility service lines as required for construction and to protect them during construction at no cost to SAWS.

6. The Contractor shall verify the exact location of underground utilities and drainage structures at least 1-2 weeks prior to construction whether shown on plans or not. Please allow up to 7 business days for locates requesting pipe location markers on SAWS facilities. The following contact information are supplied for verification purposes:
SAWS Utility Locates: <http://www.saws.org/Service/Locates>
COSA Drainage (210) 207-0724 or (210) 207-6026
COSA Traffic Signal Operations (210) 206-6480
COSA Traffic Signal Damages (210) 207-3951
Texas State Wide One Call Locator 1-800-545-6005 or 811

7. The Contractor shall be responsible for restoring existing fences, curbs, streets, driveways, sidewalks, landscaping and structures to its original or better condition if damages are made as a result of the project's construction.

8. All work in Texas Department of Transportation (TxDOT) and/or Bexar County right-of-way shall be done in accordance with respective construction specifications and permit requirements.

9. The Contractor shall comply with City of San Antonio or other governing municipality's tree ordinances when excavating near trees.

10. The Contractor shall not place any waste materials in the 100-year Flood Plain without first obtaining an approved Flood Plain Permit.

11. Holiday Work: Contractors will not be allowed to perform SAWS work on SAWS recognized holidays. Request should be sent to constworkreq@saws.org. Weekend Work: Contractors are required to notify the SAWS Inspection Construction Department 48 hours in advance to request weekend work. Request should be sent to constworkreq@saws.org. Any and all SAWS utility work installed without holiday/weekend approval will be subject to be uncovered for proper inspection.

12. Compaction note (Item 804): The contractor shall be responsible for meeting the compaction requirements on all trench backfill and for paying for the tests performed by a third party. Compaction tests will be done at one location point randomly selected, or as indicated by the SAWS Inspector and/or the test administrator, per each 12-inch loose fill per 400 linear feet at a minimum. This project will not be accepted and finalized by SAWS without this requirement being met and verified by providing all necessary documented test results.

13. A copy of all testing reports shall be forwarded to SAWS Construction Inspection Division.

Sewer Notes

1. The Contractor is responsible for ensuring that no Sanitary Sewer Overflow (SSO) occurs as a result of their work. All contractor personnel responsible for SSO prevention and control shall be trained on proper response. Should an SSO occur, the contractor shall:

A. Identify the source of the SSO and notify SAWS Emergency Operations Center (EOC) immediately at (210) 233-2014. Provide the address of the spill and an estimated volume or flow.

B. Attempt to eliminate the source of the SSO.

C. Contain sewage from the SSO to the extent of preventing a possible contamination of waterways.

D. Clean up spill site (return contained sewage to the collection system if possible) and properly dispose of contaminated soil/materials.

E. Clean the affected sewer mains and remove any debris.

F. Meet all post-SSO requirements as per the EPA Consent Decree, including line cleaning and televising the affected sewer mains (at SAWS direction) within 24 hours. Should the Contractor fail to address an SSO immediately and to SAWS satisfaction, they will be responsible for all costs incurred by SAWS, including any fines from EPA, TCEQ and/or any other Federal, State or Local Agencies. No separate measurement or payment shall be made for this work. All work shall be done according to guidelines set by the TCEQ and SAWS.

2. If bypass pumping is required, the Contractor shall perform such work in accordance with SAWS Standard Specification for Water and Sanitary Sewer Construction, Item No. 864, "Bypass Pumping".

3. Prior to tie-ins, any shutdowns of existing force mains of any size must be coordinated with the SAWS Construction Inspection Division at (210) 233-2973 at least one week in advance of the shutdown. The Contractor must also provide a sequence of work as related to the tie-ins; this is at no additional cost to SAWS or the project and it is the responsibility of the Contractor to sequence the work accordingly.

4. Sewer pipe where water line crosses shall be 160 psi and meet the requirements of ASTM D2241, TAC 217.53 and TCEQ 290.44(e)(4)(B). Contractor shall center a 20" joint of 160 psi pressure rated PVC at the proposed water crossing.

5. ELEVATIONS POSTED FOR TOP OF MANHOLES ARE FOR REFERENCE ONLY. It shall be the responsibility of the Contractor to make allowances and adjustments for top of manholes to match the finished grade of the project's improvements. (NSPI).

6. Spills, Overflows, or Discharges of Wastewater: All spills, overflows, or discharges of wastewater, recycled water, petroleum products, or chemicals must be reported immediately to the SAWS Inspector assigned to the Counter Permit or General Construction Permit (GCP). This requirement applies to every spill, overflow, or discharge regardless of size.

7. Manhole and all pipe testing (including the TV inspection) must be performed and passed prior to Final Field Acceptance by SAWS Construction Inspection Division, as per the SAWS Specifications For Water and Sanitary Sewer Construction.

8. All PVC pipe over 14 feet of cover shall be extra strength with minimum pipe stiffness of 115 psi.

SOUTHEAST MEADOWS UNIT 3

BEXAR COUNTY, TX

SANITARY SEWER IMPROVEMENTS

LOCATION MAP

NOT-TO-SCALE

OWNER/DEVELOPER

MEH HOLDING COMPANY LTD

5210 THOUSAND OAKS, SUITE 1318

SAN ANTONIO, TX 78233

DESCRIPTION	SHEET NO.
SANITARY SEWER COVER SHEET	6.0
OVERALL SANITARY SEWER PLAN	6.1
OVERALL SANITARY SEWER PLAN	6.2
LINE "A" PLAN & PROFILE	6.3
LINE "A" PLAN & PROFILE	6.4
LINE "B" PLAN & PROFILE	6.5
LINE "C" AND LINE "D" PLAN & PROFILE	6.6

LOWER - EASTER SEWERSHED - DOS RIOS / LEON CREEK

DEVELOPER'S NAME: MEH HOLDING COMPANY, LTD	
DEVELOPER'S ADDRESS: 5210 THOUSAND OAKS, SUITE 1318	
CITY: SAN ANTONIO	STATE: TEXAS
PHONE#: (210) 493-2811	FAX#:
SAWS BLOCK MAP#: 214558, 214560, 216560	TOTAL ACREAGE: 28.07 ACRES
TOTAL LINEAR FOOTAGE OF PIPE: 3,751 LF OF 8" SDR 26	TOTAL EDU'S: 112
NUMBER OF LOTS: 112	PLAT NO.: 23-11800440
SAWS JOB#: 23-1654	

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STATE OF TEXAS

JEFFREY W. MARTIN

139094

LICENSED PROFESSIONAL ENGINEER

6/28/24

PRELIMINARY

FOR

SOUTHEAST MEADOWS UNIT 3

PLAT# 23-11800440

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SAN ANTONIO (KFW)

3421 Paesanos Parkway

San Antonio, TX 78231

Phone: 210.979.8444

COLLIERS ENGINEERING & DESIGN, INC.

TBPL'S Permit #: 10194550

SCALE: AS SHOWN	DATE: 07/20/2023	DRAWN BY: SD	CHECKED BY: SC
PROJECT NUMBER: 205-43-07	DRAWING NAME: CV052054307		

SANITARY SEWER COVER SHEET

SHEET NUMBER: 6.0

NOTE: DO NOT SCALE DRAWINGS FOR CONSTRUCTION.

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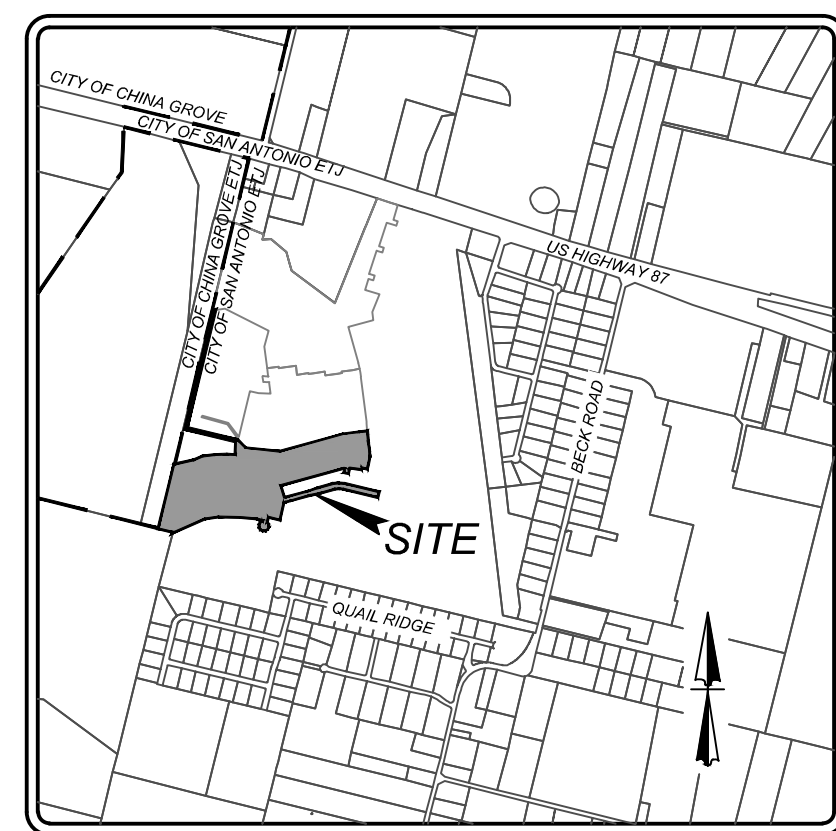
CONTRACTOR AND/OR CONTRACTOR'S INDEPENDENTLY RETAINED EMPLOYEE OR STRUCTURAL DESIGN/TECHNICAL/SAFETY/EQUIPMENT CONSULTANT, IF ANY, SHALL REVIEW THESE PLANS AND SPECIFICATIONS FOR CONFORMANCE WITH ALL APPLICABLE OSHA AND OTHER FEDERAL, STATE, AND LOCAL REGULATIONS AND STANDARDS, AND SHALL BE RESPONSIBLE FOR WITHIN THE PROJECT WORK AREA IN ORDER TO IMPLEMENT CONTRACTOR'S TRENCH EXCAVATION SAFETY PROTECTION SYSTEMS, PROGRAMS AND/OR PROCEDURES FOR THE PROJECT DESCRIBED IN THE SPECIFICATIONS. CONTRACTOR SHALL PROVIDE ADEQUATE TRENCH EXCAVATION SAFETY PROTECTION AND/OR PROCEDURES SHALL PROVIDE FOR ADEQUATE TRENCH EXCAVATION SAFETY PROTECTION THAT COMPLY WITH AS A MINIMUM, OSHA STANDARDS FOR TRENCH EXCAVATIONS. SPECIFICALLY, CONTRACTOR AND/OR CONTRACTOR'S INDEPENDENTLY RETAINED EMPLOYEE OR SAFETY CONSULTANT SHALL BE RESPONSIBLE FOR THE PRESENCE AND ACTIVITY OF INDIVIDUALS WORKING IN AND AROUND TRENCH EXCAVATION.

THE CONTRACTOR SHALL BE RESPONSIBLE FOR MEETING 98% COMPACTION ON ALL TRENCH BACKFILL AND PAYING FOR THE TESTS TO BE PERFORMED BY A THIRD PARTY. COMPACTION TESTS WILL BE DONE AT ONE LOCATION POINT RANDOMLY SELECTED OR AS INDICATED BY THE SAWS INSPECTOR/TEST ADMINISTRATOR, PER EACH 12 INCH LOOSE LIFT PER 400 LINEAR FEET AT A MINIMUM. PERMITS AND/OR WILL NOT BE ACCEPTED AND FINALIZED BY SAWS WITHOUT THIS REQUIREMENT BEING MET AND VERIFIED BY PROVIDING ALL NECESSARY DOCUMENTED TEST RESULTS.

CONDUIT LOCATIONS SHOWN ON PLAN ARE FOR GEOGRAPHICAL PURPOSES ONLY AND ARE APPROXIMATE. CONTRACTOR TO INSTALL PROPOSED CONDUITS IN ACCORDANCE WITH DRY UTILITY PURVEYOR'S SPECIFICATIONS. CONTRACTOR TO VERIFY THE CONDUIT LOCATIONS AND SIZES BASED ON THE DRY UTILITY PURVEYOR'S PLAN.


LOT 912, BLOCK 5, & LOT 901, BLOCK 12, ARE DESIGNATED AS ACCESS, OPEN SPACE, ELECTRIC, GAS, TELEPHONE, CABLE TV, WATER, SANITARY SEWER, DRAINAGE & LANDSCAPE EASEMENT. LOT 915, BLOCK 5, & LOT 917, BLOCK 5, ARE DESIGNATED AS A PRIVATE DRAINAGE, DRAIN MAINTENANCE, AND SANITARY SEWER EASEMENT.

MANHOLE NOTE:
ALL MANHOLES MUST BE WATERTIGHT, WITH
WATERTIGHT RINGS AND COVERS. THESE
MANHOLES MUST BE VENTED PER SAWS DET
DD852.02



PROPOSED WATER MAIN	=		W
PROPOSED WATER SERVICE & METER BOX	=		
PROPOSED WATER 3/4" IRRIGATION SERVICE & METER BOX	=		
PROPOSED FIRE HYDRANT	=		
PROPOSED WATER VALVE	=		
PROPOSED SANITARY SEWER MAIN	=		SS
PROPOSED SANITARY SEWER MANHOLE	=		
PROPOSED SANITARY SEWER LATERAL	=		
PROPOSED ELECTRIC, GAS, TELEPHONE, & CABLE TV EASEMENT	=		E G T V E
EXISTING WATER MAIN	=		E-W
EXISTING FIRE HYDRANT	=		
EXISTING WATER VALVE	=		
EXISTING SANITARY SEWER MAIN	=		E-SS
EXISTING SANITARY SEWER MANHOLE	=		
EXISTING OVERHEAD ELECTRIC WIPOWPOLE	=		OHE
EXISTING GUY WIRE/OVERHEAD ELECTRIC	=		OHE

1. ALL MATERIALS AND CONSTRUCTION PROCEDURES WITHIN THE SCOPE OF THIS CONTRACT SHALL BE IN ACCORDANCE WITH THE SAN ANTONIO WATER SYSTEM (S.A.W.S.) STANDARD SPECIFICATION.
2. THE S.W.E.R. WATER MAIN CROSSINGS SHALL MEET THE REQUIREMENTS OF ASTM D2241. CONTRACTOR SHALL CENTER A 20 FOOT JOINT OF 160 P.S.I. PRESSURE RATED P.V.C. AT THE PROPOSED WATER CROSSING (NO SEPARATE PAY ITEM).
3. REFERENCE SHEET ____ , SANITARY SEWER GENERAL NOTES, S.A.W.S. CRITERIA FOR THE S.W.E.R. MAIN CONSTRUCTION TO THE QUALITY OF WATER MAINS.
4. SEE THIS SHEET FOR BENCHMARK INFORMATION.
5. PIPE TYPE DESIGNATIONS ARE SDR 26.
6. SEE THIS SHEET FOR TYPICAL SANITARY SEWER / WATER CROSSING DETAIL.
7. ALL MANHOLES SHALL HAVE CONCRETE RING ENCASEMENT AND A WATER TIGHT RING AND COVER.

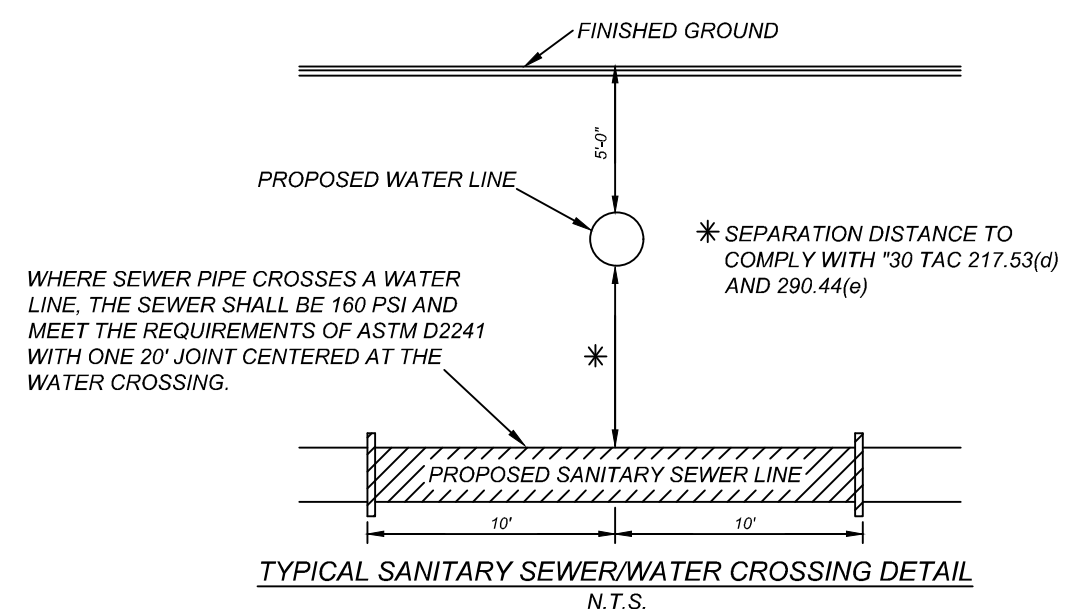

DEVELOPER'S NAME: MEH HOLDING COMPANY, LTD		
DEVELOPER'S ADDRESS: 5210 THOUSAND OAKS, SUITE 1318		
CITY: SAN ANTONIO	STATE: TEXAS	ZIP: 78233
PHONE: (210) 493-2811	FAX:	TOTAL ACREAGE: 28.07 ACRES
SAWS BLOCK MAP#: 214558, 214560, 216560		TOTAL EDUS: 112
TOTAL LINEAR FOOTAGE OF PIPE: 3,751 LF OF 8" SDR 26		PLAT NO.: 21-1800440
NUMBER OF LOTS: 112	SAWS JOB#: 23-1654	

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6/28/24

FOR
SOUTHEAST
MEADOWS UNIT 3
PLAT# 23-11800440

SAN ANTONIO
BEXAR COUNTY
TEXAS



SAN ANTONIO (KFW)
3421 Paesanos
Parkway
San Antonio, TX 78231
Phone: 210.979.8444
COLLIERS ENGINEERING & DESIGN, INC.
TBPE Firm#: F-14909
TBPLS Firm#: 10194550

SCALE: AS SHOWN	DATE: 07/20/2023	DRAWN BY: SD	CHECKED BY: SC
PROJECT NUMBER: 205-43-07		DRAWING NAME: OS2054307	

OVERALL SANITARY SEWER PLAN

SHEET NUMBER

6.1

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CONTRACTOR AND/OR CONTRACTOR'S INDEPENDENTLY RETAINED EMPLOYEE OR STRUCTURAL DESIGN/TECHNICAL/SAFETY/EQUIPMENT CONSULTANT, IF ANY, SHALL REVIEW THESE PLANS AND SPECIFICATIONS FOR CONFORMANCE WITH ALL APPLICABLE OSHA AND OTHER FEDERAL, STATE AND LOCAL REGULATIONS AND STANDARDS, AND SHALL BE RESPONSIBLE FOR WITHIN THE PROJECT WORK AREA IN ORDER TO IMPLEMENT CONTRACTOR'S TRENCH EXCAVATION SAFETY PROTECTION SYSTEMS, PROGRAMS AND/OR PROCEDURES FOR THE PROJECT DESCRIBED IN THE SPECIFICATIONS. CONTRACTOR SHALL BE RESPONSIBLE FOR THE PROVISION OF ALL PERSONNEL AND/OR PROCEDURES SHALL PROVIDE FOR ADEQUATE TRENCH EXCAVATION SAFETY PROTECTION THAT COMPLY WITH AS A MINIMUM, OSHA STANDARDS FOR TRENCH EXCAVATIONS. SPECIFICALLY, CONTRACTOR AND/OR CONTRACTOR'S INDEPENDENTLY RETAINED EMPLOYEE OR SAFETY CONSULTANT SHALL BE RESPONSIBLE FOR THE PROVISION OF ALL PERSONNEL AND/OR PROCEDURES GOVERNING THE PRESENCE AND ACTIVITIES OF INDIVIDUALS WORKING IN AND AROUND TRENCH EXCAVATION.

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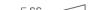
CONDUIT LOCATIONS SHOWN ON PLAN ARE FOR GEOGRAPHICAL PURPOSES ONLY AND ARE APPROXIMATE. CONTRACTOR TO INSTALL PROPOSED CONDUITS IN ACCORDANCE WITH DRY UTILITY PURVEYOR'S SPECIFICATIONS. CONTRACTOR TO VERIFY THE CONDUIT LOCATIONS AND SIZES BASED ON THE DRY UTILITY PURVEYOR'S PLAN.

CAUTION!: THE CONTRACTOR SHALL BE REQUIRED TO LOCATE ALL PUBLIC OR PRIVATE UTILITIES INCLUDING BUT NOT LIMITED TO: WATER, SEWER, TELEPHONE AND FIBER OPTIC LINES, SITE LIGHTING, ELECTRIC, SECONDARY ELECTRIC, PRIMARY ELECTRICAL, DUCTBANKS, LANDSCAPE IRRIGATION FACILITIES AND GAS LINES. ANY UTILITY CONFLICTS THAT ARISE SHOULD BE COMMUNICATED TO THE ENGINEER IMMEDIATELY AND PRIOR TO CONSTRUCTION. THE CONTRACTOR SHALL CONTACT 1-800-GID-TESS A MINIMUM OF 48 HOURS PRIOR TO THE START OF CONSTRUCTION. ANY DAMAGE TO EXISTING UTILITIES SHALL BE THE SOLE RESPONSIBILITY OF THE CONTRACTOR AND THE REPAIR SHALL BE AT CONTRACTOR'S SOLE EXPENSE WHETHER THE UTILITY IS SHOWN ON THESE PLANS OR NOT.


LOT 912, BLOCK 5, & LOT 901, BLOCK 12, ARE DESIGNATED AS ACCESS, OPEN SPACE, ELECTRIC, GAS, TELEPHONE, CABLE TV, WATER, SANITARY SEWER, DRAINAGE & LANDSCAPE EASEMENT. LOT 915, BLOCK 5, & LOT 917, BLOCK 5, ARE DESIGNATED AS A PRIVATE DRAINAGE, DRAIN MAINTENANCE, AND SANITARY SEWER EASEMENT.

MANHOLE NOTE:
ALL MANHOLES MUST BE WATERTIGHT, WITH
WATERTIGHT RINGS AND COVERS. THESE
MANHOLES MUST BE VENTED PER SAWS DETAIL
DD852-02.

DD-804-01 SANITARY SEWER PIPE LAID IN TRENCH
DD-804-02 TRENCH COMPACTION DETAIL
DD-848-01 GO, NO DESTRUCTION TESTING MANDREL
DD-852-01 STANDARD PRECAST MANHOLE
DD-852-02 VENTED MANHOLE RING AND COVER DETAIL (WHEN SPECIFIED)
DD-852-03 MANHOLE RING ENCASEMENT DETAIL
DD-854-ER2D HOUSE LATERAL DETAIL (IN THE E.A.R.Z.)
DD-858-01 TYPICAL CONCRETE ENCASEMENT DETAILS
DD-858-02 TYPICAL CONCRETE DETAILS
DD-860-01 TYPICAL VERTICAL STACK DETAILS
DD-852-06 PRECAST MANHOLE BASE 45° ANGLE
DD-852-08 DROP MANHOLE DETAIL
DD-852-09 MANHOLE RING AND COVER DETAIL

PROPOSED WATER MAIN	=	
PROPOSED WATER SERVICE & METER BOX	=	
PROPOSED WATER 3/4" IRRIGATION SERVICE & METER BOX	=	
PROPOSED FIRE HYDRANT	=	
PROPOSED WATER VALVE	=	
PROPOSED SANITARY SEWER MAIN	=	
PROPOSED SANITARY SEWER MANHOLE	=	
PROPOSED SANITARY SEWER LATERAL	=	
PROPOSED ELECTRIC, GAS, TELEPHONE, & CABLE TV EASEMENT	=	E. G. T. V. E
EXISTING WATER MAIN	=	
EXISTING FIRE HYDRANT	=	
EXISTING WATER VALVE	=	
EXISTING SANITARY SEWER MAIN	=	
EXISTING SANITARY SEWER MANHOLE	=	
EXISTING OVERHEAD ELECTRIC WIREFOLE	=	
EXISTING GUY WIRE/OVERHEAD ELECTRIC	=	

1. ALL MATERIALS AS CONSTRUCTION PROCEDURES WITHIN THE SCOPE OF THIS CONTRACT SHALL BE IN ACCORDANCE WITH THE SANITARY SEWER SYSTEM (S.A.S.W.S) STANDARD SPECIFICATION.
2. SEWER PIPE WHERE WATER LINE CROSSES SHALL MEET THE REQUIREMENTS OF THE SANITARY SEWER SYSTEM (S.A.S.W.S) DOT JOINT 180 P.S. (PRESSURE RATED P.V.C. AT THE PROPOSED WATER CROSSING (NO SEPARATE PAY ITEM), REFERENCE SHEET _____. SANITARY SEWER GENERAL NOTES, S.A.S.W.S. CRITERIA FOR SEWER MAIN CONSTRUCTION IN THE VICINITY OF WATER MAINS.
3. SEE THIS SHEET FOR BUREAU OF REVENUE INFORMATION.
4. PIPE TYPE DESIGNATIONS ARE SDR 26.
5. SEE THIS SHEET FOR TYPICAL SANITARY SEWER / WATER CROSSING DETAIL.
6. SEE THIS SHEET FOR BUREAU OF REVENUE INFORMATION.
7. THIS SHEET SHALL HAVE CONCRETE RING ENCASEMENT AND A WATER TIGHT RING AND COVER.

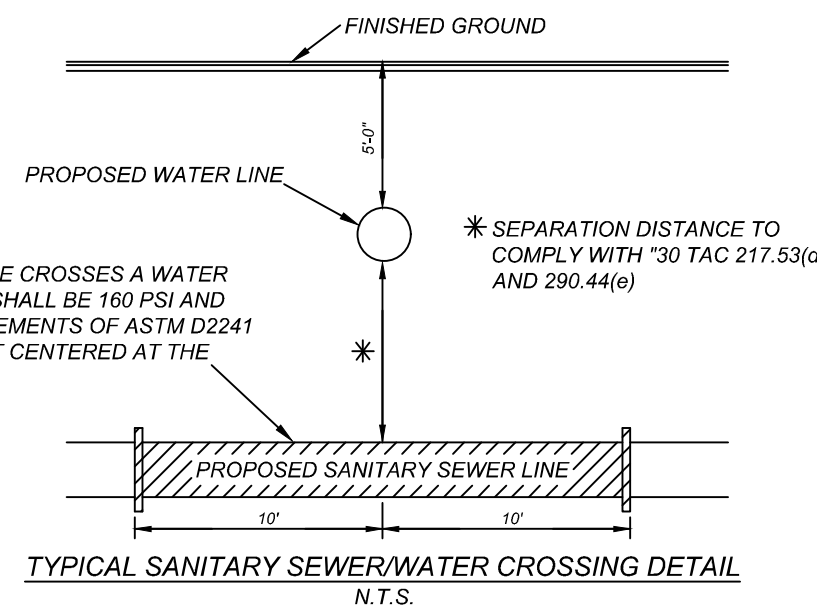

DEVELOPER'S NAME: MEH HOLDING COMPANY, LTD		
DEVELOPER'S ADDRESS: 5210 THOUSAND OAKS, SUITE 1318		
CITY: SAN ANTONIO	STATE: TEXAS	ZIP: 78233
PHONE#: (210) 493-2811	FAX#:	TOTAL ACREAGE: 28.07 ACRES
SAWS BLOCK MAP#: 214558, 214560, 216560		TOTAL EDU'S: 112
TOTAL LINEAR FOOTAGE OF PIPE: 3,751 LF OF 8" SDR 26		PLAT NO.: 23-1800440
NUMBER OF LOTS: 112	SAWS JOB#: 23-1654	

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6/28/24

FOR
SOUTHEAST
MEADOWS UNIT 3
PLAT# 23-11800440

SAN ANTONIO
BEXAR COUNTY
TEXAS

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SCALE: AS SHOWN	DATE: 07/20/2023	DRAWN BY: SD	CHECKED BY: SC
PROJECT NUMBER: 205-43-07		DRAWING NAME: 052054307	

OVERALL SANITARY
SEWER PLAN

SHEET NUMBER:

6.2


NOTE: DO NOT SCALE DRAWINGS FOR CONSTRUCTION

TRENCH EXCAVATION SAFETY PROTECTION
CONTRACTOR AND/OR CONTRACTOR'S INDEPENDENTLY RETAINED EMPLOYEE OR STRUCTURAL DESIGN/GEOTECHNICAL/SAFETY EQUIPMENT CONSULTANT, IF ANY, SHALL REVIEW THESE PLANS AND ANY AVAILABLE GEOTECHNICAL INFORMATION AND THE ANTICIPATED INSTALLATION SITES WITHIN THE PROJECT WORK AREA IN ORDER TO IMPLEMENT CONTRACTOR'S TRENCH EXCAVATION SAFETY PROTECTION SYSTEMS, PROGRAMS AND/OR PROCEDURES FOR THE PROJECT DESCRIBED IN THE CONTRACT DOCUMENTS. THE CONTRACTOR'S IMPLEMENTATION OF THESE SYSTEMS, PROGRAMS AND/OR PROCEDURES SHALL PROVIDE FOR ADEQUATE TRENCH EXCAVATION SAFETY PROTECTION THAT COMPLY WITH AS A MINIMUM, OSHA STANDARDS FOR TRENCH EXCAVATIONS. SPECIFICALLY, CONTRACTOR AND/OR CONTRACTOR'S INDEPENDENTLY RETAINED EMPLOYEE OR SAFETY CONSULTANT SHALL IMPLEMENT A TRENCH SAFETY PROGRAM IN ACCORDANCE WITH OSHA STANDARDS GOVERNING THE PRESENCE AND ACTIVITIES OF INDIVIDUALS WORKING IN AND AROUND TRENCH EXCAVATION.

NOTE:
1. SEWER PIPE WHERE WATER LINE CROSSES SHALL BE MEET THE REQUIREMENTS OF ASTM D2241.
CONTRACTOR SHALL CENTER A 20 FOOT JOINT OF 160 P.S.I. PRESSURE RATED P.V.C. AT THE PROPOSED WATER CROSSING (NO SEPARATE PAY ITEM).
2. SEE THIS SHEET FOR BENCHMARK INFORMATION.
3. PIPE TYPE DESIGNATIONS ARE SDR 26.
4. SEE THIS SHEET FOR TYPICAL SANITARY SEWER / WATER CROSSING DETAIL.
5. ALL MANHOLES SHALL HAVE CONCRETE RING ENCASEMENT AND A WATER TIGHT RING AND COVER.
6. ALL MATERIALS AND CONSTRUCTION PROCEDURES WITHIN THE SCOPE OF THIS CONTRACT SHALL BE IN ACCORDANCE WITH THE SAN ANTONIO WATER SYSTEM (SAWS) STANDARD SPECIFICATIONS.



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MANHOLE NOTE:
ALL MANHOLES MUST BE WATERTIGHT, WITH WATERTIGHT RINGS AND COVERS. THESE MANHOLES MUST BE VENTED PER SAWS DETAIL DD852-02.

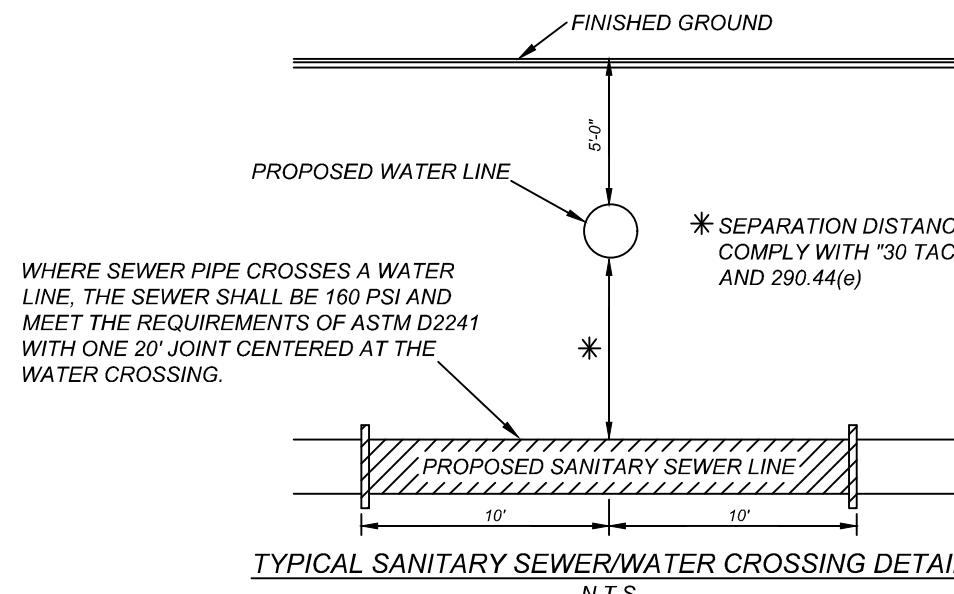


LOWER - EASTER SEWERSHED - DOS RIOS / LEON CREEK

DEVELOPER'S NAME: MEH HOLDING COMPANY, LTD
DEVELOPER'S ADDRESS: 5210 THOUSAND OAKS, SUITE 1318
CITY: SAN ANTONIO STATE: TEXAS ZIP: 78233
PHONE#: (210) 493-2811 FAX#: TOTAL ACREAGE: 28.07 ACRES
SAWS BLOCK MAP#: 214558, 214560, 218560 TOTAL EDU'S: 112
TOTAL LINEAR FOOTAGE OF PIPE: 3,751 LF OF 8" SDR 26 PLAT NO.: 23-11800440
NUMBER OF LOTS: 112 SAWS JOB#: 23-1654

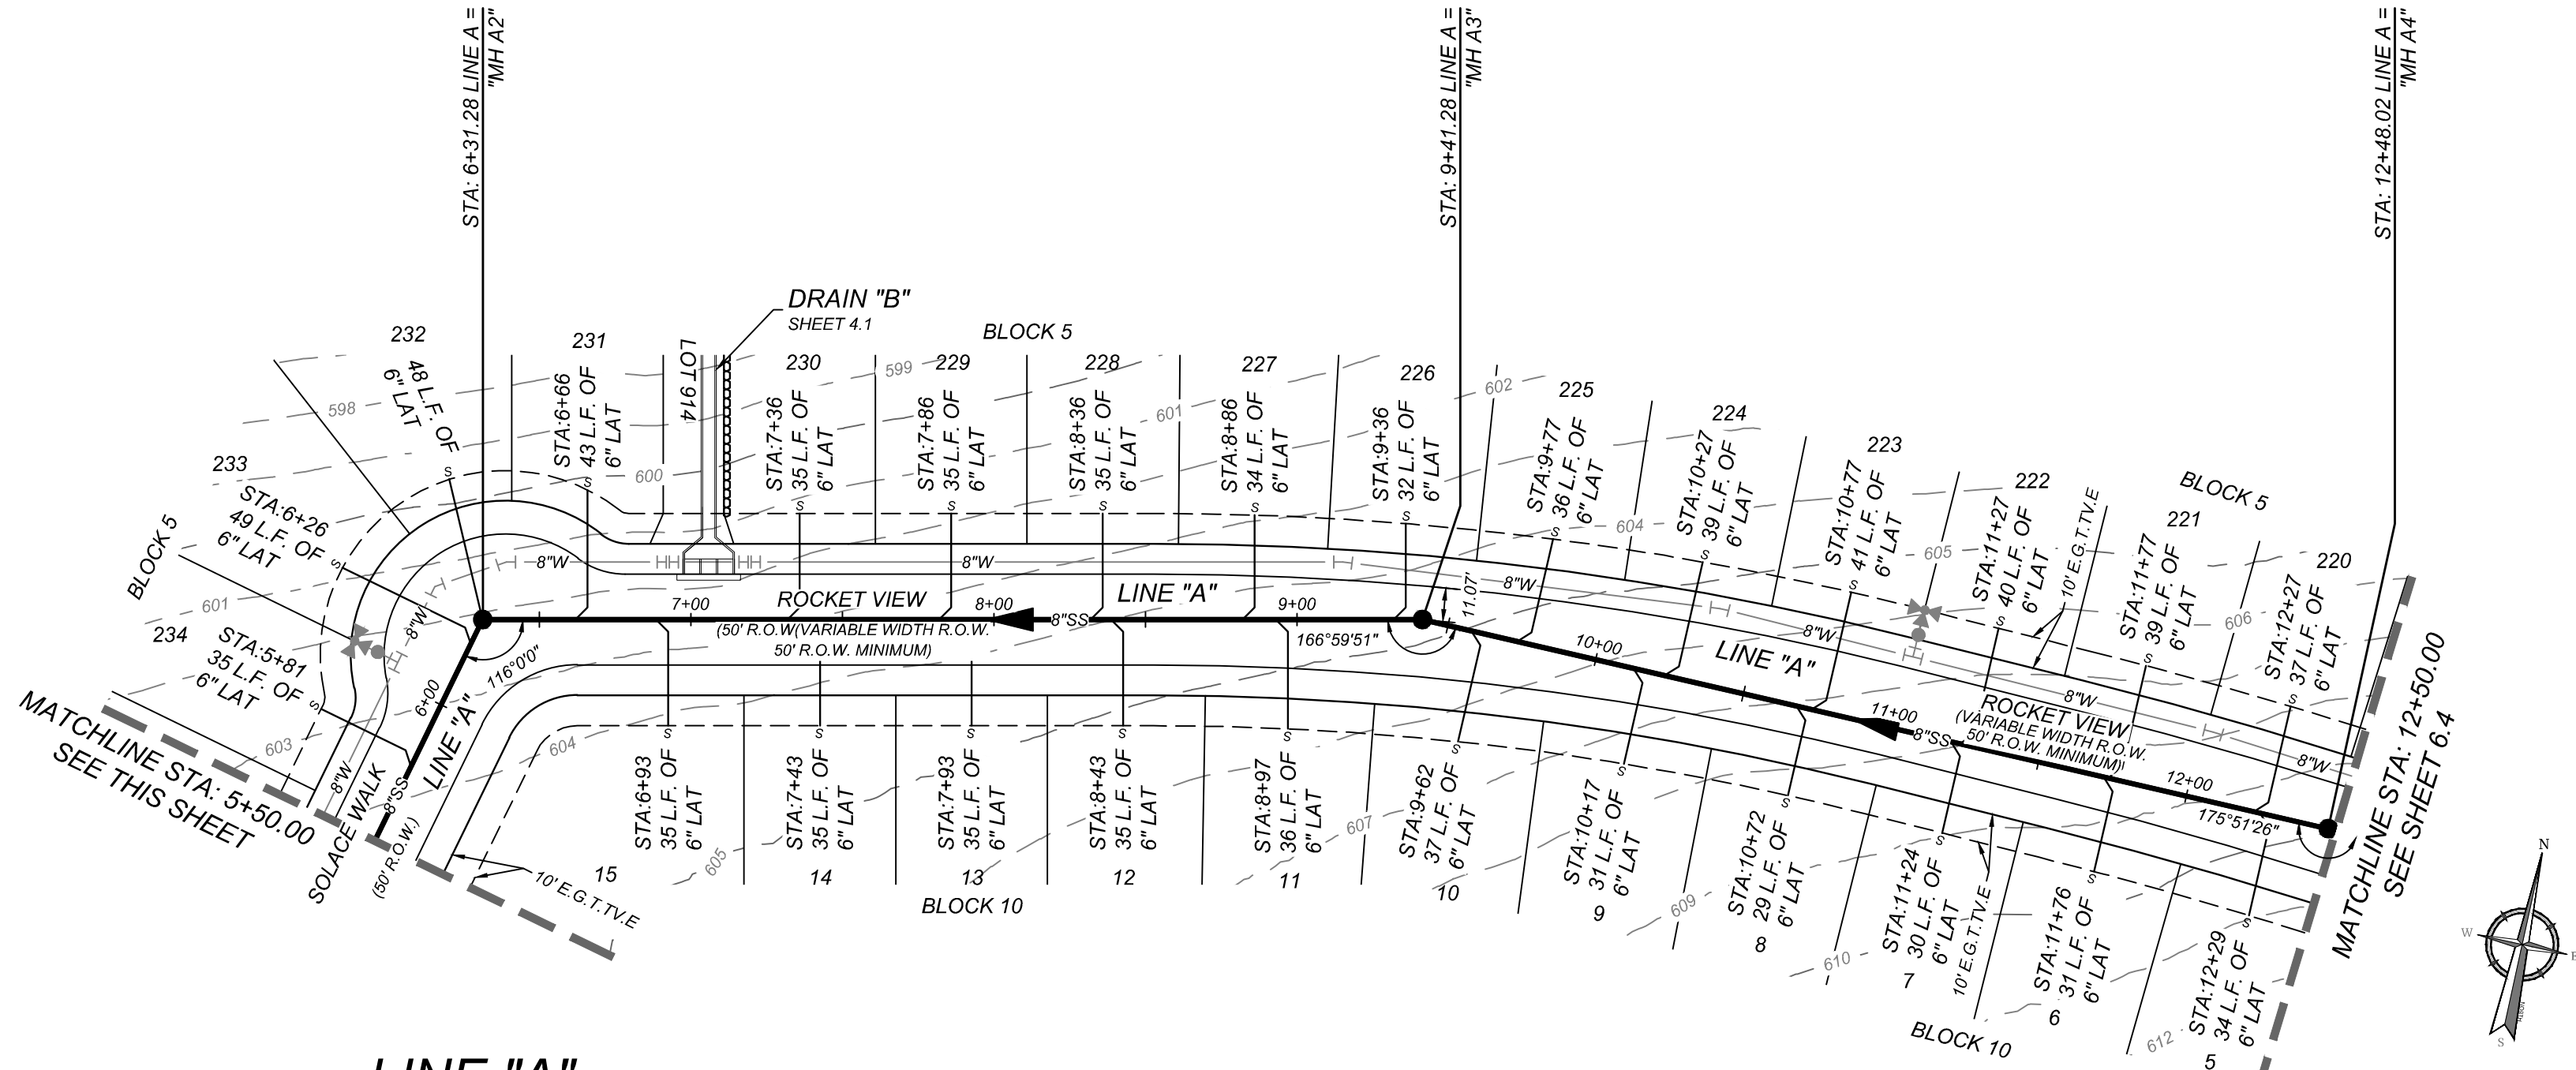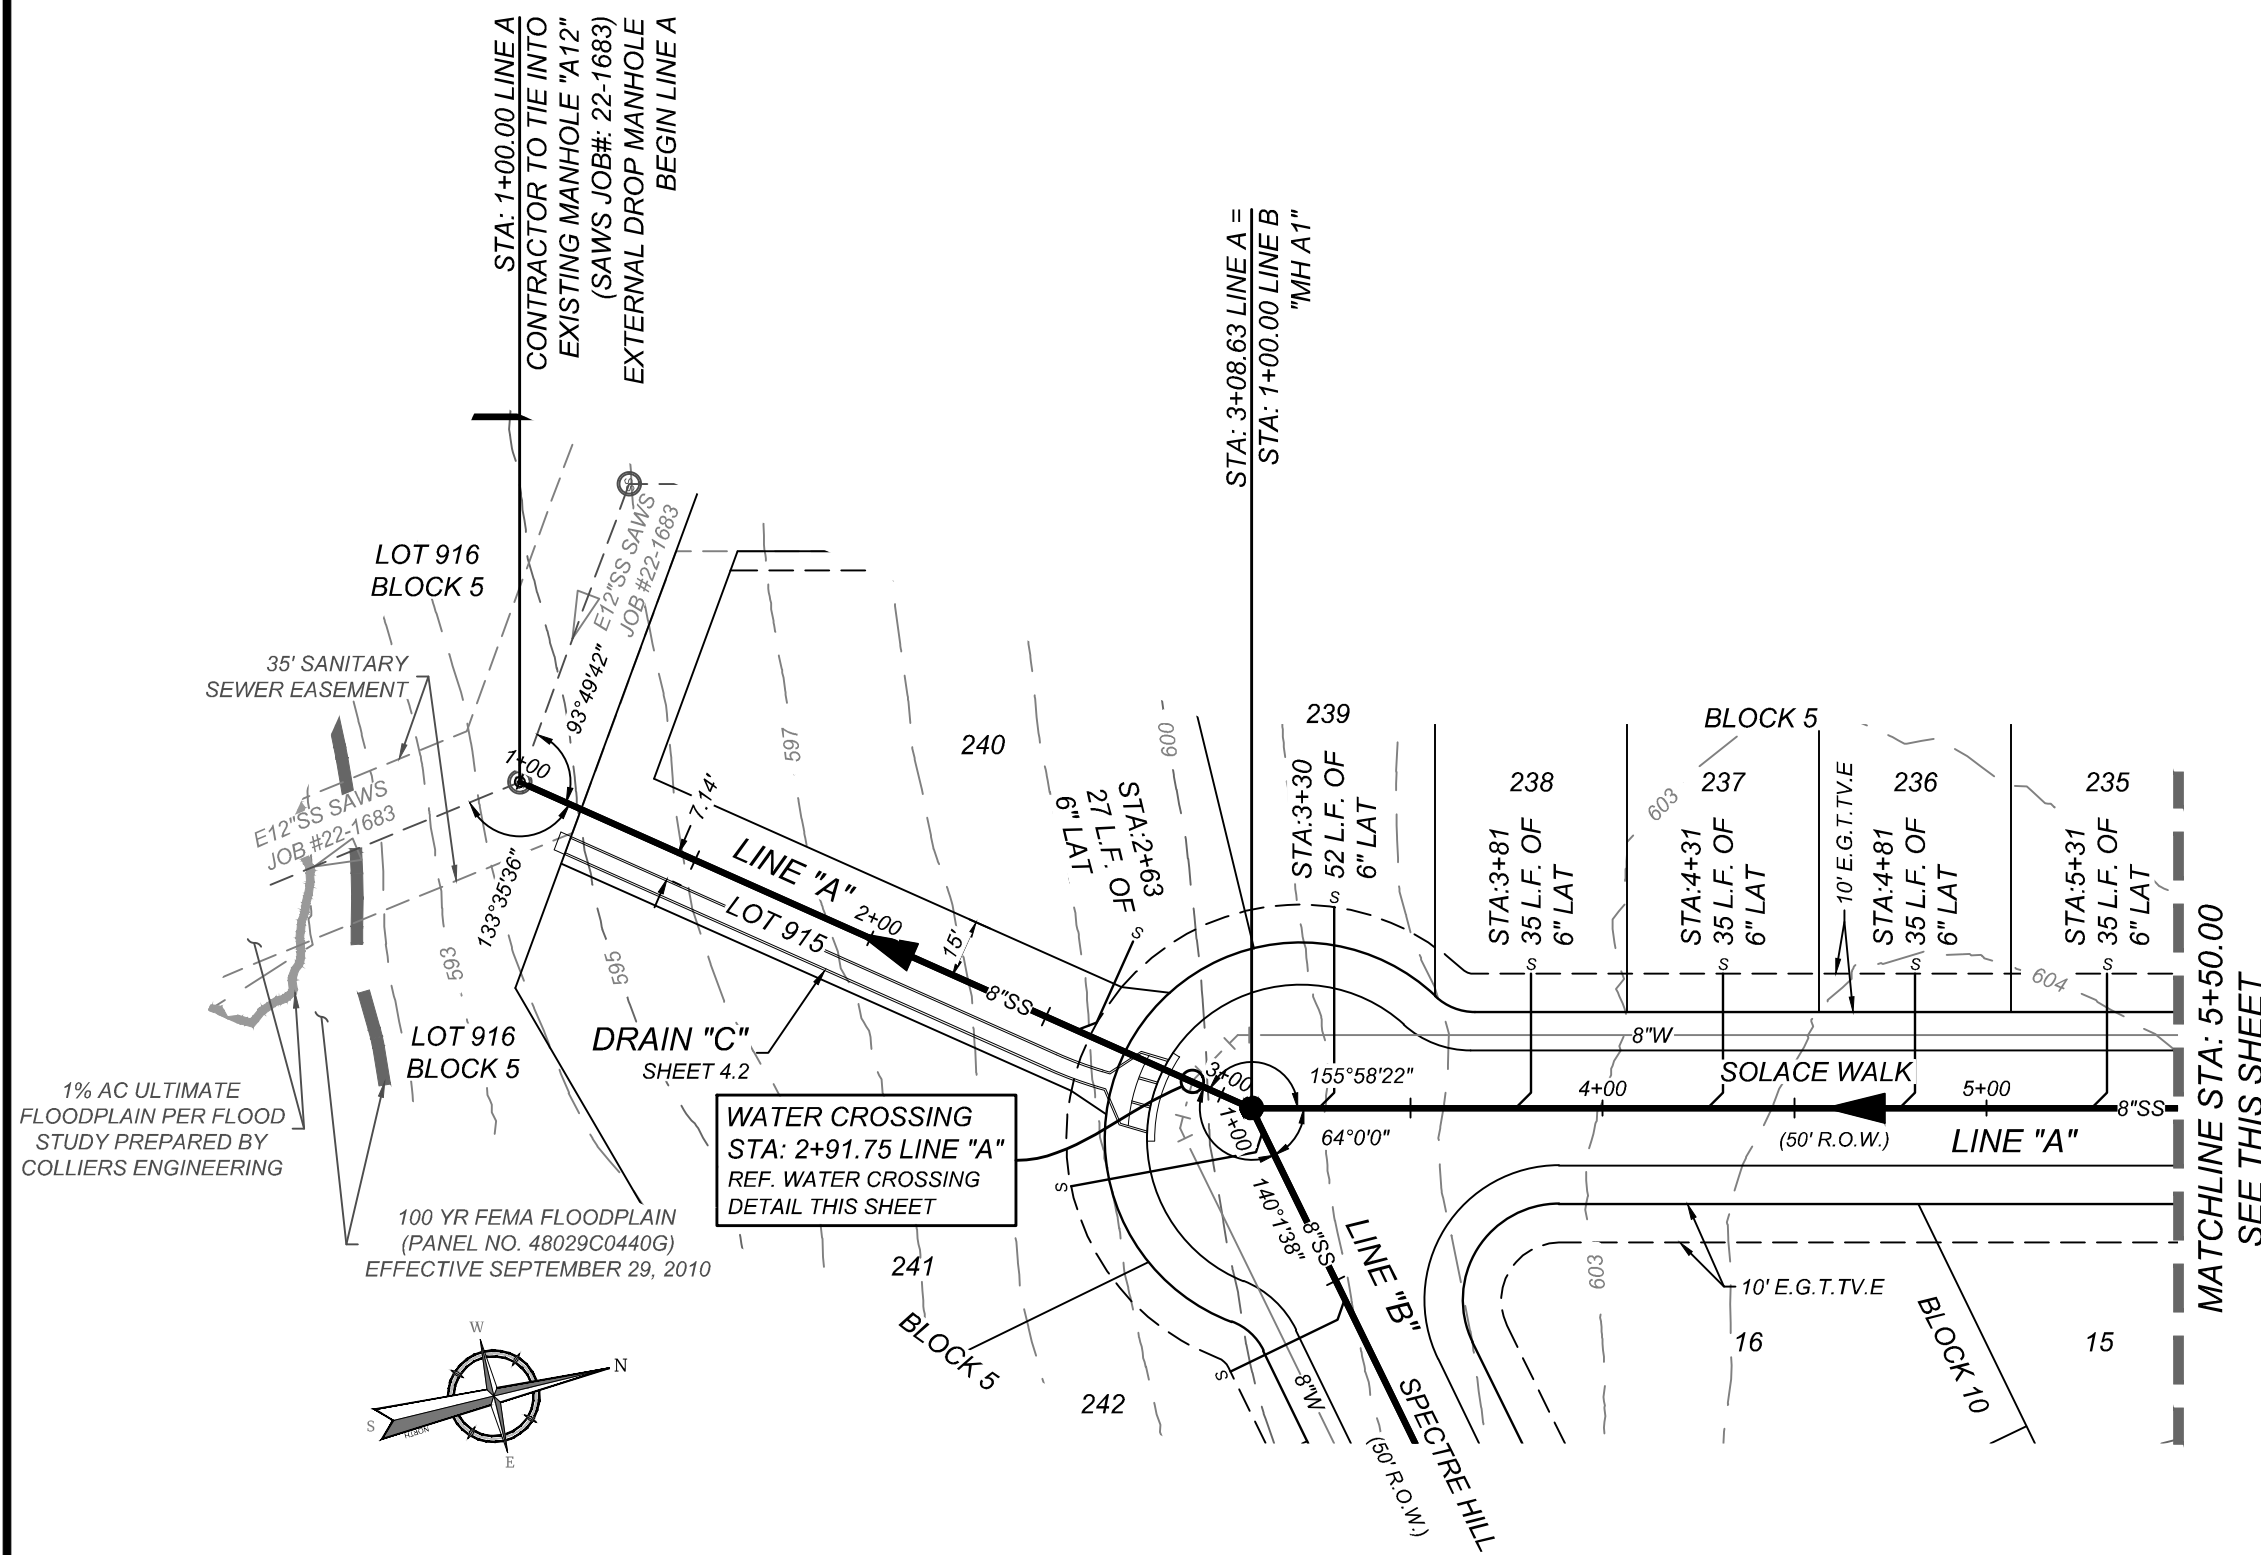

LINE "A"
STA: 1+00.00 - 12+50.00

HORZ SCALE: 1"=50'
VERT SCALE: 1"=5'

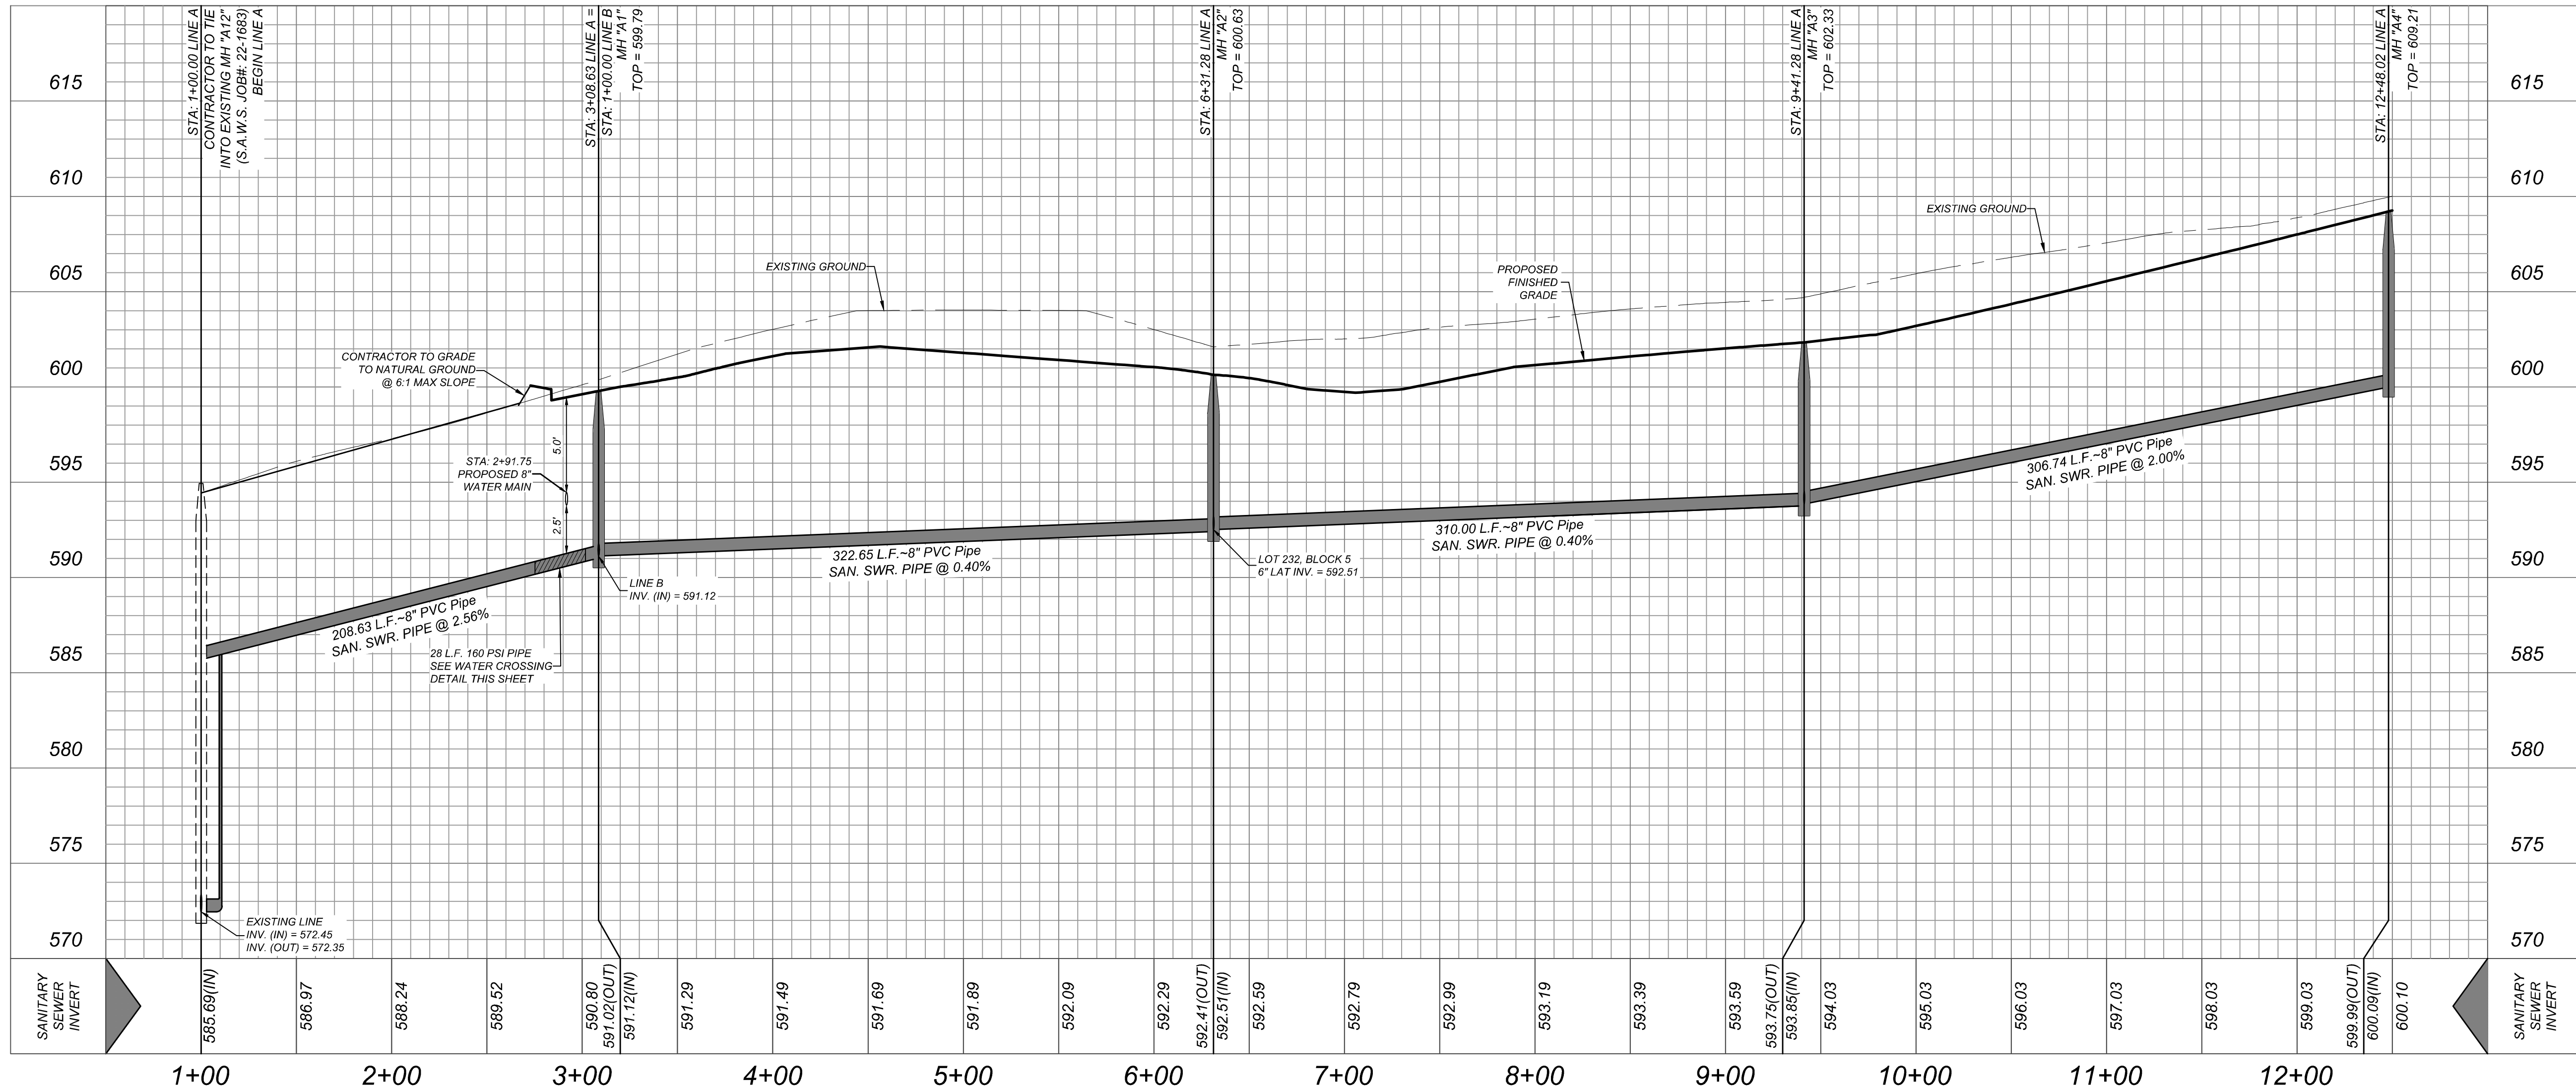

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STATE OF TEXAS

JEFFREY W. MARTIN

139094

LICENSED PROFESSIONAL ENGINEER

6/28/24

PRELIMINARY

FOR

SOUTHEAST

MEADOWS UNIT 3

PLAT# 23-11800440

SAN ANTONIO BEXAR COUNTY TEXAS

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Phone: 210.979.8444
COLLIERS ENGINEERING & DESIGN, INC.
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TBD'S Form# 10194550

SCALE: AS SHOWN	DATE: 07/20/2023	DRAWN BY: SD	CHECKED BY: SC
PROJECT NUMBER: 205-43-07	DRAWING NAME: SSP2054307		

SHEET TITLE: LINE "A" PLAN & PROFILE


SHEET NUMBER: 6.3

CONTRACTOR AND/OR CONTRACTORS INDEPENDENTLY RETAINED EMPLOYEE OR STRUCTURAL DESIGN/ENGINEER/SAFETY/EQUIPMENT CONSULTANT, IF ANY, SHALL REVIEW THESE PLANS AND ANY AVAILABLE RECORD DRAWINGS AND FIELD SURVEY DATA TO DETERMINE THE LOCATION OF ALL EXISTING UTILITY LINES AND STRUCTURES AND TO IDENTIFY ANY OTHER POTENTIAL OBSTACLES TO THE PROJECT WORK AREA IN ORDER TO IMPLEMENT CONTRACTOR'S TRENCH EXCAVATION SAFETY PROTECTION SYSTEMS, PROGRAMS AND/OR PROCEDURES FOR THE PROJECT DESCRIBED IN THE CONTRACT. CONTRACTOR SHALL BE RESPONSIBLE FOR IDENTIFYING ALL EXISTING UTILITIES AND/OR OBSTACLES AND FOR PROVIDING THE LOCATION OF ALL EXISTING UTILITIES AND/OR OBSTACLES TO THE PROJECT. CONTRACTOR SHALL PROVIDE FOR ADEQUATE TRENCH EXCAVATION SAFETY PROTECTION THAT COMPLY WITH AS A MINIMUM, OSHA STANDARDS FOR TRENCH EXCAVATIONS. SPECIFICALLY, CONTRACTOR AND/OR SUBS CONTRACTORS SHALL PROVIDE FOR ADEQUATE TRENCH EXCAVATION SAFETY PROTECTION THAT COMPLY WITH ALL APPLICABLE OSHA STANDARDS AND ANY OTHER APPLICABLE STATE AND/OR LOCAL TRENCH SAFETY PROGRAMS IN ACCORDANCE WITH OSHA STANDARDS GOVERNING THE PRESENCE AND ACTIVITIES OF PERSONNEL WORKING IN AND AROUND TRENCH EXCAVATION.

1. SEWER PIPE WHERE WATER LINE CROSSES SHALL BE MEET THE REQUIREMENTS OF ASTM D2241; CONTRACTOR SHALL CENTER A 20 FOOT JOINT OF 160 P.S.I. PRESSURE RATED P.V.C. AT THE PROPOSED WATER CROSSING (NO SEPARATE PAY ITEM).
2. SEE THIS SHEET FOR BENCHMARK INFORMATION.
3. PIPE TYPE DESIGNATIONS ARE SDR 26.
4. SEE THIS SHEET FOR TYPICAL SANITARY SEWER / WATER CROSSING DETAIL.
5. ALL MANHOLES SHALL HAVE CONCRETE RING ENCASMENT AND A WATER TIGHT RING AND COVER.
6. ALL MATERIALS AND CONSTRUCTION PROCEDURES WITHIN THE SCOPE OF THIS CONTRACT SHALL BE IN ACCORDANCE WITH THE SAN ANTONIO WATER SYSTEM (SAWS) STANDARD SPECIFICATIONS.

THE CONTRACTOR SHALL BE REQUIRED TO LOCATE ALL PUBLIC OR PRIVATE UTILITIES INCLUDING BUT NOT LIMITED TO: WATER, SEWER, TELEPHONE AND FIBER OPTIC LINES, SITE LIGHTING ELECTRIC, SECONDARY ELECTRIC, PRIMARY ELECTRICAL DUCTBANKS, LANDSCAPE IRRIGATION FACILITIES, AND GAS LINES. ANY UTILITY CONFLICTS THAT ARISE SHOULD BE COMMUNICATED TO THE OWNER IMMEDIATELY AND PRIOR TO CONSTRUCTION. THE CONTRACTOR SHALL CONTACT 1-800-DIG-TESS A MINIMUM OF 48 HOURS PRIOR TO THE START OF CONSTRUCTION. ANY DAMAGE TO EXISTING UTILITIES SHALL BE THE SOLE RESPONSIBILITY OF THE CONTRACTOR AND THE REPAIR SHALL BE AT CONTRACTOR'S SOLE EXPENSE WHETHER THE UTILITY IS SHOWN ON THESE PLANS OR NOT.

ALL MANHOLES MUST BE WATERTIGHT, WITH WATERTIGHT RINGS AND COVERS. THESE MANHOLES MUST BE VENTED PER SAWS DETAIL DD852-02.

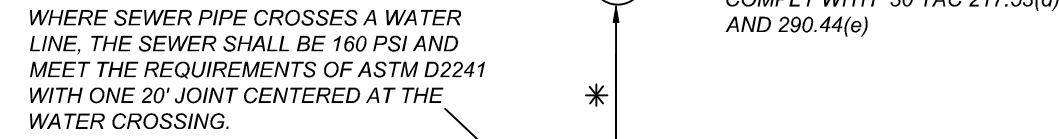


DEVELOPER'S NAME: MEH HOLDING COMPANY, LTD		
DEVELOPER'S ADDRESS: 5210 THOUSAND OAKS, SUITE 1318		
CITY: SAN ANTONIO	STATE: TEXAS	ZIP: 78233
PHONE#: (210) 493-2811	FAX#:	TOTAL ACREAGE: 28.07 ACRES
SAWS BLOCK MAP#: 214558, 214560, 216560		TOTAL EDUS: 112
TOTAL LINEAR FOOTAGE OF PIPE: 3,751 LF OF 8" SDR 26		PLAT NO.: 23-11800440
NUMBER OF LOTS: 112	SAWS JOB#: 23-1654	

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HORZ SCALE: 1"=50'
VERT SCALE: 1"=5'




By ABIEL MONTALVO

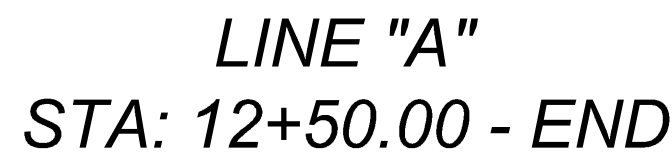TRENCH EXCAVATION SAFETY PROTECTION
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- NOTE:**
- SEWER PIPE WHERE WATER LINE CROSSES SHALL MEET THE REQUIREMENTS OF ASTM D2241. CONTRACTOR SHALL CENTER A 20 FOOT JOINT OF 160 P.S.I. PRESSURE RATED P.V.C. AT THE PROPOSED WATER CROSSING (NO SEPARATE PAY ITEM).
 - SEE THIS SHEET FOR BENCHMARK INFORMATION.
 - PIPE TYPE DESIGNATIONS ARE SDR 26.
 - SEE THIS SHEET FOR TYPICAL SANITARY SEWER / WATER CROSSING DETAIL.
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 - ALL MATERIALS AND CONSTRUCTION PROCEDURES WITHIN THE SCOPE OF THIS CONTRACT SHALL BE IN ACCORDANCE WITH THE SAN ANTONIO WATER SYSTEM (SAWS) STANDARD SPECIFICATIONS.


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MANHOLE NOTE:
ALL MANHOLES MUST BE WATERTIGHT, WITH WATERTIGHT RINGS AND COVERS. THESE MANHOLES MUST BE VENTED PER SAWS DETAIL D852-02.




LINE "B"
STA: 1+00.00 - END

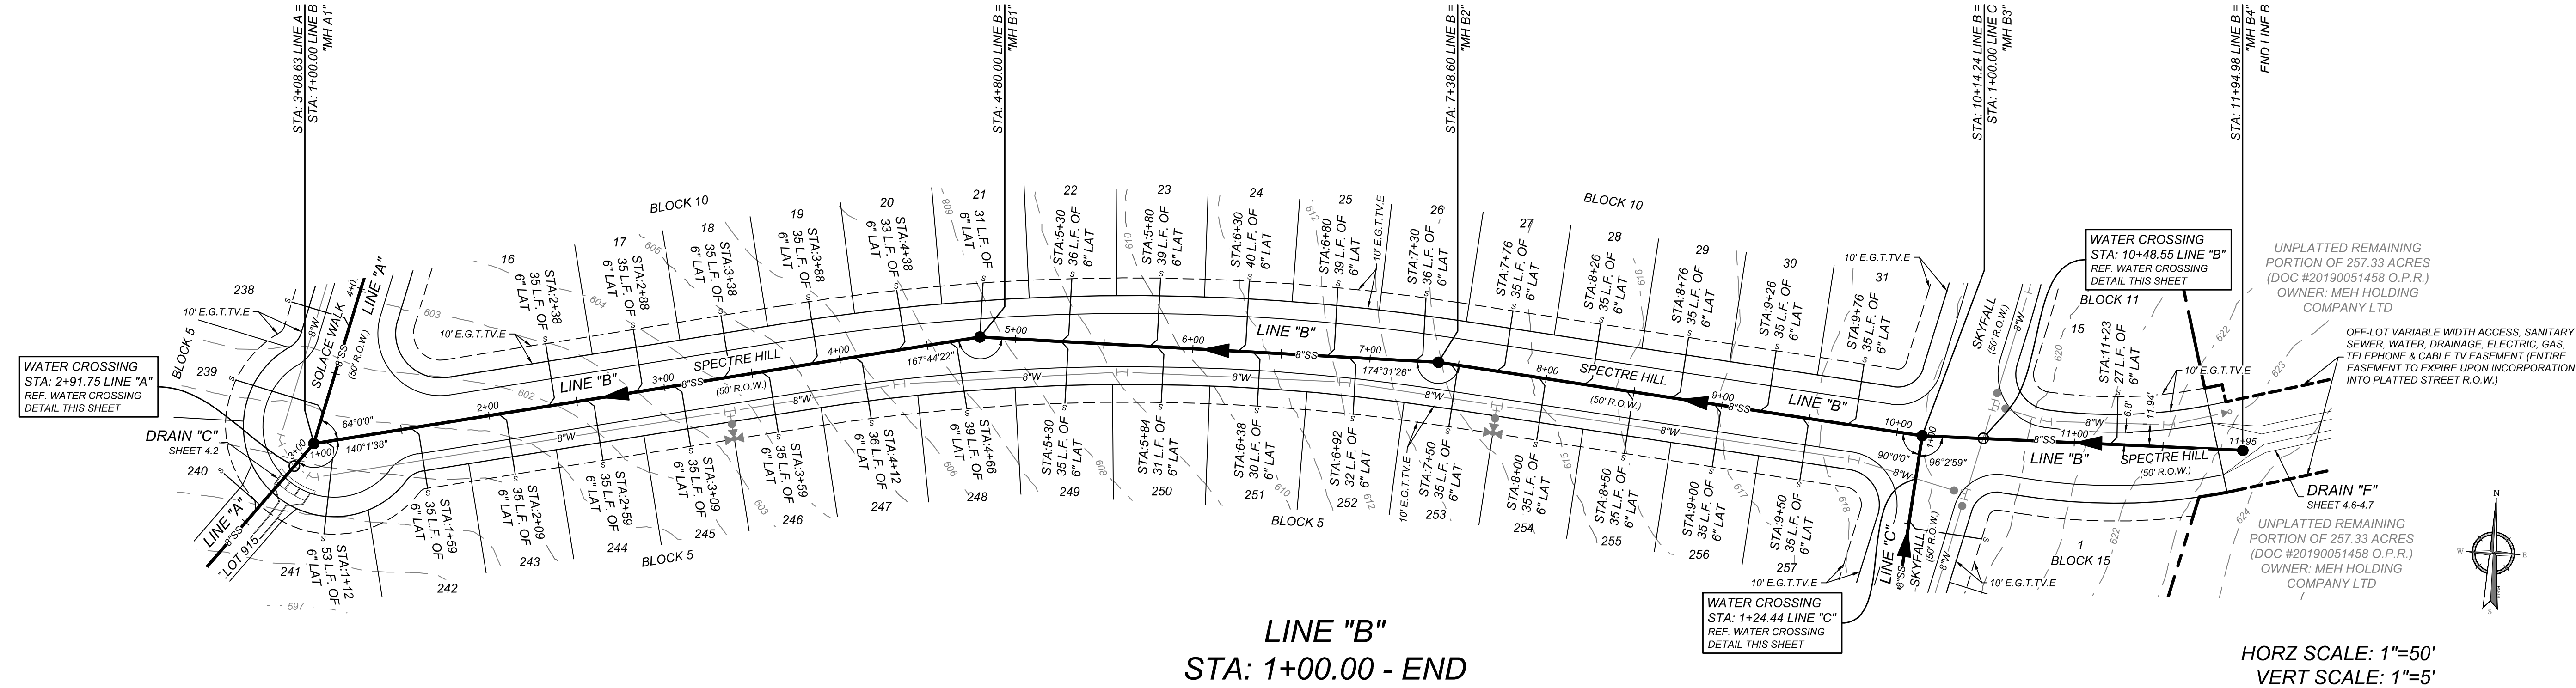HORZ SCALE: 1"=50'
VERT SCALE: 1"=5'

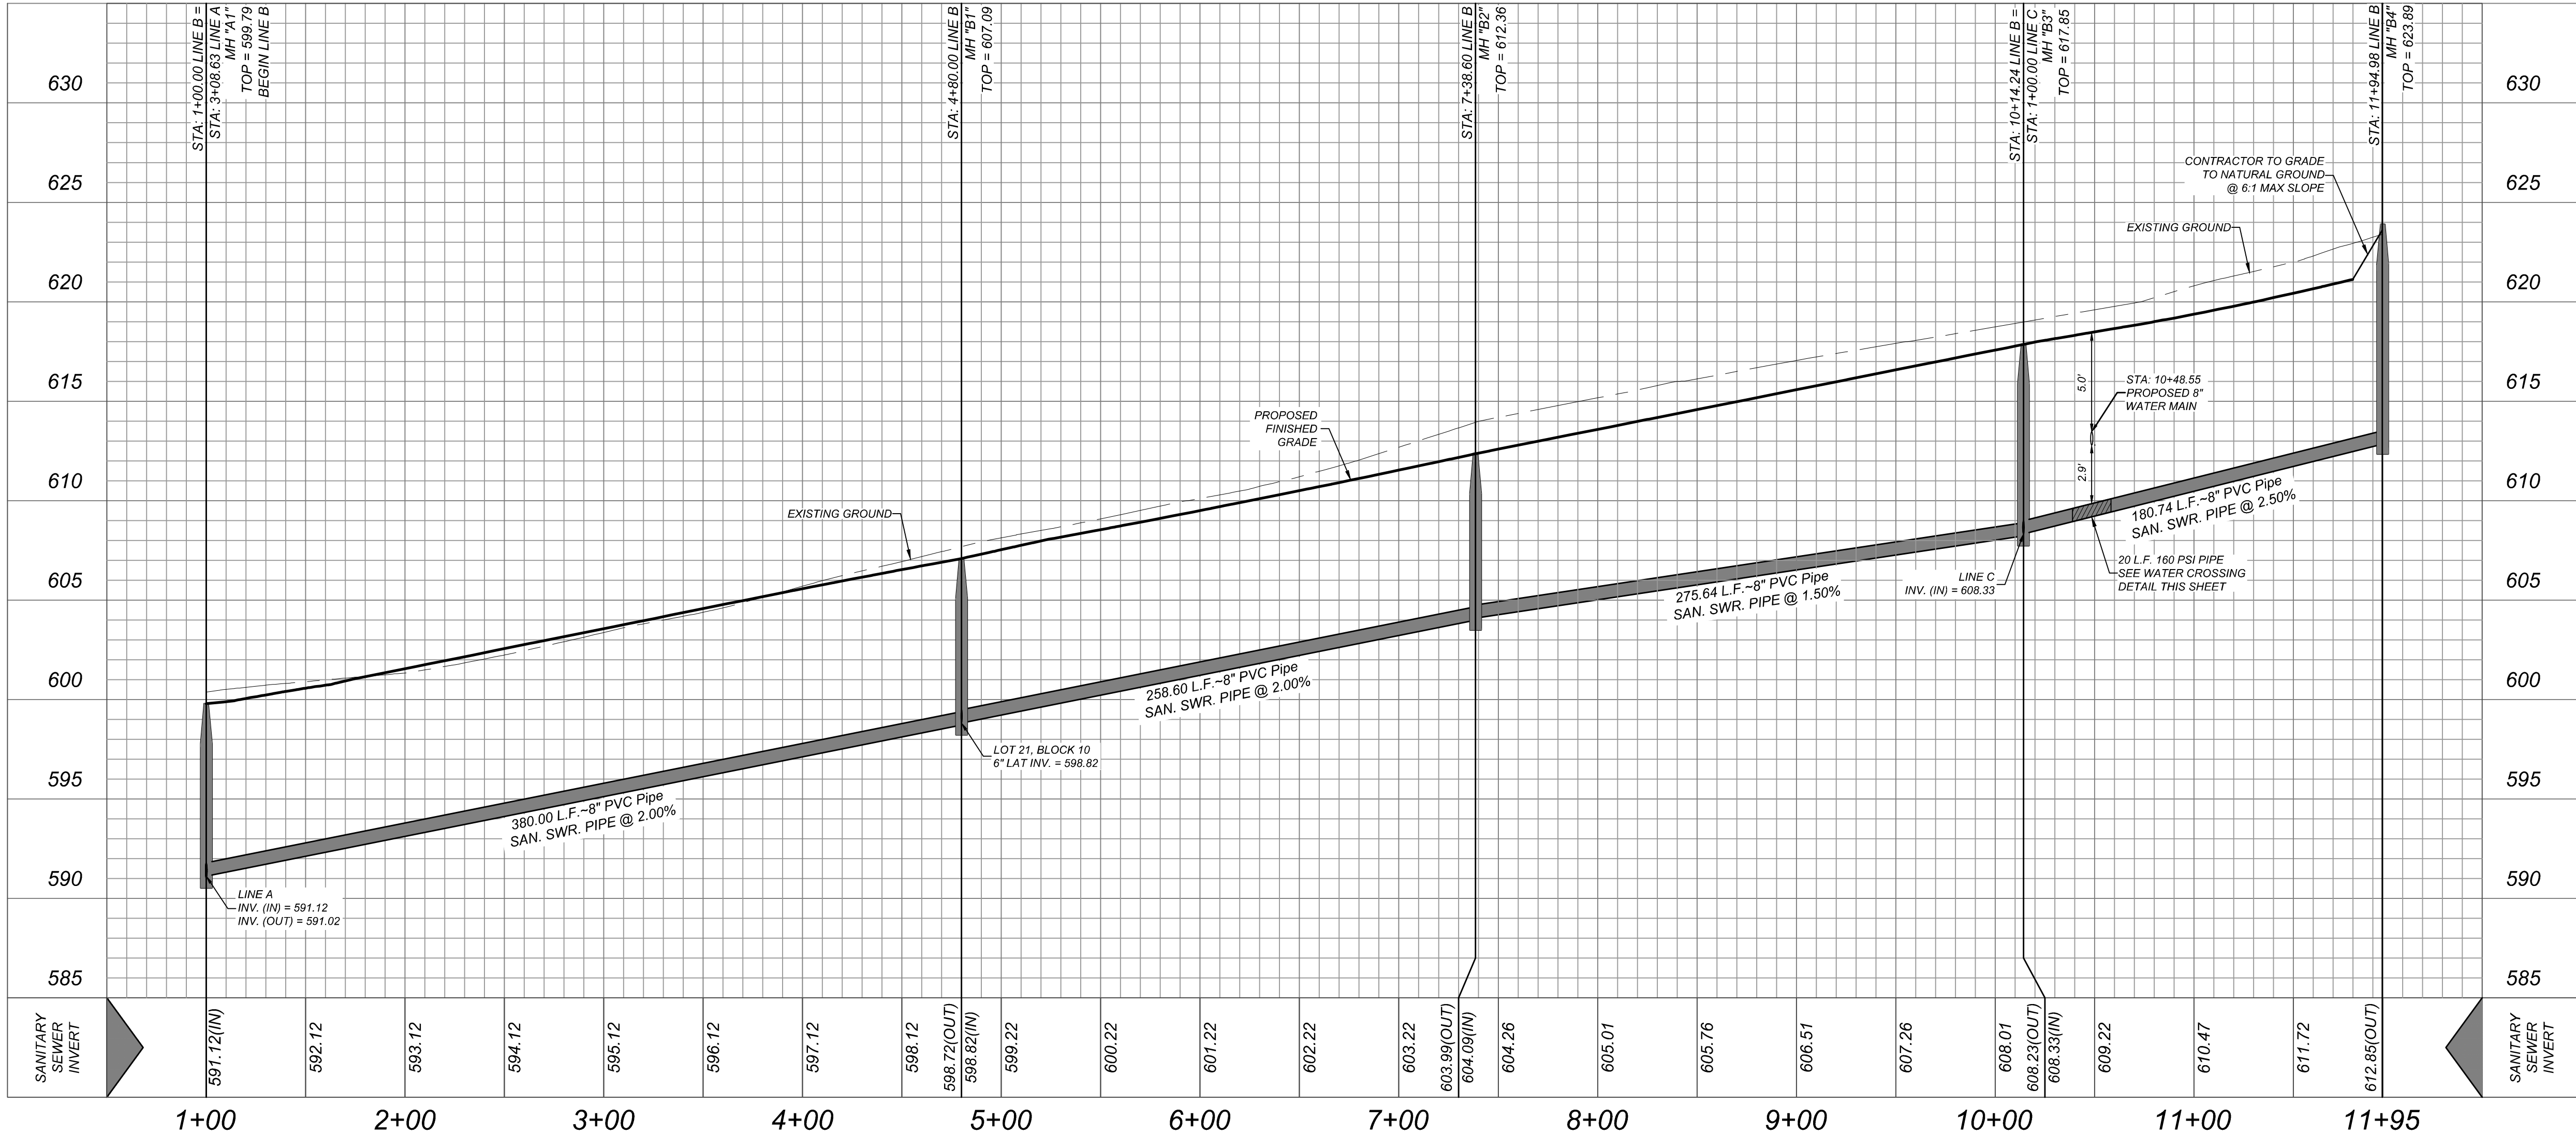

LOWER - EASTER SEWERSHED - DOS RIOS / LEON CREEK

DEVELOPER'S NAME: MEH HOLDING COMPANY, LTD
DEVELOPER'S ADDRESS: 5210 THOUSAND OAKS, SUITE 1318
CITY: SAN ANTONIO STATE: TEXAS ZIP: 78233
PHONE#: (210) 493-2811 FAX#: TOTAL ACREAGE: 28.07 ACRES
SAWS BLOCK MAP#: 214558, 214560, 216560 TOTAL EDU'S: 112
TOTAL LINEAR FOOTAGE OF PIPE: 3,751 LF OF 8" SDR 26 PLAT NO.: 23-11800440
NUMBER OF LOTS: 112 SAWS JOB#: 23-1654

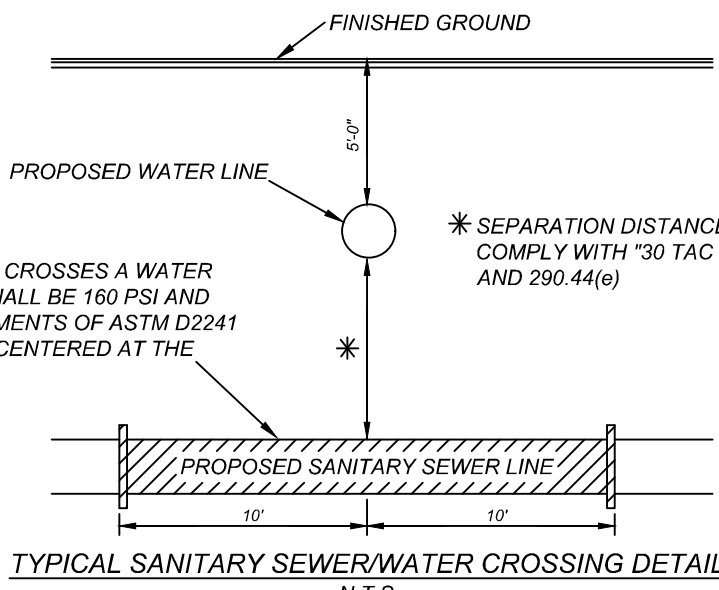

WHERE SEWER PIPE CROSSES A WATER LINE, THE SEWER SHALL BE 160 PSI AND MEET THE REQUIREMENTS OF ASTM D2241 WITH ONE 20 JOINT CENTERED AT THE WATER CROSSING.

WATER CROSSING
STA: 10+48.55 LINE "B"
REF. WATER CROSSING
DETAIL THIS SHEET

UNPLATTED REMAINING
PORTION OF 257.33 ACRES
(DOC #20190051458 O.P.R.)
OWNER: MEH HOLDING
COMPANY LTD

OFF-LOT VARIABLE WIDTH ACCESS, SANITARY
SEWER, WATER, DRAINAGE, ELECTRIC, GAS,
TELEPHONE & CABLE TV EASEMENT (ENTIRE
EASEMENT TO EXPIRE UPON INCORPORATION
INTO PLATTED STREET R.O.W.)

DRAIN "F"
SHEET 4.6-4.7

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FOR STATE SPECIFIC DIRECT PHONE NUMBERS VISIT: WWW.CALL811.COM

STATE OF TEXAS
JEFFREY W. MARTIN
139094
LICENSED PROFESSIONAL ENGINEER
6/28/24

PRELIMINARY

FOR
SOUTHEAST
MEADOWS UNIT 3
PLAT# 23-11800440

SAN ANTONIO
BEXAR COUNTY
TEXAS

Colliers
Engineering & Design

SAN ANTONIO (KFW)
3421 Paesanos Parkway
San Antonio, TX 78231
Phone: 210.979.8444
COLLIERS ENGINEERING & DESIGN, INC.
TBP'S Form: 1-1-003
TBP'S Form: 10194550

SCALE:	DATE:	DRAWN BY:	CHECKED BY:
AS SHOWN	07/20/2023	SD	SC

PROJECT NUMBER: 205-43-07 DRAWING NUMBER: SSP2054307

SHEET TITLE:
LINE "B" PLAN & PROFILE





SHEET NUMBER:
6.5

CONTRACTOR AND/OR CONTRACTOR'S INDEPENDENTLY RETAINED EMPLOYEE OR STRUCTURAL DESIGN/GEOTECHNICAL SAFETY/EQUIPMENT CONSULTANT, IF ANY, SHALL REVIEW THESE PLANS AND ANY SUBSEQUENT REVISIONS TO THESE PLANS AND APPROVE THEM FOR CONSTRUCTION OF THE PROJECT WORK AREA IN ORDER TO IMPLEMENT CONTRACTOR'S TRENCH EXCAVATION SAFETY PROTECTION SYSTEMS, PROGRAMS AND/OR PROCEDURES FOR THE PROJECT DESCRIBED IN THE TRENCH EXCAVATION SAFETY PROTECTION SYSTEMS, PROGRAMS AND/OR PROCEDURES. CONTRACTOR SHALL PROVIDE FOR ADEQUATE TRENCH EXCAVATION SAFETY PROTECTION THAT COMPLY WITH AS A MINIMUM, OSHA STANDARDS FOR TRENCH EXCAVATIONS. SPECIFICALLY, CONTRACTOR AND/OR CONTRACTOR'S INDEPENDENTLY RETAINED EMPLOYEE OR SAFETY CONSULTANT SHALL IMPLEMENT A TRENCH EXCAVATION SAFETY PROTECTION SYSTEM, PROGRAM AND/OR PROCEDURES, PRESENCE AND ACTIVITIES OF INDIVIDUALS WORKING IN AND AROUND TRENCH EXCAVATION.

1. SEWER PIPE WHERE WATER LINE CROSSES SHALL MEET THE REQUIREMENTS OF ASTM D2241. CONTRACTOR SHALL CENTER A 20 FOOT JOINT OF 160 P.S.I. PRESSURE RATED P.V.C. AT THE PROPOSED WATER CROSSING (NO SEPARATE PAY ITEM).
2. SEE THIS SHEET FOR BENCHMARK INFORMATION.
3. PIPE TYPE DESIGNATIONS ARE SHOWN IN SDP 36.
4. SEE THIS SHEET FOR TYPICAL SANITARY SEWER / WATER CROSSING DETAIL.
5. ALL MANHOLES SHALL HAVE CONCRETE RING ENCASEMENT AND A WATER TIGHT RING AND COVER.
6. ALL MATERIALS AND CONSTRUCTION PROCEDURES WITHIN THE SCOPE OF THIS CONTRACT SHALL BE IN ACCORDANCE WITH THE SAN ANTONIO WATER SYSTEM (SAWS) STANDARD SPECIFICATIONS.

THE CONTRACTOR SHALL BE REQUIRED TO LOCATE ALL PUBLIC OR PRIVATE UTILITIES INCLUDING BUT NOT LIMITED TO: WATER, SEWER, TELEPHONE AND FIBER OPTIC LINES, SITE LIGHTING, ELECTRIC, SECONDARY ELECTRIC, PRIMARY ELECTRICAL, DUCTBANKS, LANDSCAPE IRRIGATION FACILITIES, AND GAS LINES. ANY UTILITY CONFLICTS THAT ARISE SHOULD BE COMMUNICATED TO THE OWNER IMMEDIATELY AND PRIOR TO CONSTRUCTION. THE UTILITIES SHALL CONTACT 1-800-DIG-TESS A MINIMUM OF 48 HOURS PRIOR TO THE START OF CONSTRUCTION. ANY DAMAGE TO EXISTING UTILITIES SHALL BE THE SOLE RESPONSIBILITY OF THE CONTRACTOR AND THE REPAIR SHALL BE AT CONTRACTOR'S SOLE EXPENSE WHETHER THE UTILITY IS SHOWN ON THESE PLANS OR NOT.

ALL MANHOLES MUST BE WATERTIGHT, WITH WATERTIGHT RINGS AND COVERS. THESE MANHOLES MUST BE VENTED PER SAWS DETAIL DD852-02.

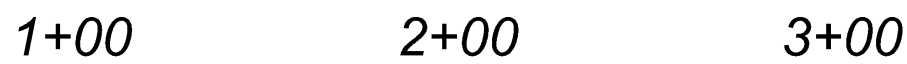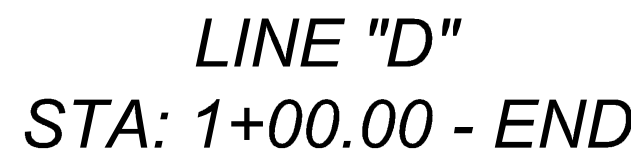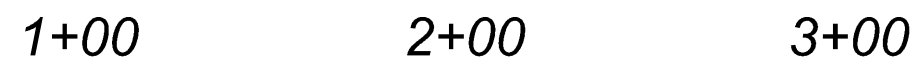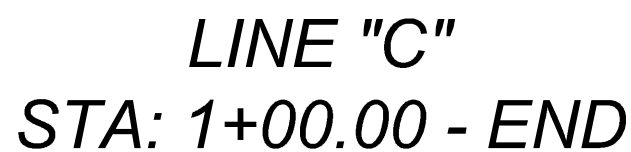

DEVELOPER'S NAME: MEH HOLDING COMPANY, LTD

DEVELOPER'S ADDRESS: 5210 THOUSAND OAKS, SUITE 1318

CITY: SAN ANTONIO STATE: TEXAS ZIP: 78233


PHONE#: (210) 493-2811 FAX#: TOTAL ACREAGE: 28.07 ACRES

SAWS BLOCK MAP#: 214558, 214560, 216560 TOTAL EDUS: 112

TOTAL LINEAR FOOTAGE OF PIPE: 3,751 LF OF 8" SDR 26 PLAT NO.: 23-11800440

NUMBER OF LOTS: 112 SAWS JOB#: 23-1654


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FOR
SOUTHEAST
MEADOWS UNIT 3
PLAT# 23-11800440

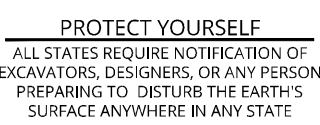

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Parkway
San Antonio, TX 78231
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COLLIERS ENGINEERING & DESIGN, INC.
TBPE Firm#: F-14909
TBPLS Firm#: 10194550

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PROJECT NUMBER: 205-43-07		DRAWING NAME: SSPP2054307	

SHEET TITLE:


LINE "C" AND LINE "D"
PLAN & PROFILE

SHEET NUMBER:

6.6

NOTE: DO NOT SCALE DRAWINGS FOR CONSTRUCTION

SOUTHEAST MEADOWS UNIT 3
BEXAR COUNTY, TX
WATER IMPROVEMENTS

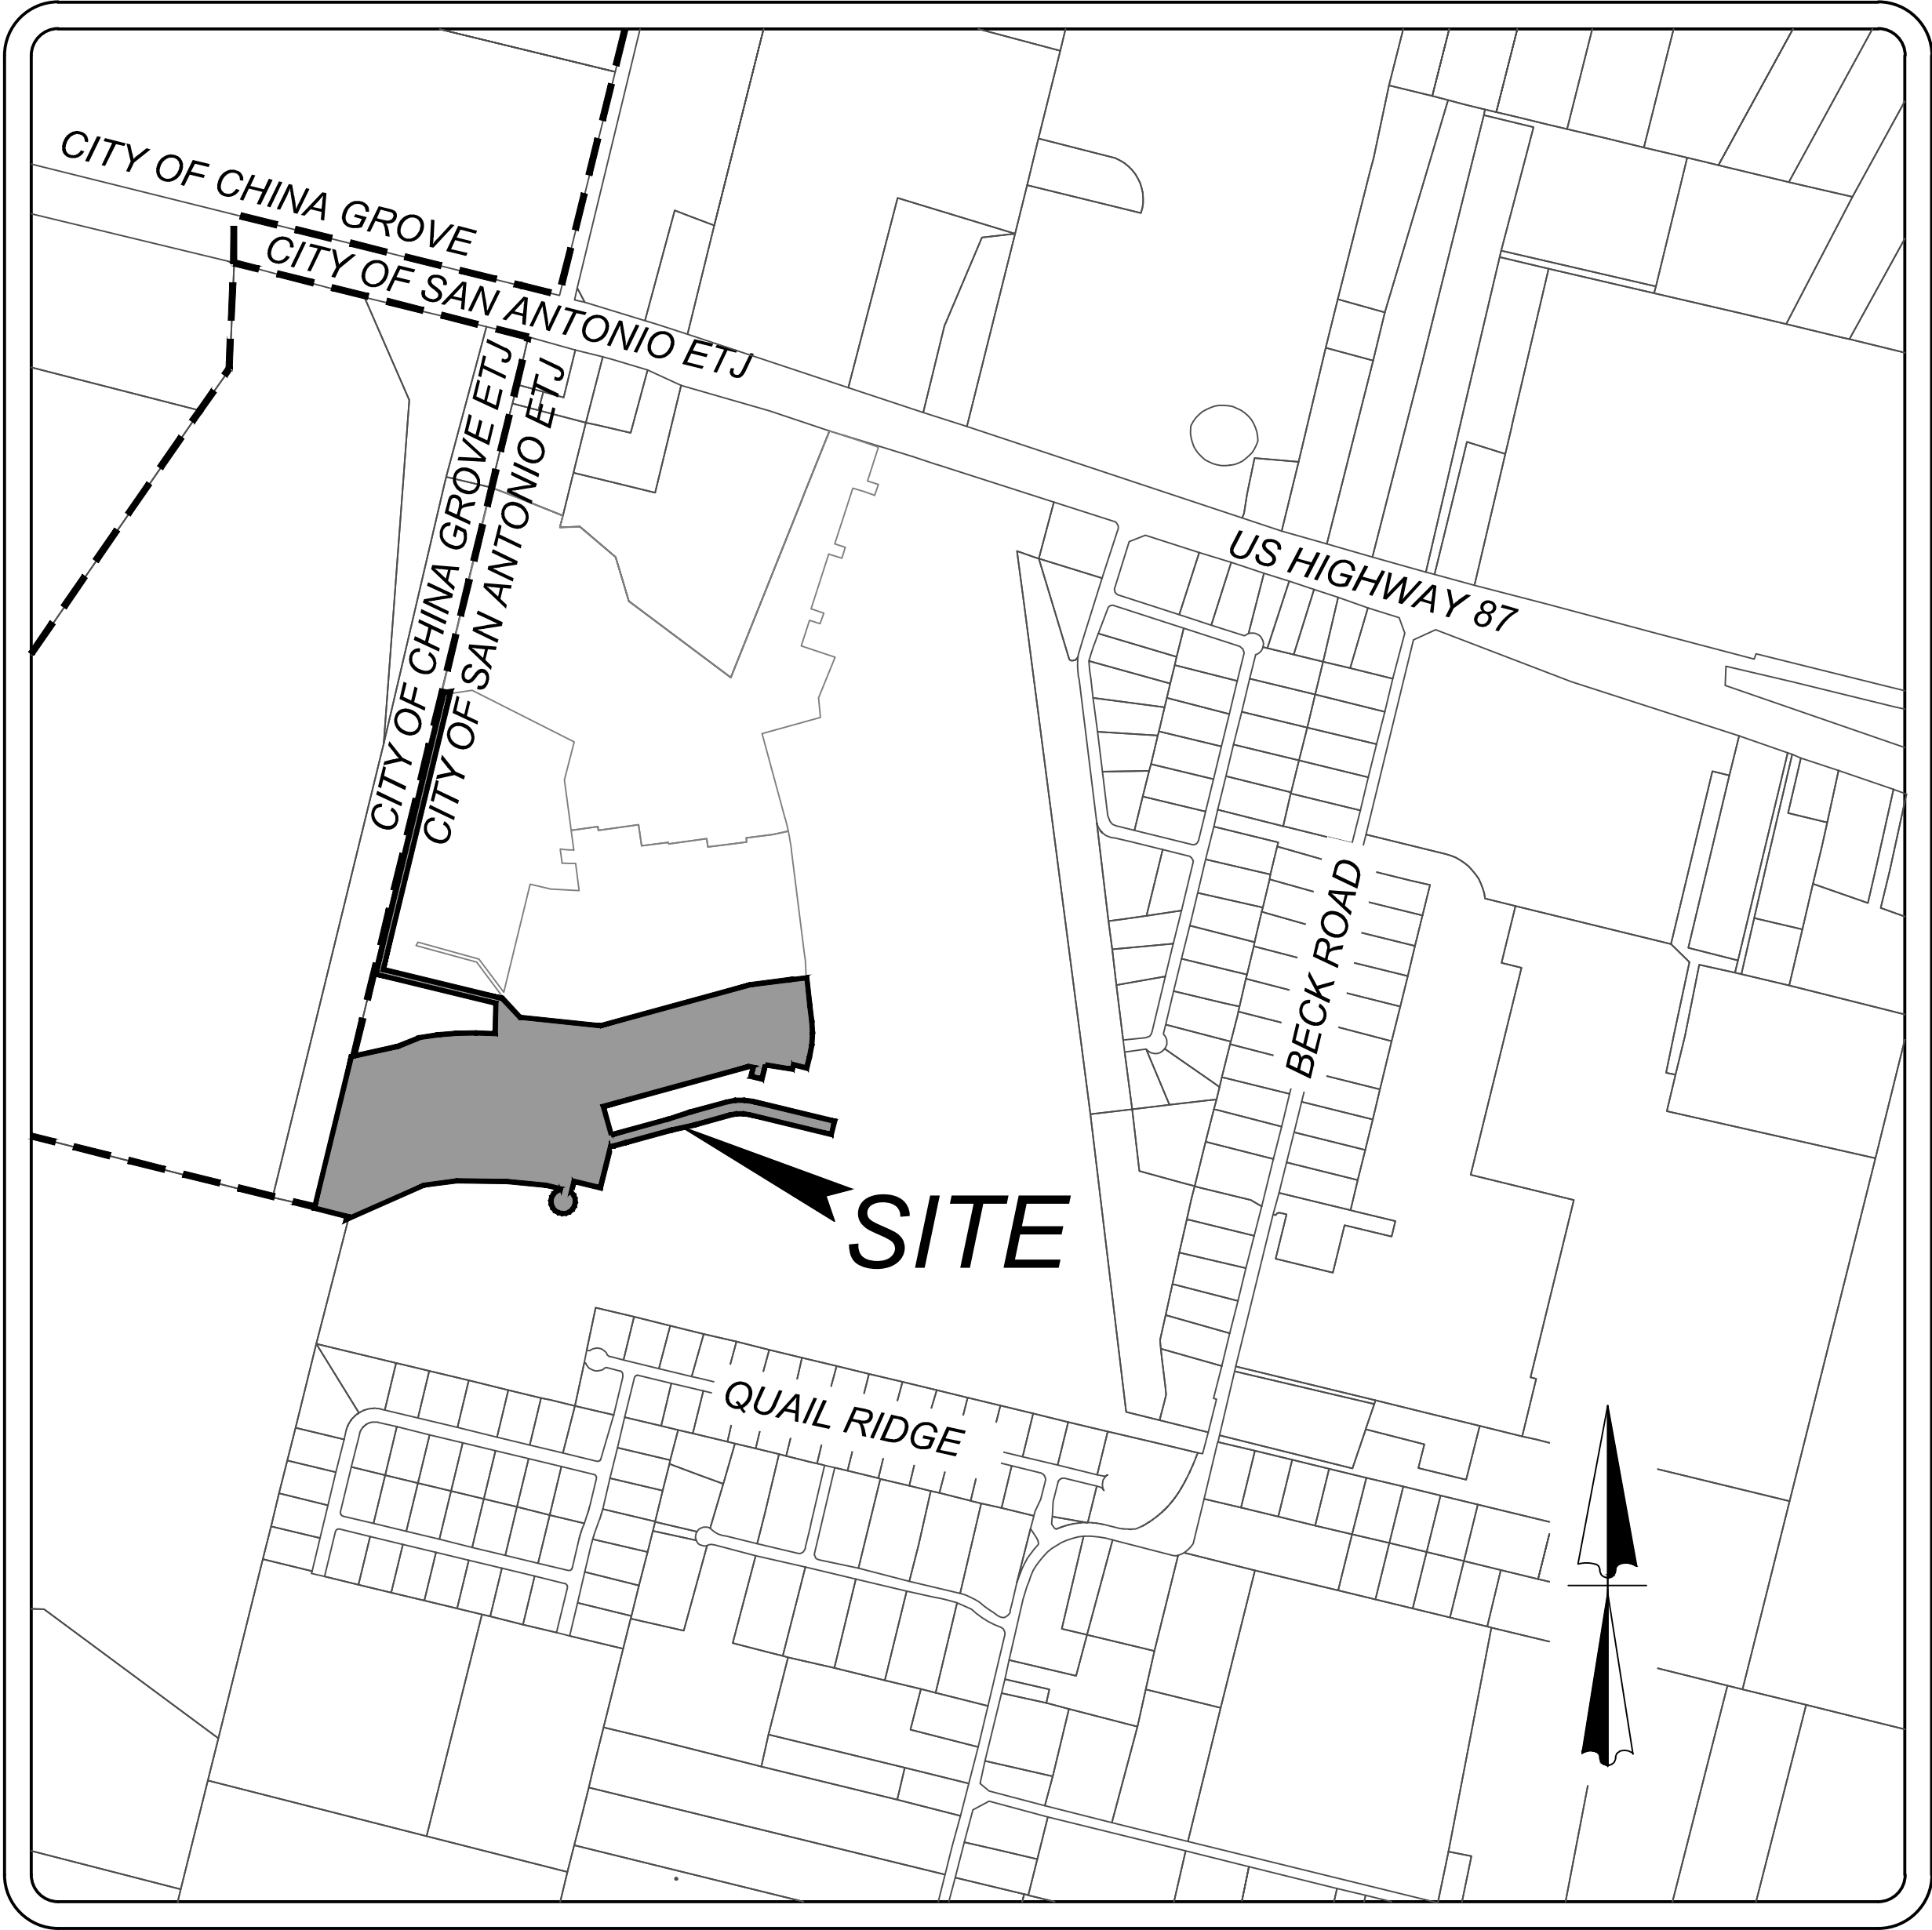

LOCATION MAP
NOT-TO-SCALE

OWNER/DEVELOPER
MEH HOLDING COMPANY LTD
5210 THOUSAND OAKS, SUITE 1318
SAN ANTONIO, TX 78233

INDEX

DESCRIPTION	SHEET NO.
WATER DISTRIBUTION COVER SHEET	7.0
WATER DISTRIBUTION PLAN	7.1
WATER DISTRIBUTION PLAN	7.2
WATER DISTRIBUTION DETAILS	7.3
WATER DISTRIBUTION DETAILS	7.4
WATER DISTRIBUTION DETAILS	7.5



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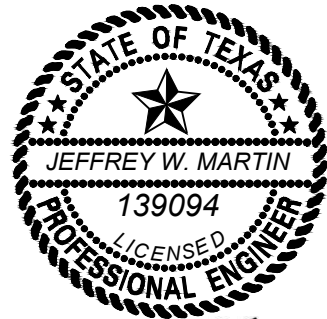


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FOR
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TBPB Form# 10194550

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PROJECT NUMBER: 205-43-07	DRAWING NAME: CVOW2054307		


SHEET TITLE:
WATER DISTRIBUTION
COVER SHEET

SHEET NUMBER:
7.0

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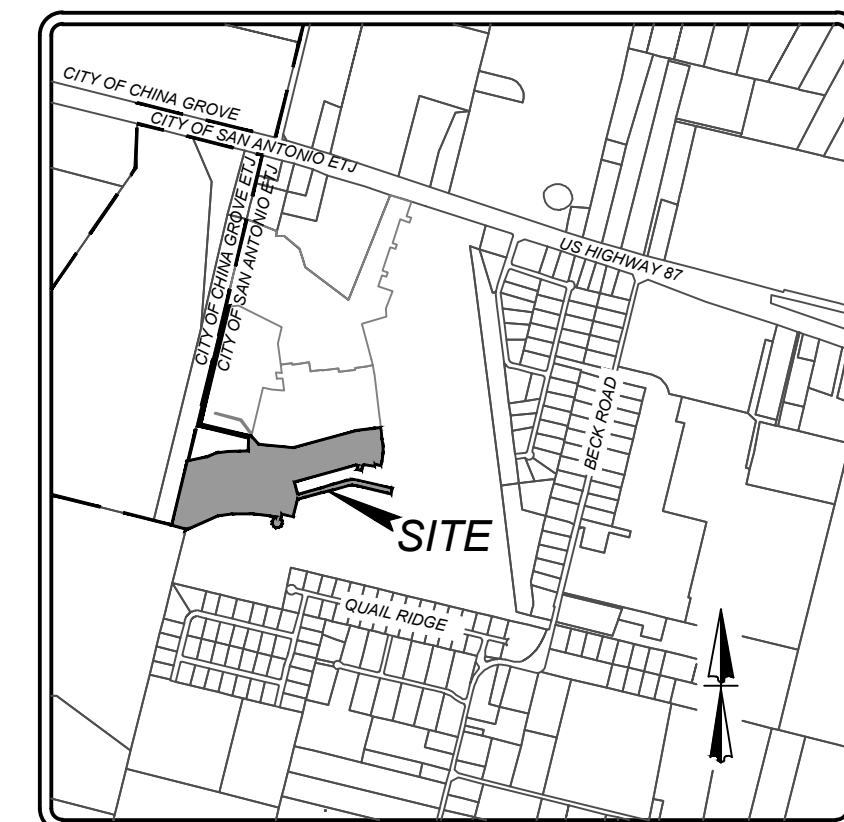
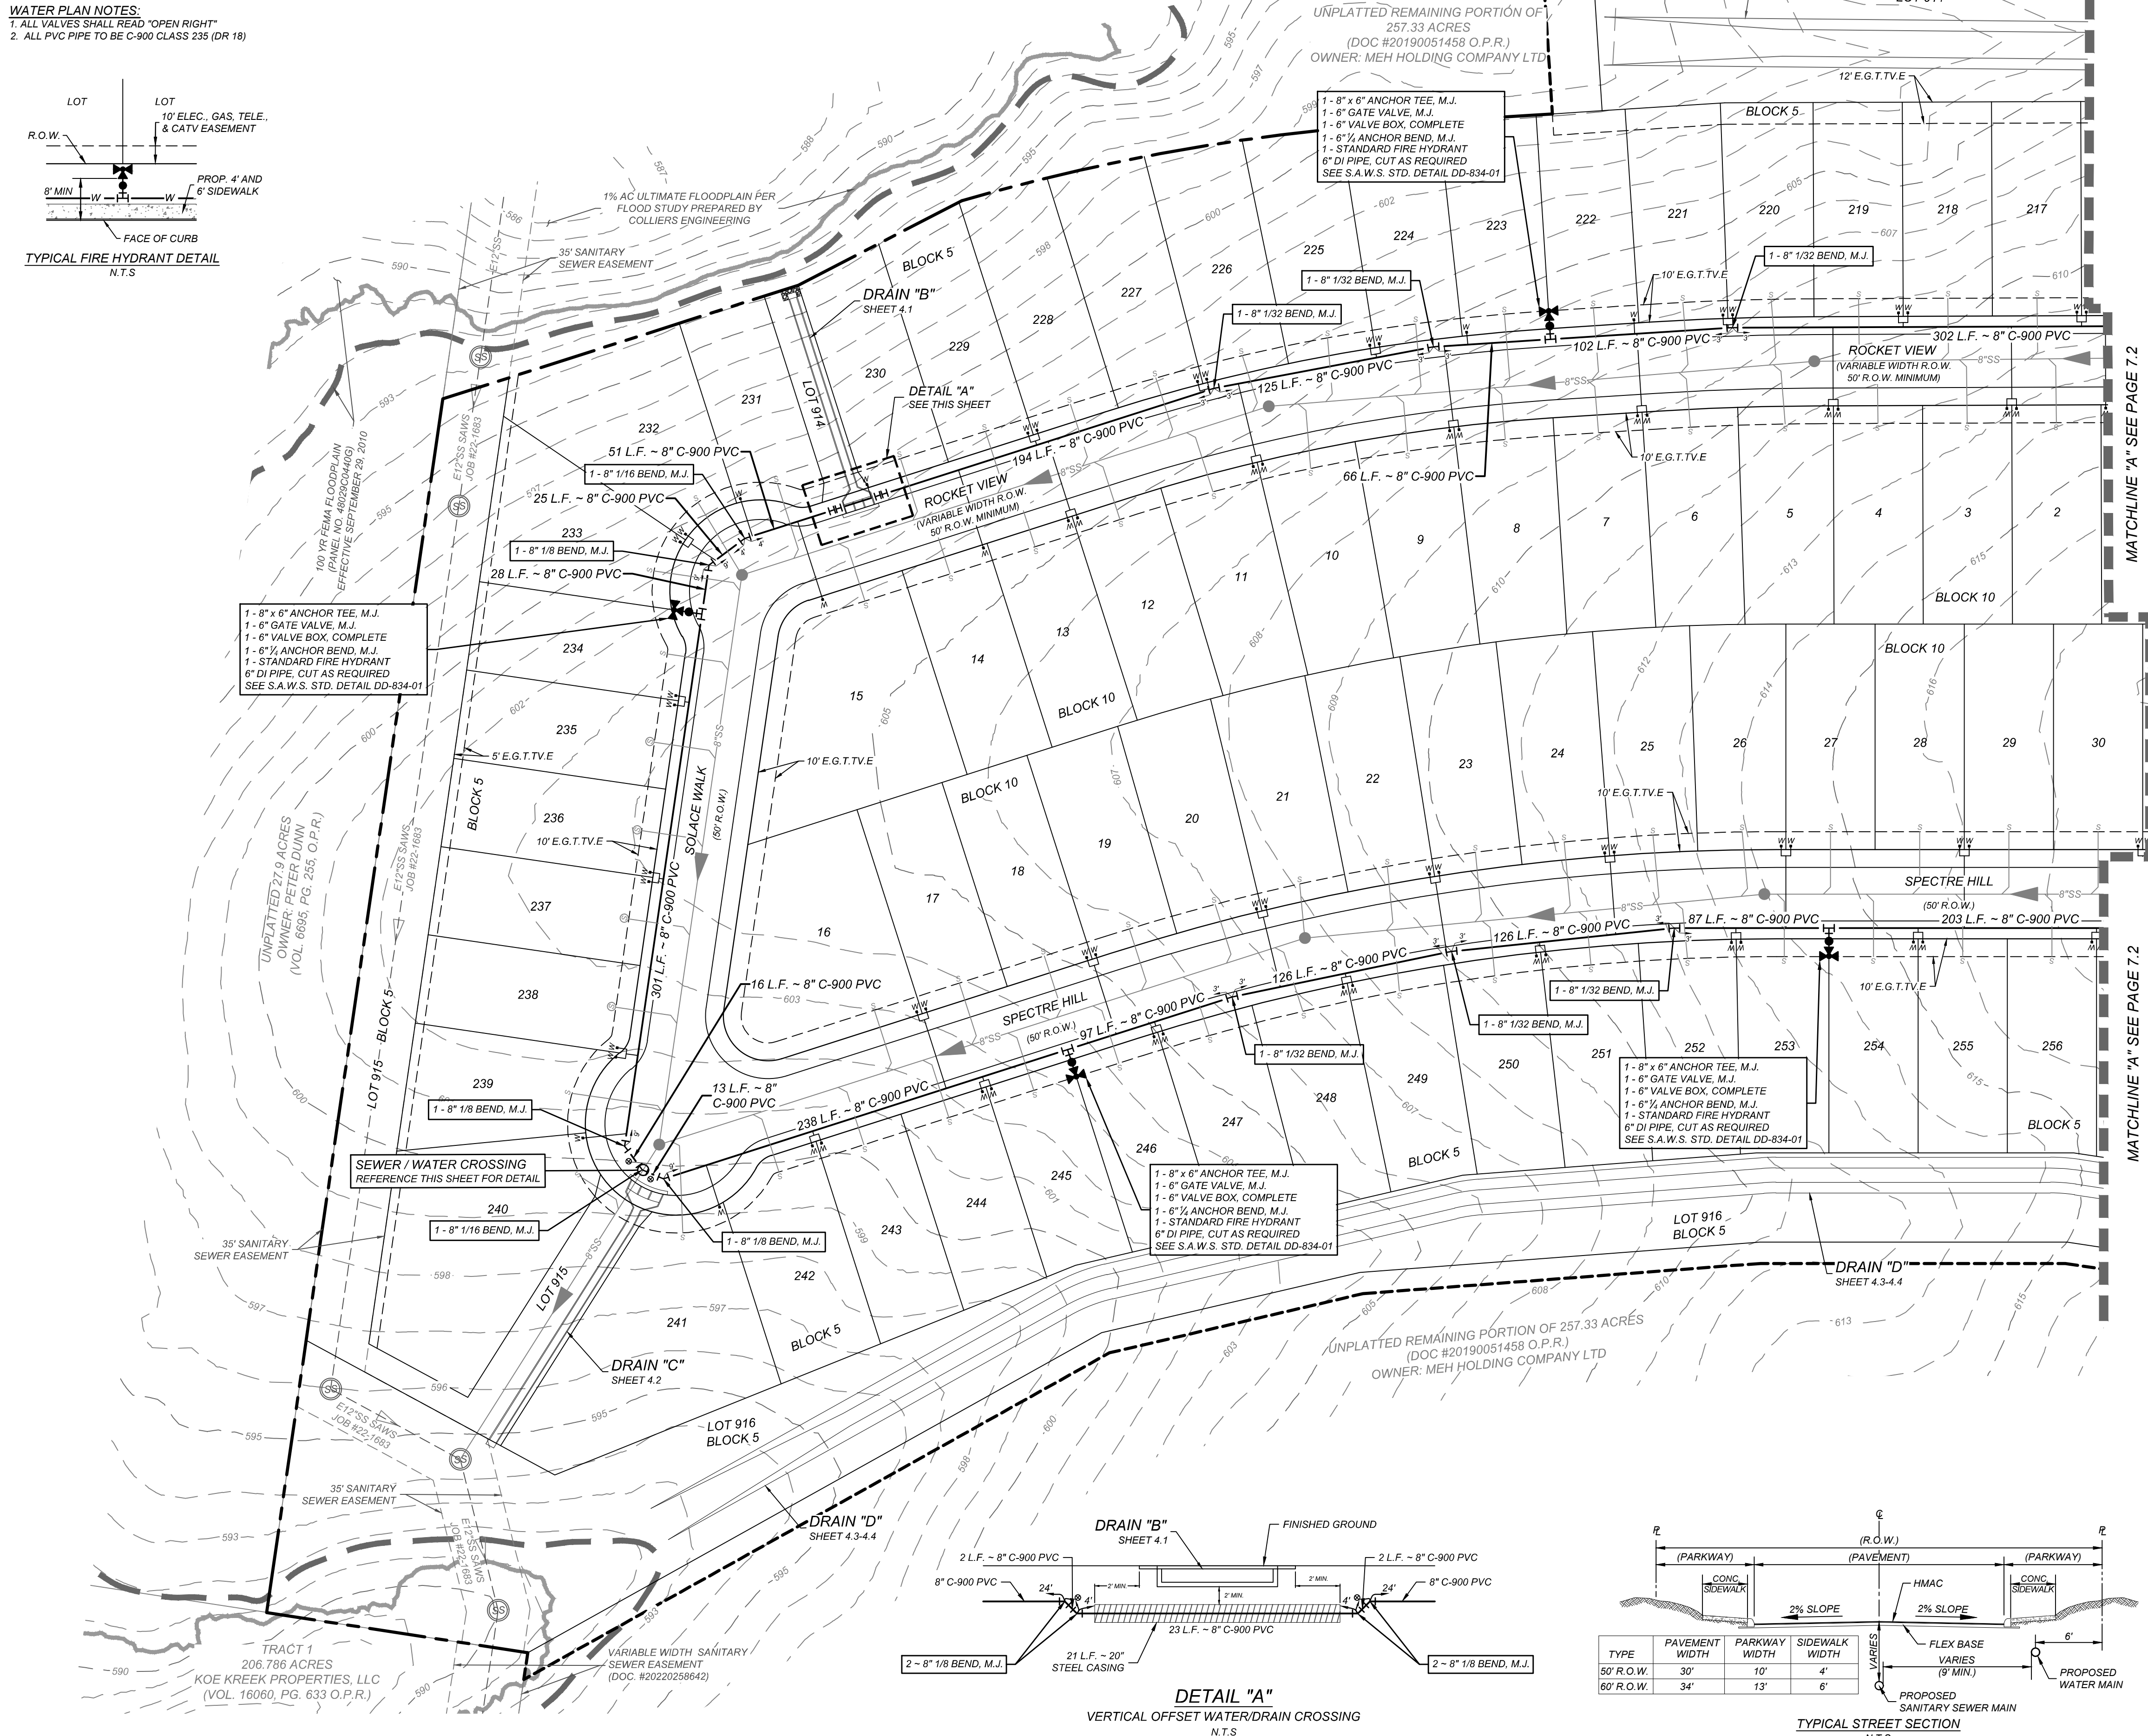
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1. ALL VALVES SHALL READ "OPEN RIGHT"
2. ALL PVC PIPE TO BE C-900 CLASS 235 (DR 18)





IN AN EFFORT TO MEET THE CITY OF SAN ANTONIO'S FIRE FLOW REQUIREMENTS FOR THE PROPOSED RESIDENTIAL DEVELOPMENT, THE PUBLIC WATER MAIN SYSTEM HAS BEEN DESIGNED FOR A MINIMUM FIRE FLOW DEMAND OF 1,500 GPM AT 25 PSI RESIDUAL PRESSURE. THE FIRE FLOW REQUIREMENTS FOR INDIVIDUAL STRUCTURES WILL BE REVIEWED DURING THE BUILDING PERMIT PROCESS IN ACCORDANCE WITH THE PROCEDURES SET FORTH BY THE CITY OF SAN ANTONIO DIRECTOR OF DEVELOPMENT SERVICES DEPARTMENT AND THE SAN ANTONIO FIRE DEPARTMENT FIRE MARSHAL.

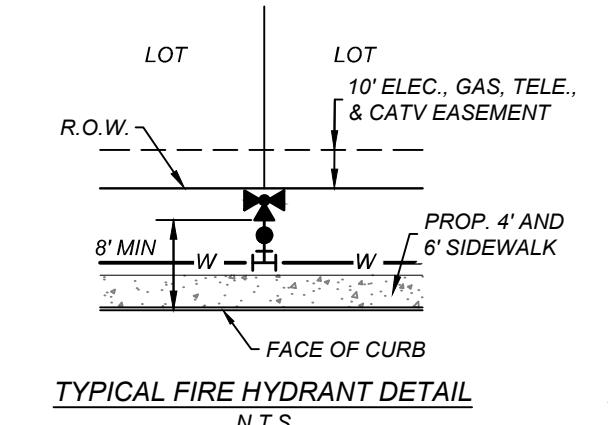THE CONTRACTOR SHALL BE REQUIRED TO LOCATE ALL PUBLIC OR PRIVATE UTILITIES INCLUDING BUT NOT LIMITED TO: WATER, SEWER, TELEPHONE AND FIBER OPTIC LINES, SITE LIGHTING, ELECTRIC, SECONDARY ELECTRIC, PRIMARY ELECTRICAL, DUCTBANKS, LANDSCAPE IRRIGATION FACILITIES, AND GAS LINES. ANY UTILITY CONFLICTS THAT ARISE SHOULD BE COMMUNICATED TO THE ENGINEER IMMEDIATELY AND PRIOR TO CONSTRUCTION. THE CONTRACTOR SHALL CONTACT 1-800-DIG-IT TO OBTAIN A MINIMUM OF 48 HOURS PRIOR TO THE START OF CONSTRUCTION. ANY DAMAGE TO EXISTING UTILITIES SHALL BE THE SOLE RESPONSIBILITY OF THE CONTRACTOR, AND THE REPAIRS SHALL BE AT CONTRACTOR'S SOLE EXPENSE WHETHER THE UTILITY IS SHOWN ON THESE PLANS OR NOT.



PROPOSED WATER MAIN	=	— W —
PROPOSED 3/4" WATER SERVICE WITH 5/8" METER & BOX	=	— W —
PROPOSED WATER 3/4" IRRIGATION SERVICE WITH 3/4" METER & BOX	=	— IW —
PROPOSED FIRE HYDRANT	=	
PROPOSED WATER VALVE	=	
PROPOSED SANITARY SEWER MAIN	=	— SS — 
PROPOSED SANITARY SEWER MANHOLE	=	
PROPOSED ELECTRIC, GAS, TELEPHONE & CABLE TV EASEMENT	=	E, G, T, V E
PROPOSED VEHICULAR NON-ACCESS EASEMENT	=	V, N, A, E
PROPOSED CLEAR VISION EASEMENT	=	C, V, E
EXISTING WATER MAIN	=	— EW —
EXISTING FIRE HYDRANT	=	
EXISTING WATER VALVE	=	
EXISTING SANITARY SEWER MAIN	=	— ESS — 
EXISTING SANITARY SEWER MANHOLE	=	
EXISTING OVERHEAD ELECTRIC W/POWER POLE	=	— OHE —  — OHE —
EXISTING GUY WIRE/OVERHEAD FLYING GUY	=	— OHE —  — OHE —

**** ALL TEE FITTINGS TO HAVE 3 VALVES
EXCEPT WHERE NOTED**

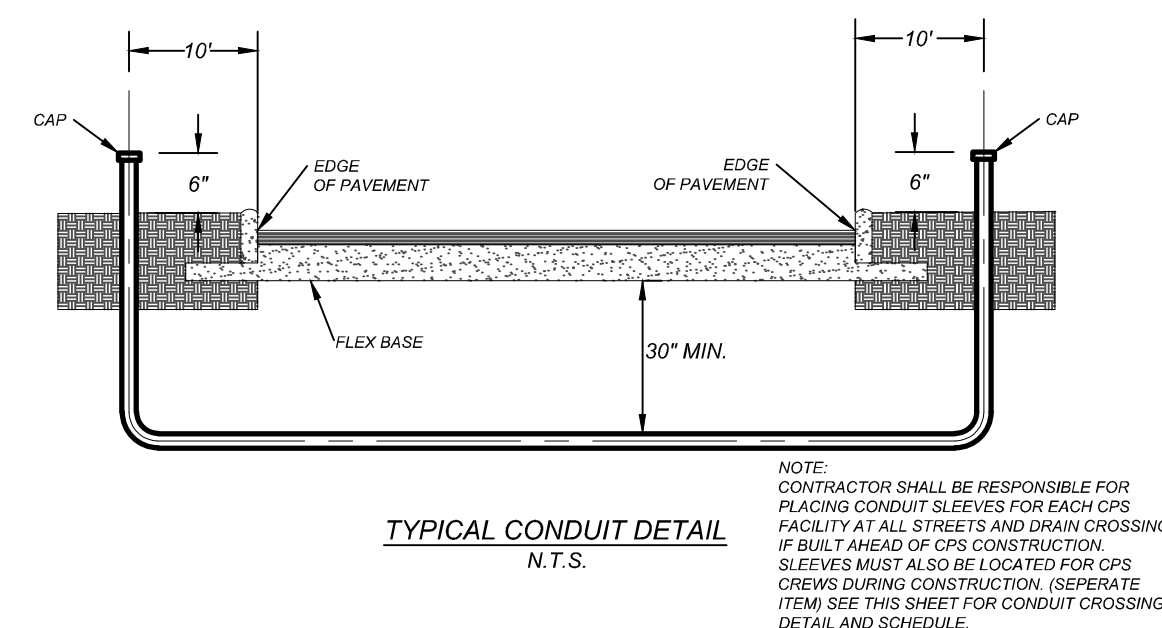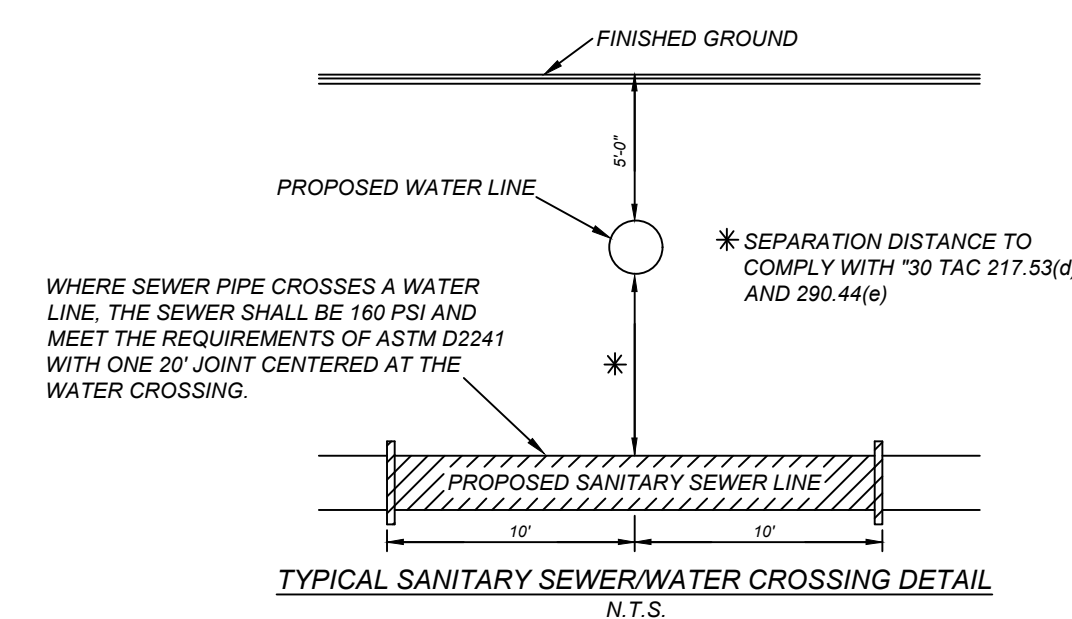

NOTE:
CONTRACTOR SHALL BE RESPONSIBLE FOR
PLACING CONDUIT SLEEVES FOR EACH CPS
FACILITY AT ALL STREETS AND DRAIN CROSSINGS
IF BUILT AHEAD OF CPS CONSTRUCTION.
SLEEVES MUST ALSO BE LOCATED FOR CPS
CREWS DURING CONSTRUCTION. (SEPARATE
ITEM) SEE THIS SHEET FOR CONDUIT CROSSING
DETAIL AND SCHEDULE.

NOTE: DO NOT SCALE DRAWINGS FOR CONSTRUCTION

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
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FOR
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PLAT# 23-11800440

SAN ANTONIO
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PROJECT NUMBER: 205-43-07		DRAWING NAME: OW2054307	

WATER DISTRIBUTION PLAN

SHEET NUMBER

71

TRENCH EXCAVATION SAFETY PROTECTION

CONTRACTOR AND/OR CONTRACTORS INDEPENDENTLY RETAINED EMPLOYEE OR STRUCTURAL DESIGN/GEOTECHNICAL SAFETY EQUIPMENT CONSULTANT, IF ANY, SHALL REVIEW THESE PLANS AND ANY AVAILABLE GEOTECHNICAL INFORMATION AND THE ANTICIPATED INSTALLATION SITES WITHIN THE PROJECT WORK AREA IN ORDER TO IMPLEMENT CONTRACTOR'S TRENCH EXCAVATION SAFETY PROTECTION SYSTEMS, PROGRAMS AND/OR PROCEDURES FOR THE PROJECT DESCRIBED IN THE CONTRACT DOCUMENTS. THE CONTRACTOR'S IMPLEMENTATION OF THESE SYSTEMS, PROGRAMS AND/OR PROCEDURES SHALL PROVIDE FOR ADEQUATE TRENCH EXCAVATION SAFETY PROTECTION THAT COMPLY WITH AS A MINIMUM, OSHA STANDARDS FOR TRENCH EXCAVATIONS. SPECIFICALLY, CONTRACTOR AND/OR CONTRACTOR'S INDEPENDENTLY RETAINED EMPLOYEE OR SAFETY CONSULTANT SHALL IMPLEMENT A TRENCH SAFETY PROGRAM IN ACCORDANCE WITH OSHA STANDARDS GOVERNING THE PRESENCE AND ACTIVITIES OF INDIVIDUALS WORKING IN AND AROUND TRENCH EXCAVATION.

JOINT RESTRAINT NOTE:

CONTRACTOR SHALL INSTALL RETAINER GLANDS AT ALL FITTINGS AND PROVIDE JOINT RESTRAINING HARNESS OR FIELD LOCK GASKETS AT ALL JOINTS WITHIN THE LENGTH SHOWN. CONTRACTOR SHALL INSURE THAT ALL TEES, BENDS, VALVES, ETC. HAVE A MINIMUM OF 5 FT OF PIPE WITH NO JOINTS ON EACH SIDE OF THE FITTING. JOINT RESTRAINTS AND RETAINER GLANDS SHALL BE CALCULATED BY SAWS APPROVED PROGRAMS. THERE WILL BE NO SEPARATE PAY ITEM FOR RETAINER GLANDS AND OTHER JOINT RESTRAINING HARNESS AND GASKETS, BUT SHALL BE SUBSIDIARY TO THE UNIT COST PER LINEAL FOOT OF PIPE INSTALLED.

FIRE FLOW NOTE:

IN AN EFFORT TO MEET THE CITY OF SAN ANTONIO'S FIRE FLOW REQUIREMENTS FOR THE PROPOSED RESIDENTIAL DEVELOPMENT, THE PUBLIC WATER MAIN SYSTEM HAS BEEN DESIGNED FOR A MINIMUM FIRE FLOW DEMAND OF 1,500 GPM AT 25 PSI RESIDUAL PRESSURE. THE FIRE FLOW REQUIREMENTS FOR INDIVIDUAL STRUCTURES WILL BE REVIEWED DURING THE BUILDING PERMIT PROCESS IN ACCORDANCE WITH THE PROCEDURES SET FORTH BY THE CITY OF SAN ANTONIO DIRECTOR OF DEVELOPMENT SERVICES DEPARTMENT AND THE SAN ANTONIO FIRE DEPARTMENT FIRE MARSHAL.

WATER PLAN NOTES:

1. ALL VALVES SHALL READ "OPEN RIGHT"
2. ALL PVC PIPE TO BE C-900 CLASS 235 (DR 18)



CAUTION!:

THE CONTRACTOR SHALL BE REQUIRED TO LOCATE ALL PUBLIC OR PRIVATE UTILITIES INCLUDING BUT NOT LIMITED TO: WATER, SEWER, TELEPHONE AND FIBER OPTIC LINES, SITE LIGHTING, ELECTRIC, SECONDARY ELECTRIC, PRIMARY ELECTRICAL DUCTBANKS, LANDSCAPE IRRIGATION FACILITIES, AND GAS LINES. ANY UTILITY CONFLICTS THAT ARISE SHOULD BE COMMUNICATED TO THE ENGINEER IMMEDIATELY AND PRIOR TO CONSTRUCTION. THE CONTRACTOR SHALL CONTACT 1-800-DIG-TESS A MINIMUM OF 48 HOURS PRIOR TO THE START OF CONSTRUCTION. ANY DAMAGE TO EXISTING UTILITIES SHALL BE THE SOLE RESPONSIBILITY OF THE CONTRACTOR AND THE REPAIR SHALL BE AT CONTRACTOR'S SOLE EXPENSE WHETHER THE UTILITY IS SHOWN ON THESE PLANS OR NOT.


CONTRACTOR TO REMOVE EXISTING BLOWOFF AND TIE NEW 12" PVC MAIN TO EXISTING 12" PVC PIPE AFTER CHLORINATION AND ACCEPTANCE BY EAST CENTRAL SPECIAL UTILITY DISTRICT.

INSTALL FOR CHLORINATION INJECTION
1- 12" SOLID SLEEVE, M.J.
1- 2" BLOWOFF (TEMP) ASSEMBLY
SEE SAWS STD. DETAIL DD-844-01

- 2- 1" CORPORATION STOP, C.C. x I.P.
- 2- 1" COPPER TUBING, CUT AS REQUIRED
- 2- 1 1/2" THD. SOLID CAPS, THR.
- 2- 1" COUP. x 1 1/4" COUPLING, CURB STOP
- CONTRACTOR SHALL PROVIDE A 2" JUMPER CONNECTION TO LOAD NEW MAIN

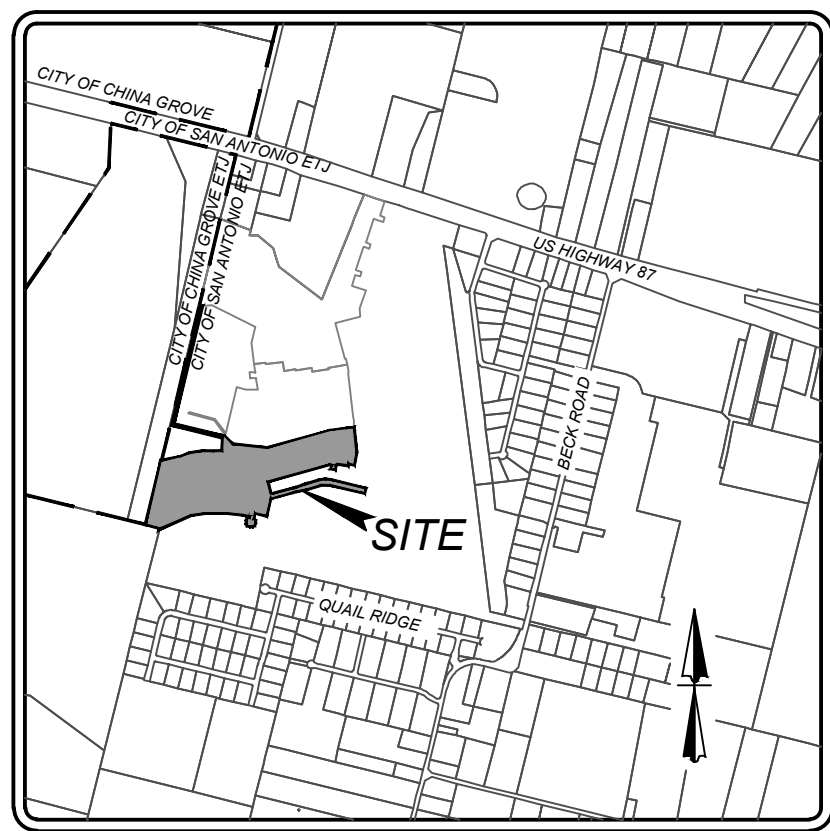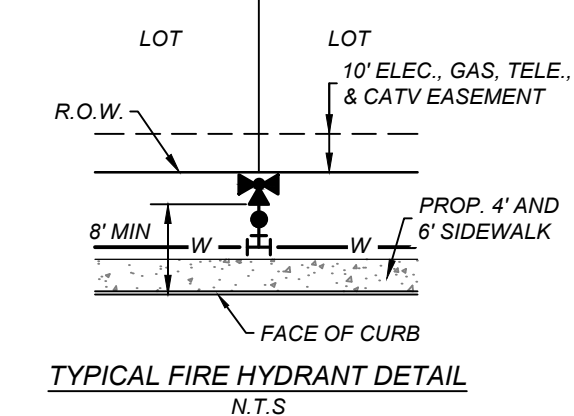




LOCATION MAP NOT-TO-SCALE

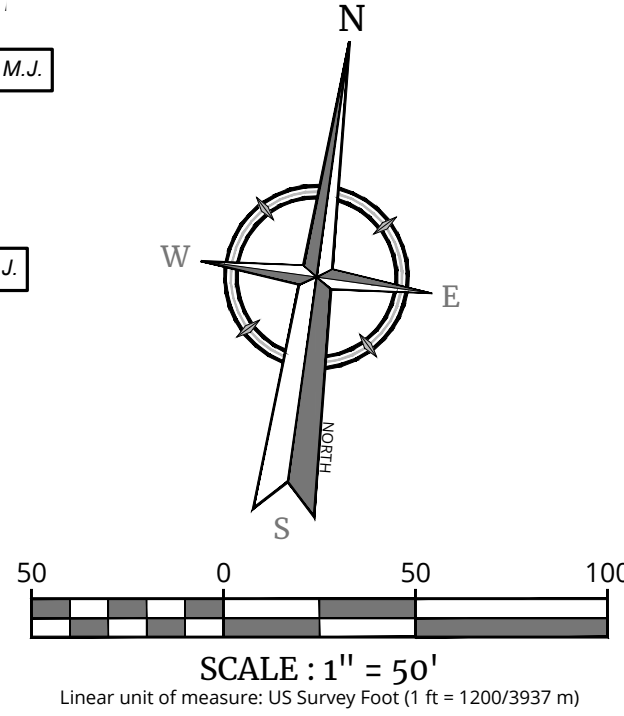

LEGEND

- PROPOSED WATER MAIN
- PROPOSED 3/4" WATER SERVICE WITH 58" METER & BOX
- PROPOSED WATER 3/4" IRRIGATION SERVICE WITH 3/4" METER & BOX
- PROPOSED FIRE HYDRANT
- PROPOSED WATER VALVE
- PROPOSED SANITARY SEWER MAIN
- PROPOSED SANITARY SEWER MANHOLE
- PROPOSED ELECTRIC, GAS, TELEPHONE & CABLE TV EASEMENT
- PROPOSED VEHICULAR NON-ACCESS EASEMENT
- PROPOSED CLEAR VISION EASEMENT
- EXISTING WATER MAIN
- EXISTING FIRE HYDRANT
- EXISTING WATER VALVE
- EXISTING SANITARY SEWER MAIN
- EXISTING SANITARY SEWER MANHOLE
- EXISTING OVERHEAD ELECTRIC
- EXISTING W/POWER POLE
- EXISTING GUY WIRE/OVERHEAD ELECTRIC

ALL TEE FITTINGS TO HAVE 3 VALVES EXCEPT WHERE NOTED

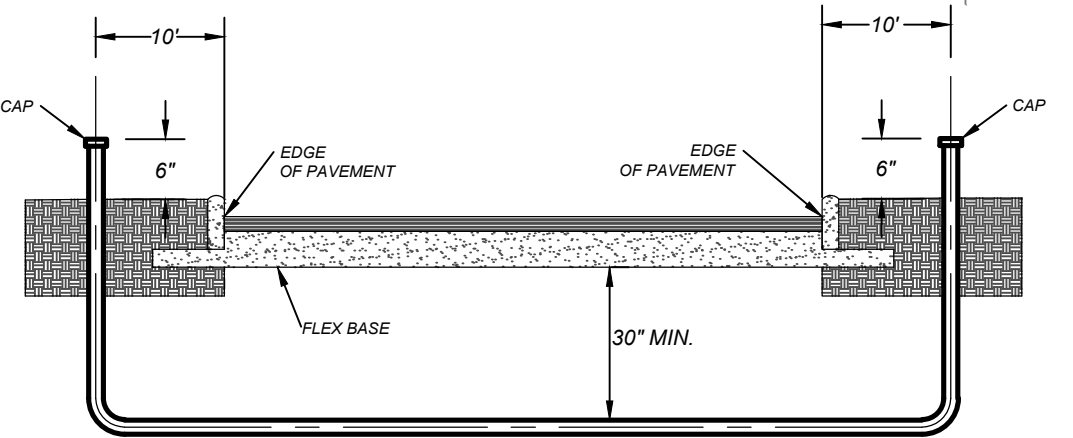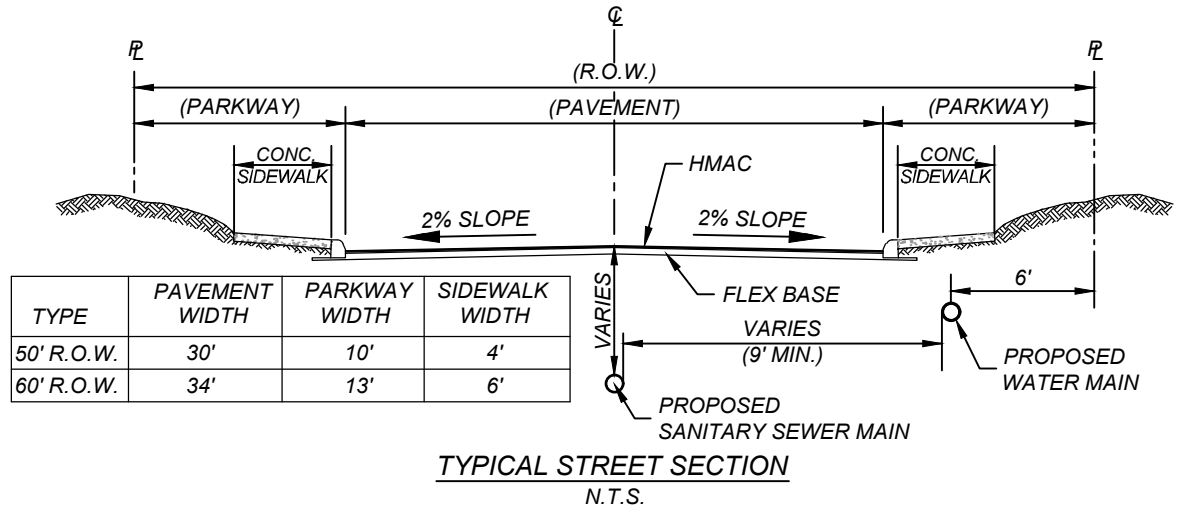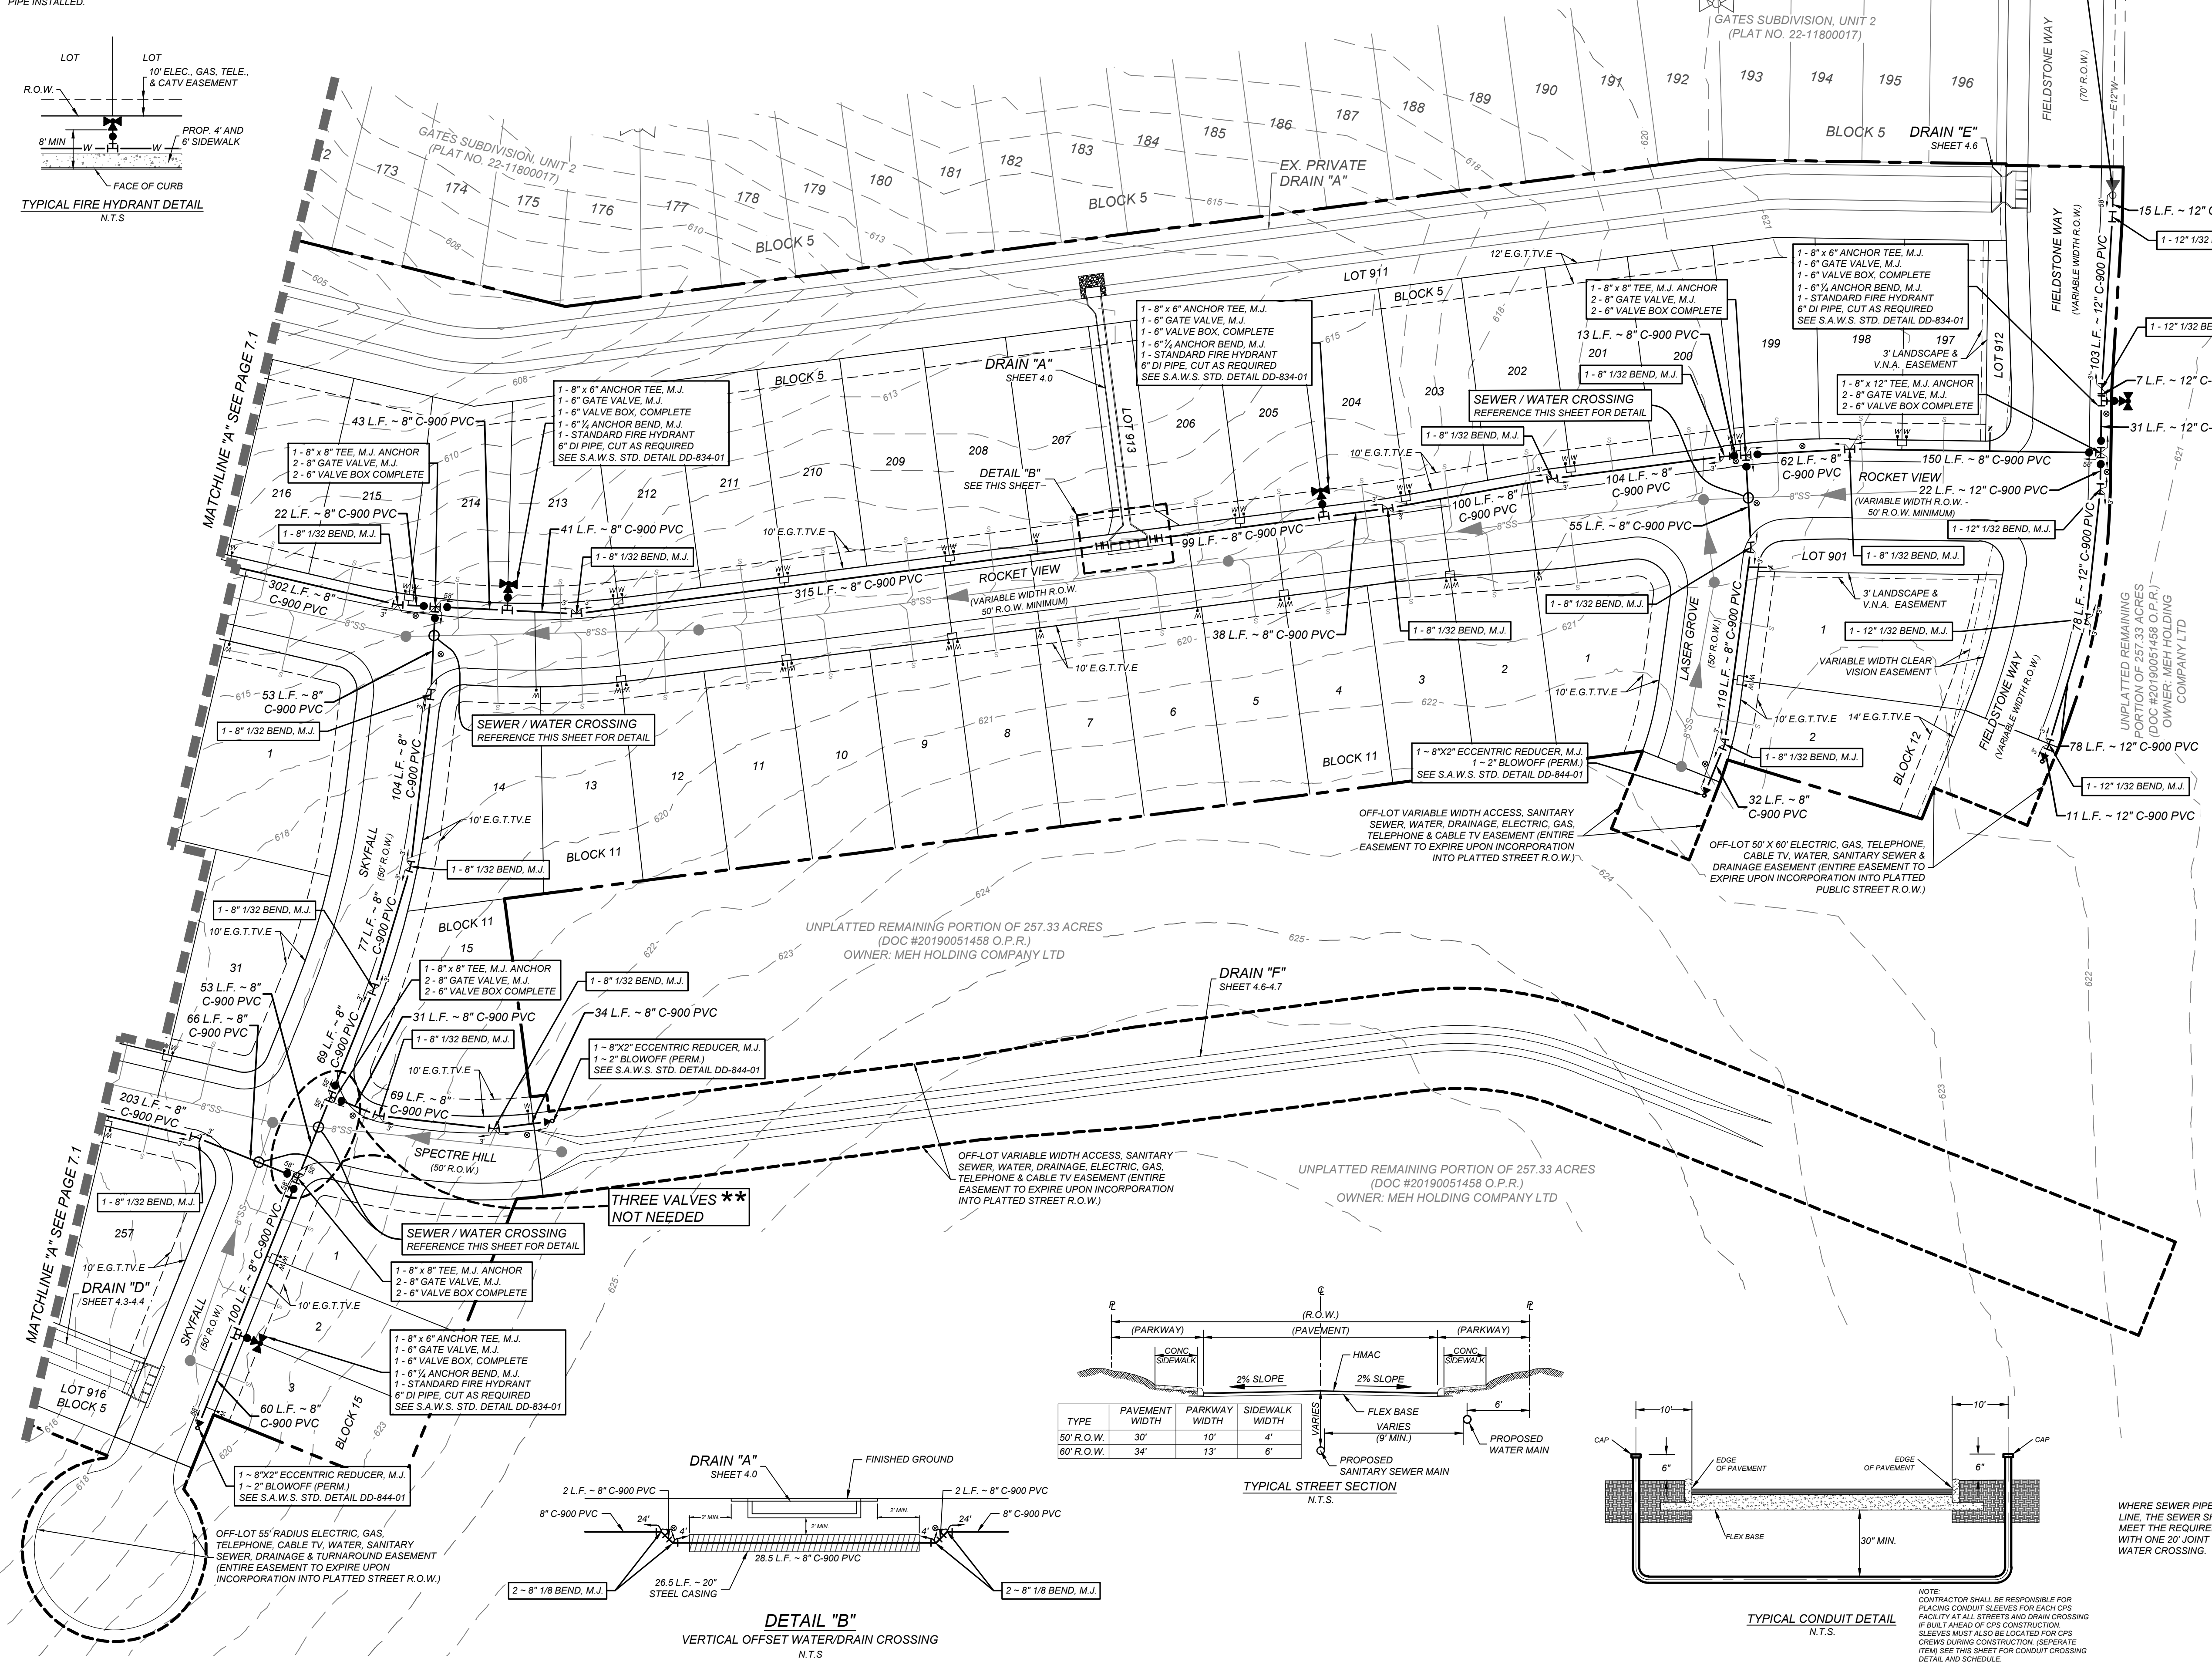

DETAIL "B" VERTICAL OFFSET SEWER/RAIN CROSSING N.T.S.

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FOR

SOUTHEAST MEADOWS UNIT 3

PLAT# 23-11800440

SAN ANTONIO BEXAR COUNTY TEXAS

Colliers

Engineering & Design

SAN ANTONIO (KFW)

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San Antonio, TX 78231

Phone: 210.979.8444

COLLIERS ENGINEERING & DESIGN, INC.

TBPLS Form: 1-1909

TBPLS Form: 10194550

SCALE: AS SHOWN

DATE: 07/20/2023

DRAWN BY: SD


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PROJECT NUMBER: 205-437










DRAWING NUMBER: DW2054307

SHEET TITLE: WATER DISTRIBUTION PLAN

SHEET NUMBER: 7.2

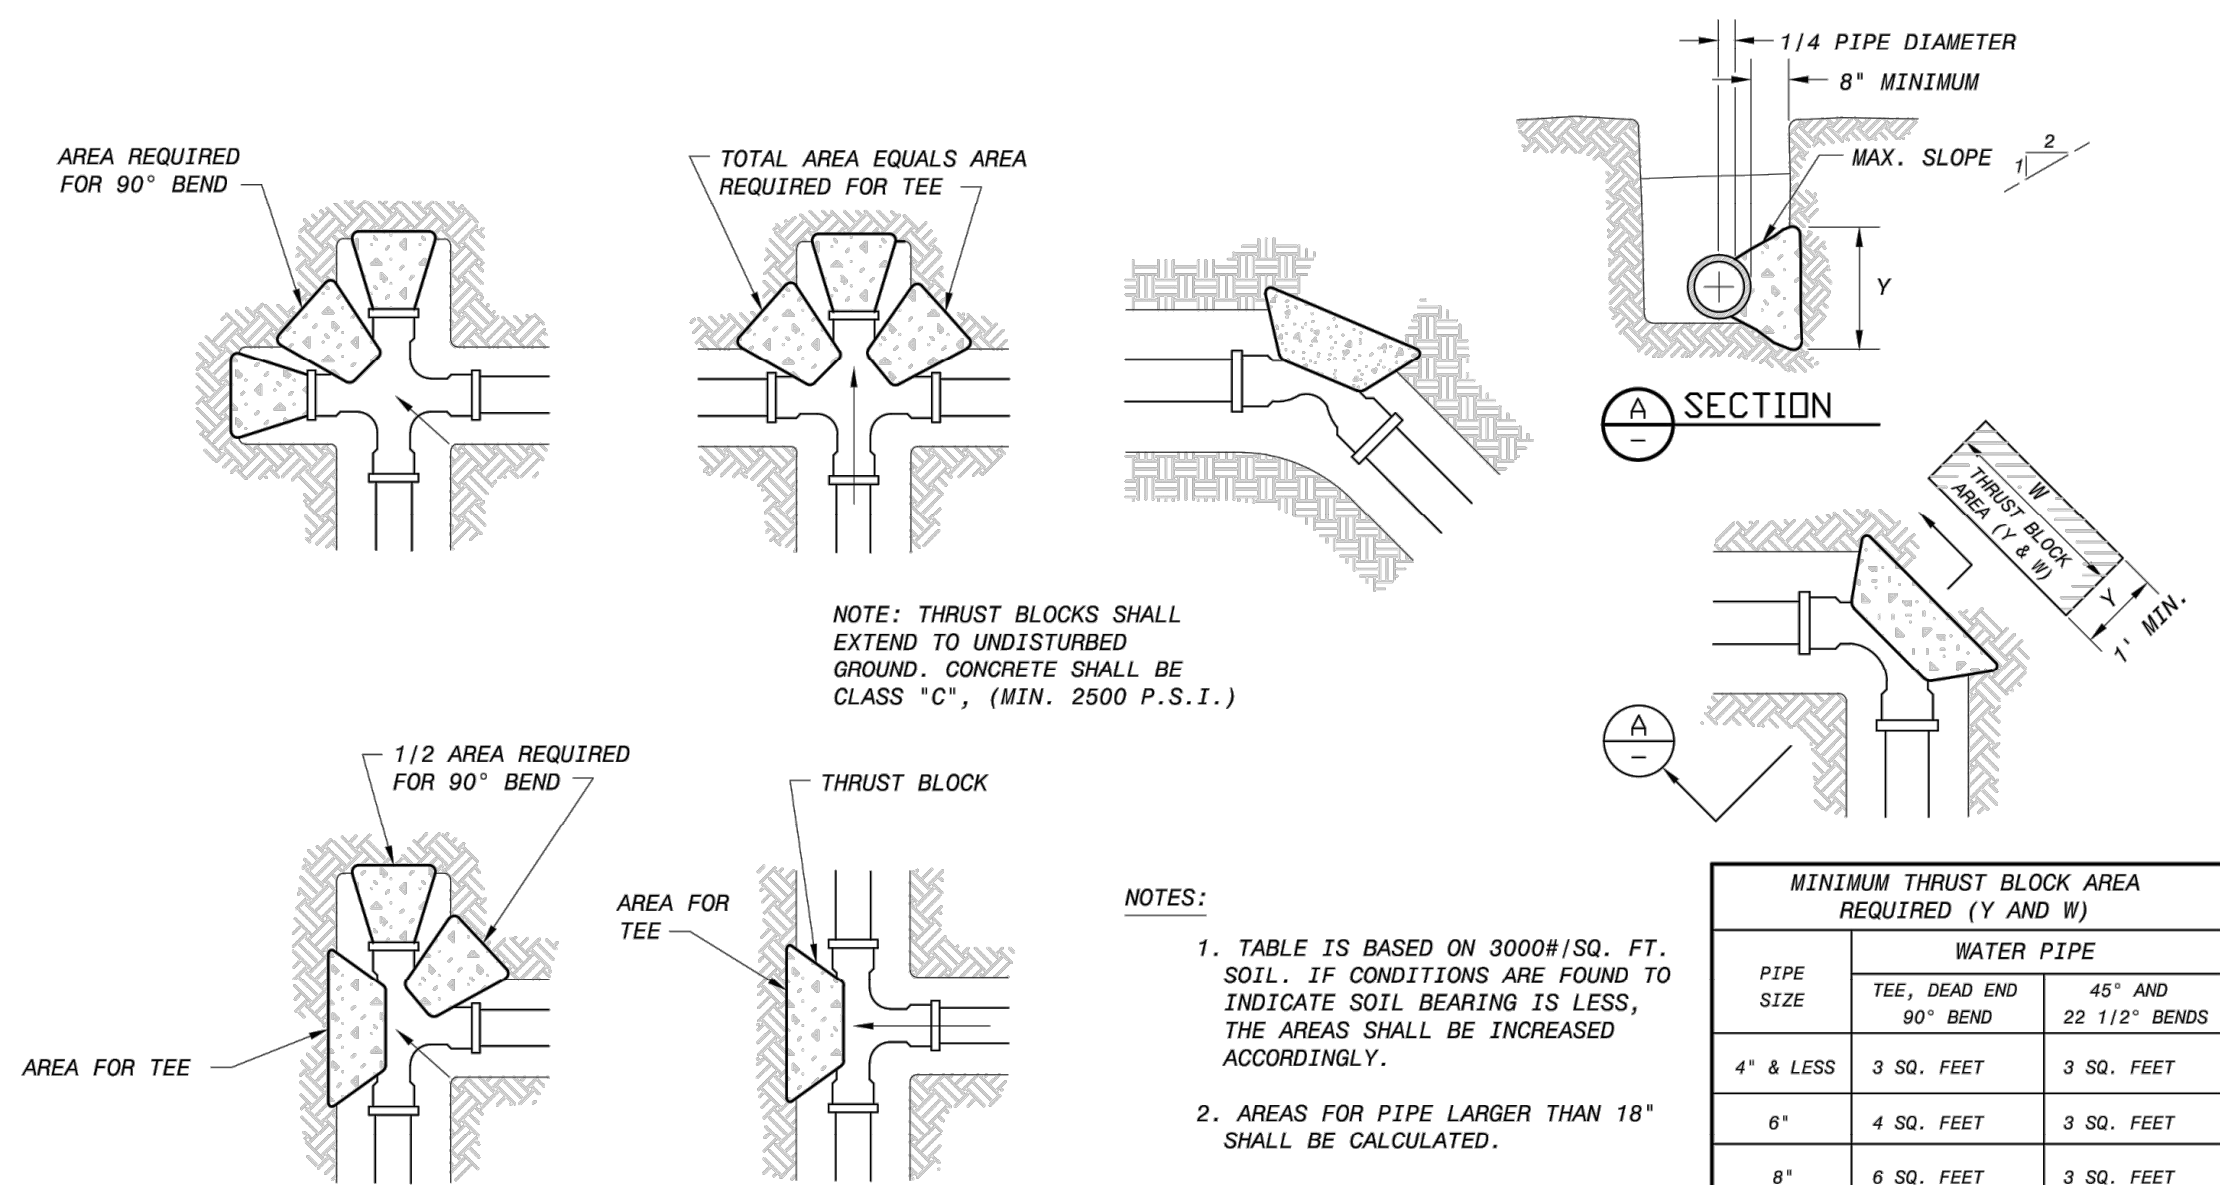


MINIMUM THRUST BLOCK AREA REQUIRED (Y AND W)		
PIPE SIZE	WATER PIPE	
	TEE, DEAD END 90° BEND	45° AND 22 1/2° BENDS
4" & LESS	3 SQ. FEET	3 SQ. FEET
6"	4 SQ. FEET	3 SQ. FEET
8"	6 SQ. FEET	3 SQ. FEET
10"	9 SQ. FEET	5 SQ. FEET
12"	13 SQ. FEET	7 SQ. FEET
16"	23 SQ. FEET	12 SQ. FEET
18"	29 SQ. FEET	15 SQ. FEET

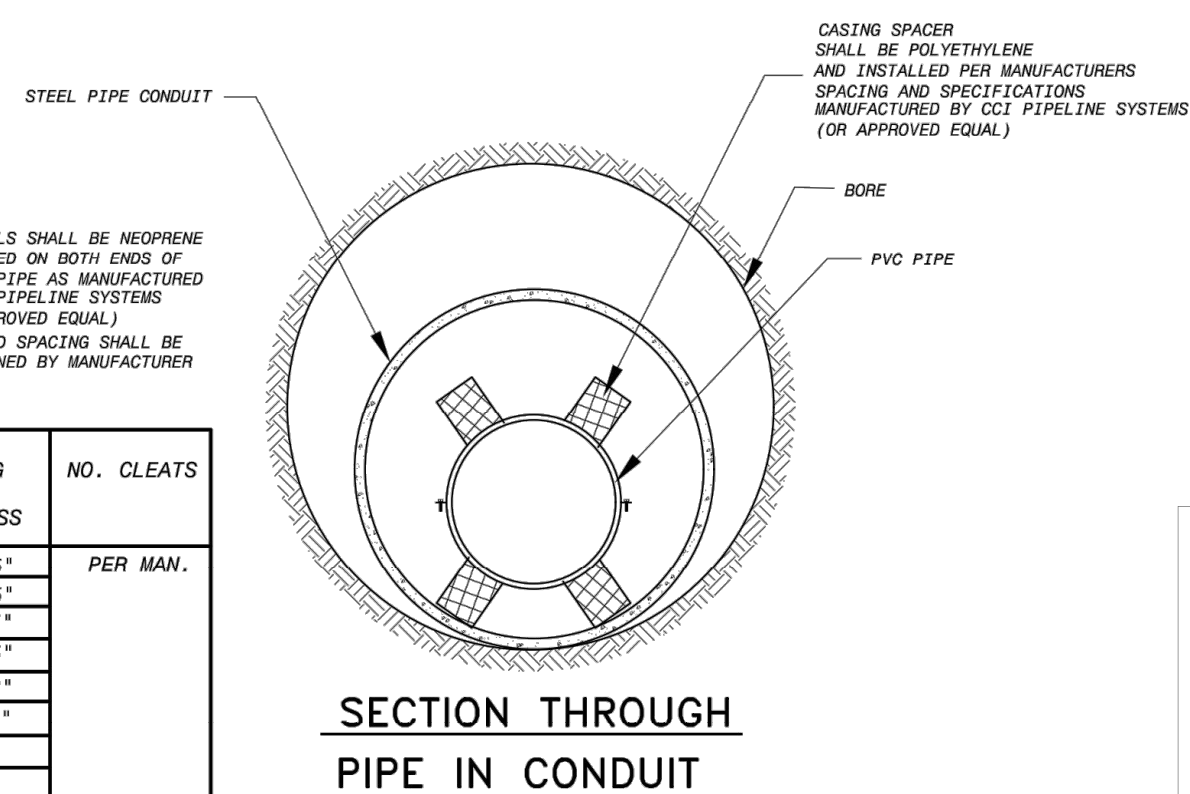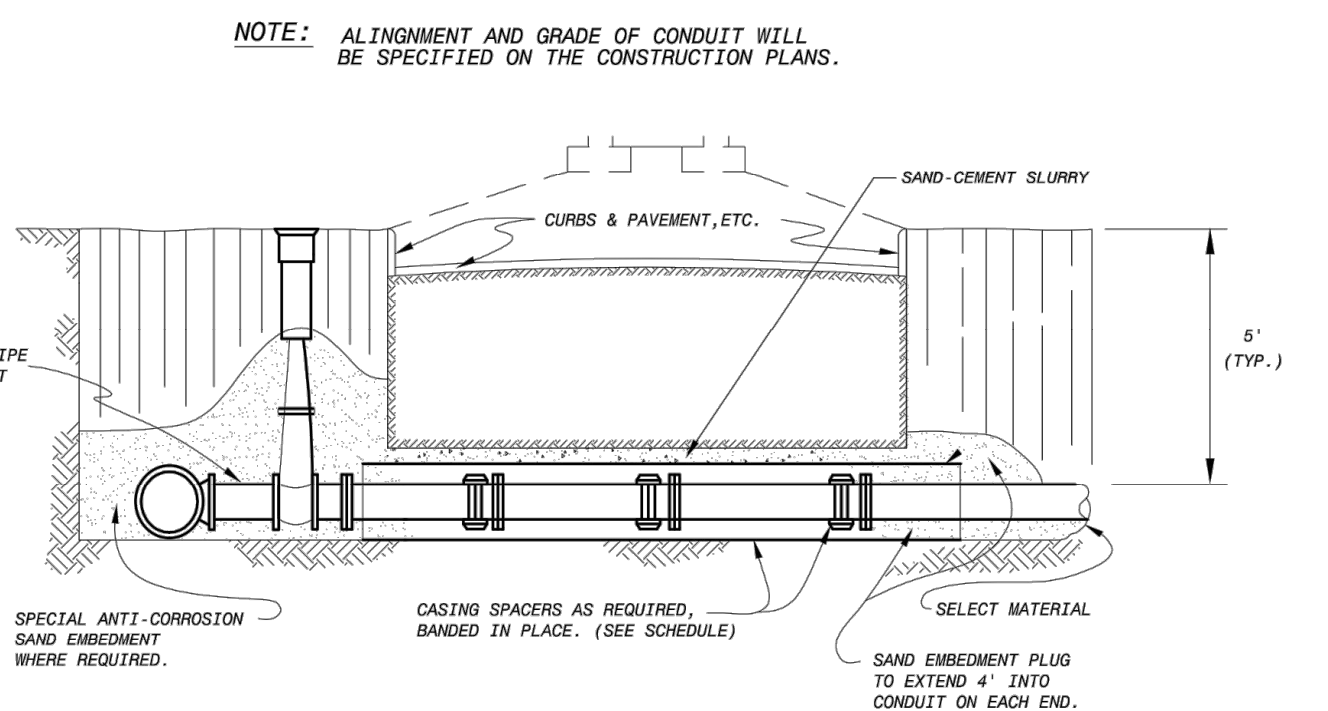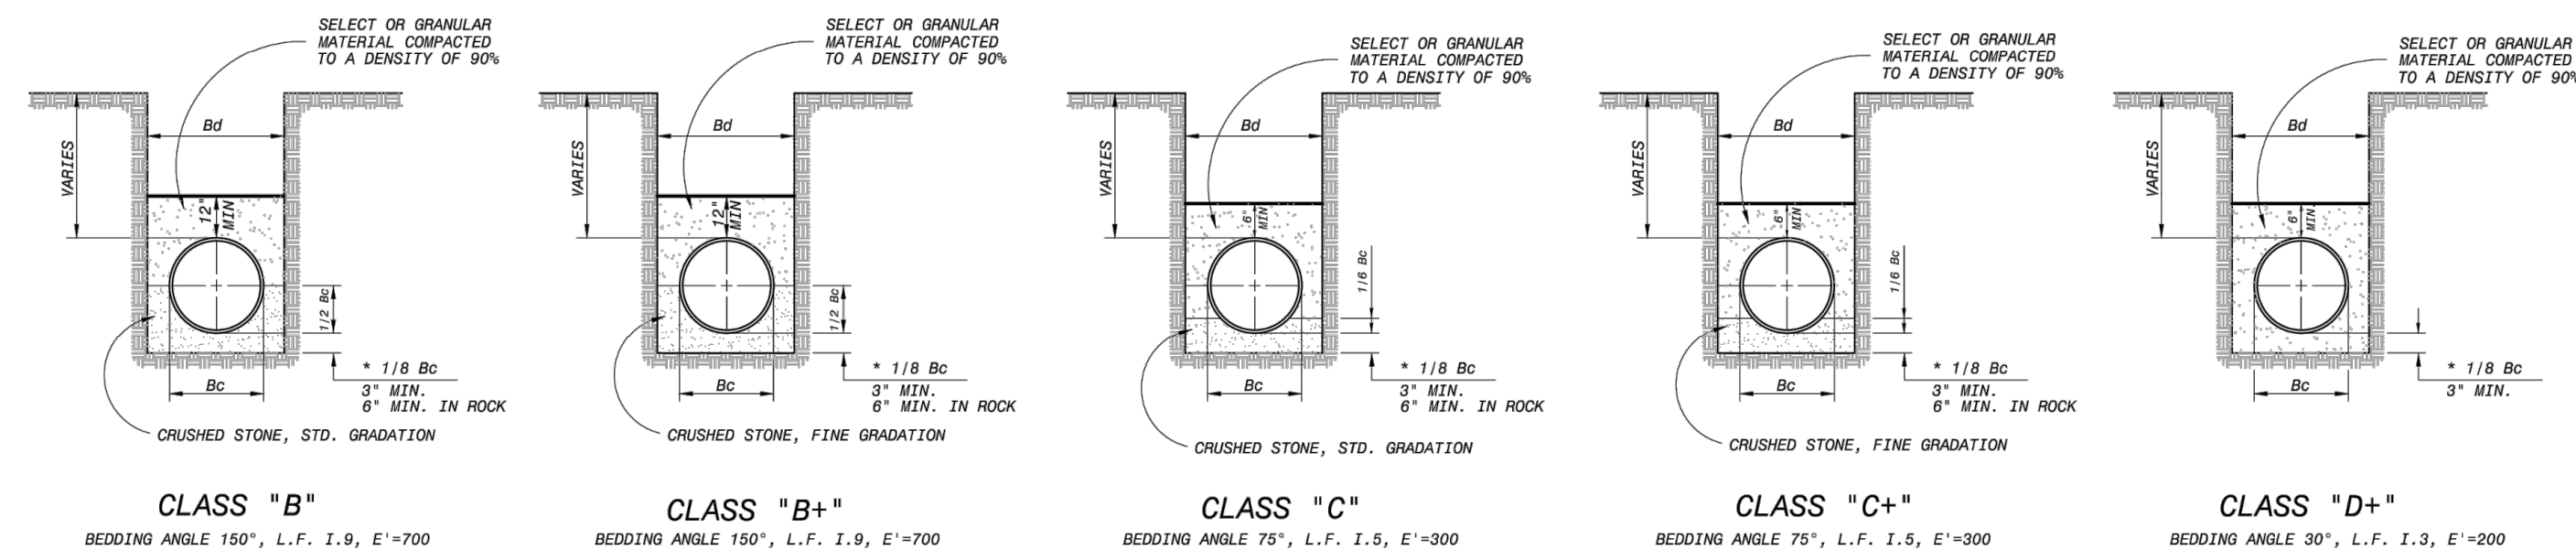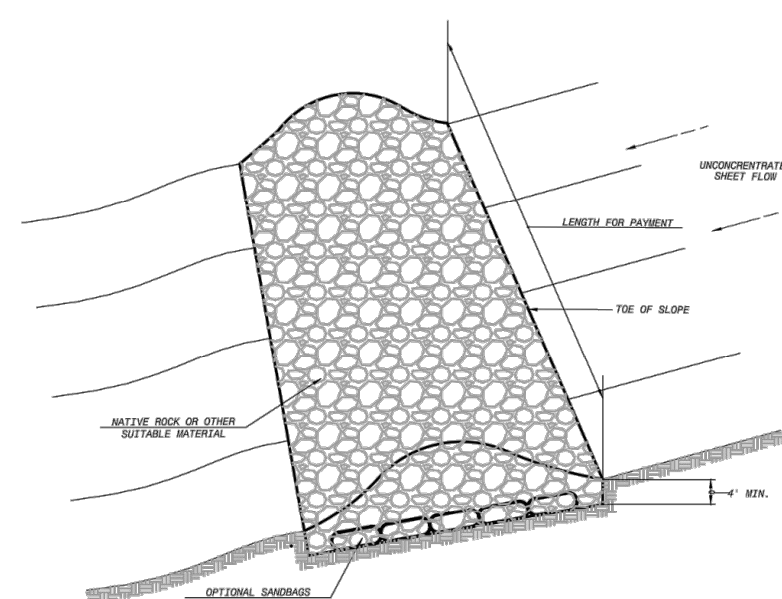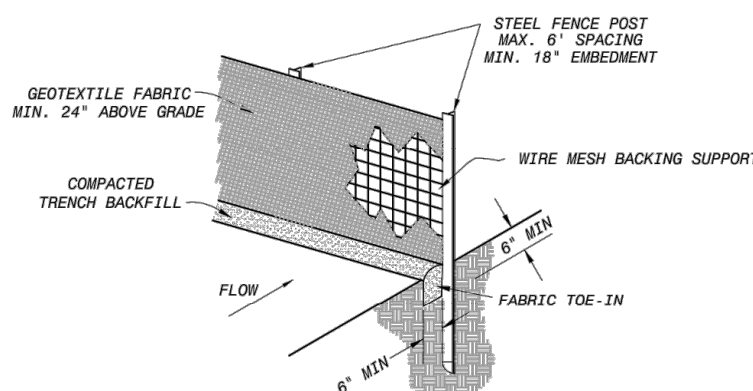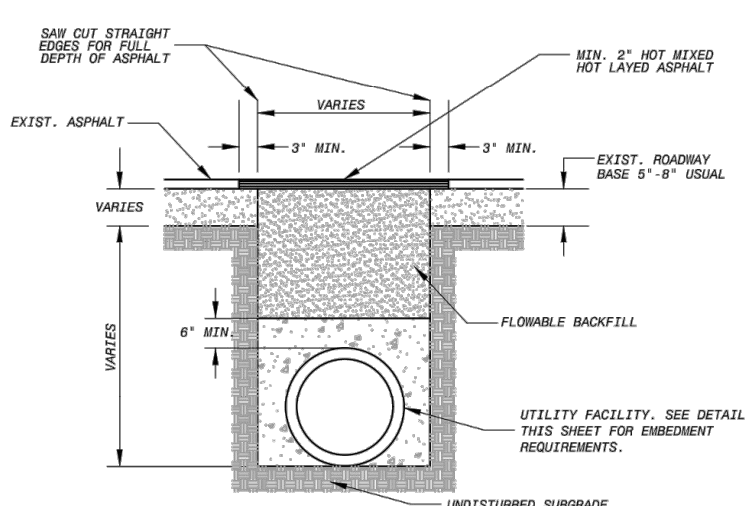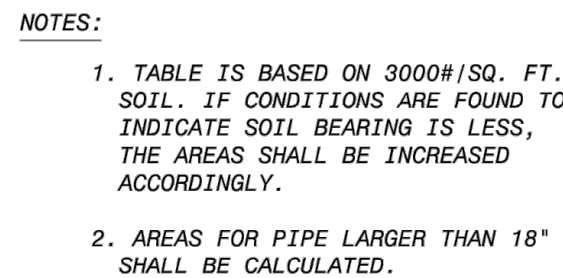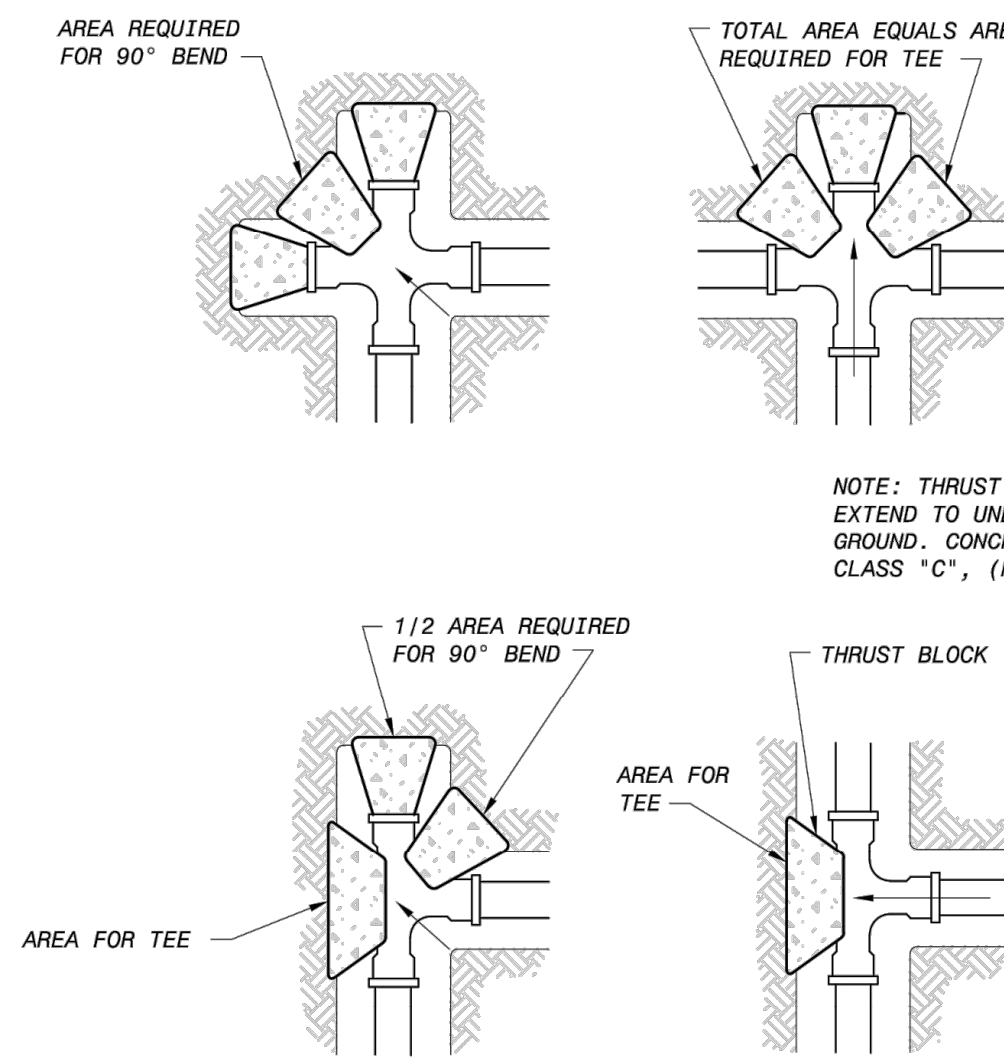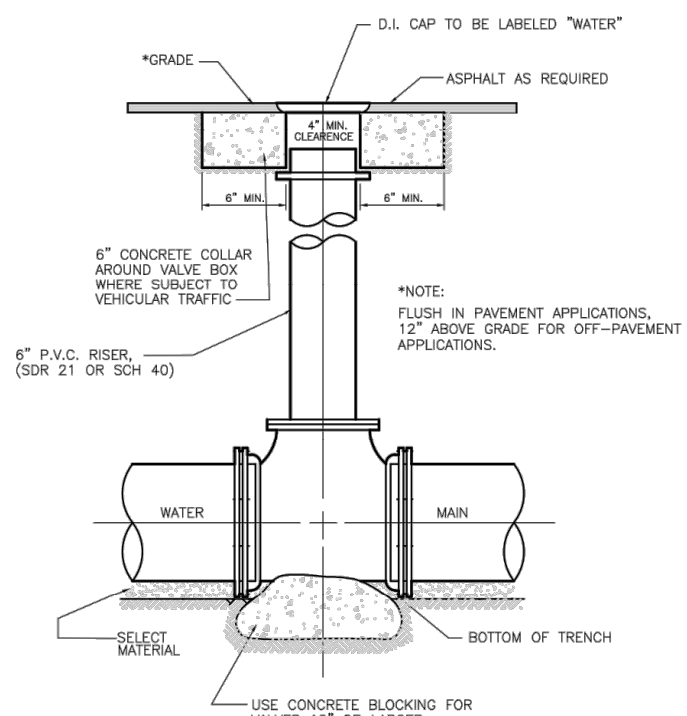
[illegible]

EMBEDMENT FOR WATER CONDUITS						
TYPE OF PIPE	IN EARTH			IN ROCK		
	0'-8"	8'-16"	>16"	0'-8"	8'-16"	>16"
ALL PVC WATER PIPE	C+	B+	B+	C+	B+	B+
16" AND SMALLER DUCTILE IRON WATER PIPE	D+	C	B	C	C	B
18" AND LARGER DUCTILE IRON WATER PIPE	B	B	B	B	B	B


EMBEDMENT DIMENSIONS			
PIPE DIAMETER (INCHES)	K/NO OF PIPE	EXTERNAL DIAMETER B _o (INCHES)	TRENCH WIDTH B ₁ (INCHES)
6"	PVC	6.90	24
6"	DI	6.90	24
8"	PVC	9.05	25
8"	DI	9.05	25
10"	PVC	11.10	27
10"	DI	11.10	27
12"	PVC	13.20	29
12"	DI	13.20	29
16"	DI	17.40	33
16"	DI	19.50	36
20"	DI	21.60	38

CARRIER PIPE SIZE	CASING PIPE SIZE	CASING PIPE THICKNESS	NO. CLEATS
6"	18"	0.375"	PER MAN.
8"	20"	0.375"	
12"	24"	0.375"	
16"	30"	0.375"	
20"	36"	0.438"	
24"	42"	0.438"	
30"	48"	1/2"	
36"	54"	9/16"	


	INSTALLATION OF NON-GEARED GATE VALVE WITH VALVE BOX AND EXTENSION	APPROVED JULY 2022	REVISED
	DET-828-01	SHEET 1 OF 1	

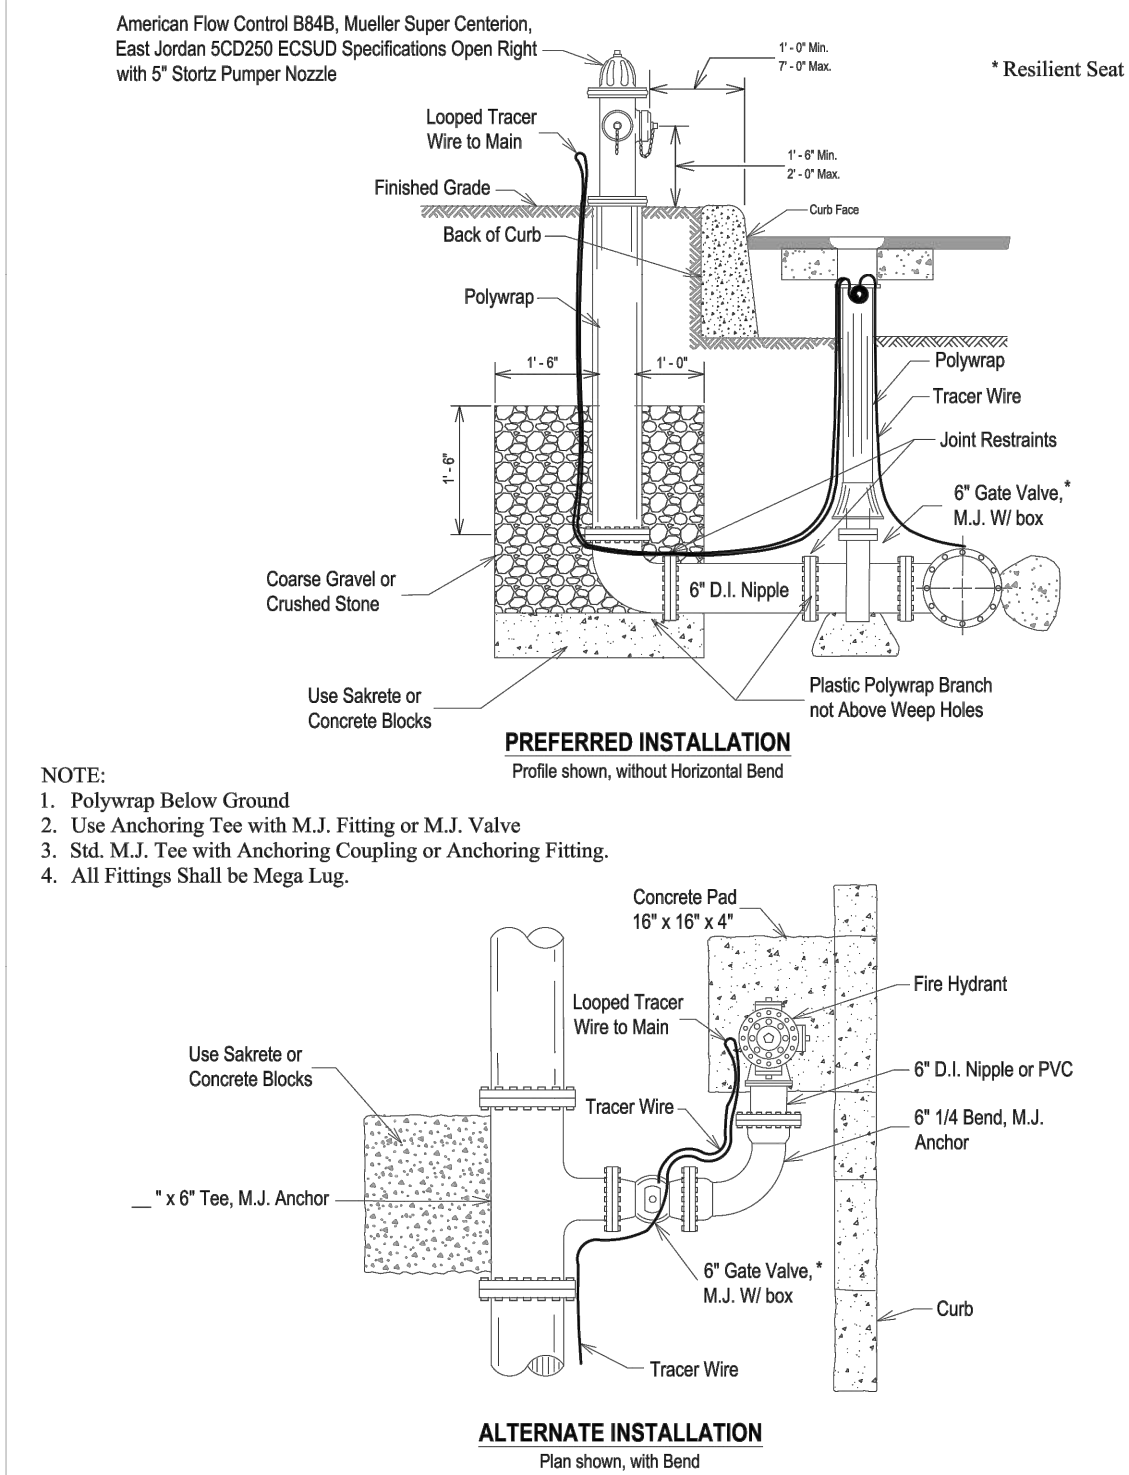


East Central OUR QUALITY IS YOURS	FIRE HYDRANT INSTALLATION		APPROVED JULY 2022	REVISED
	DET-834-01		SHEET 1 OF 1	

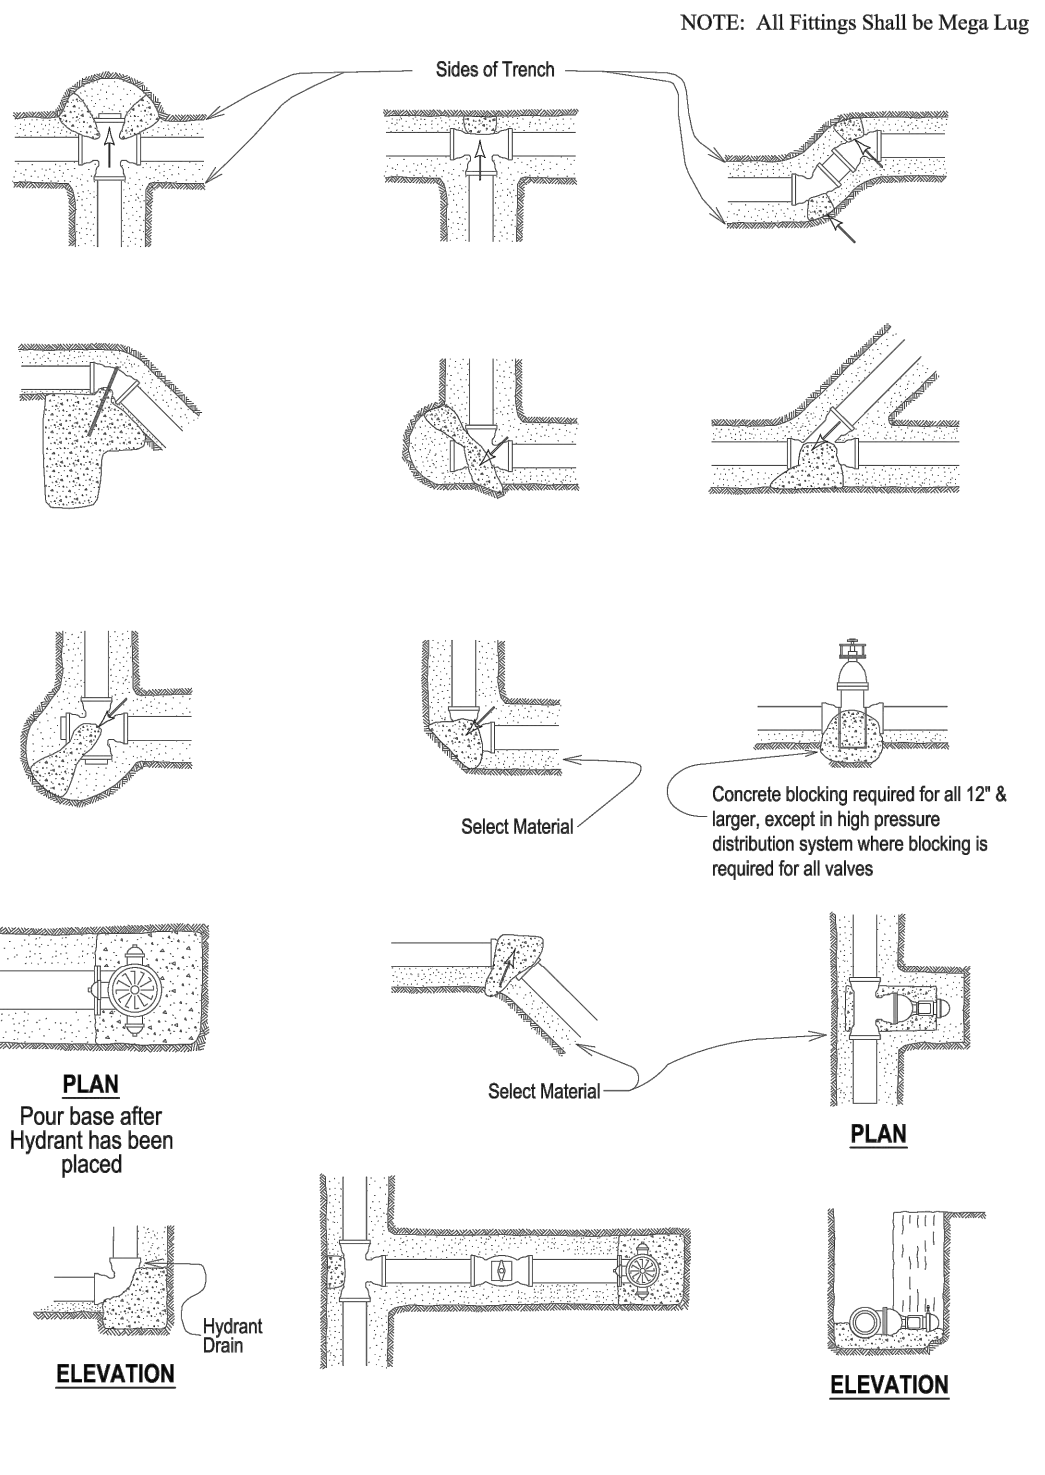


East Central OUR QUALITY IS YOURS	THRUST BLOCKS FOR FITTINGS (WATER ONLY)		APPROVED JULY 2022	REVISED
	DET-839-01		SHEET 1 OF 1	

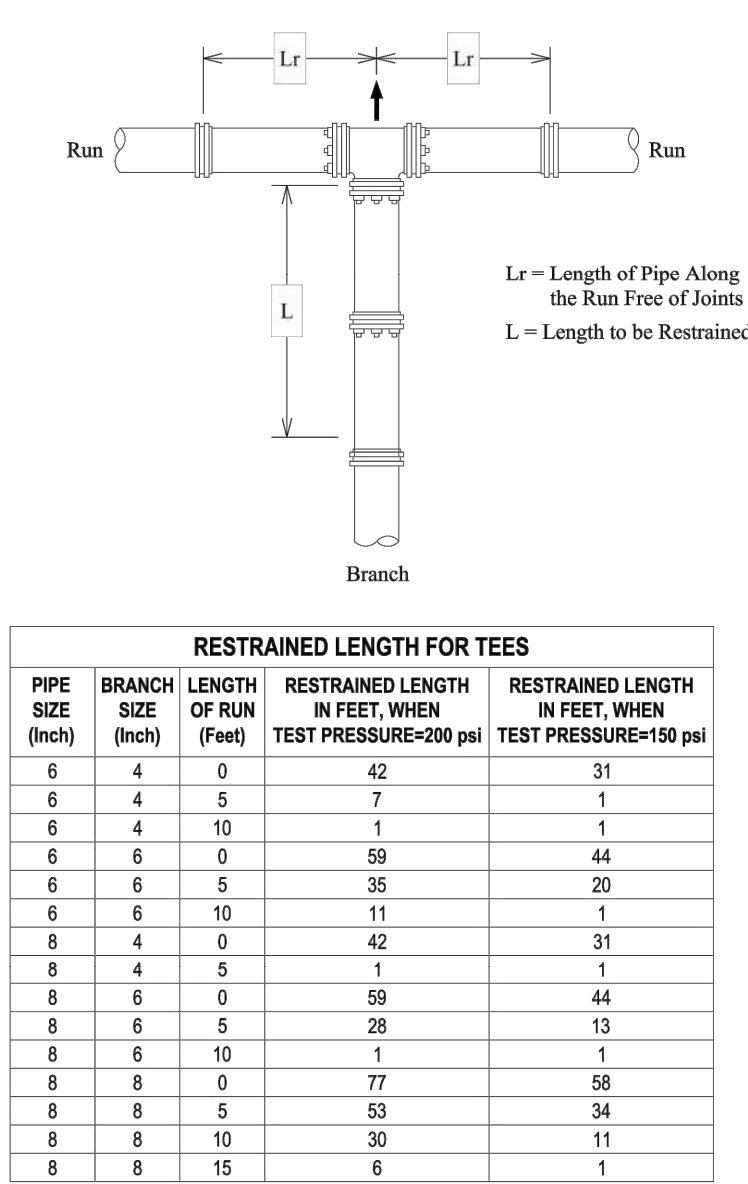


East Central OUR QUALITY IS YOURS	RESTRAINED LENGTHS FOR TEES		APPROVED MARCH 2020	REVISED
	DET-839-04		SHEET 1 OF 2	

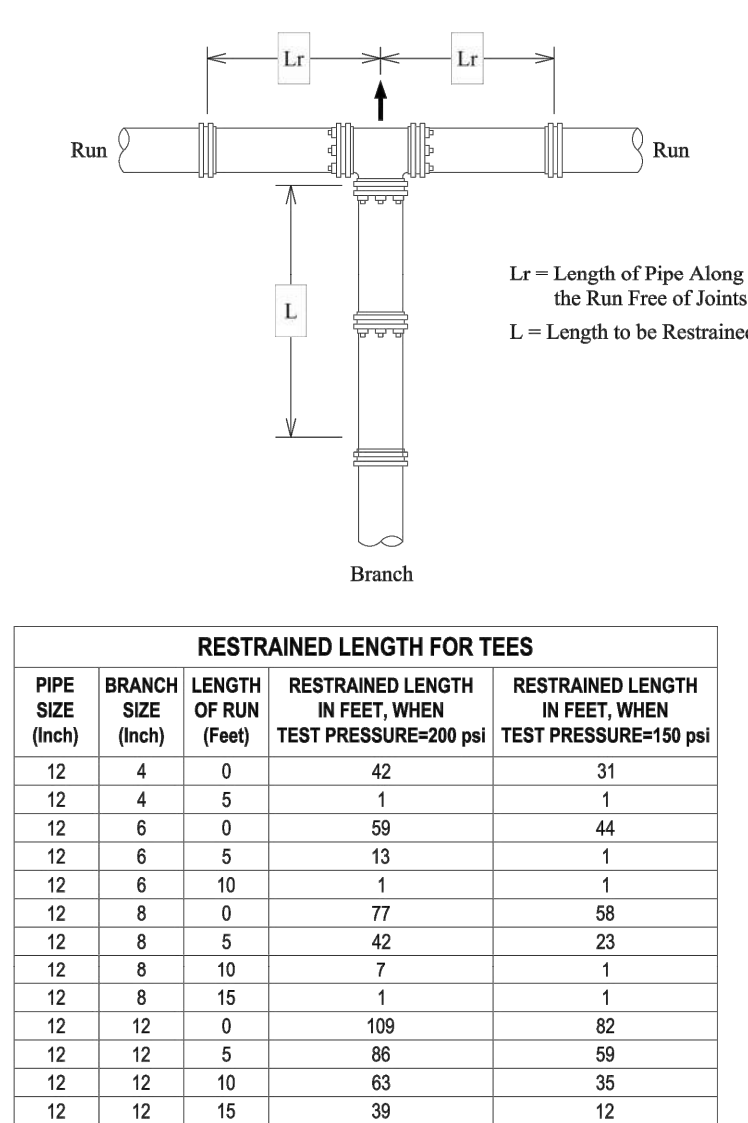


East Central OUR QUALITY IS YOURS	RESTRAINED LENGTHS FOR TEES		APPROVED MARCH 2020	REVISED
	DET-839-04		SHEET 2 OF 2	

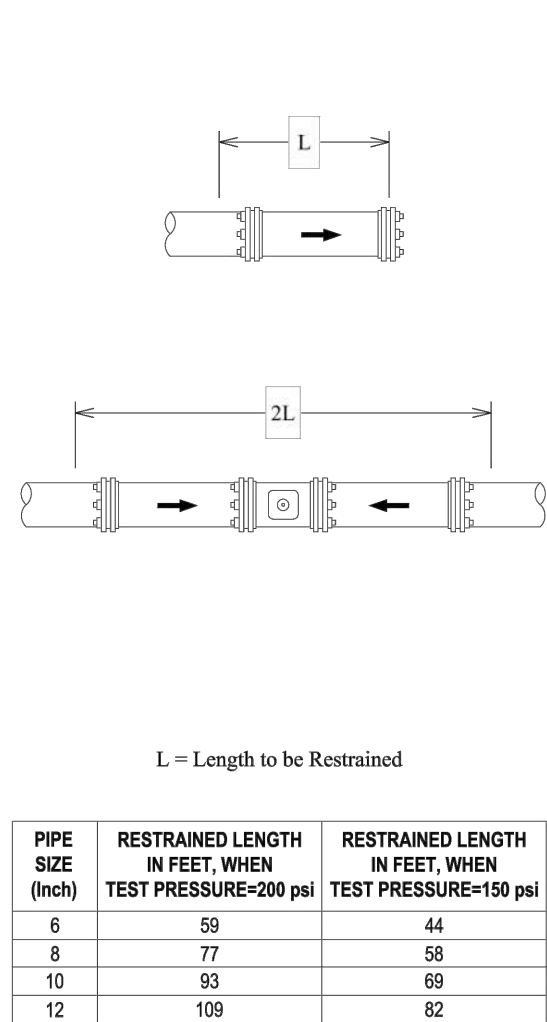


East Central OUR QUALITY IS YOURS	RESTRAINED LENGTHS FOR DEAD ENDS & INLINE VALVES		APPROVED JULY 2022	REVISED
	DET-839-05		SHEET 1 OF 1	

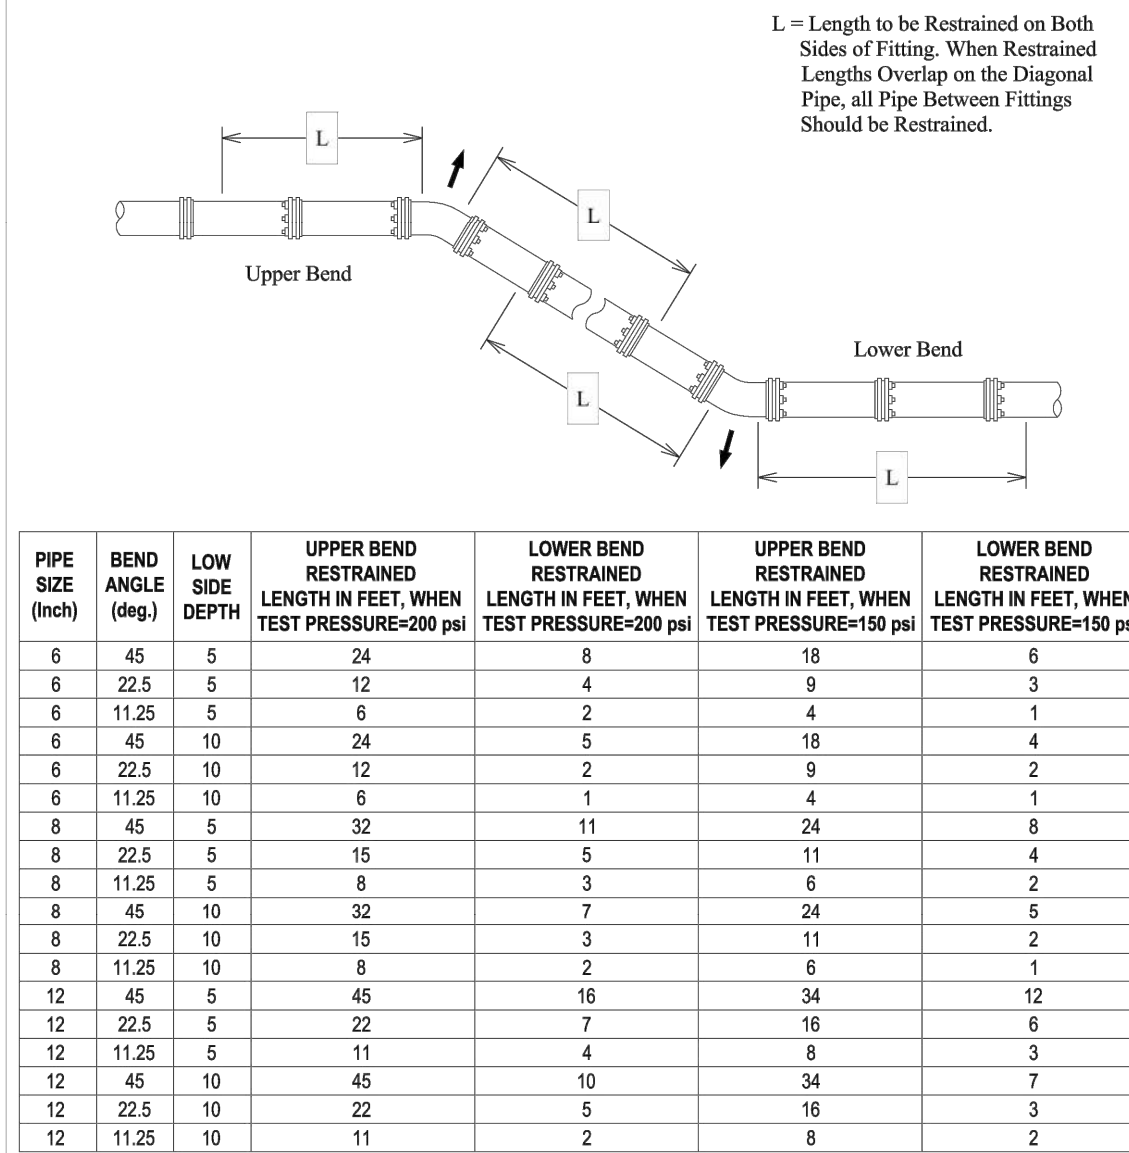


East Central OUR QUALITY IS YOURS	RESTRAINED LENGTHS VERTICAL OFFSETS		APPROVED JULY 2022	REVISED
	DET-839-06		SHEET 1 OF 1	

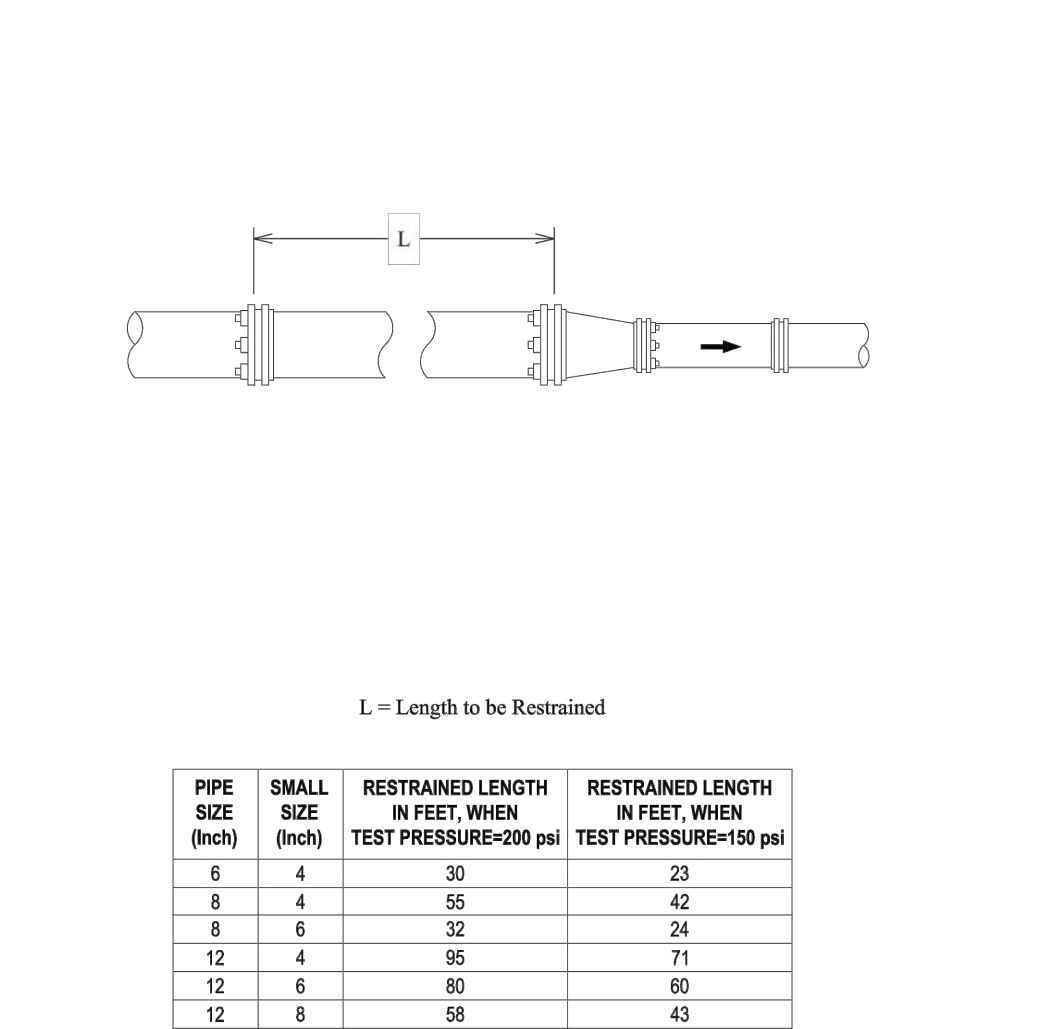


East Central OUR QUALITY IS YOURS	RESTRAINED LENGTHS FOR REDUCERS		APPROVED JULY 2022	REVISED
	DET-839-07		SHEET 1 OF 1	

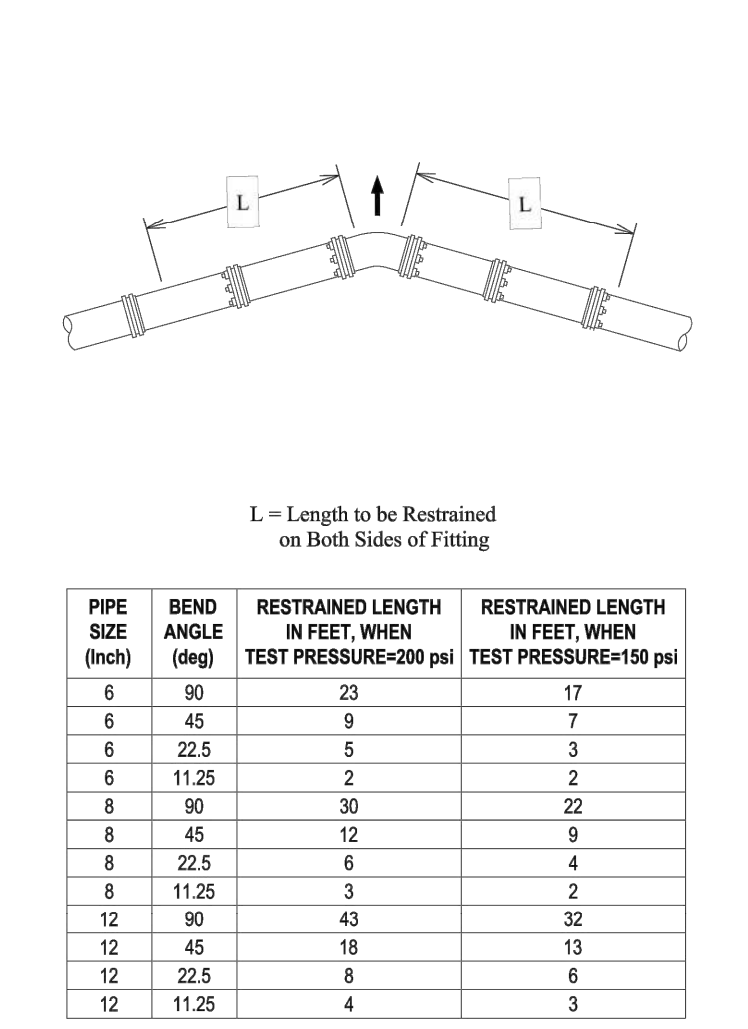

East Central OUR QUALITY IS YOURS	RESTRAINED LENGTHS FOR HORIZONTAL BENDS		APPROVED JULY 2022	REVISED
	DET-839-08		SHEET 1 OF 2	

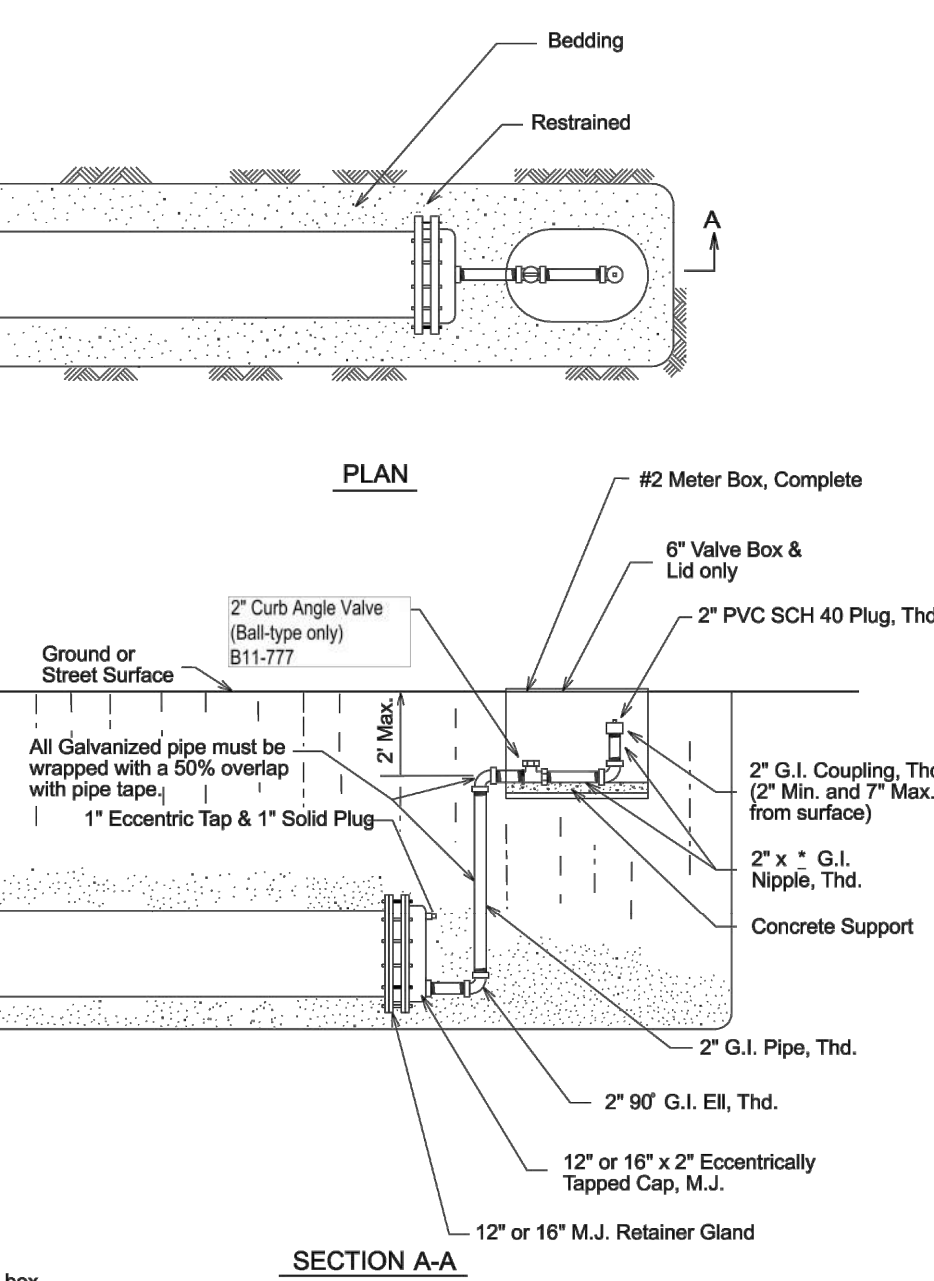

East Central OUR QUALITY IS YOURS	2\"/>
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East Central OUR QUALITY IS YOURS	2\"/>
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811 PROTECT YOURSELF ALL STATES REQUIRE NOTIFICATION OF EXCAVATIONS, DRIVERS OR ANY PERSON PREPARING TO DISTURB THE EARTH'S SURFACE ANYWHERE IN ANY STATE

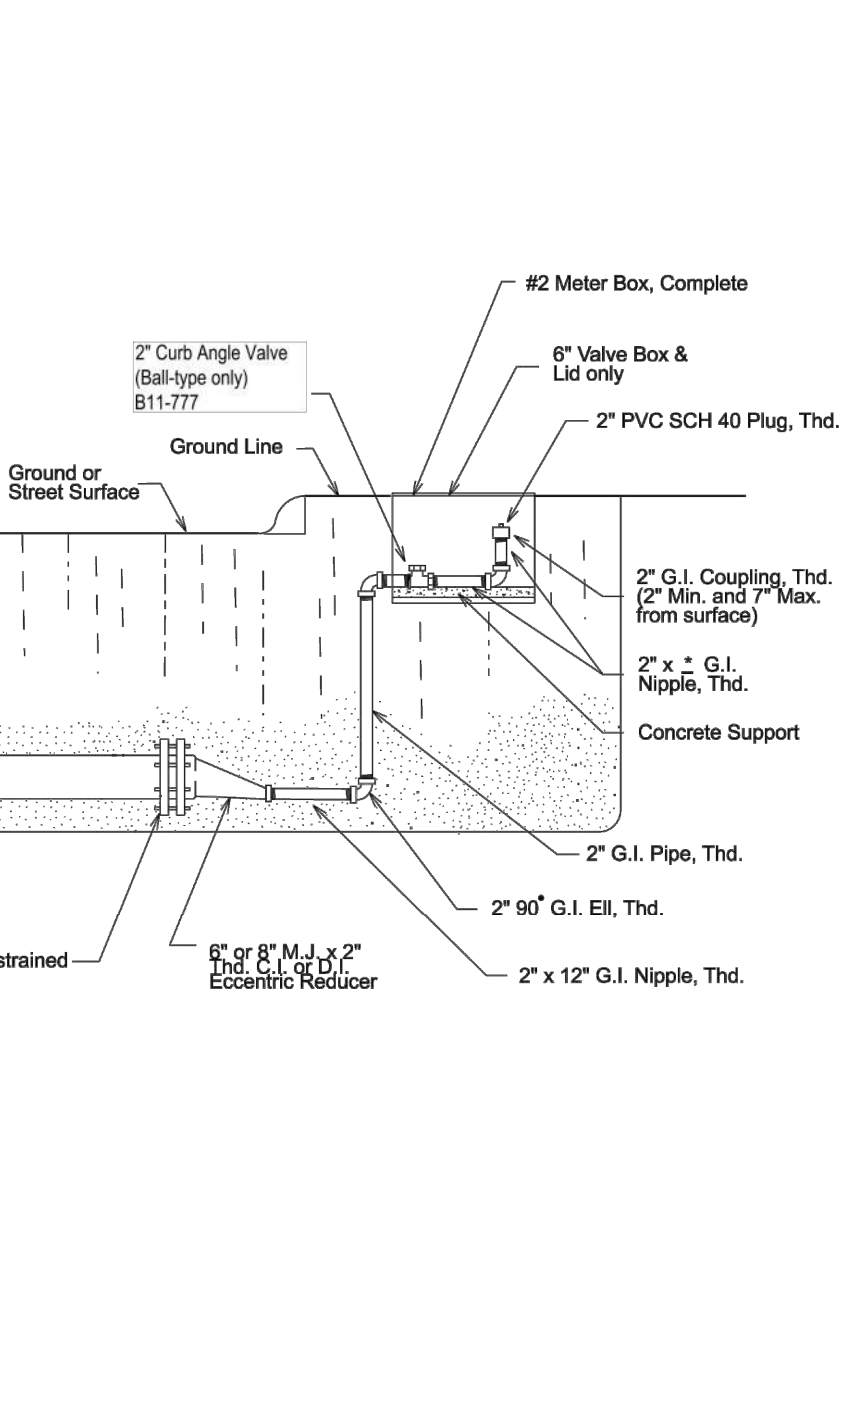FOR STATE SPECIFIC DIRECT PHONE NUMBERS VISIT: WWW.CALL811.COM

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DESCRIPTION

DRAWN BY

DATE

KEY

PRELIMINARY

FOR

SOUTHEAST MEADOWS UNIT 3

PLAT# 23- 11800440

SAN ANTONIO BEXAR COUNTY TEXAS

11/15/23

Engineering & Design

SCALE: AS SHOWN

PROJECT NUMBER: 205-43-07

SHEET TITLE: WATER DISTRIBUTION DETAILS

SHEET NUMBER: 7.5

DATE: 07/20/2023

DRAWING NAME: CWD205-43-07

DRAWN BY: SD

CHECKED BY: SC

TRENCH EXCAVATION SAFETY PROTECTION

CONTRACTOR AND/OR CONTRACTORS INDEPENDENTLY RETAINED EMPLOYEE OR STRUCTURAL DESIGN/GEOTECHNICAL/SAFETY/EQUIPMENT CONSULTANT, IF ANY, SHALL REVIEW THESE PLANS AND ANY AVAILABLE GEOTECHNICAL INFORMATION AND THE ANTICIPATED INSTALLATION SITES WITHIN THE PROJECT WORK AREA IN ORDER TO IMPLEMENT CONTRACTOR'S TRENCH EXCAVATION SAFETY PROTECTION SYSTEMS, PROGRAMS AND/OR PROCEDURES FOR THE PROJECT DESCRIBED IN THE CONTRACT DOCUMENTS. THE CONTRACTOR'S IMPLEMENTATION OF THESE SYSTEMS, PROGRAMS AND/OR PROCEDURES SHALL PROVIDE FOR ADEQUATE TRENCH EXCAVATION SAFETY PROTECTION THAT COMPLY WITH AS A MINIMUM, OSHA STANDARDS FOR TRENCH EXCAVATIONS. SPECIFICALLY, CONTRACTOR AND/OR CONTRACTOR'S INDEPENDENTLY RETAINED EMPLOYEE OR SAFETY CONSULTANT SHALL IMPLEMENT A TRENCH SAFETY PROGRAM IN ACCORDANCE WITH OSHA STANDARDS GOVERNING THE PRESENCE AND ACTIVITIES OF INDIVIDUALS WORKING IN AND AROUND TRENCH EXCAVATION.

COMPACTION NOTE:

THE CONTRACTOR SHALL BE RESPONSIBLE FOR MEETING 98% COMPACTION ON ALL TRENCH BACKFILL AND PAYING FOR THE TESTS TO BE PERFORMED BY A THIRD PARTY. COMPACTION TESTS WILL BE DONE AT ONE LOCATION POINT RANDOMLY SELECTED OR AS INDICATED BY THE SAWS INSPECTOR/TEST ADMINISTRATOR, PER EACH 12 INCH LOOSE LIFT PER 400 LINEAR FEET AT A MINIMUM. PERMITS AND/OR WILL NOT BE ACCEPTED AND FINALIZED BY SAWS WITHOUT THIS REQUIREMENT BEING MET AND VERIFIED BY PROVIDING ALL NECESSARY DOCUMENTED TEST RESULTS.

DRY UTILITY CONDUIT NOTE:


CONDUIT LOCATIONS SHOWN ON PLAN ARE FOR GEOGRAPHICAL PURPOSES ONLY AND ARE APPROXIMATE. CONTRACTOR TO INSTALL PROPOSED CONDUITS IN ACCORDANCE WITH DRY UTILITY PURVEYOR'S SPECIFICATIONS. CONTRACTOR TO VERIFY THE CONDUIT LOCATIONS AND SIZES BASED ON THE DRY UTILITY PURVEYOR'S PLAN.

PROJECT COMPLETION:

- ALL DISTURBED AREAS ARE NOT COVERED BY IMPERVIOUS COVER ARE TO BE STABILIZED PER THE SWPPP AND PROJECT SPECIFICATIONS PRIOR TO REMOVAL OF ANY BMP'S AND/OR PRIOR TO FILING A NOTICE OF TERMINATION (NOT).
- BEST MANAGEMENT PRACTICES MAY BE REMOVED IN PHASES IF ALL UPGRADIENT AREAS HAVE BEEN STABILIZED PER SWPPP AND PROJECT SPECIFICATIONS. THIS PHASING SHOULD BE NOTED WITHIN THE MODIFICATIONS SECTION WITH THE SIGNATURE AND DATE OF THE RESPONSIBLE PARTY.
- CONTRACTOR TO ENSURE THEY HAVE MET ALL REQUIREMENTS OF THE SWPPP BEFORE FILING A NOTICE OF TERMINATION (NOT).


GENERAL:

- THIS EXHIBIT IS TO BE USED FOR THE PURPOSES OF STORMWATER POLLUTION PREVENTION ONLY. ALL OTHER CIVIL ENGINEERING INFORMATION SHOULD BE OBTAINED FROM THE APPROPRIATE CONSTRUCTION DOCUMENTS.
- THE PURPOSE OF THE SIGNATURE AND SEAL OF THE ENGINEER ON THIS DOCUMENT IS TO DEMONSTRATE COMPLIANCE WITH THE TYPES STORMWATER POLLUTION PREVENTION PLAN REGULATIONS ONLY.
- ALL OWNERS/OPERATORS ARE RESPONSIBLE FOR FAMILIARIZING THEMSELVES WITH THE STORMWATER POLLUTION PREVENTION PLAN AND COMPLYING WITH THE REGULATIONS CONTAINED WITHIN IT.

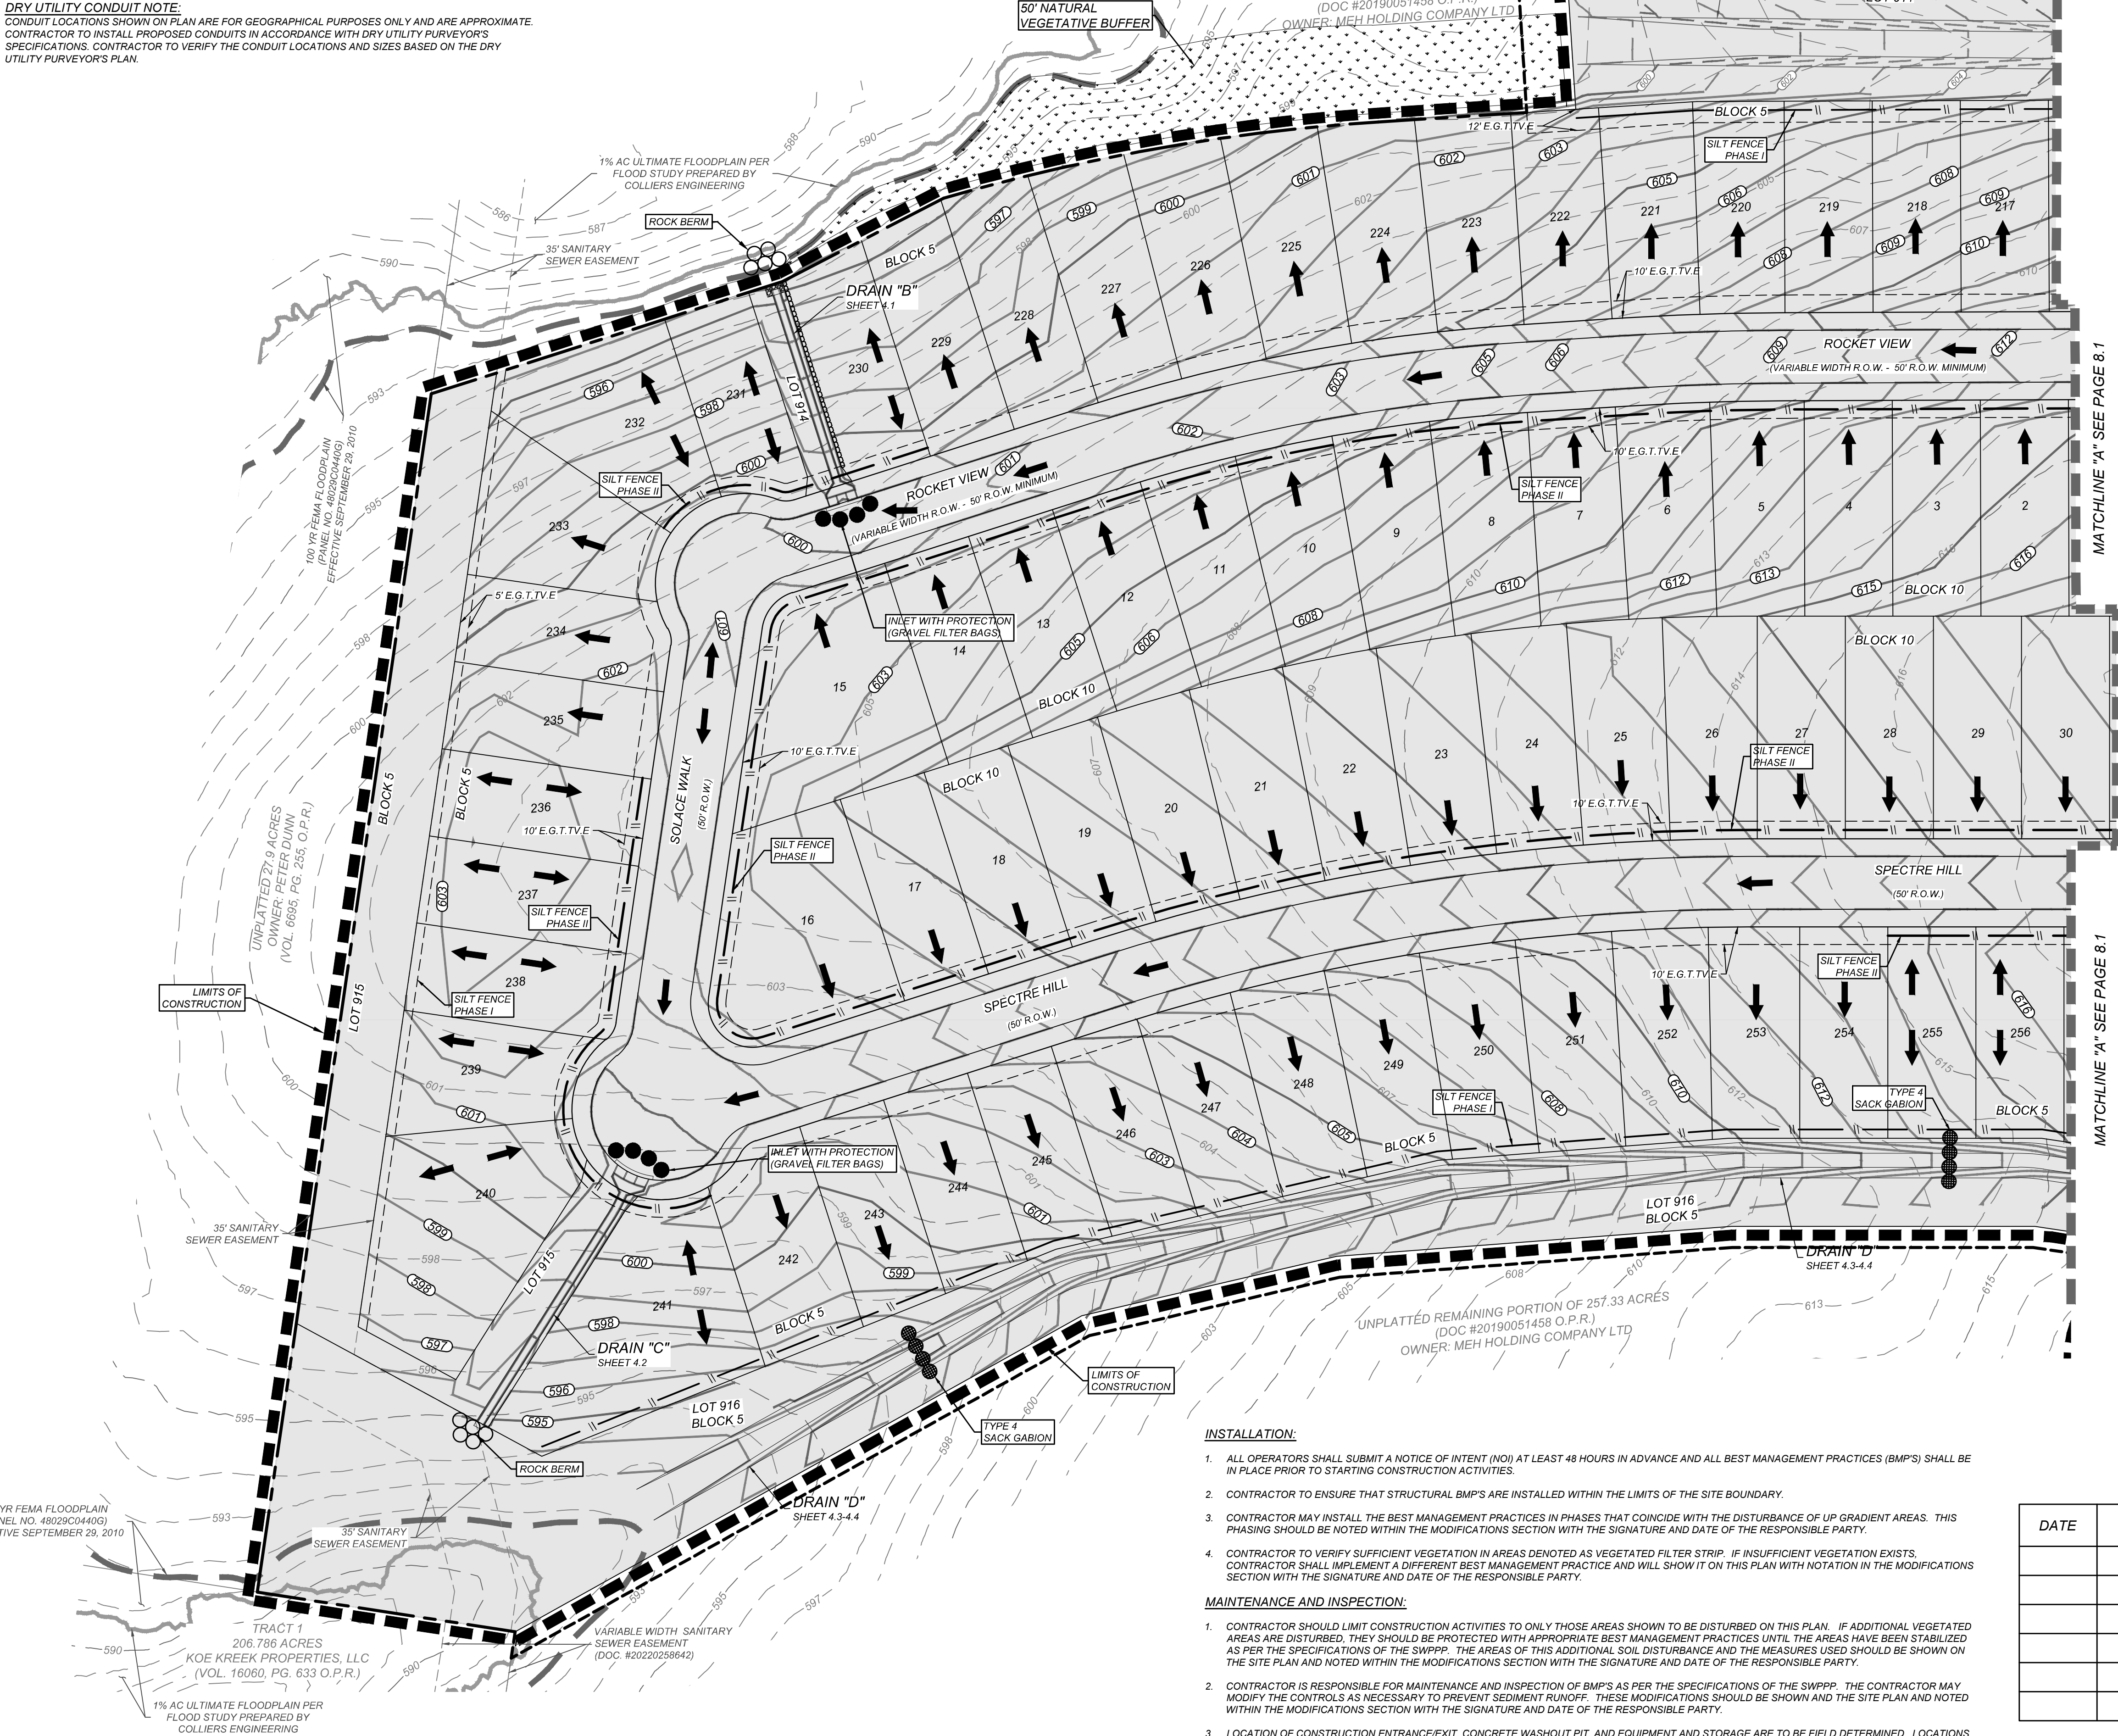


BEXAR COUNTY R.O.W. NOTE:

A BEXAR COUNTY PERMIT MUST BE OBTAINED BEFORE WORKING IN BEXAR COUNTY R.O.W.

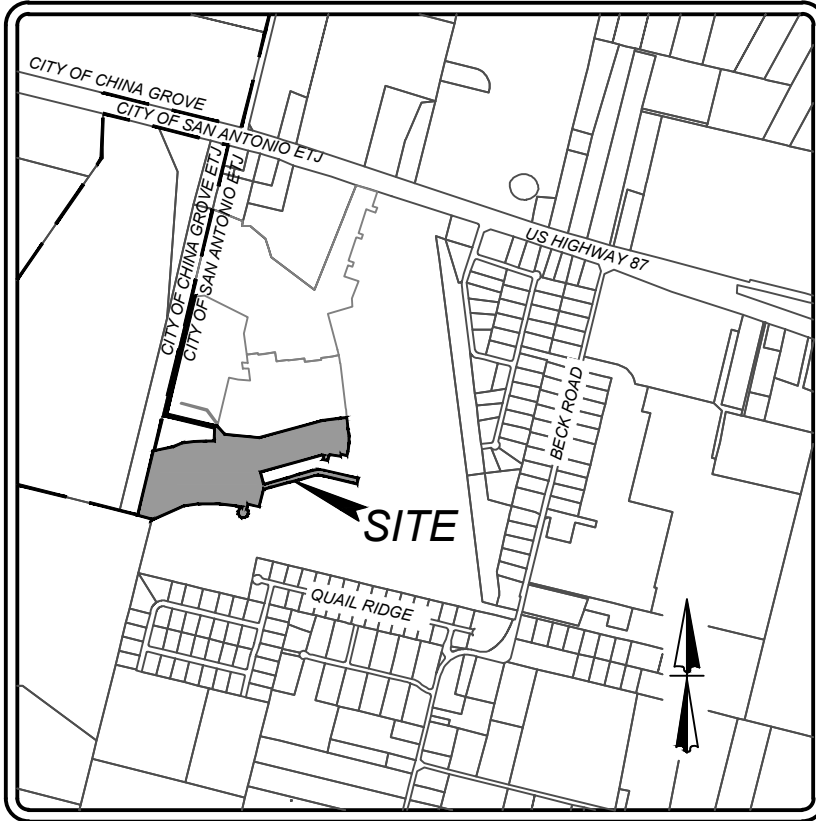

LOCATION MAP NOT-TO-SCALE

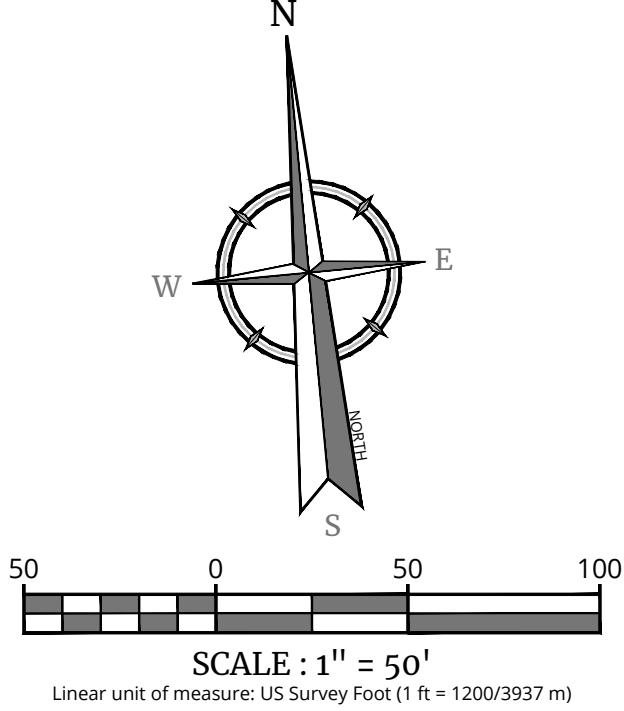

LEGEND

- 680 EXISTING CONTOURS
- 680 PROPOSED CONTOURS
- LIMITS OF CONSTRUCTION
- FLOW ARROW
- STABILIZED CONSTRUCTION ENTRANCE/EXIT
- CONSTRUCTION EQUIPMENT, VEHICLE & MATERIALS STORAGE AREA
- CONCRETE TRUCK WASHOUT PIT
- DISTURBED AREA
- ROCK BERM
- SILT FENCE
- NATURAL VEGETATIVE BUFFER
- INLET WITH PROTECTION (GRAVEL FILTER BAGS)
- EARTHEN CHECK BERM

COORDINATION NOTE:

- CONTACT TIME WARNER TO COORDINATE CABLE TV SERVICE. (210) 244-0500
- CONDUIT FOR ELECTRICAL SERVICE. CONFIRM REQUIREMENTS AND COORDINATE WITH CPS FOR INSPECTION. (210) 353-2246
- CONTACT AT&T TO COORDINATE TELEPHONE SERVICE. 1-800-449-7928
- CONTRACTOR TO COORDINATE WITH CPS PRIOR TO CONSTRUCTION TO PLAN ELECTRIC SERVICE.
- CONTRACTOR TO COORDINATE WITH SAWS TO PLAN WATER AND SANITARY SEWER SERVICES (210) 704-7297
- CONTRACTOR SHALL CONTACT 1-800-DIG-TESS A MINIMUM OF 48 HOURS PRIOR TO THE START OF CONSTRUCTION.

SW3P MODIFICATIONS

DATE	SIGNATURE	DESCRIPTION

INSTALLATION:

- ALL OPERATORS SHALL SUBMIT A NOTICE OF INTENT (NOI) AT LEAST 48 HOURS IN ADVANCE AND ALL BEST MANAGEMENT PRACTICES (BMP'S) SHALL BE IN PLACE PRIOR TO STARTING CONSTRUCTION ACTIVITIES.
- CONTRACTOR TO ENSURE THAT STRUCTURAL BMP'S ARE INSTALLED WITHIN THE LIMITS OF THE SITE BOUNDARY.
- CONTRACTOR MAY INSTALL THE BEST MANAGEMENT PRACTICES IN PHASES THAT COINCIDE WITH THE DISTURBANCE OF UP GRADIENT AREAS. THIS PHASING SHOULD BE NOTED WITHIN THE MODIFICATIONS SECTION WITH THE SIGNATURE AND DATE OF THE RESPONSIBLE PARTY.
- CONTRACTOR TO VERIFY SUFFICIENT VEGETATION IN AREAS DENOTED AS VEGETATED FILTER STRIP. IF INSUFFICIENT VEGETATION EXISTS, CONTRACTOR SHALL IMPLEMENT A DIFFERENT BEST MANAGEMENT PRACTICE AND WILL SHOW IT ON THIS PLAN WITH NOTATION IN THE MODIFICATIONS SECTION WITH THE SIGNATURE AND DATE OF THE RESPONSIBLE PARTY.

MAINTENANCE AND INSPECTION:

- CONTRACTOR SHOULD LIMIT CONSTRUCTION ACTIVITIES TO ONLY THOSE AREAS SHOWN TO BE DISTURBED ON THIS PLAN. IF ADDITIONAL VEGETATED AREAS ARE DISTURBED, THEY SHOULD BE PROTECTED WITH APPROPRIATE BEST MANAGEMENT PRACTICES UNTIL THE AREAS HAVE BEEN STABILIZED AS PER THE SPECIFICATIONS OF THE SWPPP. THE AREAS OF THIS ADDITIONAL SOIL DISTURBANCE AND THE MEASURES USED SHOULD BE SHOWN ON THE SITE PLAN AND NOTED WITHIN THE MODIFICATIONS SECTION WITH THE SIGNATURE AND DATE OF THE RESPONSIBLE PARTY.
- CONTRACTOR IS RESPONSIBLE FOR MAINTENANCE AND INSPECTION OF BMP'S AS PER THE SPECIFICATIONS OF THE SWPPP. THE CONTRACTOR MAY MODIFY THE CONTROLS AS NECESSARY TO PREVENT SEDIMENT RUNOFF. THESE MODIFICATIONS SHOULD BE SHOWN AND THE SITE PLAN AND NOTED WITHIN THE MODIFICATIONS SECTION WITH THE SIGNATURE AND DATE OF THE RESPONSIBLE PARTY.
- LOCATION OF CONSTRUCTION ENTRANCE/EXIT, CONCRETE WASHOUT PIT, AND EQUIPMENT AND STORAGE ARE TO BE FIELD DETERMINED. LOCATIONS SHALL BE UPDATED ON THIS PLAN.

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Formerly Known as

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FOR STATE SPECIFIC DIRECT PHONE NUMBERS VISIT: WWW.CALL811.COM



PRELIMINARY

FOR
SOUTHEAST
MEADOWS UNIT 3
PLAT# 23-11800440

SAN ANTONIO
BEXAR COUNTY
TEXAS



Engineering & Design


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Parkway
San Antonio, TX 78231
Phone: 210.979.8444
COLLIERS ENGINEERING & DESIGN, INC.
TBP'S Form # 1-1409
TBP'S Form # 10194550

SCALE: AS SHOWN
DATE: 07/20/2023
DRAWN BY: SD
CHECKED BY: SC
PROJECT NUMBER: 205-43-07
DRAWING NAME: SW3P2054307

SHEET TITLE: STORMWATER POLLUTION PREVENTION PLAN

SHEET NUMBER: 8.0

NOTE: DO NOT SCALE DRAWINGS FOR CONSTRUCTION.

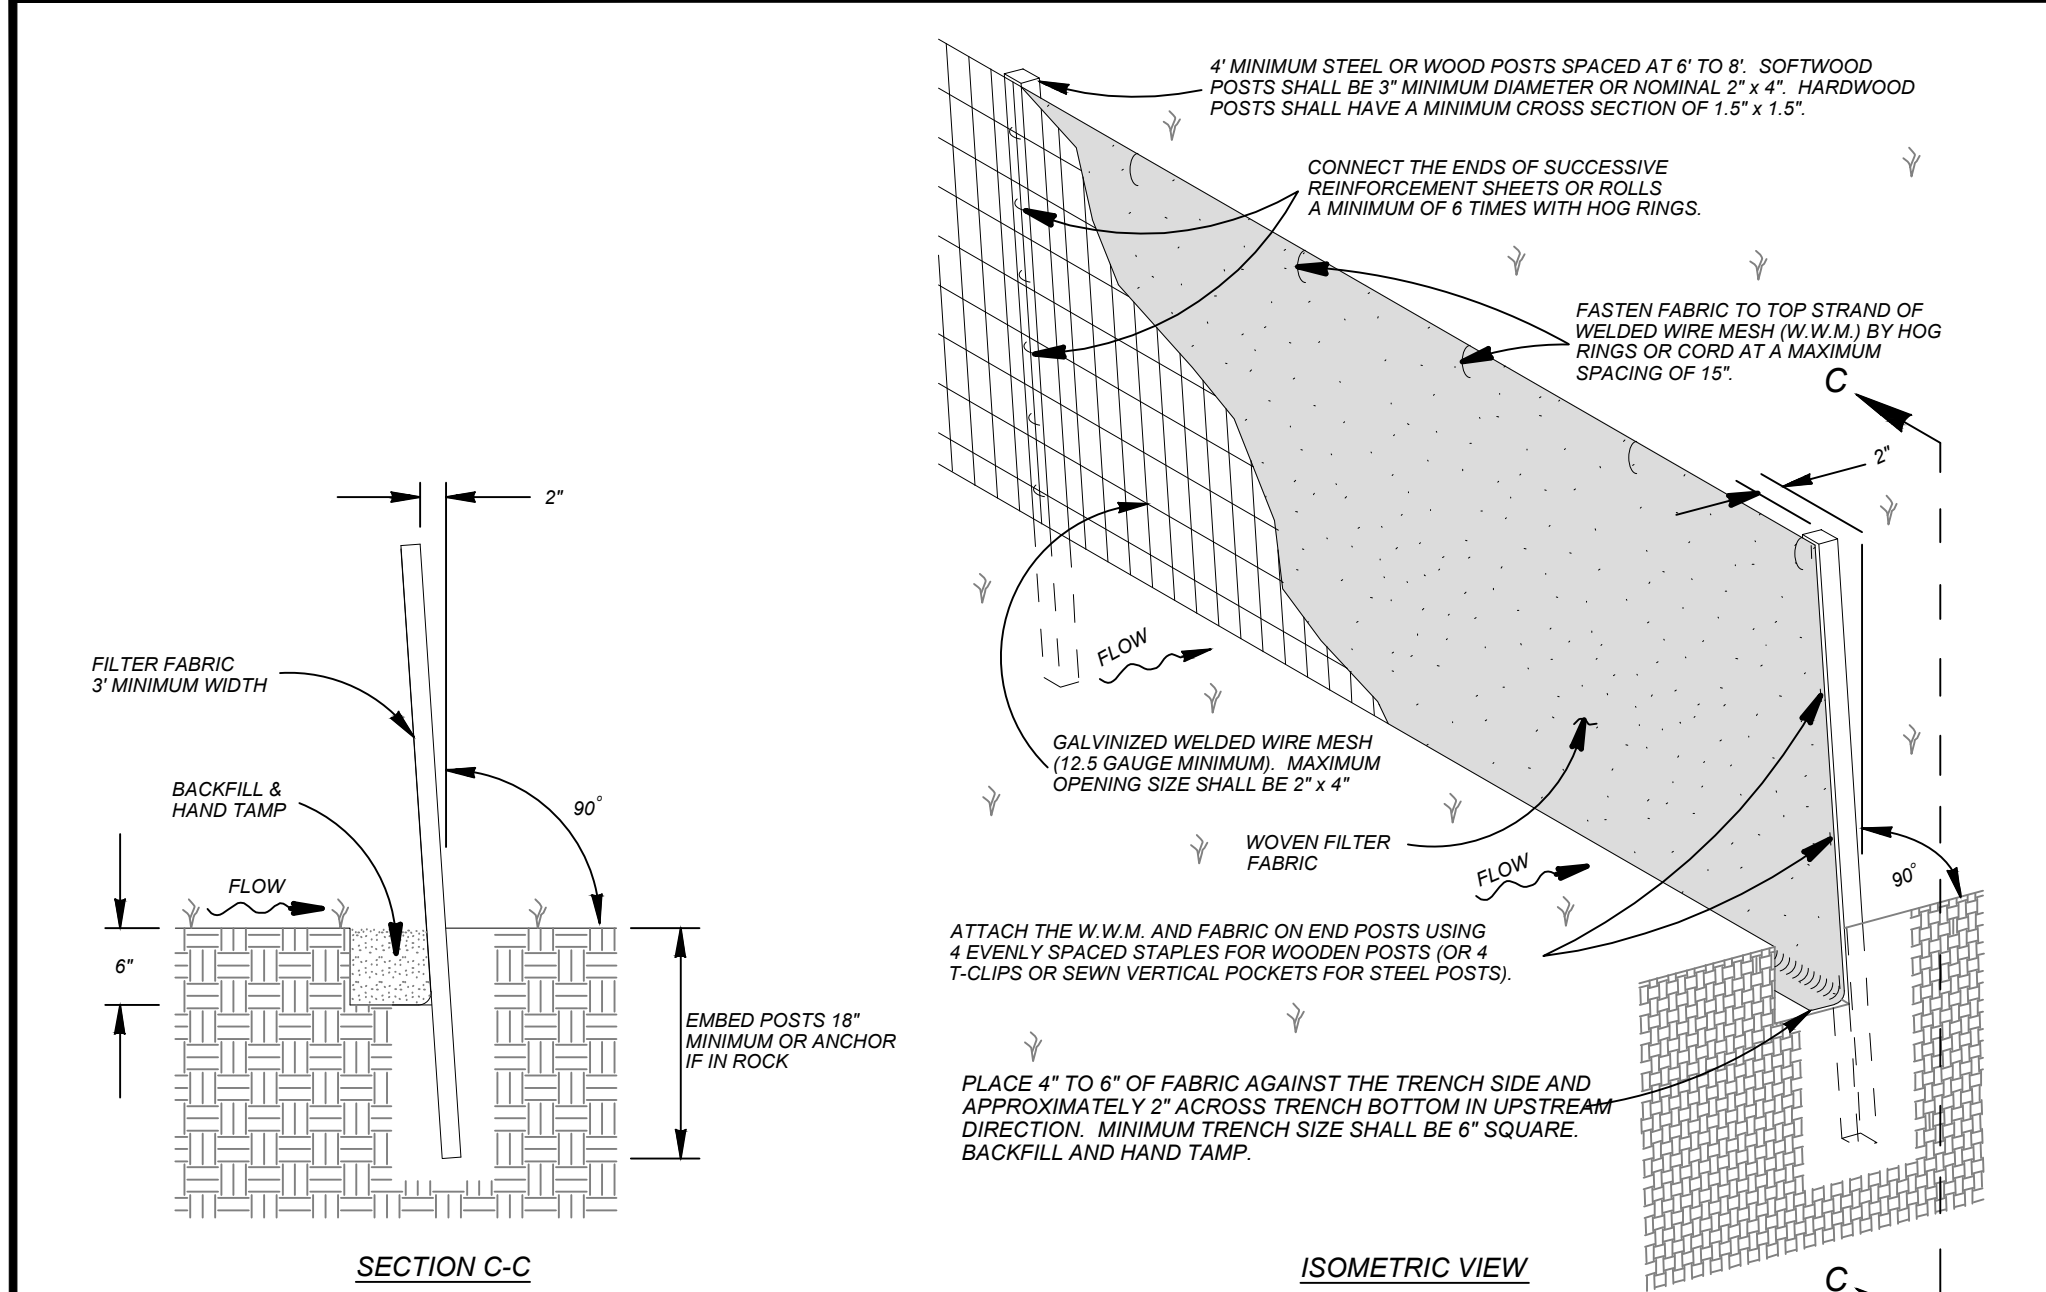

SEDIMENT CONTROL FENCE USAGE GUIDELINES



A SEDIMENT CONTROL FENCE MAY BE CONSTRUCTED NEAR THE DOWNSTREAM PERIMETER OF A DISTURBED AREA ALONG A CONTOUR TO INTERCEPT SEDIMENT FROM OVERLAND RUN-OFF. A 2 YEAR STORM FREQUENCY MAY BE USED TO CALCULATE THE FLOW RATE TO BE FILTERED.

SEDIMENT CONTROL FENCE SHOULD BE SIZED TO FILTER A MAXIMUM FLOW THRU RATE OF 100 GPM / FT SQUARED. SEDIMENT CONTROL FENCE IS NOT RECOMMENDED TO CONTROL EROSION FROM A DRAINAGE AREA LARGER THAN 2 ACRES.

GENERAL NOTES

1. THE GUIDELINES SHOWN HEREON ARE SUGGESTIONS ONLY AND MAY BE MODIFIED BY THE ENGINEER.

TEMPORARY SEDIMENT CONTROL FENCE

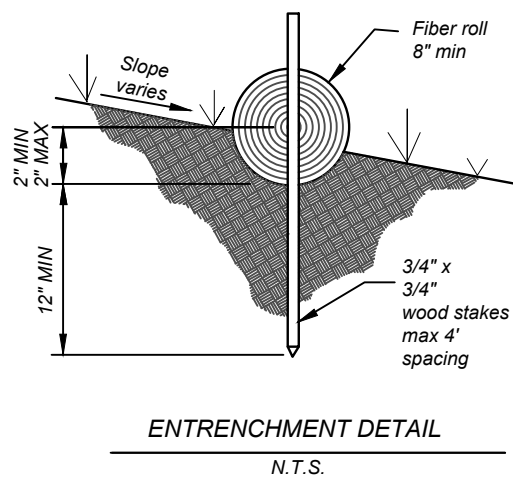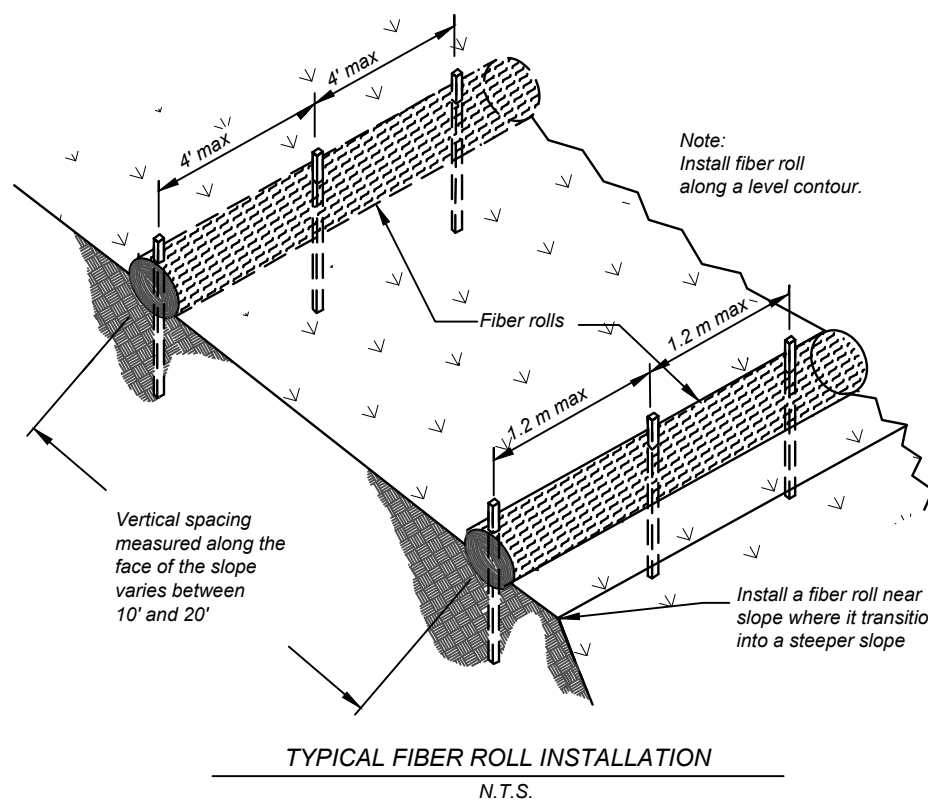

FIBER ROLL

THE MATERIAL, INSTALLATION, INSPECTION, AND MAINTENANCE OF FIBER ROLLS WILL BE PER THE MANUFACTURE'S SPECIFICATIONS AND SHALL ALSO COMPLY WITH THE TEXAS COMMISSION OF ENVIRONMENTAL QUALITY CURRENT TECHNICAL GUIDANCE ON BEST MANAGEMENT PRACTICES AS NOTED BELOW.

Material:


- (1) Core material: Core material should be biodegradable or recyclable. Material may be compost, mulch, aspen wood fibers, chipped site vegetation, agricultural rice or wheat straw, coconut fiber, 100% recyclable fibers, or similar materials.
- (2) Containment Mesh: Containment mesh should be 100% biodegradable, photodegradable or recyclable such as burlap, twine, UV photodegradable plastic, polyester, or similar material. When the fiber role will remain in place as part of a vegetative system use biodegradable or photodegradable mesh. For temporary installation recyclable mesh is recommended.

Implementation:

- (1) Locate fiber rolls on level contours spaced as follows:
Slope inclination of 4:1 (H:V) or flatter: Fiber rolls should be placed at a maximum interval of 20 ft.
Slope inclination between 4:1 and 2:1 (H:V): Fiber Rolls should be placed at a maximum interval of 15 ft. (a closer spacing is more effective).
Slope inclination 2:1 (H:V) or greater: Fiber Rolls should be placed at a maximum interval of 10 ft. (a closer spacing is more effective).
- (2) Turn the ends of the fiber roll up slope to prevent runoff from going around the roll.
- (3) Stake fiber rolls into a 2 to 4 in. deep trench with a width equal to the diameter of the fiber roll.
- (4) Drive stakes at the end of each fiber roll and spaced 4 ft maximum on center.
- (5) Use wood stakes with a nominal classification of 0.75 by 0.75 in. and minimum length of 24 in.
- (6) If more than one fiber roll is placed in a row, the rolls should be overlapped, not abutted.

Inspection and Maintenance Guidelines:

- (1) Inspect weekly.
- (2) Repair or replace split, torn, unraveling, or slumping fiber rolls.
- (3) If the fiber roll is used as a sediment capture device, or as an erosion control device to maintain sheet flows, sediment that accumulates behind the roll must be periodically removed in order to maintain its effectiveness. Sediment should be removed when the accumulation reaches one-half the designated sediment storage depth, usually one-half the distance between the top of the fiber roll and the adjacent ground surface. Sediment removed during maintenance may be incorporated into earthwork on the site or disposed of at an appropriate location.

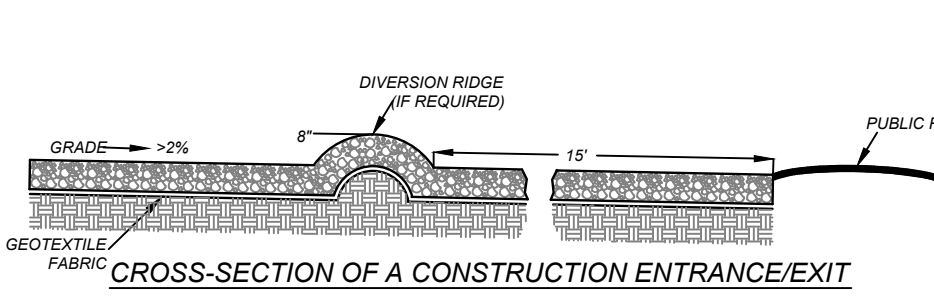

Materials:

- (1) The aggregate should consist of 4 to 8 inch washed stone over a stable foundation as specified in the plan.
- (2) The aggregate should be placed with a minimum thickness of 8 inches.
- (3) The geotextile fabric should be designed specifically for use as a soil filtration media with an approximate weight of 6 oz/yd², a mullen burst rating of 140 lb/in², and an equivalent opening size greater than a number 50 sieve.
- (4) If a washing facility is required, a level area with a minimum of 4 inch diameter washed stone or commercial rack should be included in the plans. Divert wastewater to a sediment trap or basin.


Installation: (North Carolina, 1993)

- (1) Avoid curves on public roads and steep slopes. Remove vegetation and other objectionable material from the foundation area. Grade crown foundation for positive drainage.
- (2) The minimum width of the entrance/exit should be 12 feet or the full width of exit roadway, whichever is greater.
- (3) The construction entrance should be at least 50 feet long.
- (4) If the slope toward the road exceeds 2%, construct a ridge, 6 to 8 inches high with 3:1 (H:V) side slopes, across the foundation approximately 15 feet from the entrance to divert runoff away from the public road.
- (5) Place geotextile fabric and grade foundation to improve stability, especially where wet conditions are anticipated.
- (6) Place stone to dimensions and grade shown on plans. Leave surface smooth and wet conditions are anticipated.
- (7) Divert all surface runoff and drainage from the stone pad to a sediment trap or basin.
- (8) Install pipe under pad as needed to maintain proper public road drainage.

Inspection and Maintenance Guidelines:

- (1) The entrance should be maintained in a condition, which will prevent tracking or flowing of sediment onto public rights-of-way. This may require periodic top dressing with additional stone as conditions demand and repair and/or cleanup of any measures used to trap sediment.
- (2) All sediment spilled, dropped, washed or tracked onto public rights-of-way should be removed immediately by contractor.
- (3) When necessary, wheels should be cleaned to remove sediment prior to entrance onto public right-of-way.
- (4) When washing is required, it should be done on an area stabilized with crushed stone that drains into an approved sediment trap or sediment basin.
- (5) All sediment should be prevented from entering any storm drain, ditch or water course by using approved methods.

STABILIZED CONSTRUCTION ENTRANCE / EXIT

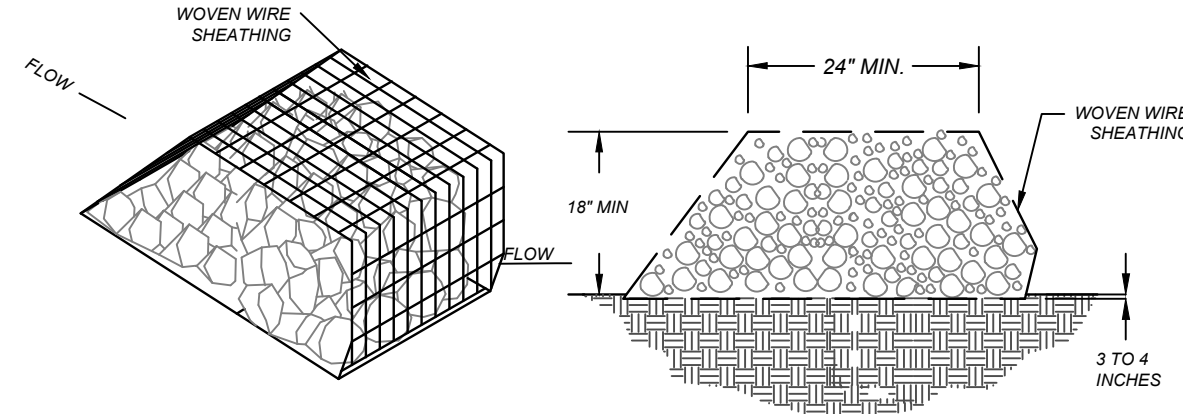

ISOMETRIC PLAN VIEW

CROSS SECTION

Materials:

- (1) The berm structure should be secured with a woven wire sheathing having maximum opening of 1 inch and a minimum wire diameter of 20 gauge galvanized and should be secured with short rings.
- (2) Clean, open graded 3- to 5-inch diameter rock should be used, except in areas where high velocities or large volumes of flow are expected, where 5- to 8-inch diameter rocks may be used.


Installation:

- (1) Lay out the woven wire sheathing perpendicular to the flow line. The sheathing should be 20 gauge woven wire mesh with 1 inch openings.
- (2) Berm should have a top width of 2 feet minimum with side slopes being 2:1 (H:V) or flatter.
- (3) Place the rock along the sheathing as shown in the diagram Figure 1-28), to a height not less than 18".
- (4) Wrap the wire sheathing around the rock and secure with the wire so that the ends of the sheathing overlap at least 3 inches, and the berm retains its shape when walked upon.
- (5) Berm should be built along the contour at zero percent grade or as near as possible.
- (6) The ends of the berm should be tied into existing upslope grade and the berm should be buried in a trench approximately 3 to 4 inches deep to prevent failure of the control.

Inspection and Maintenance Guidelines:

- (1) Inspection should be made weekly by the responsible party. For installations in streambeds, additional daily inspections should be made.
- (2) Remove sediment and other debris when buildup reaches 6 inches and dispose of the accumulated silt in an approved manner that will not cause any additional situation.
- (3) Repair any loose wire sheathing.
- (4) The berm should be reshaped as needed during inspection.
- (5) The berm should be replaced when the structure ceases to function as intended due to silt accumulation among the rocks, washout, construction traffic damage, etc.
- (6) The rock berm should be left in place until all upstream areas are stabilized and accumulated silt removed.

ROCK BERM

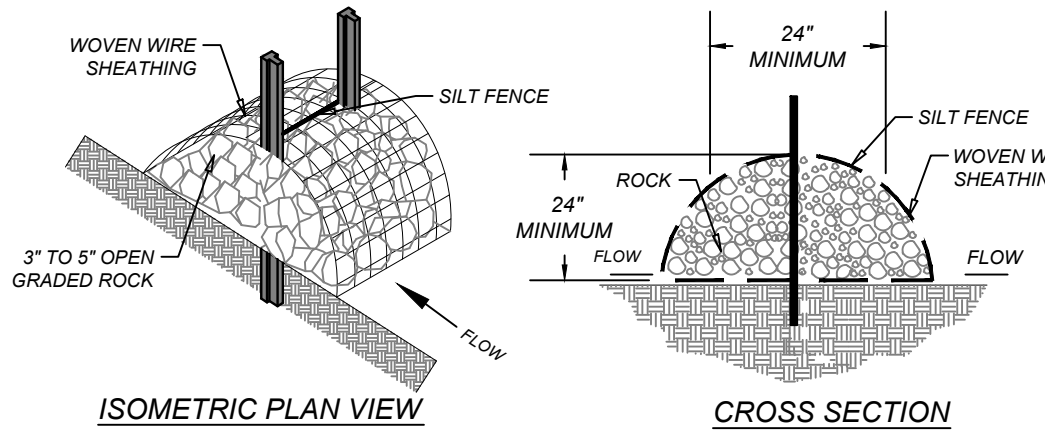

MATERIALS:


- (1) SILT FENCE MATERIAL SHOULD BE POLYPROPYLENE, POLYETHYLENE OR POLYAMIDE WOVEN OR NONWOVEN FABRIC. THE FABRIC WIDTH SHOULD BE 36 INCHES, WITH A MINIMUM UNIT WEIGHT OF 4.5 OZ/YD, MULLEN BURST STRENGTH EXCEEDING 190 LB/IN², ULTRAVIOLET STABILITY EXCEEDING 70%, AND MINIMUM APPARENT OPENING SIZE OF U.S. SIEVE NO. 30.
- (2) FENCE POSTS SHOULD BE MADE OF HOT ROLLED STEEL, AT LEAST 4 FEET LONG WITH TEE OR YBAR CROSS SECTION, SURFACE PAINTED OR GALVANIZED, MINIMUM NOMINAL WEIGHT 1.25 LB/LIN², AND MINIMUM HARDSNESS EXCEEDING 140. REBAR (EITHER #5 OR #6) MAY ALSO BE USED TO ANCHOR THE BERM.
- (3) WOVEN WIRE BACKING TO SUPPORT THE FABRIC SHOULD BE GALVANIZED 2" X 4" WELDED WIRE, 12 GAUGE MINIMUM.
- (4) THE BERM STRUCTURE SHOULD BE SECURED WITH A WOVEN WIRE SHEATHING HAVING MAXIMUM OPENING OF 1 INCH, AND A MINIMUM WIRE DIAMETER OF 20 GAUGE GALVANIZED AND SHOULD BE SECURED WITH SHORT RINGS.
- (5) CLEAN, OPEN GRADED 3- TO 5-INCH DIAMETER ROCK SHOULD BE USED, EXCEPT IN AREAS WHERE HIGH VELOCITIES OR LARGE VOLUMES OF FLOW ARE EXPECTED, WHERE 5- TO 8-INCH DIAMETER ROCKS MAY BE USED.

INSTALLATION:


- (1) LAY OUT THE WOVEN WIRE SHEATHING PERPENDICULAR TO THE FLOW LINE. THE SHEATHING SHOULD BE 20 GAUGE WOVEN WIRE MESH WITH 1-INCH OPENINGS.
- (2) INSTALL THE SILT FENCE ALONG THE CENTER OF THE PROPOSED BERM PLACEMENT, AS WITH A NORMAL SILT FENCE DESCRIBED IN SECTION 2.4.3.
- (3) PLACE THE ROCK ALONG THE SHEATHING ON BOTH SIDES OF THE SILT FENCE AS SHOWN IN THE DIAGRAM (FIGURE 1-29). TO A HEIGHT NOT LESS THAN 24 INCHES. CLEAN, OPEN GRADED 3- TO 5" DIAMETER ROCK SHOULD BE USED, EXCEPT IN AREAS WHERE HIGH VELOCITIES OR LARGE VOLUMES OF FLOW ARE EXPECTED, WHERE 5- TO 8-INCH DIAMETER ROCK MAY BE USED.
- (4) WRAP THE WIRE SHEATHING AROUND THE ROCK AND SECURE WITH THE WIRE SO THAT THE ENDS OF THE SHEATHING OVERLAP AT LEAST 2 INCHES, AND THE BERM RETAINS ITS SHAPE WHEN WALKED UPON.
- (5) THE HIGH SERVICE ROCK BERM SHOULD BE REMOVED WHEN THE SITE IS REVEGETATED OR OTHERWISE STABILIZED OR IT MAY REMAIN IN PLACE AS A PERMANENT BMP IF DRAINAGE IS ADEQUATE.

INSPECTION AND MAINTENANCE GUIDELINES:

- (1) INSPECTION SHOULD BE MADE WEEKLY BY THE RESPONSIBLE PARTY. FOR INSTALLATIONS IN STREAMBEDS, ADDITIONAL DAILY INSPECTIONS SHOULD BE MADE ON ROCK BERM.
- (2) REMOVE SEDIMENT AND OTHER DEBRIS WHEN BUILDUP REACHES 6 INCHES AND DISPOSE OF THE ACCUMULATED SILT OF IN AN APPROVED MANNER.
- (3) REPAIR ANY LOOSE WIRE SHEATHING.
- (4) THE BERM SHOULD BE RESHAPED AS NEEDED DURING INSPECTION.
- (5) THE BERM SHOULD BE REPLACED WHEN THE STRUCTURE CEASES TO FUNCTION AS INTENDED DUE TO SILT ACCUMULATION AMONG THE ROCKS, WASHOUT, CONSTRUCTION TRAFFIC DAMAGE, ETC.
- (6) THE ROCK BERM SHOULD BE LEFT IN PLACE UNTIL ALL UPSTREAM AREAS ARE STABILIZED AND ACCUMULATED SILT REMOVED.

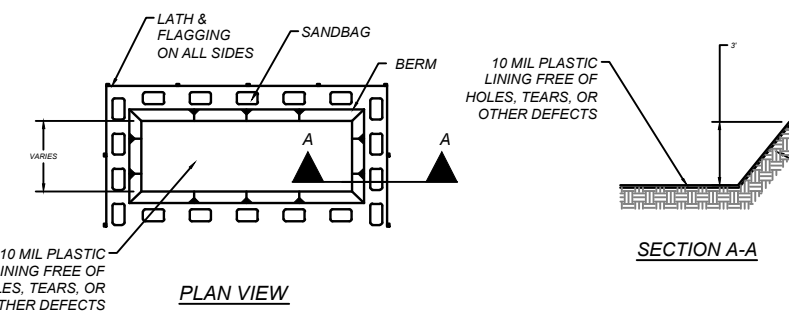


TYPE "BELOW GRADE"

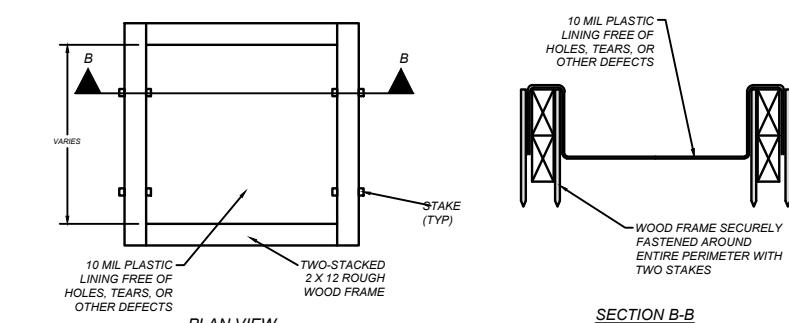

TYPE "ABOVE GRADE"

- GENERAL NOTES:**
- DETAIL ABOVE ILLUSTRATES MINIMUM DIMENSIONS. PIT CAN BE INCREASED IN SIZE DEPENDING ON EXPECTED FREQUENCY OF USE.
 - WASHOUT PIT SHALL BE LOCATED IN AN AREA EASILY ACCESSIBLE TO CONSTRUCTION TRAFFIC.
 - WASHOUT PIT SHALL NOT BE LOCATED IN AREAS SUBJECT TO INUNDATION FROM STORM WATER RUNOFF AND AT LEAST 50 FEET FROM SENSITIVE FEATURES, STORM DRAINS, OPEN DITCHES, STREETS, OR STREAMS.


CONCRETE TRUCK WASHOUT PIT

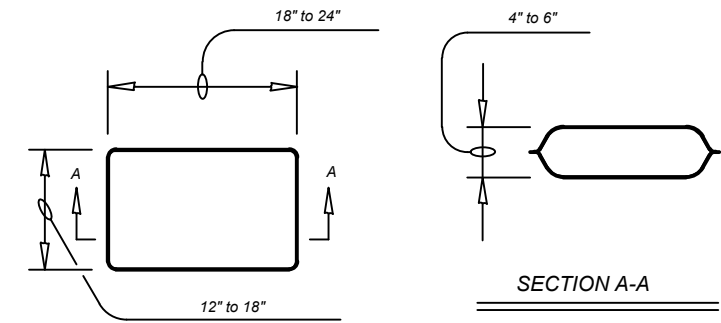

GENERAL NOTES:

- THE FILTER BAG MATERIAL SHALL BE MADE OF POLYPROPYLENE, POLYETHYLENE OR POLYAMIDE WOVEN FABRIC. MIN UNIT WEIGHT OF 4 OUNCES/Y. MULLEN BURST STRENGTH EXCEEDING 300 PSI AND ULTRAVIOLET STABILITY EXCEEDING 70%.
- THE FILTER BAG SHALL BE FILLED WITH CLEAN, MEDIUM TO COARSE GRAVEL (0.31 TO 0.75 INCH DIAMETER).


GRAVEL FILTER BAG DETAIL

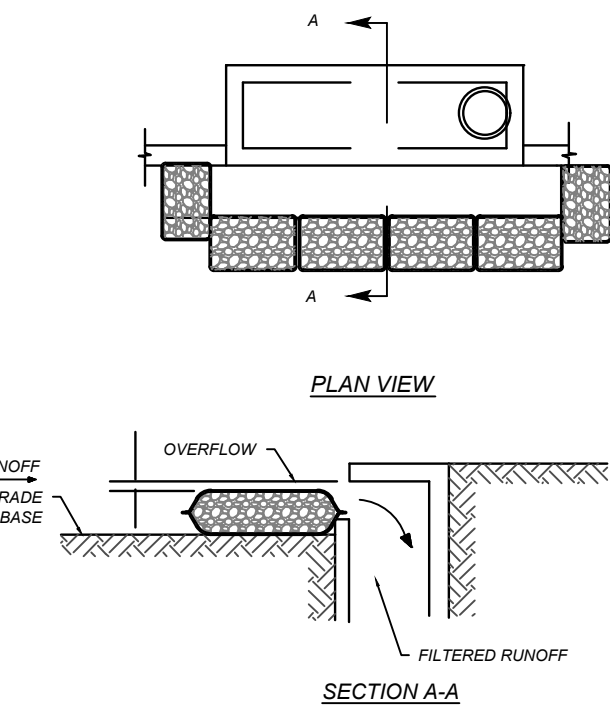


GENERAL NOTES:

- ALL STORM DRAINAGE SYSTEMS INLETS SHOULD FILTER RUNOFF BEFORE THE WATER IS DISCHARGED INTO STREAMS OR ONTO ADJACENT PROPERTIES, UNLESS TREATMENT IS PROVIDED ELSEWHERE.
- IF NO ADDITIONAL DOWNSTREAM TREATMENT EXISTS, THE MAXIMUM DRAINAGE AREA TRIBUTARY TO AN AREA DRAIN INSTALLED WITH A GRAVEL FILTER SHOULD BE ONE ACRE.
- ALL CURB INLET GRAVEL FILTERS SHOULD BE INSPECTED AND REPAIRED AFTER EACH RAINFALL EVENT. SEDIMENT SHOULD BE REMOVED WHEN MATERIAL IS WITHIN THREE INCHES OF THE TOP OF THE CONCRETE BLOCKS. PERIODICALLY, THE GRAVEL SHOULD BE RAKED TO INCREASE INFILTRATION AND FILTERING OF RUNOFF WATERS.

CURB INLET PROTECTION GRAVEL FILTER BAGS

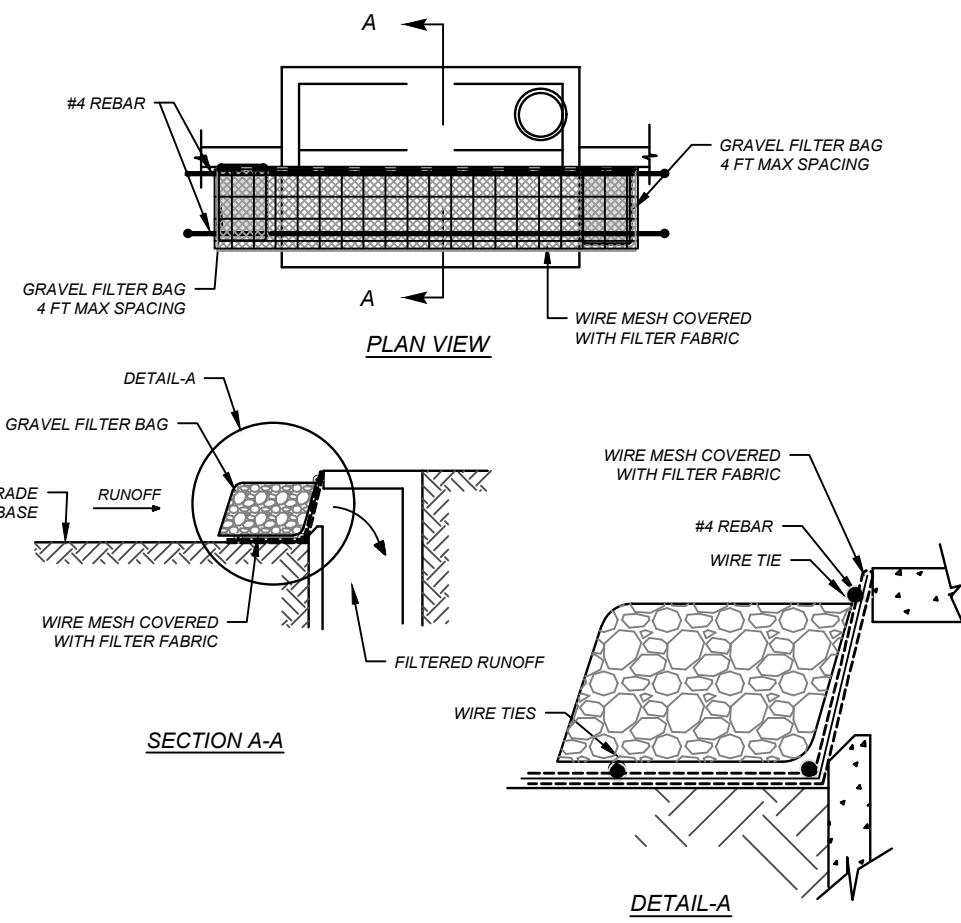

CURB INLET PROTECTION (ALTERNATE)

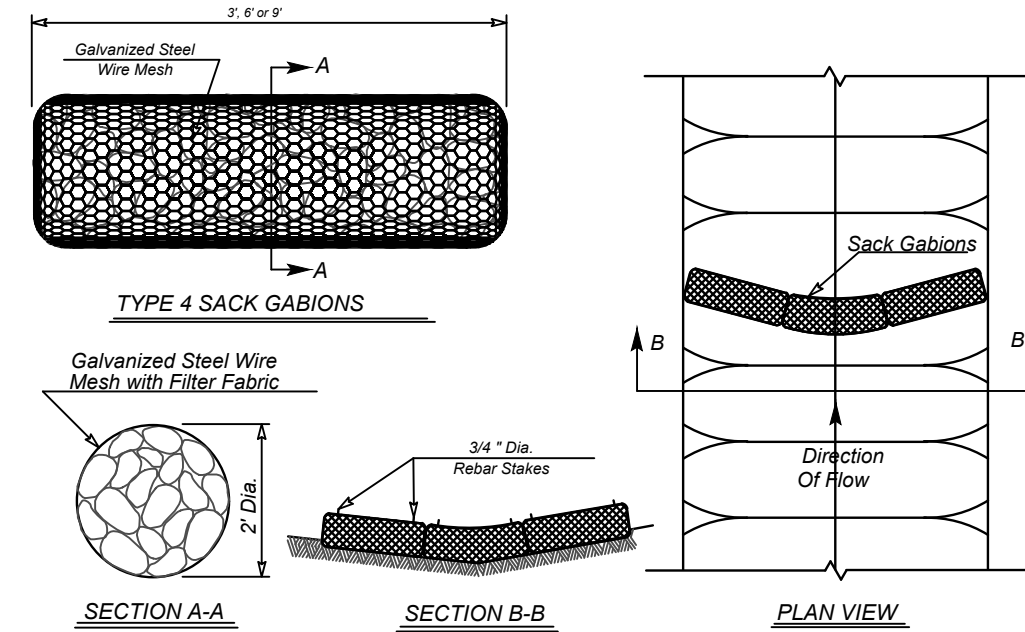


TYPE 4 SACK GABIONS

GENERAL NOTES:

- THE TOP OF THE SACK GABIONS SHOULD BE LEVEL AND ORIENTED PERPENDICULAR TO THE DIRECTION OF FLOW.
- FILTER FABRIC MATERIAL SHALL BE FASTENED TO WOVEN WIRE SUPPORT.
- FILTER FABRIC MATERIAL SHOULD MEET THE FOLLOWING SPECIFICATIONS: RESISTANT TO ULTRAVIOLET LIGHT, FABRIC SHOULD BE NON-WOVEN GEOTEXTILE WITH MINIMUM WEIGHT OF 3.5 OUNCES PER SQUARE YARD, MINIMUM MULLEN BURST STRENGTH OF 200 POUNDS PER SQUARE INCH, AND A FLOW THRU RATE OF 120 GALLONS PER MINUTE PER SQUARE FOOT OF FRONTAL AREA.
- STONE SIZE: 1/4" - 8" OPEN GRADED CRUSHED LIMESTONE.
- INSPECT WEEKLY OR AFTER EACH RAINFALL EVENT AND REPAIR OR REPLACE AS NEEDED.
- WHEN SILT REACHES A DEPTH OF 6 INCHES OR MORE ABOVE NATURAL GROUND, SILT SHALL BE REMOVED AND DISPOSED IN AN APPROVED MANNER THAT WILL NOT CONTRIBUTE TO RESILIATION. CONTAMINATED SEDIMENT MUST BE REMOVED AND DISPOSED OF OFF-SITE IN ACCORDANCE WITH APPLICABLE REGULATIONS.

TYPICAL CONSTRUCTION STAGING AREA

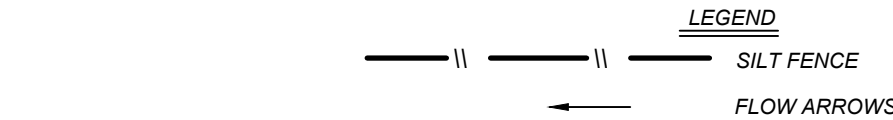

HIGH SERVICE ROCK BERM

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SCALE: AS SHOWN DATE: 07/20/2023 DRAWN BY: SD CHECKED BY: SC

PROJECT NUMBER: 205-43-07 DRAWING NAME: SW3P-DT2054307

SHEET TITLE: STORMWATER POLLUTION PREVENTION DETAILS

SHEET NUMBER: 8.2

NOTE: DO NOT SCALE DRAWINGS FOR CONSTRUCTION.