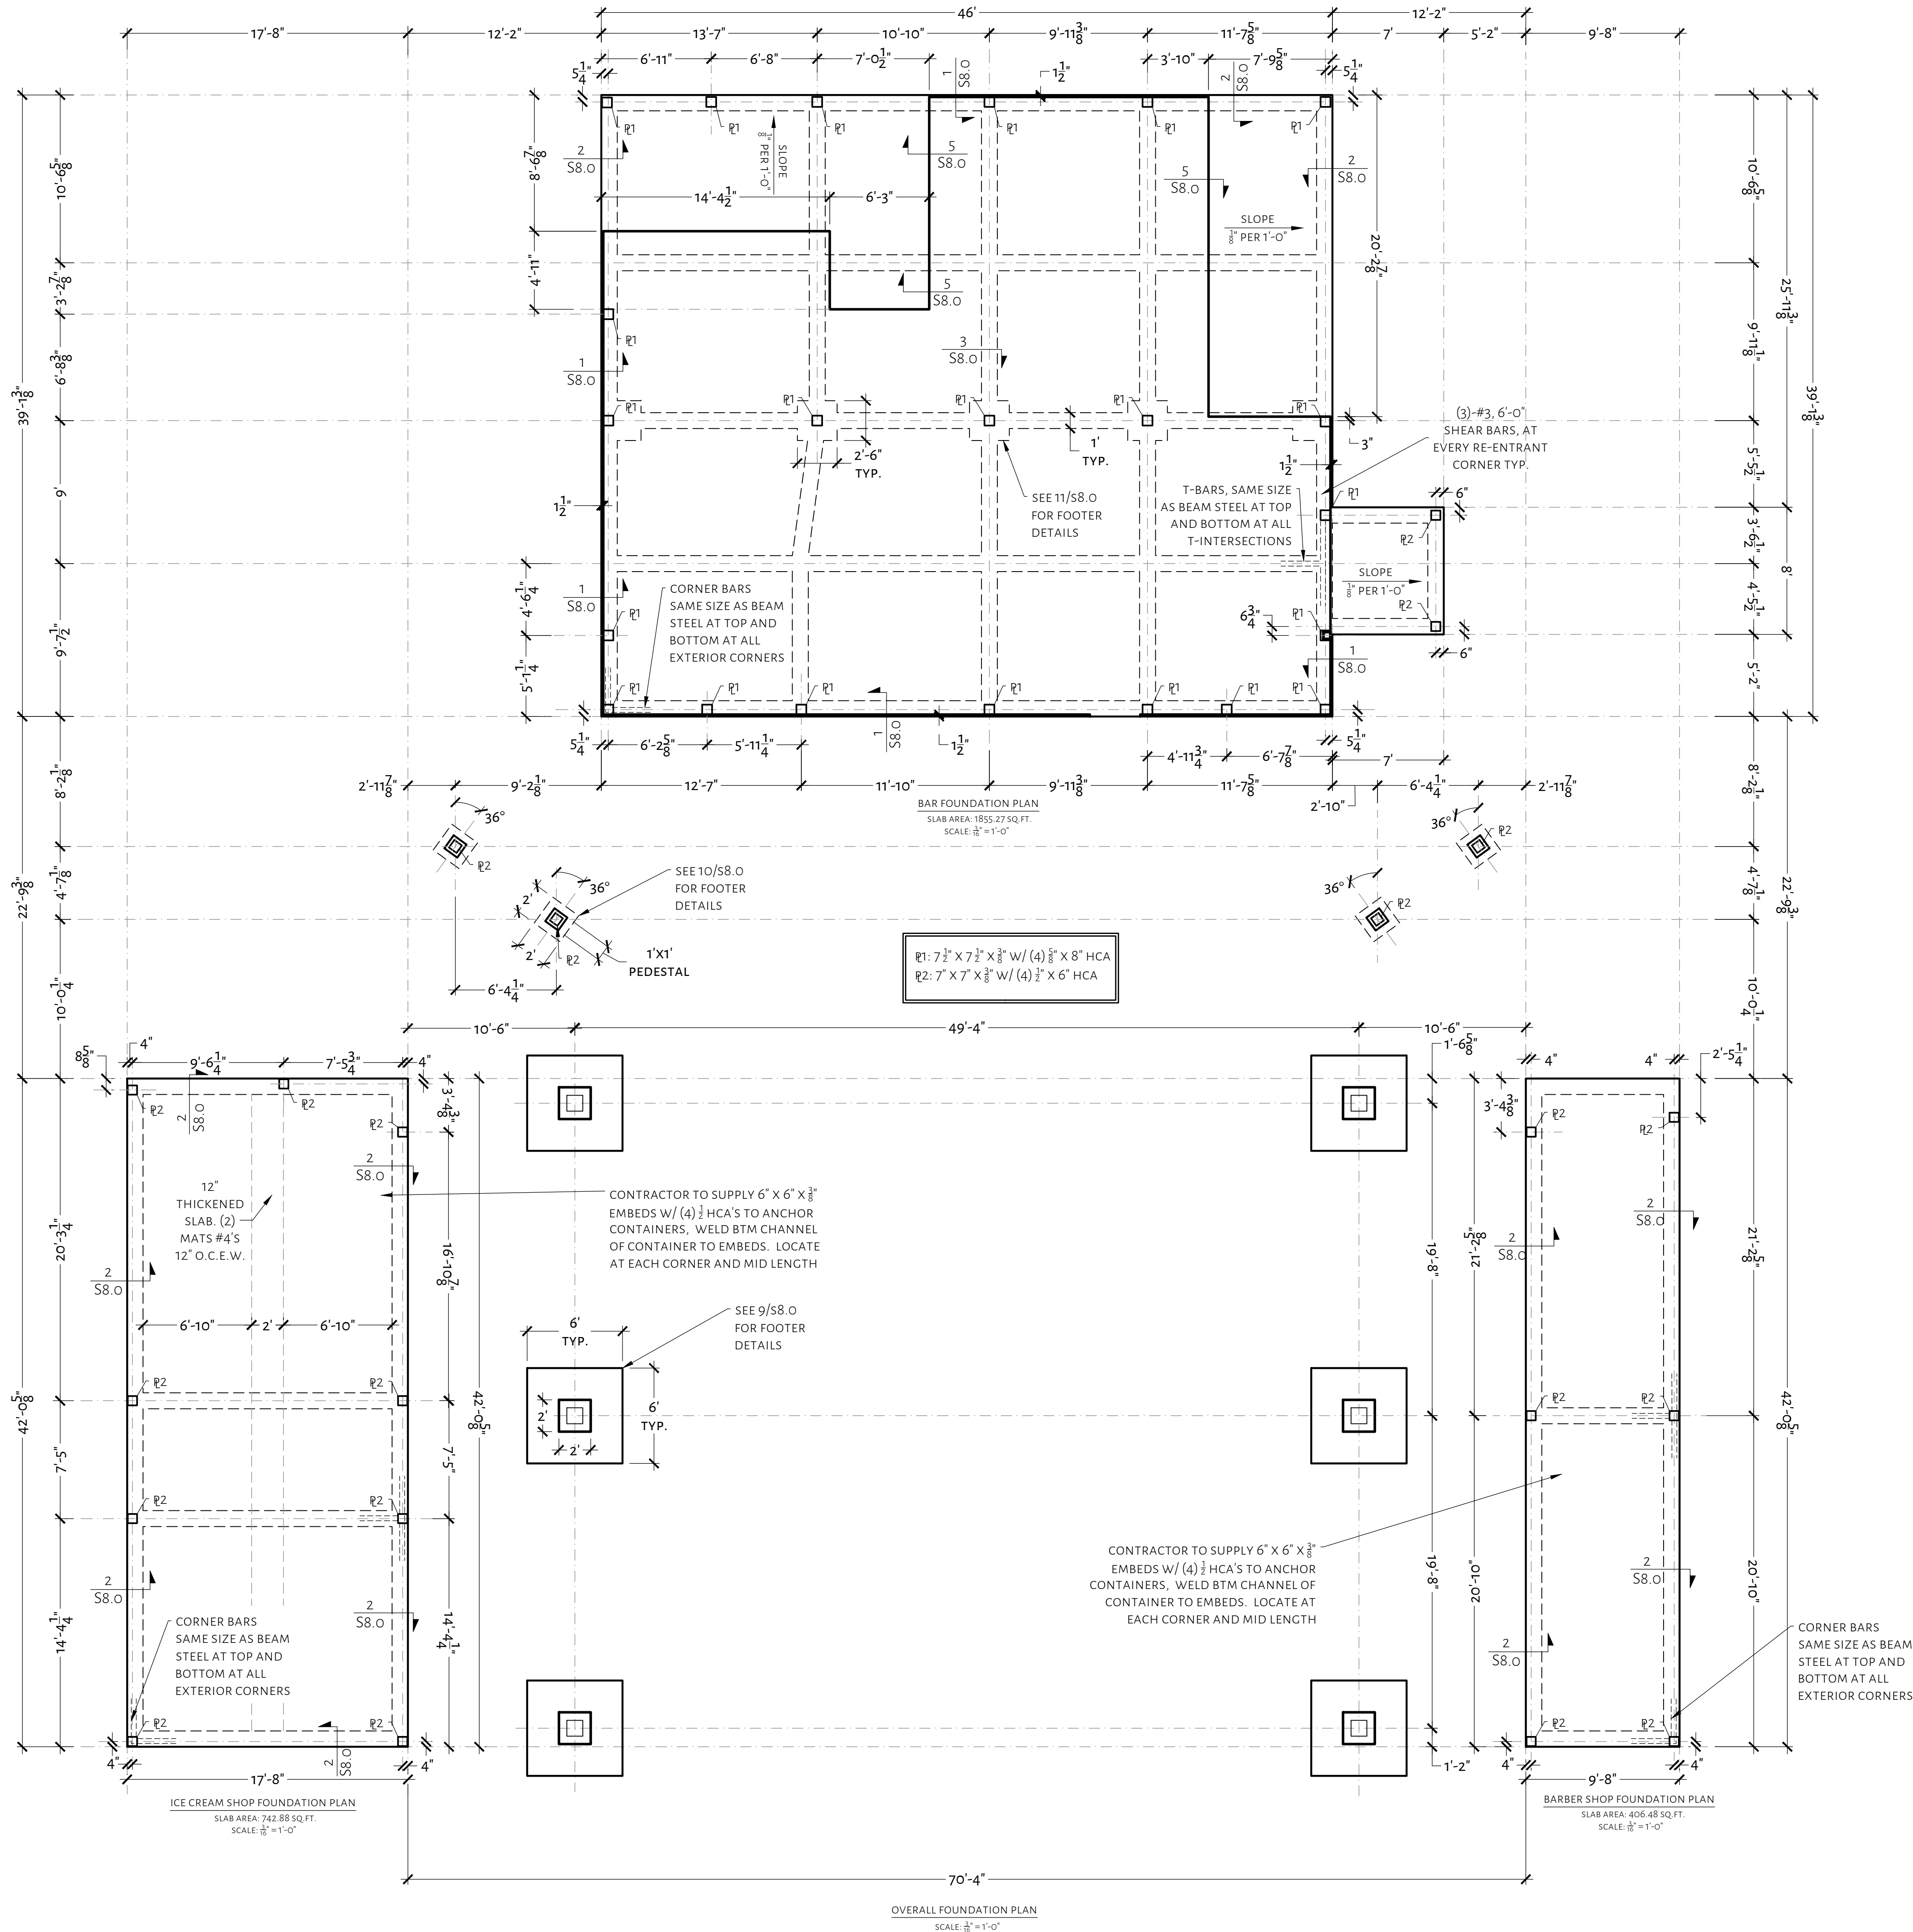


Date: Nov 13, 2024, 7:48am User ID: jwilk
File D:\Lone Star Structural Dropbox\Lone Star Structural\13 -Active Projects\2024\24231AU05292024 -Sinners and Saints.dwg



NOTES


- THIS DESIGN IS SITE SPECIFIC AND MAY NOT BE USED FOR DIFFERENT SITE LOCATIONS WITHOUT WRITTEN PERMISSION FROM LONE STAR STRUCTURAL, LLC.
- DETAILS PROVIDED ARE FOR INSTALLATION GUIDANCE. ALTERNATE DESIGNS SHALL BE ALLOWED AND APPROVED BY THE SEOR.
- ALL DIMENSIONS SHALL BE VERIFIED WITH THE ARCHITECTURAL DESIGN. IF A DISCREPANCY EXIST, NOTIFY THE ARCHITECT AND SEOR IN WRITING FOR THE ISSUE TO BE RESOLVED.
- LONE STAR STRUCTURAL RELEASES ALL LIABILITY FOR THE PERFORMANCE OF THE FOUNDATION AND FRAMING DESIGN, IF THE PRE-POUR / FRAMING INSPECTIONS ARE NOT COMPLETED BY LONE STAR STRUCTURAL, LLC OR ANY ALTERATIONS ARE MADE TO THE ORIGINAL PLAN USED FOR DESIGN WHICH ARE NOT REVIEWED AND APPROVED BY LONE STAR STRUCTURAL IN WRITING PRIOR TO COMPLETION.
- THE STRUCTURAL SYSTEM FOR THIS PROJECT SHALL NOT BE CONSTRUCTED BY USING THE STRUCTURAL DRAWINGS ALONE. THESE DRAWINGS WERE DEVELOPED FROM DATA DERIVED PRIMARILY FROM THE ARCHITECTURAL DRAWINGS AND SECONDARILY FROM MEP, CIVIL AND OTHER DISCIPLINES. IT IS INTENDED THAT CONSTRUCTION PROCEED BY UTILIZING ALL OF THE INFORMATION CONTAINED IN THE ENTIRE SET OF CONSTRUCTION DOCUMENTS TAKEN AS A WHOLE; FAILURE TO DO SO WILL RESULT IN ERRORS WHICH SHALL BE CORRECTED AT THE CONTRACTORS EXPENSE.
- THE CONTRACTOR SHALL VERIFY THE EXISTING SOIL AND COMPARE WITH THE PROVIDED GEOTECHNICAL REPORT. NOTIFY THE GEOTECHNICAL ENGINEER IF THE EXISTING SOIL DOES NOT MATCH THE REPORT.
- ALL LARGE ROCKS ARE REQUIRED TO BE REMOVED FROM THE INTERIOR OF THE FORM WORK TO ENSURE NO INTERFERENCES OCCUR WITH THE BEAM STEEL.
- BEAM STEEL SHALL BE INSTALLED AT A CONSISTENT SLOPE, ELEVATION, TO MATCH THE SLAB STEEL. TO THE BEST OF THE CONTRACTORS ABILITY, THE BEAM STEEL SHALL BE PARALLEL WITH THE FINISHED FLOOR ELEVATION, PREVENTING A WAVYING EFFECT IN THE REINFORCEMENT BARS.

SILL PLATE ANCHOR SCHEDULE				
ANCHOR	LOCATION	MINIMUM DISTANCE FROM CORNERS	MINIMUM O.C. SPACING	MINIMUM EMBEDMENT
HILTI QUICK BOLT TZ ZINC PLATED	EXTERIOR WALLS	6"	48"	3"
HILTI POWDER ACTUATED X-P ZINC PLATED	INTERIOR WALLS	6"	24"	1-1/4"
CAST IN 1/2" X 8" GALVANIZED J BOLT	EXTERIOR WALLS	6"	48"	4"

ANCHORS ARE REQUIRED AT ALL PLATE JOINTS, LOCATED BETWEEN 2'-6" FROM THE JOINT.

FOUNDATION DESIGN SCHEDULE								
MINIMUM HEIGHT ABOVE GRADE	MINIMUM BEAM WIDTH	MINIMUM BEAM DEPTH	MINIMUM BEAM DEPTH IN EXIST. GRADE	BEAM BARS T & B	SLAB BARS	MINIMUM SLAB THICKNESS	BEAM STIRRUPS	
							BEAM DEPTH	STIRRUP SPACING
EXT: 6"	INT: 12" EXT: 12"	INT: 32" EXT: 32"	EXT: 6"	TOP: (2) #6 BTM: (2) #6	#4 @ 12" O.C.E.W	LIVING :5"	18"-24"	#3 BARS 18" O.C.
							> 24"	#3 BARS 24" O.C.

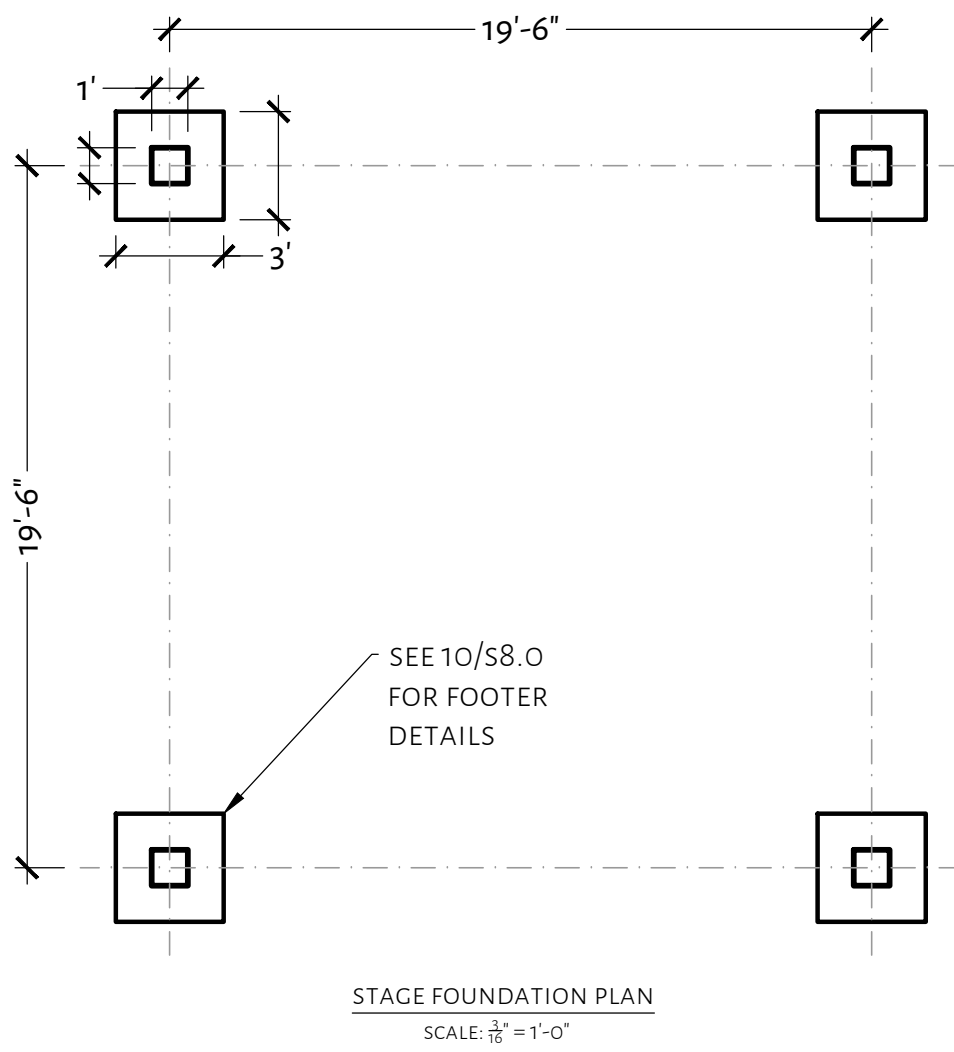
- FOUNDATION FILL AREAS IN EXCESS OF 36" IN DEPTH, ADD 12" PIERS AT ALL INTERIOR BEAM INTERSECTIONS. REINFORCE WITH (4) #6 BARS, AND #3 STIRRUPS 10" O.C.
- WHERE THE BEAM DEPTH EXCEEDS 60", A THICKENED SLAB IS REQUIRED. USE A 8" SLAB FOR 5 FT FROM THE PERIMETER REINFORCED WITH WITH (2) MATS OF #4 BARS 12" O.C. WHERE THE BEAM EXCEEDS 60" IN DEPTH.
- BEAM STIRRUPS, SHALL NOT BE CUT IF TOO LONG. BEND HOOKS OVER BARS.



LONE STAR STRUCTURAL, LLC
WWW.LONESTARSTRUCTURAL.COM | TEXAS REGISTERED FIRM F-20642 | P: 210.827.5509

SINNERS AND SAINTS

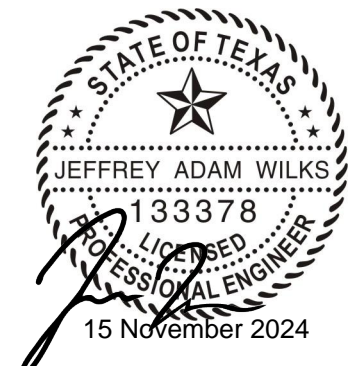19186 FM 2252
GARDEN RIDGE, TEXAS 78266



JOB: 24231AU05292024
DATE: 15 NOVEMBER 2024
DRAWN: JW | DESIGN: JW
OVERALL FOUNDATION PLN
SHEET:

S2.0


- THIS DESIGN IS SITE SPECIFIC AND MAY NOT BE USED FOR DIFFERENT SITE LOCATIONS WITHOUT WRITTEN PERMISSION FROM LONE STAR STRUCTURAL, LLC.
- DETAILS PROVIDED ARE FOR INSTALLATION GUIDANCE. ALTERNATE DESIGNS SHALL BE ALLOWED AND APPROVED BY THE SEOR.
- ALL DIMENSIONS SHALL BE VERIFIED WITH THE ARCHITECTURAL DESIGN. IF A DISCREPANCY EXIST, NOTIFY THE ARCHITECT AND SEOR IN WRITING FOR THE ISSUE TO BE RESOLVED.
- LONE STAR STRUCTURAL RELEASES ALL LIABILITY FOR THE PERFORMANCE OF THE FOUNDATION AND FRAMING DESIGN, IF THE PRE-POUR / FRAMING INSPECTIONS ARE NOT COMPLETED BY LONE STAR STRUCTURAL, LLC OR ANY ALTERATIONS ARE MADE TO THE ORIGINAL PLAN USED FOR DESIGN WHICH ARE NOT REVIEWED AND APPROVED BY LONE STAR STRUCTURAL IN WRITING PRIOR TO COMPLETION.
- THE STRUCTURAL SYSTEM FOR THIS PROJECT SHALL NOT BE CONSTRUCTED BY USING THE STRUCTURAL DRAWINGS ALONE. THESE DRAWINGS WERE DEVELOPED FROM DATA DERIVED PRIMARILY FROM THE ARCHITECTURAL DRAWINGS AND SECONDARILY FROM MEP, CIVIL AND OTHER DISCIPLINES. IT IS INTENDED THAT CONSTRUCTION PROCEED BY UTILIZING ALL OF THE INFORMATION CONTAINED IN THE ENTIRE SET OF CONSTRUCTION DOCUMENTS TAKEN AS A WHOLE; FAILURE TO DO SO WILL RESULT IN ERRORS WHICH SHALL BE CORRECTED AT THE CONTRACTORS EXPENSE.
- THE CONTRACTOR SHALL VERIFY THE EXISTING SOIL AND COMPARE WITH THE PROVIDED GEOTECHNICAL REPORT. NOTIFY THE GEOTECHNICAL ENGINEER IF THE EXISTING SOIL DOES NOT MATCH THE REPORT.
- ALL LARGE ROCKS ARE REQUIRED TO BE REMOVED FROM THE INTERIOR OF THE FORM WORK TO ENSURE NO INTERFERENCES OCCUR WITH THE BEAM STEEL.
- BEAM STEEL SHALL BE INSTALLED AT A CONSISTENT SLOPE, ELEVATION, TO MATCH THE SLAB STEEL. TO THE BEST OF THE CONTRACTORS ABILITY, THE BEAM STEEL SHALL BE PARALLEL WITH THE FINISHED FLOOR ELEVATION, PREVENTING A WAVYING EFFECT IN THE REINFORCEMENT BARS.

SILL PLATE ANCHOR SCHEDULE				
ANCHOR	LOCATION	MINIMUM DISTANCE FROM CORNERS	MINIMUM O.C. SPACING	MINIMUM EMBEDMENT
HILTI QUICK BOLT TZ ZINC PLATED	EXTERIOR WALLS	6"	48"	3"
HILTI POWDER ACTUATED X-P ZINC PLATED	INTERIOR WALLS	6"	24"	1-1/4"
CAST IN 1/2" X 8" GALVANIZED J BOLT	EXTERIOR WALLS	6"	48"	4"


ANCHORS ARE REQUIRED AT ALL PLATE JOINTS, LOCATED BETWEEN 2'-6" FROM THE JOINT.

FOUNDATION DESIGN SCHEDULE								
MINIMUM HEIGHT ABOVE GRADE	MINIMUM BEAM WIDTH	MINIMUM BEAM DEPTH	MINIMUM BEAM DEPTH IN EXIST. GRADE	BEAM BARS T & B	SLAB BARS	MINIMUM SLAB THICKNESS	BEAM STIRRUPS	
							BEAM DEPTH	STIRRUP SPACING
EXT: 6"	INT: 12" EXT: 12"	INT: 32" EXT: 32"	EXT: 6"	TOP: (2) #6 BTM: (2) #6	#4 @ 12" O.C.E.W	LIVING :5"	18"-24"	#3 BARS 18" O.C.
							> 24"	#3 BARS 24" O.C.

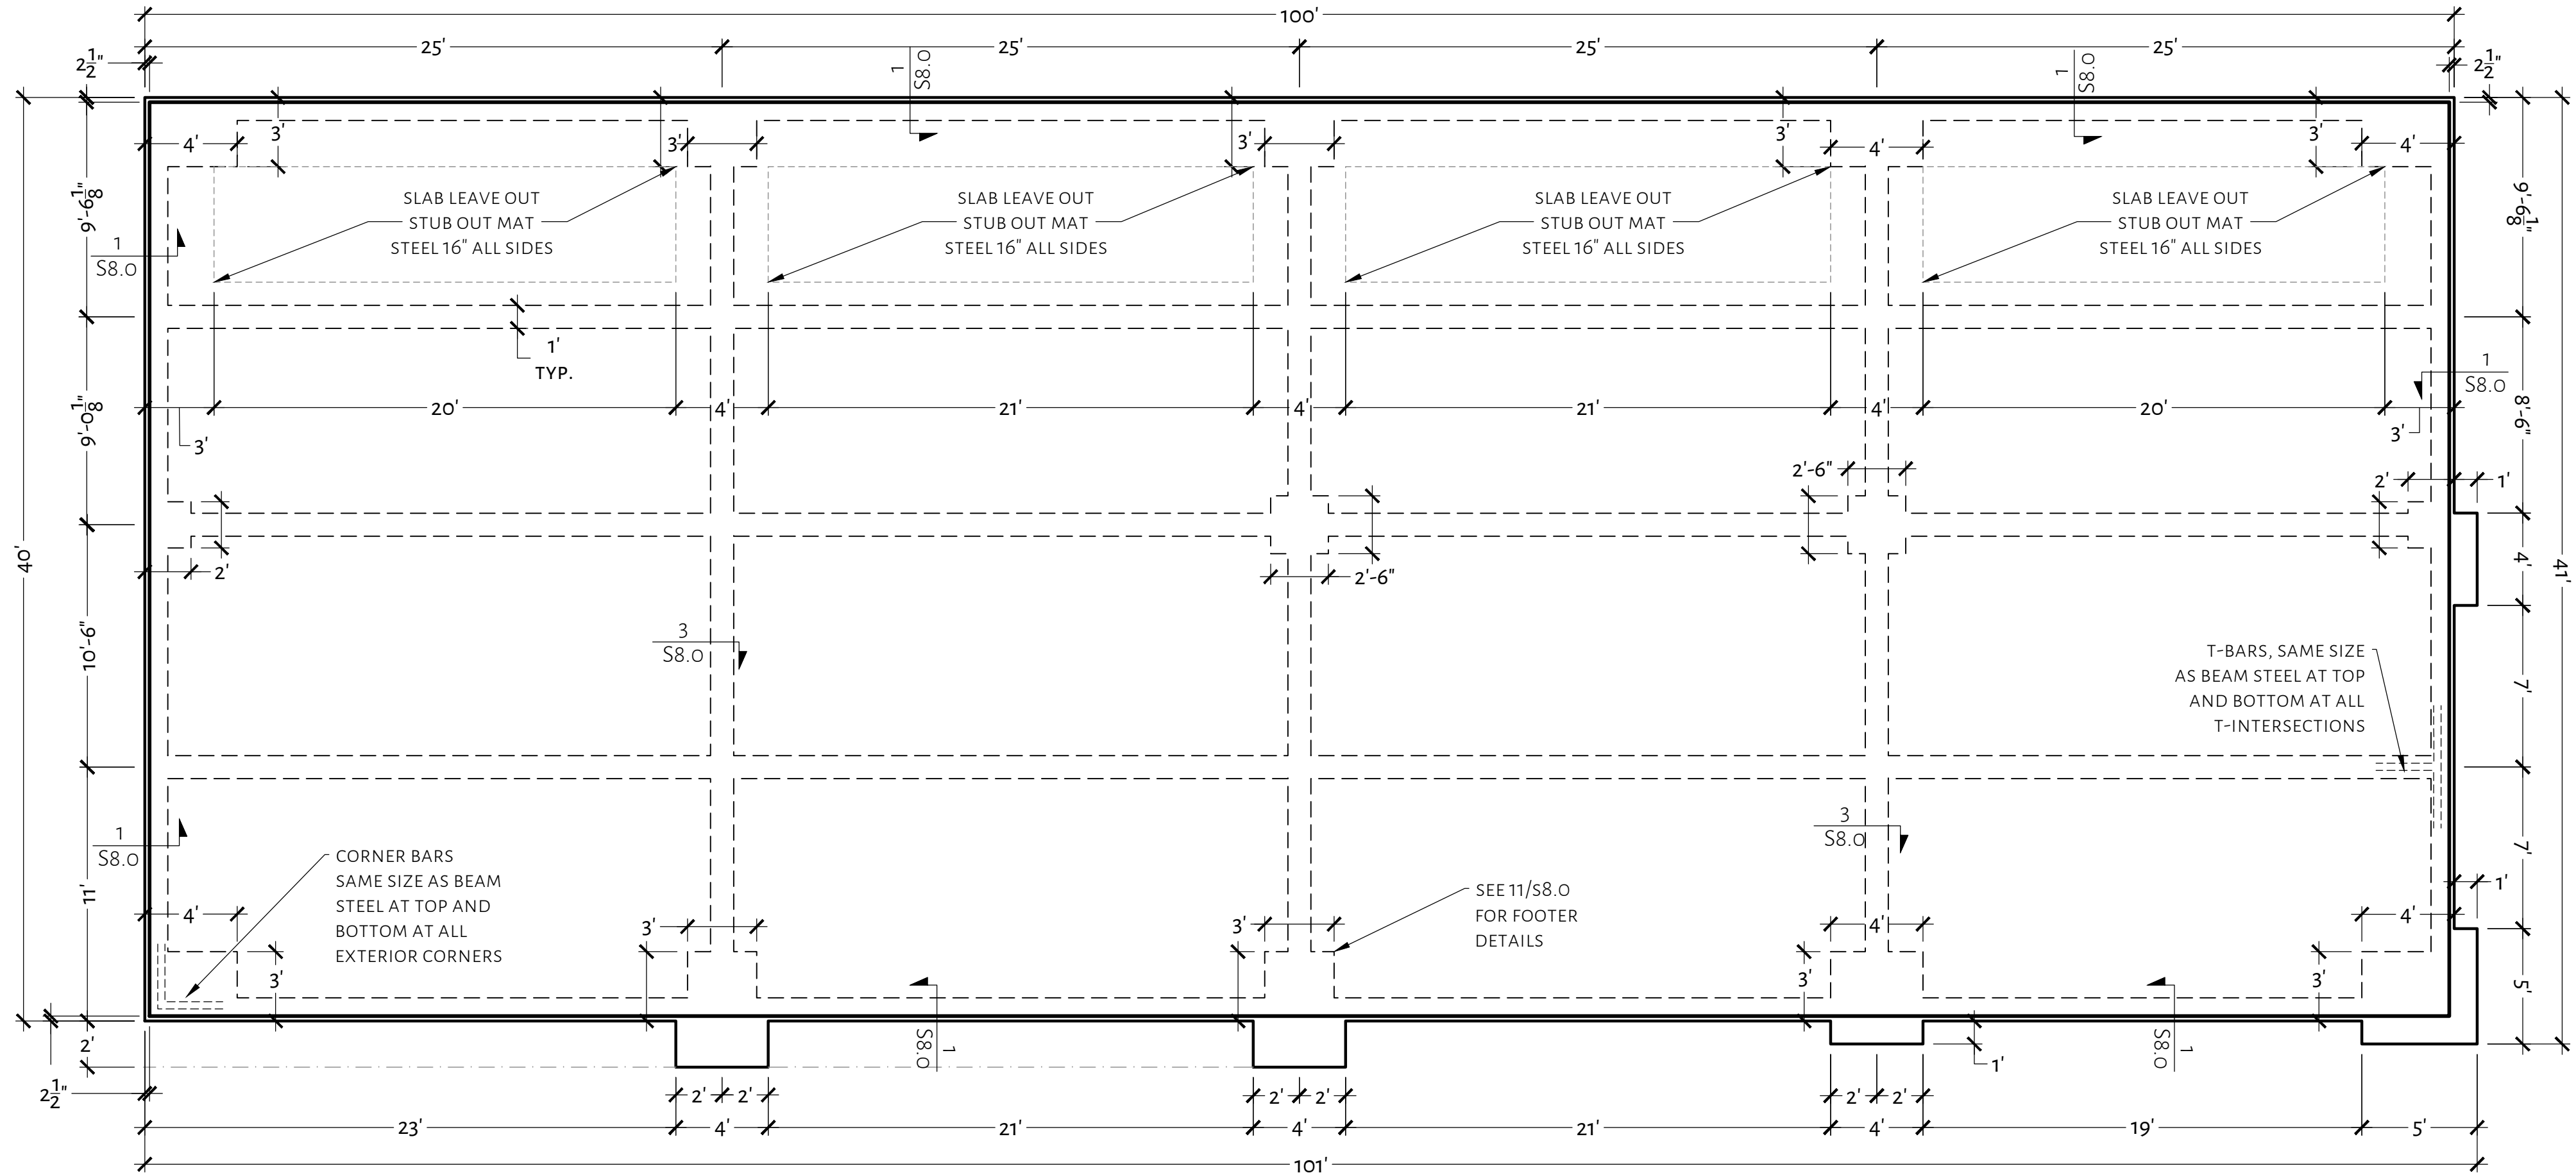
- FOUNDATION FILL AREAS IN EXCESS OF 36" IN DEPTH, ADD 12" PIERS AT ALL INTERIOR BEAM INTERSECTIONS. REINFORCE WITH (4) #6 BARS, AND #3 STIRRUPS 10" O.C.
- WHERE THE BEAM DEPTH EXCEEDS 60", A THICKENED SLAB IS REQUIRED. USE A 8" SLAB FOR 5 FT FROM THE PERIMETER REINFORCED WITH WITH (2) MATS OF #4 BARS 12" O.C. WHERE THE BEAM EXCEEDS 60" IN DEPTH.
- BEAM STIRRUPS, SHALL NOT BE CUT IF TOO LONG. BEND HOOKS OVER BARS.



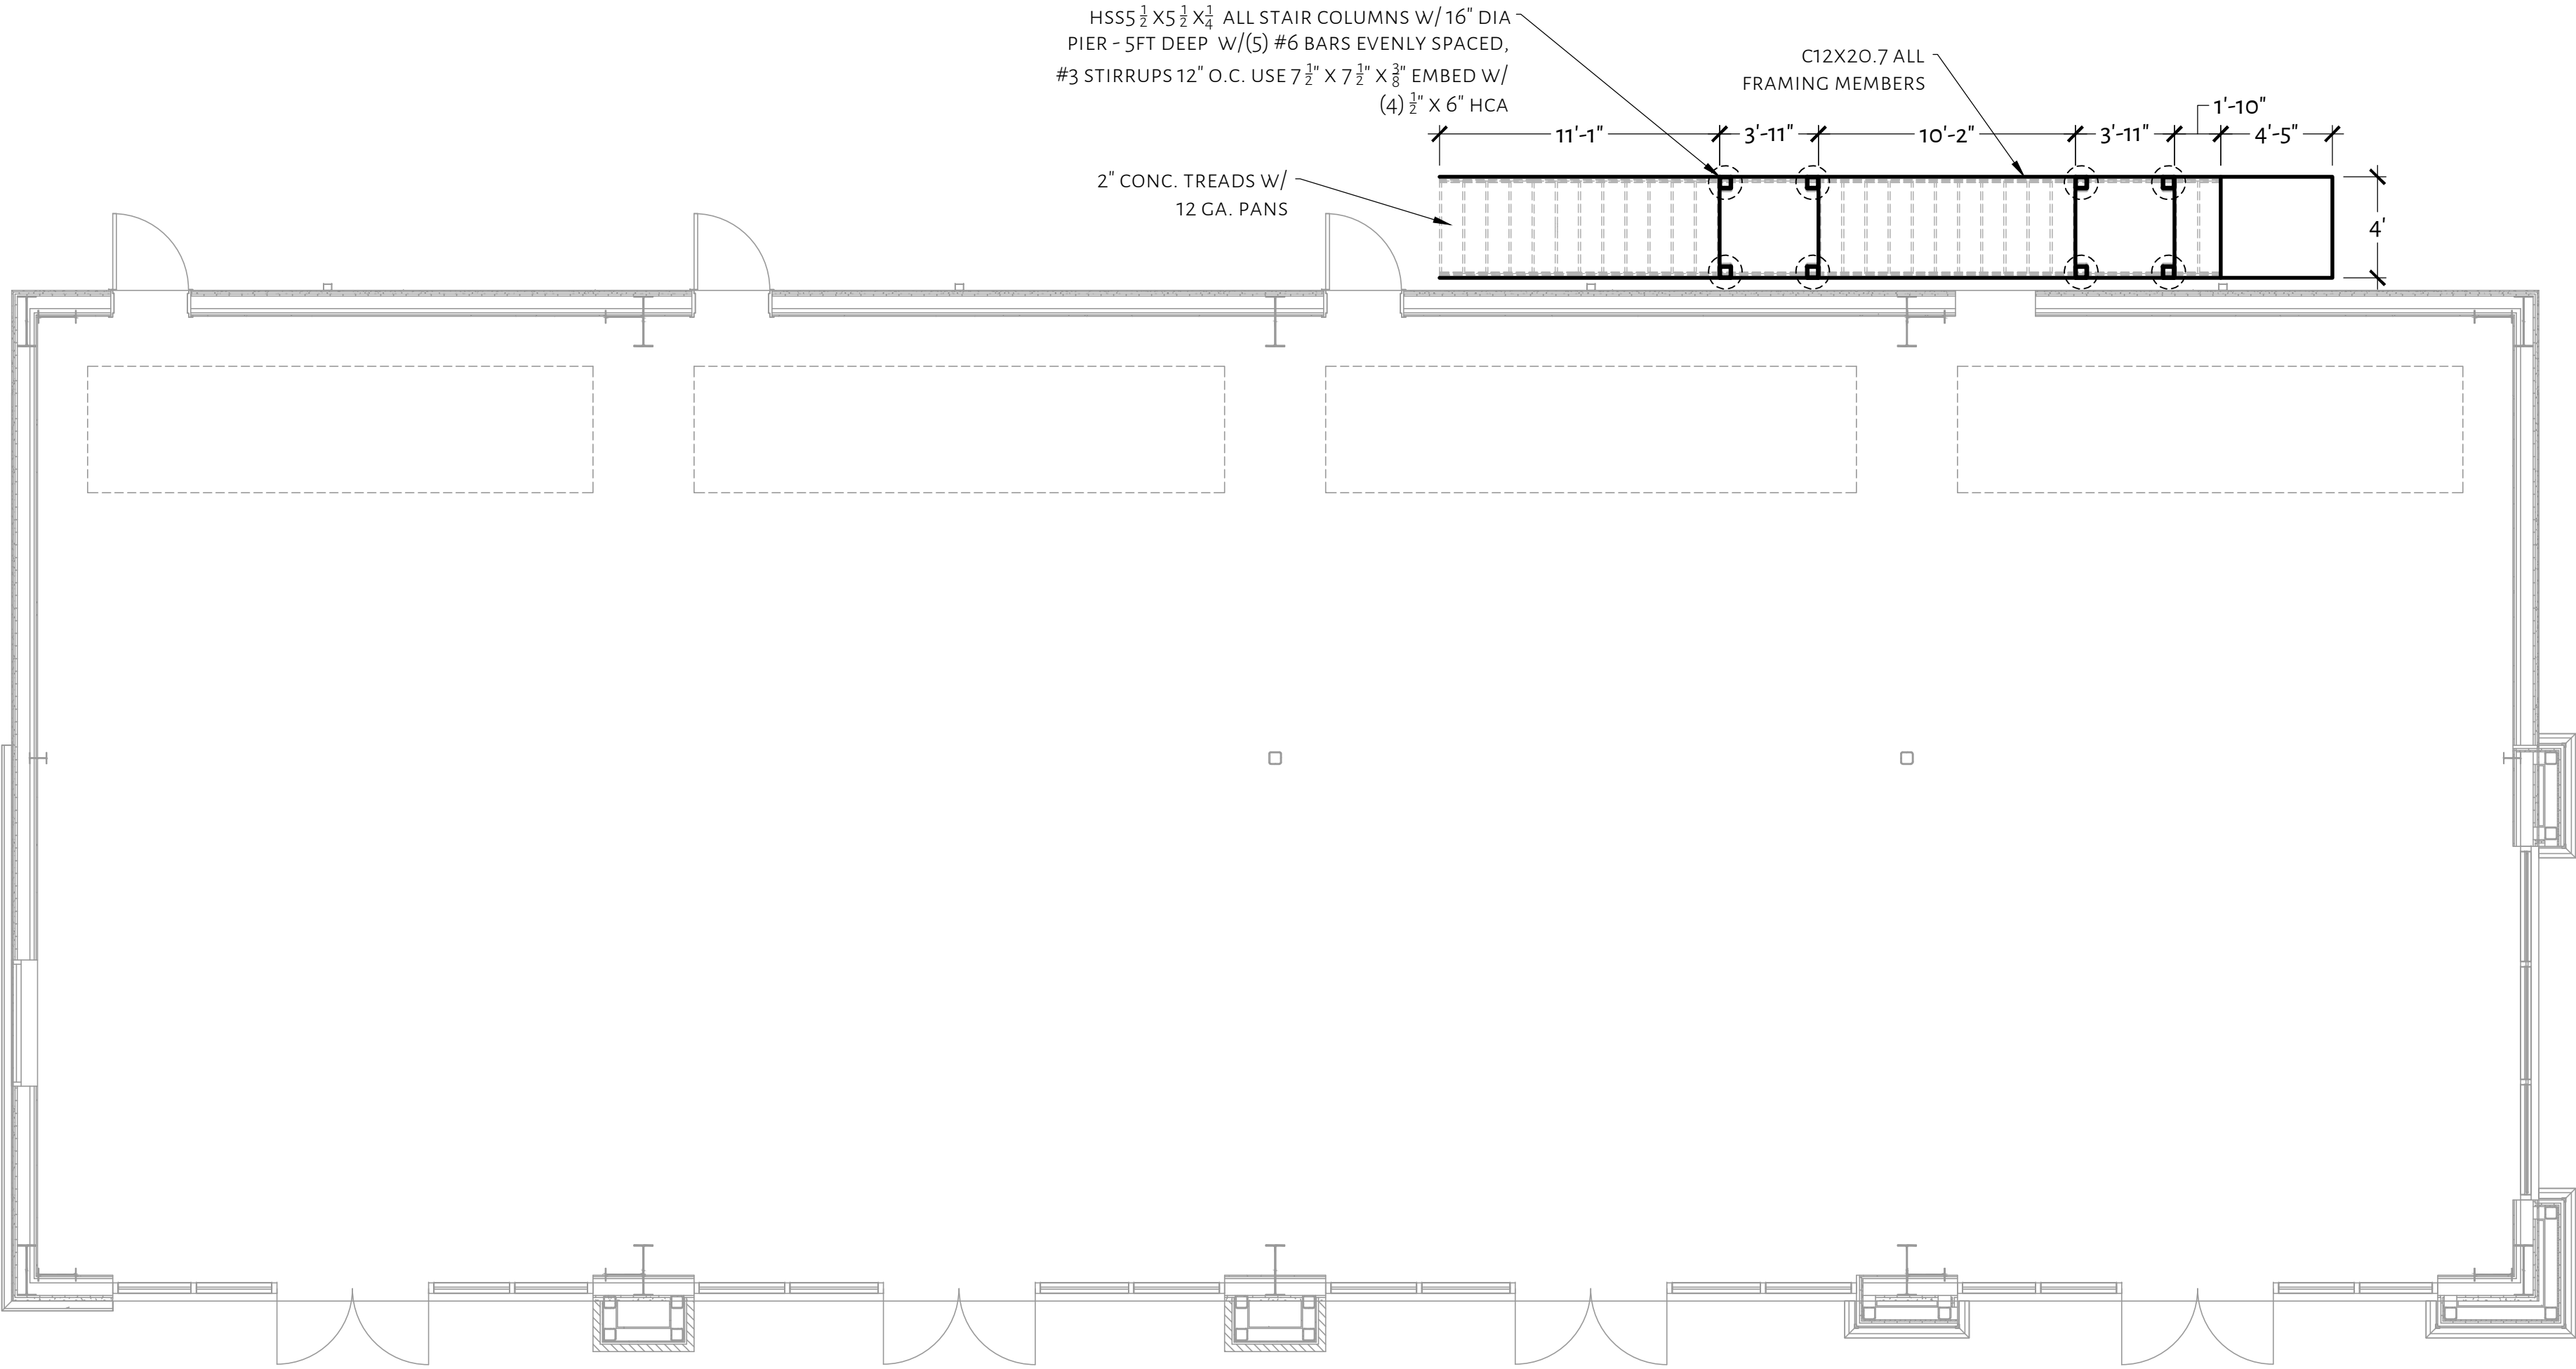REVIVAL RETAIL SHELL FOUNDATION PLAN
SLAB AREA: 4,033.00 SQ. FT.
SCALE: 1/8" = 1'-0"



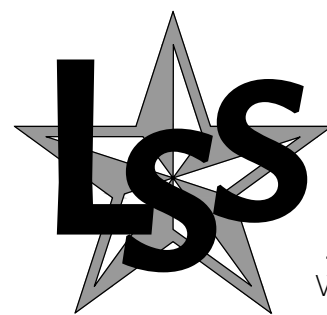REVIVAL RETAIL SHELL STAIR FRAMING
SCALE: 1/8" = 1'-0"




**LONE STAR
STRUCTURAL, LLC**

WWW.LONESTARSTRUCTURAL.COM | TEXAS REGISTERED FIRM F-26642 | P: 210.827.5509

SINNERS AND SAINTS

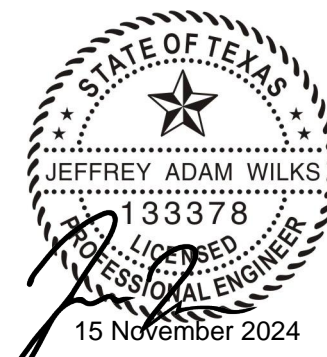
19186 FM 2252
GARDEN RIDGE, TEXAS 78266



JOB: 2423LA105292024
DATE: 15 NOVEMBER 2024
DRAWN: JW | DESIGN: JW
REVIVAL BUILDING
SHEET:


S2.1

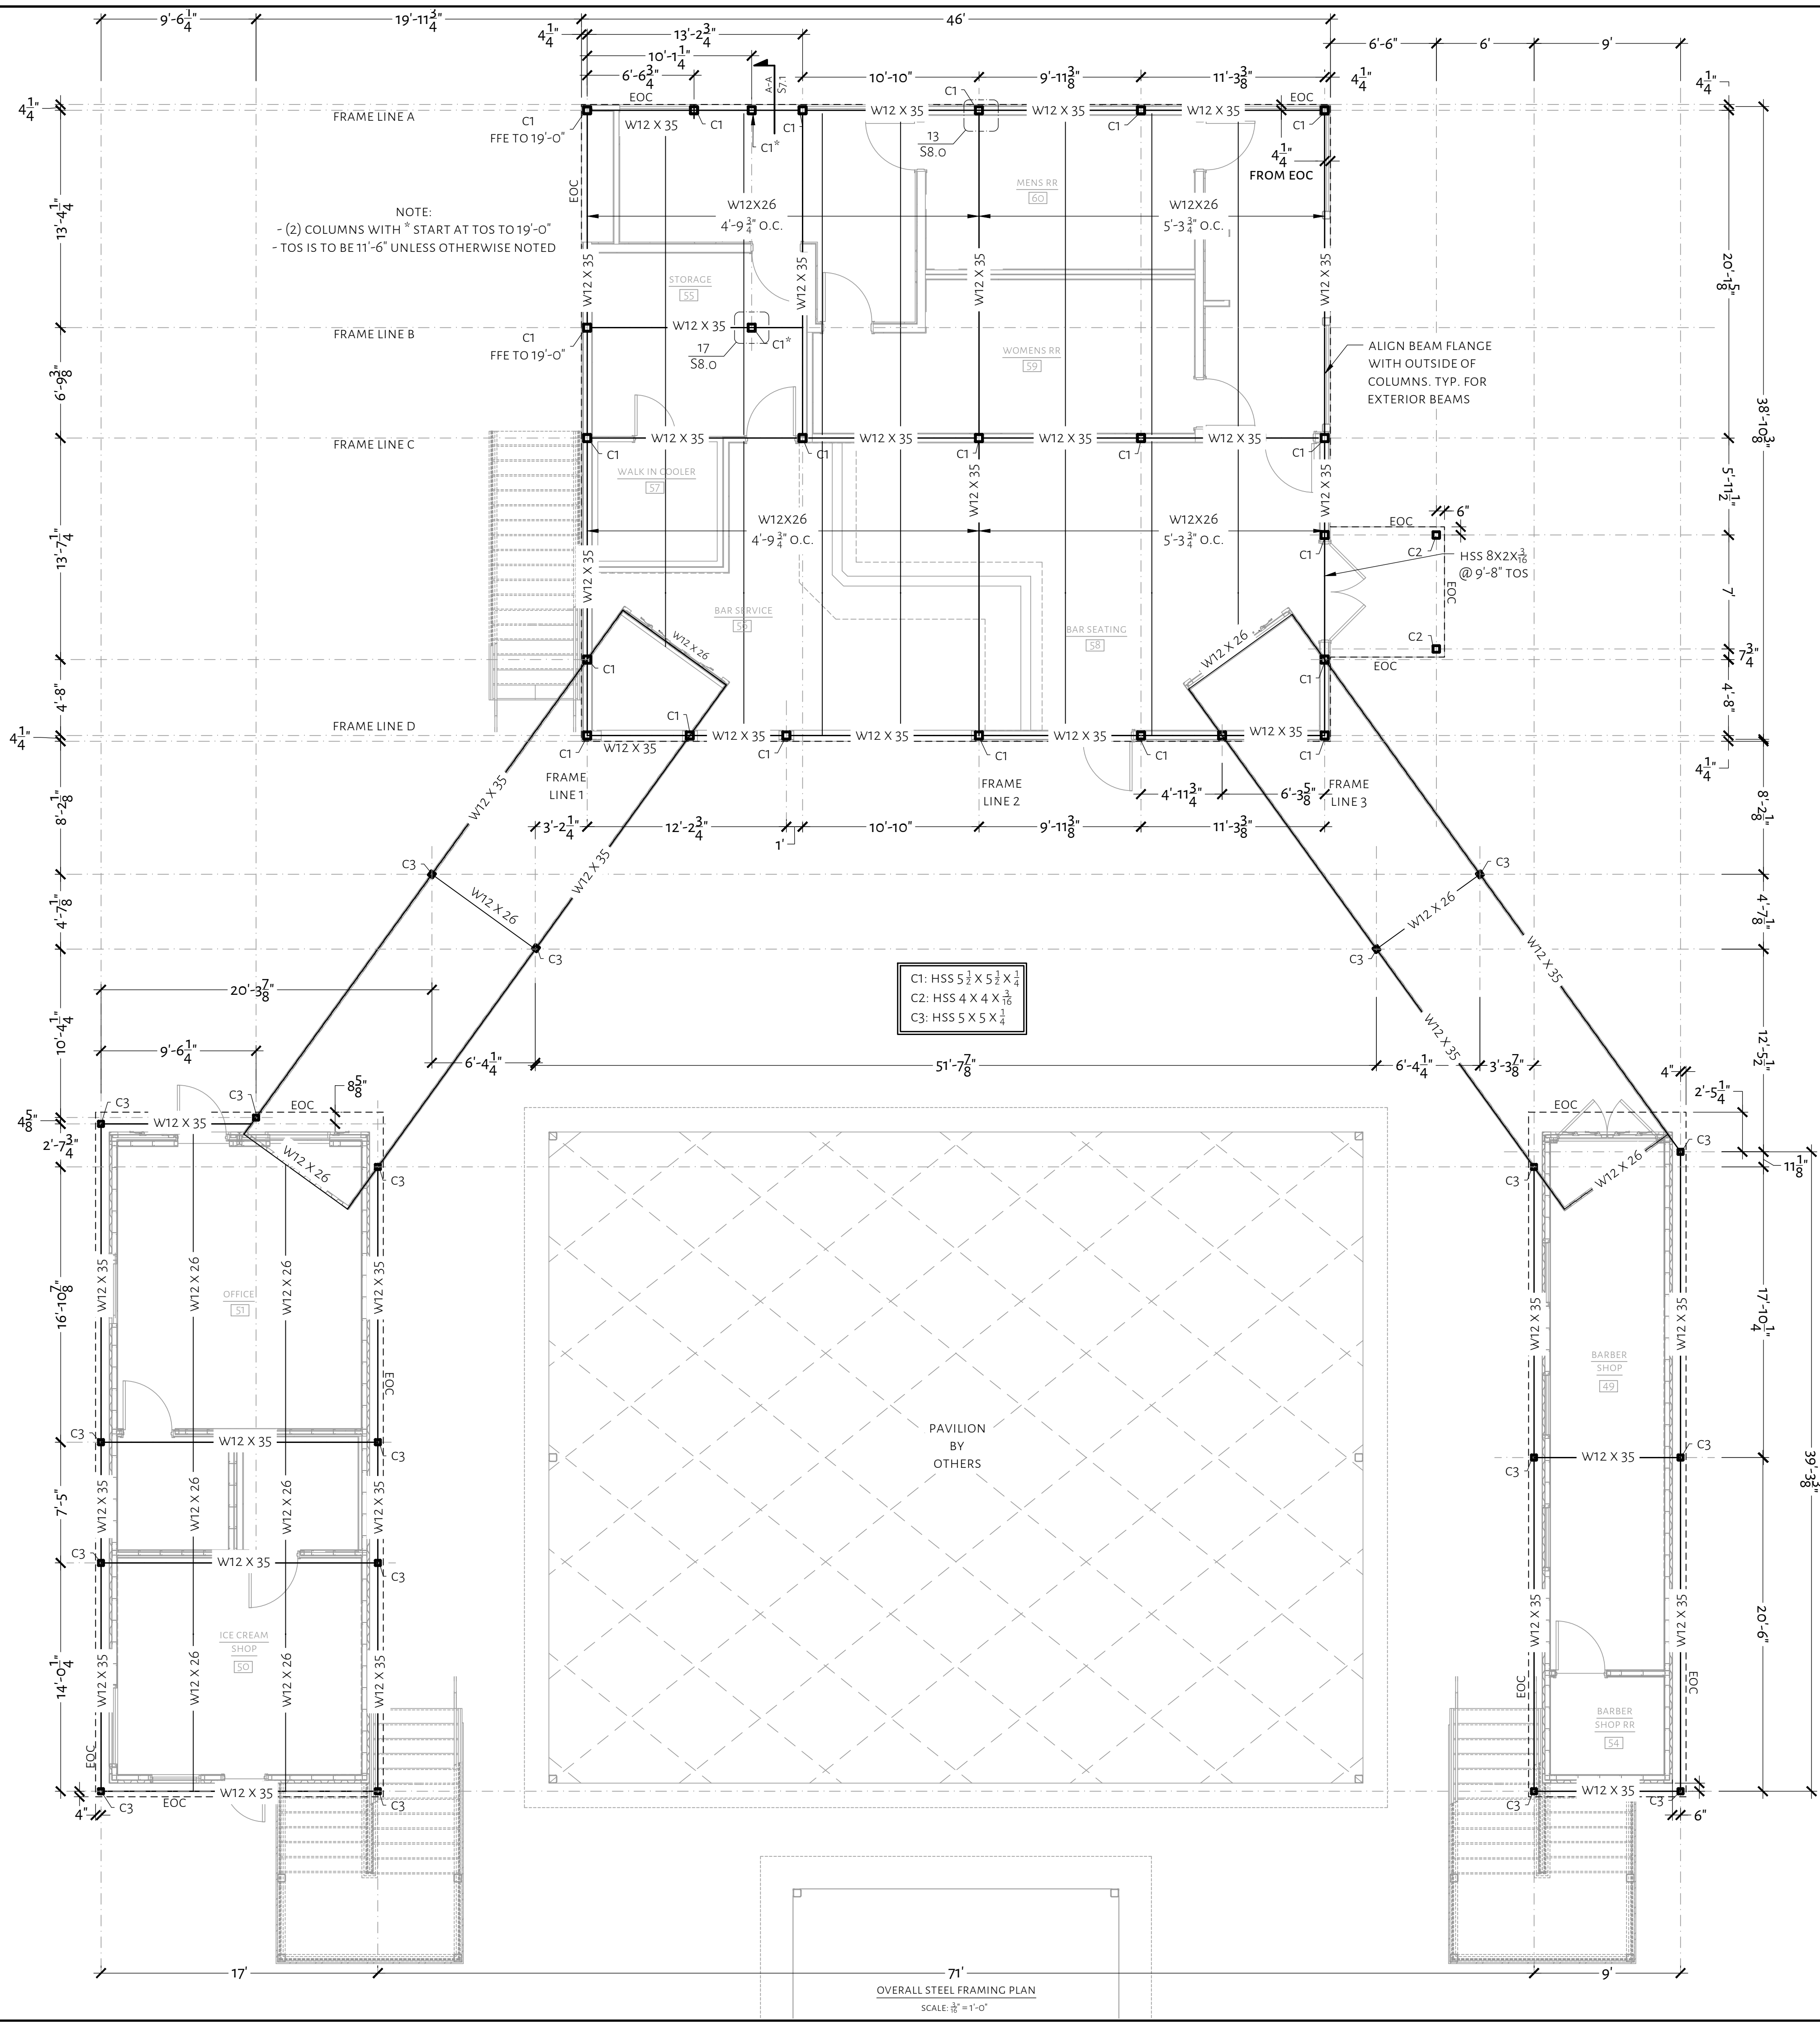Date: Nov 13, 2024, 7:50am User ID: jwilk
File: D:\Lone Star Structural Dropbox\Lone Star Structural\13 - Active Projects\2024\2423LAJ05292024 - Sinners and Saints\15 - Drawings\2423LAJ05292024 - Sinners and Saints.dwg



NOTES

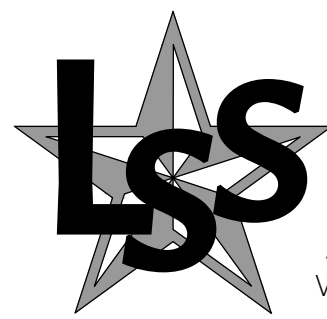1. THIS DESIGN IS SITE SPECIFIC AND MAY NOT BE USED FOR DIFFERENT SITE LOCATIONS WITHOUT WRITTEN PERMISSION FROM LONE STAR STRUCTURAL, LLC.
2. DETAILS PROVIDED ARE FOR INSTALLATION GUIDANCE. ALTERNATE DESIGNS SHALL BE ALLOWED AND APPROVED BY THE SEOR.
3. ALL DIMENSIONS SHALL BE VERIFIED WITH THE ARCHITECTURAL DESIGN. IF A DISCREPANCY EXIST, NOTIFY THE ARCHITECT AND SEOR IN WRITING FOR THE ISSUE TO BE RESOLVED.
4. LONE STAR STRUCTURAL RELEASES ALL LIABILITY FOR THE PERFORMANCE OF THE FOUNDATION AND FRAMING DESIGN, IF THE PRE-POUR / FRAMING INSPECTIONS ARE NOT COMPLETED BY LONE STAR STRUCTURAL, LLC OR ANY ALTERATIONS ARE MADE TO THE ORIGINAL PLAN USED FOR DESIGN WHICH ARE NOT REVIEWED AND APPROVED BY LONE STAR STRUCTURAL IN WRITING PRIOR TO COMPLETION.
5. THE STRUCTURAL SYSTEM FOR THIS PROJECT SHALL NOT BE CONSTRUCTED BY USING THE STRUCTURAL DRAWINGS ALONE. THESE DRAWINGS WERE DEVELOPED FROM DATA DERIVED PRIMARILY FROM THE ARCHITECTURAL DRAWINGS AND SECONDARILY FROM MEP, CIVIL AND OTHER DISCIPLINES. IT IS INTENDED THAT CONSTRUCTION PROCEED BY UTILIZING ALL OF THE INFORMATION CONTAINED IN THE ENTIRE SET OF CONSTRUCTION DOCUMENTS TAKEN AS A WHOLE; FAILURE TO DO SO WILL RESULT IN ERRORS WHICH SHALL BE CORRECTED AT THE CONTRACTORS EXPENSE.
6. BUILDER/ CONTRACTOR SHALL VERIFY BASE PLATE DIRECTION PRIOR TO SETTING.
7. ALL BASE PLATES, SHALL BE TAPPED DOWN WITH A HAMMER OR LIGHTLY VIBRATED TO REDUCE VOIDS BELOW THE BASE PLATE, ALL PLATES SHALL BE SET FLUSH WITH THE FINISHED ELEVATION.
8. ALL WELDS SHALL BE FULL PENETRATING WELDS. BEVEL ALL EDGES PRIOR TO WELDING.
9. ALL CONNECTIONS SHALL BE CONSIDERED MOMENT CONNECTIONS UNLESS OTHERWISE NOTED.
10. UNLESS NOTED, ALL STEEL MEMBERS SHALL BE FULLY WELDED WITH $\frac{3}{16}$ " FULL PENETRATING WELD, ALL




**LONE STAR
STRUCTURAL, LLC**

WWW.LONESTARSTRUCTURAL.COM | TEXAS REGISTERED FIRM F-20642 | P: 210.827.5509

SINNERS AND SAINTS

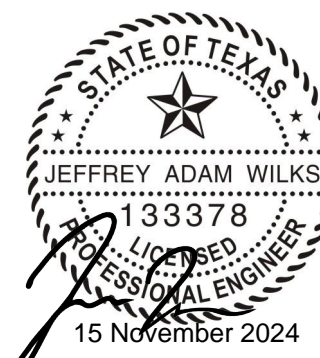19186 FM 2252
GARDEN RIDGE, TEXAS 78266



JOB: 2423LAJ05292024

DATE: 15 NOVEMBER 2024

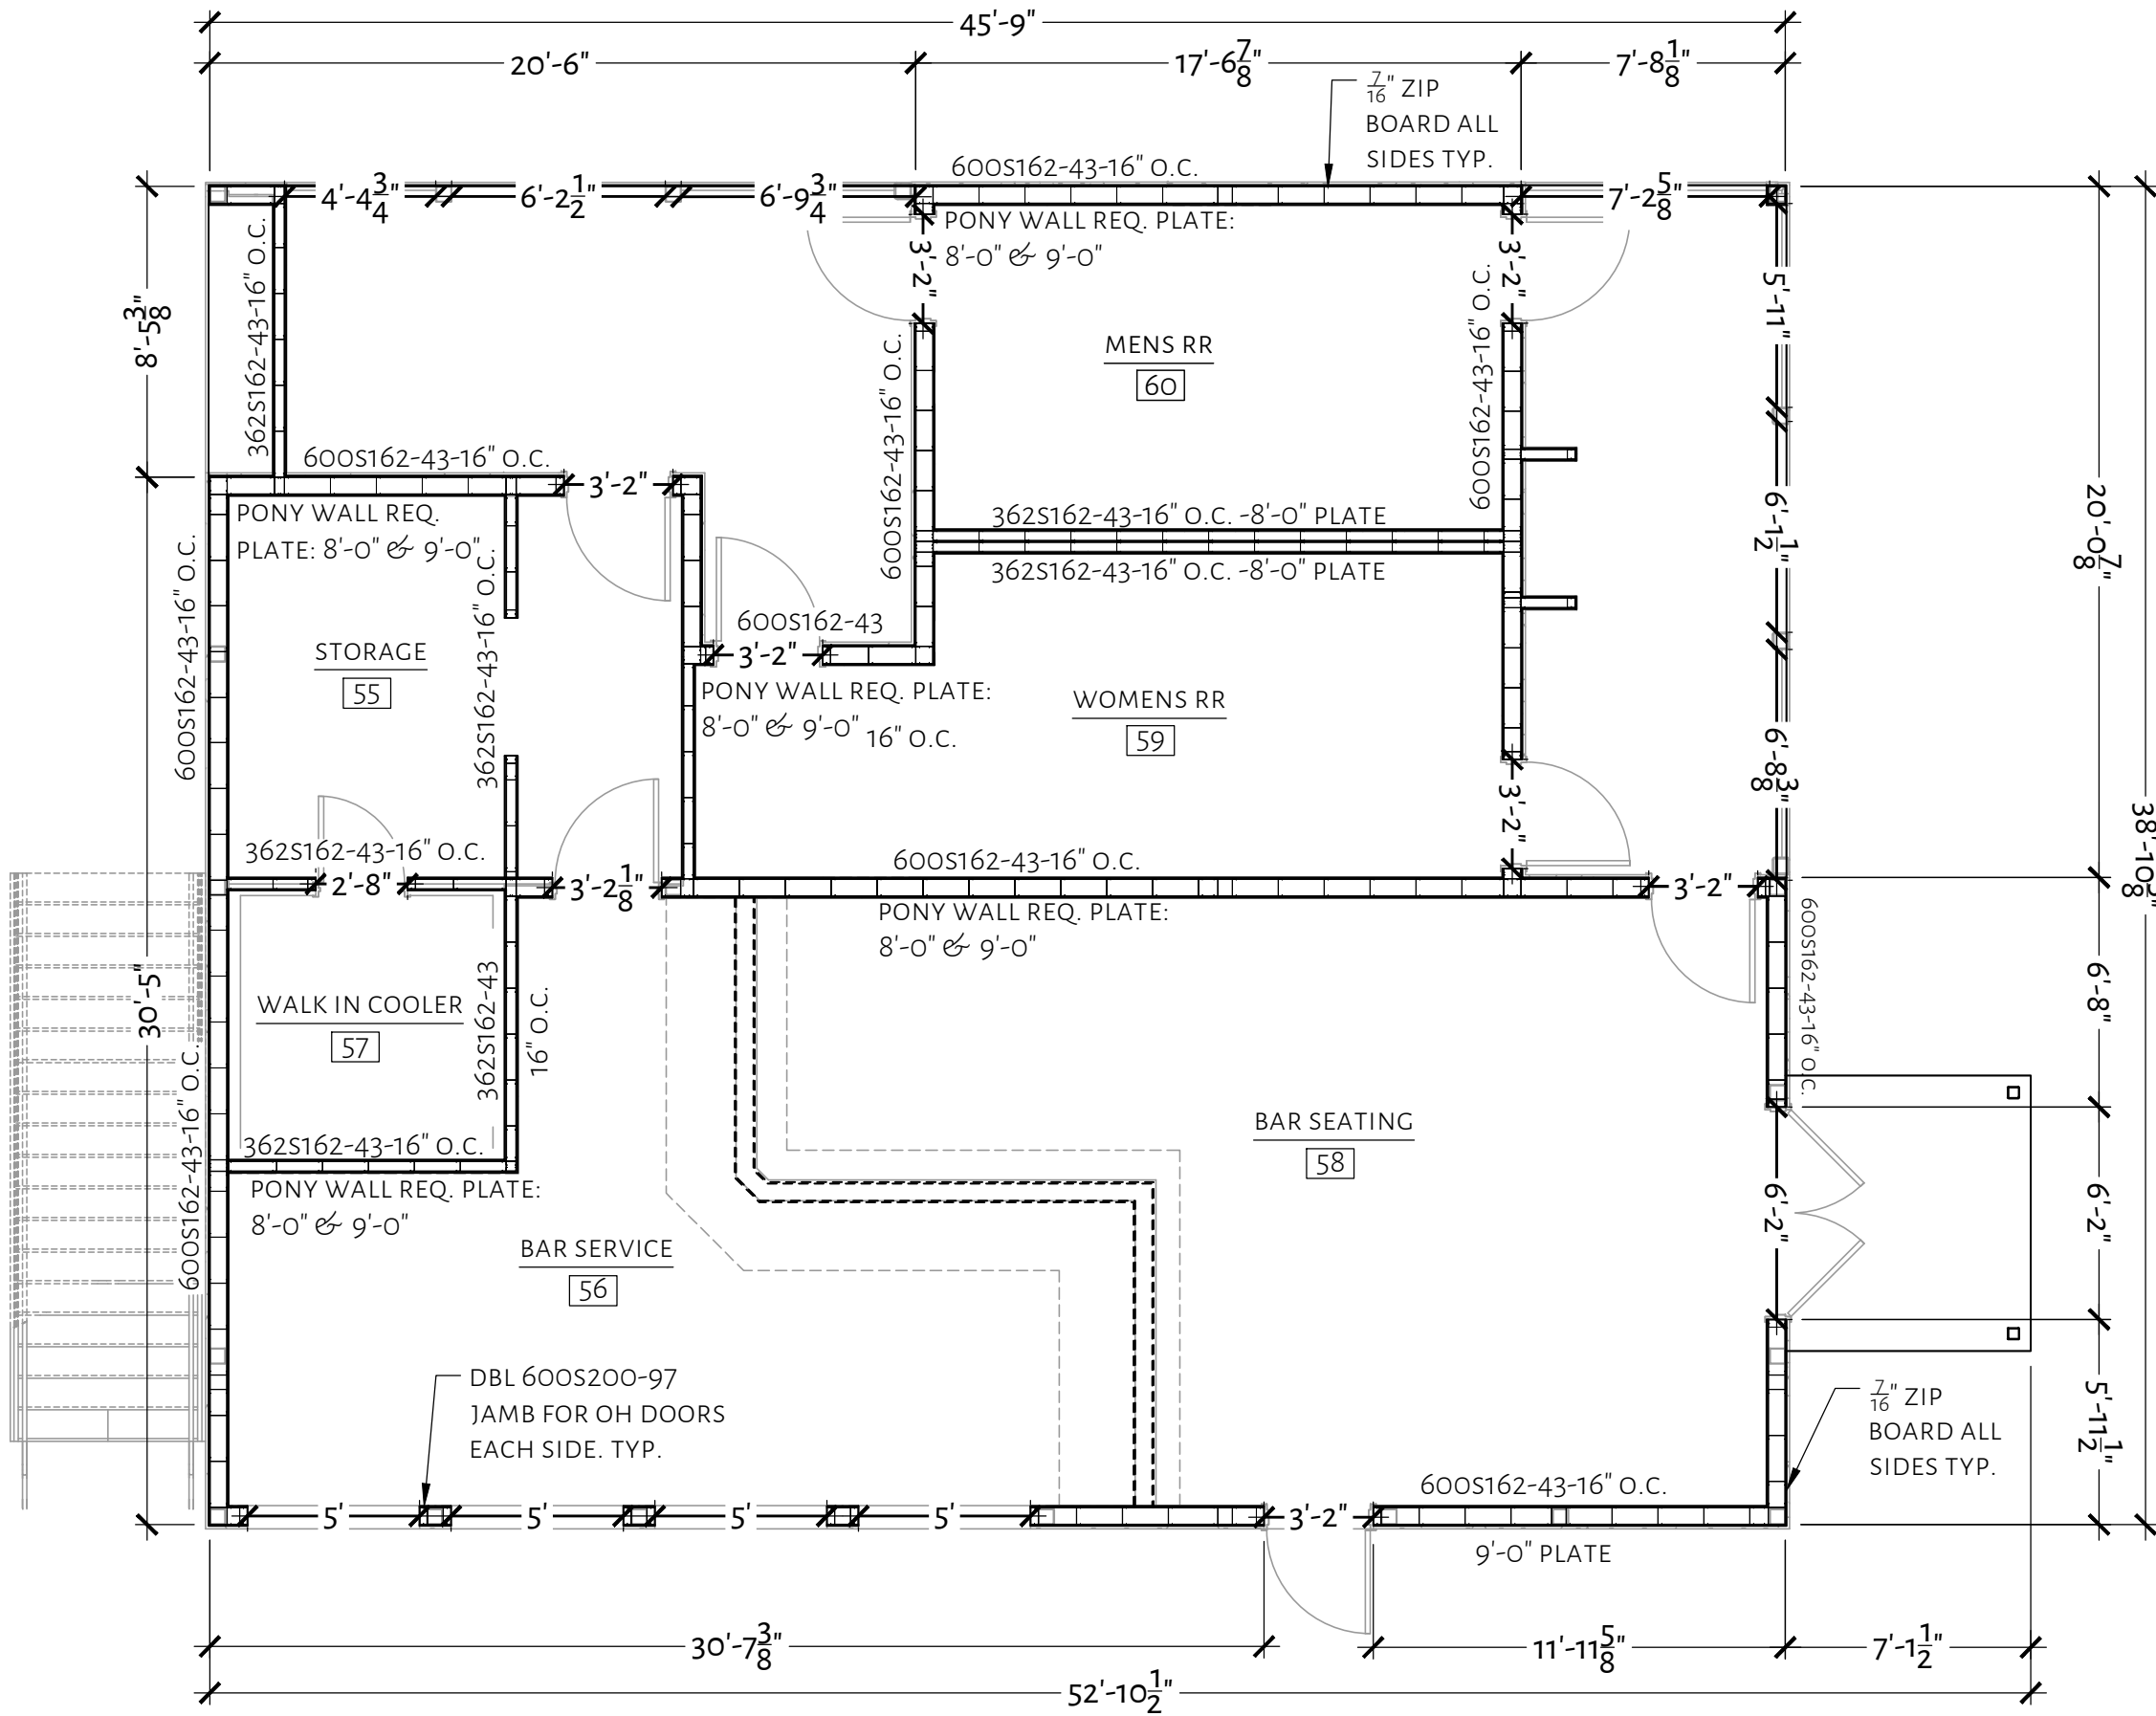
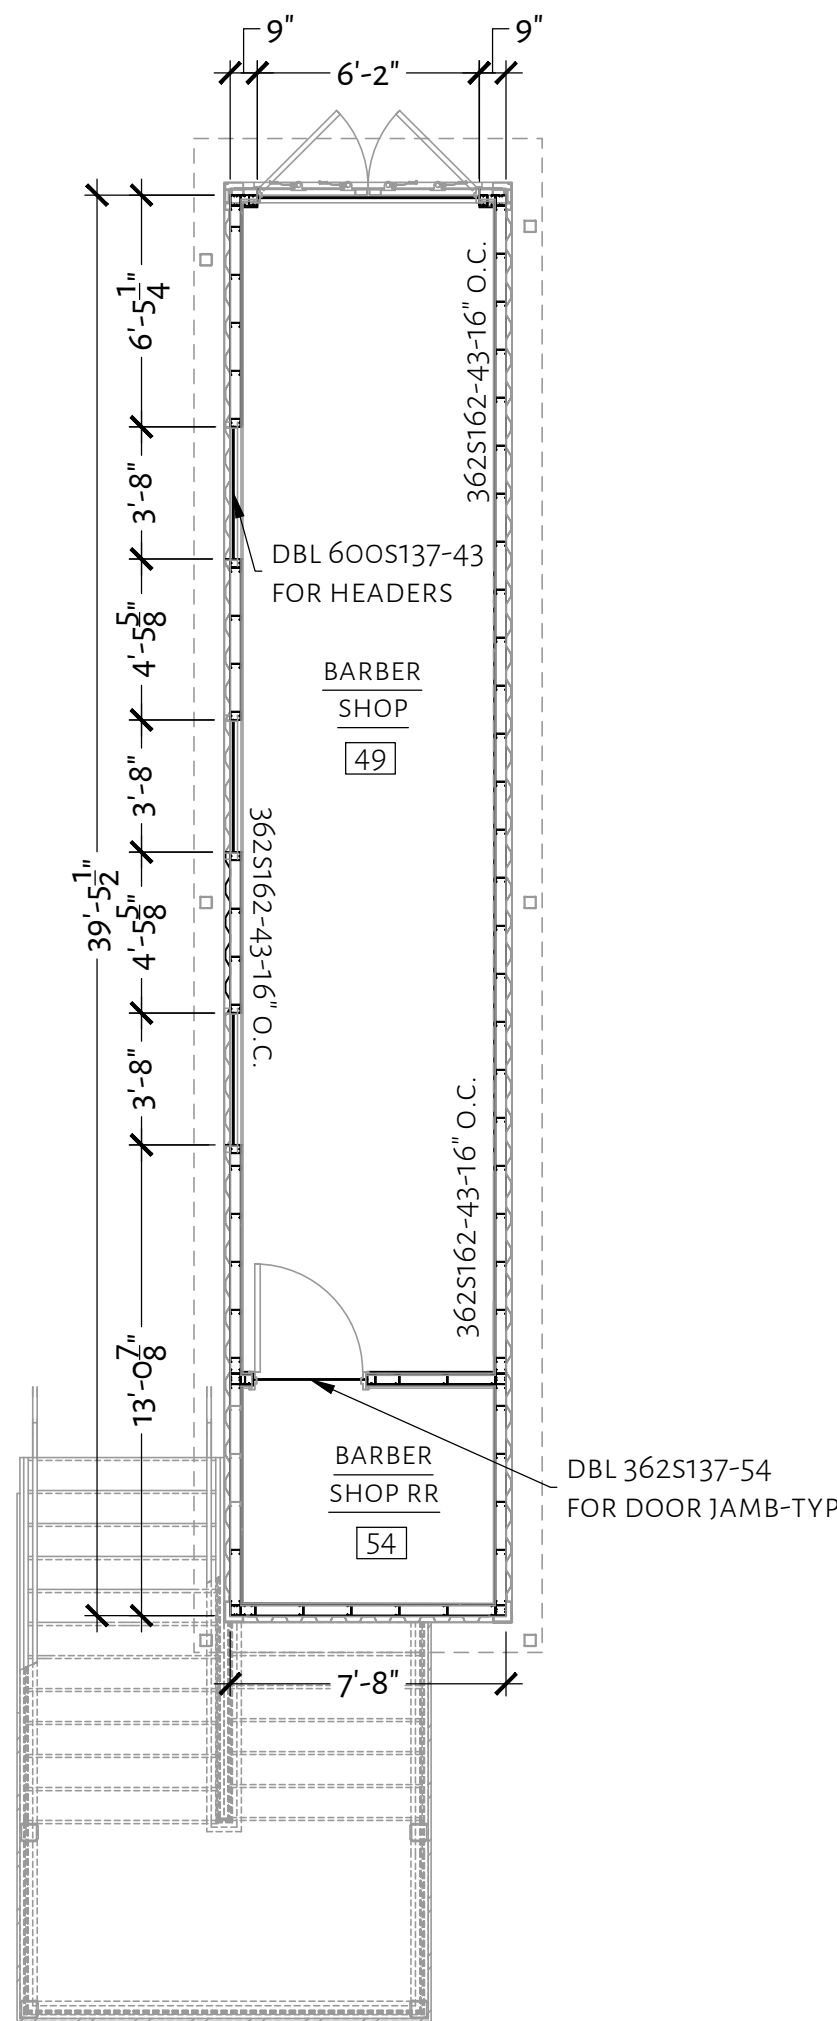
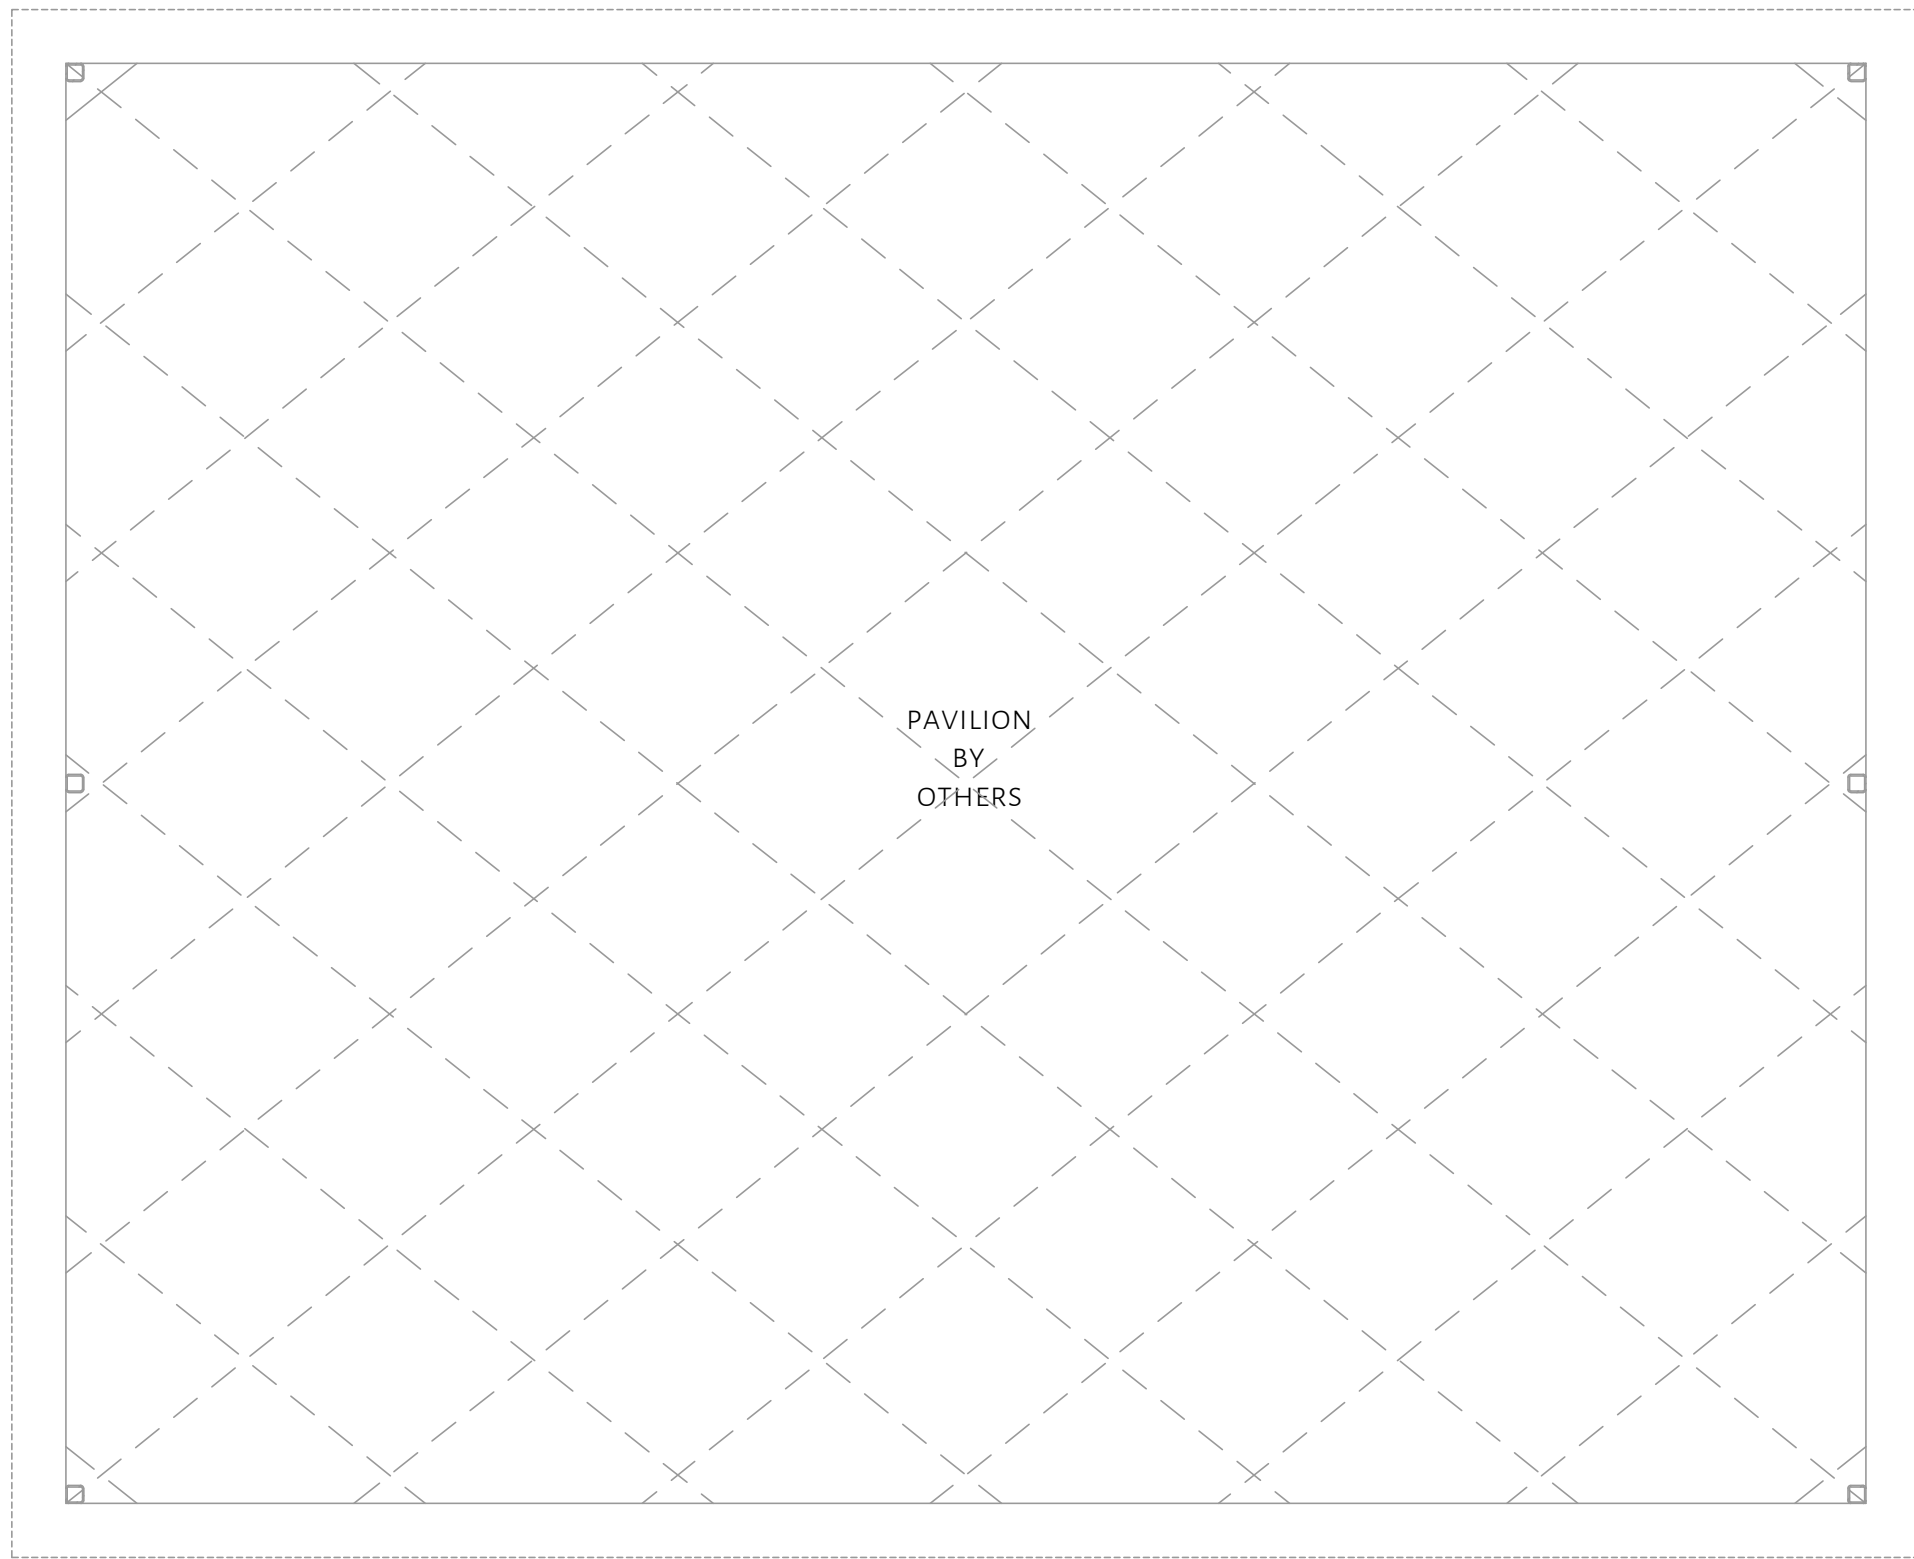
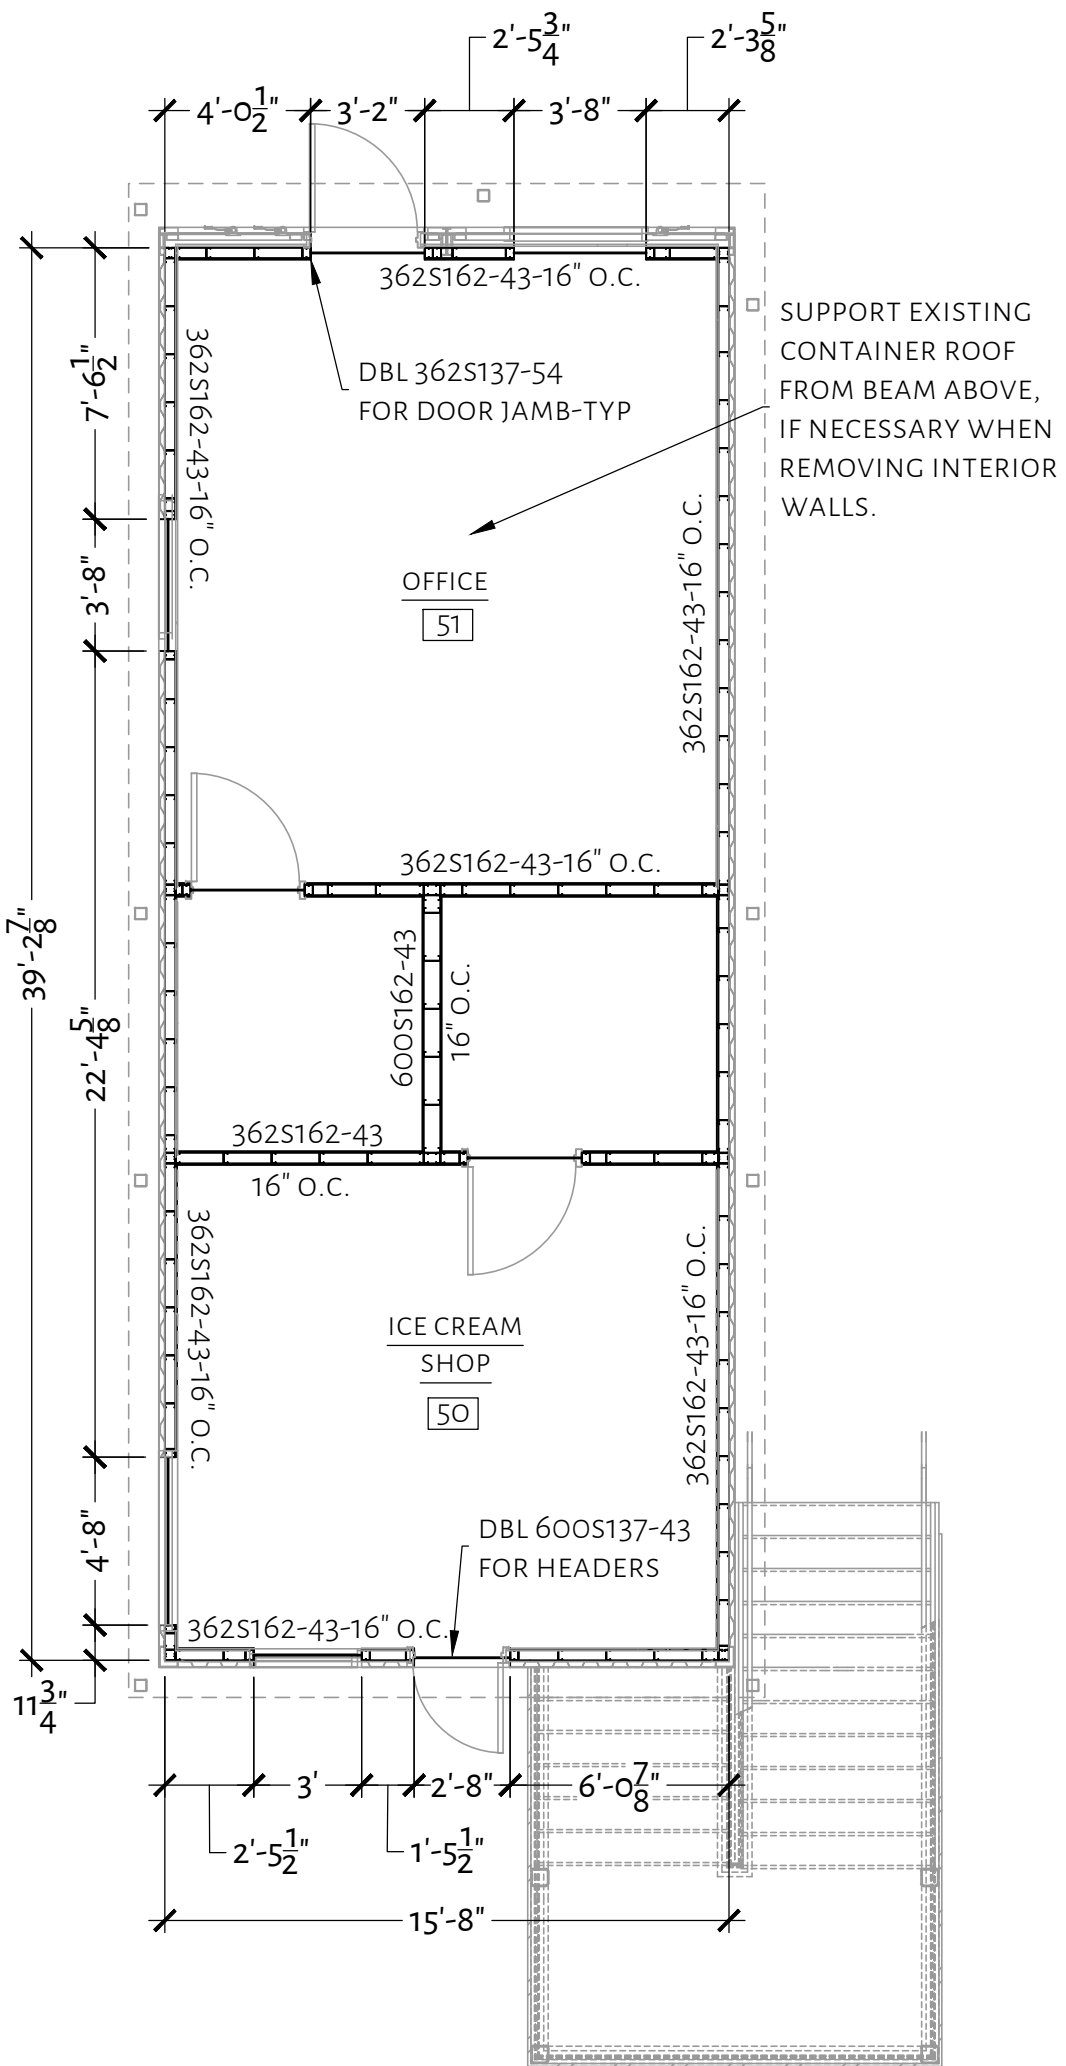
DRAWN: JW DESIGN: JW

OVERALL STEEL FRAMING

SHEET:

S3.0


Date: Nov 13, 2024, 7:50am User ID: jwilk
File: D:\Lone Star Structural Dropbox\Lone Star Structural\13 - Active Projects\2024\24231\A105292024 - Sinners and Saints.dwg



NOTE:
SEE S8.1 FOR COLD FORMED DETAILS

NOTES

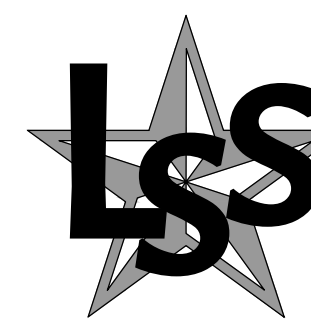- THIS DESIGN IS SITE SPECIFIC AND MAY NOT BE USED FOR DIFFERENT SITE LOCATIONS WITHOUT WRITTEN PERMISSION FROM LONE STAR STRUCTURAL, LLC.
- DETAILS PROVIDED ARE FOR INSTALLATION GUIDANCE. ALTERNATE DESIGNS SHALL BE ALLOWED AND APPROVED BY THE SEOR.
- ALL DIMENSIONS SHALL BE VERIFIED WITH THE ARCHITECTURAL DESIGN. IF A DISCREPANCY EXIST, NOTIFY THE ARCHITECT AND SEOR IN WRITING FOR THE ISSUE TO BE RESOLVED.
- LONE STAR STRUCTURAL RELEASES ALL LIABILITY FOR THE PERFORMANCE OF THE FOUNDATION AND FRAMING DESIGN, IF THE PRE-POUR / FRAMING INSPECTIONS ARE NOT COMPLETED BY LONE STAR STRUCTURAL, LLC OR ANY ALTERATIONS ARE MADE TO THE ORIGINAL PLAN USED FOR DESIGN WHICH ARE NOT REVIEWED AND APPROVED BY LONE STAR STRUCTURAL IN WRITING PRIOR TO COMPLETION. THE STRUCTURAL SYSTEM FOR THIS PROJECT SHALL NOT BE CONSTRUCTED BY USING THE STRUCTURAL DRAWINGS ALONE. THESE DRAWINGS WERE DEVELOPED FROM DATA DERIVED PRIMARILY FROM THE ARCHITECTURAL DRAWINGS AND SECONDARILY FROM MEP, CIVIL AND OTHER DISCIPLINES. IT IS INTENDED THAT CONSTRUCTION PROCEED BY UTILIZING ALL OF THE INFORMATION CONTAINED IN THE ENTIRE SET OF CONSTRUCTION DOCUMENTS TAKEN AS A WHOLE, FAILURE TO DO SO WILL RESULT IN ERRORS WHICH SHALL BE CORRECTED AT THE CONTRACTORS EXPENSE.
- BUILDER/ CONTRACTOR SHALL VERIFY ALL UNSUPPORTED SPANS SHOWN. IF THE SPAN EXCEEDS SPANS SHOWN GREATER THAN 4' CONTACT ENGINEER.
- SIZES IN HEADER SCHEDULE SHOWN ARE MINIMUMS, FOR CONTRACTIBILITY THE CONTRACTOR CAN INCREASE BEAM DEPTHS AND PLIES.
- DIMENSIONS SHOWN, ARE NOT ROUGH OPENING SIZES. CONTRACTOR SHALL COMPARE WITH WINDOW AND DOOR SCHEDULE PROVIDED BY OTHERS, AND ADJUST AS NECESSARY.
- ALL EXTERIOR WALLS, SHALL HAVE BLOCKING AT MID HEIGHT.
- ALL TRACKS SHALL BE SECURED TO STEEL FRAMING A MINIMUM 24" O.C.




**LONE STAR
STRUCTURAL, LLC**

WWW.LONESTARSTRUCTURAL.COM | TEXAS REGISTERED FIRM F-20642 | P: 210.827.5509

SINNERS AND SAINTS

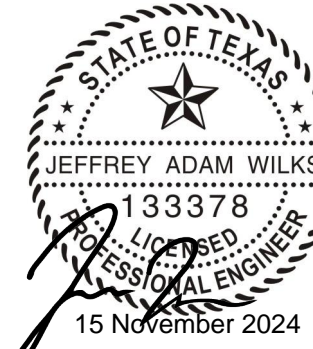19186 FM 2252
GARDEN RIDGE, TEXAS 78266



JOB: 24231A105292024

DATE: 15 NOVEMBER 2024

DRAWN: JW DESIGN: JW

OVERALL LIGHT GAUGE FRAMING

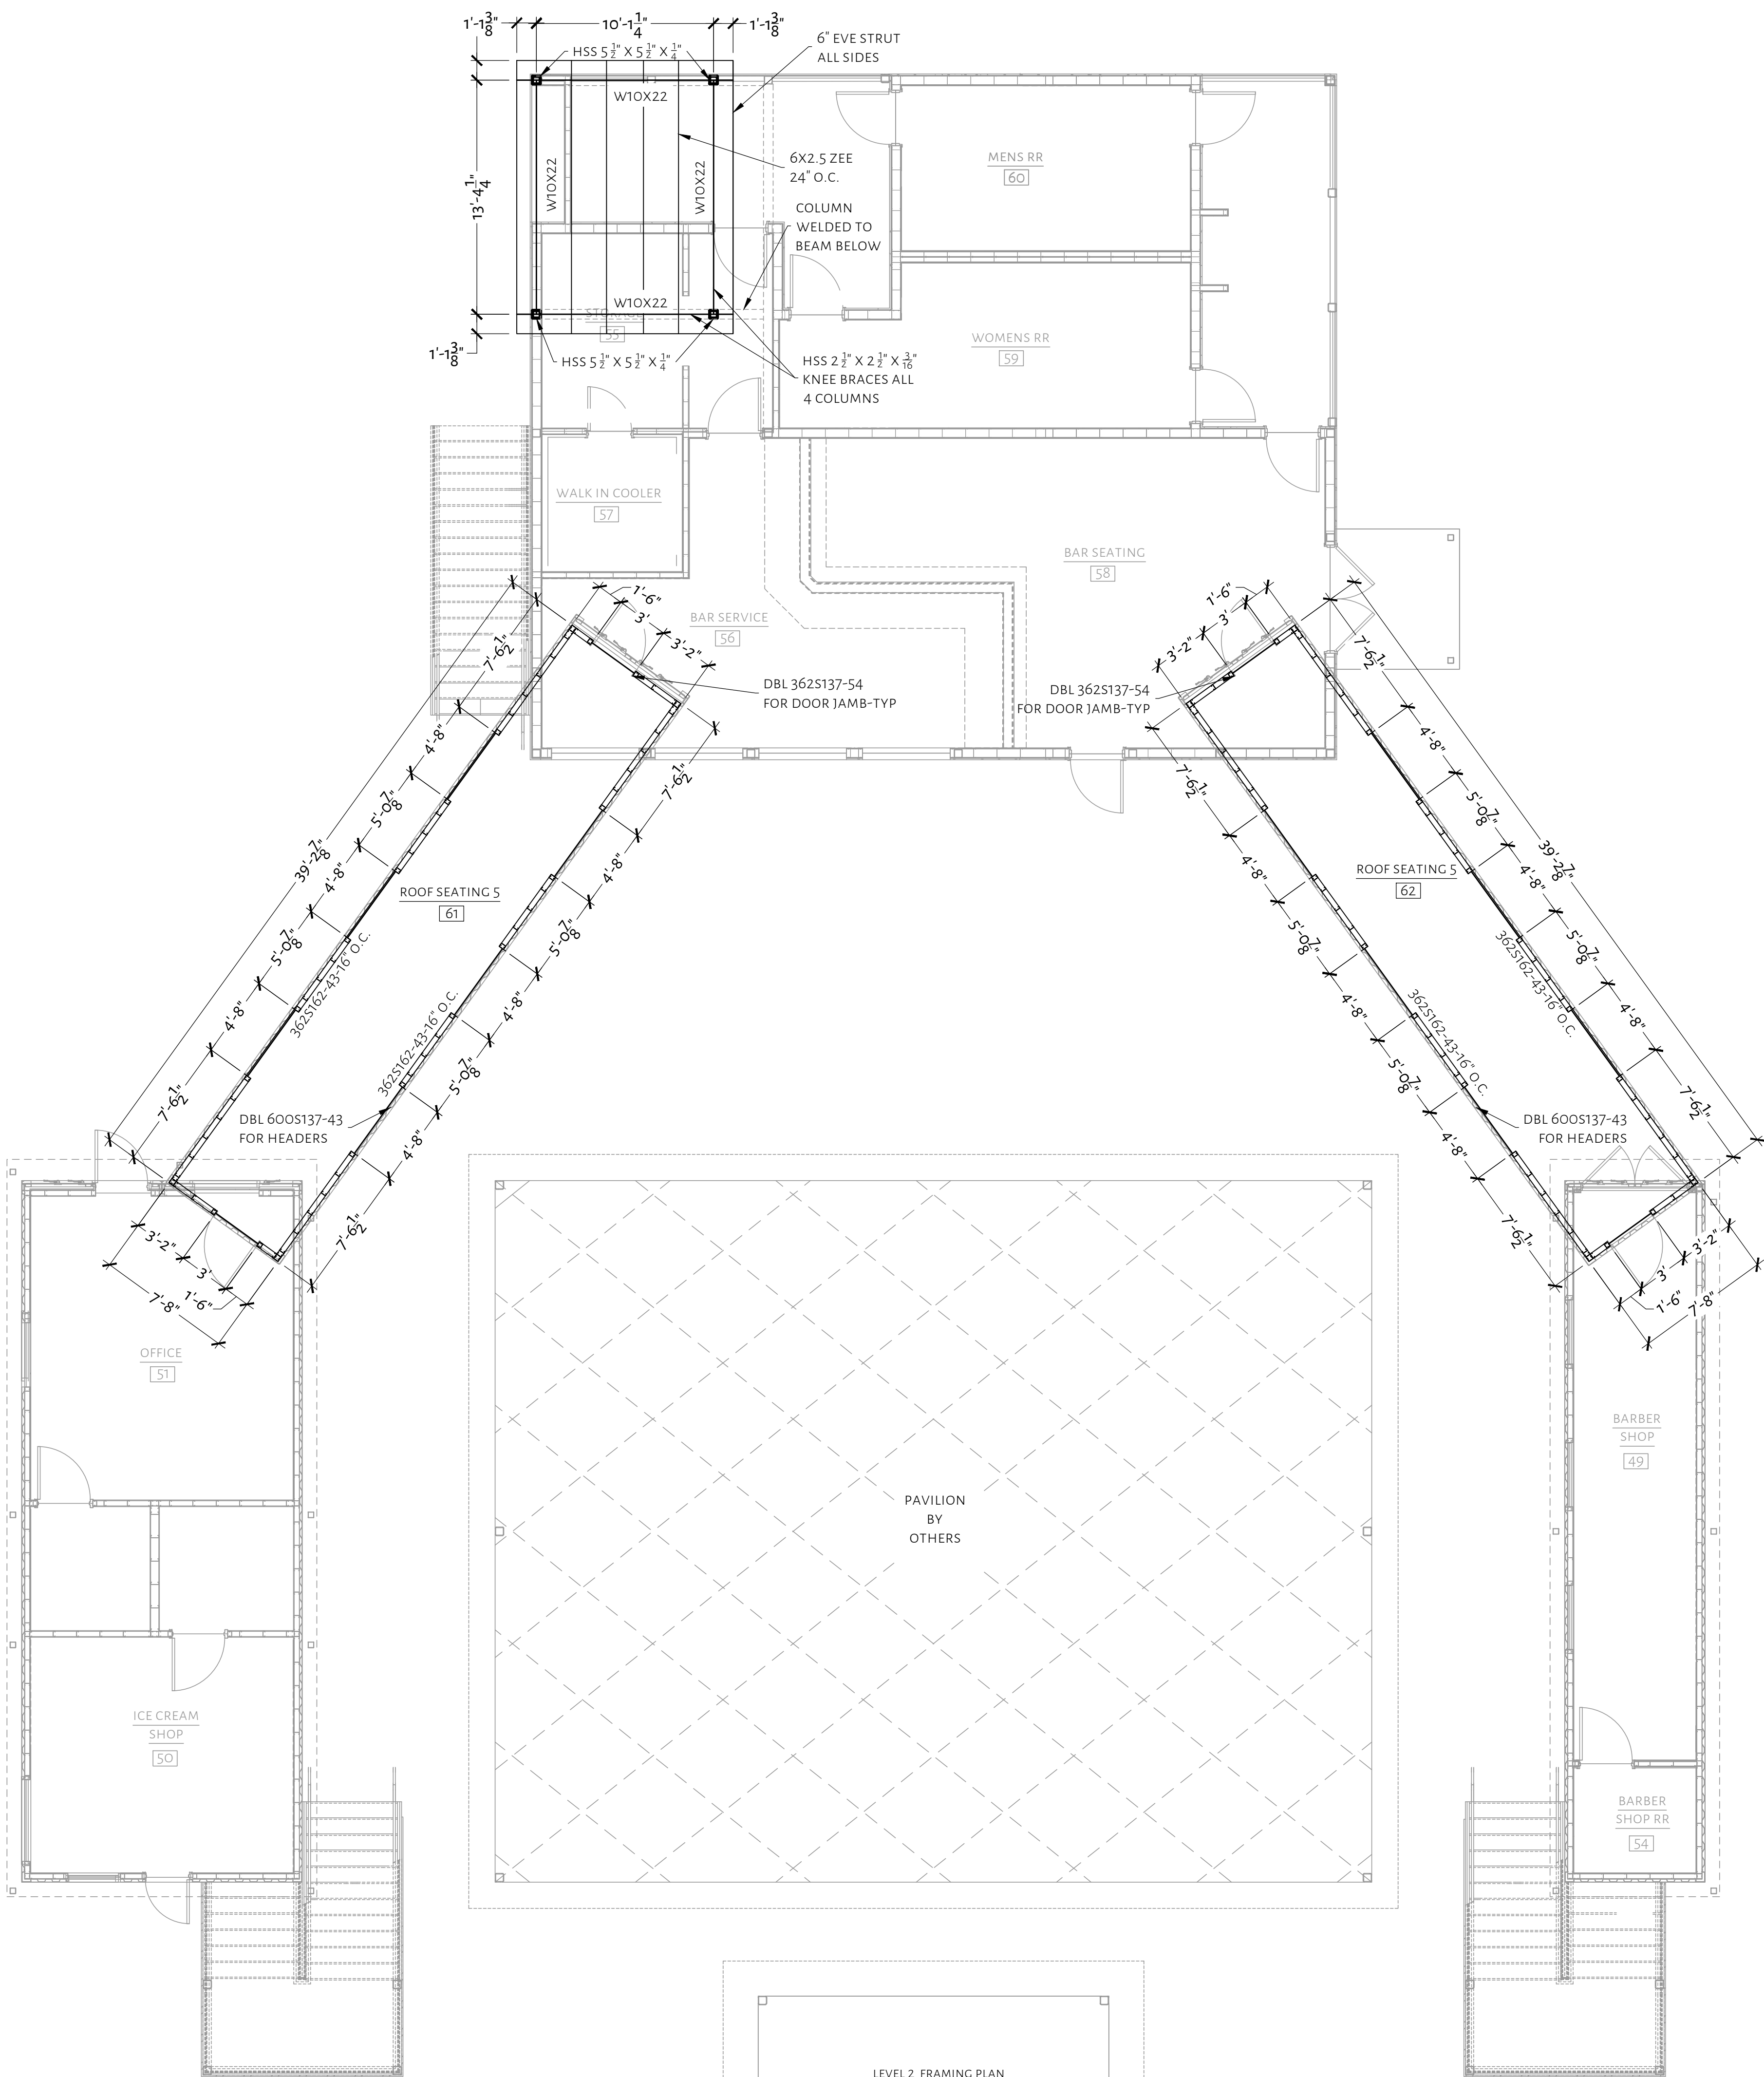
SHEET:

S4.0


NOTE:
SEE S8.1 FOR COLD FORMED DETAILS

NOTES

- THIS DESIGN IS SITE SPECIFIC AND MAY NOT BE USED FOR DIFFERENT SITE LOCATIONS WITHOUT WRITTEN PERMISSION FROM LONE STAR STRUCTURAL, LLC.
- DETAILS PROVIDED ARE FOR INSTALLATION GUIDANCE. ALTERNATE DESIGNS SHALL BE ALLOWED AND APPROVED BY THE SEOR.
- ALL DIMENSIONS SHALL BE VERIFIED WITH THE ARCHITECTURAL DESIGN. IF A DISCREPANCY EXIST, NOTIFY THE ARCHITECT AND SEOR IN WRITING FOR THE ISSUE TO BE RESOLVED.
- LONE STAR STRUCTURAL RELEASES ALL LIABILITY FOR THE PERFORMANCE OF THE FOUNDATION AND FRAMING DESIGN, IF THE PRE-POUR / FRAMING INSPECTIONS ARE NOT COMPLETED BY LONE STAR STRUCTURAL, LLC OR ANY ALTERATIONS ARE MADE TO THE ORIGINAL PLAN USED FOR DESIGN WHICH ARE NOT REVIEWED AND APPROVED BY LONE STAR STRUCTURAL IN WRITING PRIOR TO COMPLETION. THE STRUCTURAL SYSTEM FOR THIS PROJECT SHALL NOT BE CONSTRUCTED BY USING THE STRUCTURAL DRAWINGS ALONE. THESE DRAWINGS WERE DEVELOPED FROM DATA DERIVED PRIMARILY FROM THE ARCHITECTURAL DRAWINGS AND SECONDARILY FROM MEP, CIVIL AND OTHER DISCIPLINES. IT IS INTENDED THAT CONSTRUCTION PROCEED BY UTILIZING ALL OF THE INFORMATION CONTAINED IN THE ENTIRE SET OF CONSTRUCTION DOCUMENTS TAKEN AS A WHOLE. FAILURE TO DO SO WILL RESULT IN ERRORS WHICH SHALL BE CORRECTED AT THE CONTRACTORS EXPENSE.
- BUILDER/ CONTRACTOR SHALL VERIFY ALL UNSUPPORTED SPANS SHOWN. IF THE SPAN EXCEEDS SPANS SHOWN GREATER THAN 4' CONTACT ENGINEER.
- SIZES IN HEADER SCHEDULE SHOWN ARE MINIMUMS, FOR CONTRACTIBILITY THE CONTRACTOR CAN INCREASE BEAM DEPTHS AND PLIES.
- DIMENSIONS SHOWN, ARE NOT ROUGH OPENING SIZES. CONTRACTOR SHALL COMPARE WITH WINDOW AND DOOR SCHEDULE PROVIDED BY OTHERS, AND ADJUST AS NECESSARY.
- ALL EXTERIOR WALLS, SHALL HAVE BLOCKING AT MID HEIGHT.
- ALL TRACKS SHALL BE SECURED TO STEEL FRAMING A MINIMUM 24" O.C.



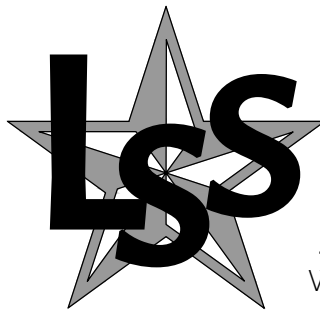LEVEL 2 FRAMING PLAN
SCALE: 1/8" = 1'-0"




**LONE STAR
STRUCTURAL, LLC**

WWW.LONESTARSTRUCTURAL.COM | TEXAS REGISTERED FIRM F-20642 | P: 210.827.5509


SINNERS AND SAINTS

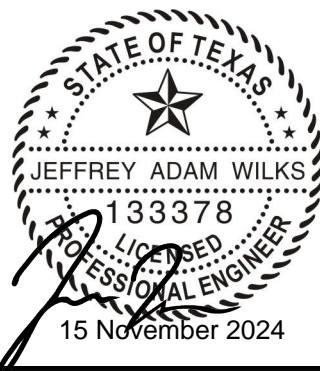19186 FM 2252
GARDEN RIDGE, TEXAS 78266




JOB: 2423LAI05292024
DATE: 15 NOVEMBER 2024
DRAWN: JW | DESIGN: JW
LVL 2 LIGHT GAUGE FRAMING
SHEET:
S4.1

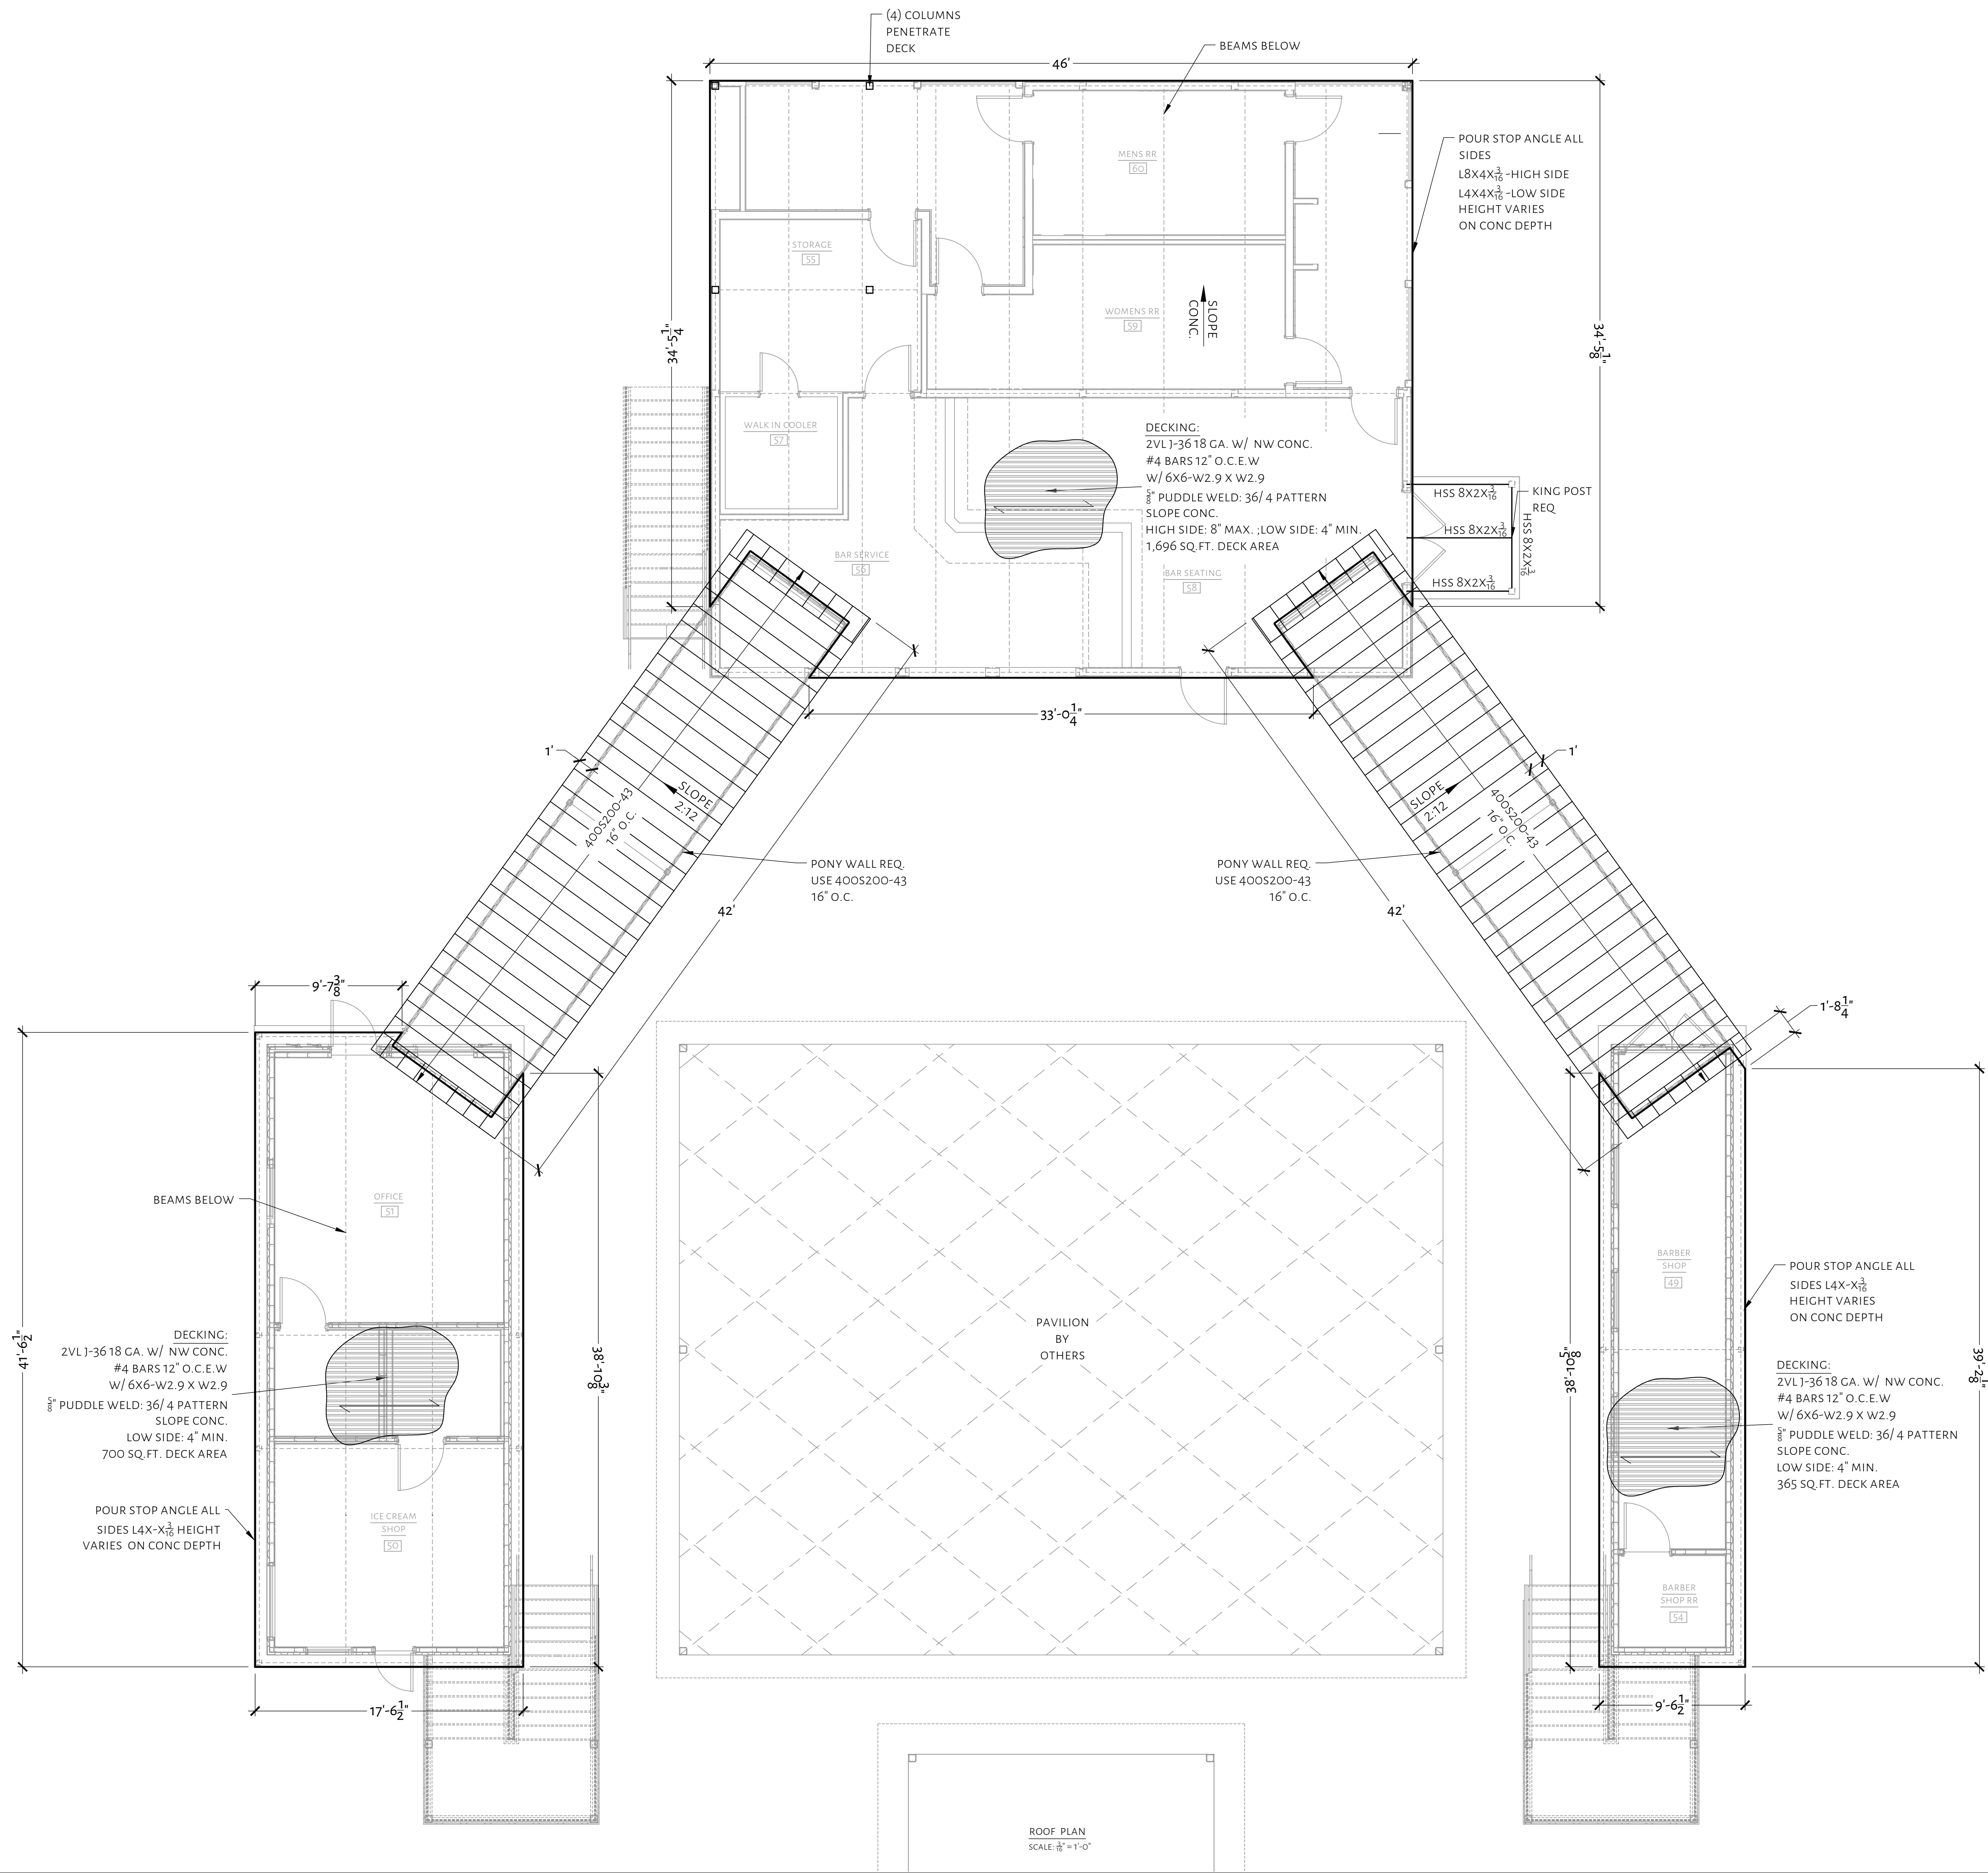Date: Nov 13, 2024, 7:51am User ID: jwilk
File D:\Lone Star Structural Dropbox\Lone Star Structural\13 -Active Projects\2024\24231AU05292024 -Sinners and Saints.dwg



NOTES

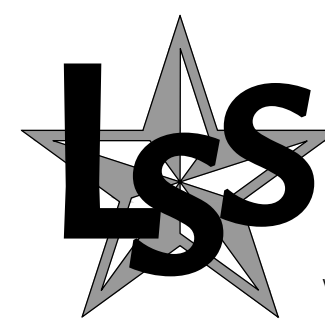- THIS DESIGN IS SITE SPECIFIC AND MAY NOT BE USED FOR DIFFERENT SITE LOCATIONS WITHOUT WRITTEN PERMISSION FROM LONE STAR STRUCTURAL, LLC.
- DETAILS PROVIDED ARE FOR INSTALLATION GUIDANCE. ALTERNATE DESIGNS SHALL BE ALLOWED AND APPROVED BY THE SEOR.
- ALL DIMENSIONS SHALL BE VERIFIED WITH THE ARCHITECTURAL DESIGN. IF A DISCREPANCY EXIST, NOTIFY THE ARCHITECT AND SEOR IN WRITING FOR THE ISSUE TO BE RESOLVED.
- LONE STAR STRUCTURAL RELEASES ALL LIABILITY FOR THE PERFORMANCE OF THE FOUNDATION AND FRAMING DESIGN, IF THE PRE-POUR / FRAMING INSPECTIONS ARE NOT COMPLETED BY LONE STAR STRUCTURAL, LLC OR ANY ALTERATIONS ARE MADE TO THE ORIGINAL PLAN USED FOR DESIGN WHICH ARE NOT REVIEWED AND APPROVED BY LONE STAR STRUCTURAL IN WRITING PRIOR TO COMPLETION.
- THE STRUCTURAL SYSTEM FOR THIS PROJECT SHALL NOT BE CONSTRUCTED BY USING THE STRUCTURAL DRAWINGS ALONE. THESE DRAWINGS WERE DEVELOPED FROM DATA DERIVED PRIMARILY FROM THE ARCHITECTURAL DRAWINGS AND SECONDARILY FROM MEP, CIVIL AND OTHER DISCIPLINES. IT IS INTENDED THAT CONSTRUCTION PROCEED BY UTILIZING ALL OF THE INFORMATION CONTAINED IN THE ENTIRE SET OF CONSTRUCTION DOCUMENTS TAKEN AS A WHOLE; FAILURE TO DO SO WILL RESULT IN ERRORS WHICH SHALL BE CORRECTED AT THE CONTRACTORS EXPENSE.
- BUILDER/ CONTRACTOR SHALL VERIFY ALL UNSUPPORTED SPANS SHOWN. IF THE SPAN EXCEEDS SPANS SHOWN GREATER THAN 4" CONTACT ENGINEER.
- SIZES IN HEADER SCHEDULE SHOWN ARE MINIMUMS, FOR CONTRACTIBILITY THE CONTRACTOR CAN INCREASE BEAM DEPTHS AND PLIES.
- CONTRACTOR SHALL INSTALL THE DECKING ACCORDING TO THE MANUFACTURERS SPECIFICATIONS.
- VERIFY ALL UNSHORED SPANS, AND FOLLOW ALL NECESSARY SHORING RECOMMENDATIONS AS PROVIDED BY THE MANUFACTURER.



**LONE STAR
STRUCTURAL, LLC**

WWW.LONESTARSTRUCTURAL.COM | TEXAS REGISTERED FIRM F-20642 | P: 210.827.5509

SINNERS AND SAINTS

19186 FM 2252
GARDEN RIDGE, TEXAS 78266



JOB: 24231AU05292024

DATE: 15 NOVEMBER 2024

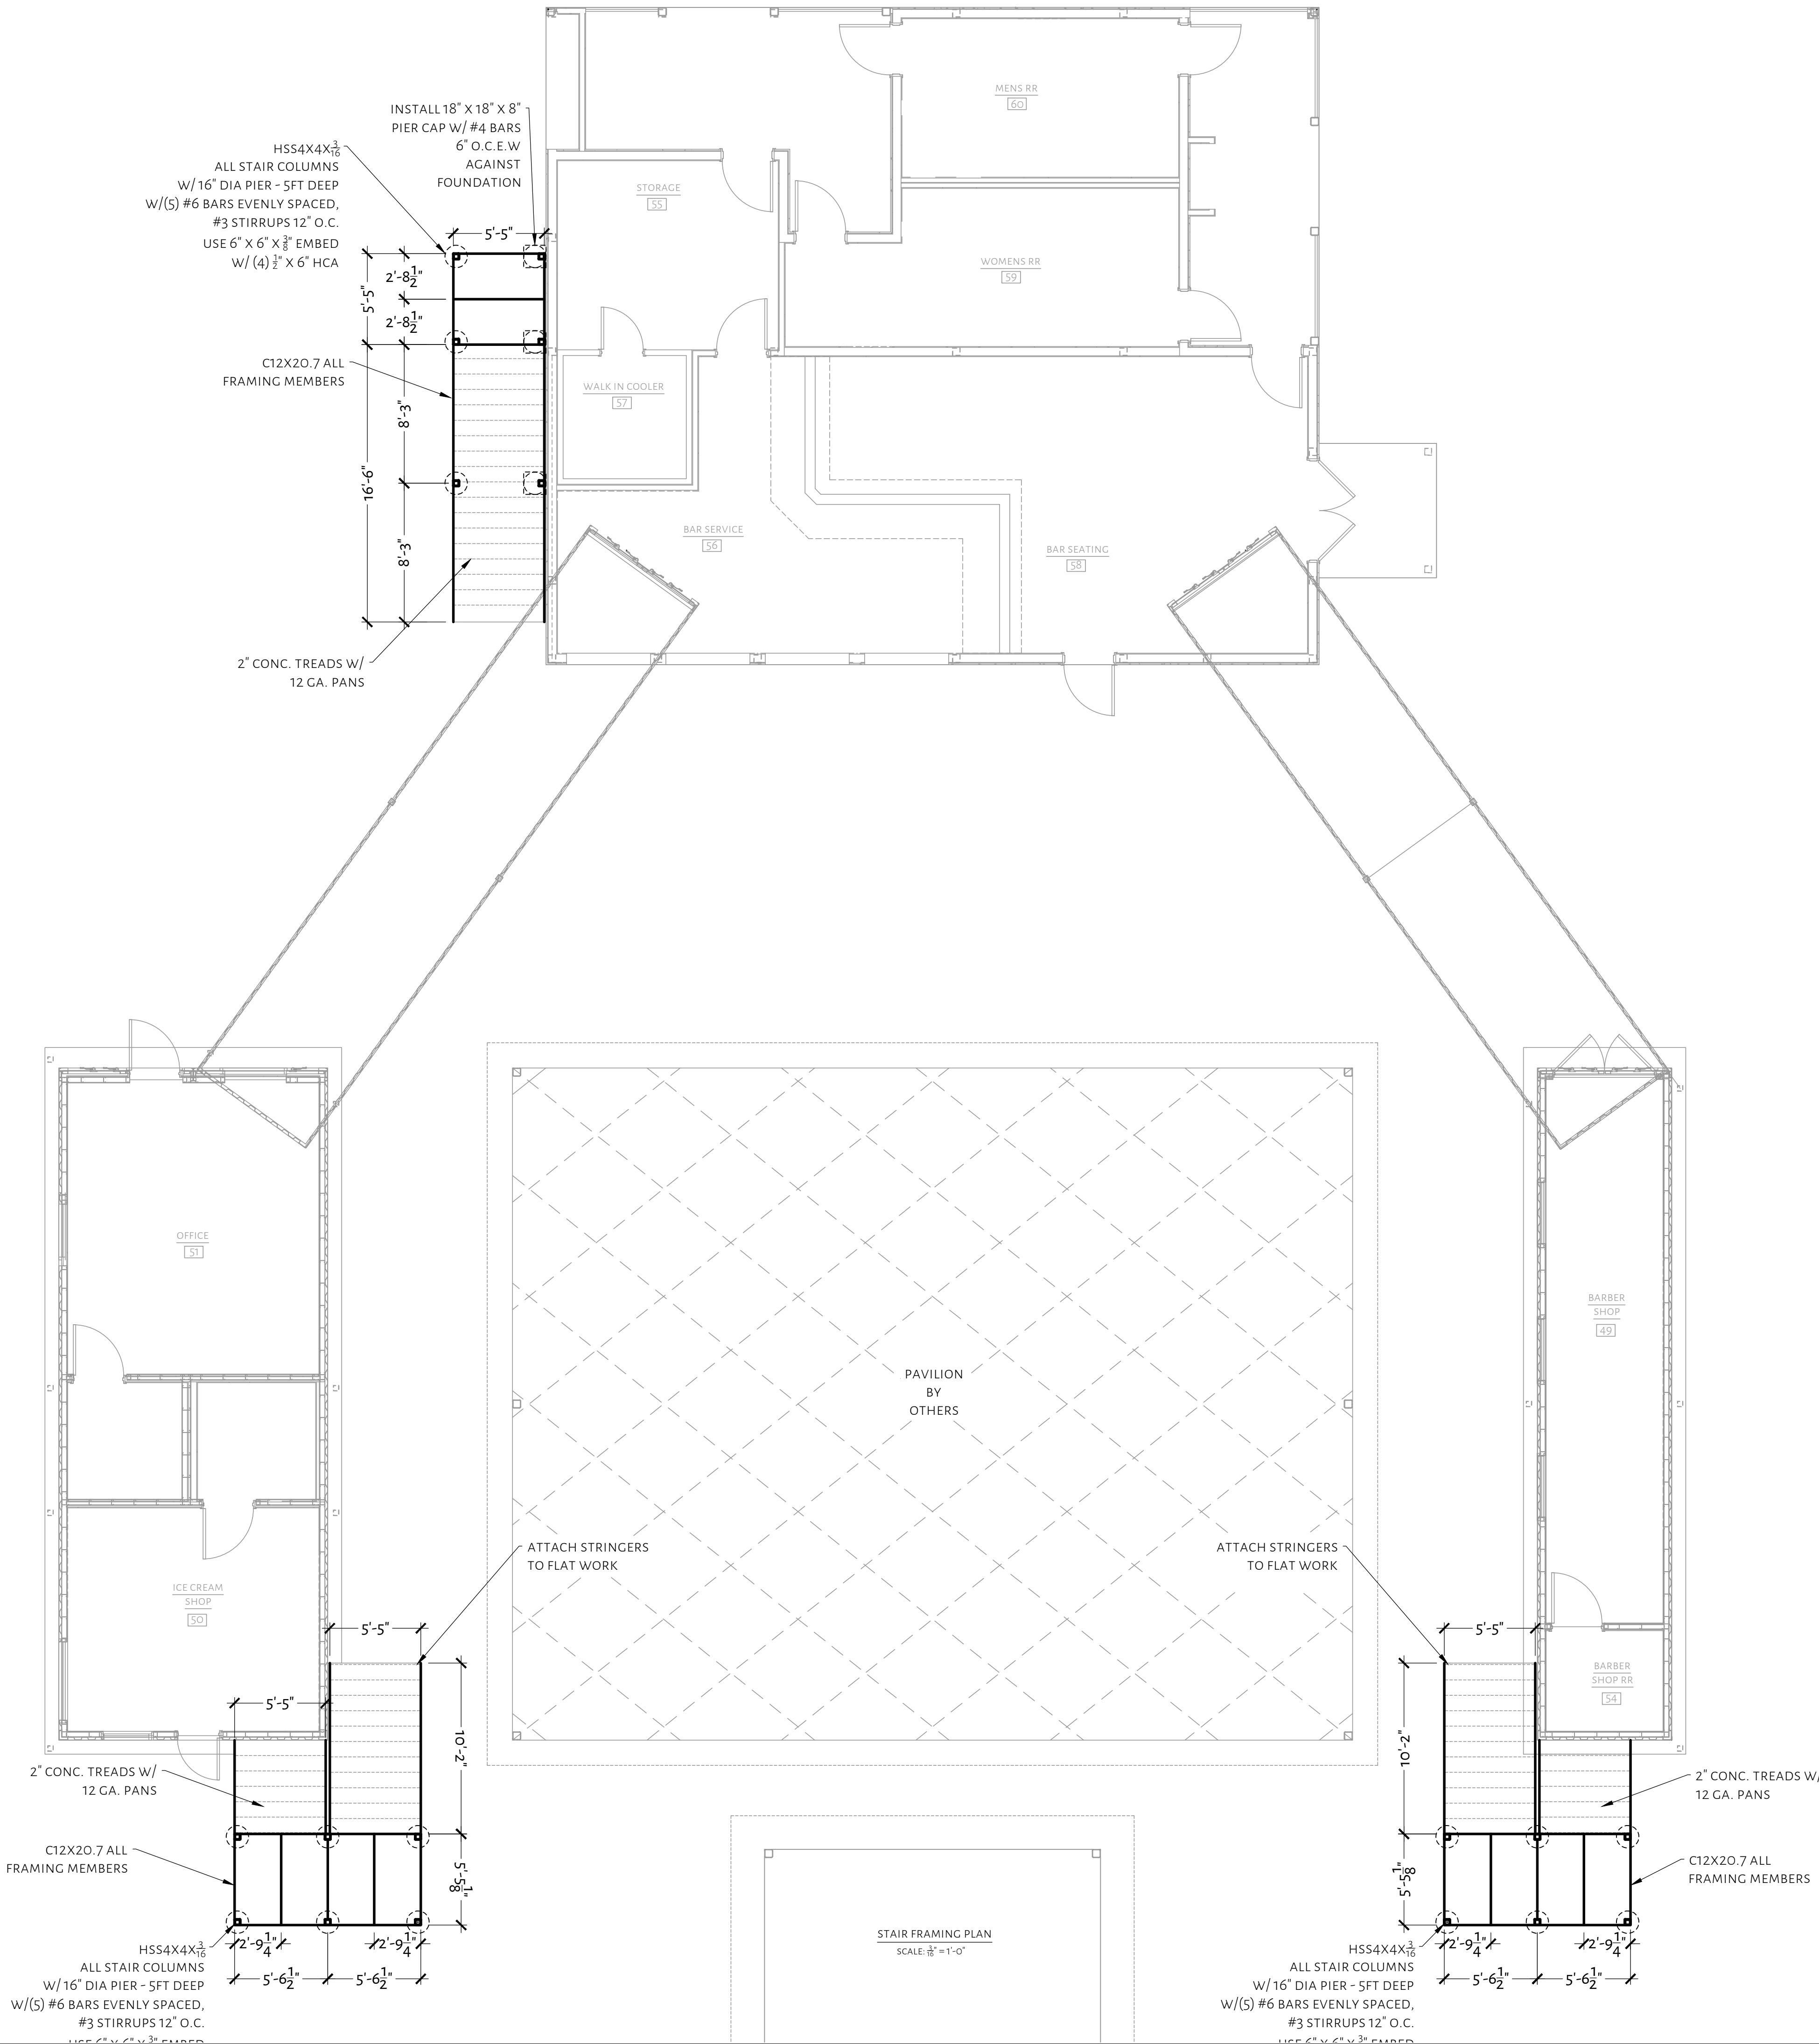
DRAWN: JW DESIGN: JW

OVERALL ROOF PLAN

SHEET:


S5.0

Date: Nov 13, 2024, 7:51am User ID: jwilk
File D:\Lone Star Structural Dropbox\Lone Star Structural\13 - Active Projects\2024\24231\AUG292024 - Sinners and Saints.dwg



NOTES

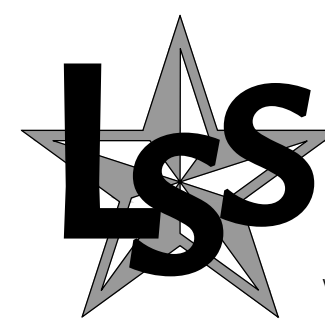- THIS DESIGN IS SITE SPECIFIC AND MAY NOT BE USED FOR DIFFERENT SITE LOCATIONS WITHOUT WRITTEN PERMISSION FROM LONE STAR STRUCTURAL, LLC.
- DETAILS PROVIDED ARE FOR INSTALLATION GUIDANCE. ALTERNATE DESIGNS SHALL BE ALLOWED AND APPROVED BY THE SEOR.
- ALL DIMENSIONS SHALL BE VERIFIED WITH THE ARCHITECTURAL DESIGN. IF A DISCREPANCY EXIST, NOTIFY THE ARCHITECT AND SEOR IN WRITING FOR THE ISSUE TO BE RESOLVED.
- LONE STAR STRUCTURAL RELEASES ALL LIABILITY FOR THE PERFORMANCE OF THE FOUNDATION AND FRAMING DESIGN, IF THE PRE-POUR / FRAMING INSPECTIONS ARE NOT COMPLETED BY LONE STAR STRUCTURAL, LLC OR ANY ALTERATIONS ARE MADE TO THE ORIGINAL PLAN USED FOR DESIGN WHICH ARE NOT REVIEWED AND APPROVED BY LONE STAR STRUCTURAL IN WRITING PRIOR TO COMPLETION. THE STRUCTURAL SYSTEM FOR THIS PROJECT SHALL NOT BE CONSTRUCTED BY USING THE STRUCTURAL DRAWINGS ALONE. THESE DRAWINGS WERE DEVELOPED FROM DATA DERIVED PRIMARILY FROM THE ARCHITECTURAL DRAWINGS AND SECONDARILY FROM MEP, CIVIL AND OTHER DISCIPLINES. IT IS INTENDED THAT CONSTRUCTION PROCEED BY UTILIZING ALL OF THE INFORMATION CONTAINED IN THE ENTIRE SET OF CONSTRUCTION DOCUMENTS TAKEN AS A WHOLE; FAILURE TO DO SO WILL RESULT IN ERRORS WHICH SHALL BE CORRECTED AT THE CONTRACTORS EXPENSE.
- BUILDER/ CONTRACTOR SHALL VERIFY ALL UNSUPPORTED SPANS SHOWN. IF THE SPAN EXCEEDS SPANS SHOWN GREATER THAN 4' CONTACT ENGINEER.
- SIZES IN HEADER SCHEDULE SHOWN ARE MINIMUMS, FOR CONTRACTIBILITY THE CONTRACTOR CAN INCREASE BEAM DEPTHS AND PLIES.
- CONTRACTOR SHALL INSTALL THE DECKING ACCORDING TO THE MANUFACTURERS SPECIFICATIONS. VERIFY ALL UNSHORED SPANS, AND FOLLOW ALL NECESSARY SHORING RECOMMENDATIONS AS PROVIDED BY THE MANUFACTURER.
- UNLESS NOTED, ALL STEEL MEMBERS SHALL BE COPED, AND FULLY WELDED WITH $\frac{3}{16}$ " FULL PENETRATING WELDS ALL SIDES.
- STAIR TREADS AND LANDINGS SHALL BE 2" 3,000 PSI CONCRETE FORMED WITH 12 GA. BENT PANS. CONC. PANS SHALL BE FASTENED WITH L2"X2" X $\frac{3}{8}$ " CLIPS FULLY WELDED TO STRINGERS. REINFORCE WITH WELDED MIRE MESH.




**LONE STAR
STRUCTURAL, LLC**

WWW.LONESTARSTRUCTURAL.COM | TEXAS REGISTERED FIRM F-20642 | P: 210.827.5509

SINNERS AND SAINTS

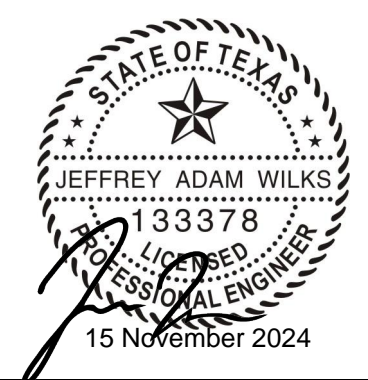19186 FM 2252
GARDEN RIDGE, TEXAS 78266



JOB: 24231AUG292024

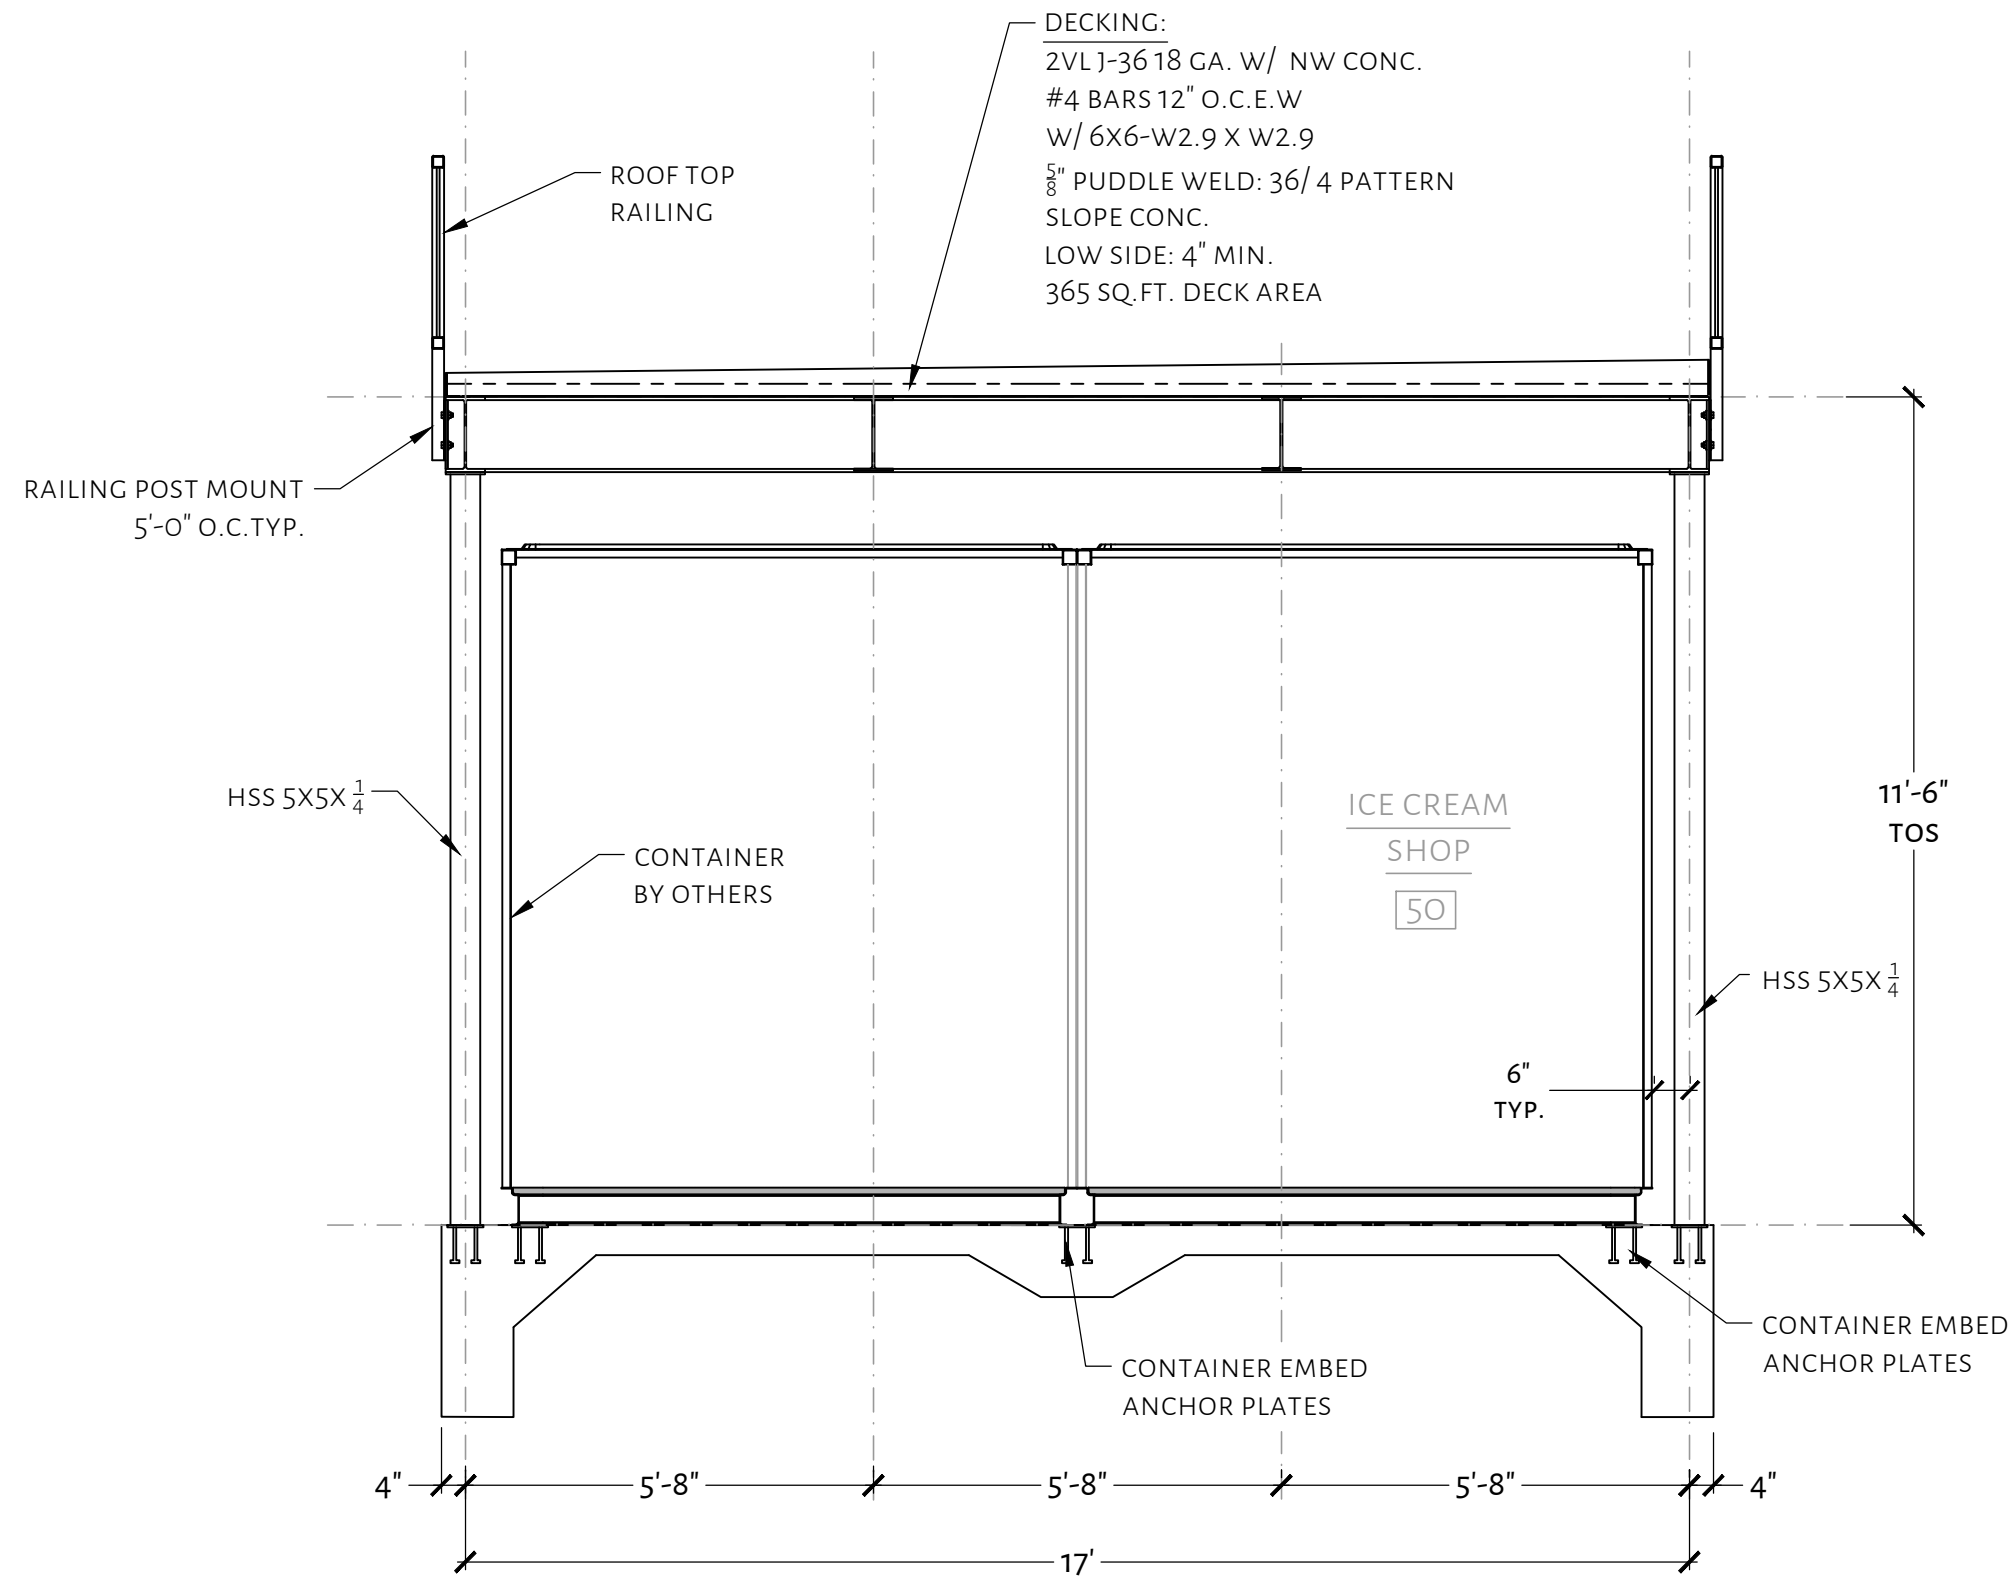
DATE: 15 NOVEMBER 2024

DRAWN: JW DESIGN: JW


STAIR FRAMING

SHEET:


S6.0



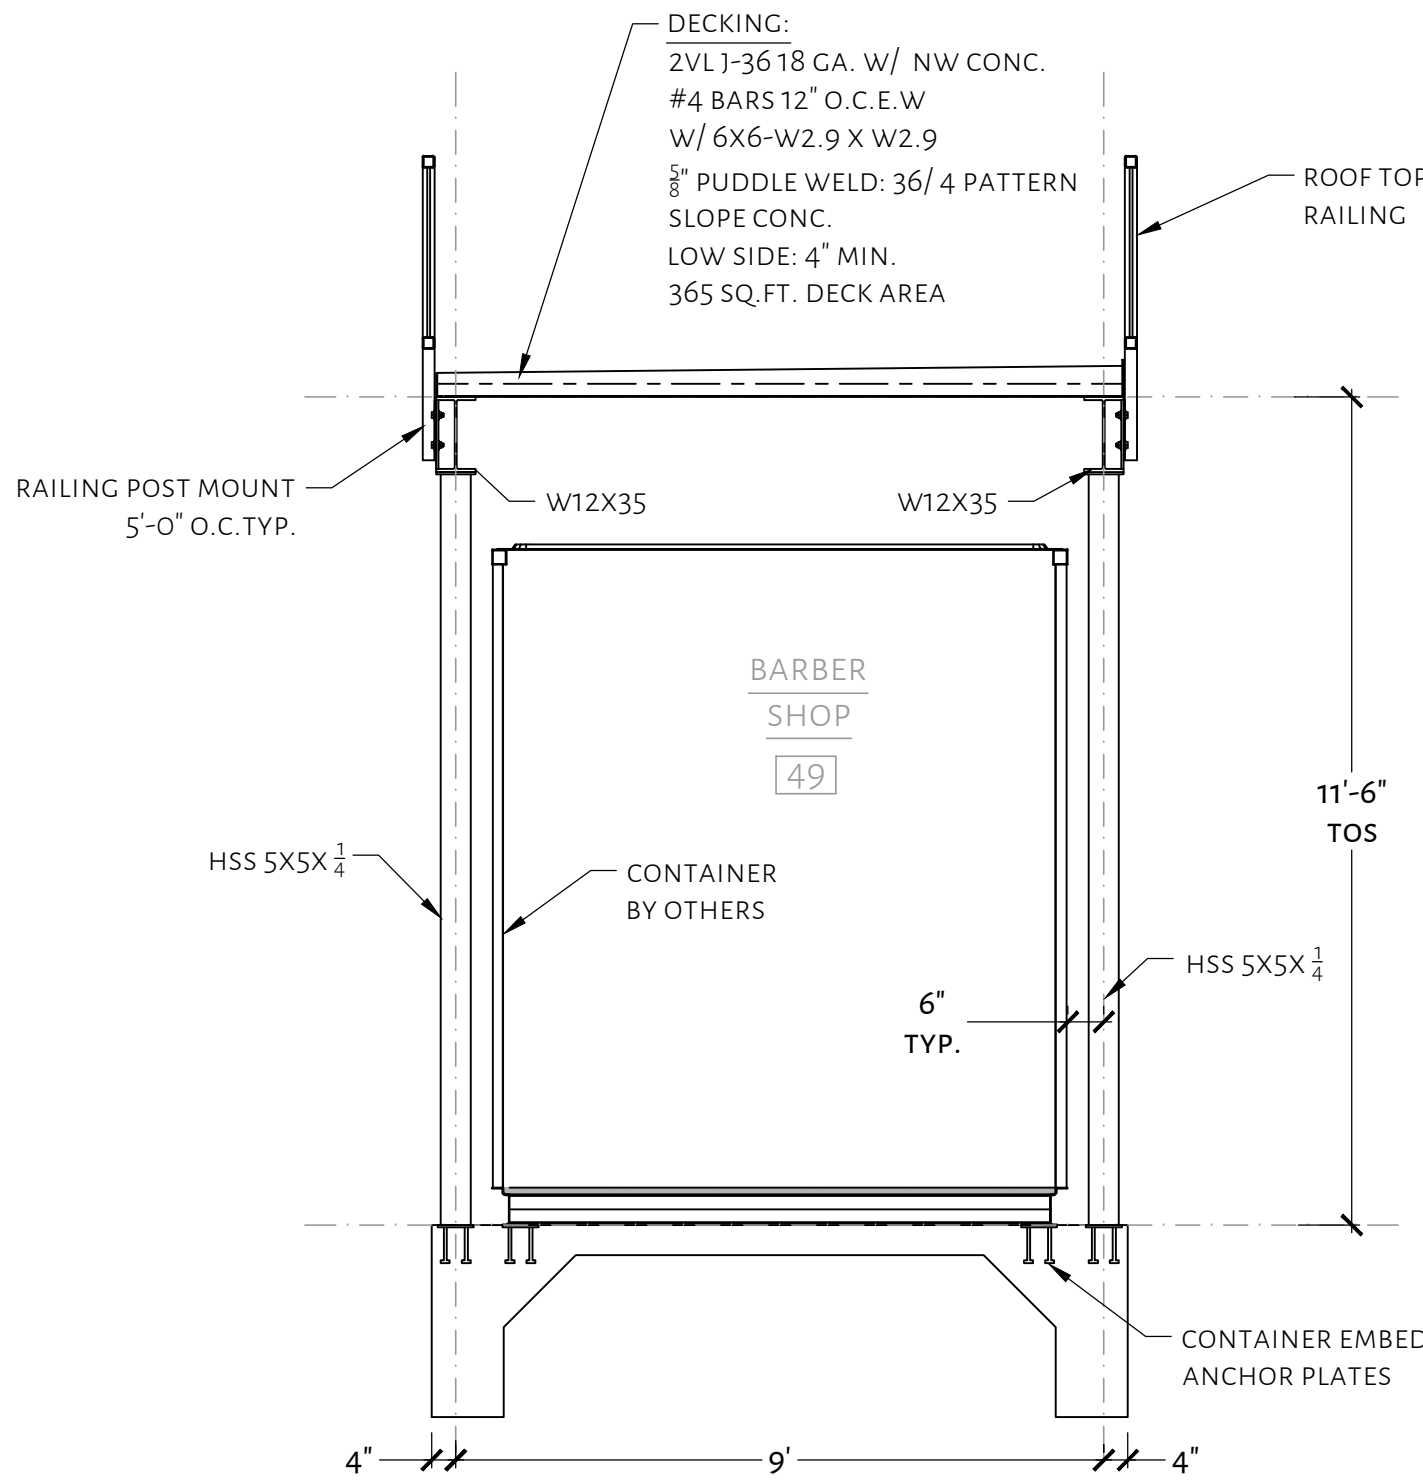
ICE CREAM SHOP
SCALE: $\frac{3}{8}$ " = 1'-0"



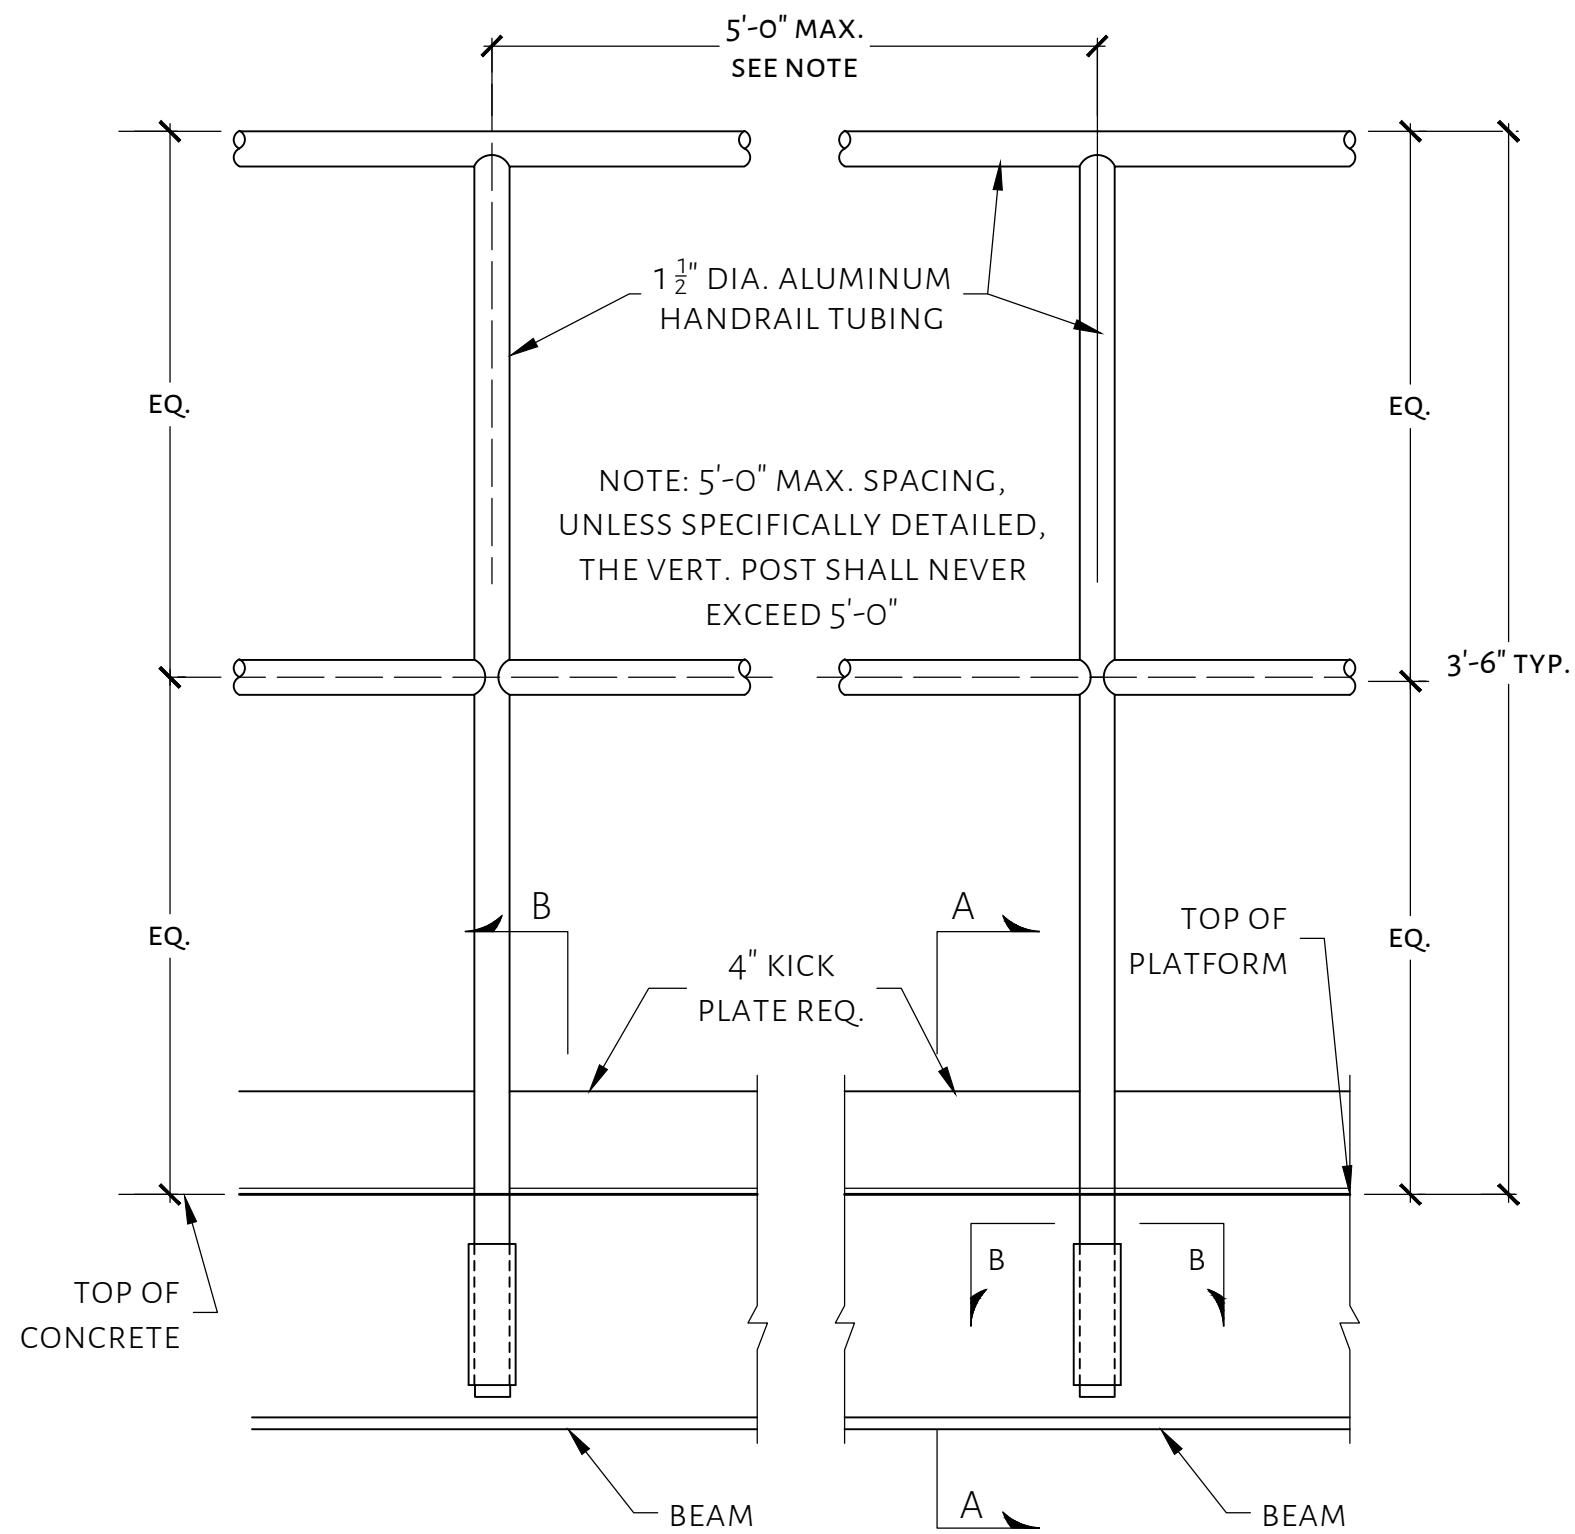
BARBER SHOP
SCALE: $\frac{3}{8}$ " = 1'-0"



ELEVATION

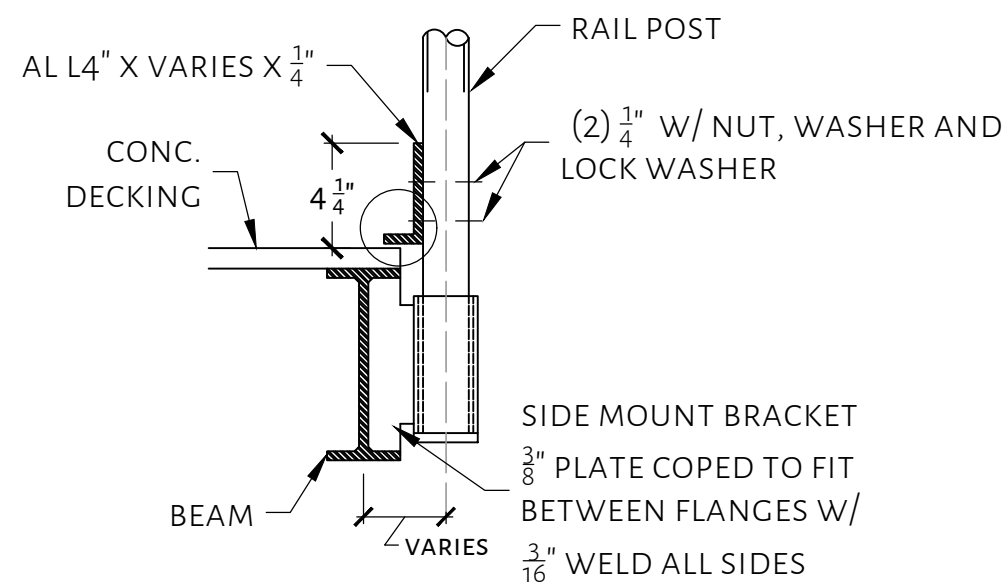

DETAIL SECTION "A"

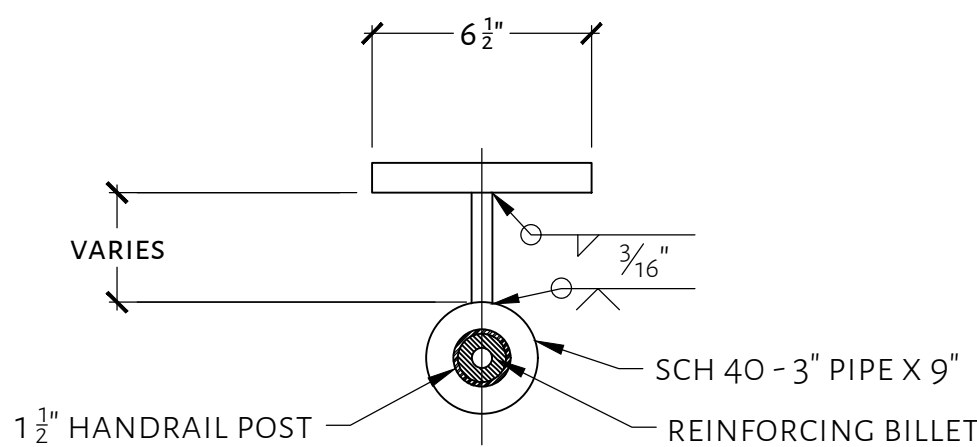


DETAIL SECTION "B"

SIDE MOUNT DETAILS

NOTES

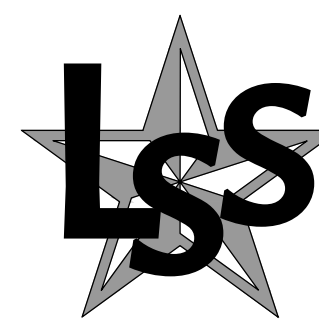- THIS DESIGN IS SITE SPECIFIC AND MAY NOT BE USED FOR DIFFERENT SITE LOCATIONS WITHOUT WRITTEN PERMISSION FROM LONE STAR STRUCTURAL, LLC.
- DETAILS PROVIDED ARE FOR INSTALLATION GUIDANCE. ALTERNATE DESIGNS SHALL BE ALLOWED AND APPROVED BY THE SEOR.
- ALL DIMENSIONS SHALL BE VERIFIED WITH THE DESIGNER PLANS. IF A DISCREPANCY EXIST, NOTIFY THE DESIGNER AND SEOR IN WRITING FOR THE ISSUE TO BE RESOLVED.
- LONE STAR STRUCTURAL RELEASES ALL LIABILITY FOR THE PERFORMANCE OF THE FOUNDATION AND FRAMING DESIGN, IF THE PRE-POUR / FRAMING INSPECTIONS ARE NOT COMPLETED BY LONE STAR STRUCTURAL, LLC OR ANY ALTERATIONS ARE MADE TO THE ORIGINAL PLAN USED FOR DESIGN WHICH ARE NOT REVIEWED AND APPROVED BY LONE STAR STRUCTURAL IN WRITING PRIOR TO COMPLETION.
- THE STRUCTURAL SYSTEM FOR THIS PROJECT SHALL NOT BE CONSTRUCTED BY USING THE STRUCTURAL DRAWINGS ALONE. THESE DRAWINGS WERE DEVELOPED FROM DATA DERIVED PRIMARILY FROM THE ARCHITECTURAL DRAWINGS AND SECONDARILY FROM MEP, CIVIL AND OTHER DISCIPLINES. IT IS INTENDED THAT CONSTRUCTION PROCEED BY UTILIZING ALL OF THE INFORMATION CONTAINED IN THE ENTIRE SET OF CONSTRUCTION DOCUMENTS TAKEN AS A WHOLE; FAILURE TO DO SO WILL RESULT IN ERRORS WHICH SHALL BE CORRECTED AT THE CONTRACTORS EXPENSE.




**LONE STAR
STRUCTURAL, LLC**

WWW.LONESTARSTRUCTURAL.COM | TEXAS REGISTERED FIRM F-20642 | P: 210.827.5509

SINNERS AND SAINTS

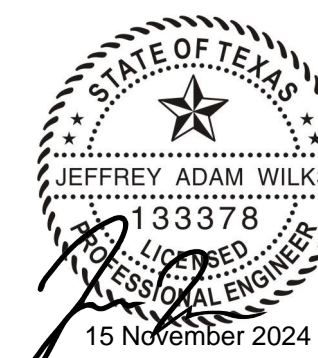19186 FM 2252
GARDEN RIDGE, TEXAS 78266



JOB: 2423LAI05292024

DATE: 15 NOVEMBER 2024

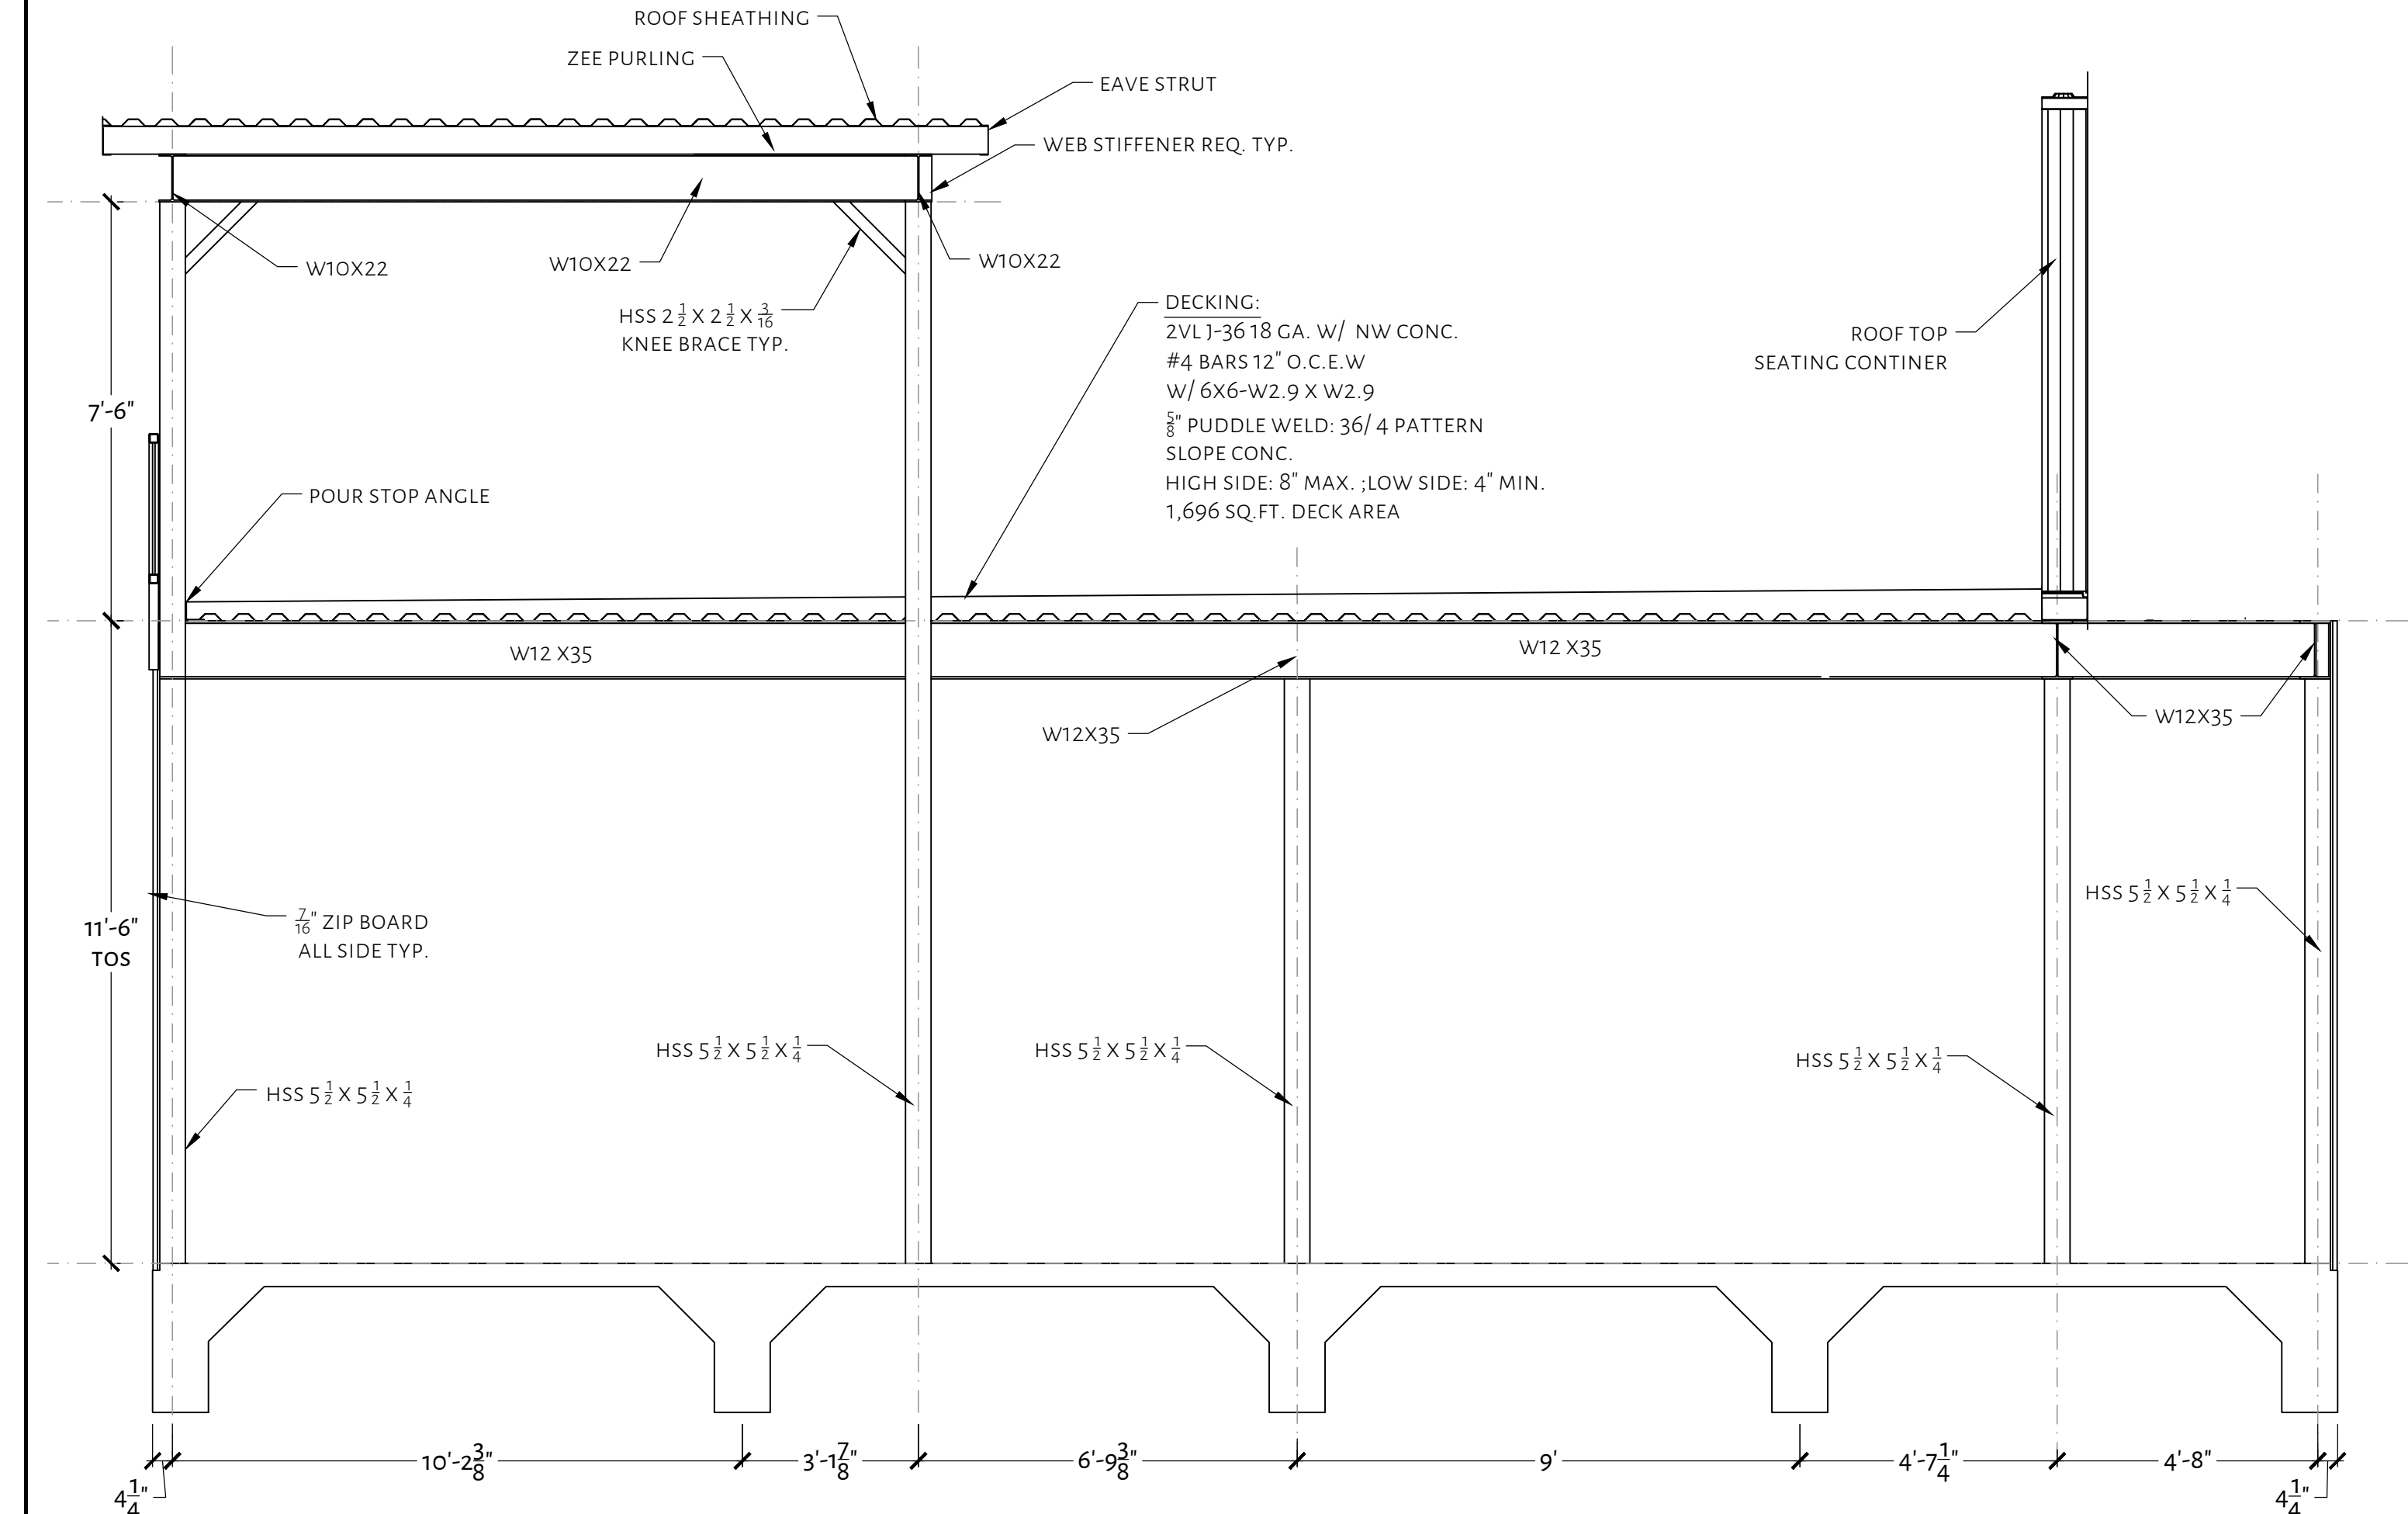
DRAWN: JW DESIGN: JW

RAILING AND SECTIONS


SHEET:

S7.0


Date: Nov 13, 2024, 7:51am User ID: jwilk
File: D:\Lone Star Structural Dropbox\Lone Star Structural\13 - Active Projects\2024\2423LAJ05292024 - Sinners and Saints\15 - Drawings\2423LAJ05292024 - Sinners and Saints.dwg



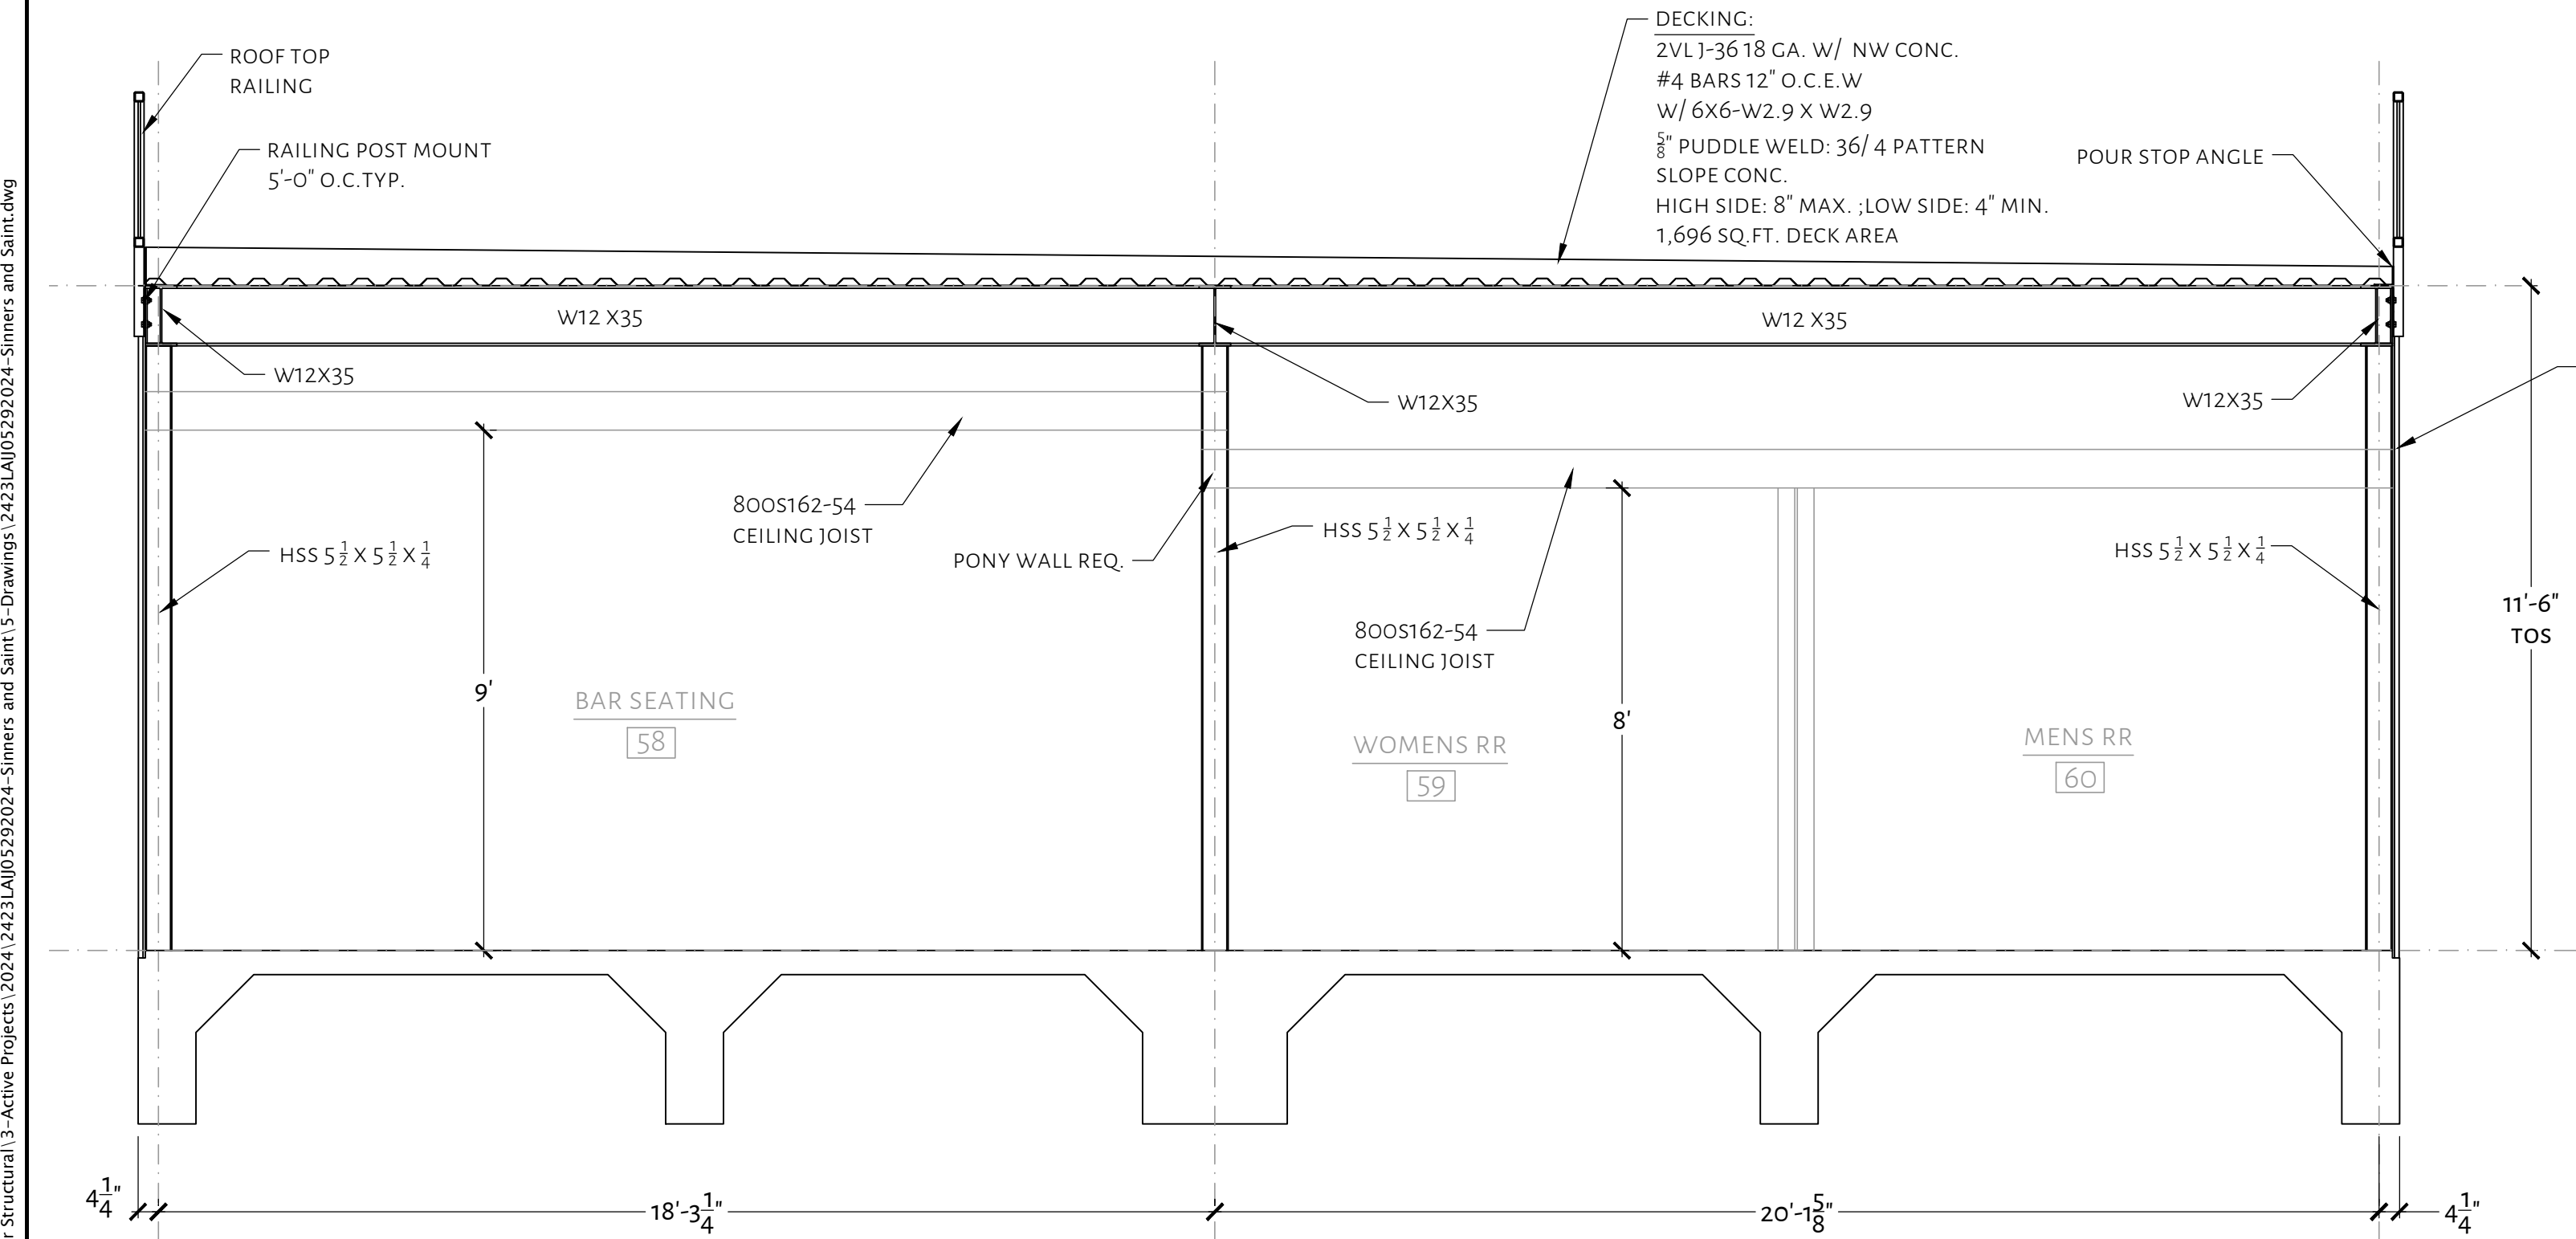
FRAME LINE 1
SCALE: $\frac{3}{8}'' = 1'-0''$



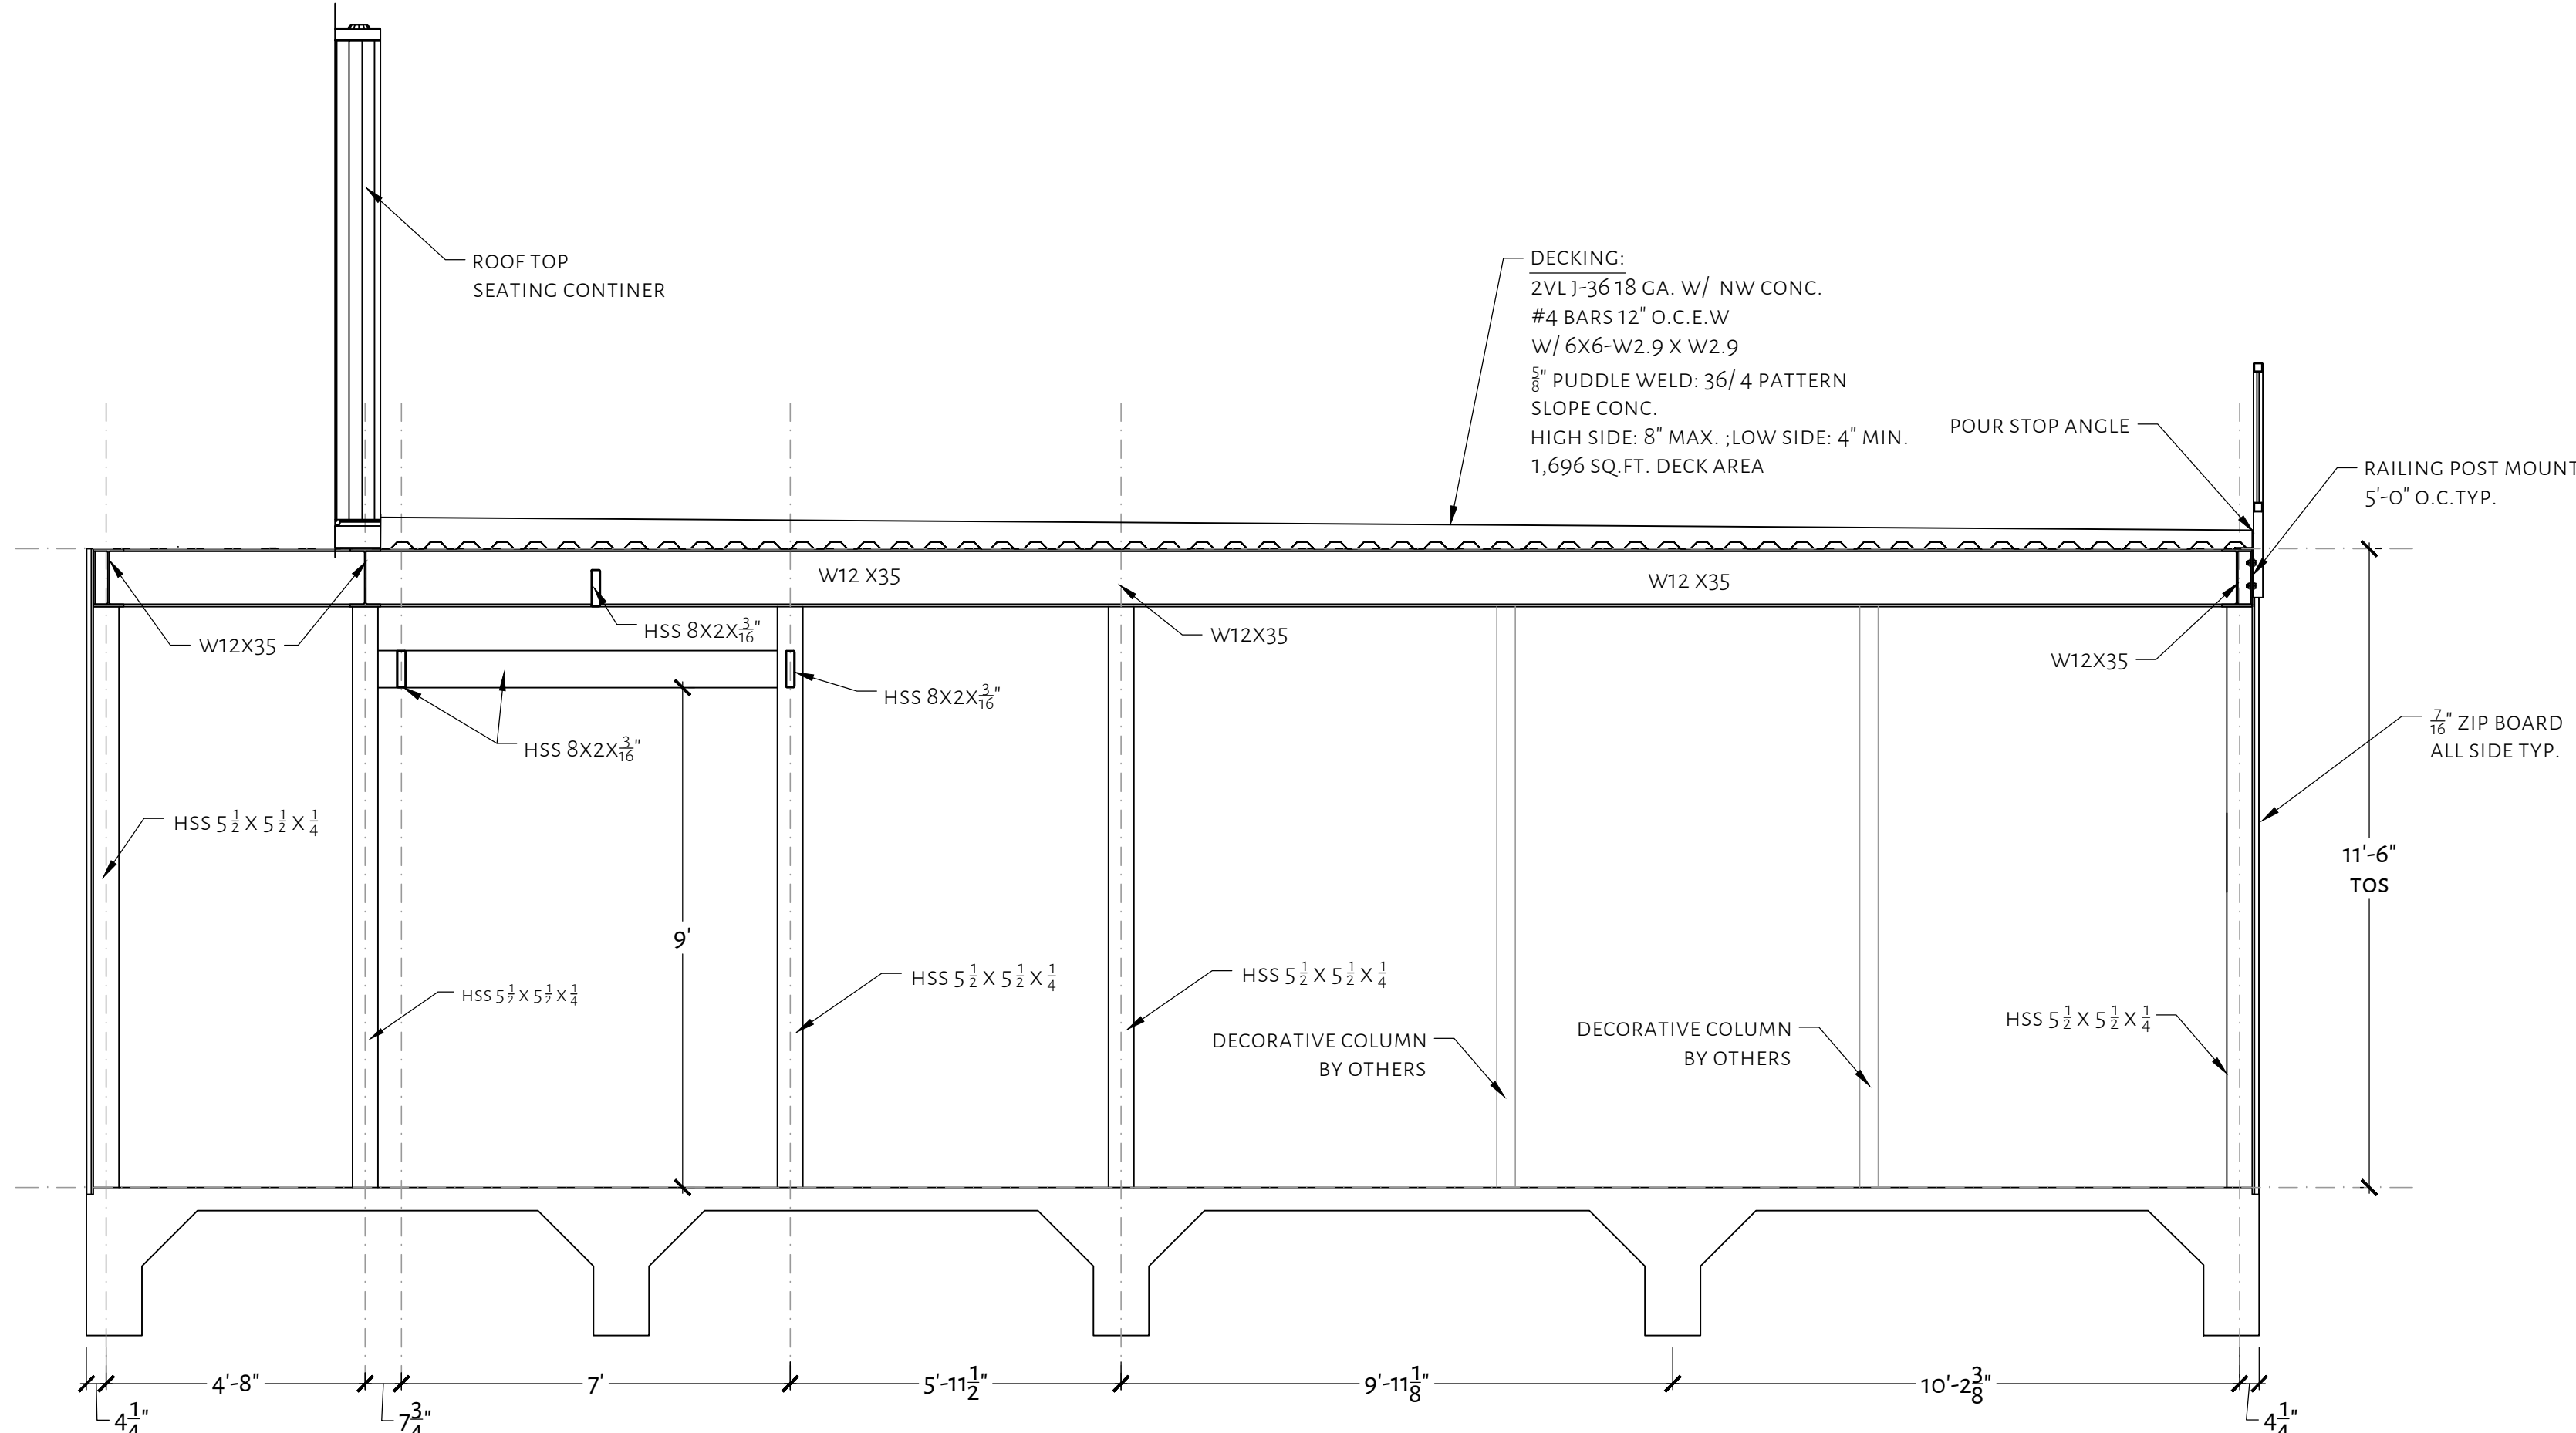FRAME LINE 2
SCALE: $\frac{3}{8}'' = 1'-0''$



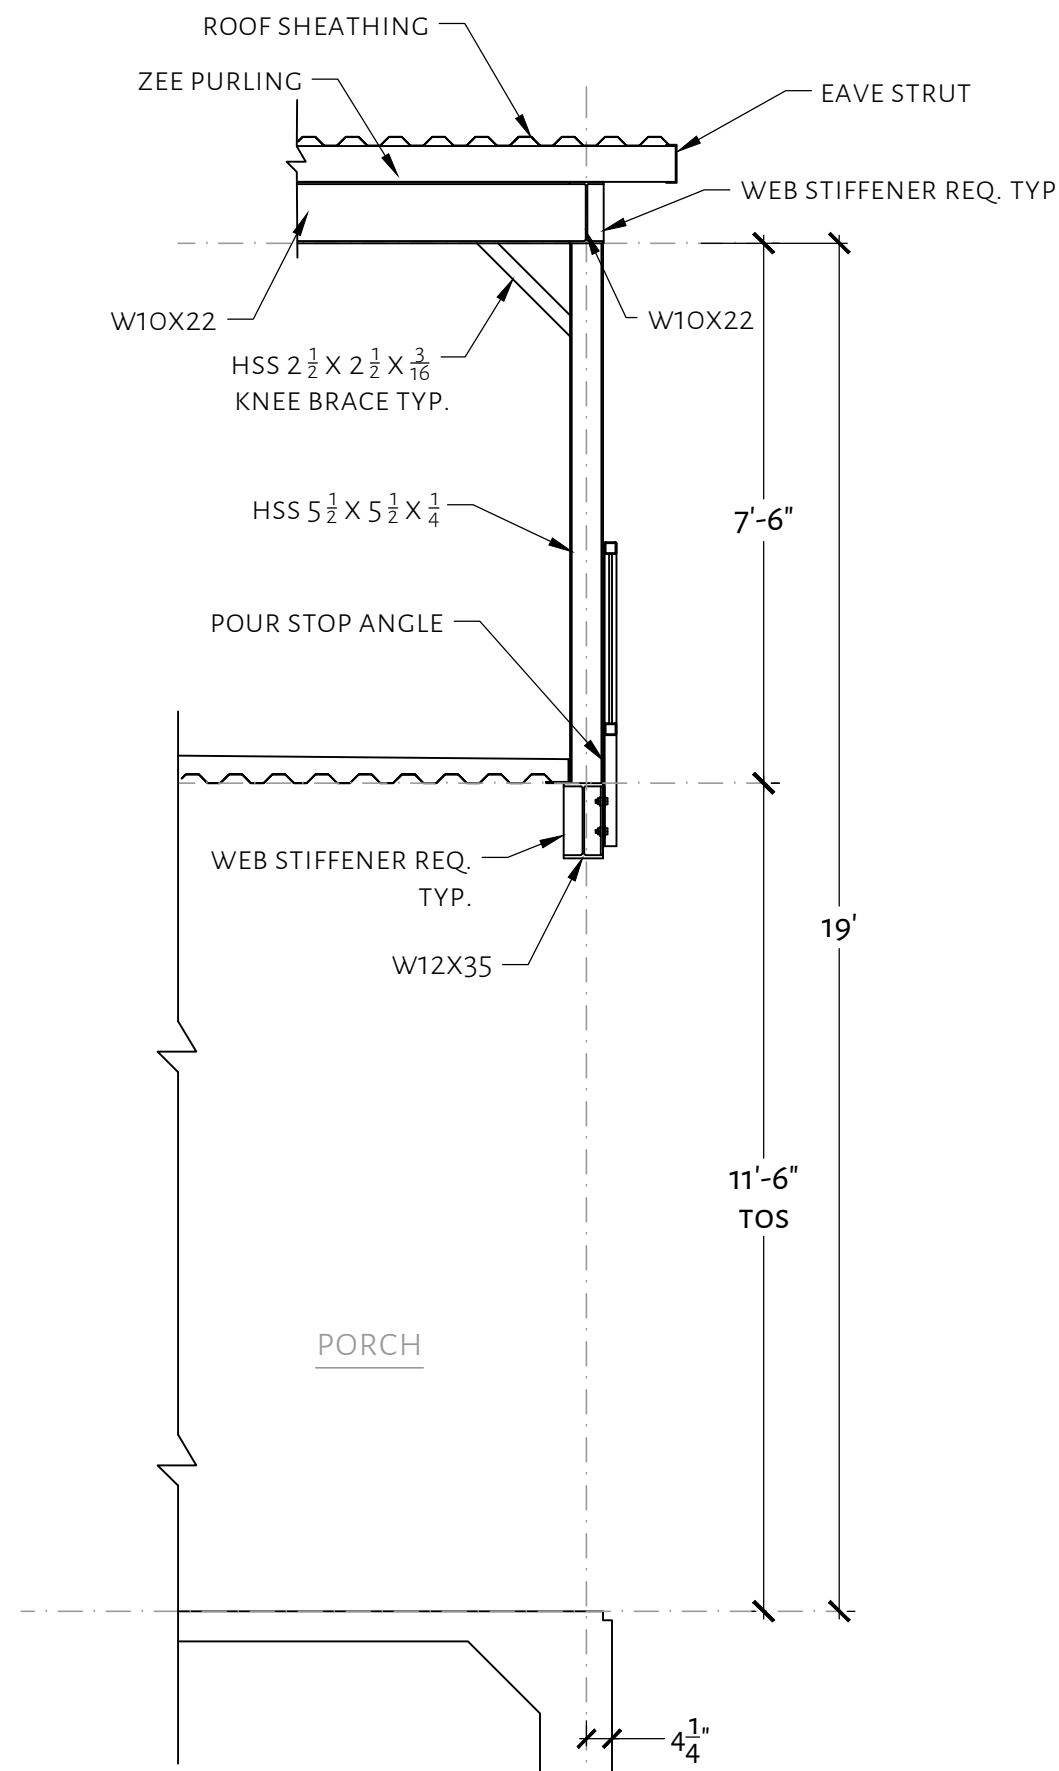FRAME LINE 3
SCALE: $\frac{3}{8}'' = 1'-0''$




FRAME SECTION A-A
SCALE: $\frac{3}{8}'' = 1'-0''$



SINNERS AND SAINTS






















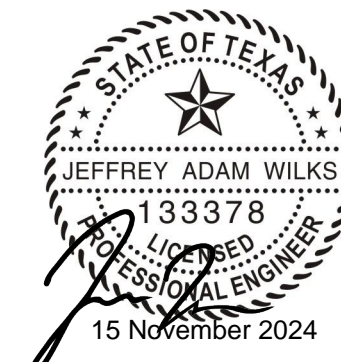
19186 FM 2252
GARDEN RIDGE, TEXAS 78266



JOB: 2423LAJ05292024
DATE: 15 NOVEMBER 2024
DRAWN: JW | DESIGN: JW
BUILDING SECTIONS
SHEET:

S7.1

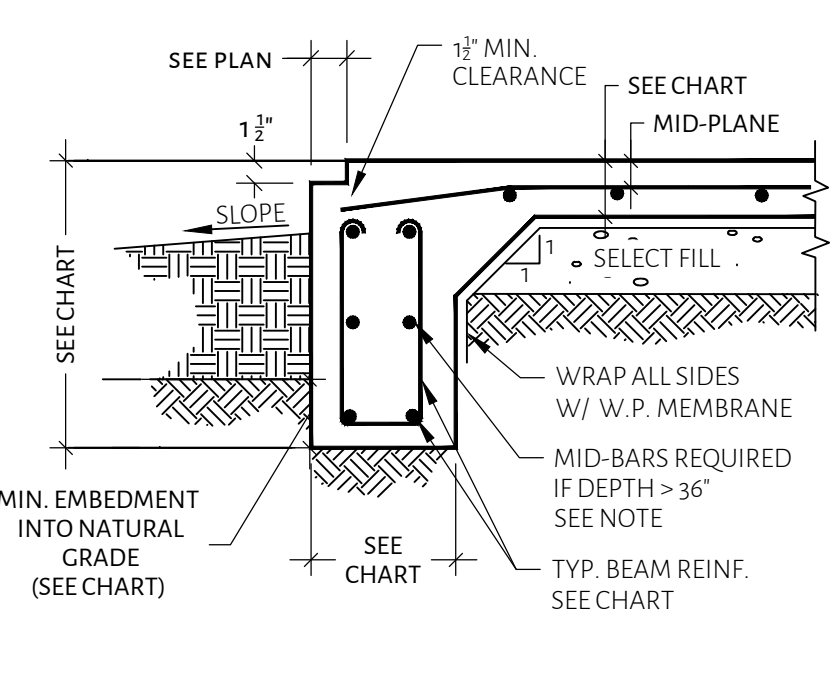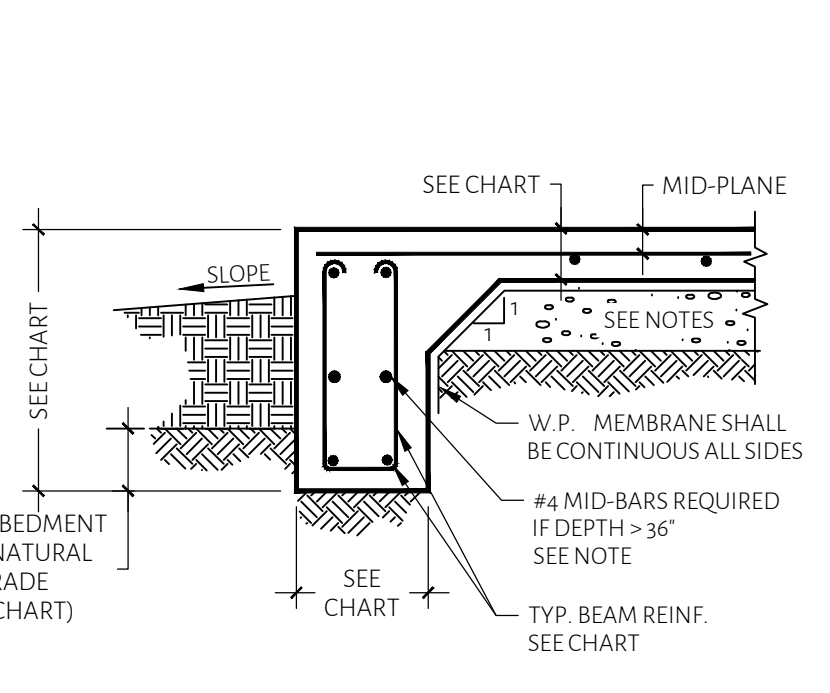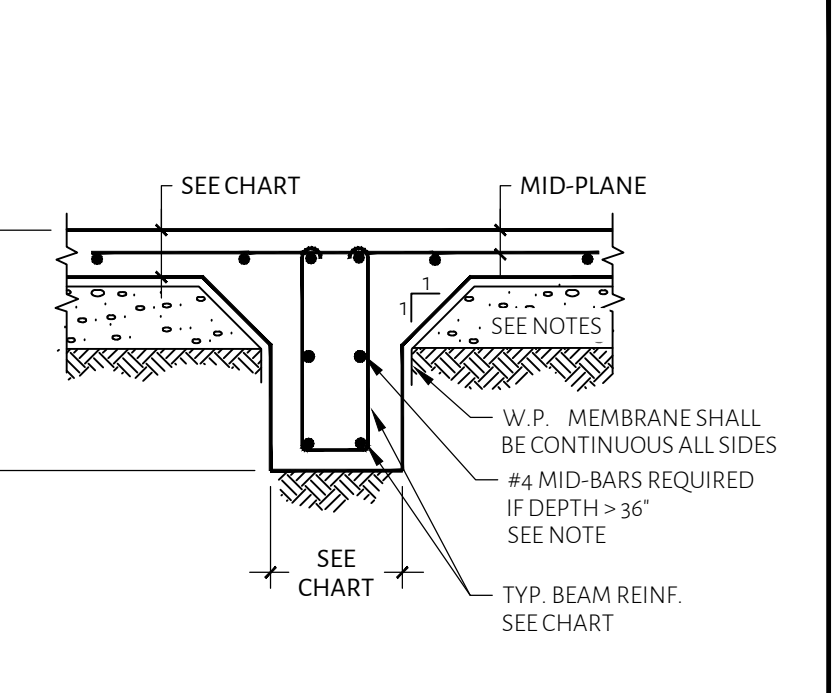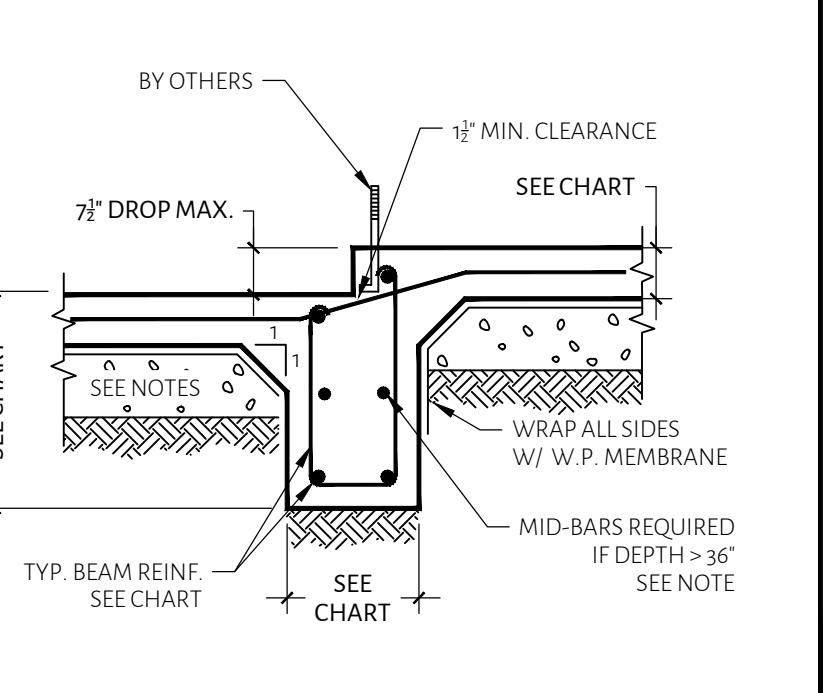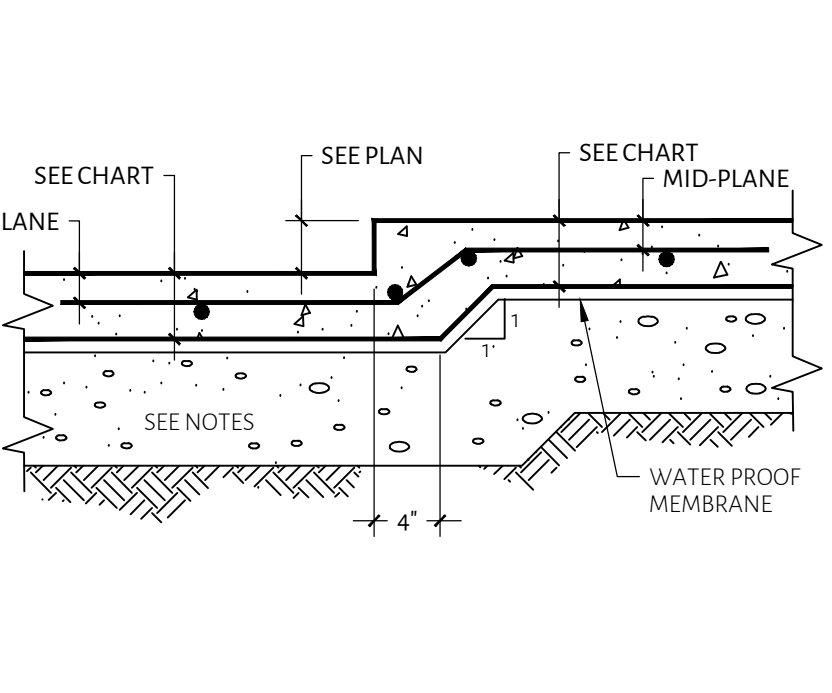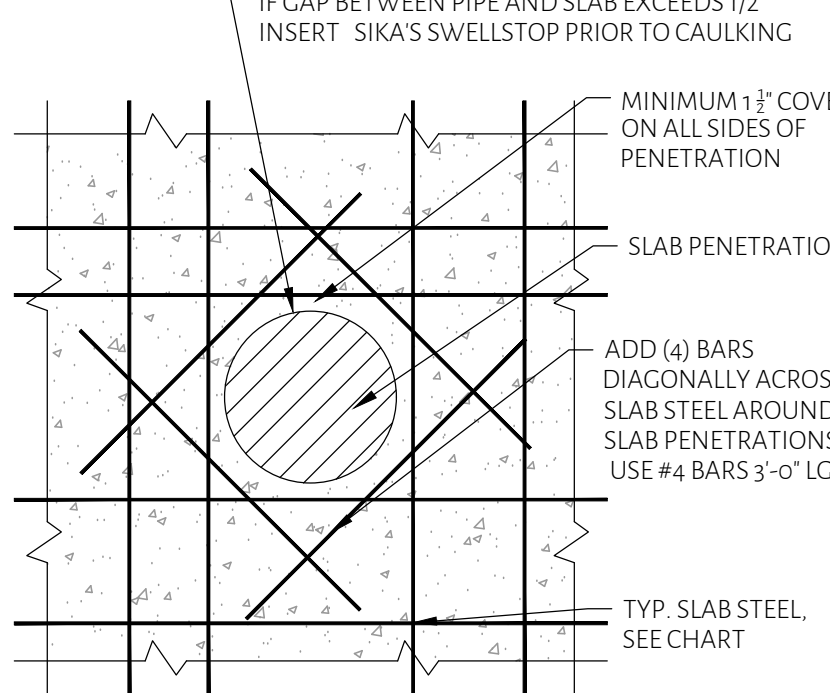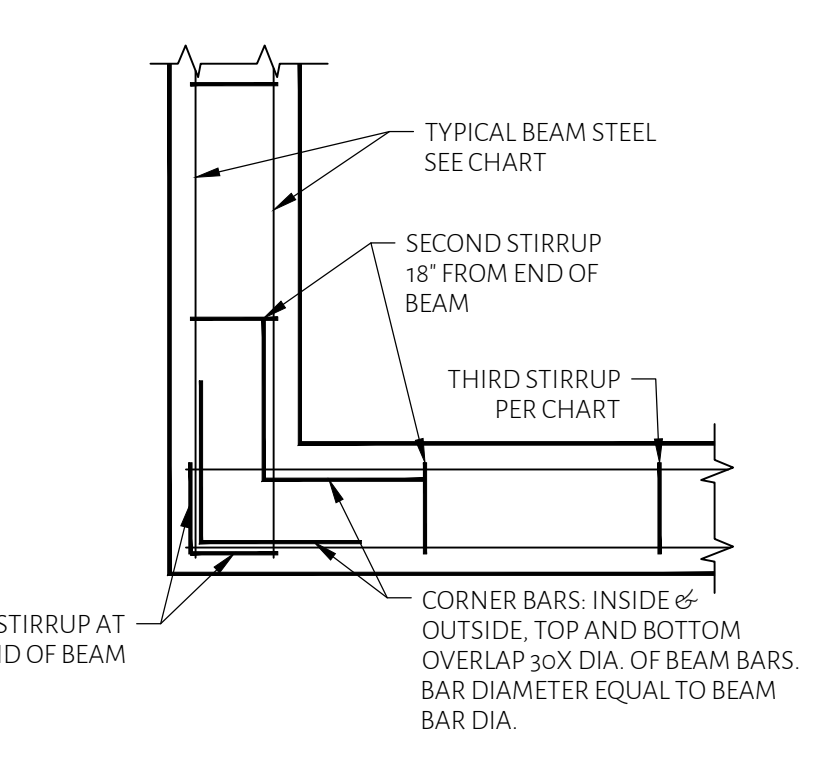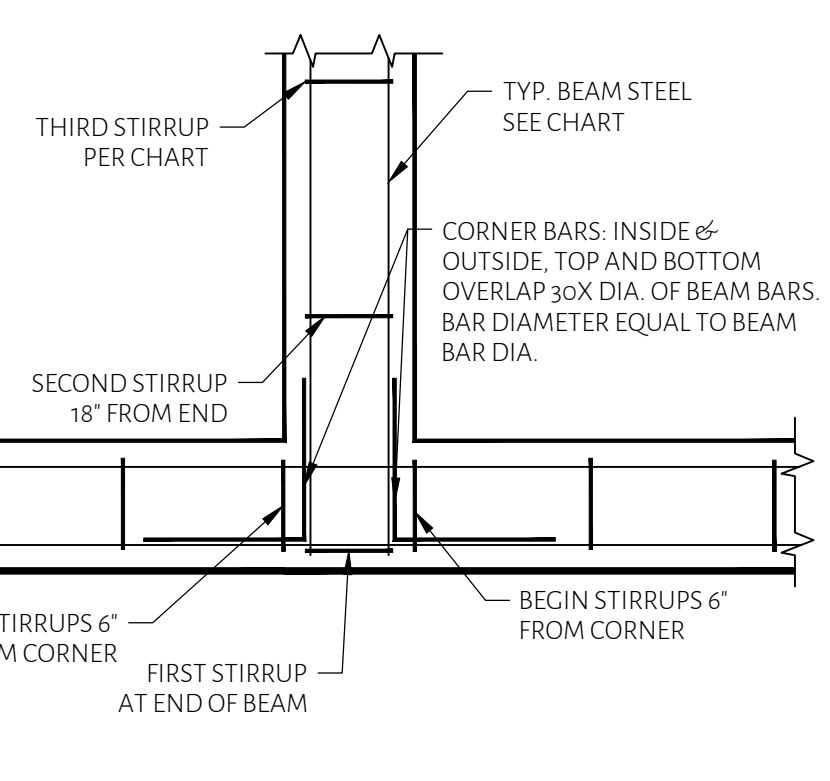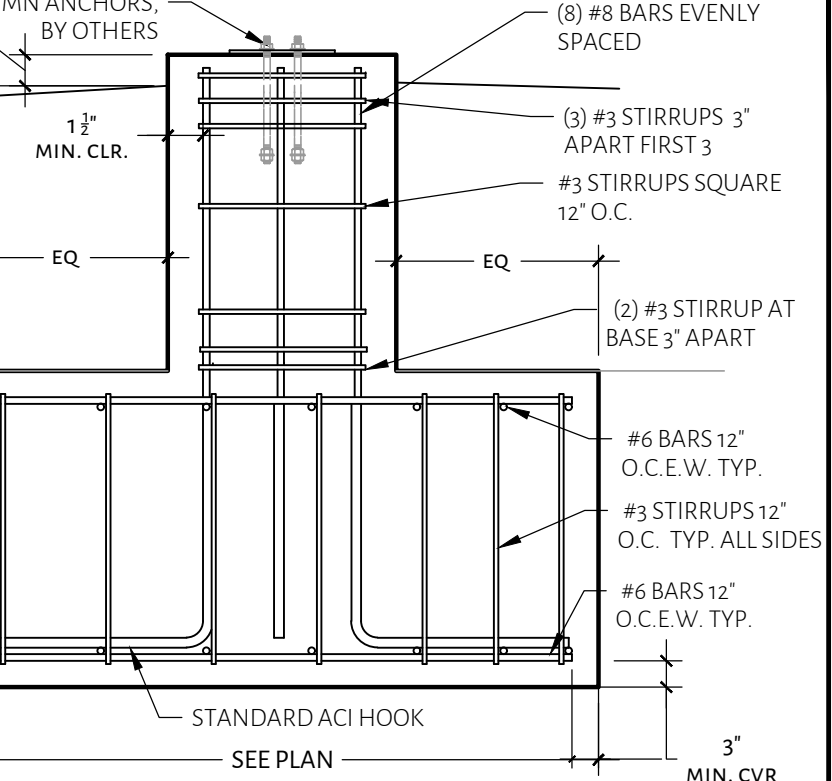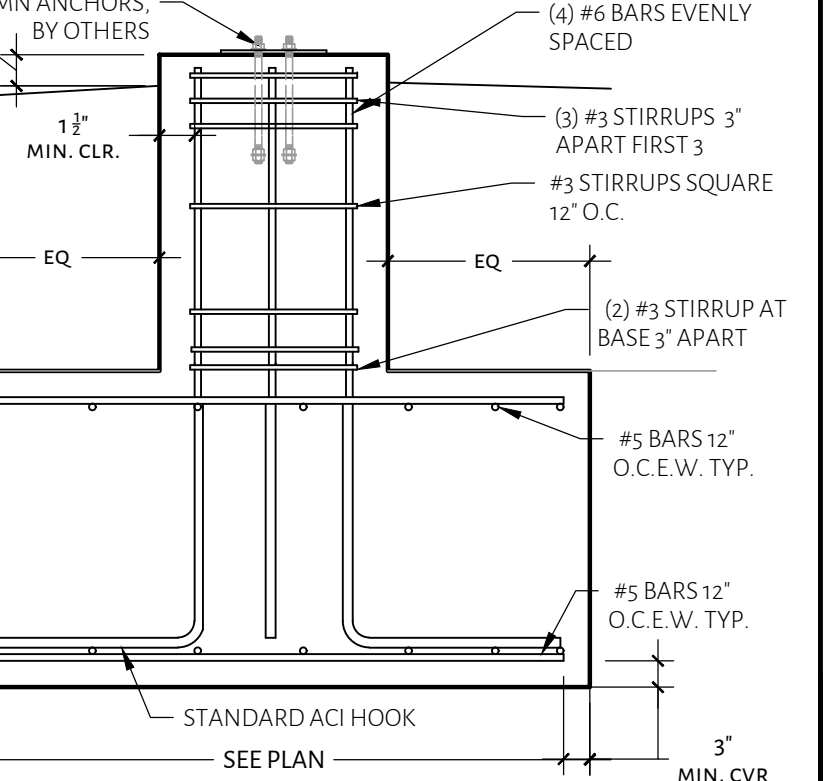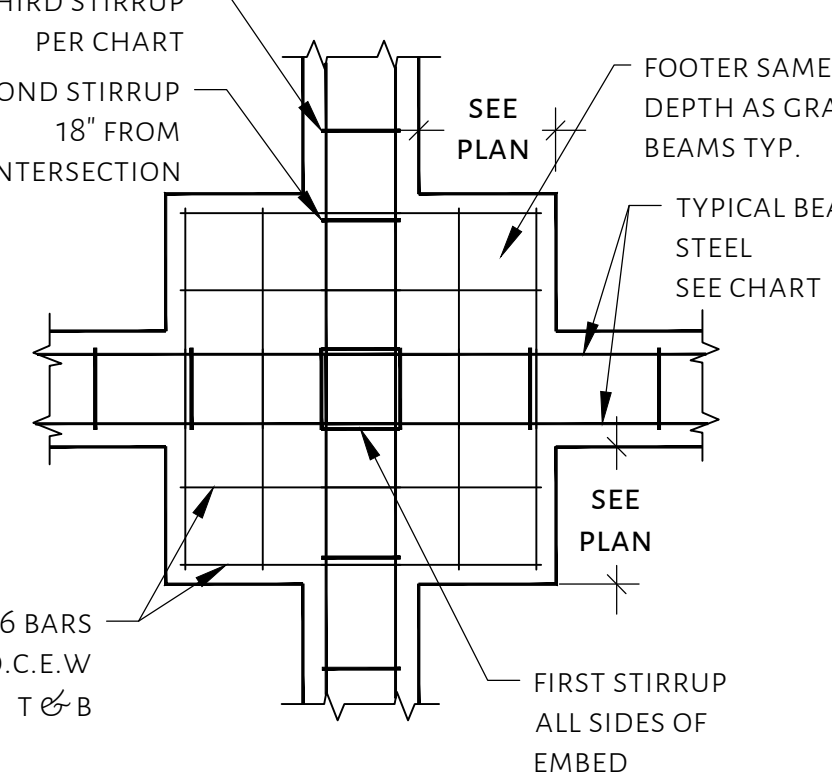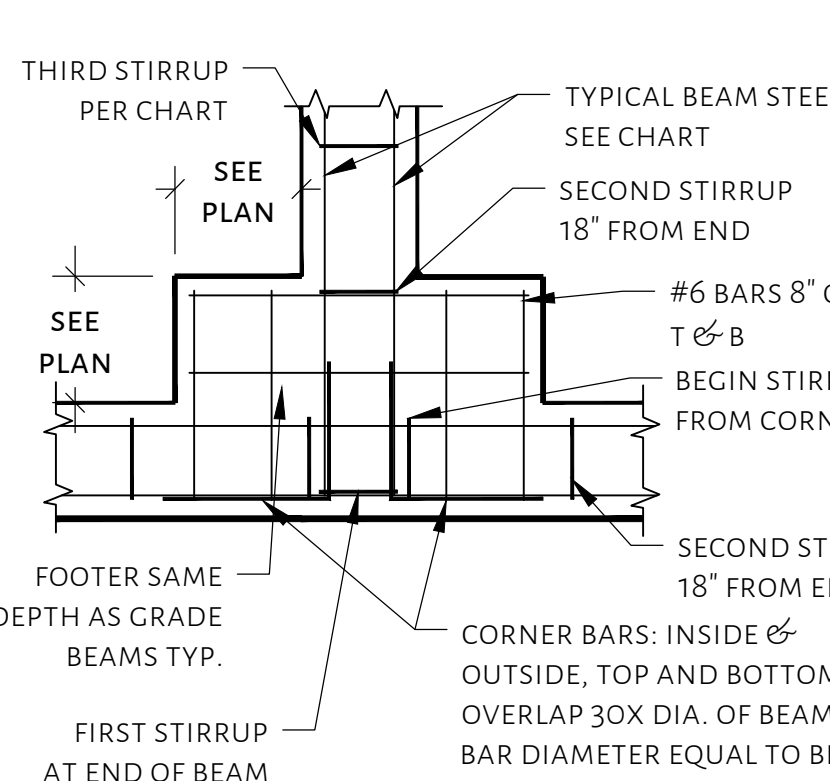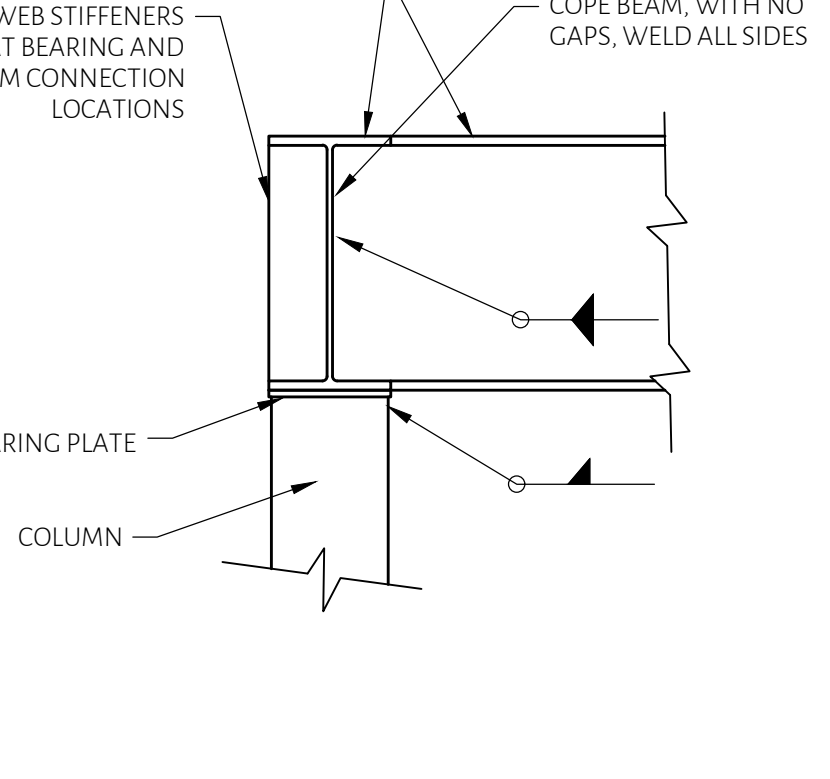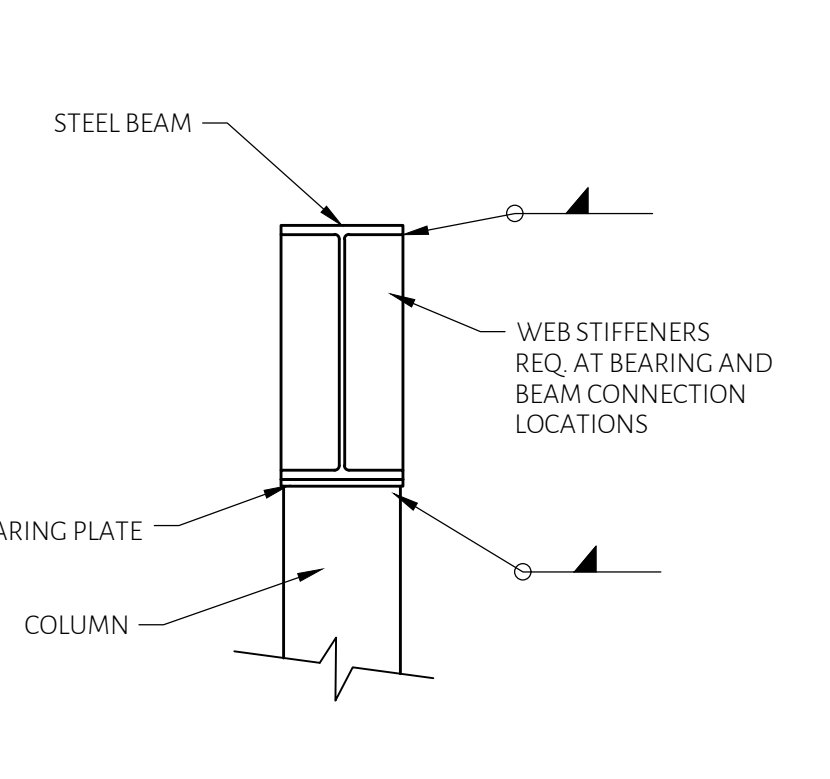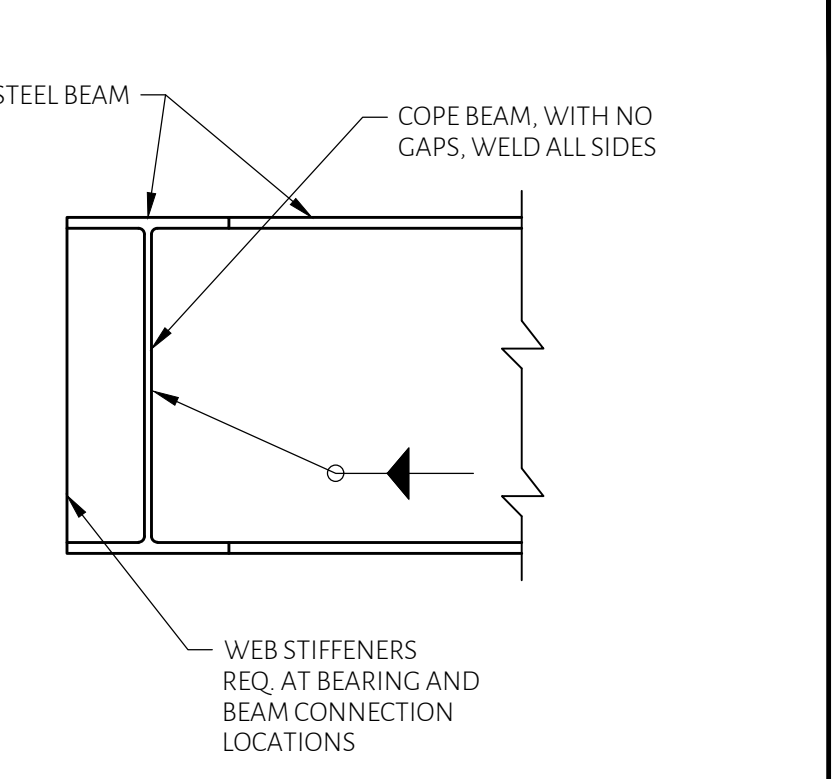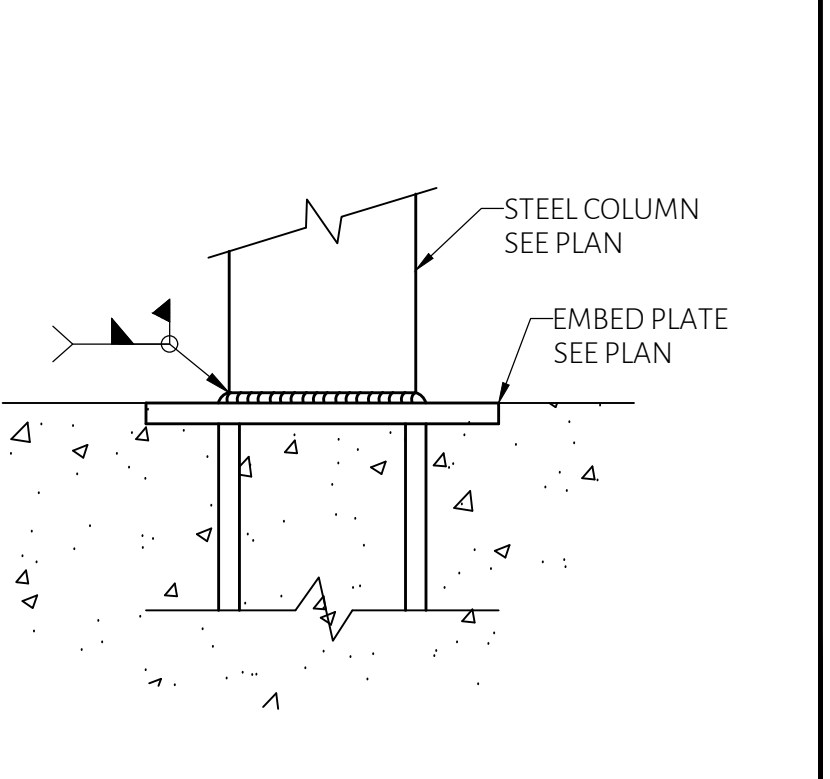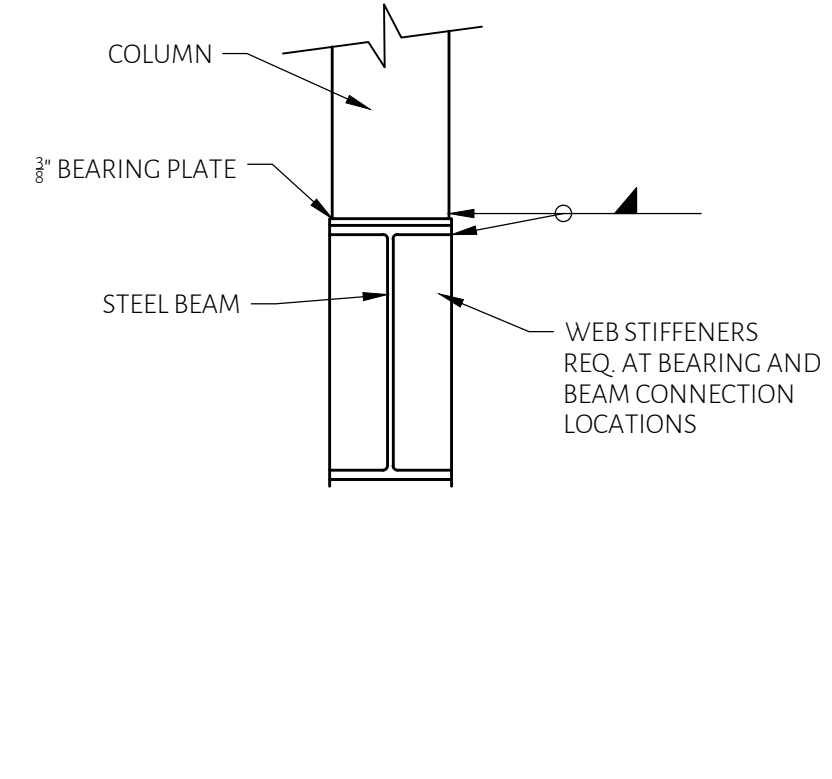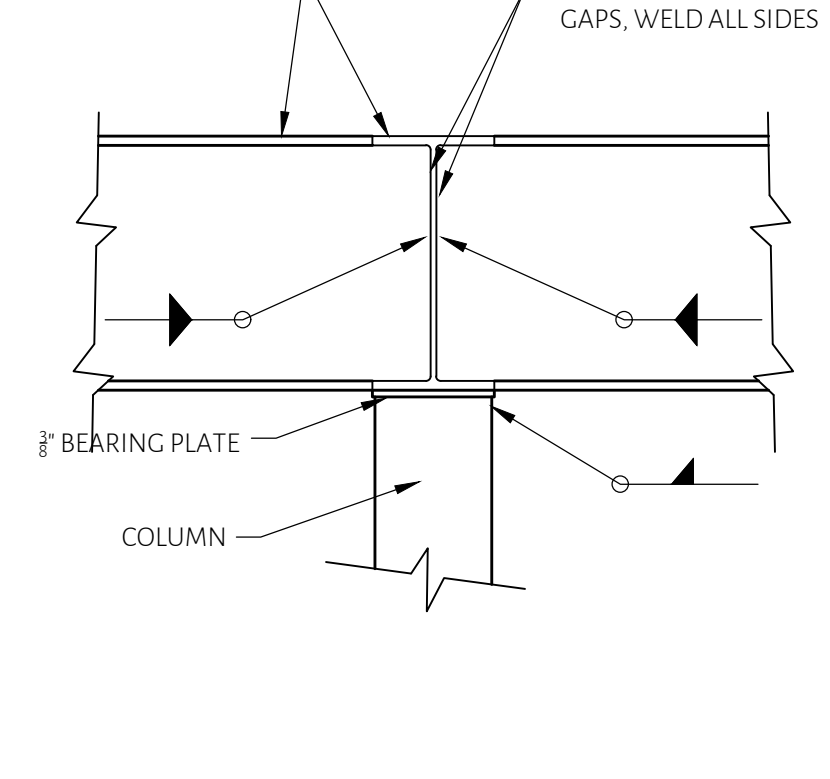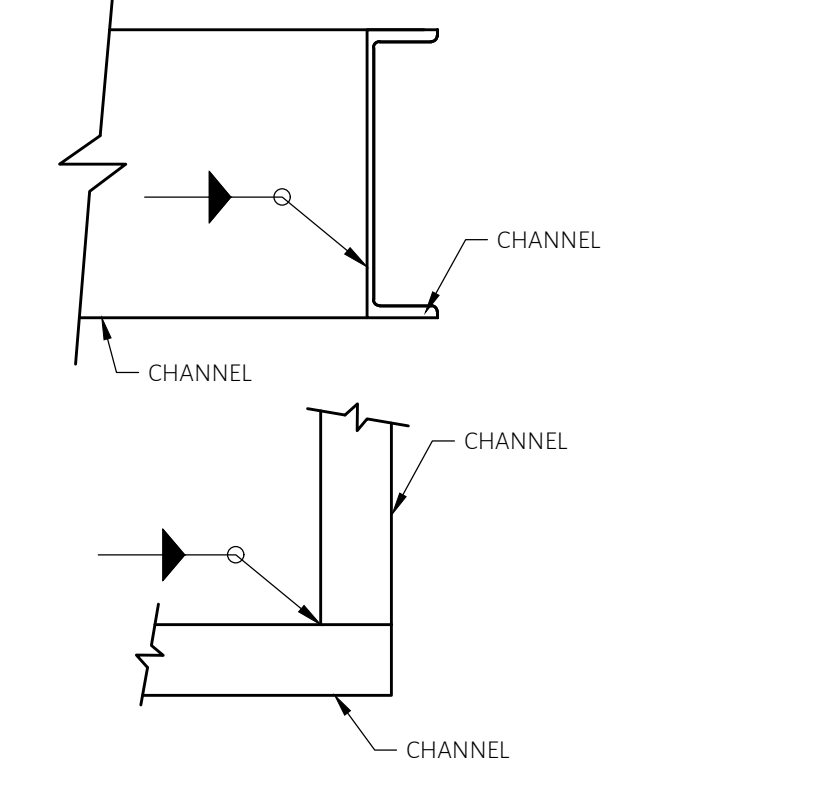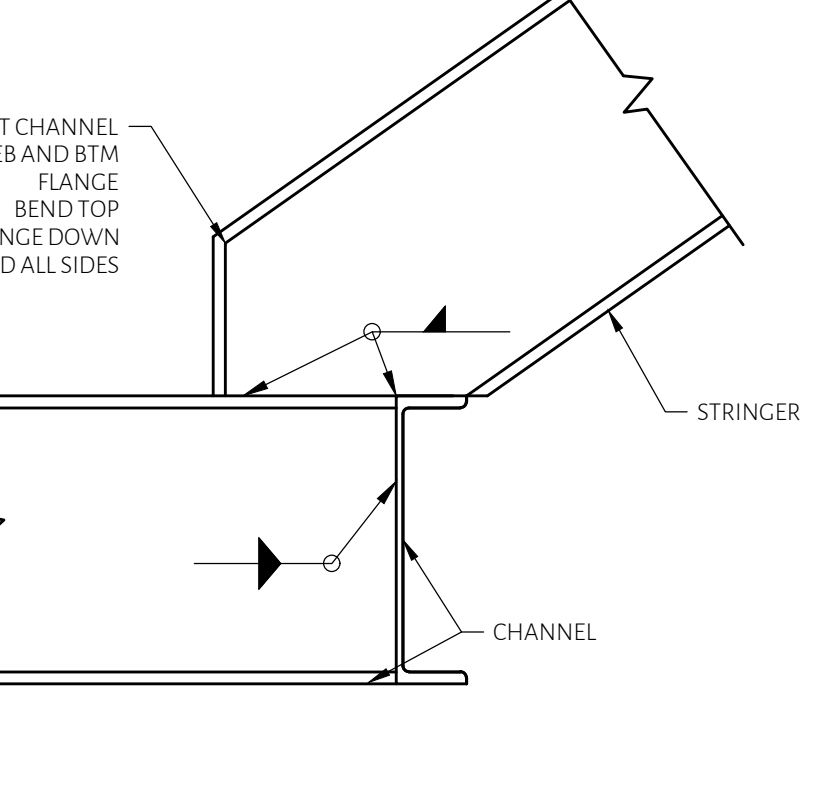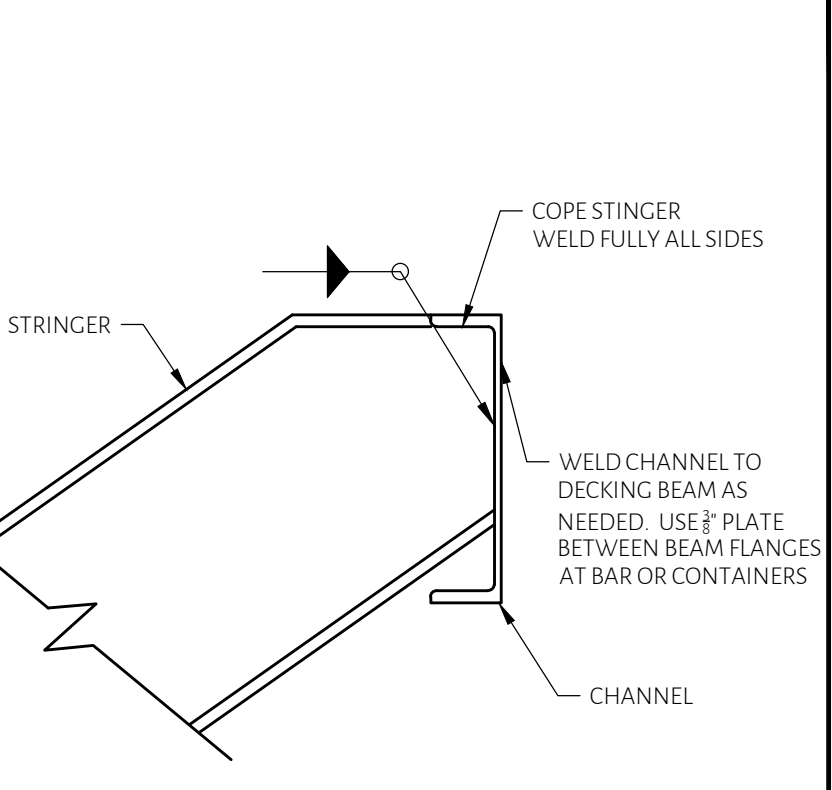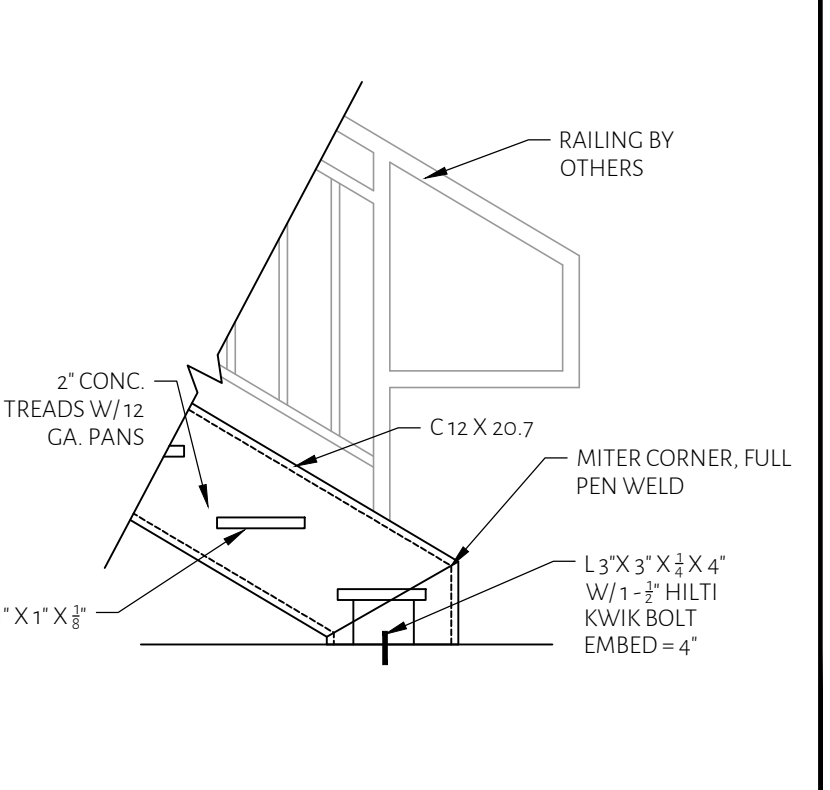Date: Nov 13, 2024, 7:51am User ID: jwilk
File: D:\Lone Star Structural Dropbox\Lone Star Structural\13 - Active Projects\2024\24231A\05292024 - Sinners and Saints.dwg

		NTS			NTS			NTS			NTS			NTS			NTS
1		NTS	2	TYP. EXTERIOR BEAM	NTS	3	TYP. INTERIOR BEAM	NTS	4	INTERIOR BEAM WITH DROP	NTS	5	SLAB DROP 6" OR LESS	NTS	6	TYP. SLAB PENETRATION	NTS
		NTS			NTS			NTS			NTS			NTS			NTS
7	TYP. BEAM CORNER	NTS	8	TYP. BEAM INTERSECTION	NTS	9	SHALLOW FOOTING DETAIL @ COLUMN-PAVILION	NTS	10	SHALLOW FOOTING DETAIL @ COLUMN-STAGE & CONTAINER	NTS	11	TYP. INT. FOOTER DETAIL PLAN VIEW	NTS	12	TYP. EXT. INTERSECTION FOOTER DETAIL	NTS
		NTS			NTS			NTS			NTS			NTS			NTS
13	BEAM INTERSECTION AT COLUMN	NTS	14	BEAM TO COLUMN BTM FLANGE WELDED DETAIL	NTS	15	BEAM TO BEAM WELDED DETAIL	NTS	16	STEEL COLUMN TO EMBED	NTS	17	BEAM TO COLUMN TOP FLANGE WELDED DETAIL	NTS	18	BEAM INTERSECTION AT COLUMN	NTS
		NTS			NTS			NTS			NTS						
19	CHANNEL TO CHANNEL STAIR DETAIL	NTS	20	CHANNEL TO STRINGER LOWER STAIR DETAIL	NTS	21	CHANNEL TO STRINGER UPPER MOUNT DETAIL	NTS	22	STAIR FRAMING BOTTOM CONNECTION	NTS						

LSS

LO
STRUC

WWW.LONESTARSTRUCTURAL.COM



LONE STAR
STRUCTURAL, LLC

WWW.LONESTARSTRUCTURAL.COM | TEXAS REGISTERED FIRM F-20642 | P: 210.827.5509

SINNERS AND SAINTS

19186 FM 2252
GARDEN RIDGE, TEXAS 78266



JOB: 24231A\05292024

DATE: 15 NOVEMBER 2024



















DRAWN: JW | DESIGN: JW


STRUCTURAL DETAILS

SHEET:

S8.0

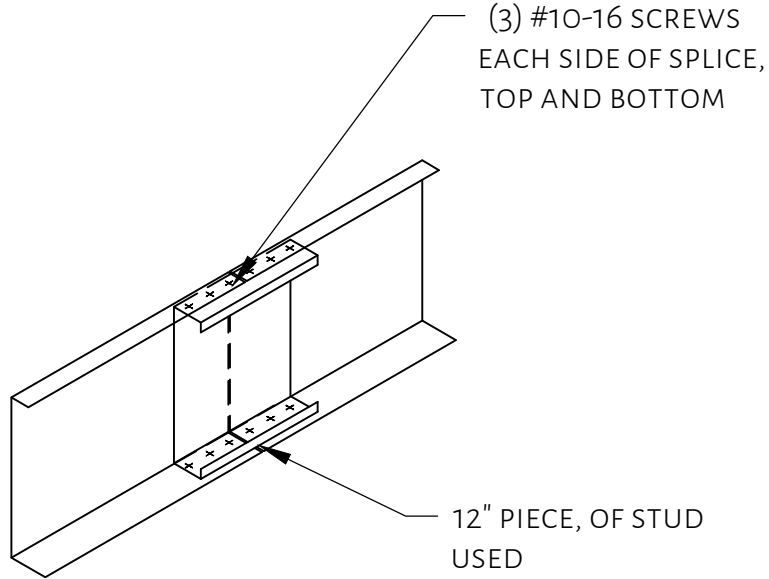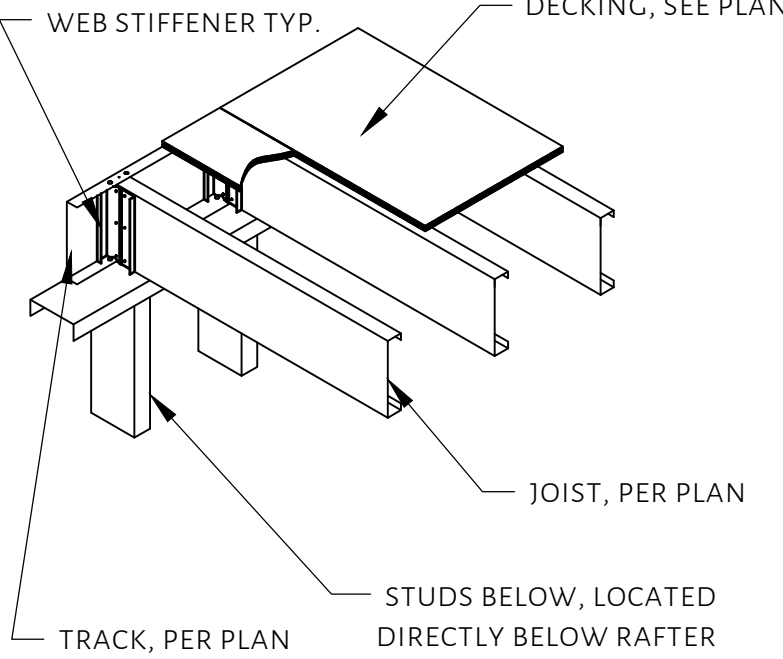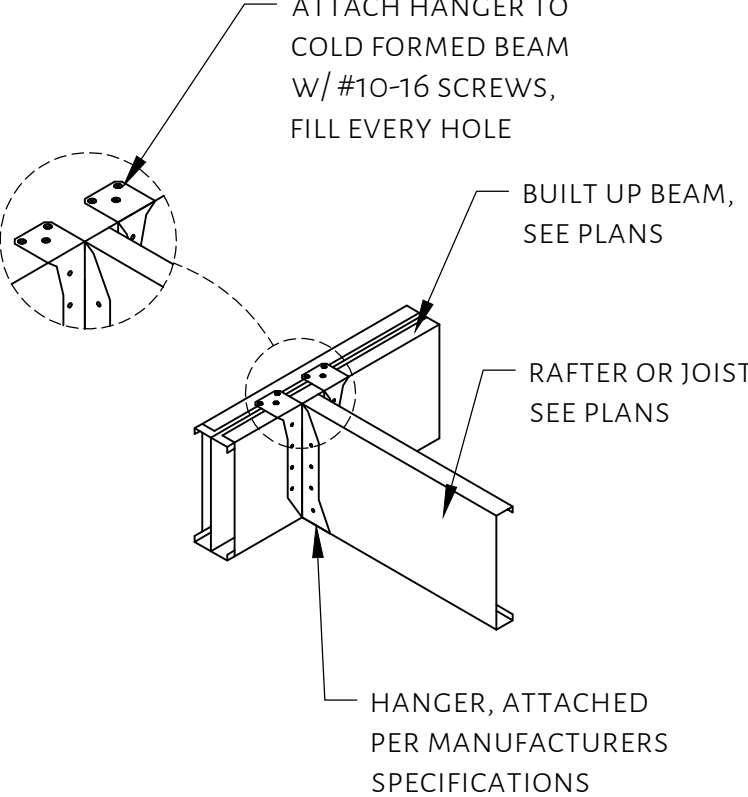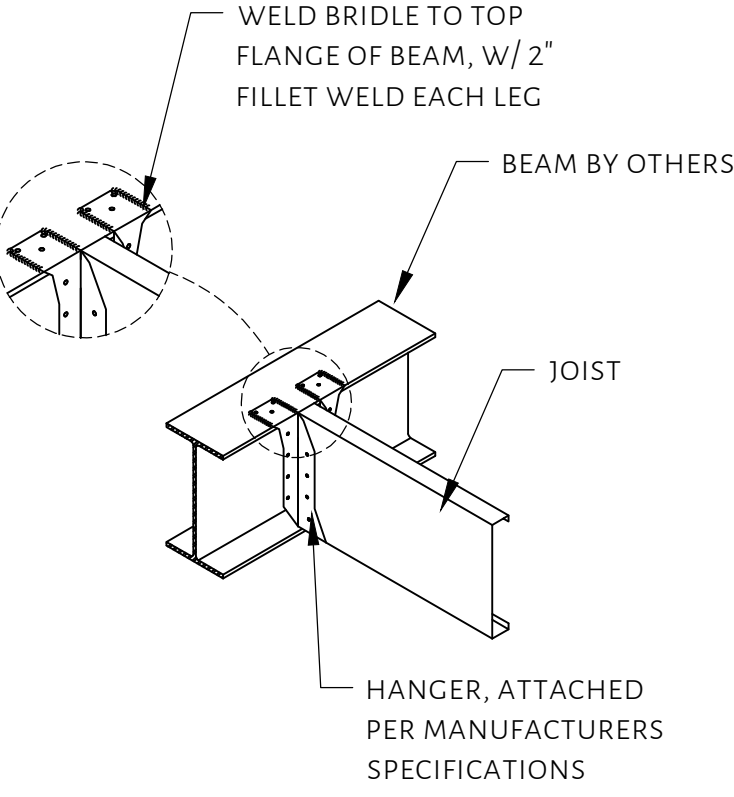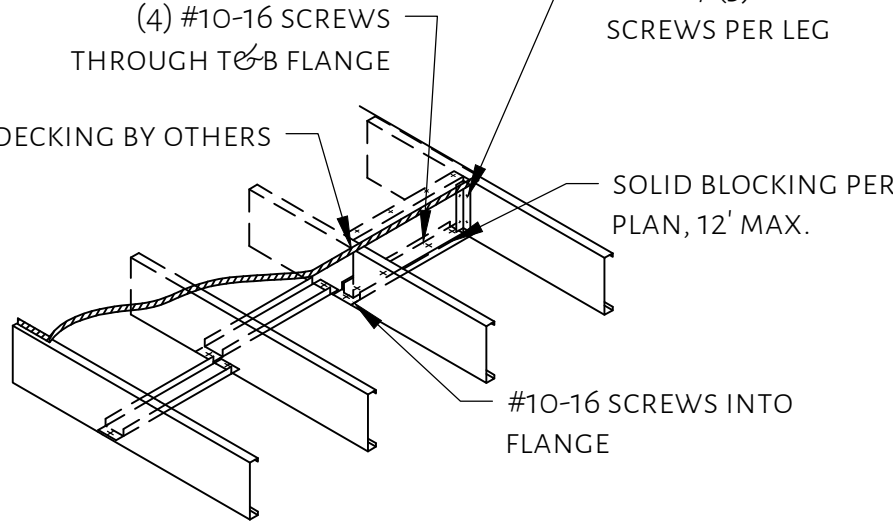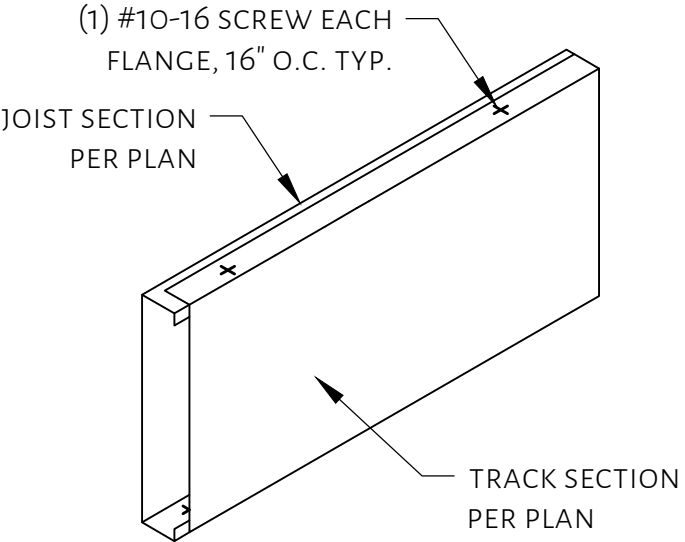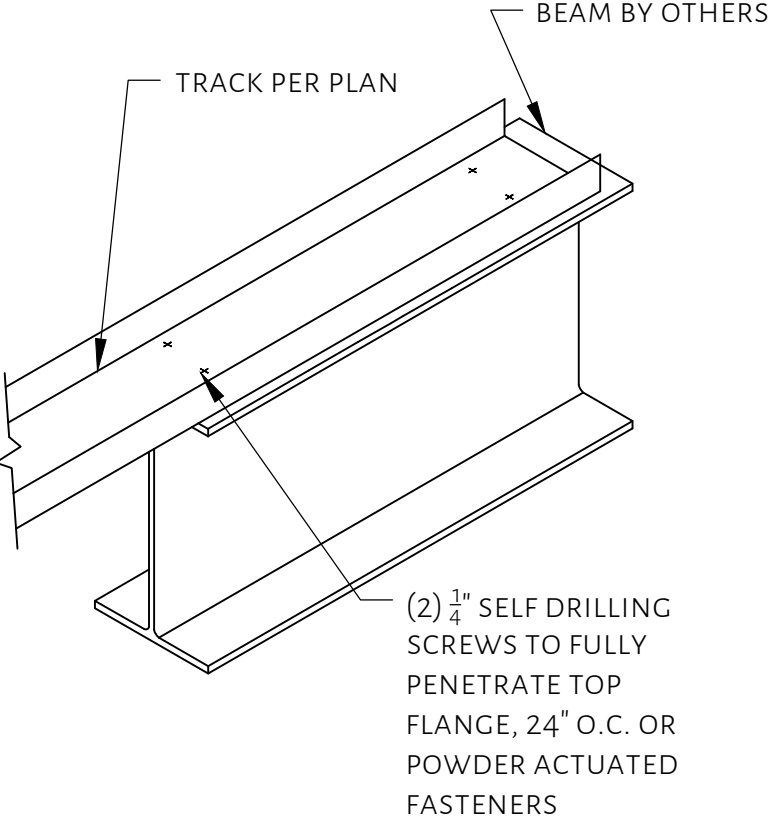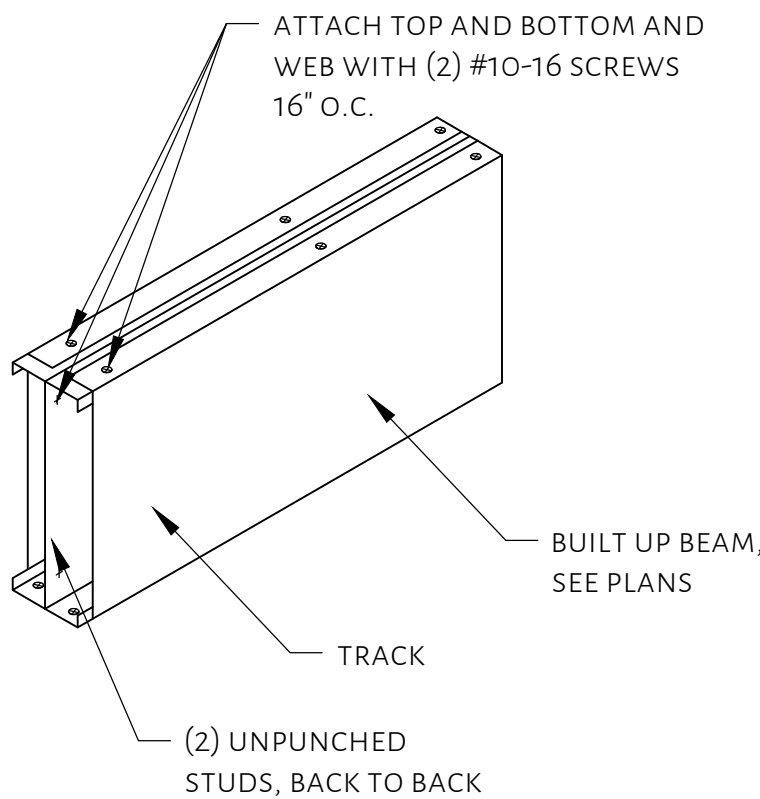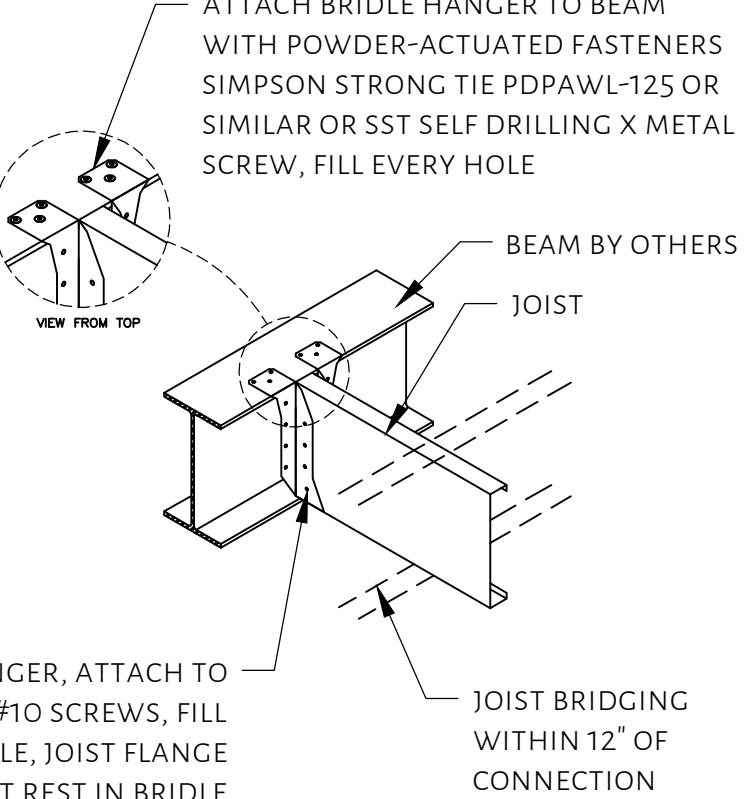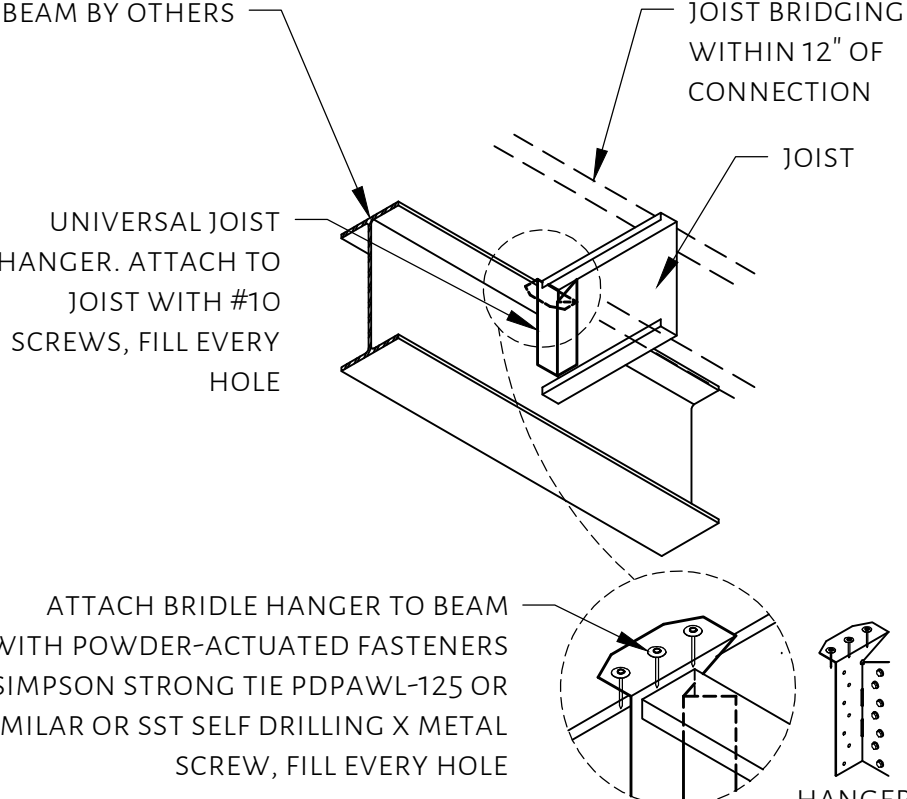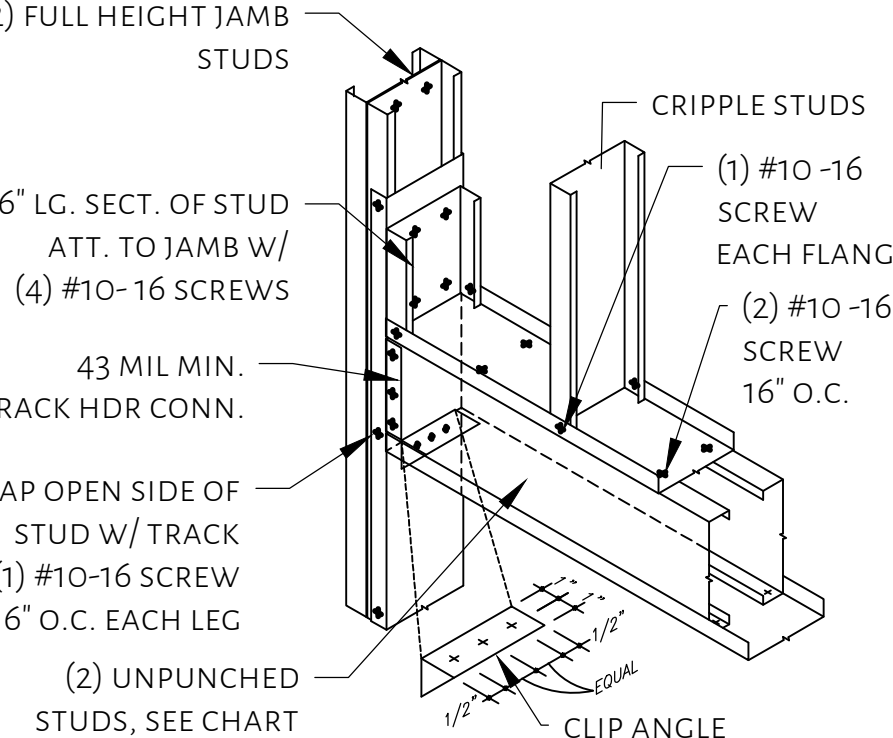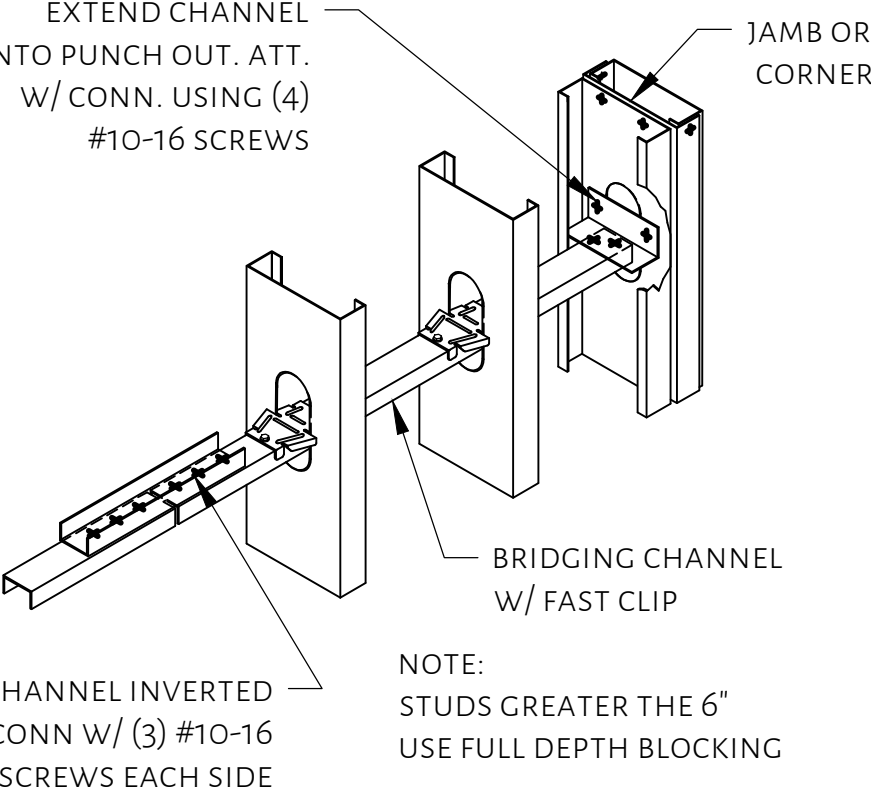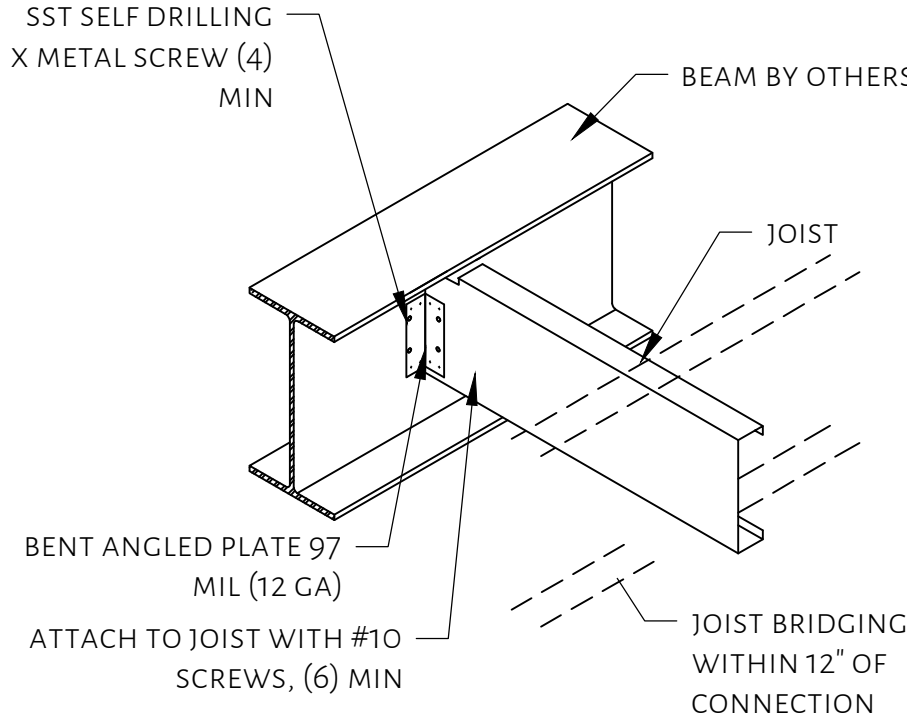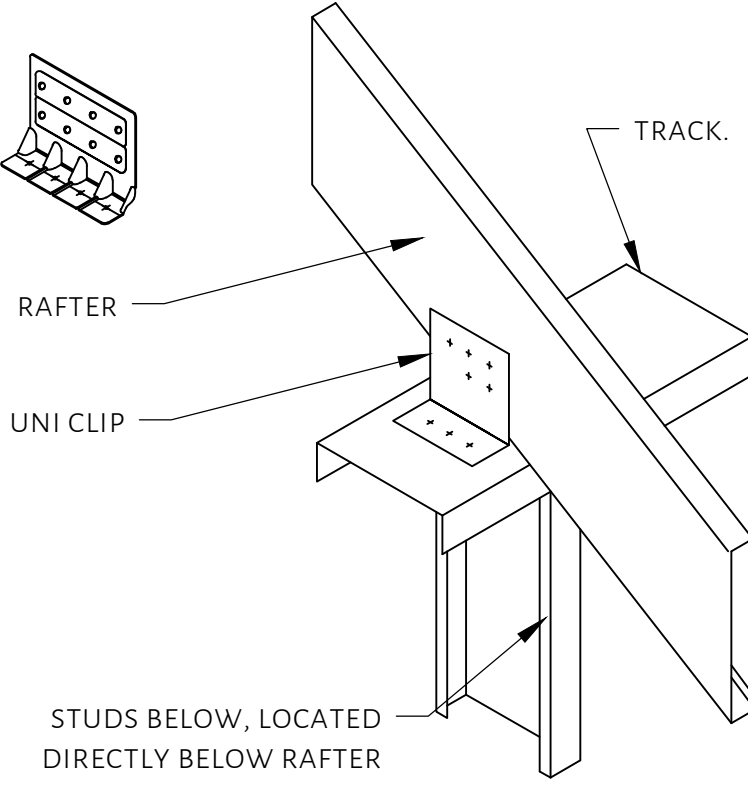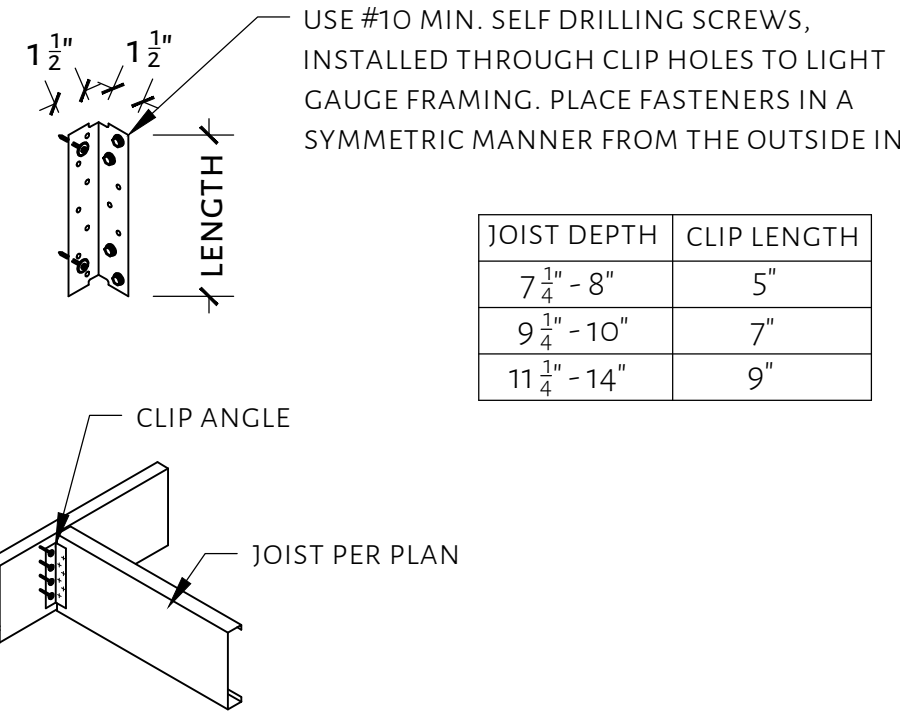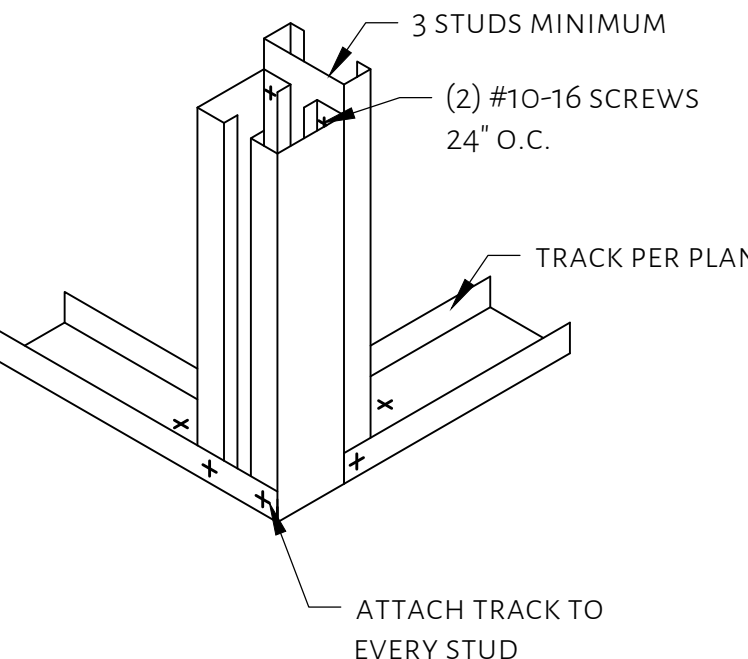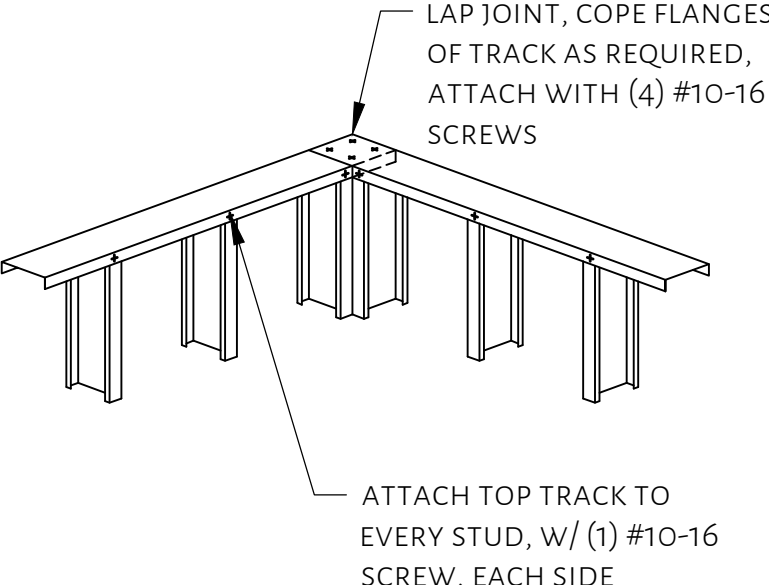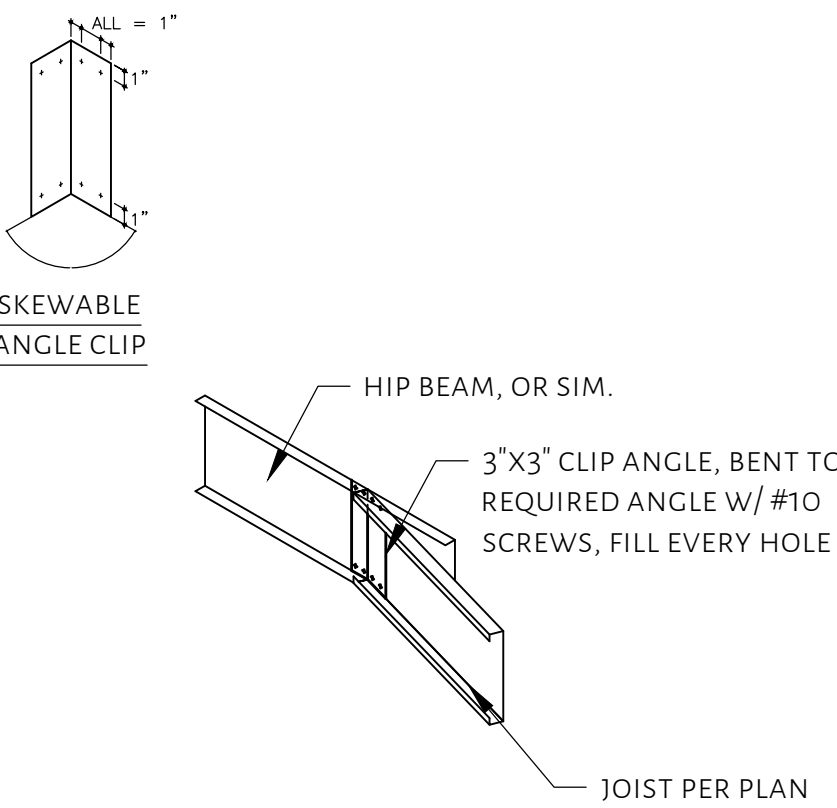Date: Nov 13, 2024, 7:53am User ID: jwilk
File: D:\Lone Star Structural Dropbox\Lone Star Structural\3 - Active Projects\2024\24231A\05292024 - Sinners and Saints.dwg

																	
23	TYP. TRACK SPLICE	NTS	24	PARAPET/ PEDESTAL DETAIL	NTS	25	CFS HANGER DETAIL	NTS	26	CFS HANGER DETAIL - WELDED	NTS	27	JOIST BRIDGING DETAIL	NTS	28	BOXED BEAM DETAIL	NTS
																	
29	TRACK TO STEEL BEAM DETAIL	NTS	30	BACK TO BACK BUILT UP MEMBER DETAIL	NTS	31	CFS HANGER DETAIL - SCREWED	NTS	32	SKEWED HANGER DETAIL	NTS	33	HEADER DETAIL TOE TO TOE	NTS	34	BRIDGING DETAIL	NTS
																	
35	SKEWED HANGER DETAIL-2	NTS	36	BEARING RAFTER CONN. DETAIL	NTS	37	LIGHT GAUGE CLIP ANGLE	NTS	38	TYP. CORNER DETAIL	NTS	39	TYP. CORNER DETAIL	NTS	40	SKEWED JOIST DETAIL	NTS

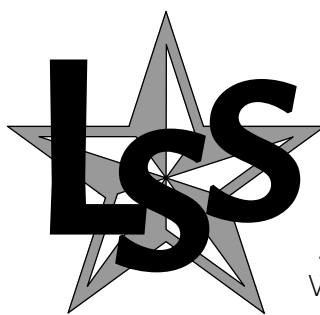


**LONE STAR
STRUCTURAL, LLC**

WWW.LONESTARSTRUCTURAL.COM | TEXAS REGISTERED FIRM F-20642 | P: 210.827.5509

SINNERS AND SAINTS

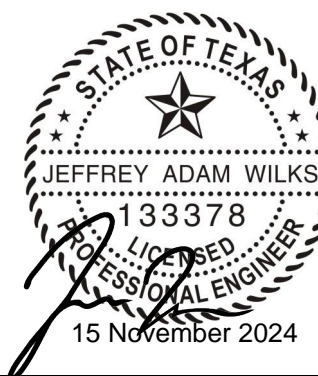19186 FM 2252
GARDEN RIDGE, TEXAS 78266



JOB: 24231A\05292024
DATE: 15 NOVEMBER 2024
DRAWN: JW | DESIGN: JW
STRUCTURAL DETAILS
SHEET:

S8.1